REVISION LOG

REVISION:001

ADJUST OPTION SQUARE FOOTAGES TO ACCURATELY SHOW THE DIFFERENCES FROM THE BASE PLAN SQUARE FOOTAGE TOTALS.

REVISION:002

1. ADJUST OPTION SQUARE FOOTAGES TO ACCURATELY SHOW THE DIFFERENCES FROM THE BASE PLAN SQUARE FOOTAGE TOTAGES.
2. EXTENDED TRIM AT GARAGE DOOR DOWN TO BASE AND CUT STONE BACK
3. ADJUSTED KITCHEN ISLAND
4. RESIZED THE FIREPLACE OPTION
5. RELOCATED THE WINDOW IN THE MESSY KITCHEN TO BEHIND THE OPT. SINK
6. CHANGED MESSY KITCHEN WINDOW TO OPTIONAL
7. ADDED CHASE TO OWNER'S WC
8. ADDED DIMS TO 0. BATH VANITY FOR CLARIFICATION
9. REMOVED OPT. DOOR TO LOFT
10. ADDED CHASE TO LOFT WC
11. RELOCATED LINEN IN THE 0. BATH OPTIONS
12. REMOVED THE OPT. SUPER SHOWER (ZERO ENTRY)
13. FLIPPED SMART DOOR DELIVERY DOOR HANDING
14. CHANGED ALL LINEN CLOSETS TO HAVE ONLY 4 SHELVES
15. CHANGED SIZE OF BASE SHOWER TO 60X36
16. UPDATED OPTIONAL SQ. FTG. CHART
17. REMOVED HALE WALLS AT KITCHEN ISLAND AND UPDATED PER CABINET PROVIDER
18. EXTEND PORCH SLAB 4* AT FRONT AND EXTEND AROUND CORNER 20* TO SUPPORT STONE VENEER
19. EXTEND PORCH SLAB 4* AROUND THE PERMETER AT THE 'CRAFTSMAN' ELEVATION

REVISION:003 DATE: 3/30/2022

EXTEND PORCH SLAB 4" AROUND THE PERIMETER AT THE 'CRAFTSMAN' ELEVATION

ADDED A COLUMN DETAIL FOR CLARITY ON THE "CRAFTSMAM" ELEVATION
ADDED A SEPARATE OPTION FOR THE POCKET OFFICE WITH THE SMART DELIVERY DOOR
ADDED ELECTRICAL PLAN SHEETS

REVISION:004 DATE: 6/20/2022

1. ADD SIDE LOAD GARAGE.

REVISION:005

ADD STEM WALL SLAB FOUNDATION SHEETS CORRECT OPTIONAL SMART DELIVERY DOOR LOCATION ON FOUNDATION PLANS TO MATCH FLOOR PLAN.

REVISION:006 DATE: 10/29/23

CHANGED 48X42 SHOWER TO 42X42.
 ADDED SIDE LODA GARAGE FOUNDATION FOR EXTENDED CAFE OPTION.
 UPDATED SQUARE FOOTAGE CHART TO ADD EXTENDED PATIO TO THE EXTENDED CAFE
 OPTION. REVISED PORCH/ POCKET OFFICE/ SMART DOOR DELIVERY SQUARE FOOTAGE
 MOVED WATER HEATER TO INNER CORNER FOR ALL SIDE LOAD OPTIONS.
 REMOVED OPT. EXTENDED PATIO FROM BASE DRAMINGS

DATE: 7/22/2022

Redlines Completed 2-Mar-24 (DP)

Crawl Foundation

SQUARE	FOOT	4GE		
	GEOR	:GIAN		
	UNHEATED	HEATED		
FIRST FLOOR	0	872		
SECOND FLOOR	0	1336		
FRONT PORCH	123	0		
2 CAR GARAGE	437	0		
PATIO	160	÷		
SUBTOTALS	720	2208		
TOTAL UNDER ROOF	29	28		
O	PTIONS			
	UNHEATED S.F.	HEATED S.F.		
COVERED PATIO	160	÷		
EXTENDED CAFE w/ PATIO	+148	+152		
REAR POCKET OFFICE	0	+60		
FRONT POCKET OFFICE	0	:07		
EPONT POPCH W/	107	•		
FRONT POCKET OFFICE	100	V		
FRONT POCKET OFFICE W/ SMART DOOR	+18	+51		

150 Duncan's Creek

606 Duncan Duncan Creek Rd Lillington, NC 27546

NC.



First Floor Options:

- 1. Extended Cafe w/ Messy Kitchen
- 2. Window and Sink at Messy Kitchen
- 3. Pocket Office w/ Smart Door Delivery
- 4. Vault at Extended Cafe

Second Floor Options

- 1. Bedroom 4 ILO Loft
- 2. Adding second door to Laundry
- 3. Owners Shower w/ Seat, Tiled Walls and 42x42 Fiberglass Pan
- 4. Adding window at Owners Bath

The Holly - LH 'GEORGIAN' ELEVATION

Sheet No.	Sheet Description
0.0	Cover Sheet
1.1	Foundation (Slab)
1.1.1	Foundation Options (Slab)
1.1.2	Foundation Options (Slab)
1.2.1	Foundation (Crawl) Foundation Options (Crawl)
1.2.2	Foundation Options (Crawl)
1.3	Foundation (Stem Wall Slab)
1.3.1	Foundation Options (Stem Wall Slab)
1.3.2	Foundation Options (Stem Wall Slab)
2.1	First Floor Plan
2.1.1	First Floor Plan Options
2.2	Second Floor Plan
2.2.1	Second Floor Plan Options
2.4	Covered Porch Plans & Elevations (Slab)
2.4.1	Covered Porch Plans & Elevations (Crawl/Stem Wall)
2.5	Covered Porch w/ Extended Cafe Plans & Elevations (Slab)
2.5.1	Covered Porch w/ Extended Cafe Plans & Elevations (Crawl/ Stem Wall)
2.6	Extended Cafe Plans & Elevations (Slab)
2.6.1	Extended Cafe Plans & Elevations (Crawl/ Stem Wall)
2.7	2-Car Sideload Garage Plans
2.7.1	2-Car Sideload Garage Elevations
3.1	Front & Rear Elevations (Slab)
3.1.1	Front & Rear Elevations (Crawl/ Stem Wall)
3.2	Side Elevations (Slab)
3.2.1	Side Elevations (Crawl/ Stem Wall)
3.3	Roof Plan
5.1	First Floor Electrical
5.1.1	First Floor Options Electrical
5.2	Second Floor Electrical
5.2.1	Second Floor Options Electrical

DESIGN CRITERIA:

THIS PLAN IS TO BE BUILT IN CONFORMANCE WITH THE 2018 NORTH CAROLINA STATE BUILDING CODE: RESIDENTIAL CODE

DIMENSIONS SHALL GOVERN OVER SCALE, AND CODE SHALL GOVERN OVER DIMENSIONS.

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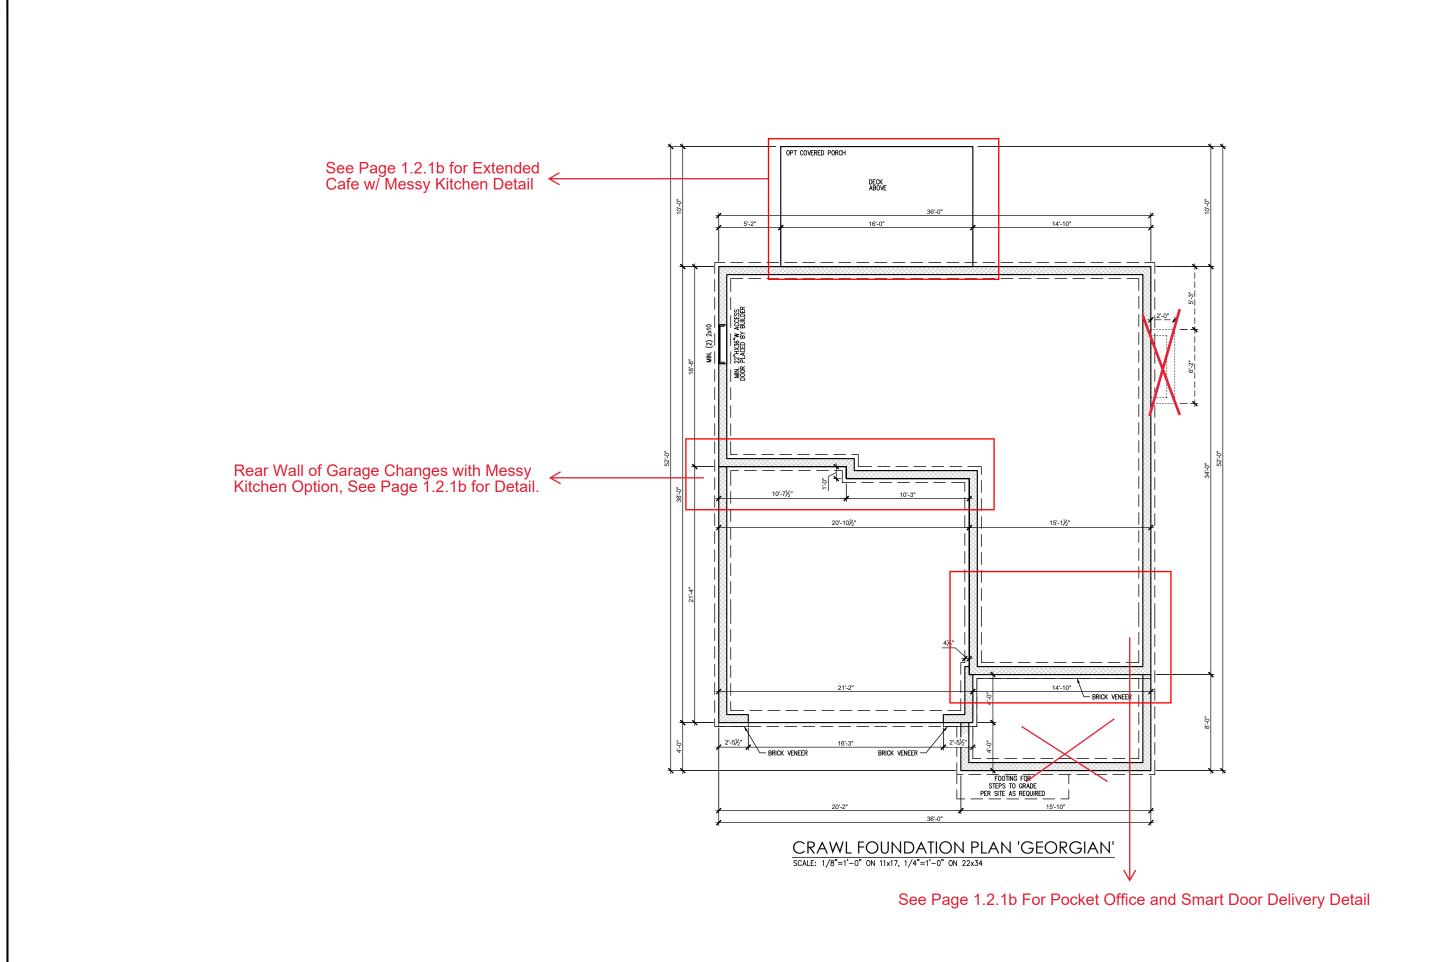
THE HOLLY

Cover Sheet 'Georgian'

DRAWN BY: South Designs ISSUE DATE:

CURRENT REVISION DATE

1/8" = 1'-0"



NEW NEW NOHC

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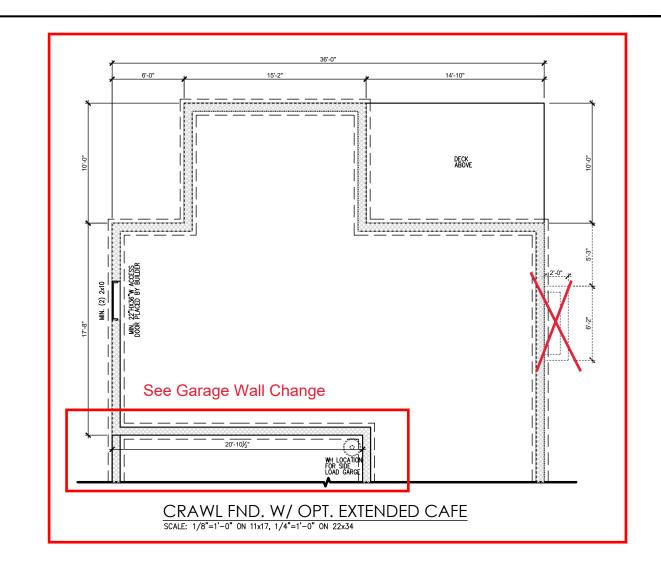
THE HOLLY - LH
--Foundation Crawl 'Georgian'


DRAWN BY: South Designs

ISSUE DATE: 7/1/2021 CURRENT REVISION DATE:

SCALE: 1/8" = 1'-0"

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Foundation Crawl Options 'Georgian'

THE HOLLY - LH

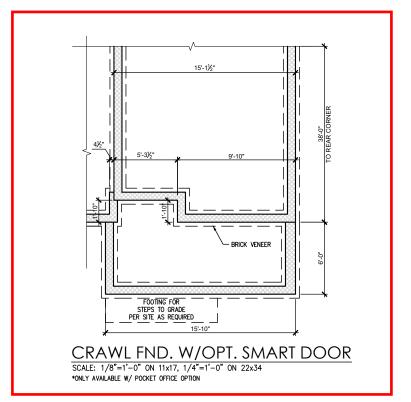DRAWN BY: South Designs


ISSUE DATE: 7/1/2021

CURRENT REVISION DATE:
---SCALE:
1/8" = 1'-0"

1.2.11

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- Wall Heights: Typically 9"-1 1/2" at first floor and 8"-1 1/2" at second floor and attics U.N.O. All walls are constructed using a double top plate. Splices at Double Top Plate do not need to occur at Vertical Studs but must be at least 24" apart from Joint in other Top Plate layer. Special wall heights are noted on plans where they occur.
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- Soffits, Coffered Ceilings, Trey Ceilings and other significant ceiling plan elements are shown on the floor plans and are denoted as single dashed lines. Unless specifically call out as included, Kitchens do not include soffits over wall cabinetry.
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- Stair treads shall be a min of 9" deep, risers shall be a maximum of 8 1/4", unless noted otherwise, per the current North Carolina Residential Code
- 10. Handralls and Guards at stairs shall be 34" above the finished surface of the ramp surface of the stair. Handralls at landings and overlooks of multilevel spaces shall be 36" above finished floor. Guards (pickets or balusters) shall be spaced with no more than 4" between guards.
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---First Floor Plan 'Georgian'

THE HOLLY

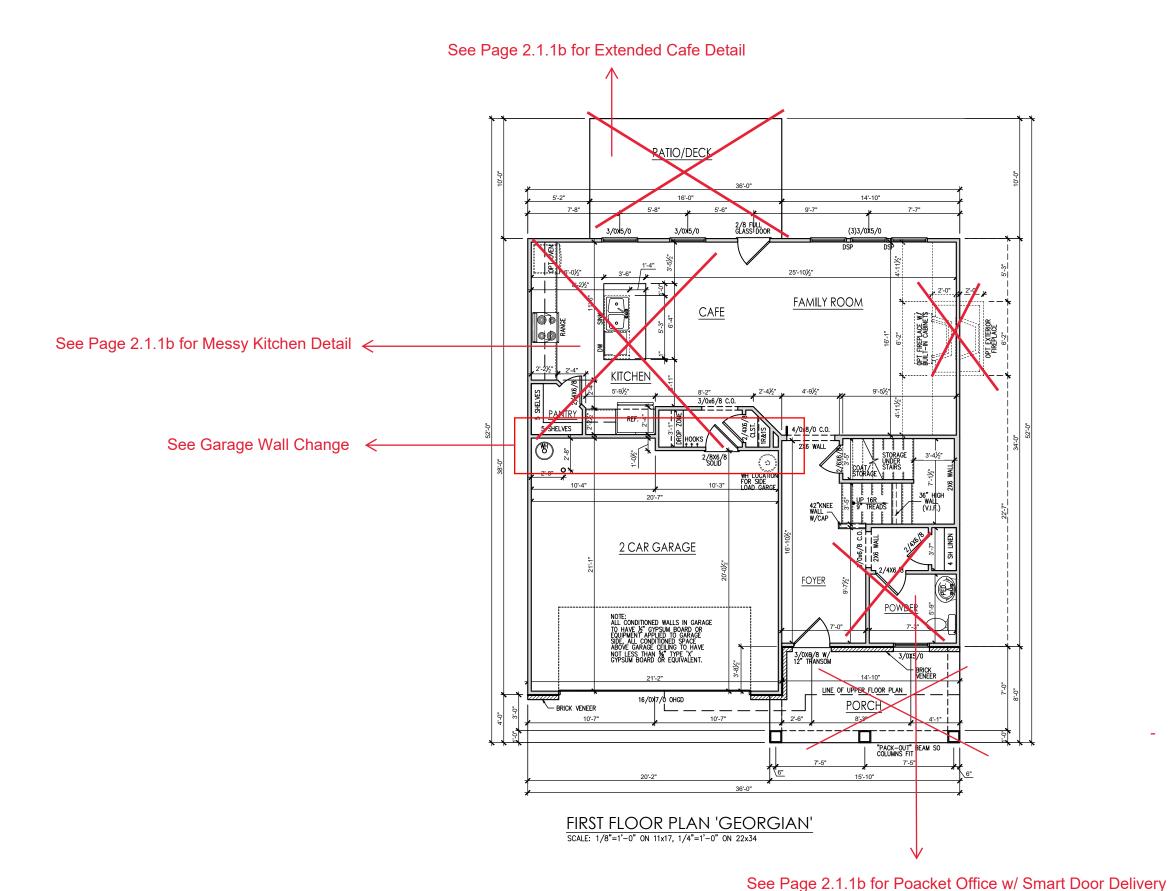DRAWN BY: South Designs


ISSUE DATE: 7/1/2021 CURRENT REVISION DATE:


SCALE: 1/8" = 1'-0"

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First Floor Plan Options 'Georgian'

- LH

THE HOLLY

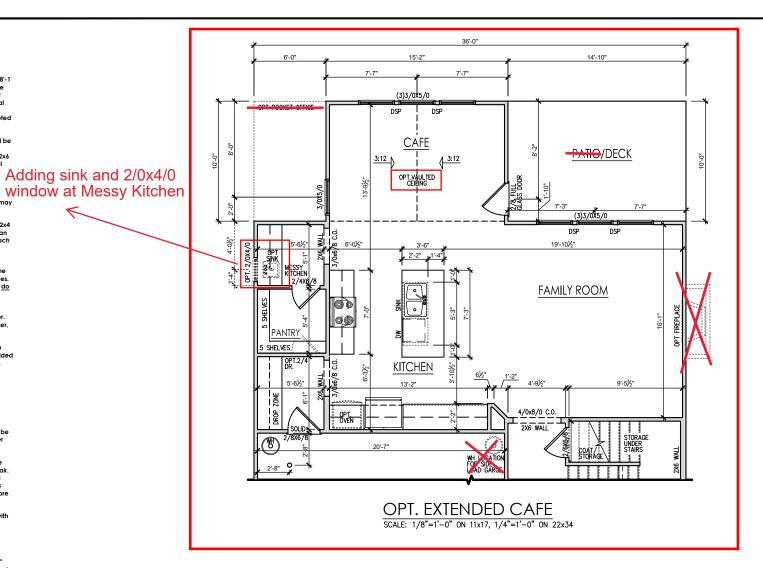
DRAWN BY: South Designs

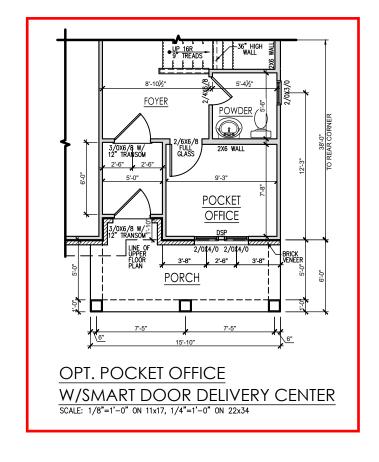ISSUE DATE: 7/1/2021

CURRENT REVISION DATE: 1/8" = 1'-0"

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SECOND FLOOR PLAN 'GEORGIAN'

SCALE: 1/8"=1'-0" ON 11x17, 1/4"=1'-0" ON 22x34

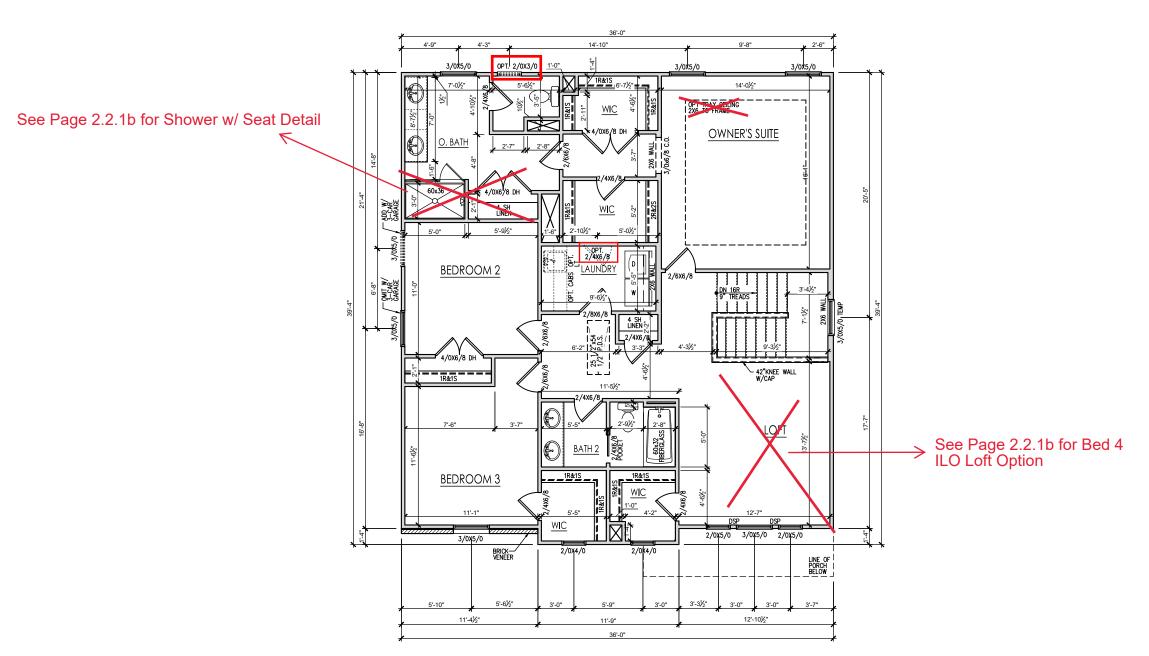

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THE HOLLY - LH
--Second Floor Plan 'Georgian'

DRAWN BY: South Designs

ISSUE DATE:


CURRENT REVISION DATE

1/8" = 1'-0"

2.2h


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OPT. BEDROOM 4 ILO LOFT SCALE: 1/8"=1'-0" ON 11x17, 1/4"=1'-0" ON 22x34

Adding Optional 2/0x3/0 Window

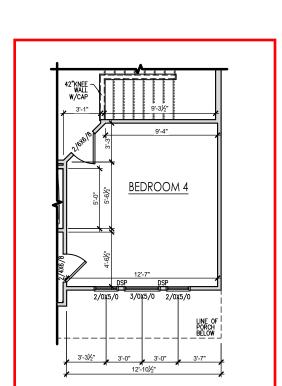

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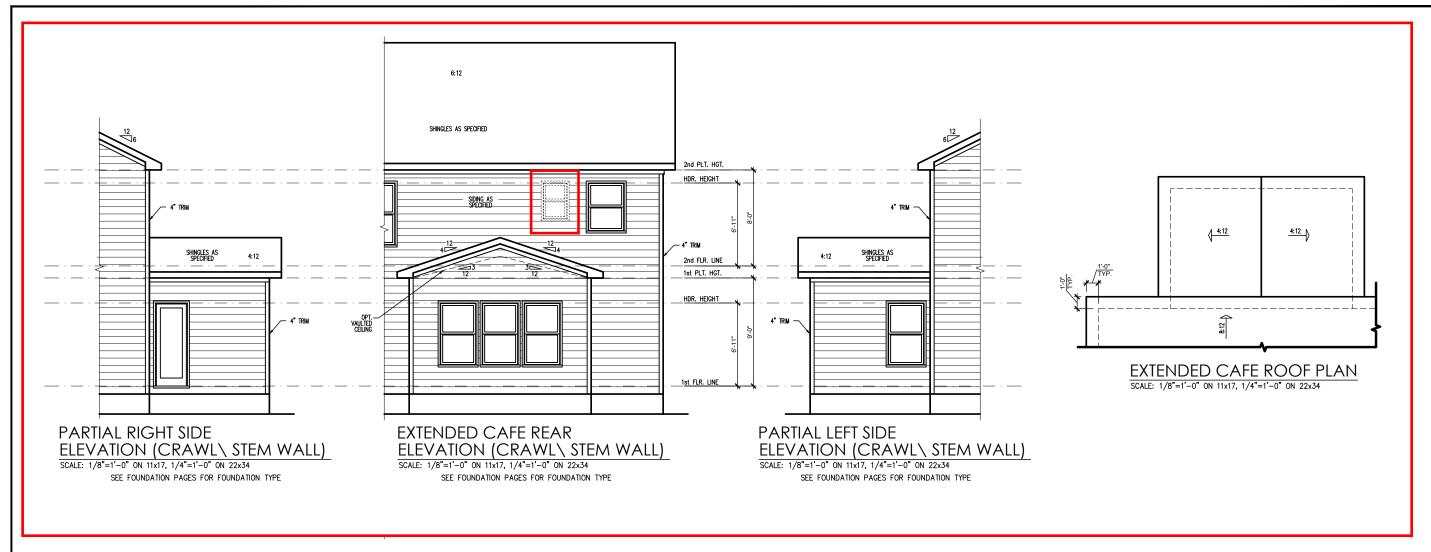
Second Floor Plan Options 'Georgian' - LH THE HOLLY


> DRAWN BY: South Designs

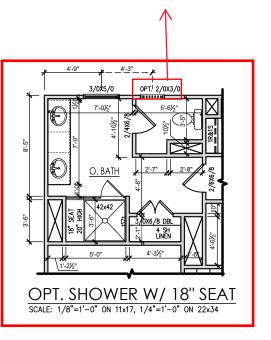ISSUE DATE: 7/1/2021

CURRENT REVISION DATE:

1/8" = 1'-0"



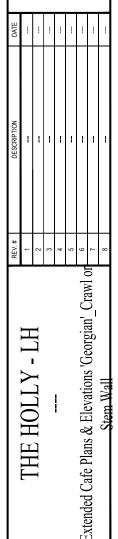

- LH THE HOLLY

DRAWN BY: South Designs

ISSUE DATE:

CURRENT REVISION DATE SCALE: 1/8" = 1'-0"

2.6.1b

General Elevation Notes


General Elevation Notes shall apply unless


- Roof shall be finished with architectural composition shingles with slopes as noted on plan.
- Ridge Vent shall be provided and installed on all ridges greater than 6' in length per manufacturer's specifications.
- 3. Soffit Vent shall be continuous soffit vent
- House Wrap, "tyvek" or approved equal shall be installed over entire exterior wall per manufacturer's specifications and recommendations.
- Flashing shall be provided above all door and window openings, above finish wall material changes and at wall surfaces where lower roof areas abut vertical wall surfaces.
- Porch Railings shall be provided at all porch walking surfaces greater than 30" above adjacent finished grade. It shall be 36" high with guards spaced no more than 4" apart. Consult community specifications for material.
- Finish Wall Material shall be as noted on elevation drawings.
- 8. Brick Veneer, if included on elevation shall be tied to wall surface with galvanized corrugated metal ties at a rate of 24" oc horizontally and 16" oc vertically so that no more than 2.67sf of brick is supported by (1) tie. Space between face of wall and back face of brick shall be limited to a maximum of 1". Flashing shall be provided behind brick above all wall openings and at base of brick wall. Flashing shall be a minimum of 6-mil poly or other corrosion resistant material and shall be installed so that if laps under the house wrap material a minimum of 2".
 Weepholes shall be provided at a rate of 48" oc and shall not be less than 3/16" in diameter and shall be located immediately obove flashing.
- Brick Veneer Support Lintels shall be provided if brick veneer is included on elevation. Lintels shall be provided as listed in the following schedule and shall have a minimum bearing length of 6". Masonry Lintels shall be provided so that deflection is limited to L/600.

Masonry Opening Lintel Schedule


Opening Size Angle

up to	4'-0"		3-1/2" x 3-1/2" x 5/1
4'-1"	to	5'-6"	4" x 3-1/2" x 5/16" LL
5'-7"	to	6'-6"	5" x 3-1/2" x 5/16" LL
6'-7"	to	8'-4"	6" x 3-1/2" x 5/16" LL
8'-5"	to	16'-4"	7" x 4" x 3/8" LLV

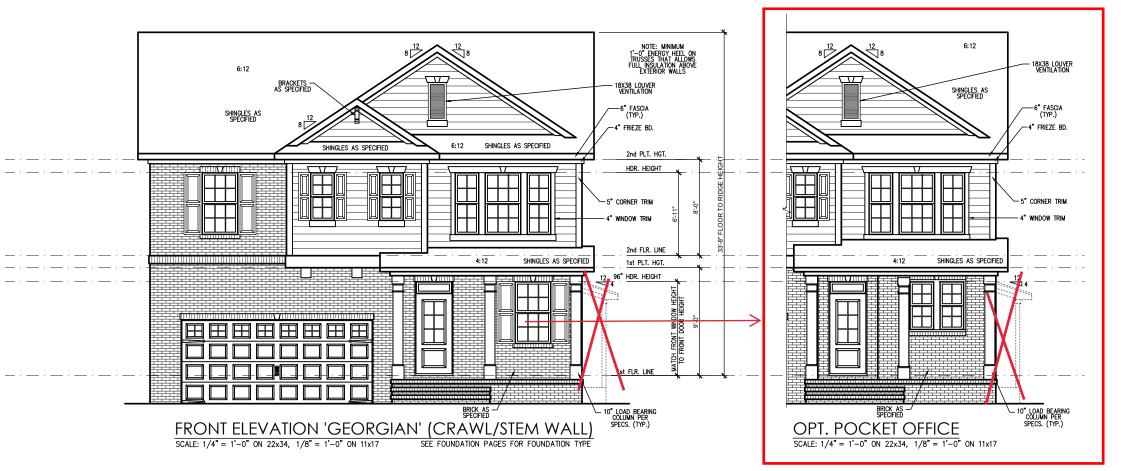

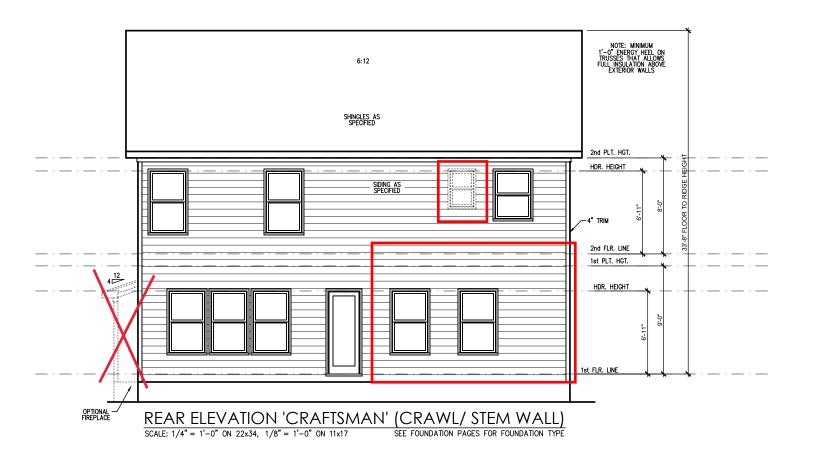



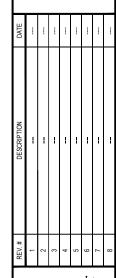

THE HOLLY - LH
--Front & Rear Elevations 'Georgian'_Crawl or
Stem Wall


DRAWN BY: South Designs ISSUE DATE: 7/1/2021

CURRENT REVISION DATE:
---SCALE:

3.1.1b

1/8" = 1'-0"

General Elevation Notes General Elevation Notes shall apply unless noted otherwise on plan. Roof shall be finished with architectural composition shingles with slopes as noted on plan. Ridge Vent shall be provided and installed on all ridges greater than 6' in length per manufacturer's specifications. SHINGLES AS SPECIFIED 3. Soffit Vent shall be continuous soffit vent House Wrap, "tyvek" or approved equal shall be installed over entire exterior wall per manufacturer's specifications and recommendations. SIDING AS SPECIFIED Flashing shall be provided above all door and 2nd PLT. HGT. Porch Railings shall be provided at all porch walking surfaces greater than 30" above adjacent finished grade. It shall be 36" high with guards spaced no more than 4" apart. Consult community specifications for material. HDR. HEIGHT OPTIONAL COVERED PATIO Finish Wall Material shall be as noted on elevation SIDING AS SPECIFIED Brick Veneer, if included on elevation shall be tied to wall surface with galvanized corrugated metal ties at a rate of 24" oc horizontally and 16" oc vertically so 2nd FLR. LINE a rate of 24" oc horizontally and 16" oc vertically so that no more than 2.67st of brick is supported by (1) fle. Space between face of wall and back face of brick shall be limited to a maximum of 1". Flashing shall be provided behind brick above all wall openings and at base of brick wall. Flashing shall be a minimum of 6-mil poly or other corrosion resistant material and shall be installed so that it laps under the house wrap material a minimum of 2". Weepholes shall be provided at a rate of 48" oc and shall not be less than 3/16" in diameter and shall be located immediately above flashing. 1st PLT. HGT. 96" HDR. HEIGHT 4:12 HDR. HEIGHT Brick Veneer Support Lintels shall be provided if brick veneer is included on elevation. Lintels shall be provided as listed in the following schedule and shall have a minimum bearing length of 6". Masonry Lintels shall be provided so that deflection is limited to L/600. Opening Size OPT. POCKET OFFICE SCALE: 1/4" = 1'-0" ON 22x34, 1/8" = 1'-0" ON 11x17 RIGHT SIDE ELEVATION 'GEORGIAN' (CRAWL/STEM WALL) up to 4'-0" 4'-1" to 5'-6" 5'-7" to 6'-6" 6'-7" to 8'-4" 8'-5" to 16'-4" 3-1/2" x 3-1/2" x 5/16" SCALE: 1/4" = 1'-0" ON 22x34, 1/8" = 1'-0" ON 11x17 SEE FOUNDATION PAGES FOR FOUNDATION TYPE See Page 2.6.1b for Extended Cafe Option SHINGLES AS SPECIFIED Side Elevations 'Georgian' Crawl or НТ 2nd PLT. HGT. HDR. HEIGHT THE HOLLY SIDING AS SPECIFIED 2nd FLR. LINE 1st PLT. HGT. HDR. HEIGHT See Page 2.6.1b for Extended DRAWN BY: Cafe Option \leftarrow South Designs ISSUE DATE: 1st FLR. LINE CURRENT REVISION DATE: LEFT SIDE ELEVATION 'GEORGIAN' (CRAWL/STEMWALL) 1/8" = 1'-0" SCALE: 1/4" = 1'-0" ON 22x34, 1/8" = 1'-0" ON 11x17 SEE FOUNDATION PAGES FOR FOUNDATION TYPE

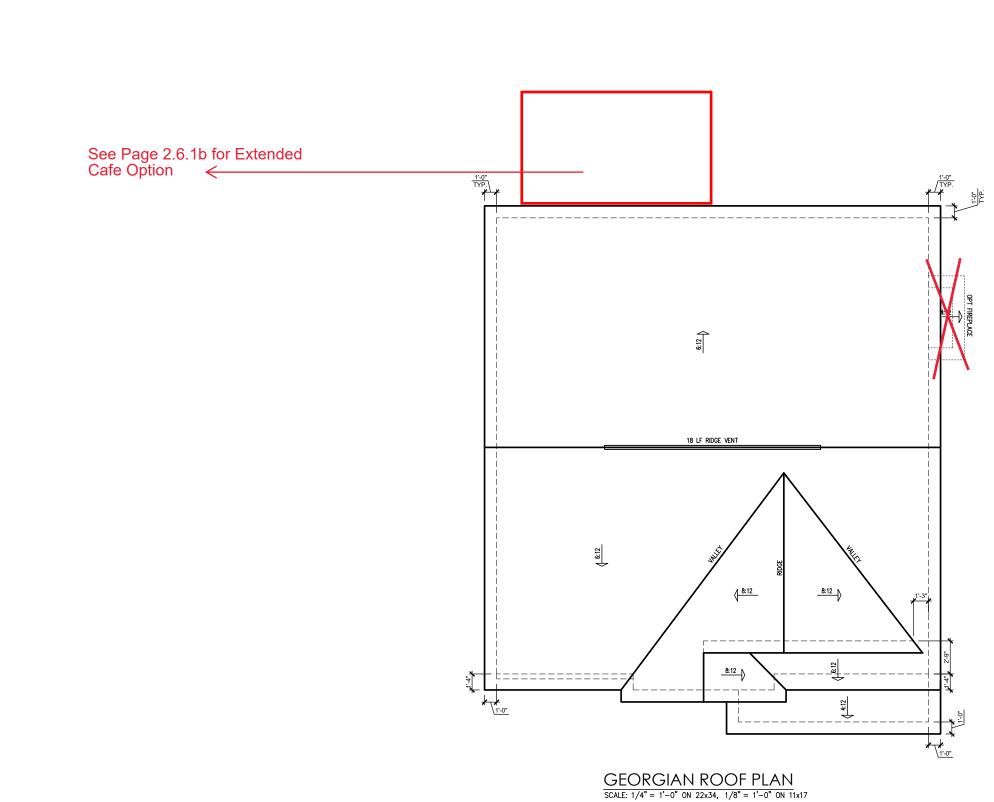

	ATTIC VENT SCHEDULE													
	GEORGIAN													
MAIN HOUSE SQ FTG 1393 AT / NEAR RIDGE AT / NEAR E								AR EAVE						
VENT TYPE	SQ. REQL		SQ. FT. PERCEN		POT LARGE (SQ. FT. EACH)	POT SMALL (SQ. FT. EACH)	RIDGE VENT (SQ. FT. PER LF)	EAVE VENT (SQ. IN. EACH)	CONT. VENT (SQ. IN. PER LF)					
72.11.11.2	RAN		SUPPLIED	SUPPLIED	0.4236	0.2778	0.125	0.1944	0.0625					
0						I		1						
RIDGE VENT	1.86	2.32	3.00	44.44	0	0	24.00							
SOFFIT VENTS	2.79	2.32	3.75	55.56				0	60.00					
TOTAL (MIN)	4.64	4.64	6.75	100.00	POT VENTS MAY BE REQUIRED IF THERE IS INSUFFICIENT RIDGE AVAILABLE									

* SCHEDULE HAS BEEN CALCULATED ASSUMING EAVE VENTILATION AT 50-60% OF TOTAL AND RIDGE AT 40-50% OF TOTAL REQUIRED VENTILATION

THE HOLLY - LH
--Roof Plan 'Georgian'

DRAWN BY: South Designs

ISSUE DATE: 7/1/2021

> SCALE: 1/8" = 1'-0"

3.3b

- TRUSS SYSTEM LAYOUTS (PLACEMENT PLANS)
 SHALL BE DESIGNED IN ACCORDANCE WITH SEALED STRUCTURAL PLANS. ANY NEED TO CHANGE TRUSSES SHALL BE COORDINATED WITH SOUTHERN
- TRUSS SCHEMATICS (PROFILES) SHALL BE PREPARED AND SEALED BY TRUSS MANUFACTURER.
- ALL TRUSSES SHALL BE DESIGNED FOR BEARING ON SPF #2 OR #3 PLATES OR LEDGERS (UNO).
- ALL REQUIRED ANCHORS FOR TRUSSES DUE TO UPLIET OR BEARING SHALL MEET THE REQUIREMENTS AS SPECIFIED ON THE TRUSS

WOOD "I" JOISTS

(SHALL BE ONE OF THE FOLLOWING):

• TJI 210 BY TRUS JOIST

- LPI 20 PLUS BY LP BCI 5000s I.8 BY BC
- ALL WOOD "I"JOISTS SHALL BE INSTALLED ACCORDING TO MANUFACTURER'S SPECIFICATIONS.
- INSTALL SQUASH BLOCKS, WEB STIFFENERS. ETC. AS REQUIRED BY AND ACCORDING TO THE I-JOIST MANUFACTURER'S SPECIFICATIONS AND INSTRUCTIONS
- HANGERS FOR I-JOISTS ARE THE RESPONSIBILITY OF THE I-JOIST SUPPLIER.
- FLOOR TRUSSES BY MANUFACTURER MAY BE

See Page S-1.2.1 for

Wall of Garage Changes

Messy Kitchen Option. Rear ←

FOUNDATION STRUCTURAL NOTES NC (2018 NCRC): Wind: 115-120 mph - CRAWL

(I.) (3)2xIO SYP#2 OR SPF#2 GIRDER, TYPICAL UNO.

CONCRETE BLOCK PIER SIZE SHALL BE:

<u>SOLID</u> UP TO 5'-O" UP TO 9'-O" HOLLOW 8xl6 UP TO 32"

UP TO 48" 12x16 UP TO 64" 24x24 UP TO 96"

WITH 30" x 30" × IO" CONCRETE FOOTING, UNO.

3 WALL FOOTING AS FOLLOWS 8" - UP TO 2 STORY


10" - 3 STORY 16" - UP TO 2 STORY 20" - 3 STORY BRICK: 16" - I STORY

FOR FOUNDATION WALL HEIGHT AND BACKFILL REQUIREMENTS, REFER TO CODE TABLE R404.I.I (I THRU 4) NOTE: ASSUMED SOIL BEARING CAPACITY = 2000 PSF. CONTRACTOR MUST VERIFY SITE CONDITIONS AND CONTACT SOILS ENGINEER IF MARGINAL OR UNSTABLE SOILS ARE ENCOUNTERED.

20" - 2 STORY

- (4) 2xIO SPF #2 OR SYP #2 GIRDER
- (5) (2) 1.75x4.25 LVL OR LSL GIRDER
- 6) (3) 1.75x9.25 LVL OR LSL GIRDER
- "" DESIGNATES A SIGNIFICANT POINT LOAD TO HAVE SOLID BLOCKING TO PIER. SOLID BLOCK ALL BEAM BEARING POINTS NOTED TO HAVE THREE OR MORE STUDS TO FND, TYPICAL.
- ABBREVIATIONS:
- "SJ" = SINGLE JOIST
- "D.I" = DOUBLE . IOIST
- ADJUST SUBFLOOR THICKNESS OR JOIST SPACING AS REQ'D FOR FLOOR FINISH MATERIALS.

See Page S-1.2.1 for Extended Cafe Option

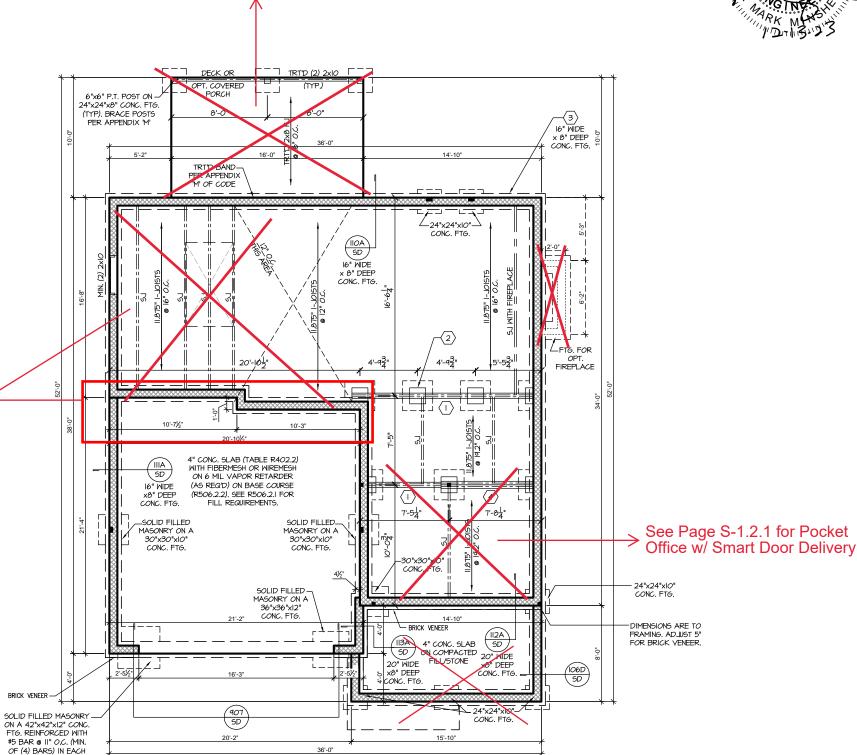

CRAWL FOUNDATION PLAN 'GEORGIAN'

SCALE: 1/8"=1'-0" ON 11x17, 1/4"=1'-0" ON 22x34

REFER TO "SD" SHEET(S) FOR STANDARD DETAILS BRACING

DETAILS AND STRUCTURAL NOTES


PROJECT # 21-2816.1-LH

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SOUTH DESIGNS


Holly The Plan

S-1.2

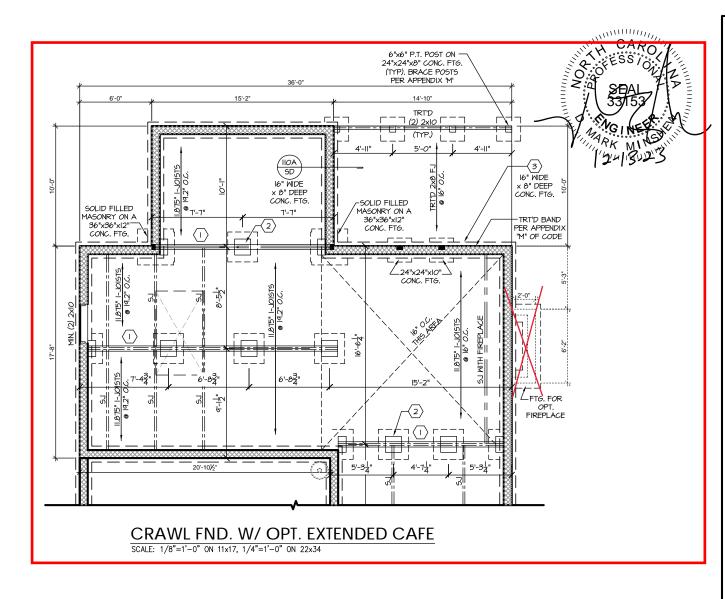

FI

I6"xI6" SOLID FILLED MASONRY PIER
ON A 42"x42"x12" CONC. FTG.
REINFORECED WITH #4 BAR @ 7" O.C.
(MIN. OF (6) BARS) IN EACH DIRECTION

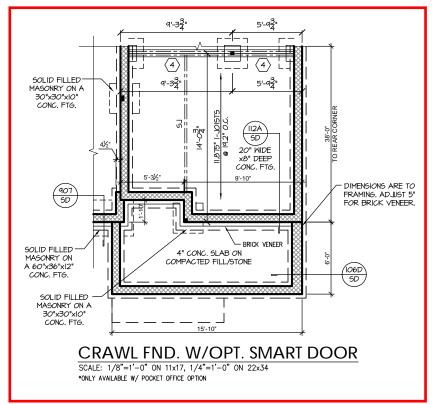

PROJECT # 21-2816.1-LH

illions as will litions as

Seal does not include construction means, methods, technique sequences, procedures or safety precautions.

Any deviations or discrepancies on plans are to be brought to immediate attention of Southern Engineers. Failure to do so void Southern Engineers, Failure to do so I heep plans, constitutes annoval of ferms & conditions.

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SOUTH DESIGNS

Plan 2 - The Holly - LH
NEW HOME, INC.

REFER TO "SD" SHEET(S) FOR STANDARD DETAILS, BRACING DETAILS AND STRUCTURAL NOTES.

S-1.2.

- TRUSS SYSTEM LAYOUTS (PLACEMENT PLANS) SHALL BE DESIGNED IN ACCORDANCE WITH SEALED STRUCTURAL PLANS, ANY NEED TO CHANGE TRUSSES SHALL BE COORDINATED WITH SOUTHERN ENGINEERS.
- TRUSS SCHEMATICS (PROFILES) SHALL BE PREPARED AND SEALED BY TRUSS MANUFACTURER.
- ALL TRUSSES SHALL BE DESIGNED FOR BEARING ON SPF #2 OR #3 PLATES OR LEDGERS (UNO).
- ALL REQUIRED ANCHORS FOR TRUSSES DUE TO UPLIFT OR BEARING SHALL MEET THE REQUIREMENTS AS SPECIFIED ON THE TRUSS

HEADER/BEAM & COLUMN NOTES

- ALL EXTERIOR AND LOAD BEARING HEADERS SHALL BE MIN. (2)2x6 (4" WALL) OR (3)2x6 (6 WALL) WITH (I) SUPPORT STUD, UNLESS NOTED
- 2. THE NUMBER SHOWN AT BEAM AND HEADER SUPPORTS INDICATES THE NUMBER OF SUPPORT STUDS REQUIRED IN STUD POCKET OR COLUMN. THE NUMBER OF KING STUDS AT EACH END OF HEADERS IN EXTERIOR WALLS SHALL BE ACCORDING TO ITEM "d" IN TABLE R602.3(5) OR AS BELOW PER NCDOI COMMENTARY "KING STUDS AT WALL OPENINGS" REVISED 1-9-2020: UP TO 3' SPAN: (I) KING STUD
- OVER 3' UP TO 6' SPAN: (2) KING STUDS
- OVER 6' UP TO 9' SPAN: (3) KING STUDS
- OVER 9' UP TO 12' SPAN: (4) KING STUDS OVER 12' UP TO 15' SPAN: (5) KING STUDS

MOOD "I" JOISTS

(SHALL BE ONE OF THE FOLLOWING):

• TJI 210 BY TRUS JOIST

- I PI 20 PI IIS BY I P
- ALL WOOD "I"JOISTS SHALL BE INSTALLED ACCORDING TO MANUFACTURER'S SPECIFICATIONS.
- INSTALL SQUASH BLOCKS, WEB STIFFENERS, ETC. AS REQUIRED BY AND ACCORDING TO THE I-JOIST MANUFACTURER'S SPECIFICATIONS
- HANGERS FOR I-JOISTS ARE THE RESPONSIBILITY OF THE I-JOIST SUPPLIER.
- FLOOR TRUSSES BY MANUFACTURER MAY BE

PORCH POST NOTES:

- 4X4 (6x6) TRT'D POST (OR EQUAL).
- ATTACH TRUSSES (RAFTERS) AT PORCH WITH POST CAP: SIMPSON AC4-MAX (AC6-MAX)
- POST CAP AT CORNER: (2) SIMPSON LCE4 (MITER HEADER AT CORNER). HIGH WIND; ADD (I)
- 3. POST BASE: SIMPSON ABU44 (ABU66).
- MONO: 5/" ANCHOR (EMBED 7")

 CMU: 5/" ANCHOR (EXTEND TO FOOTING
- HIGH WIND ONLY)
- 4. POST BASE: WOOD FOUNDATION: (2) SIMPSON CSI6 STRAPS AT POSTS. EXTEND 12" ONTO EACH POST (UPPER AND LOWER) OR TO GIRDER.
- NOTE: THE ABOVE CONNECTORS ARE SUGGESTIONS. EQUIVALENT CONNECTORS THAT MEET THE REQUIREMENTS OF THE NO. RESIDENTIAL BUILDING CODE, LOCAL CODES, AND/OR ARE APPROVED BY THE BUILDING INSPECTOR MAY BE SUBSTITUTED

See Page S-2.1.1 for Messy Kitchen Option. Rear


Wall of Garage Changes

FRAMING NOTES

- BRACING METHOD AND TYPE: CONTINUOUSLY SHEATHED WSP: CS-WSP. NOTE THAT THE WALL BRACING AMOUNT PROVIDED ON THE PLANS (DETAILS AND SPECIFICATIONS) IS GREATER THAN THE AMOUNT OF WALL BRACING REQUIRED BY SECTION R602.10 OF THE CODE. SEE NOTES BELOW FOR DETAILS AND SPECIFICATIONS FOR WALL BRACING AND WALL FRAMING.
- EXTERIOR WALL SHEATHING: WALLS SHALL BE BRACED BY SHEATHING MALLS ON ALL STORIES WITH WOOD STRUCTURAL PANEL SHEATHING (MSP) (EXPOSURE B: 7/16". EXPOSURE C: 15/32"), SHEATHING SHALL BE ATTACHED WITH 8d NAILS AT A 6"/12" NAILING PATTERN (6" OC AT PANEL EDGES AND 12" OC AT INTERMEDIATE SUPPORTS), INSTALL BLOCKING AT ALL PANEL EDGES.
- WSP SHEATHING SHALL EXTEND TO THE UPPERMOST DOUBLE BEARING PLATE. BLOCK AT ROOF PER SECTION R602.IO.4.5 AND ATTACH BRACED WALLS PER CODE. WSP SHEATHING BETWEEN FLOORS SHALL BE SPLICED ALONG CONTINUOUS BAND OR THE WSP SHEATHING MAY BE SPLICED ACROSS STUDS (CONTINUOUS ACROSS FLOOR SYSTEM) WITH BLOCKING AT PANEL EDGES. (MINIMUM 12" BEYOND FLOOR BREAK) OR OTHER APPROVED METHOD.
- "HD" = HOLDOWN: HOLD-DOWN DEVICE (NOTED AS "HD" ON PLANS) SHALL BE AN 800 POUND CAPACITY ASSEMBLY AS NOTED ON PLANS. SEE DETAILS FOR HD ASSEMBLY.

 **GROUND/FIRST FLOOR: USE "HD HOLD-DOWN DETAIL" ON SD SHEET
- **UPPER FLOORS: ATTACH BASE OF KING STUD WITH A SIMPSON C520 OR C5HP20 STRAP DOWN ACROSS THE BAND AND DOWN TO A STUD BELOW OR HEADER BELOW. EXTEND STRAP T" MIN ALONG EACH STUD (OR HEADER) AND ATTACH EACH END W (7) 8d NAILS.
- 5. INTERIOR BRACED WALL: (NOTED AS " $|\underline{BM}|$ " ON PLANS) ATTACH I/2" GYPSUM BOARD (GB) ON EACH SIDE OF WALL WITH A MIN. OF 5d COOLER NAILS OR #6 SCREWS @ 7" O.C. ALONG THE EDGES AND AT INTERMEDIATE SUPPORTS. SEE SECTION R602.10.4.4 OF THE CODE.
- INTERIOR BRACED WALL-WOOD STRUCTURAL PANEL: (NOTED AS "IBW-WSP" ON PLANS). ATTACH ONE SIDE WITH %" MSP SHEATHING WITH 8d NAILS AT A 6"/12" NAILING PATTERN (6" OC AT PANEL EDGES AND 12" OC AT INTERMEDIATE SUPPORTS). INSTALL BLOCKING AT ALL PANEL EDGES, ATTACH GB OVER MSP AS REQUIRED, ATTACH OPPOSITE SIDE WITH 1/2" GB WITH A MIN OF 5d COOLER NAILS OR #6 SCREMS @ 7" OC ALONG THE EDGES AND AT INTERMEDIATE SUPPORTS, SEE SECTION R602,10,4,4 OF THE CODE.

See Page S-2.1.1 for Extended Cafe Option

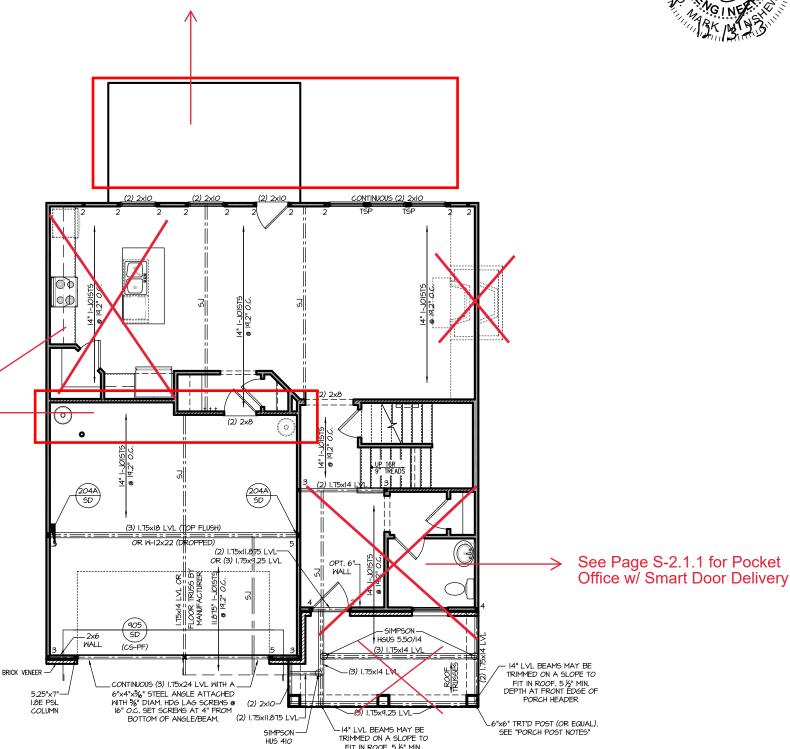

PORCH HEADER

FIRST FLOOR PLAN 'GEORGIAN'

SCALE: 1/8"=1'-0" ON 11x17, 1/4"=1'-0" ON 22x34

PROJECT # 21-2816.1-LH


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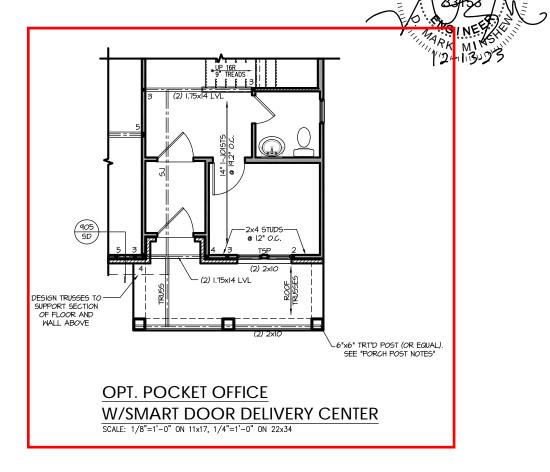
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> **DESIGNS** SOUTH]

Holly \sim

REFER TO "5D" SHEET(5) FOR STANDARD DETAILS, BRACING DETAILS AND STRUCTURAL NOTES.



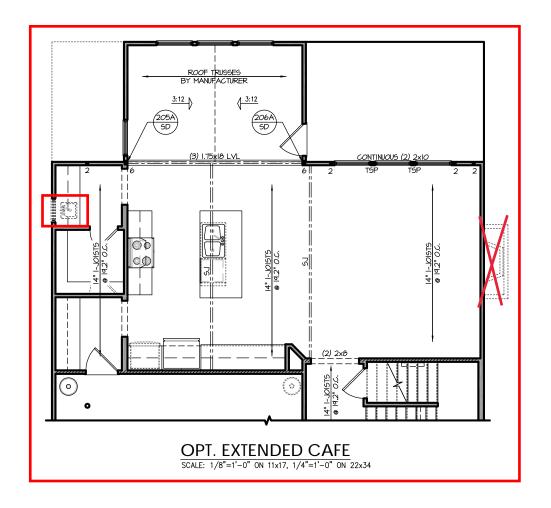

PROJECT # 21-2816.1-LH

centions.

plans are to be brought to the fingineers. Failure to do so will consult of terms & conditions as

Seal document.
Seal document.
Seal document state of the sequences, procedures or safety precautions.
Any deviations or discrepancies on plans are to be broug immediate attention of Southern Engineers. Failure to do void Southern Engineers' liability.
Use of these plans constitutes approval of terms & conditi

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SOUTH DESIGNS

Plan 2 - The Holly - L.F.

S-2.1.1

TRUSS SYSTEM REQUIREMENTS NC (2018 NCRC): Wind: 115-120 mph

- TRUSS SYSTEM LAYOUTS (PLACEMENT PLANS)
 SHALL BE DESIGNED IN ACCORDANCE WITH SEALED STRUCTURAL PLANS. ANY NEED TO CHANGE TRUSSES SHALL BE COORDINATED WITH SOUTHERN
- TRUSS SCHEMATICS (PROFILES) SHALL BE PREPARED AND SEALED BY TRUSS MANUFACTURER.
- ALL TRUSSES SHALL BE DESIGNED FOR BEARING ON SPF #2 OR #3 PLATES OR LEDGERS (UNO).
- ALL REQUIRED ANCHORS FOR TRUSSES DUE TO UPLIET OR BEARING SHALL MEET THE REQUIREMENTS AS SPECIFIED ON THE TRUSS SCHEMATICS

HEADER/BEAM & COLUMN NOTES

- I. ALL EXTERIOR AND LOAD BEARING HEADERS SHALL BE MIN. (2)2x6 (4" WALL) OR (3)2x6 (6" WALL) WITH (I) SUPPORT STUD, UNLESS NOTED OTHERWISE.
- 2. THE NUMBER SHOWN AT BEAM AND HEADER SUPPORTS INDICATES THE NUMBER OF SUPPORT STUDS REQUIRED IN STUD POCKET OR COLUMN. THE NUMBER OF KING STUDS AT EACH END OF HEADERS IN EXTERIOR WALLS SHALL BE ACCORDING TO ITEM "d" IN TABLE R602.3(5) OR AS BELOW PER NCDOI COMMENTARY "KING STUDS AT WALL OPENINGS" REVISED 1-9-2020:
- UP TO 3' SPAN; (I) KING STUD
- OVER 3' UP TO 6' SPAN: (2) KING STUDS
- OVER 6' UP TO 9' SPAN: (3) KING STUDS OVER 9' UP TO 12' SPAN: (4) KING STUDS
- OVER 12' UP TO 15' SPAN: (5) KING STUDS

FRAMING NOTES

NC (2018 NCRC): Wind: 115-120 mph

- BRACING METHOD AND TYPE: CONTINUOUSLY SHEATHED WSP: CS-WSP. NOTE THAT THE WALL BRACING AMOUNT PROVIDED ON THE PLANS (DETAILS AND SPECIFICATIONS) IS GREATER THAN THE AMOUNT OF WALL BRACING REQUIRED BY SECTION R602.10 OF THE CODE. SEE NOTES BELOW FOR DETAILS AND SPECIFICATIONS FOR WALL BRACING AND WALL FRAMING.
- . EXTERIOR WALL SHEATHING: WALLS SHALL BE BRACED BY SHEATHING WALLS ON ALL STORIES WITH WOOD STRUCTURAL PANEL SHEATHING (MGP) (EXPOSURE B: 1/16". EXPOSURE C: 15/32"), SHEATHING SHALL BE ATTACHED WITH ØA NAILS AT A 6"/12" NAILING PATTERN (6" OC AT PANEL EDGES AND 12" OC AT INTERMEDIATE SUPPORTS). INSTALL BLOCKING AT ALL PANEL EDGES.
- 3. WSP SHEATHING SHALL EXTEND TO THE UPPERMOST DOUBLE BEARING PLATE. BLOCK AT ROOF PER SECTION R60210.4.5 AND ATTACH BRACED WALLS PER CODE. WSP SHEATHING BETWEEN FLOORS SHALL BE SPLICED ALONG CONTINUOUS BAND OR THE WSP SHEATHING MAY BE SPLICED ACROSS STUDS (CONTINUOUS ACROSS FLOOR SYSTEM) WITH BLOCKING AT PANEL EDGES. (MINIMUM 12" BEYOND FLOOR BREAK) OR OTHER APPROVED METHOD.
- "<u>HD" = HOLDOWN:</u> HOLD-DOWN DEVICE (NOTED AS "HD" ON PLANS) SHALL BE AN 800 POUND CAPACITY ASSEMBLY AS NOTED ON PLANS. SEE DETAILS FOR HD ASSEMBLY.
- **GROUND/FIRST FLOOR: USE "HD HOLD-DOWN DETAIL" ON SD SHEET (OR EQUIV.)
- (UR EGUIV.)

 **UPPER FLOORS: ATTACH BASE OF KING STUD WITH A SIMPSON
 CS20 OR CSHP20 STRAP DOWN ACROSS THE BAND AND DOWN TO A
 STUD BELOW OR HEADER BELOW. EXTEND STRAP 1" MIN ALONG EACH
 STUD (OR HEADER) AND ATTACH EACH END W (1) 8d NAILS.
- 5. INTERIOR BRACED WALL: (NOTED AS "IBM" ON PLANS) ATTACH I/2" GYPSIM BOARD (6B) ON EACH SIDE OF WALL WITH A MIN, OF 5d COOLER NAILS OR #6 SCREMS @ 7" O.C. ALONG THE EDGES AND AT INTERMEDIATE SUPPORTS. SEE SECTION R602.10.4.4 OF THE CODE.
- 6. INTERIOR BRACED WALL-WOOD STRUCTURAL PANEL: (NOTED AS "IBW-WSP" ON PLANS). ATTACH ONE SIDE WITH 1/6" WSP SHEATHING WITH 80 NAILS AT A 6'1/2" NAILING PATTERN (6" OC AT PANEL EDGES AND 12" OC AT INTERMEDIATE SUPPORTS). INSTALL BLOCKING AT ALL PANEL EDGES, ATTACH GB OVER WSP AS REQUIRED, ATTACH OPPOSITE SIDE WITH I/2" GB WITH A MIN. OF 5d COOLER NAILS OR #6 SCREWS @ 7" OC ALONG THE EDGES AND AT INTERMEDIATE SUPPORTS. SEE SECTION R602.10.4.4 OF THE CODE.



SIMPSON CS20 OR CSHP20 STRAP DOWN ACROSS THE BAND AND DOWN TO A STUD BELOW OR HEADER BELOW. EXTEND STRAP 9" MIN ALONG EACH STUD (OR HEADER) AND ATTACH EACH END W (8) 8d COMMON NAILS (OR EQ). See Page S-2.2.1 for Shower
w/ Bench Option → See Page S-2.2.1 for Bed 4 ILO Loft

ATTACH BASE OF STUD WITH A -

SECOND FLOOR PLAN 'GEORGIAN' SCALE: 1/8"=1'-0" ON 11x17, 1/4"=1'-0" ON 22x34

PROJECT # 21-2816.1-LH

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SOUTH DESIGNS


Holly HOME, The

Plan

S-2.2

REFER TO "SD" SHEET(S) FOR

STANDARD DETAILS BRACING DETAILS AND STRUCTURAL NOTES

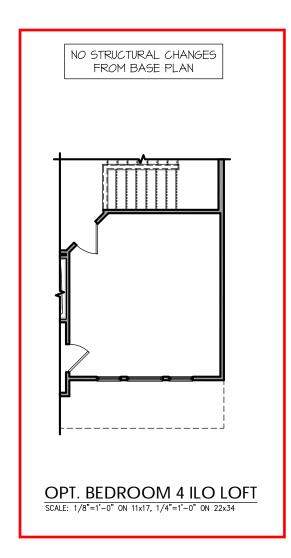



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PROJECT # 21-2816.1-LH

SOUTH DESIGNS

NEW HOME, INC.


The Holly - LH Plan 2

TRUSS SYSTEM REQUIREMENTS NC (2018 NCRC): Wind: 115-120 mph

- TRUSS SYSTEM LAYOUTS (PLACEMENT PLANS)
 SHALL BE DESIGNED IN ACCORDANCE WITH SEALED
 STRUCTURAL PLANS, ANY NEED TO CHANGE
 TRUSSES SHALL BE COORDINATED WITH SOUTHERN
- TRUSS SCHEMATICS (PROFILES) SHALL BE PREPARED AND SEALED BY TRUSS MANUFACTURER.
- ALL TRUSSES SHALL BE DESIGNED FOR BEARING ON SPF #2 OR #3 PLATES OR LEDGERS (UNO).
- ALL REQUIRED ANCHORS FOR TRUSSES DUE TO UPLIFT OR BEARING SHALL MEET THE REQUIREMENTS AS SPECIFIED ON THE TRUSS



See Page S-7.1 for Extended Porch Option

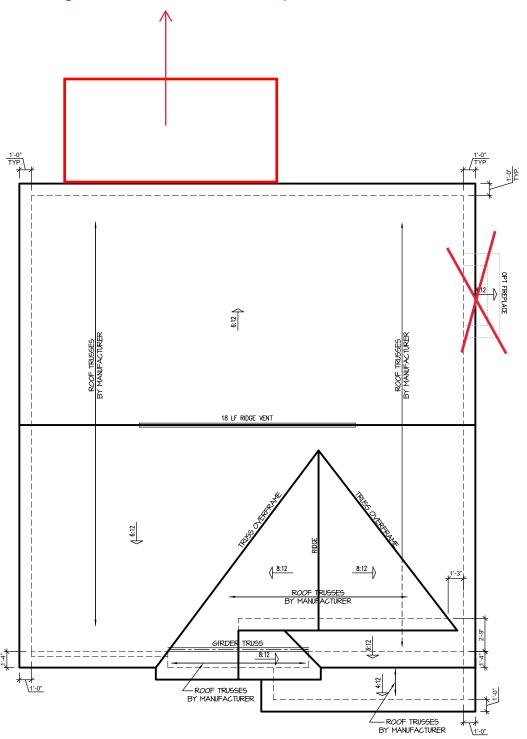


GEORGIAN ROOF PLAN SCALE: 1/4" = 1'-0" ON 22x34, 1/8" = 1'-0" ON 11x17 PROJECT # 21-2816.1-LH

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SOUTH DESIGNS

The Holly Plan

REFER TO "SD" SHEET(S) FOR STANDARD DETAILS, BRACING DETAILS AND STRUCTURAL NOTES.

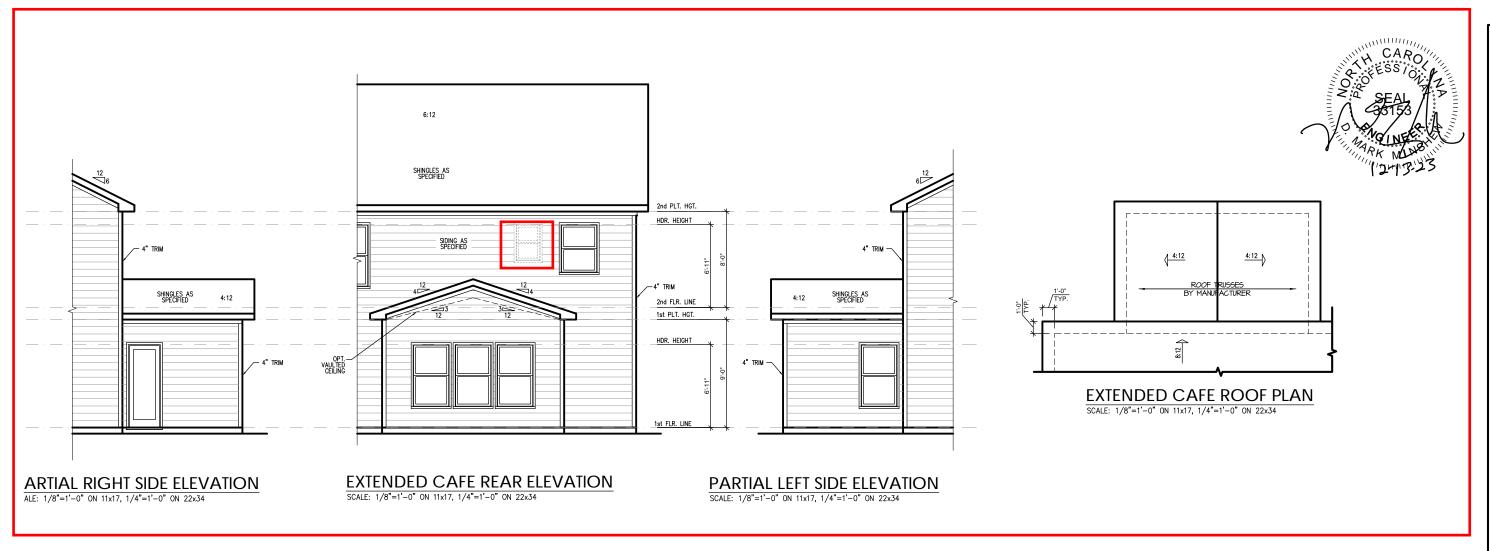

PROJECT # 21-2816.1-LH


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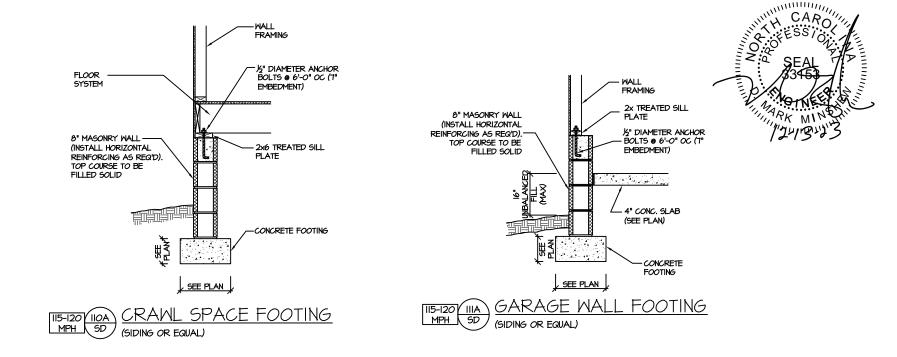
SOUTH DESIGNS


The Holly NEW HOME, INC.


Plan

S-7.1



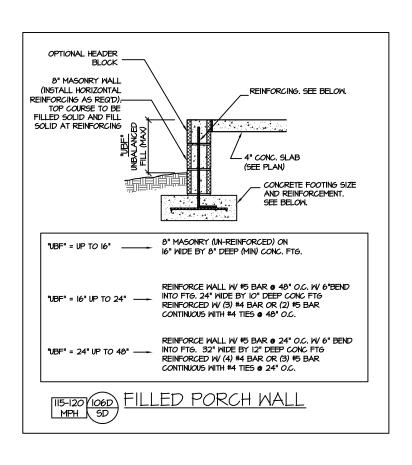

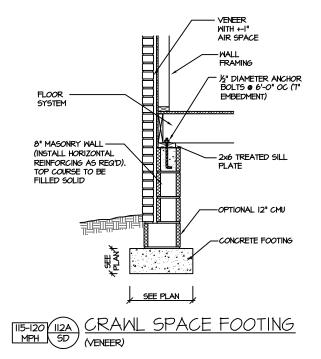

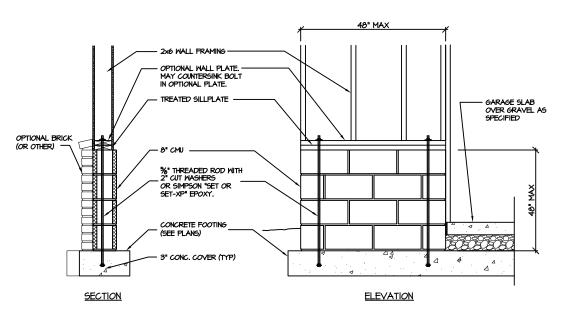

GARAGE 'WING WALL' REINFORCING
PER IRC FIGURE R602.10.4.3

CRAWL SPACE FOUNDATION

PROJECT # 21-2816.1


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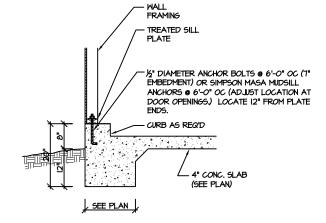
al does not include construction means, methods, tech piences, procedures or safety precautions. ya deviations or discrepancies on plans are to be broug mediate attention of Southern Engineers. Failure to did Southern Engineers. Failure to did Southern Engineer's liability.

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Phone: (919) 878-1617
License: C-4772
www.southernengineers.com

SOUTH DESIGNS

PLAN 2 - THE HOLLY
NEW HOME, INC.



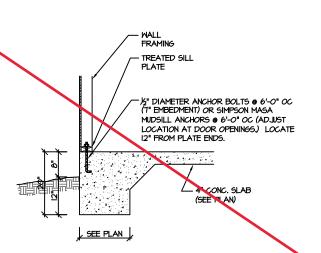

MONOLITHIC SLAB @ GARAGE

II5-I20 IOIA MPH SD

(SIDING OR EQUAL)



MONOLITHIC SLAB FOOTING | II5-I20 | IOOA | SD | (SIDING OR EQUAL)

- VENEER WITH +-1" AIR SPACE - WALL FRAMING - TREATED SILL PLATE - ½" DIAMETER ANCHOR BOLTS @ 6'-0" OC (7" EMBEDMENT) OR SIMPSON MASA MUDSILL ANCHORS @ 6'-0" OC (ADJUST LOCATION AT DOOR OPENINGS.) LOCATE 12" FROM PLATE ENDS. - 4" CONC. SLAB (SEE PLAN)

| II5-120 | 102A | MONOLITHIC SLAB FOOTING | (VENEER)

FTG WIDTH (SEE PLAN)

月 DIAMETER ANCHOR BOLTS (7" EMBEDMENT) TREATED SIL PLATE 6'-0 OC. (ALT. ANCHOR: SIMPSON THD50600H TITEN HD OR EQUAL) -SEE PLAN--THICKENED SLAB

THICKENED SLAB ||15-120 ||04A | |MPH ||5D | (INTERIOR BEARING WALL)

TREATED SILL が DIAMETER ANCHOR BOLTS (7" EMBEDMENT) 6'-O OC. (ALT. ANCHOR: SIMPSON THD50600H TITEN HD OR EQUAL) STEP AS REQ'D <u>∘</u> ₹ SEE PLAN THICKENED SLAB

THICKENED SLAB @ GARAGE MALL! (INTERIOR GARAGE WALL)


SLAB FOUNDATION


PROJECT # 21-2816.1


Southern Engineers, P.A. 3716 Benson Drive, Raleigh, NC 27609 Phone: (919) 878-1617 License: C-4772 www.southernengineers.com

SOUTH DESIGNS


THE HOLLY NEW HOME, INC. \sim **PLAN**

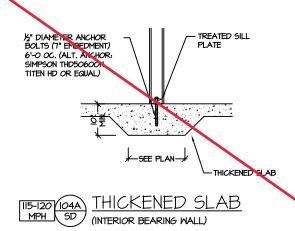


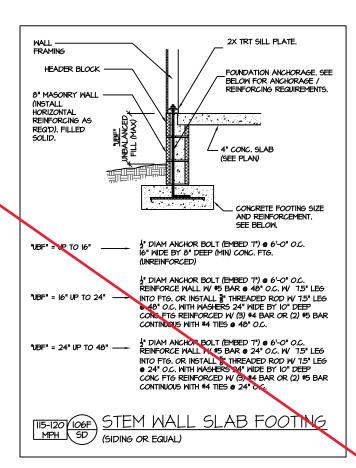


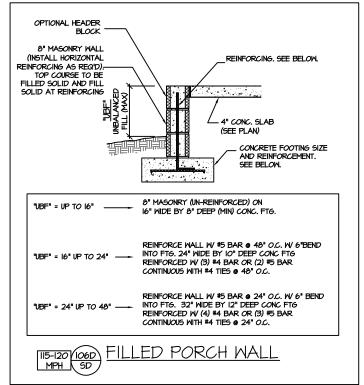




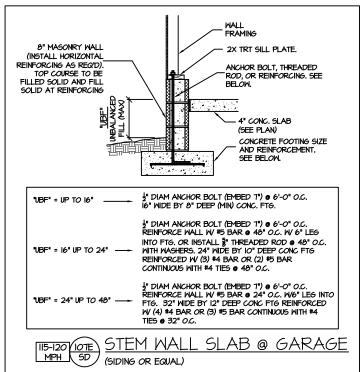

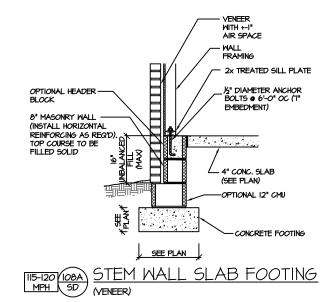

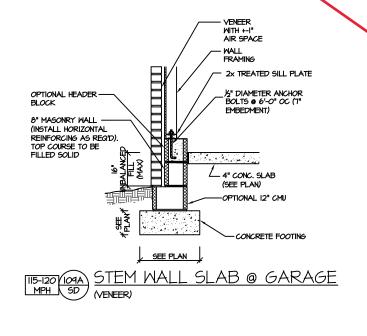

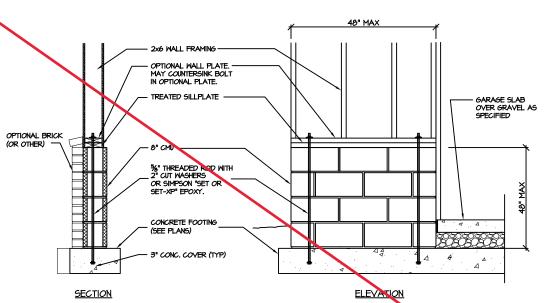

GARAGE 'WING WALL' REINFORCING PER IRC FIGURE R602.10.4.3

STEM WALL SLAB FOUNDATION

PROJECT # 21-2816.1

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SOUTH DESIGNS


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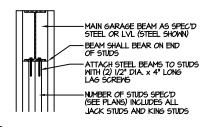
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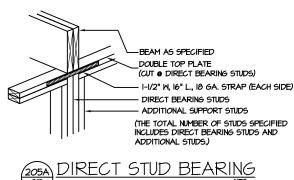


NC (2018 NCRC): Wind: 115-120 mph


- ENGINEER'S SEAL APPLIES ONLY TO STRUCTURAL COMPONENTS INCLUDING ROOF RAFTERS, HIPS, VALLEYS, RIDGES, FLOORS, WALLS, BEAMS AND HEADERS, COLUMNS, CANTILEVERS, OFFGET LOAD BEARING WALLS, PIER & GIRDER SYSTEM, FOOTING, AND PILING SYSTEM. ENGINEER'S SEAL DOES NOT CERTIFY DIMENSIONAL ACCURACY OR ARCHITECTURAL LAYOUT INCLUDING ROOF SYSTEM. ALL REQUIREMENTS FOR PROFESSIONAL CERTIFICATION SHALL BE PROVIDED BY THE APPROPRIATE PROFESSIONAL, SOUTHERN ENGINEERS, P.A. CERTIFIES ONLY THE STRUCTURAL CONTROLLING AND CONTROLLIN COMPONENTS AS SPECIFICALLY STATED.
- 2. ALL CONSTRUCTION SHALL CONFORM TO THE LATEST REQUIREMENTS OF THE 2018 NO ALL CONSTRUCTION SHALL CONFORM TO THE LATEST REQUIREMENTS OF THE 2018 NO RESIDENTIAL CODE, PLUS ALL LOCAL CODES AND REGULATIONS. THE STRUCTURAL ENGINEER IS NOT RESPONSIBLE FOR, AND WILL NOT HAVE CONTROL OF, CONSTRUCTION MEANS, METHODS, TECHNIQUES, SEQUENCES OR PROCEDURES, OR FOR SAFETY PRECAUTIONS AND PROGRAMS IN CONNECTION WITH THE CONSTRUCTION WORK, NOR WILL THE ENGINEER BE RESPONSIBLE FOR THE CONTRACTOR'S FAILURE TO CARRY OUT THE CONSTRUCTION WORK IN ACCORDANCE WITH THE CONTRACT DOCUMENTS. "CONSTRUCTION REVIEW" SERVICES ARE NOT PART OF OUR CONTRACT. ALL MEMBERS SHALL BE FRAMED ANCHORED, TIED AND BRACED IN ACCORDANCE WITH GOOD CONSTRUCTION PRACTICE AND THE BUILDING CODE.
- DESIGN LOADS (LISTED AS: LIVE LOAD, DEAD LOAD, DEFLECTION)
- ROOMS OTHER THAN SLEEPING ROOMS: (40 PSF, IO PSF, L/360)
- SLEEPING ROOMS: (30 PSF, IO PSF, L/360)
- ATTIC WITH PERMANENT STAIR: (40 PSF, IO PSF, L/360)
- ATTIC WITHOUT PERMANENT STAIR: (20 PSF, IO PSF, L/360)
- ATTIC WITHOUT STORAGE: (IO PSF, IO PSF, L/240)
- STAIRS: (40 PSF, IO PSF, L/360)
- DECKS AND EXTERIOR BALCONIES: (40 PSF, IO PSF, L/360)
- PASSENGER VEHICLE GARAGES: (50 PSF, IO PSF, L/360)
- 4. WALLS SHALL BE BRACED BY SHEATHING WALLS ON ALL STORIES WITH MOOD STRUCTURAL PANELS. SEE FRAMING NOTES FOR THICKNESS AND NAILING REQUIREMENTS.
- 5. SEE APPENDIX M (DCA6) FOR EXTERIOR DECK REQUIREMENTS INCLUDING ATTACHMENTS FOR
- CONCRETE SHALL HAVE A MINIMUM 20 DAY STRENGTH OF 3000 PSI AND A MAXIMUM SLUMP OF 5 INCHES UNLESS NOTED OTHERWISE (UNO). AIR ENTRAINED PER TABLE 402.2. ALL CONCRETE SHALL BE PROPORTIONED, MIXED, HANDLED, SAMPLED, TESTED, AND PLACED IN ACCORDANCE WITH ACI STANDARDS, ALL SAMPLES FOR PUMPING SHALL BE TAKEN FROM THE EXTRIDANCE THE PUMP. CONTROL JOINTS IN SLABS SHALL BE SPACED ON A GRID OF 1-30 TIMES THE DEPTH (D). CONTROL JOINTS SHALL BE SANCUT TO A DEPTH OF I/D. (I.E. 4" CONCRETE SLABS SHALL HAVE 以" DEEP CONTROL JOINTS SAWCUT IN SLAB ON A +-10'-0" x +-10'-0" GRID).
- ALLOWABLE SOIL BEARING PRESSURE ASSUMED TO BE 2000 PSF. THE CONTRACTOR MUST CONTACT A GEOTECHNICAL ENGINEER AND THE STRUCTURAL ENGINEER IF UNGATISFACTORY SUBSURFACE CONDITIONS ARE ENCOUNTERED. THE SURFACE AREA ADJACENT TO THE FOUNDATION WALL SHALL BE PROVIDED WITH ADEQUATE DRAINAGE, AND SHALL BE GRADED SO AS TO DRAIN SURFACE WATER AWAY FROM FOUNDATION WALLS.
- 8. ALL FRAMING LUMBER SHALL BE SPF #2 (Fb = 675 PSI) UNLESS NOTED OTHERWISE (UNO). ALL TREATED LUMBER SHALL BE SYP # 2. PLATE MATERIAL MAY BE SPF # 3 OR SYP #3 (Fc(perp))
- 9. L.V.L. SHALL BE LAMINATED VENEER LUMBER: Fb=2600 PSI, Fv=285 PSI, E=1.9xIO PSI. P.S.L. SHALL BE PARALLEL STRAND LUMBER: Fb=2900 PSI, Fv=240 PSI, E=2.0xi0 PSI. L.S.L. SHALL BE LAMINATED STRAND LUMBER: Fb=2250 PSI, Fv=400 PSI, E=1.55xi0 PSI. INSTALL ALL CONNECTIONS PER MANUFACTURERS INSTRUCTIONS.
- IO. ALL ROOF TRUSS AND I-JOIST LAYOUTS SHALL BE PREPARED IN ACCORDANCE WITH THE SEALED STRUCTURAL DRAWINGS, TRUSSES AND I-JOISTS SHALL BE INSTALLED ACCORDING TO THE MANUFACTURE'S SPECIFICATIONS, ANY CHANGE IN TRUSS OR I-JOIST LAYOUT SHALL BE COORDINATED WITH SOUTHERN ENGINEERS.
- ALL STRUCTURAL STEEL SHALL BE ASTM A-36, STEEL BEAMS SHALL BE SUPPORTED AT EACH END WITH A MINIMUM BEARING LENGTH OF 3 1/2" INCHES AND FULL FLANGE WIDTH, PROVIDE SOLID BEARING FROM BEAM SUPPORT TO FOUNDATION, BEAMS SHALL BE ATTACHED TO EACH SUPPORT WITH TWO LAG SCRENG (1/2" DIAMETER X 4" LONG), LATTERAL SUPPORT IS CONSIDERED ADEQUATE PROVIDING THE JOIST ARE TOE NAILED TO THE SOLE PLATE, AND SOLE PLATE IS NAILED OR BOLTED TO THE BEAM FLANGE @ 48" O.C. ALL STEEL TUBING SHALL BE ASTM ASOO.
- 12. REBAR SHALL BE DEFORMED STEEL, ASTM615, GRADE 60. LAP ALL REBAR SPLICES 30 BAR
- 13. FLITCH BEAMS SHALL BE BOLTED TOGETHER USING (2) ROWS OF 1/2" DIAMETER BOLTS (ASTM A325) WITH WASHERS PLACED UNDER THE THREADED END OF BOLT. BOLTS SHALL BE SPACED AT 24" O.C. (MAX), AND STAGGERED AT THE TOP AND BOTTOM OF BEAM (2" EDGE DISTANCE), WITH 2 BOLTS LOCATED AT 6" FROM EACH END.
- I4. BRICK LINTELS (WHEN REQUIRED) SHALL BE 3 I/2'x3 I/2'x1/4" STEEL ANGLE FOR UP TO 6'-0" SPAN AND 6'x4"x5/16" STEEL ANGLE WITH 6" LEG VERTICAL FOR SPANS UP TO 4'-0". SEE PLANS FOR SPANS OVER 9'-0". SEE ALSO SECTION R703.8.3 LINTELS.
- 15. METAL CONNECTORS REFERENCED ON PLANS CORRESPOND TO SIMPSON STRONG-TIE BRAND. CONNECTORS OF EQUAL OR BETTER CAPACITY ARE ACCEPTABLE. CORROSION RESISTANCE PER CODE AND AS RECOMMENDED BY MANUFACTURER.






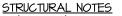



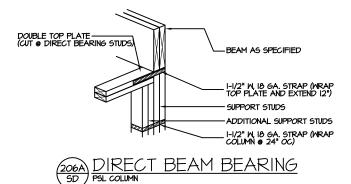

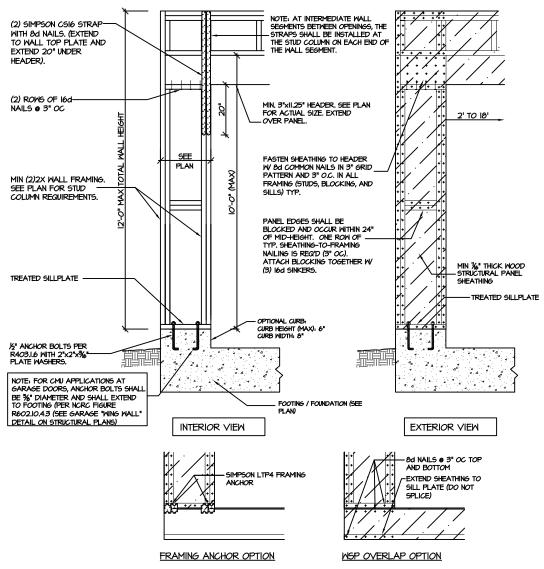

CS-PF - OVER WOOD FLOOR

CS-PF: CONTINUOUS PORTAL FRAME CONSTRUCTION DETAIL AND APPLICATION BASED ON NORC FIGURE R602.IO.I - PORTAL FRAME CONSTRUCTION

21-2816.1

PROJECT #

P.A. 27609

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