NOTICE TO CONTRACTOR All construction must comply with current NC Building Codes and is subject to field inspection and verification. **APPROVED** Limited building only review Permit holder responsible for Harnett full compliance with the code 03/25/2024 NORTH CAROLINA

GRADE ELEVATIONS SHOWN DO NOT NECESSARILY REFER TO THIS OR ANY OTHER LOT. THEY ARE FOR DIAGRAMMATIC PURPOSES ONLY AND MAY VARY, BUILDER IS RESPONSIBLE FOR ADAPTING THIS PLAN TO SUIT THE EXISTING TOPOGRAPHY OF THE SITE.

## ROOF VENTILATION TO BE DETERMINED BY BUILDER AS PER CODE.

ALL EGRESS OR RESCUE WINDOWS FROM SLEEPING ROOMS MUST HAVE A MIN. NET CLEAR OPENING OF 4.0 5Q FT. THE MIN NET CLEAR OPENING HEIGHT DIMENSION SHALL BE 22". THE MIN NET CLEAR OPENING WIDTH SHALL BE 20".

EACH EGRESS WINDOW FROM SLEEPING ROOMS MUST HAVE A SILL HIGHT OF NO MORE THAN 44" FROM THE FLOOR, ALL WINDOW SIZES ARE NOMINAL AND ARE TO BE VERIFIED WITH MANUFACTURER FOR AVAILABILITY AND CONFORMITY TO STATE AND LOCAL CODE REQUIREMENTS.

PORCHES, BALCONIES, OR RAISED FLOOR SURFACES LOCATED MORE THAN 30" ABOVE THE FLOOR OR GRADE BELOW SHALL HAVE GUARDRAILS NOT LESS THAN 32" IN HEIGHT.

I ASSUME NO RESPONSIBILITY FOR ANY DISTANCES AFTER START OF CONTRACTOR/BUILDER SHALL CONSULT WITH HOME OWNER ON ALL INTERIOR AND EXTERIOR MOLDINGS, TRIMS, COLORS, FINISHES, CABINET LAYOUTS, AND MANUFACTORS BEFORE CONSTRUCTION BEGINS, ALL BEAMS AND FRAMING MEMBERS ARE SIZED BY OTHERS.


1.1 This plan has been drawn to comply with the 2018 NC Building Code


- 1.2 Minimum Design Loads for Building and Other Structures ASCE 7-9B
- 2 Roof Dead Load 15 PSF
- 3 Roof Live Load 20 PSF
- 4 Typical Floor Dead Load 10 PSF 5 Floor Live Loads
- 5.1 Rooms other than sleeping rooms 40 PSF
- 5.2 Sleeping Rooms 30 PSF
- 5.3 Stairs 40 PSF 5.4 Decks 40 PSF
- 5.5 Exterior Balconies 60 PSF
- Wind Loads
- 6.1 Ultimate Design Wind Speeds 15 MPH 6.2 Wind Importance Factor, IW 1.00
- 6.3 Exposure B
- 6.4 Walls (Component and Cladding) 25 PSF
- 6.5 Roofs (Component and Cladding)
  - 6.5.1 Roof Slopes 2.25/12 to 7/12 34.8 PSF
  - 6.5.2 Roof Slopes 7/12 to 12/12 21 PSF

It is the sole responsibility of the Contractor and/or Builder to conform to all standards, provisions, requirements, methods of construction and uses of materials provided in buildings and/or structures as required by NC Uniform Building Code, Local Agencies and in accordance with good engineering practices. Verify all dimensions prior to construction.



LAMCO CUSTOM BUILDERS/LAMCO HOMES RETAINS TITLE AND OWNERSHIP OF ALL PLANS, THESE PLANS CAN NOT BE COPIED OR REPRODUCED. THESE PLANS CAN NOT BE BUILT BY ANYONE OTHER THAN LAMCO CUSTOM BUILDERS/LAMCO HOMES

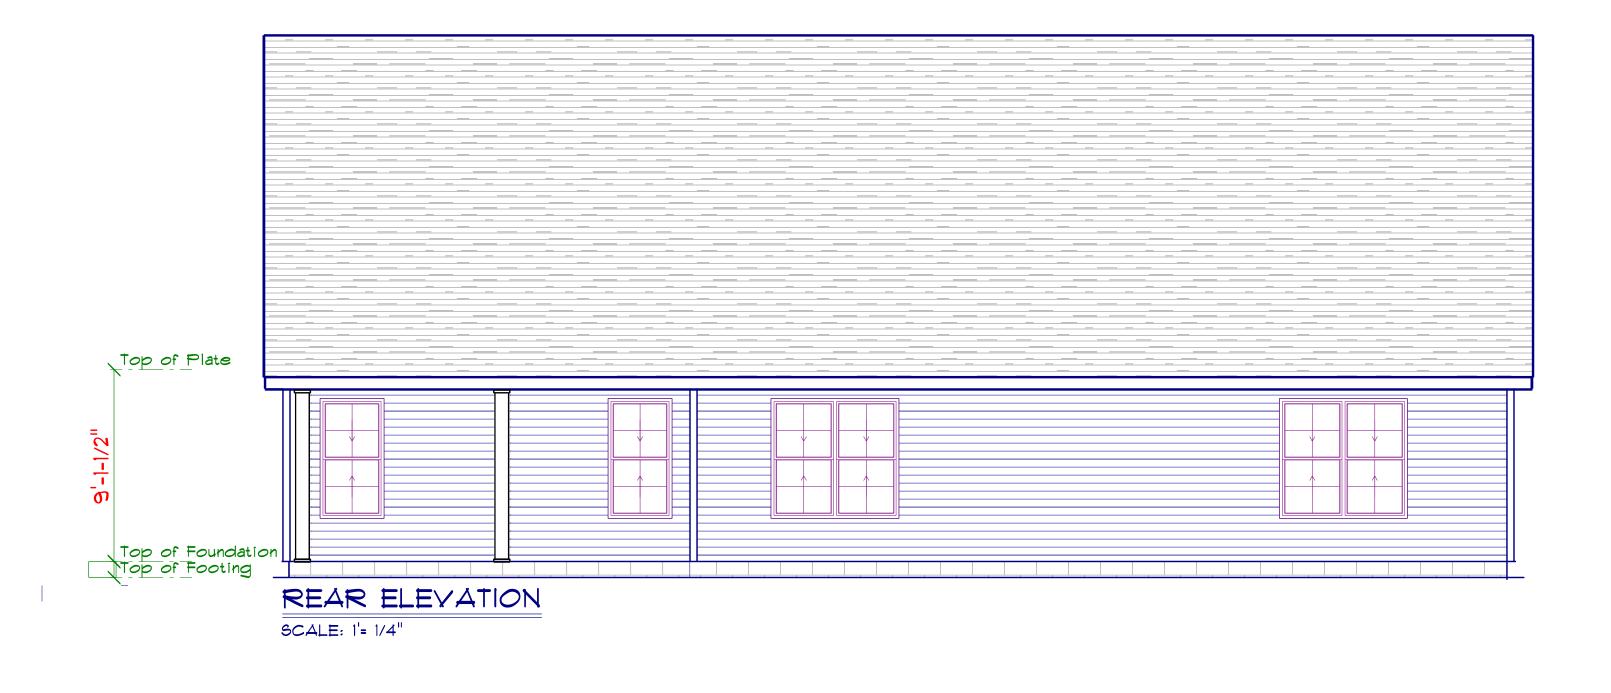

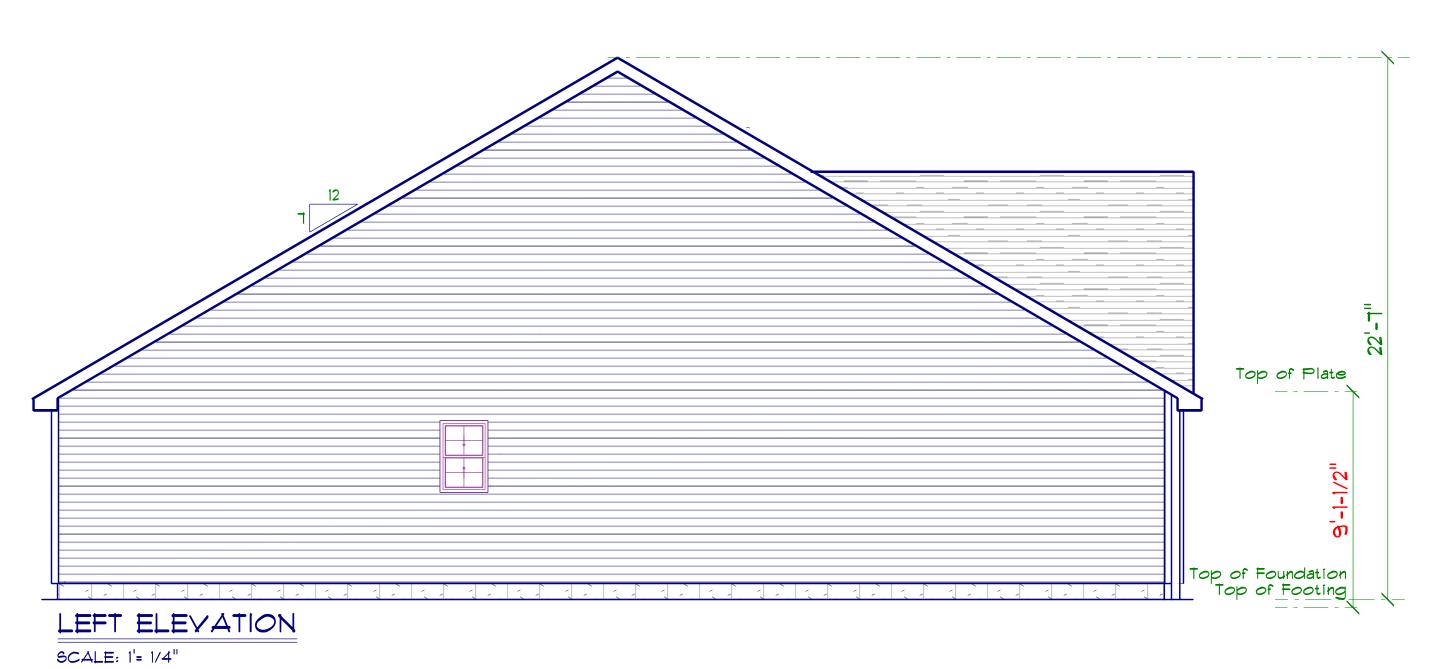





RIGHT ELEVATION

SCALE: 1'=/4"


LAMCO CUSTOM BUILDERS/LAMCO HOMES RETAINS TITLE AND OWNERSHIP OF ALL PLANS. THESE PLANS CAN NOT BE COPIED OR REPRODUCED. THESE PLANS CAN NOT BE BUILT BY ANYONE OTHER THAN LAMCO CUSTOM BUILDERS/LAMCO HOMES

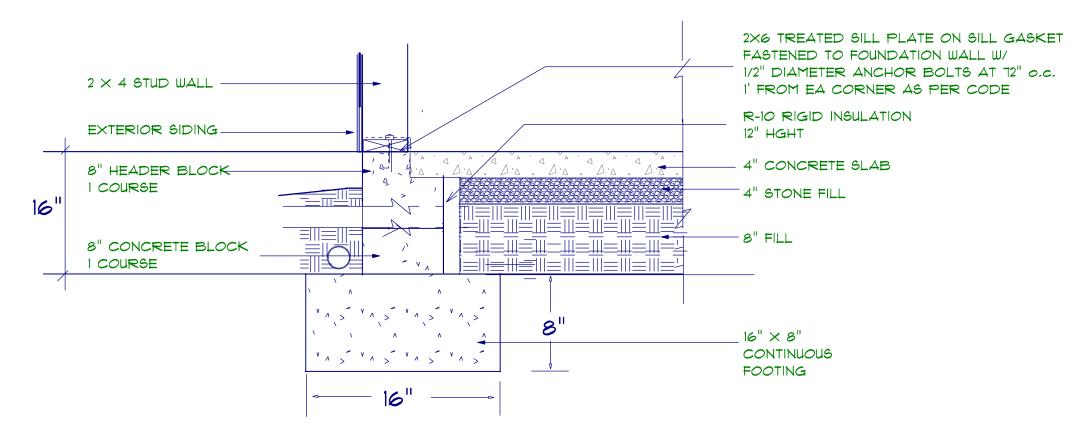

## STEM WALL FOUNDATION Detail not to scale

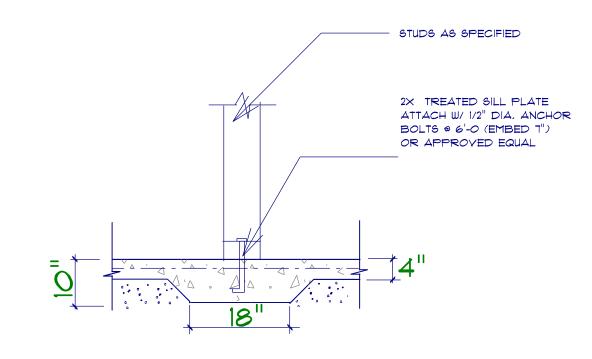

## TYPICAL THICKENED SLAB

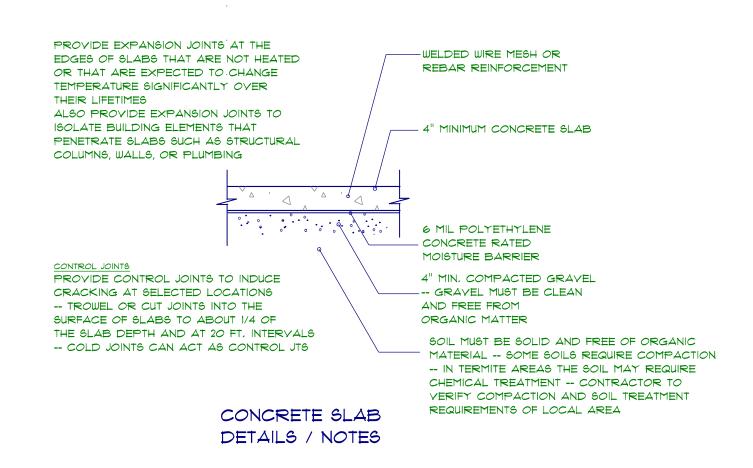

FOUNDATION NOTES:
ALL FOOTINGS SHALL BEAR ON ORIGINAL UNDISTURBED SOIL,
THE 28 DAY COMPRESSIVE STRENGTH OF ALL FOOTINGS IS 3000 PSI

PROVIDE WATER PROOFING AND PERIMETER DRAINS AS REQUIRED,

FOUNDATION CONCRETE MIX TO HAVE 1-1/2" MAX AGGREGATE SIZE, CONCRETE
FILL MIX TO HAVE 1/2" MAX AGGREGATE SIZE,


FOOTING WIDTHS ARE BASED ON A LOAD-BEARING SOIL CAPACITY OF 2000 PSI,

PROVIDE 6 MIL POLY VAPOR BARRIER TO COVER GROUND SURFACE IN CRAWL SPACE

ALL ANCHOR BOLTS TO BE 12'' LONG, 1/2'' DIA. A36 UNO ANCHOR BOLTS SHALL BE SPACE AT A MAX OF 6' OC AND NO MORE THAN 1' FROM EA CORNER.

Termite Soil Treatment: Treat entire slab area soil or crawl space surface before vapor barrier is installed and slab is poured with a state approved termiticide. Termiticide should be applied by a licensed and certified pest control professional by the state of North Carolina.

Termite Soil Treatment: Treat entire slab area soil or crawl space surface before vapor barrier is installed and slab is poured

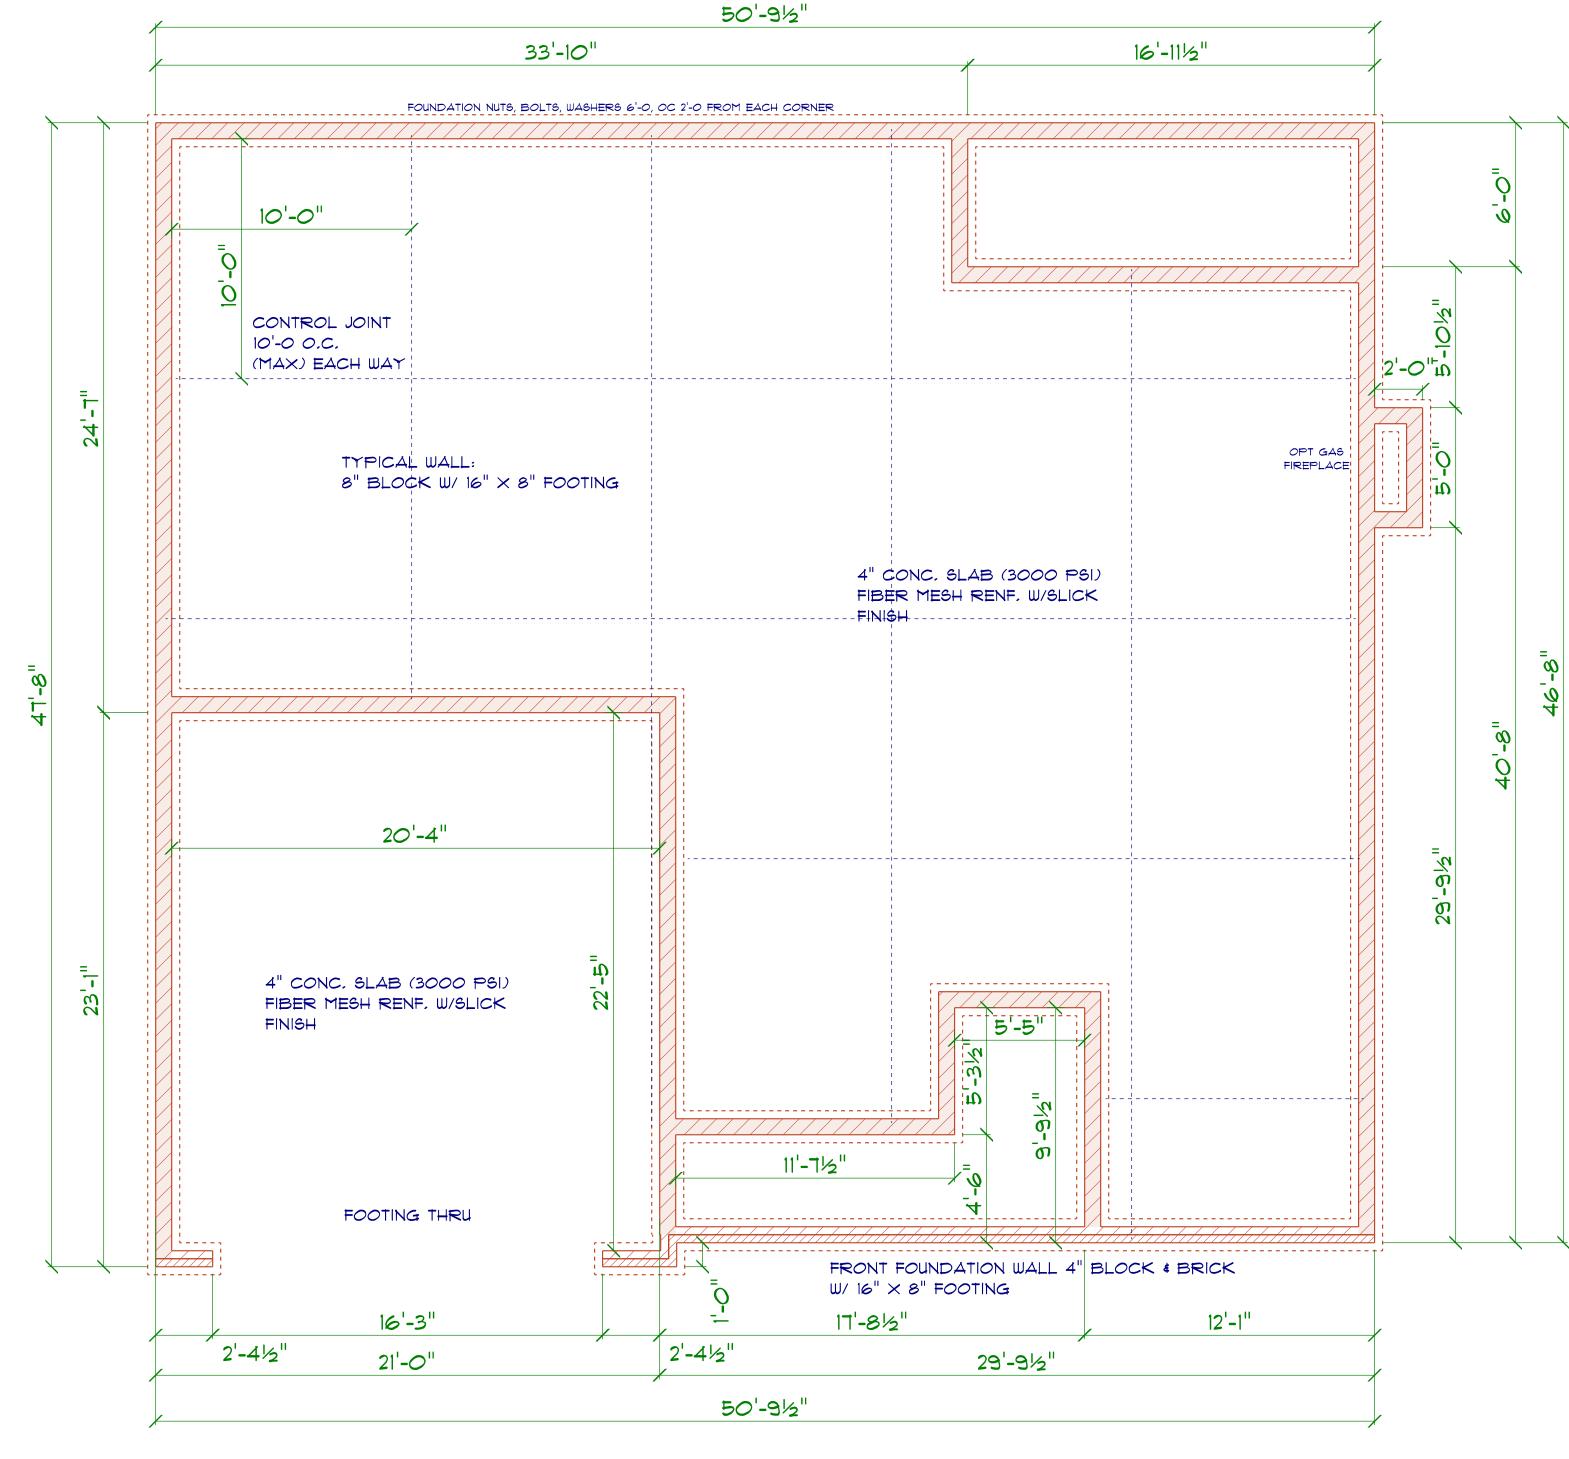

## FOUNDATION PLAN


SCALE: 1'= 1/4"

	OPENING SCHEDULE					
SIZE		COUNT	LIBRARY NAME	R.O. WIDTH	R.O. HEIGHT	
2'-8" x 5'-0"		3	Window\Single Hung	32"	60-1/2"	
2'-8" x 5'-0" Dbl		5	Window\Single Hung	64-1/2"	60-1/2"	
2'-0" x 3'-0"		2	Window\Single Hung	24"	36"	
2'-4" x 3'-0"		1	Window\Single Hung	28"	36"	

GENERAL FRA	1ING NOTES:
ALL LUMBER II PRESSURE TRI	I CONTACT WITH CONCRETE OR MASONRY SHALL BE EATED
	ER SHALL BE SYP *2 GRADE AND/OR FIR *1 AND/OR *2, KILN DRIED.
	GINEERED JOISTS ARE USED, JOIST MANUFACTURER SHALL P DRAWINGS, WHICH BEAR SEAL OF A N.C. ENGINEER.
	STS SHALL NOT BE CUT TO INSTALL PLUMBING OR WIRING WITHOUT. OR WOOD SIDE PANELS TO STRENGTHEN THE MEMBER TO ITS ACITY.
	MEMBERS WITH 2 ROWS OF 16d NAILS STAGGERED 32" OC AN USE IN AT EACH END, DOUBLE ALL STUDS UNDER ROOF POST DOWNS UNC
NAIL FLOOR JO	DISTS TO SILL PLATE WITH 8d TOE NAILS.
ALL EXPOSED	FRAMING ON PORCHES AND DECKS SHALL BE PRESSURE TREATED.
PROVIDE WAT	RPROOFING AND DRAINS AS REQUIRED.
	TO BE 16" OC UNO, WALL FRAMING DIMENSIONS ARE BASED ON $2  imes 4$ puble studs under all headers.
LYL'S AND TJI'	S TO BE SIZED BY OTHERS
EXTERIOR WAL	L6 IN LIVING AREAS ARE 2 × 4

It is the sole responsibility of the Contractor and/or Builder to conform to all standards, provisions, requirements, methods of construction and uses of materials provided in buildings and/or structures as required by NC Uniform Building Code, Local Agencies and in accordance with good engineering practices. Verify all dimensions prior to construction.


LAMCO CUSTOM BUILDERS/LAMCO HOMES RETAINS TITLE AND OWNERSHIP OF ALL PLANS, THESE PLANS CAN NOT BE COPIED OR REPRODUCED, THESE PLANS CAN NOT BE BUILT BY ANYONE OTHER THAN LAMCO CUSTOM BUILDERS/LAMCO HOMES

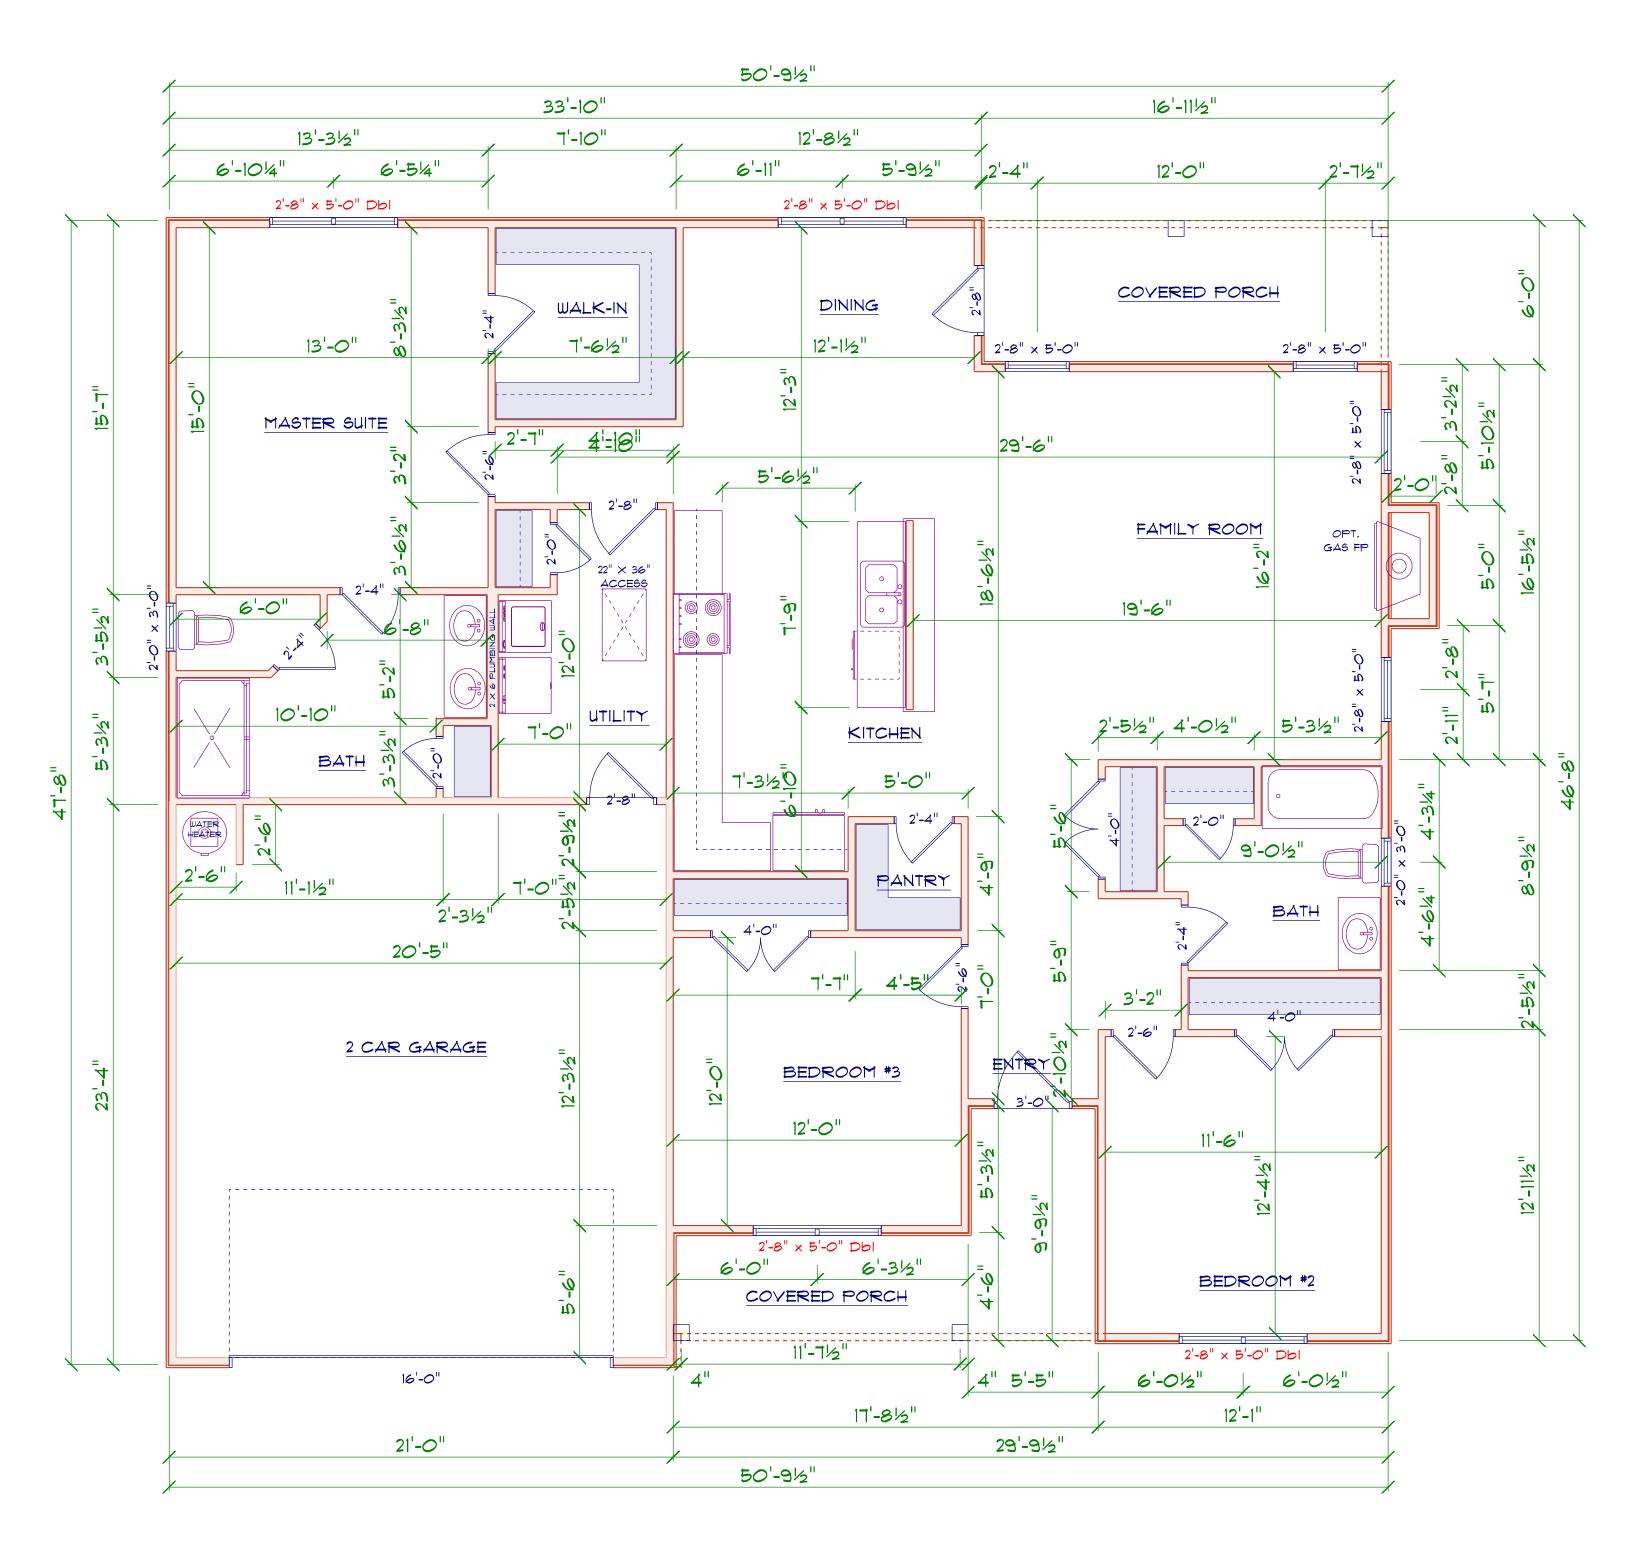

FLOOR PLAN

SCALE: 1'= 1/4"

AREA SCHE	AREA SCHEDULE			
NAME	AREA			
Heated	1717.1 sq ft.			
Garage	489.2 sq ft.			
Covered Front Porch	103.2 sq ft.			
Covered Rear Porch	101.8 sq ft.			

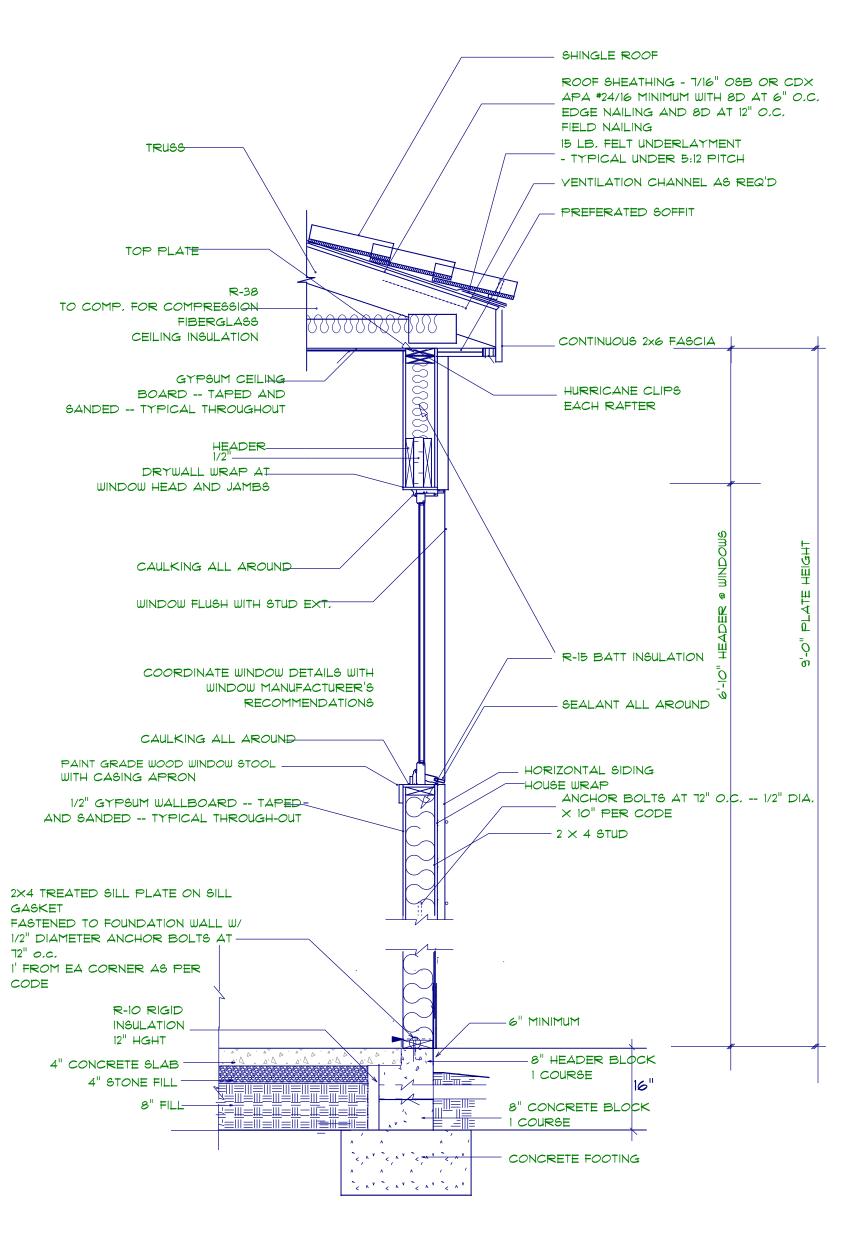

STEM WALL FOUNDATION DETAIL not to scale

LAMCO CUSTOM BUILDERS/LAMCO HOMES RETAINS TITLE AND

OWNERSHIP OF ALL PLANS. THESE PLANS CAN NOT BE COPIED

OR REPRODUCED. THESE PLANS CAN NOT BE BUILT BY

ANYONE OTHER THAN LAMCO CUSTOM BUILDERS/LAMCO HOMES

ROOF NOTES:

TRUSSES, BRACINGS, BRIDGING AND CONNECTORS ARE TO BE DESIGNED BY THE TRUSS MANUFACTURER.

IDENTIFY LUMBER BY OFFICIAL GRADE MARKINGS.

DO NOT CUT OR REMOVE CHORDS OR OTHER TRUSS MEMBERS. DO NOT NOTCH OR DRILL TRUSS MEMBERS.

WHERE PRE-ENGINEERED ROOF TRUSSES ARE USED, TRUSS MANUFACTURER SHALL PROVIDE SHOP DRAWINGS, WHICH BEAR SEAL OF A N. C. REGISTERED ENGINEER.


BLOCK & BRACE PER TRUSS MGR. PRE-ENGINEERED TRUSSES @ 24" o.c. 2×4 TRUSS BRACING TYPICAL 2x4 SIDING EXTERIOR WALL: R38 BLOWN INSULATION YINYL SIDING 5/8" CEILING BOARD 7/16" PLYWOOD SHEATHING TAPED & SANDED 2×4 STUDS @ 16" o.c. R13 BATT INSULATION 1/2" DRYWALL TYPICAL 2x4 WALL: TAPED & SANDED 1/2" DRYWALL TAPED & SANDED 2x4 STUDS @ 16" o.c. 1/2" DRYWALL TAPED & SANDED Top of Plate Top of Foundation Top of Footing SECTION SCALE: 1'= 1/4"

TYPICAL TRUSS ROOF:

7/16" ROOFING PLYWOOD c/w

SHINGLES


'H' CLIPS

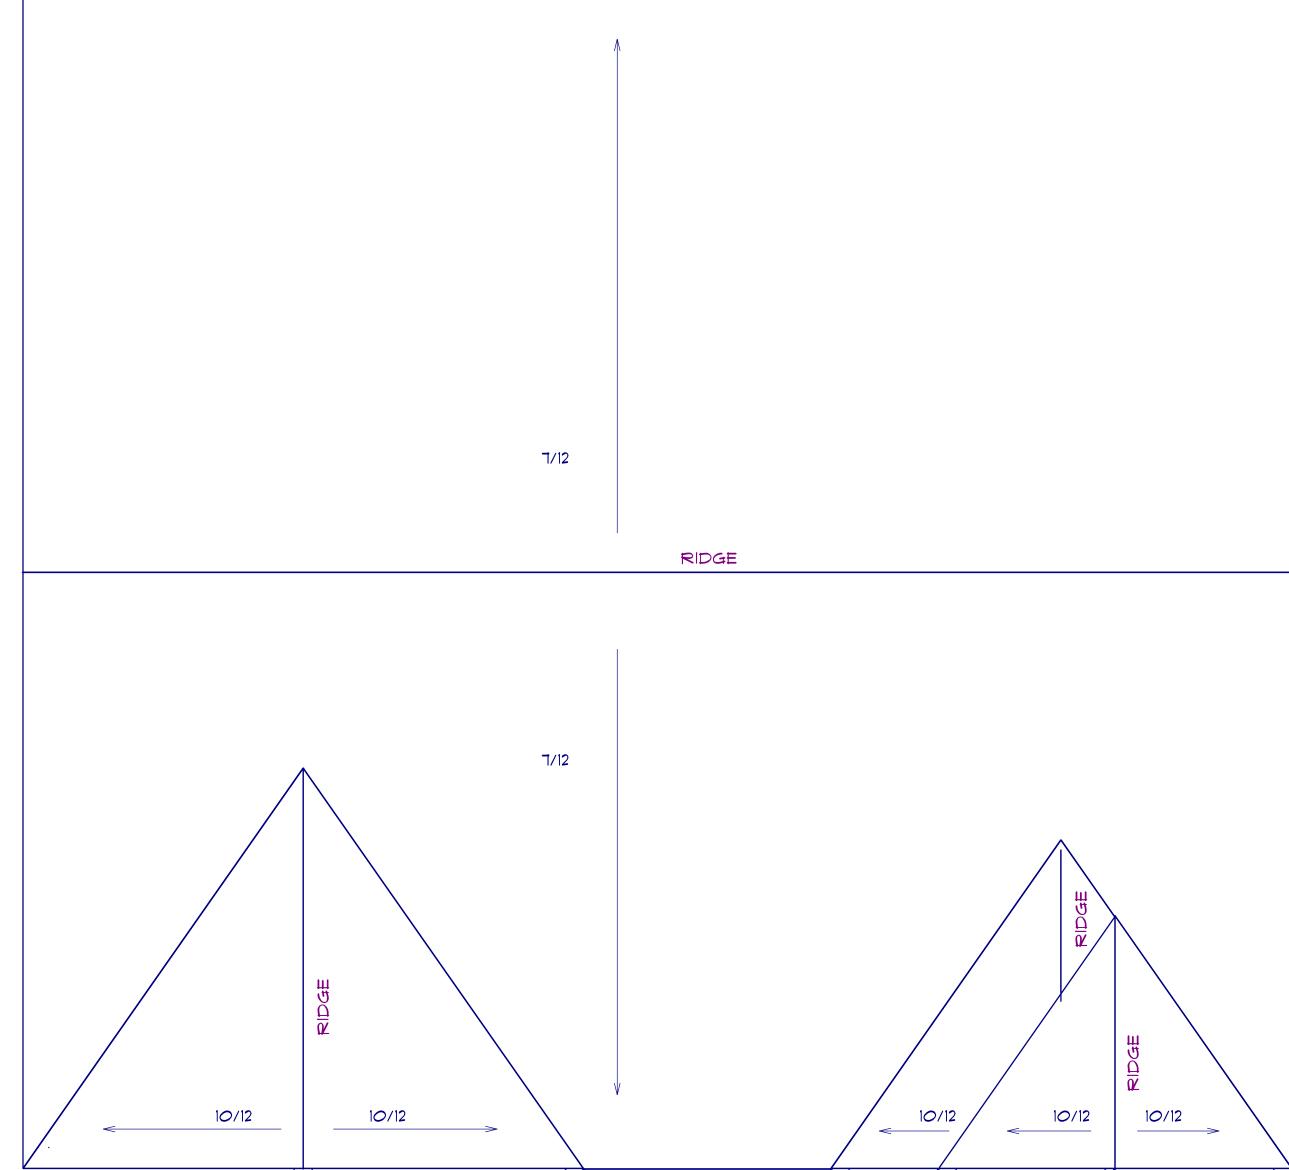

ROOF PLAN


SCALE: 1'= 1/4"


ELECTRICAL LEGEND				
ELECTRICAL	COUNT	SYMBOL		
ceiling fan 4 bladed 01	2			
foyer light	1			
10" led light	8			
7" led disc	13	•		
out door over head	4			
ceiling light 19				
4' fluorescent light				
outdoor carriage light	2	P		
flood light	2	<u>ap</u>		
vanity light	4	000		

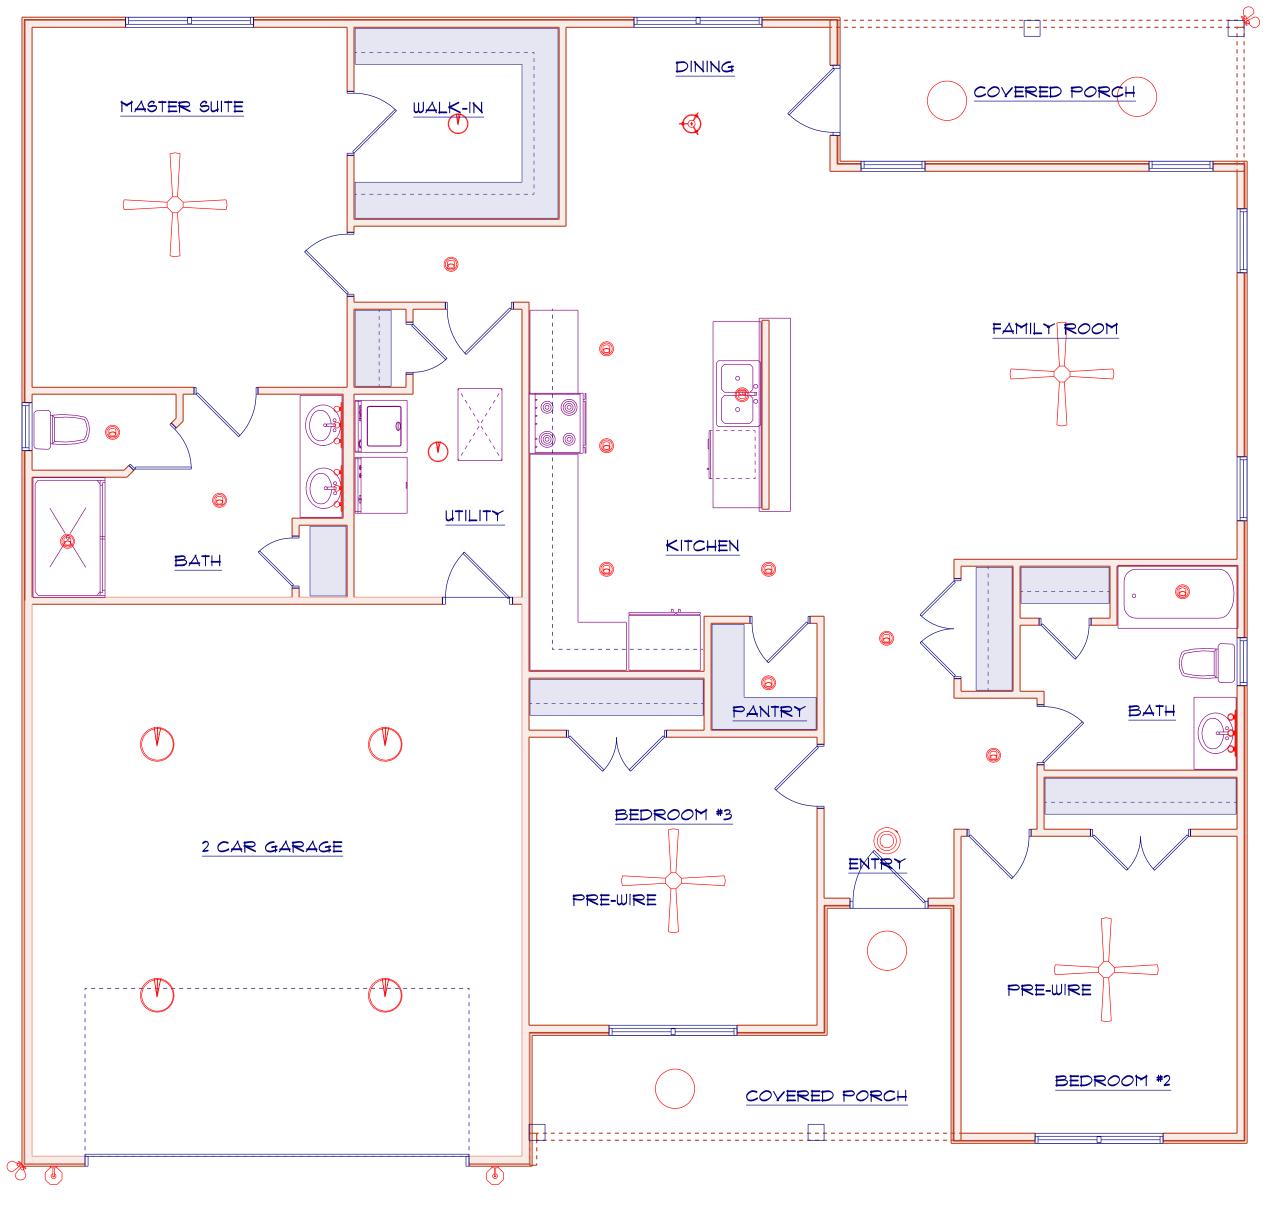

FLOOR PLAN

LAMCO CUSTOM BUILDERS/LAMCO HOMES RETAINS TITLE AND OWNERSHIP OF ALL PLANS. THESE PLANS CAN NOT BE COPIED OR REPRODUCED. THESE PLANS CAN NOT BE BUILT BY ANYONE OTHER THAN LAMCO CUSTOM BUILDERS/LAMCO HOMES

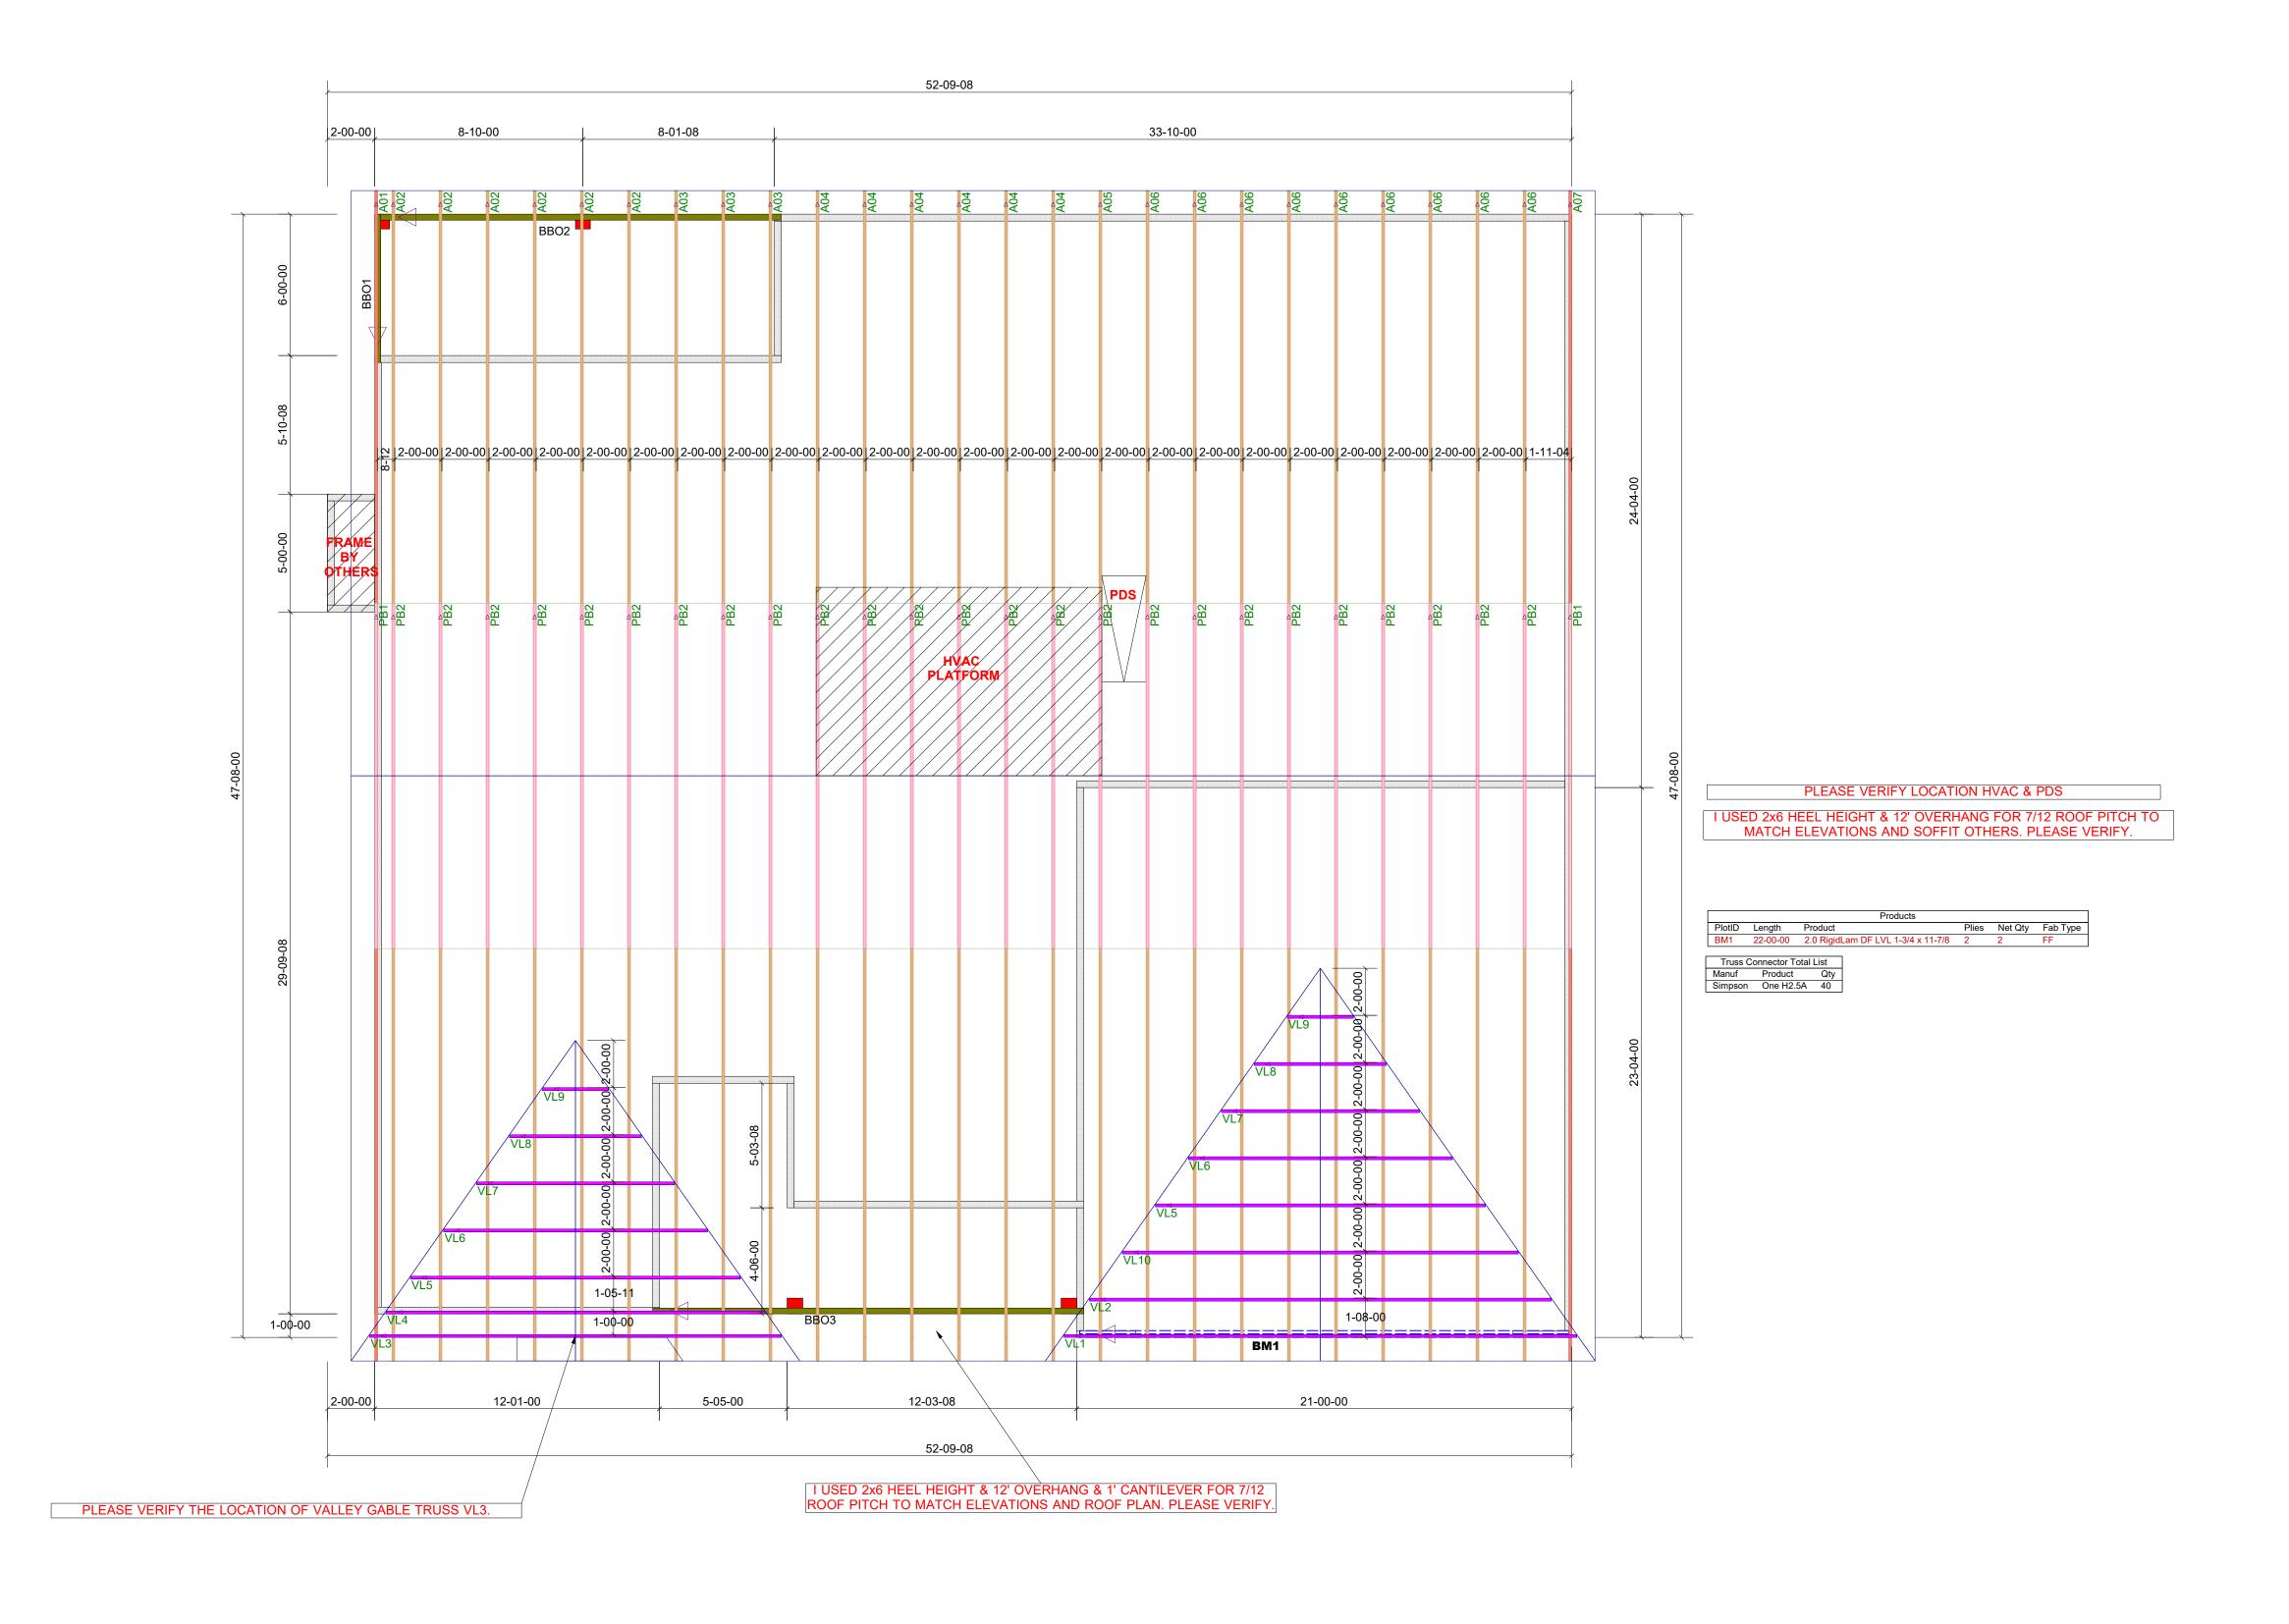

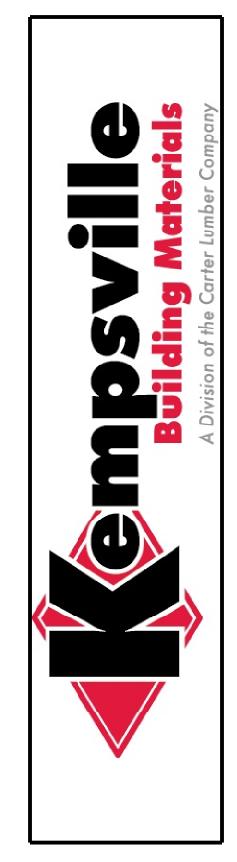

RUSS PLACEMENT PLAN

LAMCO

_				
	REVISIONS			
	DATE	BY		
	11-30-23	TH		

PROJECT NUMBER

23110135

SHEET NUMBER

ROOF TRUSS FRAMING
DRAWING SCALE : NTS