REVISION LOG

REVISION:001

- CHANGED OPT EXTENDED CAFE TO STANDARD
- CHANGED OF I. SERVINDE CAFE IN STANDARD
 ADDED 24" CHASE TO EXTENDED CAFE
 ADDED BEAD BOARD AND HOOKS TO DROP ZONE AREA
 BUMPED LOFT AND BEDROOM 3 OUT 24" TO LINE UP WITH FLOOR BELOW
 FLIPPED DOOR AT LAUNDRY CLOSET

- 5. FLIPPED DOOR AT LAUNDRY CLOSET
 6. CHANGED OWNER'S LINEN DOOR TO A 3/0 DOUBLE HINGE
 7. ALIGNED OWNER'S BATH DOOR WITH WIC ACROSS
 8. FLIPPED SEAT AT OPT. SHOWER
 9. ROOF AT REAR CHANGED PER BUMP OUT
 10. EXTENDED TRIM AT GARAGE DOOR DOWN TO BASE AND CUT BRICK/STONE BACK
 11. REMOVED HALF WALLS AT KITCHEN ISLAND AND UPDATED PER CABINET PROVIDER
 12. CHANGED ALL LINEN CLOSETS TO HAVE ONLY 4 SHELVES
 12. CHANGED THE BASE OWNER'S BATH WINDOW TO 4010

- 22. CHANGED THE DASE OWNER'S BATH MINUTU TO 4010
 24. CHANGED THE OWNER'S BATH OPTION SHOWER W/18" SEAT WINDOW TO 4010
 24. CHANGED THE OWNER'S BATH OPTION SUPER SHOWER WINDOWS TO (2)3010
 25. UPDATED THE FRENCH COUNTRY PORCH STONE COLUMNS
 26. EXTENDED FRENCH COUNTRY PORCH SLAB 4" AT FRONT AND EXTEND AROUND CORNER TO SUPPORT STONE VENEER

REVISION:002 DATE: 3/24/2022

- 1. ADD ELECTRICAL PLANS
 2. EXTEND 4" PORCH LEDGE ON SLAB FOUNDATION PAGE
 3. EXTEND 4" PORCH LEDGE ON FLOOR PLAN W/ NOTE "EXTEND PORCH SLAB 4"
 FROM FRAMING FOR STONE VENEER © SLAB FOUNDATION PORCH DOES NOT
 EXTEND WITH CRAWL OPTION".
 4. ADD 2030 WINDOWS IN THE POWDER & CLOSET/OPT. DELIVERY CENTER. CENTER
 INBETWEEN THE COLUMNS
 5. CHANGE PORCH BEAMS FROM 12" WIDE TO 8" WIDE.
 6. CHANGE PORCH WALLS TO 20"X20" FRAMED W/ STONE WRAP. ADJUST ELEVATIONS.
 7. ADD RAISED CELING © PORCH GABLE. ADD PLATE HT DIMENSION TO FRONT
 ELEVATION.

- ELEVATION.

 8. CENTER GABLE RIDGE WITH BEDROOM #2 WINDOW. ADJUST PORCH GABLE ACCORDINGLY. ADD DIMENSION ON ELEVATION.

 9. ADD 10" BAND AT GABLES ON FRONT ELEVATION

 10. DIM STONE WAINSCOTING HT

 11. SHOW CRAWL SPACE GRADE LINE 2'-6" BELOW FINISHED FLOOR

- 11. SHOW CRAWL SPACE GRADE LINE 2 6 BELOW FINISHED FLOOR
 12. INGERES WIDTH OF EXTERIOR STAIRS TO ALLOW FOR RAIL
 13. ADD NOTE "FURR OUT DOUBLE WALL UNDER FRONT PORCH CEILING." ON FLOOR PLANS AND ELEVATIONS
 14. ABOVE PORCH SHED ROOF, CUT OFF STONE AT COLUMN AND ADD SIDING BACK TO WALL.

REVISION:003

DATE: 6/20/2022

ADD SIDE LOAD GARAGE.

REVISION:004

- DATE: 7/22/2022
- ADD STEM WALL SLAB FOUNDATION SHEETS.
 ADD "STEM WALL" TO CRAWL ELEVATION TITLES AND ADD NOTE "SEE FOUNDATION PAGES FOR FOUNDATION TYPE". UPDATE SHEET TITLES

1-7-24 - Initial Redlines - JJ

166 DC - 212 Duncan Creek Rd., Lillington, NC 27546

Trademark Plus

NC.



DESIGN CRITERIA:

THIS PLAN IS TO BE BUILT IN CONFORMANCE WITH THE 2018 NORTH CAROLINA STATE BUILDING CODE: RESIDENTIAL CODE

DIMENSIONS SHALL GOVERN OVER SCALE, AND CODE SHALL GOVERN OVER DIMENSIONS.

PLAN 3 The Cary - RH 'FRENCH COUNTRY'

et No.	Sheet Description
0.0	Cover Sheet
1.1	Foundation (Slab)
.1.1	Foundation Options (Slab)
1.2	Foundation (Crawl)
.2.1	Foundation Options (Crawl)
1.3	Foundation (Stem Wall Slab))
.3.1	Foundation Options (Stem Wall Slab)
2.1	First Floor Plan
2.1.1	First Floor Plan Options
2.2	Second Floor Plan
2.2.1	Second Floor Plan Options
2.4	Covered Patio Plans & Elevations (Slab)
2.4.1	Covered Deck Plans & Elevations (Crawl/ Stem Wall)
2.5	2-Car Sideload Garage Plans
2.5.1	2-Car Sideload Garage Elevations
3.1	Front & Rear Elevations (Slab)
3.1.1	Front & Rear Elevations (Crawl/ Stem Wall)
3.2	Side Elevations (Slab)
3.2.1	Side Elevations (Crawl/ Stem Wall)
3.3	Roof Plan
5.1	First Floor Electrical Plan
5.1.1	First Floor Options Electrical Plan
5.2	Second Floor Electrical Plan
.2.1	Second Floor Options Electrical Plan

	'FRENCH COUN	TRY' ELEVATION						
	UNHEATED	HEATED						
FIRST FLOOR	0	1053						
SECOND FLOOR	0	1462						
FRONT PORCH	180	0						
REAR PATIO	144	0						
2 CAR GARAGE	403	0						
SUBTOTALS	727	2515						
TOTAL UNDER ROOF	32	42						
OPTIONS .								
	UNHEATED S.F.	HEATED S.F.						
COVERED PATIO	144	0						
EXTENDED PATIO	+120	0						




DATE	2/4/2022	3/24/2022	06/20/2022	07/22/2022				-
DESCRIPTION	REFER TO COVER SHEET	-	-	-	-			
REV.#	1	2	3	4	2	9	7	8

-RH Cover Sheet 'French Country' PLAN 3 - THE CARY

South Designs ISSUE DATE: URRENT REVISION DATE

1/8" = 1'-0"

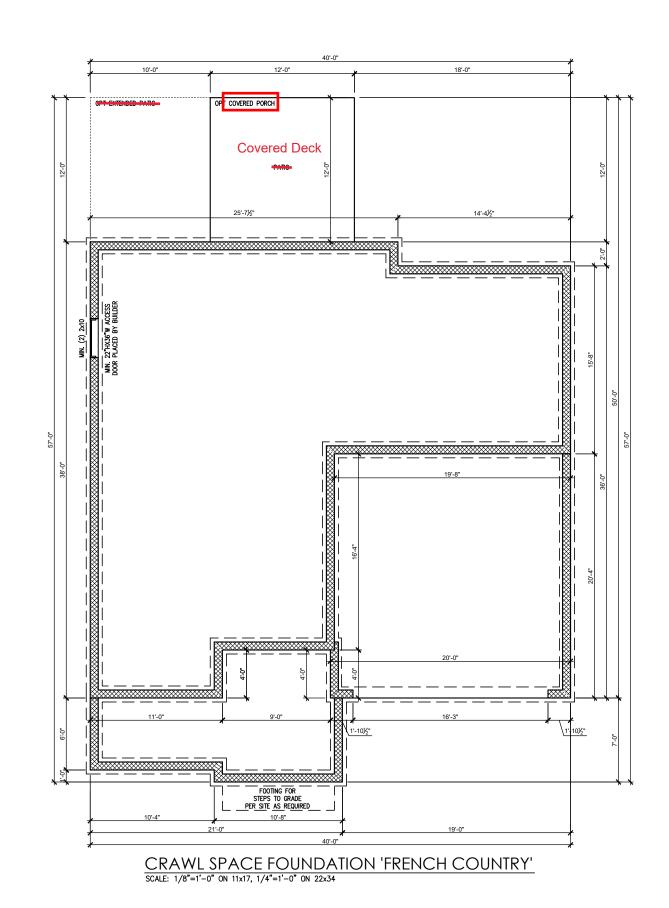



REV.#	DESCRIPTION	.PQ
1	REFER TO COVER SHEET	2/4/2
2	REFER TO COVER SHEET	3/24/
3	REFER TO COVER SHEET	06/20
4	REFER TO COVER SHEET	07/22
2		-
9	-	
7		-
8	-	

PLAN 3 - THE CARY - RH SINGLE FAMILY Crawl Foundation 'French Country'

> DRAWN BY: South Designs


ISSUE DATE: 07/01/2021

CURRENT REVISION DATE: 03/24/2022 SCALE: 1/8" = 1'-0"

1.2b

General Floor Plan Notes shall apply unless noted otherwise on plan.

- Wall Heights: Typically 9°-0" at first floor and 8°-0" at second floor and attics U.N.O. All walls are constructed using a double top plate. Splices at Double Top Plate do not need to occur at Vertical Studs but must be at least 24" apart from Joint in other Top Plate layer. Special wall heights are noted on plans where they occur.
- Wall Thickness is typically 3 1/2". 2x6 frame shall be used at walls that back up to plumbing fixtures.
 Walls greater than 10' high shall be framed with 2x6 framing or greater and will be noted as a special condition where it occurs on plan.
- Typical header height shall be 6'-11" AFF at First Floor, and 6'-11" AFF at Second Floor U.N.O. on elevation drawings. Windows at front elevation may be higher at the first floor.
- Jacks: Openings up to 3'-4" wide shall have (1) 2x4 jack stud SPF on each side. Openings greater than 3'-4" wide shall have (2) 2x4 jack studs SPF on each
- Soffits, Coffered Ceilings, Trey Ceilings and other significant ceiling plan elements are shown on the floor plans and are denoted as single dashed lines. Unless specifically call out as included, Kitchens do not include soffits over wall cabinetry.
- Door & Window Frames, where occurring near corners, shall be a minimum of 4 1/2" from corner. Except for walk-in closets with doors near a corner, doors at closets shall be centered on closet.
- Windows: Shall have at least (1) window in each sleeping room, that meets egress. Shall be provided with tempered glass of hazardous glazing areas. False windows shall be installed with obscure alazina.
- Closets for clothing or coat storage shall be equipped with 1 rod/shelf. Closets for linen shall have 4 open equal shelves. Closets for panties shall have 4 equal wood shelves, painted.
- Stair treads shall be a min of 9" deep, risers shall be a maximum of 8 1/4", unless noted otherwise, per the current North Carolina Residential Code
- 10. Handrails and Guards at stairs shall be 34" above the finished surface of the ramp surface of the stair. Handrails at landings and overlooks of multilevel spaces shall be 36" above finished floor. Guards (pickets or balusters) shall be spaced with no more than 4" between guards.
- 11.Attic Access shall be provided at all attic area with a height greater than 30". Minimum clear attic access shall be 20" x 30". Pull down stairs and access doors in knee walls meeting minimum criteria are also acceptable.
- 12.Garage Door to Living Space shall be 2'-8" x 6'-8" minimum size and shall be 20 minute fire rated and weather sealed.
- 13. Garage Walls, as a minimum, shall be separated from living space by installing 1/2" gypsum board on the garage side of the wall. With habitable space above, the inside of all garage walls require 1/2" GWB supporting 5/8" type X GWB on ceiling.

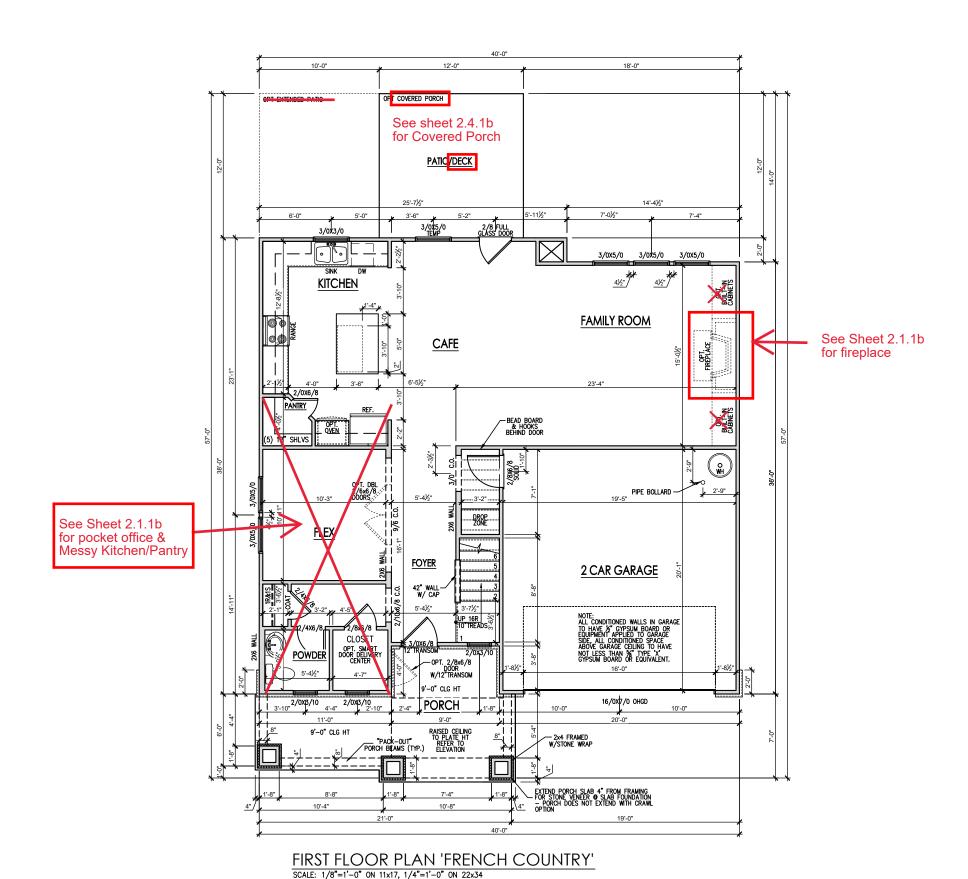

									ı
DATE	2/4/2022	3/24/2022	06/20/2022	07/22/2022					
DESCRIPTION	REFER TO COVER SHEET	-	_		_				
REV.#	٦	2	3	4	2	9	7	8	
									ĺ

PLAN 3 - THE CARY - RH SINGLE FAMILY First Floor Plan 'French Country'

> DRAWN BY: South Designs


ISSUE DATE: 07/01/2021


SURRENT REVISION DATE: 03/24/2022 SCALE: 1/8" = 1'-0"

2.1b

General Floor Plan Notes shall apply unless noted otherwise on plan.

- Wall Heights: Typically 9'-0" at first floor and 8'-0" at second floor and attics U.N.O. All walls are constructed using a double top plate. Splices at Double Top Plate do not need to occur at Vertical Studs but must be at least 24" opart from Joint in other Top Plate layer. Special wall heights are noted on plans where they occur.
- Wall Thickness is typically 3 1/2". 2x6 frame shall be used at walls that back up to plumbing fixtures.
 Walls greater than 10' high shall be framed with 2x6 framing or greater and will be noted as a special condition where it occurs on plan.
- Typical header height shall be 6-11" AFF at First Floor, and 6-11" AFF at Second Floor U.N.O. on elevation drawings. Windows at front elevation may be higher at the first floor.
- Jacks: Openings up to 3'-4" wide shall have (1) 2x4 jack stud SPF on each side. Openings greater than 3'-4" wide shall have (2) 2x4 jack studs SPF on each side.
- 5. Soffits, Coffered Ceilings, Trey Ceilings and other significant ceiling plan elements are shown on the floor plans and are denoted as single dashed lines. Unless specifically call out as included, Kitchens <u>do</u> <u>not</u> include soffits over wall cabinetry.
- Door & Window Frames, where occurring near corners, shall be a minimum of 4 1/2" from corner. Except for walk-in closets with doors near a corner, doors at closets shall be centered on closet.
- Windows: Shall have at least (1) window in each sleeping room, that meets egress. Shall be provided with tempered glass at hazardous glazing areas. False windows shall be installed with obscure glazing.
- Closets for clothing or coat storage shall be equipped with 1 rod/shelf. Closets for linen shall have 4 open equal shelves. Closets for pantries shall have 4 equal wood shelves, painted.
- Stair treads shall be a min of 9" deep, risers shall be a maximum of 8 1/4", unless noted otherwise, per the current North Carolina Residential Code
- 10. Handrails and Guards at stairs shall be 34" above the finished surface of the ramp surface of the stair. Handrails at landings and overlooks of multilevel spaces shall be 36" above finished floor. Guards (pickets or balusters) shall be spaced with no more than 4" between guards.
- 11.Attic Access shall be provided at all attic area with a height greater than 30". Minimum clear attic access shall be 20" x 30". Pull down stairs and access doors in knee walls meeting minimum criteria are also acceptable.
- 12.Garage Door to Living Space shall be 2'-8" x 6'-8" minimum size and shall be 20 minute fire rated and weather sealed.
- 13. Garage Walls, as a minimum, shall be separated from living space by installing 1/2" gypsum board on the garage side of the wall. With habitable space above, the inside of all garage walls require 1/2" GWB supporting 5/8" type X GWB on ceiling.

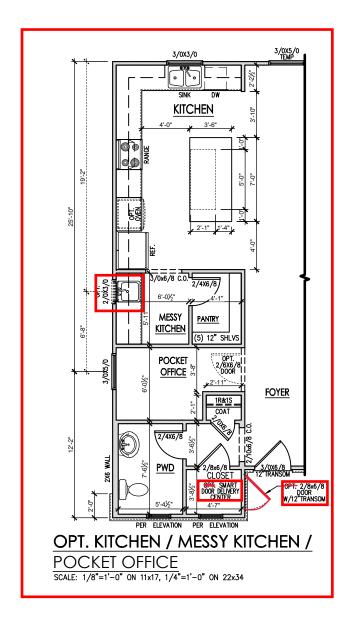

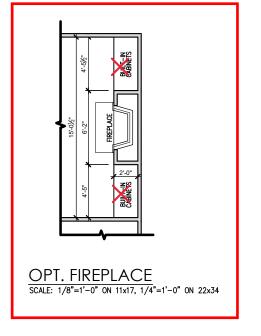



DATE	2/4/2022	3/24/2022	06/20/2022	07/22/2022				
DESCRIPTION	REFER TO COVER SHEET		-		1			
REV.#	1	2	3	4	5	9	7	8

PLAN 3 - THE CARY - RH
SINGLE FAMILY
First Floor Plan Options 'French Country'

DRAWN BY: South Designs


ISSUE DATE: 07/01/2021

CURRENT REVISION DATE: 03/24/2022 SCALE: 1/8" = 1'-0"

2.1.1b

General Floor Plan Notes shall apply unless noted otherwise on plan.

- Wall Heights: Typically 9'-0" at first floor and 8'-0" at second floor and attics U.N.O. All walls are constructed using a double top plate. Splices at Double Top Plate do not need to occur at Vertical Studs but must be at least 24" opart from Joint in other Top Plate layer. Special wall heights are noted on plans where they occur.
- Wall Thickness is typically 3 1/2". 2x6 frame shall be used at walls that back up to plumbing fixtures.
 Walls greater than 10' high shall be framed with 2x6 framing or greater and will be noted as a special condition where it occurs on plan.
- Typical header height shall be 6'-11" AFF at First Floor, and 6'-11" AFF at Second Floor U.N.O. on elevation drawings. Windows at front elevation may be higher at the first floor.
- Jacks: Openings up to 3'-4" wide shall have (1) 2x4 jack stud SPF on each side. Openings greater than 3'-4" wide shall have (2) 2x4 jack studs SPF on each side.
- Soffits, Coffered Ceilings, Trey Ceilings and other significant ceiling plan elements are shown on the floor plans and are denoted as single dashed lines. Unless specifically call out as included, Kitchens do not include soffits over wall cabinetry.
- Door & Window Frames, where occurring near corners, shall be a minimum of 4 1/2" from corner. Except for walk-in closets with doors near a corner, doors at closets shall be centered on closet.
- Windows: Shall have at least (1) window in each sleeping room, that meets egress. Shall be provided with tempered glass at hazardous glazing areas. False windows shall be installed with obscure glazing.
- Closets for clothing or coat storage shall be equipped with 1 rod/shelf. Closets for linen shall have 4 open equal shelves. Closets for pantries shall have 4 equal wood shelves, painted.
- Stair treads shall be a min of 9" deep, risers shall be a maximum of 8 1/4", unless noted otherwise, per the current North Carolina Residential Code
- 10. Handrails and Guards at stairs shall be 34" above the finished surface of the ramp surface of the stair. Handrails at landings and overlooks of multilevel spaces shall be 36" above finished floor. Guards (pickets or balusters) shall be spaced with no more than 4" between guards.
- 11.Attic Access shall be provided at all attic area with a height greater than 30". Minimum clear attic access shall be 20" x 30". Pull down stairs and access doors in knee walls meeting minimum criteria are also acceptable.
- 12.Garage Door to Living Space shall be 2'-8" x 6'-8" minimum size and shall be 20 minute fire rated and weather sealed.
- 13. Garage Walls, as a minimum, shall be separated from living space by installing 1/2" gypsum board on the garage side of the wall. With habitable space above, the inside of all garage walls require 1/2" GWB supporting 5/8" type X GWB on ceiling.

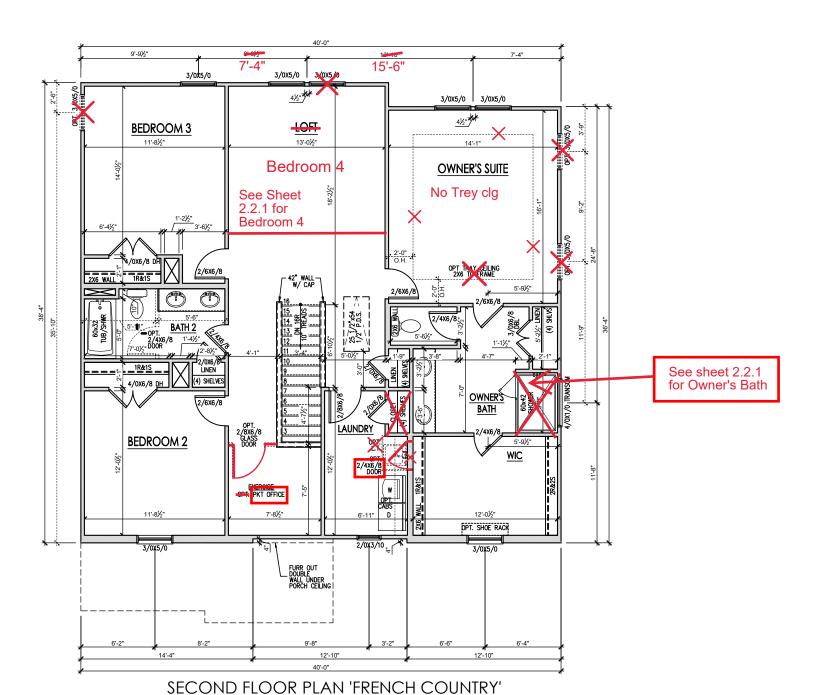

SCALE: 1/8"=1'-0" ON 11x17, 1/4"=1'-0" ON 22x34

ZNEW SHOME

DATE	2/4/2022	3/24/2022	06/20/2022	07/22/2022				!
DESCRIPTION	REFER TO COVER SHEET	-	-	1	-			
REV.#	٢	2	3	4	5	9	7	8

PLAN 3 - THE CARY - RH
SINGLE FAMILY
Second Floor Plan 'French Country'

DRAWN BY: South Designs


ISSUE DATE: 07/01/2021


CURRENT REVISION DATE: 03/24/2022 SCALE: 1/8" = 1'-0"

 $2.2^{\text{SHEET}}b$

General Floor Plan Notes shall apply unless noted otherwise on plan.

- Wall Heights: Typically 9°-0" at first floor and 8°-0" at second floor and attics U.N.O. All walls are constructed using a double top plate. Splices at Double Top Plate do not need to occur at Vertical Studs but must be at least 24" apart from Joint in other Top Plate layer. Special wall heights are noted on plans where they occur.
- Wall Thickness is typically 3 1/2". 2x6 frame shall be used at walls that back up to plumbing fixtures.
 Walls greater than 10' high shall be framed with 2x6 framing or greater and will be noted as a special condition where it occurs on plan.
- Typical header height shall be 6'-11" AFF at First Floor, and 6'-11" AFF at Second Floor U.N.O. on elevation drawings. Windows at front elevation may be higher at the first floor.
- Jacks: Openings up to 3'-4" wide shall have (1) 2x4 jack stud SPF on each side. Openings greater than 3'-4" wide shall have (2) 2x4 jack studs SPF on each side.
- Soffits, Coffered Ceilings, Trey Ceilings and other significant ceiling plan elements are shown on the floor plans and are denoted as single dashed lines. Unless specifically call out as included, Kitchens do not include soffits over wall cabinetry.
- Door & Window Frames, where occurring near corners, shall be a minimum of 4 1/2" from corner. Except for walk-in closets with doors near a corner, doors at closets shall be centered on closet.
- Windows: Shall have at least (1) window in each sleeping room, that meets egress. Shall be provided with tempered glass at hazardous glazing areas. False windows shall be installed with obscure glazing.
- Closets for clothing or coat storage shall be equipped with 1 rod/shelf. Closets for linen shall have 4 open equal shelves. Closets for pantries shall have 4 equal wood shelves, painted.
- Stair treads shall be a min of 9" deep, risers shall be a maximum of 8 1/4", unless noted otherwise, per the current North Carolina Residential Code
- 10. Handrails and Guards at stairs shall be 34" above the finished surface of the ramp surface of the stair. Handrails at landings and overlooks of multilevel spaces shall be 36" above finished floor. Guards (pickets or balusters) shall be spaced with no more than 4" between guards.
- 11. Attic Access shall be provided at all attic area with a height greater than 30". Minimum clear attic access shall be 20" x 30". Pull down stairs and access doors in knee walls meeting minimum criteria are also acceptable.
- 12.Garage Door to Living Space shall be 2'-8" x 6'-8" minimum size and shall be 20 minute fire rated and weather sealed.
- 13. Garage Walls, as a minimum, shall be separated from living space by installing 1/2" gypsum board on the garage side of the wall. With habitable space above, the inside of all garage walls require 1/2" GWB supporting 5/8" type X GWB on ceiling.

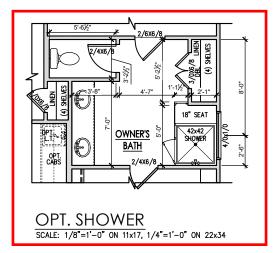

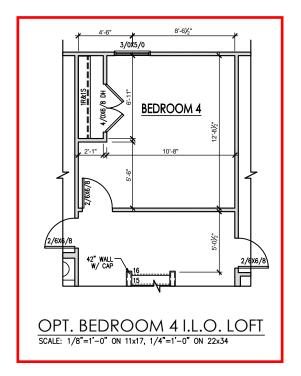



DATE	2/4/2022	3/24/2022	06/20/2022	07/22/2022				
DESCRIPTION	REFER TO COVER SHEET	amma .		-	ı			
REV.#	-	2	3	4	5	9	7	8


PLAN 3 - THE CARY - RH
SINGLE FAMILY
Second Floor Plan Options 'French
Country'

DRAWN BY: South Designs


ISSUE DATE: 07/01/2021 CURRENT REVISION DATE:


03/24/2022 SCALE: 1/8" = 1'-0"

2.2 1h

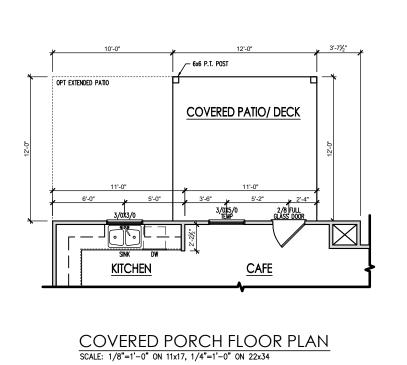

SEE FOUNDATION PAGES FOR FOUNDATION TYPE

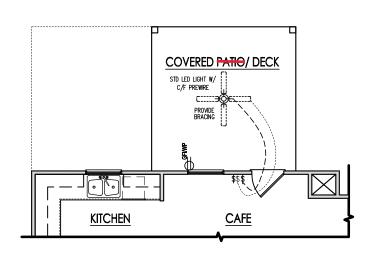

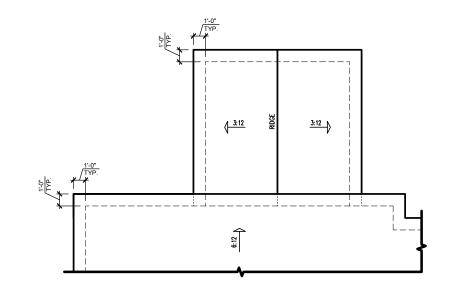


COVERED PORCH ELECTRICAL SCALE: 1/8"=1'-0" ON 11x17, 1/4"=1'-0" ON 22x34

COVERED PORCH ROOF PLAN SCALE: 1/8"=1'-0" ON 11x17, 1/4"=1'-0" ON 22x34

SEE FOUNDATION PAGES FOR FOUNDATION TYPE

Covered Porch Plans & Elev (Crawl or Stem Wall) French Country'

2.4.1b

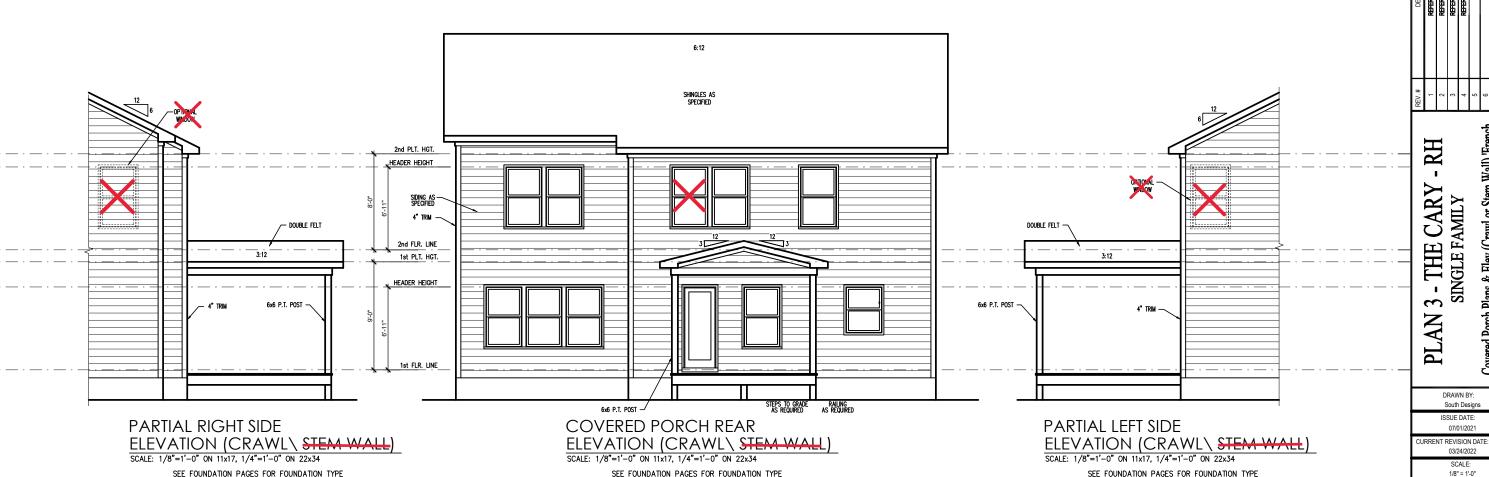

SEE FOUNDATION PAGES FOR FOUNDATION TYPE

General Elevation Notes


General Elevation Notes shall apply unless noted otherwise on plan.

- Roof shall be finished with architectural composition shingles with slopes as noted on plan.
- Ridge Vent shall be provided and installed on all ridges greater than 6' in length per manufacturer's specifications.
- 3. Soffit Vent shall be continuous soffit vent
- House Wrap, "tyvek" or approved equal shall be installed over entire exterior wall per manufacturer's specifications and recommendations.
- Flashing shall be provided above all door and window openings, above finish wall material changes and at wall surfaces where lower roof areas abut vertical wall surfaces.
- Porch Railings shall be provided at all porch walking surfaces greater than 30" above adjacent finished grade. It shall be 33" high with guards spaced no more than 4" apart. Consult community specifications for material.
- Finish Wall Material shall be as noted on elevation drawings.
- 8. Brick Veneer, if included on elevation shall be fled to wall surface with galvanized corrugated metal fles at a rate of 24" oc horizontally and 16" oc vertically so that no more than 2.67sf of brick is supported by (1) fle. Space between face of wall and back face of brick shall be limited to a maximum of 1". Flashing shall be provided behind brick above all wall openings and at base of brick wall. Flashing shall be a minimum of 6-mil poly or other corrosion resistant material and shall be installed so that it laps under the house wrap material an inimum of 2". Weepholes shall be provided at a rate of 48" oc and shall not be less than 3/16" in diameter and shall be located immediately above flashing.
- Brick Veneer Support Lintels shall be provided if brick veneer is included on elevation. Lintels shall be provided as listed in the following schedule and shall have a minimum bearing length of 6". Masonry Lintels shall be provided so that deflection is limited to L/600.

Masonry Opening Lintel Schedule

Opening Size Angle

up to 4'-1" 5'-7"	to to	5'-6" 6'-6"	3-1/2" x 3-1/2" x 5/16" 4" x 3-1/2" x 5/16" LLV 5" x 3-1/2" x 5/16" LLV
6'-7"	to	8'-4"	6" x 3-1/2" x 5/16" LLV
8'-5"	to	16'-4"	7" x 4" x 3/8" LLV

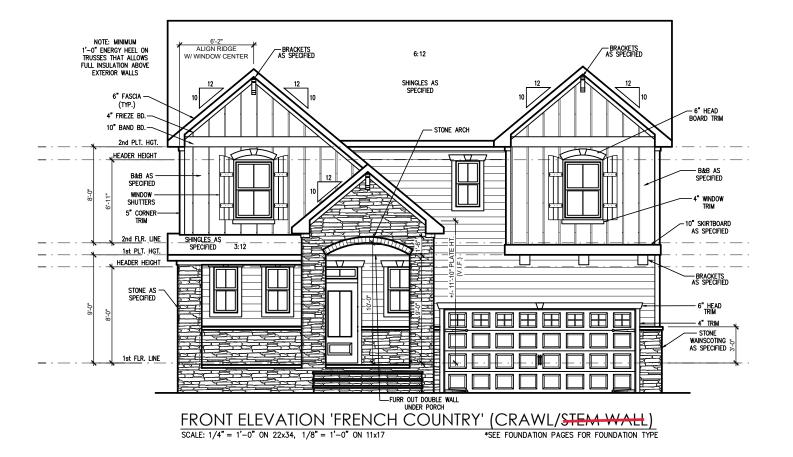

PLAN 3 - THE CARY - RH
SINGLE FAMILY
Front & Rear Elevations (Crawl or Stem
Wall) French Country'

DRAWN BY: South Designs

ISSUE DATE: 07/01/2021

CURRENT REVISION DATE: 03/24/2022 SCALE: 1/8" = 1'-0"

3.1.1b

General Elevation Notes


General Elevation Notes shall apply unless noted otherwise on plan.


- Roof shall be finished with architectural composition shingles with slopes as noted on plan.
- Ridge Vent shall be provided and installed on all ridges greater than 6' in length per manufacturer's specifications.
- 3. Soffit Vent shall be continuous soffit vent
- House Wrap, "tyvek" or approved equal shall be installed over entire exterior wall per manufacturer's specifications and recommendations.
- Flashing shall be provided above all door and window openings, above finish wall material changes and at wall surfaces where lower roof areas abut vertical wall surfaces.
- Porch Railings shall be provided at all porch walking surfaces greater than 30" above adjacent finished grade. It shall be 36" high with guards spaced no more than 4" apart. Consult community specifications for material
- Finish Wall Material shall be as noted on elevation drawings.
- 8. Brick Veneer, if included on elevation shall be fied to wall surface with galvanized corrugated metal fies at a rate of 24" oc horizontally and 15" oc vertically so that no more than 2.67sf of brick is supported by (1) fie. Space between face of wall and back face of brick shall be limited to a maximum of 1". Flashing shall be provided behind brick above all wall openings and at base of brick wall. Flashing shall be a minimum of 6-mil poly or other corrosion resistant material and shall be installed so that it laps under the house wrap material a minimum of 2". Weepholes shall be provided at a rate of 48" oc and shall not be less than 3/16" in diameter and shall be located immediately above flashing.
- Brick Veneer Support Lintels shall be provided if brick veneer is included on elevation. Untels shall be provided as listed in the following schedule and shall have a minimum bearing length of 6". Masonry Lintels shall be provided so that deflection is limited to L/600.

Masonry Opening Lintel Schedule

ening Size Angle

up to 4'-0" 3-1/2" x 3-1/2" x 5/16" 4'-1" to 5'-6" 4" x 3-1/2" x 5/16" LLV 5'-7" to 6'-6" 5" x 3-1/2" x 5/16" LLV 8'-5" to 16'-4" 7" x 4" x 3/6" LLV

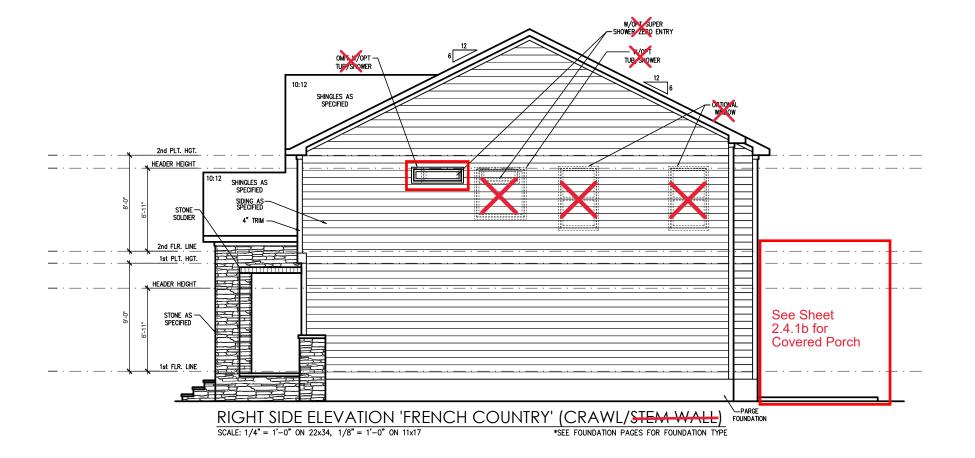

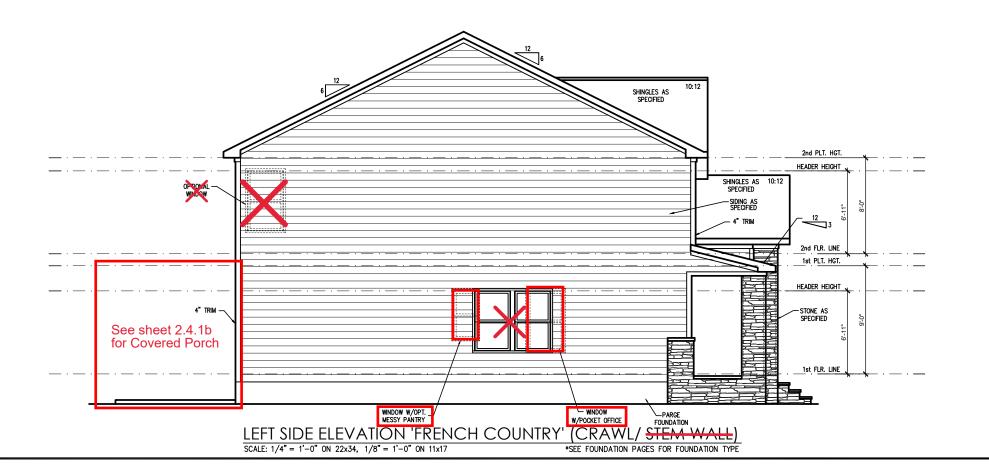




PLAN 3 - THE CARY - RH
SINGLE FAMILY
Side Elevations (Crawl or Stem Wall)
'French Country'

DRAWN BY: South Designs ISSUE DATE:

07/01/2021 CURRENT REVISION DATE: 03/24/2022

SCALE: 1/8" = 1'-0"

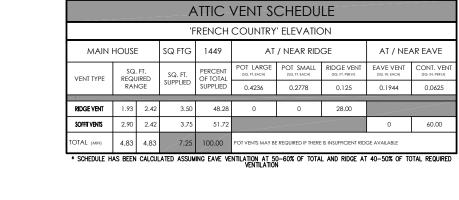

See Sheet 2.4.1b for Covered Porch roof 6:12 28 LF RIDGE VENT 10:12 10:12 10:12 10:12 10:12 10:12 'FRENCH COUNTRY' ELEVATION ROOF PLAN SCALE: 1/4" = 1'-0" ON 22x34, 1/8" = 1'-0" ON 11x17

PLAN 3 - THE CARY - RH SINGLE FAMILY Roof Plan 'French Country'

DRAWN BY: South Designs

ISSUE DATE: 07/01/2021

CURRENT REVISION DATE: 03/24/2022 SCALE: 1/8" = 1'-0"

3.3b

CRAWL SPACE FOUNDATION 'FRENCH COUNTRY'

SCALE: 1/8"=1'-0" ON 11x17, 1/4"=1'-0" ON 22x34

TRUSS SYSTEM REQUIREMENTS NC (2018 NCRC): Wind: 115-120 mph

- TRUSS SYSTEM LAYOUTS (PLACEMENT PLANS) SHALL BE DESIGNED IN ACCORDANCE WITH SEALED STRUCTURAL PLANS. ANY NEED TO CHANGE TRUSSES SHALL BE COORDINATED WITH SOUTHERN ENGINEERS.
- TRUSS SCHEMATICS (PROFILES) SHALL BE PREPARED AND SEALED BY TRUSS MANUFACTURER.
- ALL TRUSSES SHALL BE DESIGNED FOR BEARING ON SPF #2 OR #3 PLATES OR LEDGERS (UNO).
- ALL REQUIRED ANCHORS FOR TRUSSES DUE TO UPLIFT OR BEARING SHALL MEET THE REQUIREMENTS AS SPECIFIED ON THE TRUSS SCHEMATICS.

FOUNDATION STRUCTURAL NOTES NC (2018 NCRC): Wind: 115-120 mph - CRAWL

- (3)2xIO SYP#2 OR SPF#2 GIRDER, TYPICAL UNO.
- CONCRETE BLOCK PIER SIZE SHALL BE: HOLLOW UP TO 32" <u>SOLID</u> UP TO 5'-0" 8xl6 JP TO 64" UP TO 12'-0" UP TO 96" 24x24
- WITH 30" × 30" × 10" CONCRETE FOOTING, UNO
- 3 WALL FOOTING AS FOLLOWS 8" - UP TO 2 STORY IO" - 3 STORY DEPTH:

16" - UP TO 2 STORY SIDING: 20" - 3 STORY BRICK: 16" - I STORY 20" - 2 STORY 24" - 3 STORY

- FOR FOUNDATION WALL HEIGHT AND BACKFILL REQUIREMENTS, REFER TO CODE TABLE R404.LL (I THRU 4) NOTE: ASSUMED SOIL BEARING CAPACITY = 2000 PSF. CONTRACTOR MUST VERIFY SITE CONDITIONS AND CONTACT SOILS ENGINEER IF MARGINAL OR UNSTABLE SOILS ARE ENCOUNTERED
- (4) 2xIO SPF #2 OR SYP #2 GIRDER
- (2) 1.75x4.25 LVL OR LSL GIRDER
- (3) 1.75x9.25 LVL OR LSL GIRDER
- "■" DESIGNATES A SIGNIFICANT POINT LOAD TO HAVE SOLID BLOCKING TO PIER. SOLID BLOCK ALL BEAM BEARING POINTS NOTED TO HAVE THREE OR MORE STUDS TO FND, TYPICAL.
- ABBREVIATIONS:
- "SJ" = SINGLE JOIST "DJ" = DOUBLE JOIST
- "TJ" = TRIPLE JOIST
- ADJUST SUBFLOOR THICKNESS OR JOIST SPACING AS REQ'D FOR FLOOR FINISH MATERIALS.

MOOD I-JOISTS

- (SHALL BE ONE OF THE FOLLOWING):

 TJI 210 BY TRUS JOIST
- LPL 20 PLUS BY LP BCI 5000s I.8 BY BC
- ALL WOOD I-JOISTS SHALL BE INSTALLED ACCORDING TO MANUFACTURER'S SPECIFICATIONS.
- INSTALL SQUASH BLOCKS, WEB STIFFENERS, ETC. AS REQUIRED BY AND ACCORDING TO THE I-JOIST MANUFACTURER'S SPECIFICATIONS AND
- HANGERS FOR I-JOISTS ARE THE RESPONSIBILITY OF THE I-JOIST SUPPLIER.
- FLOOR TRUSSES BY THE MANUFACTURER MAY BE SUBSTITUTED FOR I-JOISTS.

PROJECT # 21-2867-RH

P.A. 27609 Engineers, Drive, Raleigh, NC ; et. (919) 878-1617

Southern Engi HOME,

NEW

RH Carv The 3 Plan

REFER TO "SD" SHEET(S) FOR STANDARD DETAILS BRACING DETAILS AND STRUCTURAL NOTES.

CAROLLA SEAL 33153

19-8'

"" CONC. SLAB (TABLE R402.2)

WITH FIBERMESH OR WIR MESH
ON 6 MIL VAPOR RET PROPER
(AS DECOT) ON BASE COURSE
(R50-0.2). SEE R506.2.1 FOR
FILL REQUIR MENTS.

IIIA
SD
IST INIDE
X IO DEEP
CG NC. FTG.

20-0"

OPT. SIDE LOAD GARAGE CRAWL FOUNDATION PLAN SCALE: 1/8"=1'-0" ON 11x17, 1/4"=1'-0" ON 22x34

6"x6" P.T. POST ON— 24"x24"x8" CONC. FTG. (TYP). BRACE POSTS PER APPENDIX 'M' 6'-0" TRT'D 7 (2) 2xIC $\langle 4 \rangle$ 4"xI6" MASONR` PIER ON A 38"x30"xI0" CONC. FTG. OPT. MESSY KITCHEN CRAWL SLAB FOUNDATION PLAN SCALE: 1/8"=1'-0" ON 11x17, 1/4"=1'-0" ON 22x34

NEW HOME, INC.


Southern Engineers, P.A.
3716 Benson Drive, Raleigh, NC 27609
Phone: (919) 878-1617
License: C-4772
www.southernengineers.com

PROJECT # 21-2867-RH

Plan 3 The Cary - RH

S-1.2.1

REFER TO "5D" SHEET(S) FOR STANDARD DETAILS, BRACING DETAILS AND STRUCTURAL NOTES.

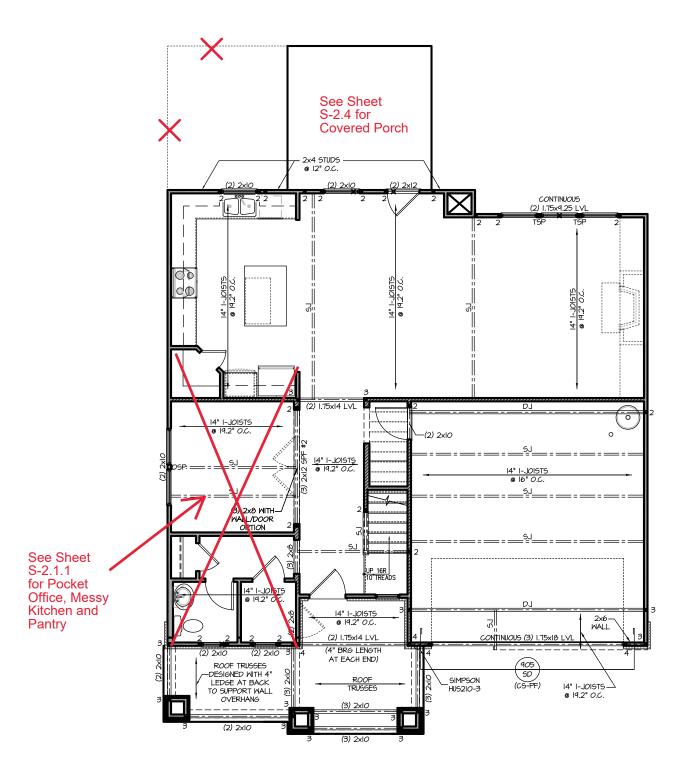

FIRST FLOOR PLAN 'FRENCH COUNTRY'

SCALE: 1/8"=1'-0" ON 11x17, 1/4"=1'-0" ON 22x34



TRUSS SYSTEM REQUIREMENTS

NC (2018 NCRC): Wind: 115-120 mph

- TRUSS SYSTEM LAYOUTS (PLACEMENT PLANS) SHALL BE DESIGNED IN ACCORDANCE WITH SEALED STRUCTURAL PLANS. ANY NEED TO CHANGE TRUSSES SHALL BE COORDINATED WITH SOUTHERN ENGINEERS.
- TRUSS SCHEMATICS (PROFILES) SHALL BE PREPARED AND SEALED BY TRUSS MANUFACTURER.
- ALL TRUSSES SHALL BE DESIGNED FOR BEARING ON SPF #2 OR #3 PLATES OR LEDGERS (UNO).
- ALL REQUIRED ANCHORS FOR TRUSSES DUE TO UPLIFT OR BEARING SHALL MEET THE REQUIREMENTS AS SPECIFIED ON THE TRUSS SCHEMATICS.

HEADER/BEAM & COLUMN NOTES

- ALL EXTERIOR AND LOAD BEARING HEADERS SHALL BE MIN. (2)2x6 (4" WALL) OR (3)2x6 (6" WALL) WITH (1) SUPPORT STUD, UNLESS NOTED OTHERWISE.
- 2. THE NUMBER SHOWN AT BEAM AND HEADER SUPPORTS INDICATES THE NUMBER OF SUPPORT STUDS REQUIRED IN STUD POCKET OR COLUMN. THE NUMBER OF KING
 STUDS AT EACH END OF HEADERS IN EXTERIOR WALLS
 SHALL BE ACCORDING TO ITEM "d" IN TABLE R602.3(5) OR AS BELOW PER NCDOI COMMENTARY "KING STUDS AT WALL OPENINGS" REVISED 1-9-2020:
- UP TO 3' SPAN: (I) KING STUD OVER 3' UP TO 6' SPAN: (2) KING STUDS
- OVER 6' UP TO 9' SPAN: (3) KING STUDS OVER 9' UP TO 12' SPAN: (4) KING STUDS
- OVER 12' UP TO 15' SPAN: (5) KING STUDS

MOOD I-JOISTS

(SHALL BE ONE OF THE FOLLOWING):

• TJI 210 BY TRUS JOIST

- I PL 20 PLUS BY LP
- BCI 5000s I.8 BY BC
- ALL WOOD I-JOISTS SHALL BE INSTALLED ACCORDING TO MANUFACTURER'S SPECIFICATIONS.
- INSTALL SQUASH BLOCKS, WEB STIFFENERS, ETC. AS REQUIRED BY AND ACCORDING TO THE I-JOIST MANUFACTURER'S SPECIFICATIONS AND
- HANGERS FOR I-JOISTS ARE THE RESPONSIBILITY OF THE I-JOIST SUPPLIER.
- FLOOR TRUSSES BY THE MANUFACTURER MAY BE SUBSTITUTED FOR I-JOISTS.

PORCH POST NOTES:

- POST CAP AT CORNER: (2) SIMPSON LCE4 (MITER HEADER AT CORNER). HIGH WIND; ADD (1) SIMPSON H6.
- 3. POST BASE: SIMPSON ABU44 (ABU66).
- MONO: 5%" ANCHOR (EMBED 1")

 CMU: 5%" ANCHOR (EXTEND TO FOOTING HIGH WIND ONLY)
- AT POSTS. EXTEND 12" ONTO EACH POST (UPPER AND LOWER) OR TO GIRDER.
- NOTE: EQUIVALENT POST CAP AND BASE ACCEPTABLE.

FRAMING NOTES

NC (2018 NCRC): Wind: 115-120 mph

- I. BRACING METHOD AND TYPE: CONTINUOUSLY SHEATHED MSP: C5-MSP. NOTE THAT THE WALL BRACING AMOUNT PROVIDED ON THE PLANS (DETAILS AND SPECIFICATIONS) IS GREATER THAN THE AMOUNT OF WALL BRACING REQUIRED BY SECTION R602.10 OF THE CODE. SEE NOTES BELOW FOR DETAILS AND SPECIFICATIONS FOR WALL BRACING AND WALL FRAMING
- 2. EXTERIOR WALL SHEATHING: WALLS SHALL BE BRACED BY SHEATHING WALLS ON ALL STORIES WITH WOOD STRUCTURAL PANEL SHEATHING (MSP) (EXPOSURE B: 7/16". EXPOSURE C: 15/32"), SHEATHING SHALL BE ATTACHED WITH 8d NAILS AT A 6"//2" NAILING PATTERN (6" OC AT PANEL EDGES AND 12" OC AT INTERMEDIATE SUPPORTS), INSTALL BLOCKING AT ALL PANEL EDGES.
- 3. WSP SHEATHING SHALL EXTEND TO THE UPPERMOST DOUBLE BEARING PLATE. BLOCK AT ROOF PER SECTION R602.10.45 AND ATTACH BRACED WALLS PER CODE. WSP SHEATHING BETWEEN FLOORS SHALL BE SPLICED ALONG CONTINUOUS BAND OR THE WSP SHEATHING MAY BE SPLICED ACROSS STUDS (CONTINUOUS ACROSS FLOOR SYSTEM) WITH BLOCKING AT PANEL EDGES. (MINIMUM 12" BEYOND FLOOR BREAK) OR OTHER APPROVED METHOD.
- 4. "HD" = HOLDOMN: HOLD-DOWN DEVICE (NOTED AS "HD" ON PLANS) SHALL BE AN 800 POUND CAPACITY ASSEMBLY AS NOTED ON PLANS. SEE DETAILS FOR HD ASSEMBLY.
- ASSEMBLT: OR EQUIV.)

 ***UPER FLOORS.*

 **UPER FLOORS.*

 **THER HOORS.*

 ***UPER FLOORS.*

 **UPER FLOORS.*

 ***UPER FLOORS.*

 **UPER FLOORS.*

 ***UPER FLOOR
- 5. INTERIOR BRACED WALL: (NOTED AS "IBW" ON PLANS) ATTACH I/2" GYPSUM BOARD (GB) ON EACH SIDE OF WALL WITH A MIN. OF 5d COOLER NAILS OR #6 SCREWS ◎ 7" O.C. ALONG THE EDGES AND AT INTERMEDIATE SUPPORTS
- INTERIOR BRACED WALL-WOOD STRUCTURAL PANEL; (NOTED AS "IBW-WSP" ON PLANS). ATTACH ONE SIDE WITH 1%" WSP SHEATHING WITH 8d NAILS AT A 6"/12" NAILING PATTERN (6" OC AT PANEL EDGES AND 12" OC AT INTERMEDIATE SUPPORTS), INSTALL BLOCKING AT ALL PANEL EDGES, ATTACH GB OVER WSP AS REQUIRED, ATTACH OPPOSITE SIDE WITH I/2" GB WITH A MIN, OF 5d COOLER NAILS OR #6 SCREWS @ 7" OC ALONG THE EDGES AND AT INTERMEDIATE SUPPORTS.

- 4"x4" (6"x6") TRT'D POST (OR EQUAL). ATTACH TRUSSES (RAFTERS) AT PORCH WITH HURRICANE CONNECTORS.

 POST CAP: SIMPSON AC4-MAX (AC6-MAX)

- 3.I. 3.2.
- POST BASE: WOOD FOUNDATION: (2) SIMPSON CSI6 STRAPS

HOME, NEW

PROJECT # 21-2867-RH

e to be brought to the Failure to do so will

docu Seal (Seque Any (imme void (Use o

P.A. 27609

Engineers, Drive, Raleigh, NC : e: (919) 878-1617


Southern Engi 3716 Benson Drive, Ra Phone: (919) 8

R C_{2} The 3 Plan

REFER TO "SD" SHEET(S) FOR STANDARD DETAILS BRACING DETAILS AND STRUCTURAL NOTES.



OPT. FIREPLACE
SCALE: 1/8"=1'-0" ON 11x17, 1/4"=1'-0" ON 22x34

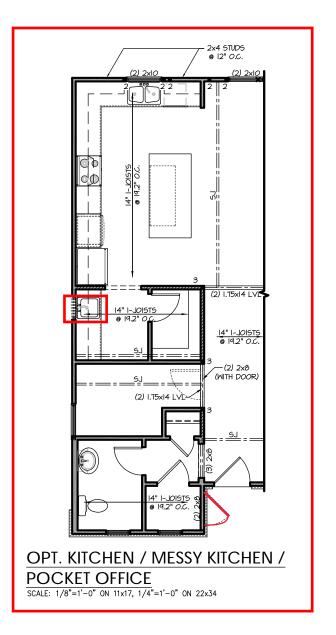

Southern Engineers, P.A. 3716 Benson Drive, Raleigh, NC 27609 Phone: (919) 878-1617 License: C-4772 www.southernengineers.com

PROJECT # 21-2867-RH

NEW HOME, INC.

-RH Plan 3 The Cary



TRUSS SYSTEM REQUIREMENTS NC (2018 NCRC): Wind: 115-120 mph

- TRUSS SYSTEM LAYOUTS (PLACEMENT PLANS) SHALL BE DESIGNED IN ACCORDANCE WITH SEALED STRUCTURAL PLANS. ANY NEED TO CHANGE TRUSSES SHALL BE COORDINATED WITH SOUTHERN ENGINEERS.
- TRUSS SCHEMATICS (PROFILES) SHALL BE PREPARED AND SEALED BY TRUSS MANUFACTURER.
- ALL TRUSSES SHALL BE DESIGNED FOR BEARING ON SPF #2 OR #3 PLATES OR LEDGERS (UNO).
- ALL REQUIRED ANCHORS FOR TRUSSES DUE TO UPLIFT OR BEARING SHALL MEET THE REQUIREMENTS AS SPECIFIED ON THE TRUSS SCHEMATICS.

HEADER/BEAM & COLUMN NOTES

- ALL EXTERIOR AND LOAD BEARING HEADERS SHALL BE MIN. (2)2x6 (4" WALL) OR (3)2x6 (6" WALL) WITH (1) SUPPORT STUD, UNLESS NOTED OTHERWISE.
- 2. THE NUMBER SHOWN AT BEAM AND HEADER SUPPORTS INDICATES THE NUMBER OF SUPPORT STUDS REQUIRED IN STUD POCKET OR COLUMN. THE NUMBER OF KING STUDS AT EACH END OF HEADERS IN EXTERIOR WALLS SHALL BE ACCORDING TO ITEM "d" IN TABLE R602.3(5) OR AS BELOW PER NCDOI COMMENTARY "KING STUDS AT WALL OPENINGS" REVISED I-9-2020:
- UP TO 3' SPAN: (I) KING STUD OVER 3' UP TO 6' SPAN: (2) KING STUDS
- OVER 6' UP TO 9' SPAN: (3) KING STUDS
- OVER 9' UP TO 12' SPAN: (4) KING STUDS OVER 12' UP TO 15' SPAN: (5) KING STUDS

FRAMING NOTES

NC (2018 NCRC): Wind: 115-120 mph

- BRACING METHOD AND TYPE: CONTINUOUSLY SHEATHED W6P; CS-W5P, NOTE THAT THE WALL BRACING AMOUNT PROVIDED ON THE PLANS (DETAILS AND SPECIFICATIONS) IS GREATER THAN THE AMOUNT OF WALL BRACING REQUIRED BY SECTION R602.10 OF THE CODE. SEE NOTES BELOW FOR DETAILS AND SPECIFICATIONS FOR WALL BRACING AND WALL FRAMING
- EXTERIOR WALL SHEATHING: WALLS SHALL BE BRACED BY SHEATHING WALLS ON ALL STORIES WITH WOOD STRUCTURAL PANEL SHEATHING (MSP) (EXPOSURE B: 7/16". EXPOSURE C: 15/32"), SHEATHING SHALL BE ATTACHED WITH 8d NAILS AT A 6"//2" NAILING PATTERN (6" OC AT PANEL EDGES AND 12" OC AT INTERMEDIATE SUPPORTS). INSTALL BLOCKING AT ALL PANEL EDGES.
- 3. WSP SHEATHING SHALL EXTEND TO THE UPPERMOST DOUBLE BEARING PLATE. BLOCK AT ROOF PER SECTION R602.10.45 AND ATTACH BRACED WALLS PER CODE. WSP SHEATHING BETWEEN FLOORS SHALL BE SPLICED ALONG CONTINUOUS BAND OR THE WSP SHEATHING MAY BE SPLICED ACROSS STUDS (CONTINUOUS ACROSS FLOOR SYSTEM) WITH BLOCKING AT PANEL EDGES. (MINIMUM 12" BEYOND FLOOR BREAK) OR OTHER APPROVED METHOD.
- 4. "HD" = HOLDOMN: HOLD-DOWN DEVICE (NOTED AS "HD" ON PLANS) SHALL BE AN 800 POUND CAPACITY ASSEMBLY AS NOTED ON PLANS. SEE DETAILS FOR HD ASSEMBLY.
- ASSEMBLT: OR EQUIV.)

 ***UPER FLOORS.*

 **UPER FLOORS.*

 **THER HOORS.*

 ***UPER FLOORS.*

 **UPER FLOORS.*

 ***UPER FLOORS.*

 **UPER FLOORS.*

 ***UPER FLOOR
- 5. INTERIOR BRACED WALL: (NOTED AS "IBM" ON PLANS) ATTACH I/2" GYPSUM BOARD (GB) ON EACH SIDE OF WALL WITH A MIN. OF 5d COOLER NAILS OR #6 SCREWS @ 7" O.C. ALONG THE EDGES AND AT INTERMEDIATE SUPPORTS.
- INTERIOR BRACED WALL-WOOD STRUCTURAL PANEL: (NOTED AS "IBW-WSP" ON PLANS). ATTACH ONE SIDE WITH 1%" WSP SHEATHING WITH 8d NAILS AT A 6"/12" NAILING PATTERN (6" OC AT PANEL EDGES AND 12" OC AT INTERMEDIATE SUPPORTS). INSTALL BLOCKING AT ALL PANEL EDGES, ATTACH GB OVER WSP AS REQUIRED. ATTACH OPPOSITE SIDE WITH I/2" GB WITH A MIN. OF 5d COOLER NAILS OR #6 SCREWS @ 7" OC ALONG THE EDGES AND AT INTERMEDIATE SUPPORTS.



PROJECT # 21-2867-RH

e to be brought to the Failure to do so will

P.A. 27609

Engineers, Drive, Raleigh, NC Southern Engi

> HOME, NEW

RH S The 3 Plan

REFER TO "SD" SHEET(S) FOR STANDARD DETAILS BRACING DETAILS AND STRUCTURAL NOTES.

OPT. TUB/SHOWER
SCILE: 1/8"=1'-0" ON 11x17, 1/4"=1'-0" ON 22x34



NO STRUCTURAL CHANGES FROM BASE PLAN






Southern Engineers, P.A. 3716 Benson Drive, Raleigh, NC 27609 Phone: (919) 878-1617 License: C-4772 www.southernengineers.com

NEW HOME, INC.

-RH Plan 3 The Cary

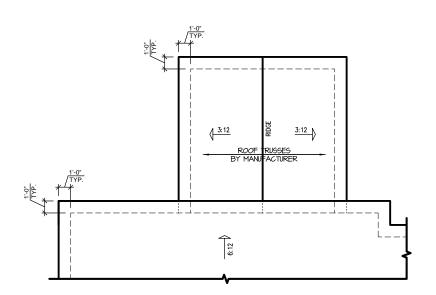

COVERED PORCH ROOF PLAN SCALE: 1/8"=1'-0" ON 11x17, 1/4"=1'-0" ON 22x34

SCALE: 1/8"=1'-0" ON 11x17, 1/4"=1'-0" ON 22x34

/-6"x6" TRT'D POST (OR EQUAL). SEE "PORCH POST NOTES" OPT EXTENDED PATIO 2x4 STUDS-@ 12" O.C. -SIMPSON MTS 12 SIMPSON-MTS 12

> **COVERED PORCH FLOOR PLAN** SCALE: 1/8"=1'-0" ON 11x17, 1/4"=1'-0" ON 22x34

6:12 SHINGLES AS SPECIFIED 2nd PLT. HGT. HEADER HEIGHT SIDING AS-SPECIFIED 4" TRIM -2nd FLR. LINE 3:12 1st PLT. HGT. HEADER HEIGHT 6x6 P.T. POST 6x6 P.T. POST 1st FLR. LINE COVERED PORCH REAR ELEVATION
SCALE: 1/8"=1'-0" ON 11x17, 1/4"=1'-0" ON 22x34 PARTIAL LEFT SIDE ELEVATION PARTIAL RIGHT SIDE ELEVATION

REFER TO "SD" SHEET(S) FOR STANDARD DETAILS, BRACING DETAILS AND STRUCTURAL NOTES.


SCALE: 1/8"=1'-0" ON 11x17, 1/4"=1'-0" ON 22x34

PROJECT # 21-2867-RH

Southern Engineers, P 3716 Benson Drive, Raleigh, NC 27 Phone: (919) 878-1617 License: C-4772

NEW HOME, INC.

RH Cary Plan 3 The

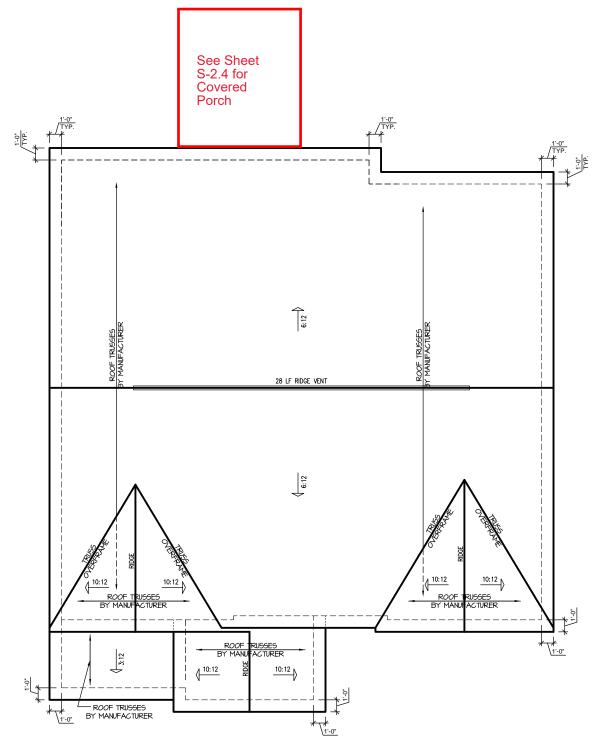


'FRENCH COUNTRY' ELEVATION ROOF PLAN SCALE: 1/4" = 1'-0" ON 22x34, 1/8" = 1'-0" ON 11x17

TRUSS SYSTEM REQUIREMENTS

NC (2018 NCRC): Wind: 115-120 mph

TRUSS SYSTEM LAYOUTS (PLACEMENT PLANS) SHALL BE DESIGNED IN ACCORDANCE WITH SEALED STRUCTURAL PLANS. ANY NEED TO CHANGE TRUSSES SHALL BE COORDINATED WITH SOUTHERN ENGINEERS.

- TRUSS SCHEMATICS (PROFILES) SHALL BE PREPARED AND SEALED BY TRUSS MANUFACTURER.
- ALL TRUSSES SHALL BE DESIGNED FOR BEARING ON SPF #2 OR #3 PLATES OR LEDGERS (UNO).
- ALL REQUIRED ANCHORS FOR TRUSSES DUE TO UPLIFT OR BEARING SHALL MEET THE REQUIREMENTS AS SPECIFIED ON THE TRUSS SCHEMATICS.

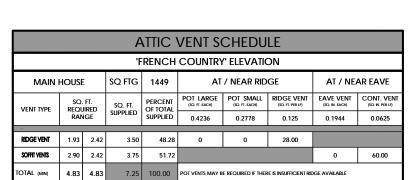

^{*} SCHEDULE HAS BEEN CALCULATED ASSUMING EAVE VENTILATION AT 50-60% OF TOTAL AND RIDGE AT 40-50% OF TOTAL REQUIRED VENTILATION



PROJECT # 21-2867-RH


P.A. 27609


Southern Engineers, P


NEW HOME,


RH Cary 3 The Plan


REFER TO "SD" SHEET(S) FOR STANDARD DETAILS, BRACING DETAILS AND STRUCTURAL NOTES.

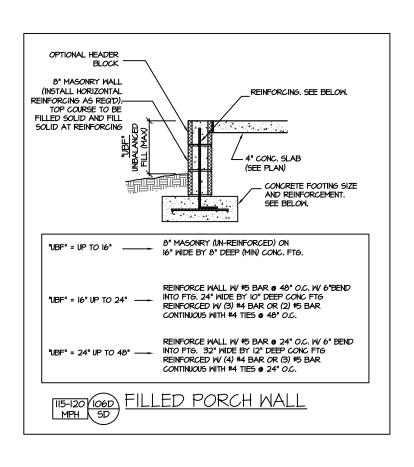

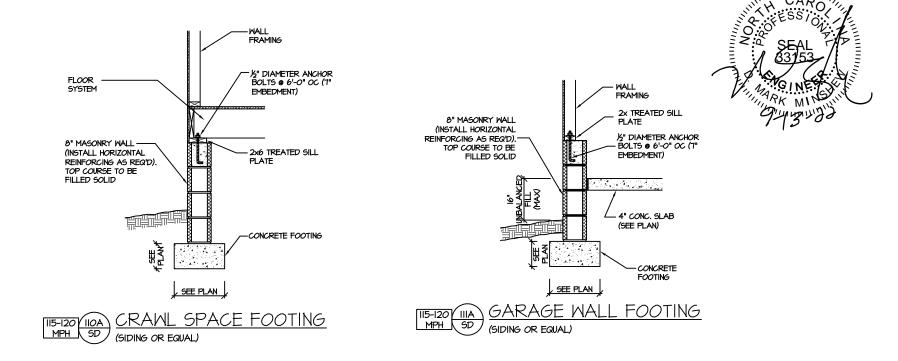

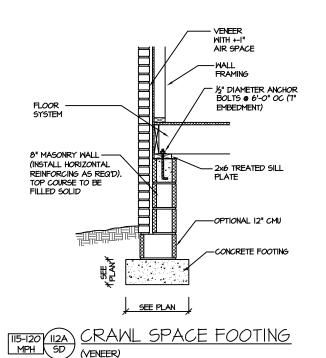

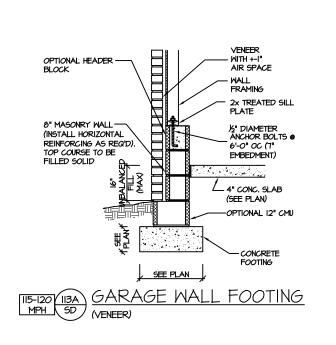

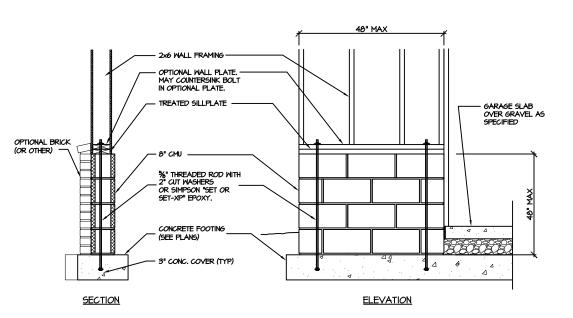

GARAGE 'WING WALL' REINFORCING
PER IRC FIGURE R602.10.4.3

CRAWL SPACE FOUNDATION

PROJECT # 21-2867


es not include construction means, methods, technique ces, procedures or safety precautions. extenders or safety precautions. Authoris or discrepancies on plans are to be brought to viate attention of Southern Engineers. Failure to do so wouthern Engineer's liability.

Southern Engineers, P.A.
3716 Benson Drive, Raleigh, NC 27609
Phone: (919) 878-1617
Immediat pinamediat processing proces


www.southernengineers.com

NEW HOME, INC


PLAN 3 - THE CARY

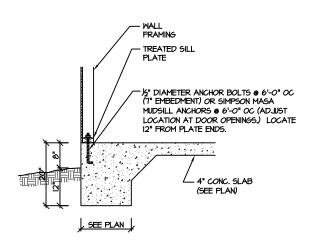





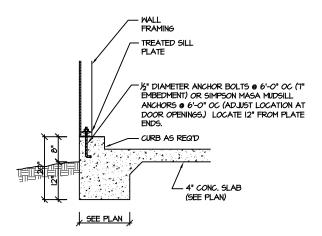




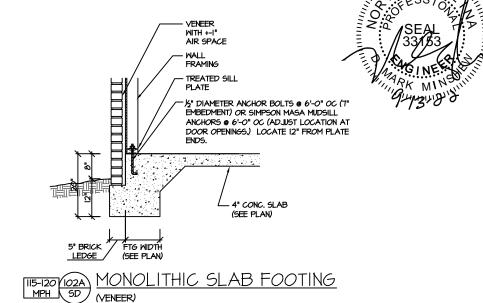

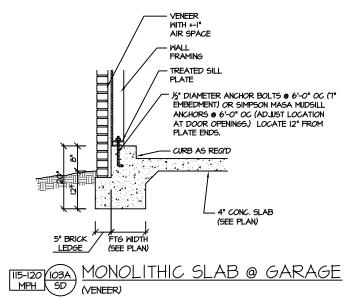

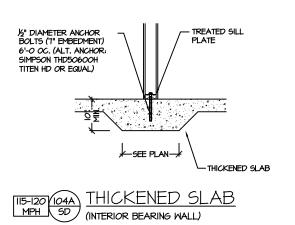

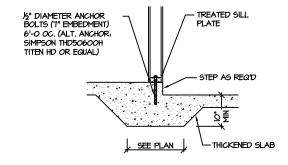

| II5-I20 | IO5A | SD | (INTERIOR GARAGE WALL)

THICKENED SLAB @ GARAGE

SLAB FOUNDATION


PROJECT # 21-2867


P.A. 27609


Southern Engineers, P. 3716 Benson Drive, Raleigh, NC 276 Phone: (919) 878-1617 License: C-4772 www.southernengineers.com

NEW HOME, INC


CARY THE 3 **PLAN**

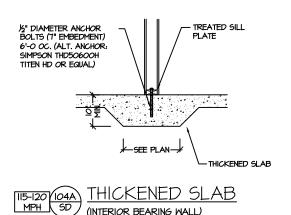


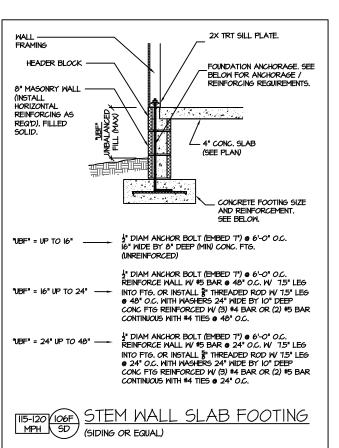


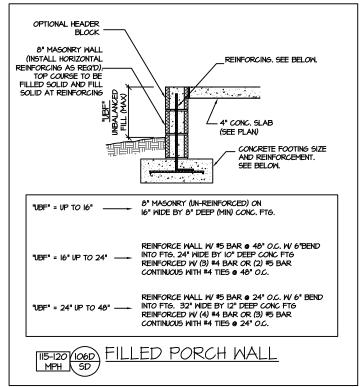




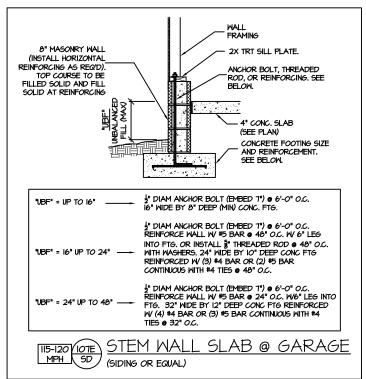

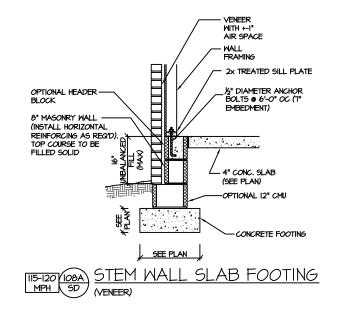

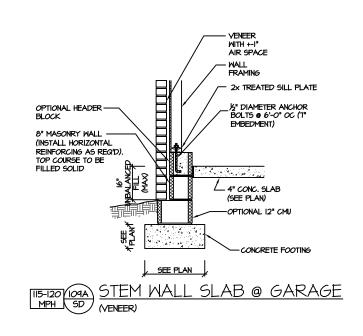

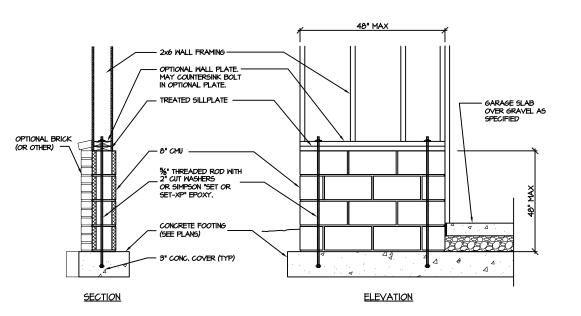

GARAGE 'WING WALL' REINFORCING PER IRC FIGURE R602.IO.4.3

STEMMALL SLAB FOUNDATION


PROJECT # 21-2867

P.A. 27609

Southern Engineers, P 3716 Benson Drive, Raleigh, NC 2' Phone: (919) 878-1617 License: C-4772 www.southernengineers.com

NEW HOME,

CARY THE 3 **PLAN**

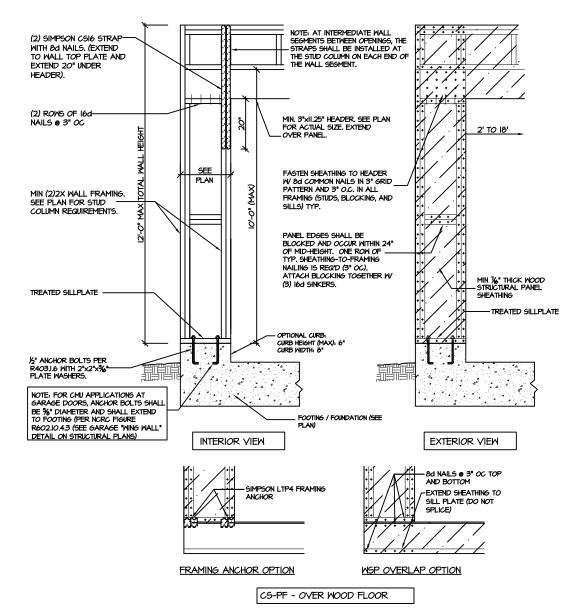

CS-PF: CONTINUOUS PORTAL FRAME CONSTRUCTION
DETAIL AND APPLICATION BASED ON NORGE FIGURE
R602.10.1 - PORTAL FRAME CONSTRUCTION



STRUCTURAL NOTES NC (2018 NCRC): Wind: 115-120 mph

- I. ENGINEER'S SEAL APPLIES ONLY TO STRUCTURAL COMPONENTS INCLUDING ROOF RAFTERS, HIPS, VALLEYS, RIDGES, FLOORS, WALLS, BEANG AND HEADERS, COLUMNS, CANTILEYERS, OFFSET LOAD BEARING WALLS, PIER & GIRDER SYSTEM, FOOTING, AND PILING SYSTEM. ENGINEER'S SEAL DOES NOT CERTIFY DIMENSIONAL ACCURACY OR ARCHITECTURAL LAYOUT INCLUDING ROOF SYSTEM. ALL REQUIREMENTS FOR PROFESSIONAL CERTIFICATION SHALL BE PROVIDED BY THE APPROPRIATE PROFESSIONAL SOUTHERN ENGINEERS, P.A. CERTIFIES ONLY THE STRUCTURAL COMPONENTS AS SPECIFICALLY STATED.
- 2. ALL CONSTRUCTION SHALL CONFORM TO THE LATEST REQUIREMENTS OF THE 2018 NC RESIDENTIAL CODE, PLUS ALL LOCAL CODES AND RESULATIONS. THE STRUCTURAL ENGINEER IS NOT RESPONSIBLE FOR, AND WILL NOT HAVE CONTROL OF, CONSTRUCTION MEANS, METHODS, TECHNIQUES, SEQUENCES OR PROCEDURES, OR FOR SAFETY PRECAUTIONS AND PROGRAMS IN CONNECTION WITH THE CONSTRUCTION WORK, NOR WILL THE ENGINEER BE RESPONSIBLE FOR THE CONTRACT DOCUMENTS. "CONSTRUCTION REVIEW" SERVICES ARE NOT PART OF OUR CONTRACT. ALL MEMBERS SHALL BE FRAMED ANCHORED, TIED AND BRACED IN ACCORDANCE WITH GOOD CONSTRUCTION PRACTICE AND THE BUILDING CODE.
- 3. DESIGN LOADS (LISTED AS: LIVE LOAD, DEAD LOAD, DEFLECTION)
- ROOMS OTHER THAN SLEEPING ROOMS: (40 PSF, IO PSF, L/360)
- SLEEPING ROOMS: (30 PSF, IO PSF, L/360)
- ATTIC WITH PERMANENT STAIR: (40 PSF, 10 PSF, L/360)
- ATTIC WITHOUT PERMANENT STAIR: (20 PSF, IO PSF, L/360)
- ATTIC WITHOUT STORAGE: (10 PSF, 10 PSF, L/240)
- STAIRS: (40 PSF, I0 PSF, L/360)
 EXTERIOR BALCONIES: (60 PSF, I0 PSF, L/360)
- DECKS: (40 PSF, IO PSF, L/360)
- GUARDRAILS AND HANDRAILS: (200 LBS)
- PASSSENGER VEHICLE GARAGES: (50 PSF, IO PSF, L/360)
- FIRE ESCAPES: (40 PSF, IO PSF, L/360)
- SNOW: (20 PSF
- WALLS SHALL BE BRACED BY SHEATHING WALLS ON ALL STORIES WITH WOOD STRUCTURAL PANELS. SEE FRAMING NOTES FOR THICKNESS AND NAILING REQUIREMENTS.
- SEE APPENDIX M (DCA6) FOR EXTERIOR DECK REQUIREMENTS INCLUDING ATTACHMENTS FOR LATERAL LOADS.
- 6. CONCRETE SHALL HAVE A MINIMUM 28 DAY STRENGTH OF 3000 PSI AND A MAXIMUM SLUMP OF 5 INCHES UNLESS NOTIED OTHERWISE (INO). AIR ENTRAINED PER TABLE 4022. ALL CONCRETE SHALL BE PROPORTIONED, MIXED, HANDLED, TESTED, AND PLACED IN ACCORDANCE WITH ACI STANDARDS. ALL SAMPLES FOR PUMPING SHALL BE TAKEN FROM THE EXIT END OF THE PUMP. CONTROL JOINTS IN SLABS SHALL BE SPACED ON A GRID OF +30 TIMES THE DEPTH (D). CONTROL JOINTS SHALL BE SANCUIT TO A DEPTH OF I/D. (I.E. 4" CONTROL JOINTS SHALL BE SANCUIT TO A DEPTH OF I/D. (I.E. 4" CONTROL JOINTS SANCUIT IN SLAB ON A +-IO'-O" x +-IO'-O" GRID).
- ALLOWABLE SOIL BEARING PRESSURE ASSUMED TO BE 2000 PSF. THE CONTRACTOR MUST CONTACT A GEOTECHNICAL ENGINEER AND THE STRUCTURAL ENGINEER IF UNGATISFACTORY SUBSURFACE CONDITIONS ARE ENCOUNTERED. THE SURFACE AREA ADJACENT TO THE FOUNDATION WALL SHALL BE PROVIDED WITH ADEQUATE DRAINAGE, AND SHALL BE GRADED SO AS TO DRAIN SURFACE WATER AWAY FROM FOUNDATION WALLS.
- ALL FRAMING LUMBER SHALL BE SPF #2 (Fb = 615 PSI) UNLESS NOTED OTHERWISE (UNO). ALL
 TREATED LUMBER SHALL BE SYP # 2. PLATE MATERIAL MAY BE SPF # 3 OR SYP #3 (Fc(perp) =
 425 PSI MIN).
- L.V.L. SHALL BE LAMINATED VENEER LUMBER: Fb=2600 PSI, Fv=265 PSI, E=1.9xl0 PSI.
 H.J. P5.L. SHALL BE PARALLEL STRAND LUMBER: Fb=2400 PSI, Fv=240 PSI, E=2.0xl0 PSI.
 L.S.L. SHALL BE LAMINATED STRAND LUMBER: Fb=2250 PSI, Fv=400 PSI, E=1.55xl0 PSI.
 MSTALL ALL CONNECTIONS PER MANUFACTURERS INSTRUCTIONS.
- IO. ALL ROOF TRUSS AND I-JOIST LAYOUTS SHALL BE PREPARED IN ACCORDANCE WITH THE SEALED STRUCTURAL DRAWINGS. TRUSSES AND I-JOISTS SHALL BE INSTALLED ACCORDING TO THE MANUFACTURE'S SPECIFICATIONS. ANY CHANGE IN TRUSS OR I-JOIST LAYOUT SHALL BE COORDINATED WITH SOUTHERN ENGINEERS.
- II. ALL STRUCTURAL STEEL SHALL BE ASTM A-36. STEEL BEAMS SHALL BE SUPPORTED AT EACH END WITH A MINIMUM BEARING LENGTH OF 3 1/2" INCHES AND FULL FLANGE MIDTH. PROVIDE SOLID BEARING FROM BEAM SUPPORT TO FOUNDATION. BEAMS SHALL BE ATTACHED TO EACH SUPPORT WITH TWO LAG SCREWS (1/2" DIAMETER x 4" LONG). LATERAL SUPPORT IS CONSIDERED ADEQUATE PROVIDING THE JOIST ARE TOE NAILED TO THE SOLE PLATE, AND SOLE PLATE IS NAILED OR BOLTED TO THE BEAM FLANGE @ 48" O.C. ALL STEEL TUBING SHALL BE ASTM A500.
- 12. REBAR SHALL BE DEFORMED STEEL, ASTM615, GRADE 60. LAP ALL REBAR SPLICES 30 BAR DIAMETERS
- 13. FLITCH BEAMS SHALL BE BOLTED TOGETHER USING (2) ROWS OF I/2" DIAMETER BOLTS (ASTM A325) WITH WASHERS PLACED UNDER THE THREADED END OF BOLT, BOLTS SHALL BE SPACED AT 24" O.C. (MAX), AND STAGGERED AT THE TOP AND BOTTOM OF BEAM (2" EDGE DISTANCE), WITH 2 BOLTS LOCATED AT 6" FROM EACH END.
- I4. BRICK LINTELS (MHEN REQUIRED) SHALL BE 3 I/2"x3 I/2"x1/4" STEEL ANGLE FOR UP TO 6'-0" SPAN AND 6"x4"x5/16" STEEL ANGLE WITH 6" LEG VERTICAL FOR SPANS UP TO 9'-0". SEE PLANS FOR SPANS OVER 9'-0". SEE ALSO SECTION RT03.8.3 LINTELS.

PROJECT # 21-2867

.-2867

uction means, methods, techniques, ety precautions. ies on plans are to be brought to th

luences, procedures or safety precautions.

devariations or disrepaneties on plans are tramediate attention of Southern Engineers. Fiid Southern Engineer's liability.

It wild for projects permitted one year froi
of these plans constitutes annowal of term

Southern Engineers, 1 3716 Benson Drive, Raleigh, NC 3 Phone: (919) 878-1617
License: C-4772
www.southernengineers.com

NEW HOME, INC

PLAN 3 - THE CARN