REVISION LOG

REVISION:001

DATE: 11/24/21

- 6x6 © COVERED PORCH, PACK OUT BEAM.
 CHANGE WALL BETWEEN PANTRY/ COAT CLOSET TO A 2X6 WALL.

- NOTE 3/0 C.O. "3/0X6/8 C.O.".

 CHANGE WALL BETWEEN KITCHEN COUNTER & MESSY KITCHEN TO 28" LENGTH.

 LOCATE 2/8X6/8 C.O. © END OF THE WALL.

- LOCATE 2/8X6/8 C.O. @ END OF THE WALL

 5. ADD (3) OPT 2/0X2/0 @ CAFE, CENTERED @ 21'-4" FRONT REAR WALL

 6. CHANGE IST FLOOR STAR RAIL AND WALL FROM A 2X4 WALL TO A 2X6 WALL.

 SLIDE BATH #2 WALL 2" TO MAINTAIN 3'-4" STAIR WIDTH. ADJUSTED WALL AND
 STAIR ON THE 2ND FLOOR.

 7. END STAIR RAIL 10'-0" FROM MIC WALL.

 REMOVE WIDE WALL BEHIND BATH #2 TUB.

 9. CHANGE BATH #2 WIDTH TO 5'-0" & ADD ROOM TO BED #2.

 10. CHANGE WALL BEHIND THE OWNER'S TOILET WALL FROM A 2X6 WALL TO A 2X4
 WALL & MOVE WALL INTO WIC TO INCREASE DEPTH THE TOILET TO 6'-1". REVISE
 ALL OWNER'S BATH OPTIONS TO MATCH.

 11. ADD GOURMET KITCHEN W/ WALL OWN AND 36" COOKTOP.

- ALL OWNER'S BAIH OPTIONS TO MATCH.

 11. ADD COURMET KITCHEN W/ WALL OVEN AND 36" COOKTOP.

 12. ADD 24"X36" ATTIC ACCESS TO BED #4 WC.

 13. CHANGE 2ND FLOOR 3/O C.O. TO A 5/0X6/8 C.O.

 14. CHANGE 2ND FLOOR 3/O C.O. TO A 5/0X6/8 ® FOYER CLOSET, BATH #2, WC ® BED #2, BATH #3, LINEN, WC ® BED #3 & WC ® BED #4.

 15. FLIP DOOR SWING INTO OPT. OFFICE/HOME GYM.
- 15. FLIP DUDY SMING INTO UP: OFFICE/FLOWE STM.

 16. ADB 8"-0" DEEP MECHANICAL RM TO REAR OF OPT. SUPER GAMEROOM/ HOME GYM/ OFFICE.

 17. 2X10 BEAM UNDER TOP PLATES @ FRONT PORCHES.

 18. AUGN (3) 2/0X2/0 WINDOW HEADER HT @ FLEX ROOM W/ FRONT DOOR HEADER

- HT.

 19. ADD PARTIAL FOR OPT FIREPLACE.

 20. ADD PARTIAL ELEVATIONS FOR OWNER'S BATH OPTIONS.

 21. ADD PARTIAL FOR OPT SMART DELIVERY DOOR.
- 22. 4 3" DSP BETWEEN WINDOWS & DIMENSION TO THE CENTER.
 23. DIMENSION WIDTH OF HIPS

REVISION:002 DATE: 2/4/2022

- DIMENSION TRIPLE STUD POCKETS (4.5")
- DIMENSION THILE STUD POCKETS (4.3)
 RELOCATED & RESIZE KITCHEN ISLAND PER REDLINES, & REMOVE UNDER-COUNTER WALL TO THE RIGHT OF KITCHEN SINK.
 SHOW FULL HEIGHT WALL AT STANDARD MASTER BATH SHOWER.
 CHANGE MASTER BATH LINEN CLOSET DOOR TO 4/0X6/8 DOUBLE DOOR.
- CALL OUT ALL LINEN CLOSETS AS (4) SHELVES.
- REMOVE SHELF/ROD BEHIND WATER CLOSET & ADJACENT TO DOOR IN MASTER WIC CALL OUT FRONT PORCH COLUMNS AS 6X6 P.T. POST W/ 1X WRAP.
- LAREL 12" DROPPED HEADER
- REMOVE THE OWNER'S ENTRY OPTION.
- 10. RESIZE/RELOCATE/REMOVE UNDER-COUNTER WALL IN KITCHEN ISLAND PER BASE
- 11. SHOW 42X42 SHOWER W/ 18" SEAT FOR TUB SHOWER COMBO PER REVISION
- REDLINES.
 12. SHOW OPT. STANDALONE 42X42 W/ 18" SEAT.
- 13. LOCATE SHOWER VALVE ON HALE WALL FOR SUPER SHOWER OPT.
 14. LABEL OPT DOOR TO FLEX ROOM AS 15-UTE FRENCH DOORS
 15. SWING DOOR AT GAMEROOM INTO UNFIN. ATTIC STORAGE.
 16. REMOVE FAUX SHUTTER FROM FARMHOUSE PLAN SINCE IT IS NOT SHOWING ON
- ELEVATION.

 ELEVATION.

 10. PIDPATE ROOF HEIGHT FOR REAR OPTIONS TO REFLECT STANDARD HEEL HEIGHT.

 18. REMOVED HALF WALLS AT KITCHEN ISLAND AND UPDATED PER CABINET PROVIDER
- 20. EXTEND PORCH SLAB 4" AT FRONT AND EXTEND AROUND CORNER 20" TO SUPPORT STONE
- VENEER.

 21. REMOVED HALF WALLS AT KITCHEN ISLAND AND UPDATED PER CABINET PROVIDER
- 22. CHANGED THE BASE OWNER'S BATH WINDOW TO 4010
 23. CHANGED THE OWNER'S BATH OPTION SHOWER WINDOW TO 4010
 24. CHANGED THE OWNER'S BATH OPTION SUPER SHOWER WINDOWS TO (2)3010

REVISION: 003 DATE: 3/21/2022 1. ADD ELECTRICAL PLANS
1. ADD ATTERNATE SECOND FLOOR PLANS WITH OWNER'S SLITE OPTIONS DATE: 7/22/2022

- ADD STEM WALL SLAB FOUNDATION SHEETS ADD "STEM WALL" TO CRAIN ELEVATION TITLES AND NOTE "SEE FOUNDATION PAGES FOR FOUNDATION TYPE". UPDATE SHEET TITLES.

1-26-24 - Initial Redlines - JJ

144 DC - Duncans Creek Rd., Lillington, NC 27546





SQUARE	<u> </u>	4GE		
	FARMI	HOUSE		
	UNHEATED	HEATED		
FIRST FLOOR	0	1955		
SECOND FLOOR	0	945		
FRONT PORCH	147	0		
2 CAR GARAGE	437	0		
PATIO	220	0		
SUBTOTALS	804-	2900		
TOTAL UNDER ROOF	37	04		
0	PTIONS TUNHEATED S.F.	HEATED S.F.		
COVERED PATIO	220	0		
EXTENDED OWNER'S SUITE	0	+32		
ALT. SECOND FLOOR	+17	+139		
SUPER GAME ROOM	0	+183		
OFFICE	0	+183		
HOME GYM	0	+183		
SMART DOOR	-28	+28		
		0		
MECHANICAL RM	+158	0		

SOLIARE FOOTAGE

PLAN 6 The Raleigh - LH

'FARMHOUSE' **ELEVATION**

Sheet No.	ARCHITECTURAL DRAWINGS Sheet Description
0.0	Cover Sheet
1.1	Foundation (Slab)
1.1.1	Foundation Options (Slab)
1.1.2	Foundation Options (Slab)
1.2	Foundation (Crawl)
1.2.1	Foundation Options (Crawl)
1.2.2	Foundation Options (Crawl)
1.3	Foundation (Stem Wall Slab)
1.3.1	Foundation Options (Stem Wall Slab)
1.3.2	Foundation Options (Stem Wall Slab)
2.1	First Floor Plan
2.1.1	First Floor Plan Options
2.2	Second Floor Plan
2.2.1	Second Floor Plan Options
2.2.2	Alt. Second Floor Plan Owner's Suite Options
2.4	Covered Porch Plans & Elevations (Slab)
2.4.1	Covered Porch Plans & Elevations (Crawl/Stem Wall)
2.5	Extended Owner's Suite Plans & Elevations (Slab)
2.5.1	Extended Owner's Suite Plans & Elevations (Crawl/ Stem Wall)
2.6	Ext. Owner's Suite W/Cov. Porch Plans & Elevations (Slab)
2.6.1	Ext. Owner's Suite W/Cov. Porch Plans & Elevations (Crawl/Stem Wall)
2.7	2-Car Sideload Garage Plans
2.7.1	2-Car Sideload Garage Elevations
2.8	3-Car Garage Plans
2.8.1	3-Car Garage Elevations (Crawl/ Stem Wall)
2.8.2	3-Car Garage Elevations (Slab)
3.1	Front & Rear Elevations (Slab)
3.1.1	Front & Rear Elevations (Crawl/Stem Wall)
3.2	Side Elevations (Slab)
3.2.1	Side Elevations (Crawl/ Stem Wall)
3.3	Roof Plan
5.1	First Floor Electrical Plan
5.1.1	First Floor Options Electrical Plan
5.2	Second Floor Electrical Plan
5.2.1	Second Floor Options Electrical Plan

DESIGN CRITERIA:

THIS PLAN IS TO BE BUILT IN CONFORMANCE WITH THE 2018 NORTH CAROLINA STATE BUILDING CODE: RESIDENTIAL CODE

DIMENSIONS SHALL GOVERN OVER SCALE, AND CODE SHALL GOVERN OVER DIMENSIONS.


DATE								
DESCRIPTION		-	1	1	1	1	1	
REV.#	1	2	3	4	9	9	2	8
	_							


THE RALEIGH 9 **PLAN**

Sheet

DRAWN BY: South Designs ISSUE DATE: CURRENT REVISION DATE

1/8" = 1'-0"

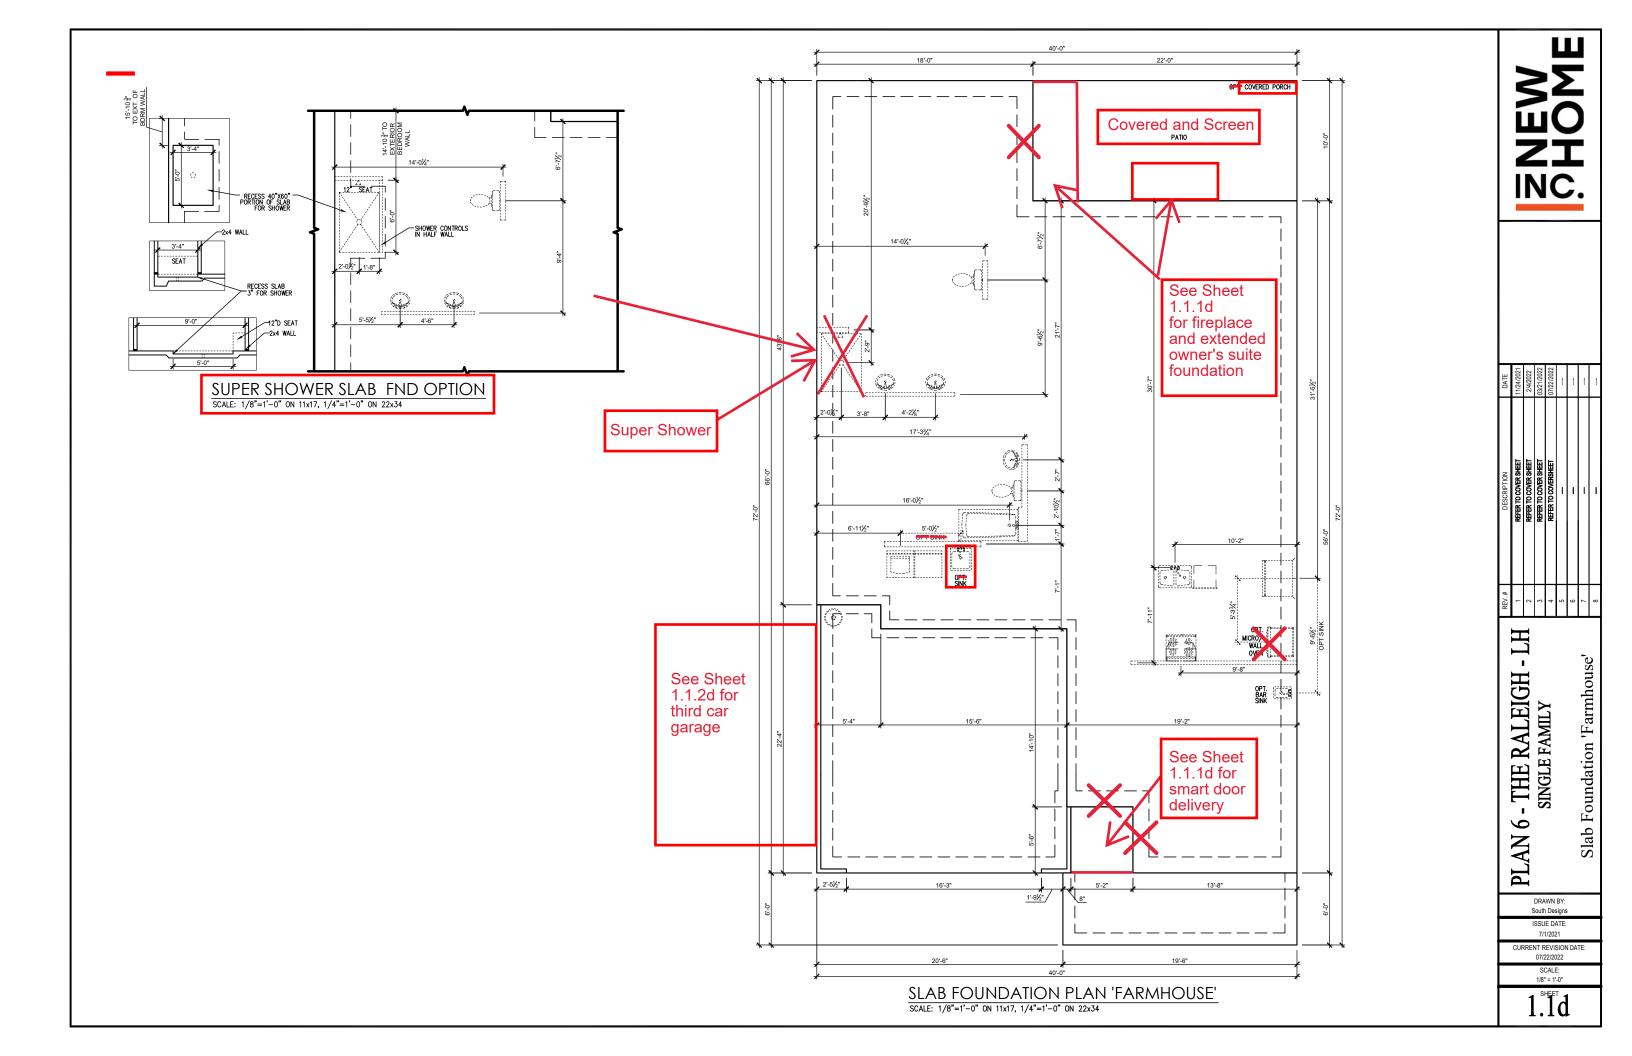

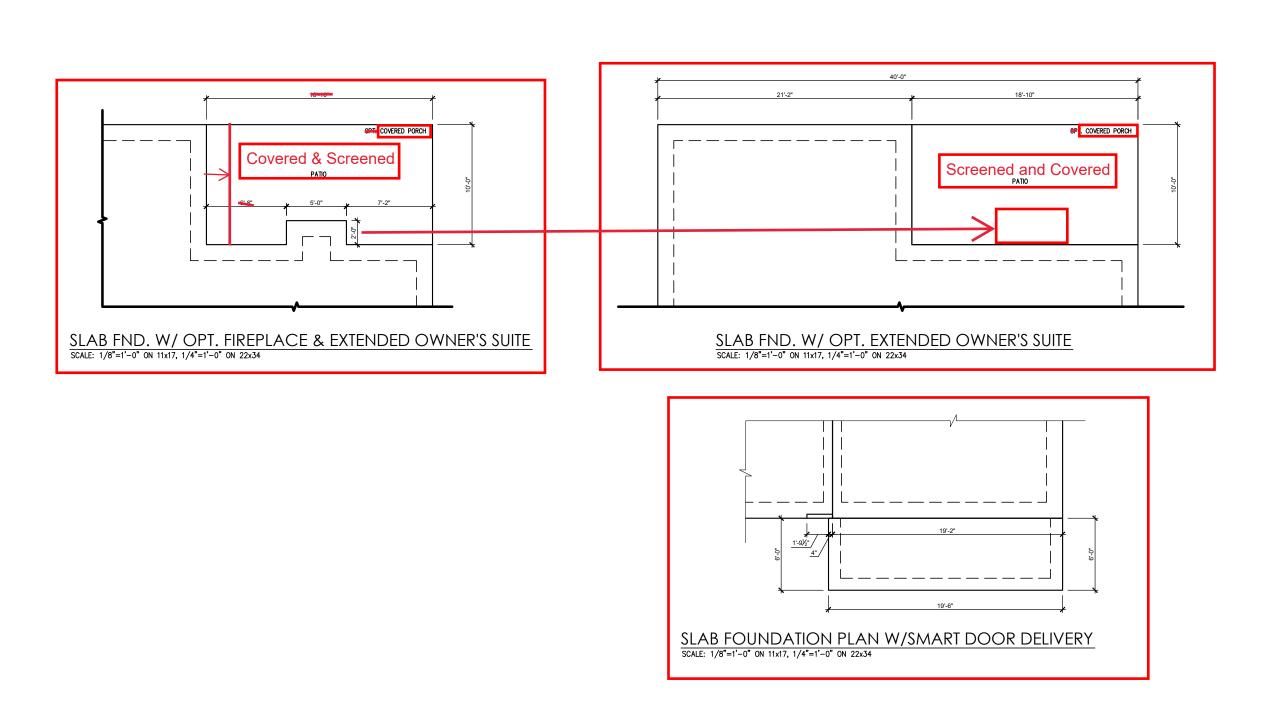



									ı
DATE	11/24/2021	2/4/2022	03/21/2022	07/22/2022				-	
DESCRIPTION	REFER TO COVER SHEET	REFER TO COVER SHEET	REFER TO COVER SHEET	REFER TO COVERSHEET	-	-	1	-	
REV.#	1	2	3	4	2	9	7	8	
	_ _	-							

PLAN 6 - THE RALEIGH - LH SINGLE FAMILY

Slab Foundation Options 'Farmhouse'


DRAWN BY: South Designs

ISSUE DATE: 7/1/2021

CURRENT REVISION DATE: 07/22/2022

SCALE: 1/8" = 1'-0"

1 1 1 1 A

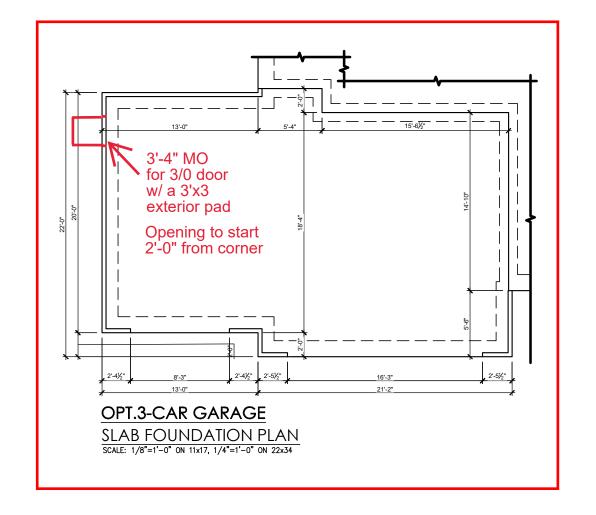



PLAN 6 - THE RALEIGH - LH
SINGLE FAMILY
Slab Foundation Options
'Farmhouse'

DRAWN BY: South Designs

ISSUE DATE: 7/1/2021

CURRENT REVISION DATE: 07/22/2022 SCALE: 1/8" = 1'-0"


1 1 7 1

General Floor Plan Notes General Floor Plan Notes shall apply unless noted otherwise on plan. 1. Wall Heights: Typically 9°-1 1/2" at first floor and second floor, and 9°-1 1/2" at affics U.N.O. All walls are constructed using a double top plate. Splices at Double Top Plate do not need to occur at Vertical Studs but must be at least 24" apart from Joint in

 Wall Thickness is typically 3 1/2". 2x6 frame shall be used at walls that back up to plumbing fixtures. Walls greater than 10' high shall be framed with 2x6 framing or greater and will be noted as a special condition where it occurs on plan.

other Top Plate layer. Special wall heights are noted on plans where they occur.


- Typical header height shall be 7'-8" AFF at First Floor, and 7'-4" AFF at Second Floor U.N.O.
- Jacks: Openings up to 3'-4" wide shall have (1) 2x4
 jack stud SPF on each side. Openings greater than
 3'-4" wide shall have (2) 2x4 jack studs SPF on each
- 5. Soffits, Coffered Ceilings, Trey Ceilings and other significant ceiling plan elements are shown on the floor plans and are denoted as single dashed lines. Unless specifically call out as included, Kitchens do not include soffits over wall cabinetry.
- Door & Window Frames, where occurring near corners, shall be a minimum of 4 1/2" from corner. Except for walk-in closets with doors near a corner, doors at closets shall be centered on closet.
- Windows: Shall have at least (1) window in each sleeping room, that meets egress. Shall be provided with tempered glass at hazardous glazing areas. False windows shall be installed with obscure alazina.
- Closets for clothing or coat storage shall be equipped with 1 rod/shelf. Closets for linen shall have 4 open equal shelves. Closets for pantries shall have 4 equal wood shelves, painted.
- Stair treads shall be a min of 9" deep, risers shall be a maximum of 8 1/4", unless noted otherwise, per the current North Carolina Residential Code
- 10. Handrails and Guards at stairs shall be 34" above the finished surface of the ramp surface of the stair. Handrails at landings and overlooks of multilevel spaces shall be 36" above finished floor. Guards (pickets or balusters) shall be spaced with no more than 4" between guards.
- 11. Attic Access shall be provided at all attic area with a height greater than 30°. Minimum clear attic access shall be 20° x 30°. Pull down stairs and access doors in knee walls meeting minimum criteria are also acceptable.
- 12. Garage Door to Living Space shall be 2'-8" x 6'-8" minimum size and shall be 20 minute fire rated and weather sealed.
- 13. Garage Walls, as a minimum, shall be separated from living space by installing 1/2" gypsum board on the garage side of the wall. With habitable space above, the inside of all garage walls require 1/2" GWB supporting 5/8" type X GWB on ceiling.

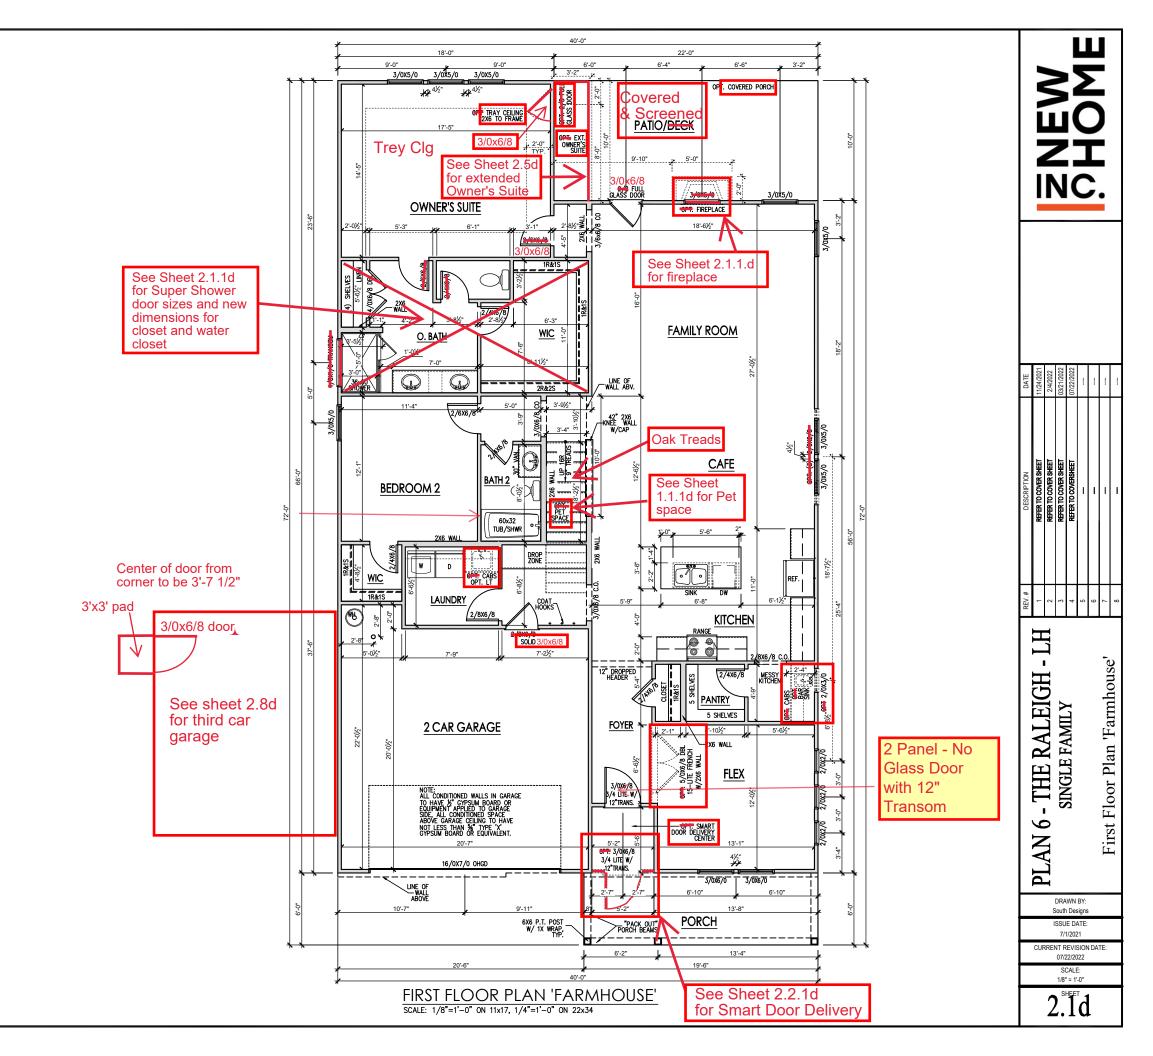



General Floor Plan Notes

General Floor Plan Notes shall apply unless noted otherwise on plan.

- . Wall Heights: Typically 9'-1 1/2" at first floor and wall Heights: Typically Y-1 1/2" at a first floor and second floor, and 9'-1 1/2" at at thics U.N.O. All walls are constructed using a double top plate. Splices at Double Top Plate do not need to occur at Verifical Studs but must be at least 24" apart from Joint in other Top Plate layer. Special wall heights are noted on plans where they occur.
- Wall Thickness is typically 3 1/2". 2x6 frame shall be used at walls that back up to plumbing fixtures.
 Walls greater than 10' high shall be framed with 2x6 framing or greater and will be noted as a special condition where it occurs on plan.
- Typical header height shall be 7'-8" AFF at First Floor, and 7'-4" AFF at Second Floor U.N.O.
- Jacks: Openings up to 3'-4" wide shall have (1) 2x4 jack stud SPF on each side. Openings greater than 3'-4" wide shall have (2) 2x4 jack studs SPF on each
- Soffits, Coffered Ceilings, Trey Ceilings and other significant ceiling plan elements are shown on the floor plans and are denoted as single dashed lines. Unless specifically call out as included, Kitchens do not include soffits over wall cabinetry.
- 6. Door & Window Frames, where occurring near corners, shall be a minimum of 4 1/2" from corner. Except for walk-in closets with doors near a corner, doors at closets shall be centered on closet.
- Windows: Shall have at least (1) window in each sleeping room, that meets egress. Shall be provided with tempered glass at hazardous glazing areas. False windows shall be installed with obscure
- Closets for clothing or coat storage shall be equipped with 1 rod/shelf. Closets for linen shall have 4 open equal shelves. Closets for pantries
- Stair treads shall be a min of 9" deep, risers shall be a maximum of 8 1/4", unless noted otherwise, per the current North Carolina Residential Code
- 10. Handrails and Guards at stairs shall be 34" above the finished surface of the ramp surface of the stair. Handrails at landings and overlooks of mullilevel spaces shall be 36" above finished floor. Guards (pickets or balusters) shall be spaced with no more than 4" between guards.
- 11. Attic Access shall be provided at all attic area with a height greater than 30". Minimum clear attic access shall be 20" x 30". Pull down stairs and access doors in knee walls meeting minimum criteria are also acceptable.
- 12. Garage Door to Living Space shall be 2'-8" x 6'-8" minimum size and shall be 20 minute fire rated and weather sealed.
- 13. Garage Walls, as a minimum, shall be separated from living space by installing 1/2" gypsum board on the garage side of the wall. With habitable space above, the inside of all garage walls require 1/2" GWB supporting 5/8" type X GWB on ceilling.

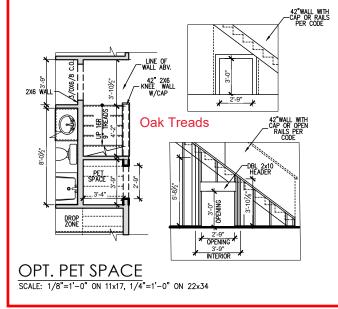

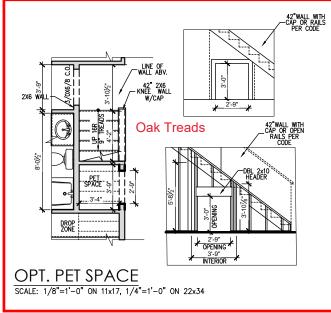

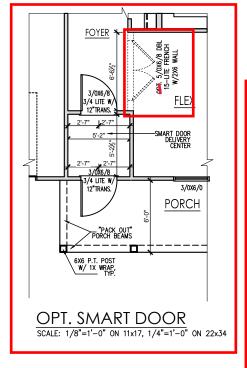

7'-2"

FIREPLACE 42"X39" R.O.

18'-61/2"


SCALE: 1/8"=1'-0" ON 11x17, 1/4"=1'-0" ON 22x34

OPT. FIREPLACE

1R&1S

3'-2"



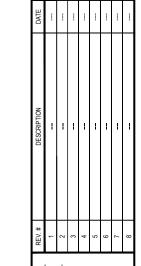

HT ı - THE RALEIGH SINGLE 9 **PLAN**

Options 'Farmhouse'

Floor (


First

DRAWN BY: South Designs

ISSUE DATE: 7/1/2021

CURRENT REVISION DATE: 1/8" = 1'-0"

40'-0" **General Floor Plan Notes** 18'-0" 22'-0" General Floor Plan Notes shall apply unless noted otherwise on plan. Wall Heights: Typically 9'-1 1/2" at first floor and second floor, and 9'-1 1/2" at attics U.N.O. All walls are constructed using a double top plate. Splices at Double Top Plate do not need to occur at Vertical Studs but must be at least 24" apart from Joint in other Top Plate layer. Special wall heights are noted on plans where they occur. Wall Thickness is typically 3 1/2". 2x6 frame shall be used at walls that back up to plumbing fixtures. Walls greater than 10' high shall be framed with 2x6 framing or greater and will be noted as a special condition where it occurs on plan. Typical header height shall be 7'-8" AFF at First Floor, and 7'-4" AFF at Second Floor U.N.O. ------LINE OF WALLS BELOW Jacks: Openings up to 3'-4" wide shall have (1) 2x4 jack stud SPF on each side. Openings greater than 3'-4" wide shall have (2) 2x4 jack studs SPF on each 5. Soffits, Coffered Ceilings, Trey Ceilings and other significant ceiling plan elements are shown on the floor plans and are denoted as single dashed lines. Unless specifically call out as included, Kitchens do not include soffits over wall cabinetry. 6. Door & Window Frames, where occurring near corners, shall be a minimum of 4 1/2" from corner. Except for walk-in closets with doors near a corner, doors at closets shall be centered on closet. 7. Windows: Shall have at least (1) window in each willdows. Shall have a least (1) will own leads is sleeping room, that meets egress. Shall be provided with tempered glass at hazardous glazing areas. False windows shall be installed with obscure Closets for clothing or coat storage shall be equipped with 1 rod/shelf. Closets for linen shall have 1 popen equal shelves. Closets for pantries shall have 4 equal wood shelves, painted. +/-8'-0" CLG HT W/O FURRING +/-8'-0" CLG HT W/O FURRING 9. Stair treads shall be a min of 9" deep, risers shall be a maximum of 8 1/4", unless noted otherwise, per the current North Carolina Residential Code Oak Treads MECHANICAL ROOM W/ OPT. OFFICE, OPT. HOME GYM OR OPT. SUPER GAMEROOM 10.Handrails and Guards at stairs shall be 34" above the finished surface of the ramp surface of the stair. Handrails at landings and overlooks of multilevel spaces shall be 36" above finished floor. Guards (pickets or balusters) shall be spaced with no more 24"X36" ATTIC ACCESS WEATHER STRIPPED — AND INSULATED than 4" between guards. Aftic Access shall be provided at all aftic area with a height greater than 30". Minimum clear aftic access shall be 20" x 30". Pull down stairs and access doors in knee walls meeting minimum 2/6X6/8 criteria are also acceptable See Sheet 2.2.2d 12.Garage Door to Living Space shall be 2'-8" x 6'-8" minimum size and shall be 20 minute fire rated and weather sealed. UNFINISHED 4'-5" for loft, landing See Sheet WIC STORAGE 13. Garage Walls, as a minimum, shall be separated from living space by installing 1/2" gypsum board on the garage side of the wall. With habitable space above, the inside of all garage walls require 1/2" GWB supporting 5/8" type X GWB on ceiling. and door at the top 2.2.2d for of the staris, entry into bedroom and bedroom 3 bathroom BEDROOM -THE RALEIGH Plan DESK BEV CENTER 0 BATH 3 Floor PT. **GAME ROOM** Second BEDROOM 3 9 **PLAN** 60x32 5 South Designs ISSUE DATE: 7/1/2021 CURRENT REVISION DATE 7'-0" SCALE: 1/8" = 1'-0" 2.2dSECOND FLOOR PLAN 'FARMHOUSE' SCALE: 1/8"=1'-0" ON 11x17, 1/4"=1'-0" ON 22x34

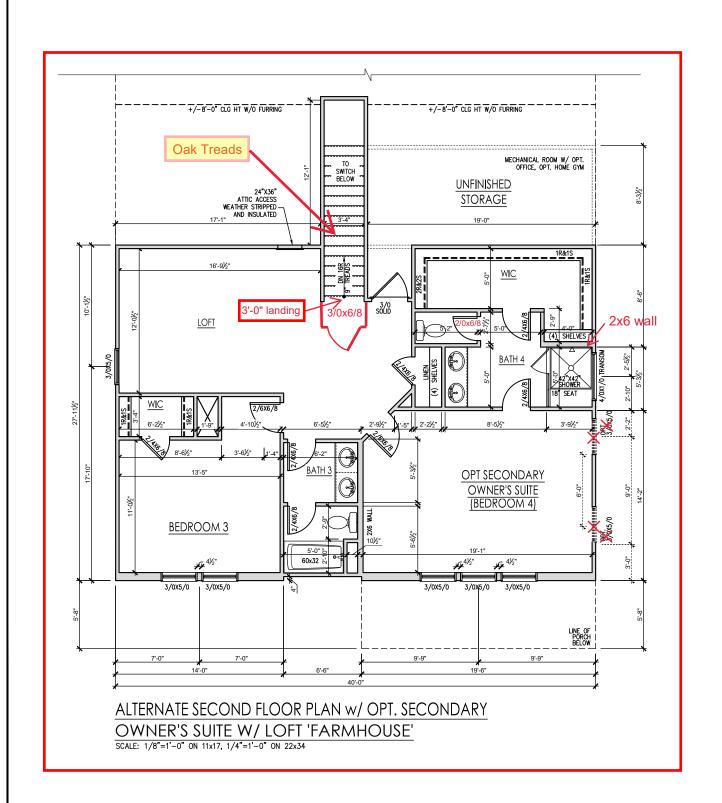

JAOHC:

DATE								
DESCRIPTION			ł	1	1	1		
REV. #	1	2	3	4	2	9	2	8
	Ţ	7						


PLAN 6 - THE RALEIGH - LL SINGLE FAMILY Second Floor Options w/ Owner's Suite 'Farmhouse'


DRAWN BY: South Designs


ISSUE DATE: 7/1/2021

CURRENT REVISION DATE:
---SCALE:
1/8" = 1'-0"

2 2 7

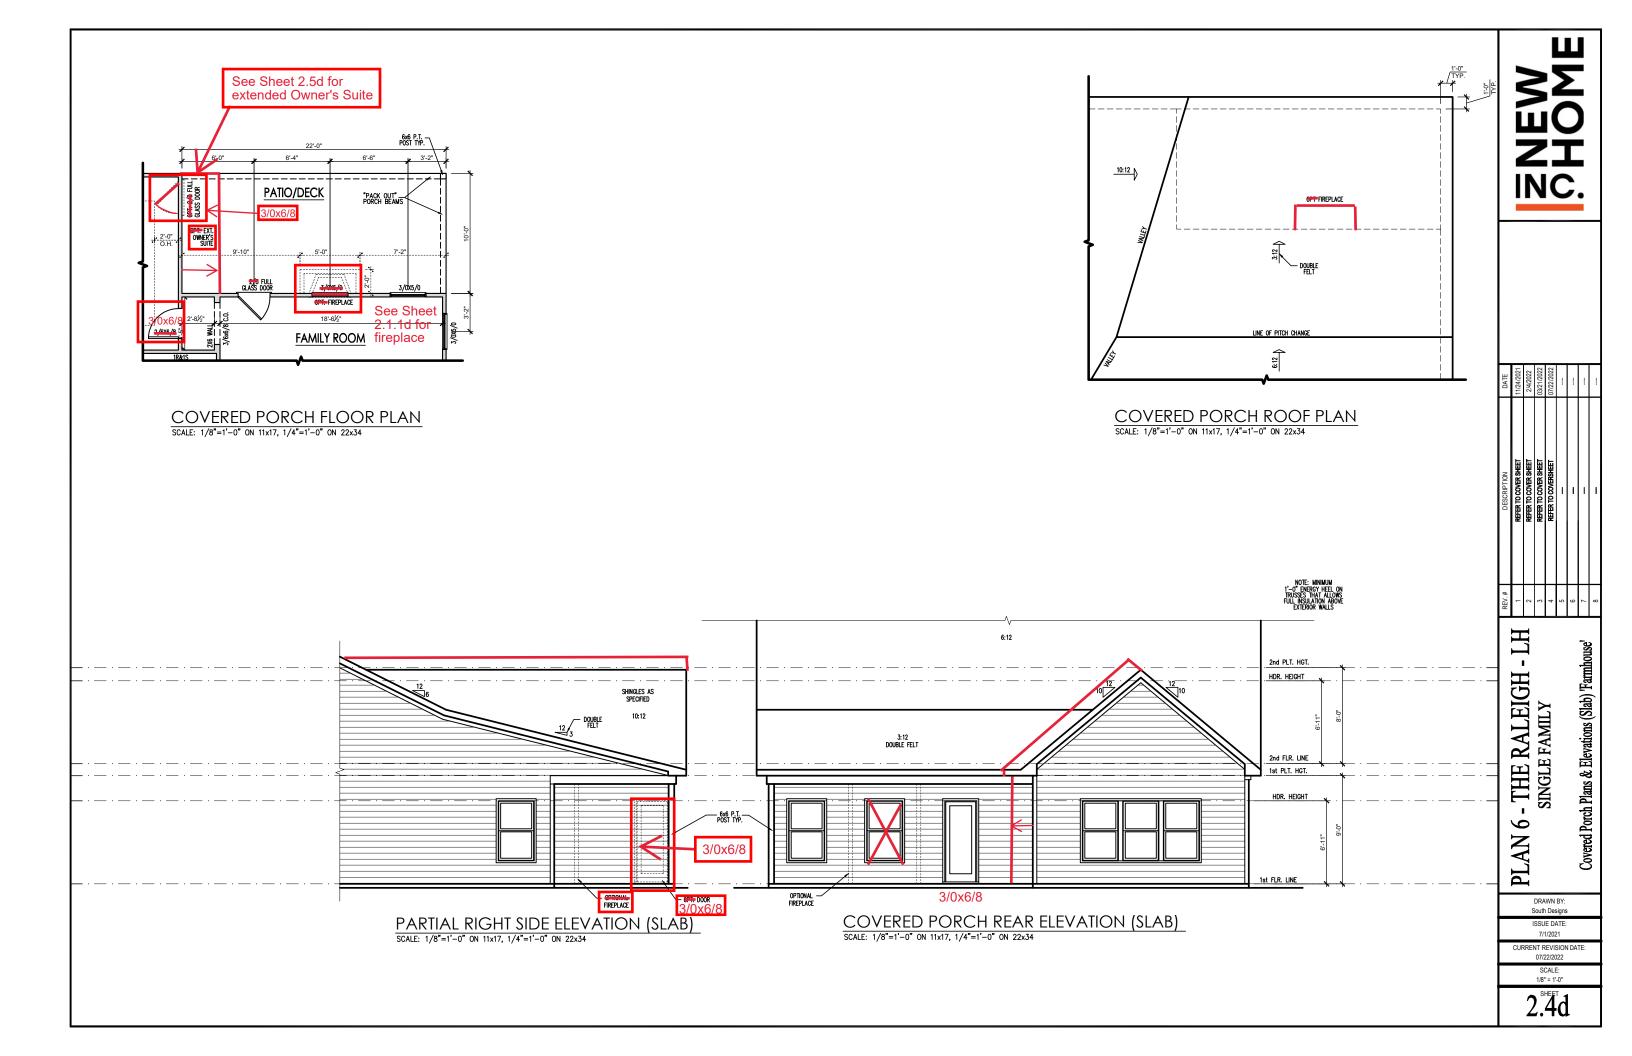


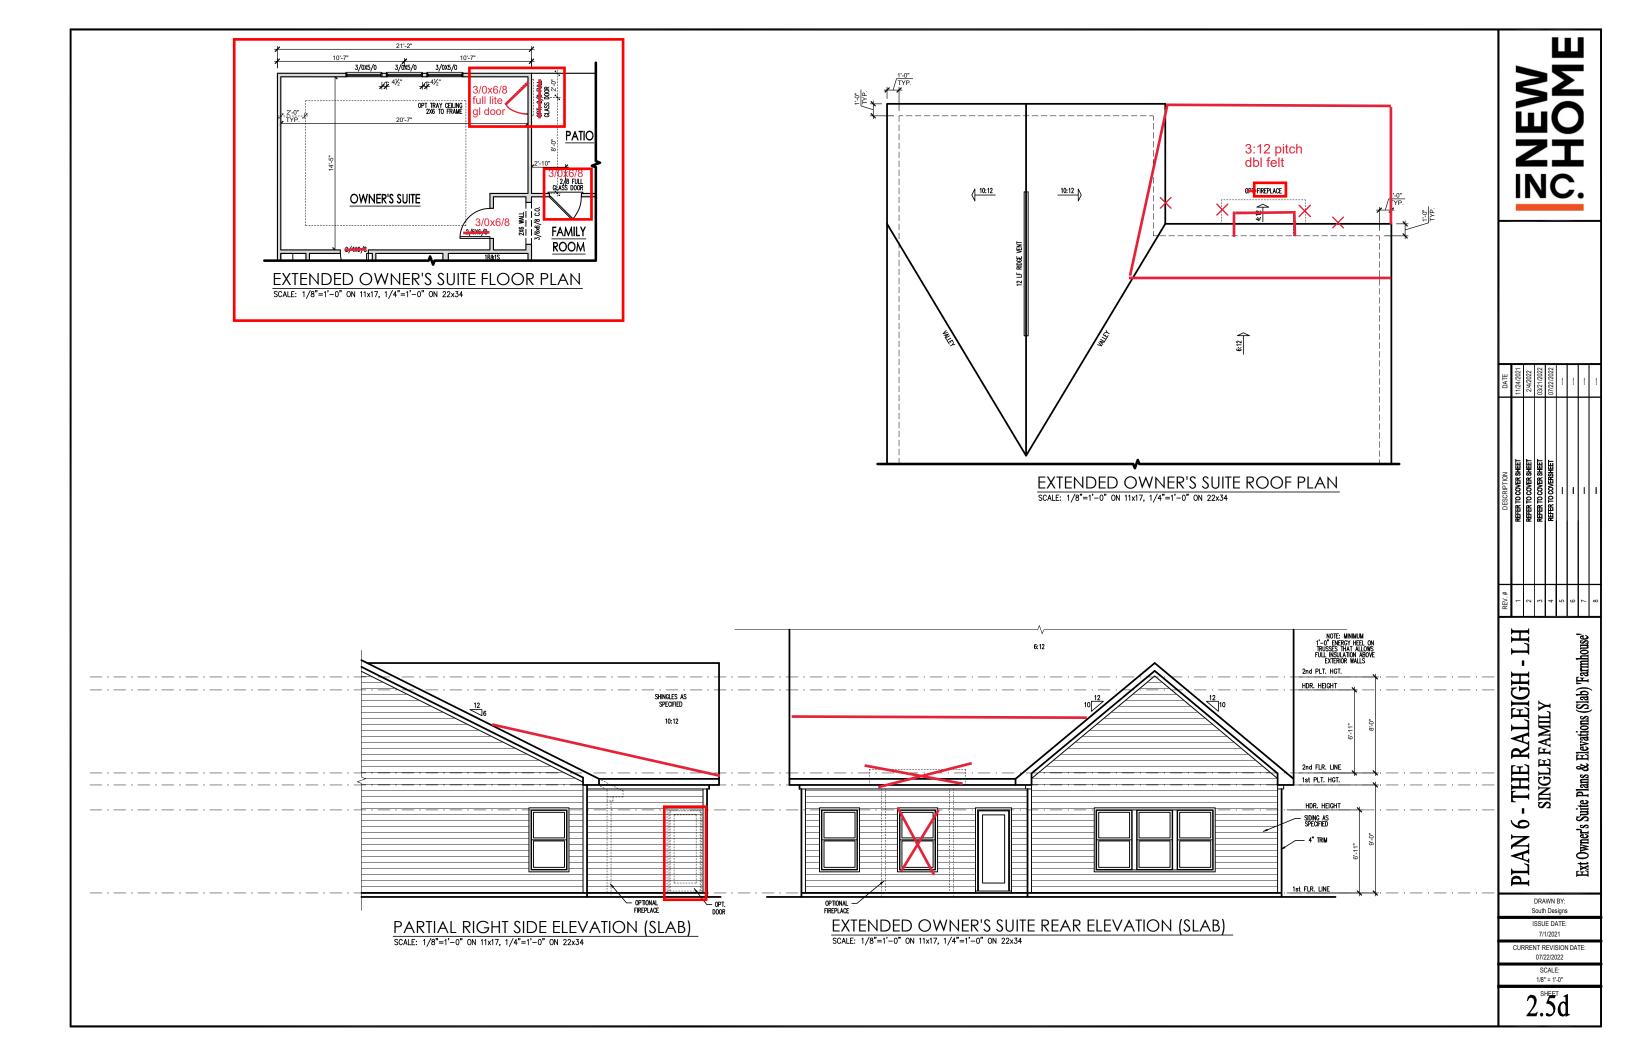


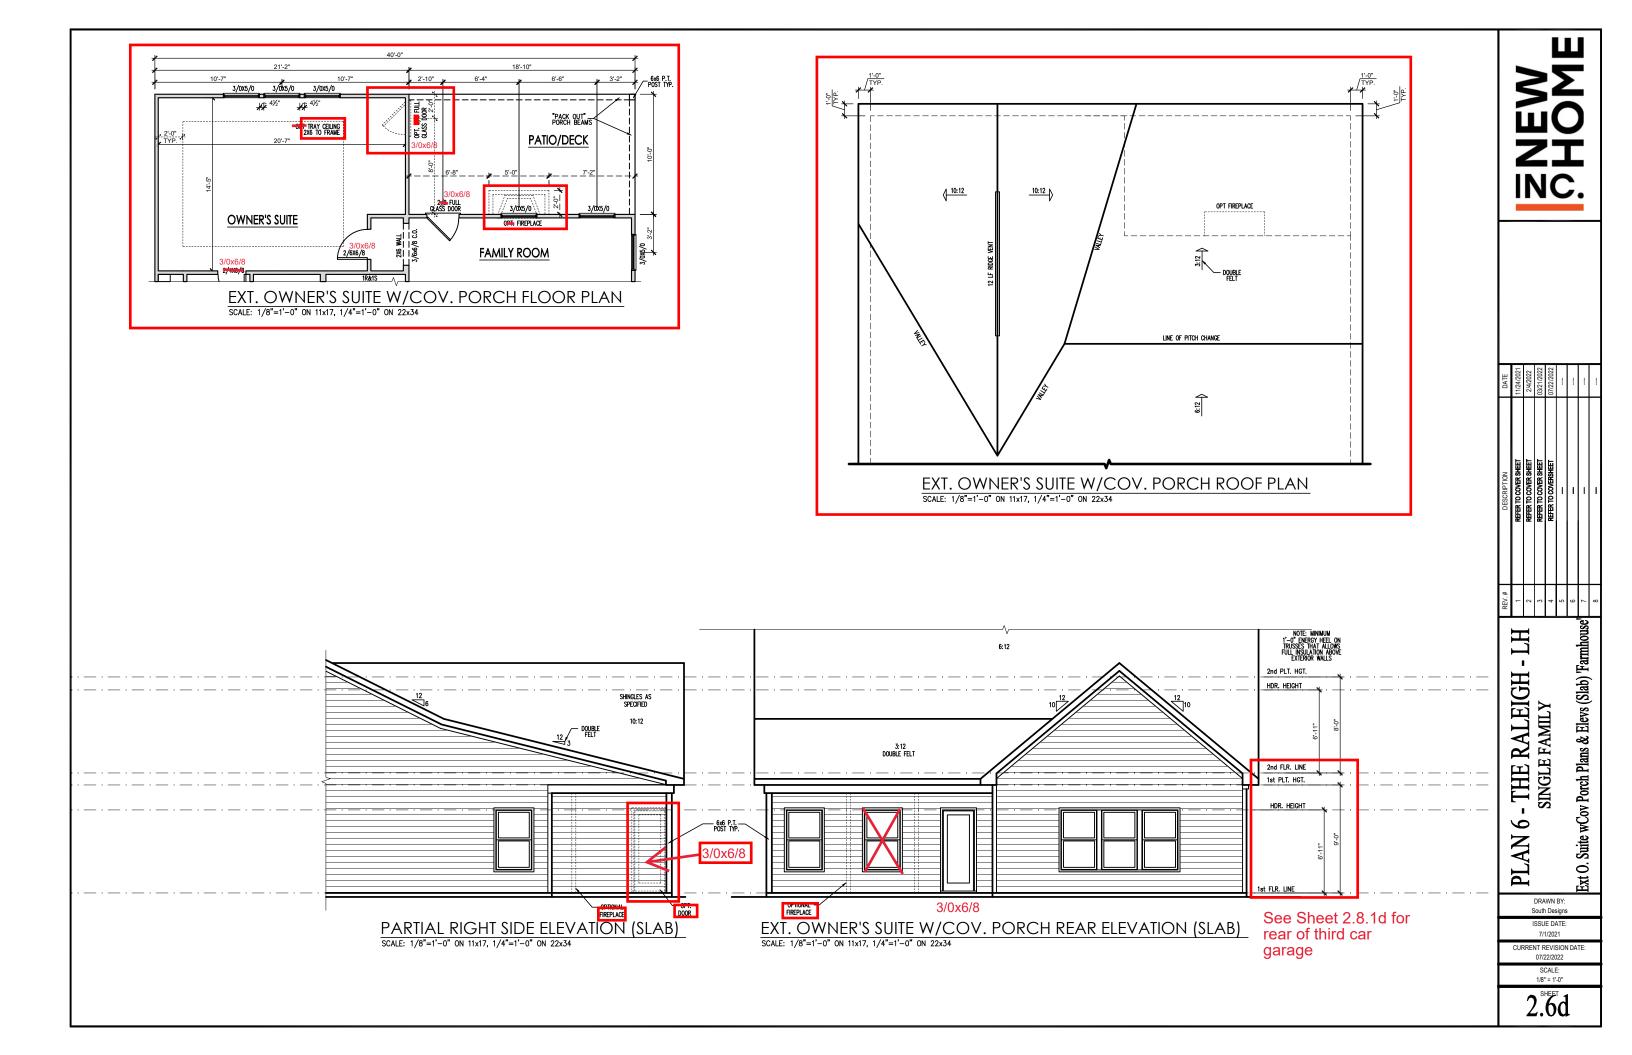

			A	TTIC '	VENT S	CHEDU	LE		
				'LOW C	EARMARKO E	OITAV 38 8	1		
MAIN I	HOUSE SQ FTG 260 AT / NEAR RIDGE AT / NEAR EAVE								
VENT TYPE	SQ. REQU		SQ. FT.	PERCENT OF TOTAL	POT LARGE (SQ. FT. EACH)	POT SMALL (SQ. FT. EACH)	RIDGE VENT (SQ. FT. PER LF)	EAVE VENT (SQ. IN. EACH)	CONT. VENT (SQ. IN. PER LF)
72.11	RAN		SUPPLIED	SUPPLIED	0.4236	0.2778	0.125	0.1944	0.0625
RIDGE VENT	0.35	0.43	1.00	44.44	0	0	8.00		
SOFFIT VENTS	0.52	0.43	1.25	55.56				0	20.00
TOTAL (MIN)	0.87	0.87	2.25	100.00	POT VENTS MAY BE	REQUIRED IF THERE	IS INSUFFICIENT RID	GE AVAILABLE	

^{*} SCHEDULE HAS BEEN CALCULATED ASSUMING EAVE VENTILATION AT 50-60% OF TOTAL AND RIDGE AT 40-50% OF TOTAL REQUIRED VENTILATION

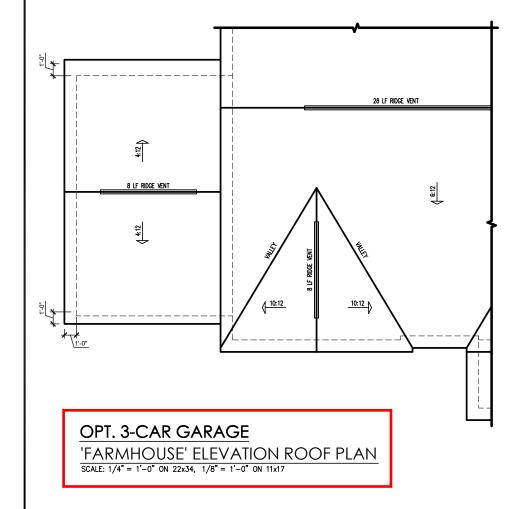

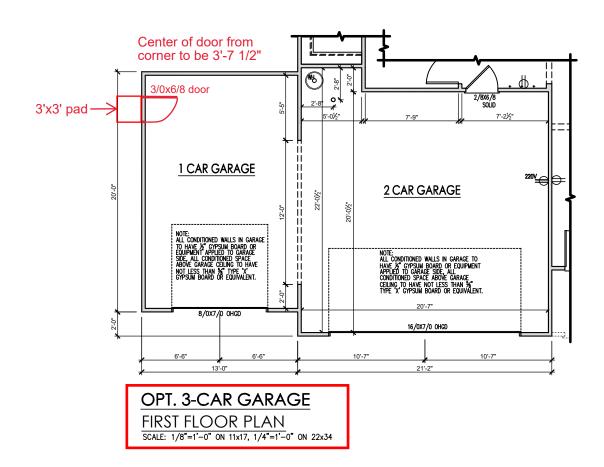



DATE	11/24/2021	2/4/2022	03/21/2022	07/22/2022				!
DESCRIPTION	REFER TO COVER SHEET	REFER TO COVER SHEET	REFER TO COVER SHEET	REFER TO COVERSHEET	amma .			1
REV.#	-	2	3	4	5	9	7	8


PLAN 6 - THE RALEIGH - LH
SINGLE FAMILY
3-Car Garage Plans 'Farmhouse'

DRAWN BY: South Designs

ISSUE DATE: 7/1/2021

CURRENT REVISION DATE: 07/22/2022 SCALE: 1/8" = 1'-0"

2.8d

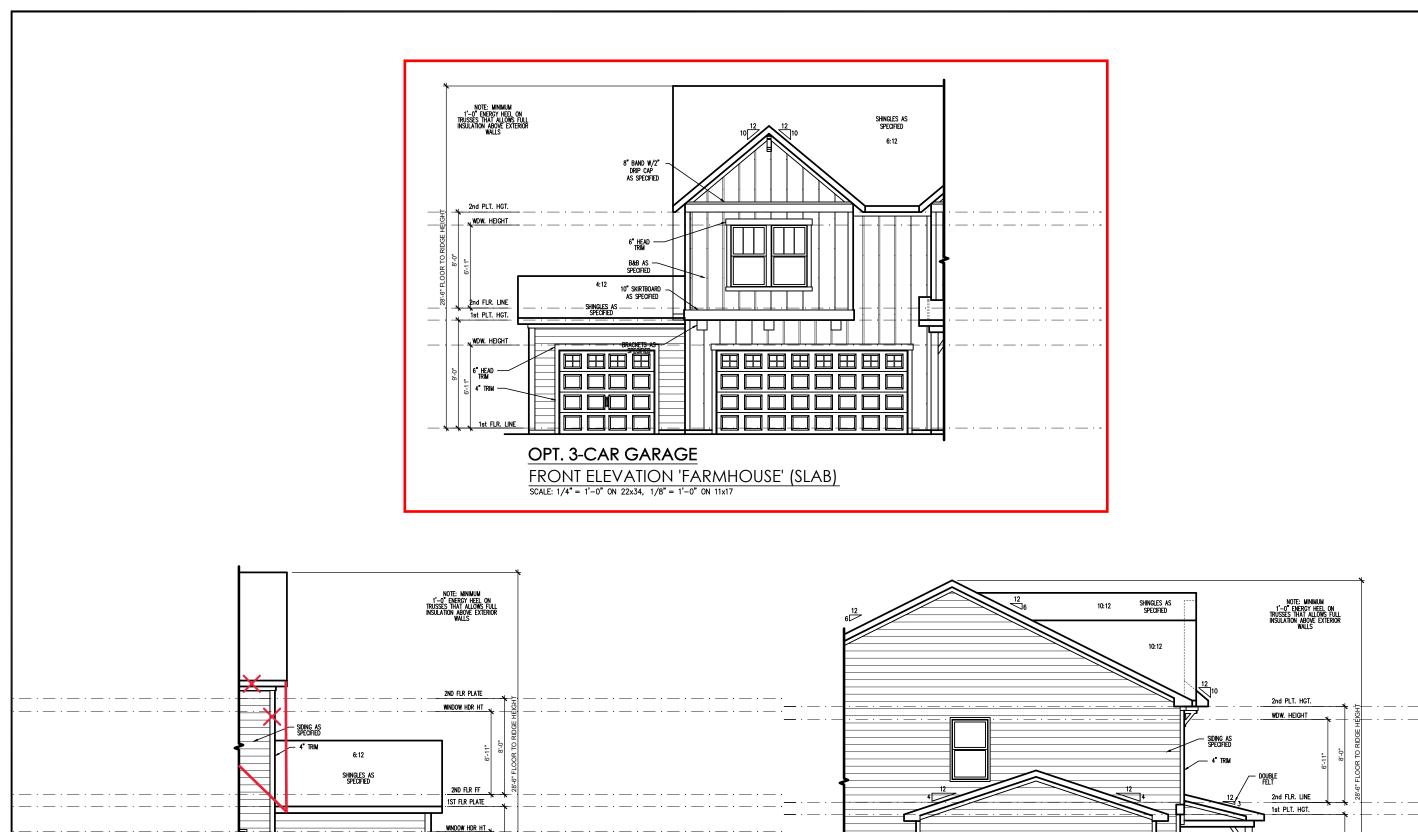

3/0x6/0 door

w/ 3'x3' pad

OPT. 3-CAR GARAGE

SCALE: 1/4" = 1'-0" ON 22x34, 1/8" = 1'-0" ON 11x17

LEFT SIDE ELEVATION 'FARMHOUSE' (SLAB)

OPT. 3-CAR GARAGE

 $\frac{\mathsf{REAR}\;\mathsf{ELEVATION}\;\mathsf{(SLAB)}}{\mathsf{SCALE:}\;1/4"=\;1'-0"\;\mathsf{ON}\;\;22x34,\;\;1/8"=\;1'-0"\;\mathsf{ON}\;\;11x17}$

PLAN 6 - THE RALEIGH - LH

SINGLE FAMILY
SINGLE FAMILY

3-Car Garage Elevations 'Farmhouse' Slab

6"x6" P.T. POST W/ 1X WRAP

1st FLR. LINE

2.8.2d

SCALE: 1/8" = 1'-0"

General Elevation Notes

General Elevation Notes shall apply unless noted otherwise on plan.

- Roof shall be finished with architectural composition shingles with slopes as noted on plan.
- Ridge Vent shall be provided and installed on all ridges greater than 6' in length per manufacturer's specifications.
- 3. Soffit Vent shall be continuous soffit vent
- House Wrap, "tyvek" or approved equal shall be installed over entire exterior wall per manufacturer's specifications and recommendations.
- Flashing shall be provided above all door and window openings, above finish wall material changes and at wall surfaces where lower roof areas abut vertical wall surfaces.
- Porch Raillings shall be provided at all porch walking surfaces greater than 30" above adjacent finished grade. It shall be 36" high with guards spaced no more than 4" apart. Consult community specifications for material.
- Finish Wall Material shall be as noted on elevation drawings.
- 8. Brick Veneer, if included on elevation shall be fied to wall surface with galvanized corrugated metal fies at a rate of 24" oc horizontally and 16" oc vertically so that no more than 2.67st of brick is supported by (1) fie. Space between face of wall and back face of brick shall be limited to a maximum of 1". Fashing shall be provided behind brick above all wall openings and at base of brick wall. Flashing shall be a minimum of 6-mill poly or other corrosion resistant material and shall be installed so that it laps under the house wrap material a minimum of 2".

 Weepholes shall be provided at a rate of 48" oc and shall not be less than 3/16" in diameter and shall be located immediately above flashing.
- Brick Veneer Support Lintels shall be provided if brick veneer is included on elevation. Lintels shall be provided as listed in the following schedule and shall have a minimum bearing length of 6". Masony Lintels shall be provided so that deflection is limited to 1/800.

Masonry Opening Lintel Schedule

Opening Size Angle

up to 4'-0" 3-1/2" x 3-1/2" x 5/16" 4'-1" to 5'-6" 4" x 3-1/2" x 5/16" LLV 5'-7" to 6'-6" 5" x 3-1/2" x 5/16" LLV 6'-7" to 8'-5" to 16'-4" 7" x 4" x 3/8" LLV



See Sheet 2.8.1 for Third Car Grage

FRONT ELEVATION 'FARMHOUSE' (SLAB)
SCALE: 1/4" = 1'-0" ON 22x34, 1/8" = 1'-0" ON 11x17

AND NC.

REV.#	DESCRIPTION	DATE
1	REFER TO COVER SHEET	11/24/2021
2	REFER TO COVER SHEET	2/4/2022
3	REFER TO COVER SHEET	03/21/2022
4	REFER TO COVERSHEET	07/22/2022
2		
9	-	
7	-	
8	-	-

PLAN 6 - THE RALEIGH - LH SINGLE FAMILY

Front & Rear Elevations (Slab) 'Farmhouse'

DRAWN BY: South Designs

ISSUE DATE: 7/1/2021

CURRENT REVISION DATE: 07/22/2022 SCALE: 1/8" = 1'-0"

3.Îd

General Elevation Notes


General Elevation Notes shall apply unless noted otherwise on plan.


- Roof shall be finished with architectural composition shingles with slopes as noted on plan.
- Ridge Vent shall be provided and installed on all ridges greater than 6' in length per manufacturer's specifications.
- 3. Soffit Vent shall be continuous soffit vent
- House Wrap, "tyvek" or approved equal shall be installed over entire exterior wall per manufacturer's specifications and recommendations.
- Flashing shall be provided above all door and window openings, above finish wall material changes and at wall surfaces where lower roof areas abut vertical wall surfaces.
- Porch Raillings shall be provided at all porch walking surfaces greater than 30" above adjacent finished grade. It shall be 36" high with guards spaced no more than 4" apart. Consult community specifications for material.
- Finish Wall Material shall be as noted on elevation drawings.
- 8. Brick Veneer, if included on elevation shall be fied to wall surface with galvanized corrugated metal fies a rate of 24" oc horizontally and 16" oc vertically so that no more than 2.67sf of brick is supported by (1) fie. Space between face of wall and back face of brick shall be limited to a maximum of 1". Flashing shall be provided behind brick above all wall openings and at base of brick wall. Flashing shall be a minimum of 6-mil poly or other corrosion resistant material and shall be installed so that it laps under the house wrap material a minimum of 2".

 Weepholes shall be provided at a rate of 48" oc and shall not be less than 3/16" in diameter and shall be located immediately above flashing.
- Brick Veneer Support Lintels shall be provided if brick veneer is included on elevation. Lintels shall be provided as listed in the following schedule and shall have a minimum bearing length of 6". Masonry Lintels shall be provided so that deflection is limited to 1/600.

Masonry Opening Lintel Schedule

	, -	
Opening	Size	Angle
up to 4'-0 4'-1" to 5'-7" to 6'-7" to 8'-5" to	" 5'-6" 6'-6"	3-1/2" x 3-1/2" x 5/16" 4" x 3-1/2" x 5/16" LLV 5" x 3-1/2" x 5/16" LLV 6" x 3-1/2" x 5/16" LLV 7" x 4" x 3/8" LLV

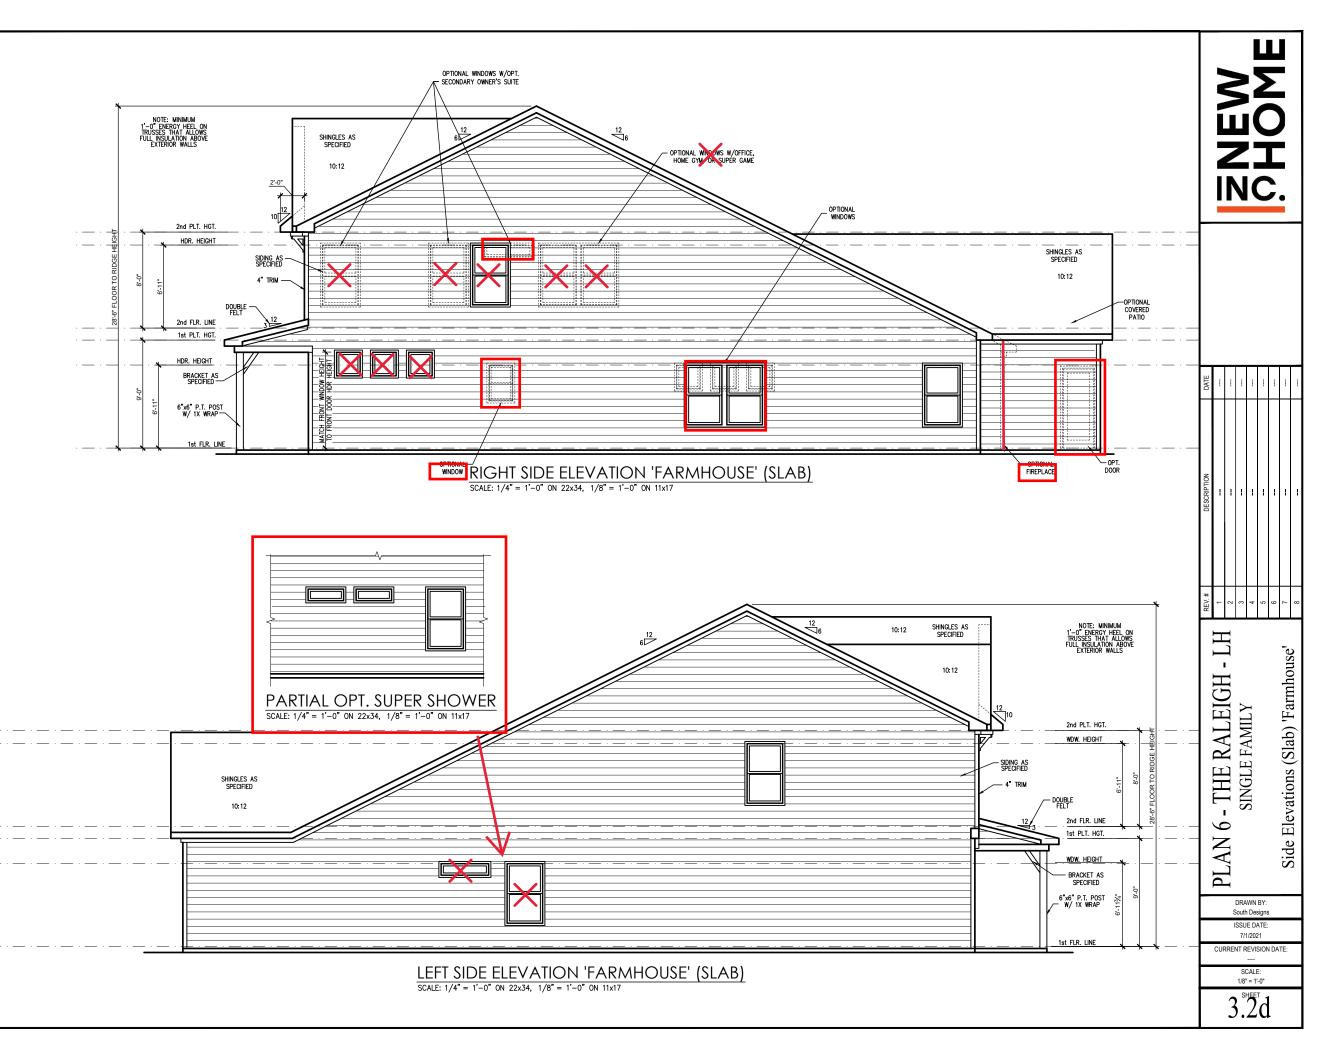

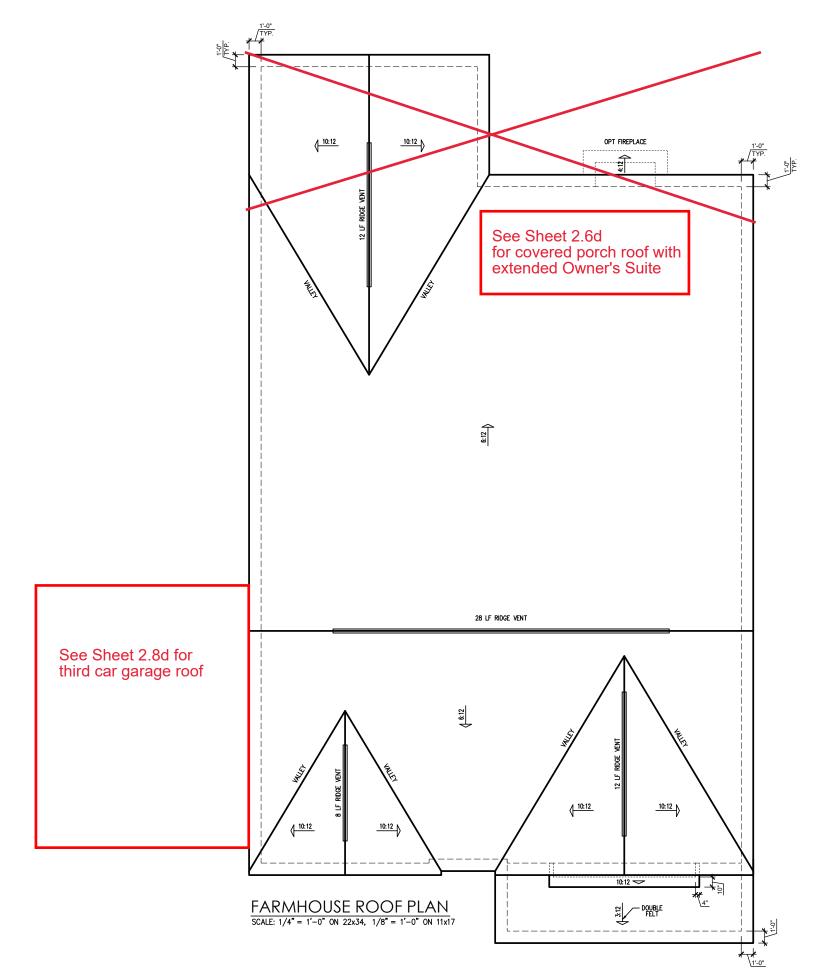

				TTIC '	VENT S	CHEDU	LE		
					FARMHOL	JSE			
MAIN	HOUSE		SQ FTG	2431	AT	/ NEAR RID	GE	AT / NE	AR EAVE
VENT TYPE	SQ. REQL		SQ. FT.	PERCENT OF TOTAL	POT LARGE (SQ. FT. EACH)	POT SMALL (SQ. FT. EACH)	RIDGE VENT (SQ. FT. PER LF)	EAVE VENT (SQ. IN. EACH)	CONT. VENT (SQ. IN. PER LF)
72.11.11.2	RAN		SUPPLIED	SUPPLIED	0.4236	0.2778	0.125	0.1944	0.0625
RIDGE VENT	3.24	4.05	7.50	72.29	0	0	60.00		
SOFFIT VENTS	4.86	4.05	2.88	27.71				0	46.00
TOTAL (MIN)	8.10	8.10	10.38	100.00	POT VENTS MAY BE	REQUIRED IF THERE	IS INSUFFICIENT RID	GE AVAILABLE	

* SCHEDULE HAS BEEN CALCULATED ASSUMING EAVE VENTILATION AT 50-60% OF TOTAL AND RIDGE AT 40-50% OF TOTAL REQUIRED VENTILATION

MEW MOHC:

DATE	11/24/2021	2/4/2022	03/21/2022	07/22/2022				
DESCRIPTION	REFER TO COVER SHEET	REFER TO COVER SHEET	REFER TO COVER SHEET	REFER TO COVERSHEET	-	_	-	-
REV.#	-	2	3	4	5	9	7	8


PLAN 6 - THE RALEIGH - LH
SINGLE FAMILY
Roof Plan 'Farmhouse'


DRAWN BY: South Designs


ISSUE DATE: 7/1/2021


CURRENT REVISION DATE: 07/22/2022 SCALE: 1/8" = 1'-0"

3.3d

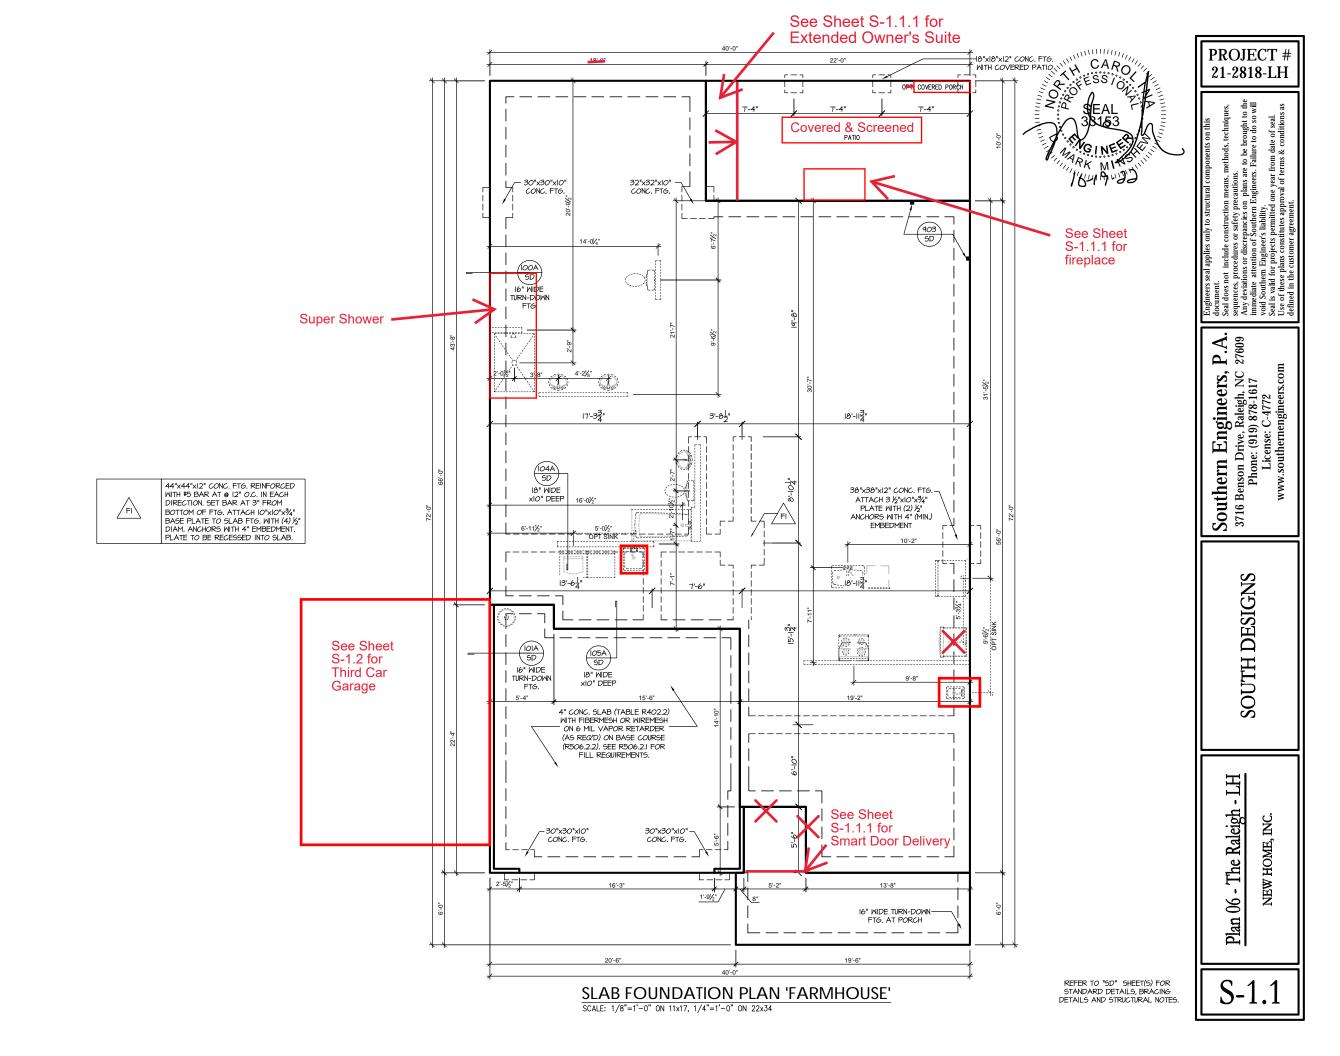

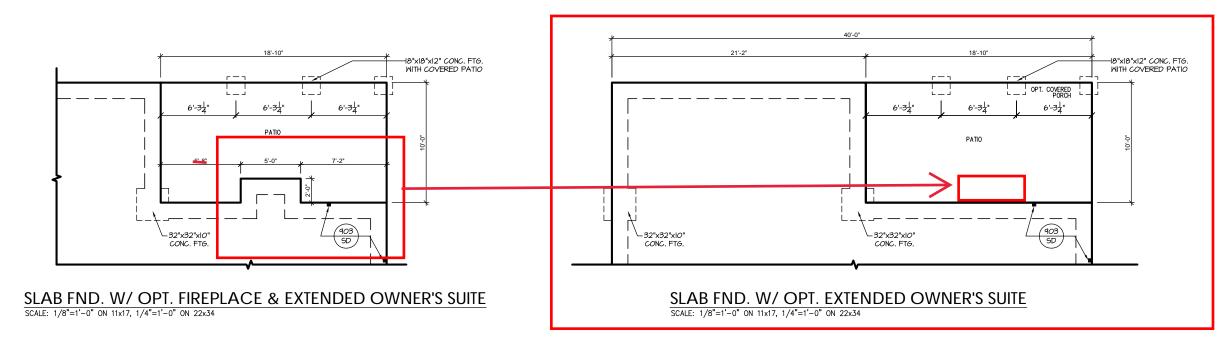


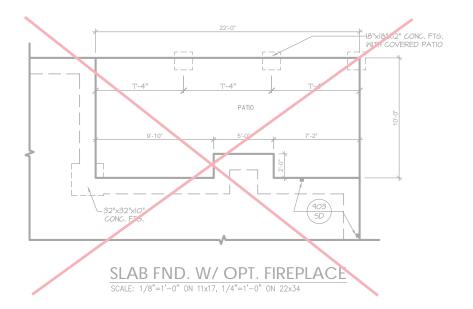


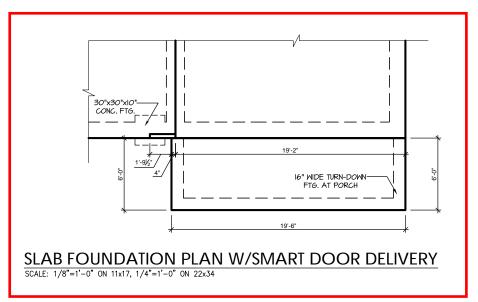

PROJECT # 21-2818-LH

Southern Engineers, P.A. 3716 Benson Drive, Raleigh, NC 27609 Phone: (919) 878-1617 License: C-4772 www.southernengineers.com

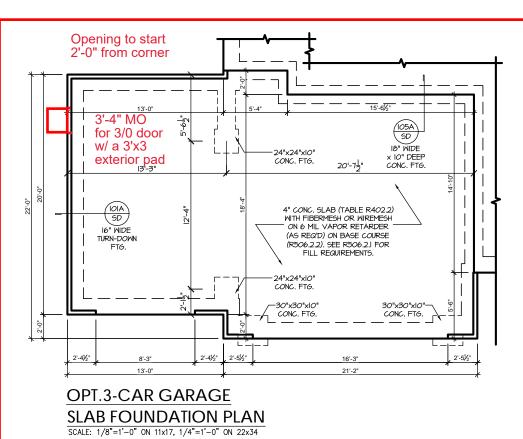

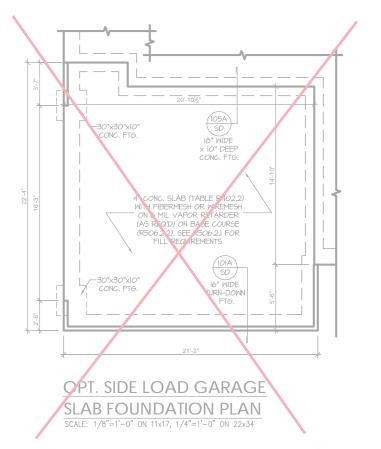

3'x3' pad

SOUTH DESIGNS

Southern Engineers, P.A. 3716 Benson Drive, Raleigh, NC 27609 Phone: (919) 878-1617 License: C-4772 www.southernengineers.com

PROJECT # 21-2818-LH

Plan 06 - The Raleigh - L.H NEW HOME, INC.

S-1.1.2

REFER TO "SD" SHEET(S) FOR STANDARD DETAILS, BRACING DETAILS AND STRUCTURAL NOTES.

MOOD I-JOISTS

(SHALL BE ONE OF THE FOLLOWING):

TJI 210 BY TRUS JOIST

- LPI 20 PLUS BY LP
- ALL MOOD I-JOISTS SHALL BE INSTALLED ACCORDING TO MANUFACTURER'S SPECIFICATIONS.
- INSTALL SQUASH BLOCKS, WEB STIFFENERS, ETC.
 AS REQUIRED BY AND ACCORDING TO THE I-JOIST MANUFACTURER'S SPECIFICATIONS AND
- HANGERS FOR I-JOISTS ARE THE RESPONSIBILITY OF THE I-JOIST SUPPLIER.
- FLOOR TRUSSES BY MANUFACTURER MAY BE SUBSTITUTED FOR I-JOISTS

TRUSS SYSTEM REQUIREMENTS

NC (2018 NCRC): Wind: 115-120 mph

- TRUSS SYSTEM LAYOUTS (PLACEMENT PLANS) SHALL BE DESIGNED IN ACCORDANCE WITH SEALED TRUSSES SHALL BE COORDINATED WITH SOUTHERN
- TRUSS SCHEMATICS (PROFILES) SHALL BE 2. PREPARED AND SEALED BY TRUSS MANUFACTURER.
- ALL TRUSSES SHALL BE DESIGNED FOR BEARING ON SPF #2 OR #3 PLATES OR LEDGERS (UNO).
- ALL REQUIRED ANCHORS FOR TRUSSES DUE TO UPLIFT OR BEARING SHALL MEET THE REQUIREMENTS AS SPECIFIED ON THE TRUSS SCHEMATICS.

FRAMING NOTES

NC (2018 NCRC): Wind: 115-120 mph

- BRACING METHOD AND TYPE: CONTINUOUSLY SHEATHED WSP: CS-MEP. NOTE THAT THE WALL BRACING AMOUNT PROVIDED ON THE PLANS (DETAILS AND SPECIFICATIONS) IS GREATER THAN THE AMOUNT OF WALL BRACING REQUIRED BY SECTION R602.10 OF THE CODE. SEE NOTES BELOW FOR DETAILS AND SPECIFICATIONS FOR WALL BRACING AND WALL FRAMING
- 2. EXTERIOR WALL SHEATHING: WALLS SHALL BE BRACED BY SHEATHING WALLS ON ALL STORIES WITH WOOD STRUCTURAL PANEL SHEATHING (WSP) (EXPOSURE B: 7/16". EXPOSURE C: 15/32"). SHEATHING SHALL BE ATTACHED WITH 8d NAILS AT A 6"/12" NAILING PATTERN (6" OC AT PANEL EDGES AND 12" OC AT INTERMEDIATE SUPPORTS). INSTALL BLOCKING AT ALL PANEL EDGES.
- 3. WSP SHEATHING SHALL EXTEND TO THE UPPERMOST DOUBLE BEARING PLATE, BLOCK AT ROOF PER SECTION R602.10.4.5 AND ATTACH BRACED WALLS PER CODE, WSP SHEATHING BETWEEN FLOORS SHALL BE SPLICED ALONG CONTINUOUS BAND OR THE WSF SHEATHING MAY BE SPLICED ACROSS STUDS (CONTINUOUS ACROSS FLOOR SYSTEM) WITH BLOCKING AT PANEL EDGES. (MINIMUM 12" BEYOND FLOOR BREAK) OR OTHER APPROVED METHOD.
- 4. "HD" = HOLDOWN: HOLD-DOWN DEVICE (NOTED AS "HD" ON PLANS) SHALL BE AN 800 POUND CAPACITY ASSEMBLY AS NOTED ON PLANS, SEE DETAILS FOR HD ASSEMBLY.

 **GROUND/FIRST FLOOR: USE "HD HOLD-DOWN DETAIL" ON SD
- SHEET (OR EQUIV.)

 **UPPER FLOORS: ATTACH BASE OF KING STUD WITH A SIMPSON
- C522 STRAP DOWN ACROSS THE BAND AND DOWN TO A STUD BELOW OR HEADER BELOW. EXTEND STRAP 7" MIN ALONG EACH STUD (OR HEADER) AND ATTACH EACH END W/ (7) 8d NAILS.
- 5. INTERIOR BRACED WALL: (NOTED AS "IBM" ON PLANS) ATTACH I/2" GYPSUM BOARD (6B) ON EACH SIDE OF WALL WITH A MIN. OF 5d COOLER NAILS OR #6 SCREWS @ 7" O.C. ALONG THE EDGES AND AT
- 6. INTERIOR BRACED WALL-WOOD STRUCTURAL PANEL: (NOTED AS "IBW-MSP" ON PLANS). ATTACH ONE SIDE WITH %" MSP SHEATHING WITH 8d NAILS AT A 6"/12" NAILING PATTERN (6" OC AT PANEL EDGES AND 12" OC AT INTERMEDIATE SUPPORTS), INSTALL BLOCKING AT ALL PANEL EDGES, ATTACH OB OVER MSP AS REQUIRED, ATTACH OPPOSITE SIDE WITH 1/2" OB WITH A MIN, OF 5d COOLER NAILS OR #6 SCREWS @ 7" OC ALONG THE EDGES AND AT

PORCH POST NOTES:

- 4"x4" (6"x6") TRT'D POST (OR EQUAL)
- ATTACH TRUSSES (RAFTERS) AT PORCH WITH HURRICANE CONNECTORS.
 POST CAP: SIMPSON AC4-MAX (AC6-MAX)
- POST CAP AT CORNER: (2) SIMPSON LCE4
 (MITER HEADER AT CORNER). HIGH WIND; ADD (I)
- 3. POST BASE: SIMPSON ABU44 (ABU66).
- MONO: 5/8" ANCHOR (EMBED 7") CMU: 5/8" ANCHOR (EXTEND TO FOOTING -HIGH WIND ONLY)
- 4. POST BASE: WOOD FOUNDATION: (2) SIMPSON CSI6 STRAPS AT POSTS. EXTEND I2" ONTO EACH POST (UPPER AND LOWER) OR TO GIRDER
- NOTE: EQUIVALENT POST CAP AND BASE ACCEPTABLE.


HEADER/BEAM & COLUMN NOTES

- ALL EXTERIOR AND LOAD BEARING HEADERS SHALL BE MIN. (2)2x6 (4" WALL) OR (3)2x6 (6" WALL) WITH (1) SUPPORT STUD, UNLESS NOTED OTHERWISE
- 2. THE NUMBER SHOWN AT BEAM AND HEADER SUPPORTS INDICATES THE NUMBER OF SUPPORT STUDS REQUIRED IN STUD POCKET OR COLUMN. THE NUMBER OF KING STUDS AT EACH END OF HEADERS IN EXTERIOR WALLS SHALL BE ACCORDING TO ITEM "d" IN TABLE R602.3(5) OR AS BELOW PER NCDOI COMMENTARY "KING STUDS AT WALL OPENINGS" REVISED 1-9-2020:
- UP TO 3' SPAN: (I) KING STUD
- OVER 3' UP TO 6' SPAN: (2) KING STUDS
- OVER 6' UP TO 9' SPAN: (3) KING STUDS OVER 9' UP TO 12' SPAN: (4) KING STUDS
- OVER 12' UP TO 15' SPAN: (5) KING STUDS

See Sheet S-2.1.2

Garage

for Third Car

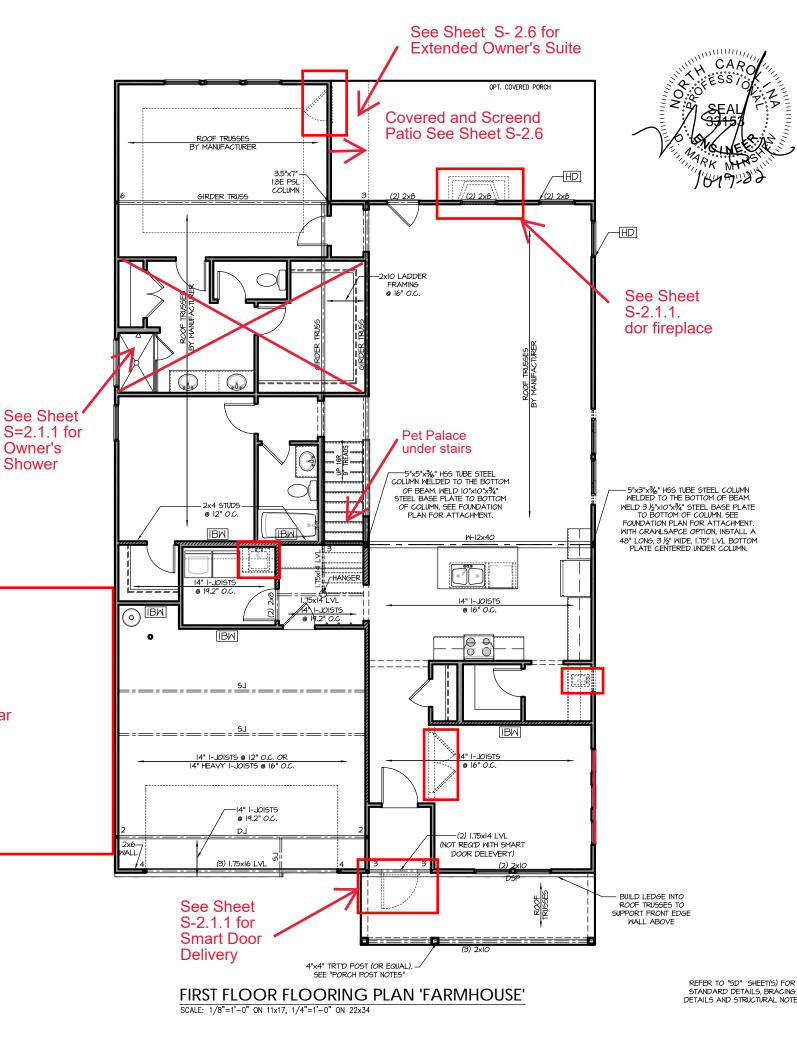

PROJECT # 21-2818-LH


e to be brought to the Failure to do so will one year from date of seal.

docu Seal Seal Any imm imm void Void

P.A. 27609 Engineers, Drive, Raleigh, NC e: (919) 878-1617 Southern Engi 3716 Benson Drive, Ra Phone: (919) 8


SOUTH DESIGNS


Raleigh HOME,

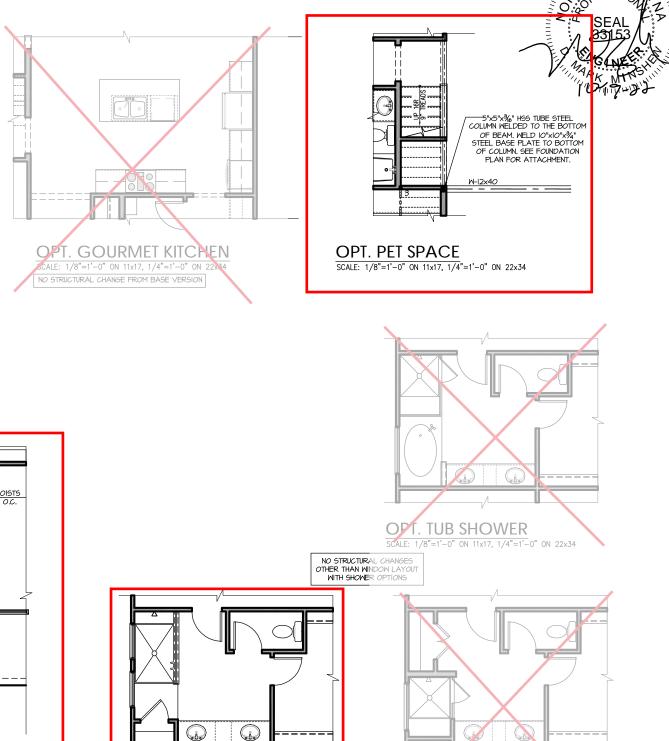

OPT. SUPER SHOWER

SCALE: 1/8"=1'-0" ON 11x17, 1/4"=1'-0" ON 22x34

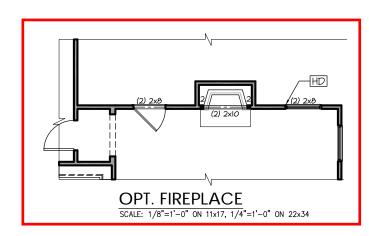

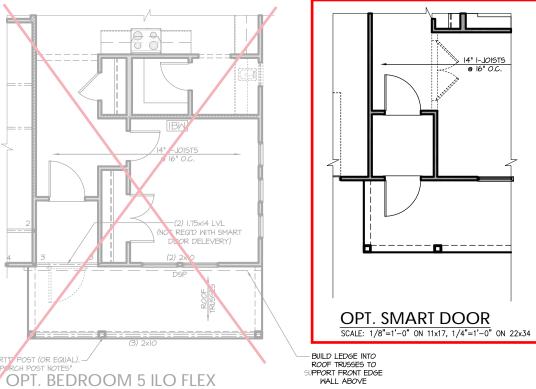

SCALE: 1/8"=1'-0" ON 11x17, 1/4"=1'-0" ON 22x34

OPT. SHOWER SCALE: /8"=1'-0" ON 11x17, 1/4"=1'-0" ON 22x34

REFER TO "SD" SHEET(S) FOR STANDARD DETAILS, BRACING DETAILS AND STRUCTURAL NOTES.

- The Raleigh


Plan 06


NEW HOME, INC.

PROJECT # 21-2818-LH

Southern Engineers, P.A. 3716 Benson Drive, Raleigh, NC 27609 Phone: (919) 878-1617 License: C-4772 www.southernengineers.com

SOUTH DESIGNS

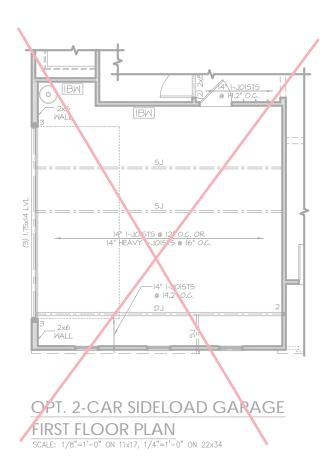

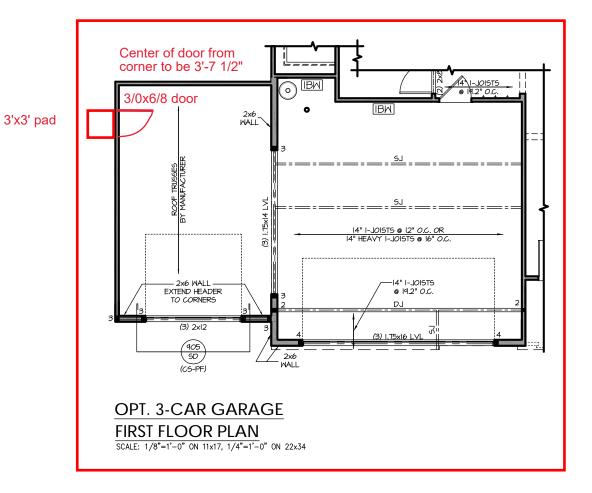

Southern Engineers, P.A. 3716 Benson Drive, Raleigh, NC 27609 Phone: (919) 878-1617 License: C-4772 www.southernengineers.com

PROJECT # 21-2818-LH

SOUTH DESIGNS

The Raleigh NEW HOME, INC.

Plan 06

REFER TO "SD" SHEET(S) FOR STANDARD DETAILS, BRACING DETAILS AND STRUCTURAL NOTES.

TRUSS SYSTEM REQUIREMENTS

NC (2018 NCRC): Wind: 115-120 mph

- TRUSS SYSTEM LAYOUTS (PLACEMENT PLANS) SHALL BE DESIGNED IN ACCORDANCE WITH SEALED STRUCTURAL PLANS. ANY NEED TO CHANGE TRUSSES SHALL BE COORDINATED WITH SOUTHERN
- 2. TRUSS SCHEMATICS (PROFILES) SHALL BE PREPARED AND SEALED BY TRUSS MANUFACTURER.
- ALL TRUSSES SHALL BE DESIGNED FOR BEARING ON SPF #2 OR #3 PLATES OR LEDGERS (UNO).
- ALL REQUIRED ANCHORS FOR TRUSSES DUE TO UPLIFT OR BEARING SHALL MEET THE REQUIREMENTS AS SPECIFIED ON THE TRUSS SCHEMATICS.

HEADER/BEAM & COLUMN NOTES


- ALL EXTERIOR AND LOAD BEARING HEADERS SHALL BE MIN. (2)2x6 (4" WALL) OR (3)2x6 (6" WALL) WITH (1) SUPPORT STUD, UNLESS NOTED OTHERWISE.
- 2. THE NUMBER SHOWN AT BEAM AND HEADER SUPPORTS INDICATES THE NUMBER OF SUPPORT STUDS REQUIRED IN STUD POCKET OR COLUMN. THE NUMBER OF KING STUDS AT EACH END OF HEADERS IN EXTERIOR WALLS SHALL BE ACCORDING TO ITEM "d" IN TABLE R602.3(5) OR AS BELOW PER NCDOI COMMENTARY "KING STUDS AT WALL OPENINGS" REVISED 1-9-2020:
- UP TO 3' SPAN: (I) KING STUD
- OVER 3' UP TO 6' SPAN: (2) KING STUDS
- OVER 6' UP TO 9' SPAN: (3) KING STUDS OVER 9' UP TO 12' SPAN: (4) KING STUDS
- OVER 12' UP TO 15' SPAN: (5) KING STUDS

FRAMING NOTES

NC (2018 NCRC): Wind: 115-120 mph

- BRACING METHOD AND TYPE: CONTINUOUSLY SHEATHED WSP: CS-W6P, NOTE THAT THE WALL BRACING AMOUNT PROVIDED ON THE PLANS (DETAILS AND SPECIFICATIONS) IS GREATER THAN THE AMOUNT OF WALL BRACING REQUIRED BY SECTION R602.10 OF THE CODE. SEE NOTES BELOW FOR DETAILS AND SPECIFICATIONS FOR WALL BRACING AND WALL FRAMING
- 2. EXTERIOR WALL SHEATHING: WALLS SHALL BE BRACED BY SHEATHING WALLS ON ALL STORIES WITH WOOD STRUCTURAL PANEL SHEATHING (WSP) (EXPOSURE B: 7/16". EXPOSURE C: 15/32"). SHEATHING SHALL BE ATTACHED WITH 6d NAILS AT A 6"/12" NAILING PATTERN (6" OC AT PANEL EDGES AND 12" OC AT INTERMEDIATE SUPPORTS). INSTALL BLOCKING AT ALL PANEL EDGES.
- 3. WSP SHEATHING SHALL EXTEND TO THE UPPERMOST DOUBLE BEARING PLATE. BLOCK AT ROOF PER SECTION R602.10.4.5 AND ATTACH BRACED WALLS PER CODE. WSP SHEATHING BETWEEN FLOORS SHALL BE SPLICED ALONG CONTINUOUS BAND OR THE WSP SHEATHING MAY BE SPLICED ACROSS STUDS (CONTINUOUS ACROSS FLOOR SYSTEM) WITH BLOCKING AT PANEL EDGES. (MINIMUM 12" BEYOND FLOOR BREAK) OR OTHER APPROVED METHOD.
- 4. "HD" = HOLDOWN: HOLD-DOWN DEVICE (NOTED AS "HD" ON PLANS) SHALL BE AN 800 POUND CAPACITY ASSEMBLY AS NOTED ON PLANS. SEE DETAILS FOR HD ASSEMBLY.

 **GROUND/FIRST FLOOR: USE "HD HOLD-DOWN DETAIL" ON SD
- **UPPER FLOORS: ATTACH BASE OF KING STUD WITH A SIMPSON C522 STRAP DOWN ACROSS THE BAND AND DOWN TO A STUD BELOW OR HEADER BELOW. EXTEND STRAP 7" MIN ALONG EACH STUD (OR HEADER) AND ATTACH EACH END W/ (7) 8d NAILS.
- 5. INTERIOR BRACED WALL: (NOTED AS "IBW" ON PLANS) ATTACH I/2" GYPSUM BOARD (GB) ON EACH SIDE OF WALL WITH A MIN, OF 5d COOLER NAILS OR #6 SCREWS @ 7" O.C. ALONG THE EDGES AND AT
- 6. INTERIOR BRACED WALL-WOOD STRUCTURAL PANEL: (NOTED AS "IBW-WSP" ON PLANS). ATTACH ONE SIDE WITH % " MSP SHEATHING WITH 8d NAILS AT A 6"/12" NAILING PATTERN (6" OC AT PANEL EDGES AND 12" OC AT INTERMEDIATE SUPPORTS), INSTALL BLOCKING AT ALL PANEL EDGES. ATTACH GB OVER MGP AS REQUIRED. ATTACH OPPOSITE SIDE WITH 1/2" GB WITH A MIN. OF 5d COOLER NAILS OR #6 SCREWS @ 7" OC ALONG THE EDGES AND AT INTERMEDIATE SUPPORTS.

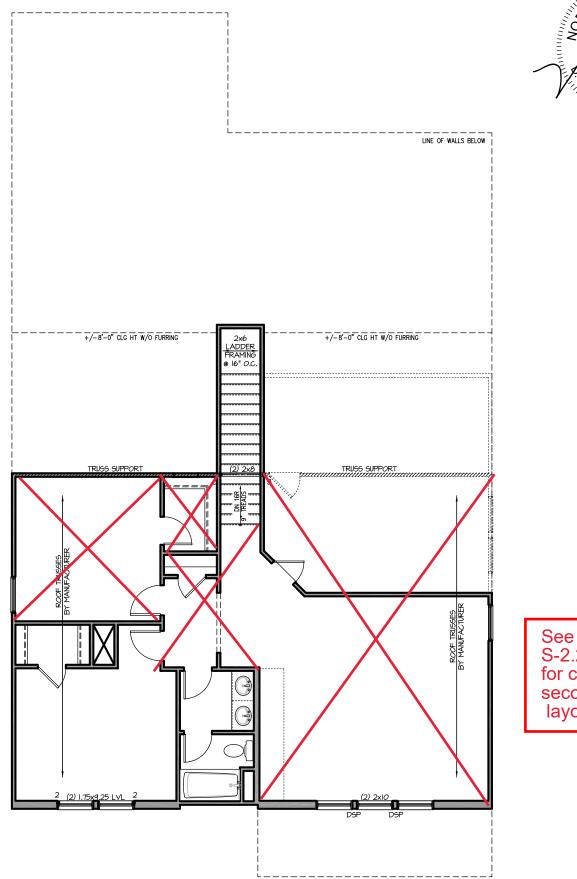

See Sheet S-2.2.2 for correct second floor layout

> REFER TO "SD" SHEET(S) FOR STANDARD DETAILS BRACING

DETAILS AND STRUCTURAL NOTES.

PROJECT # 21-2818-LH

P.A. 27609 Engineers, Drive, Raleigh, NC Southern Engi

SOUTH DESIGNS


Raleigh

SECOND FLOOR FLOORING PLAN 'FARMHOUSE' SCALE: 1/8"=1'-0" ON 11x17, 1/4"=1'-0" ON 22x34

THIS SHEET IS AN ADDENDUM TO THE ORIGINAL PLAN THAT WAS SEALED ON 10-19-22



-2xIO LADDER FRAMING @ 16" O.C. FOR FLOOR OF STORAGE AREA +/-8'-0" CLG HT W/O FURRING +/-8'-0" CLG HT W/O FURRING 2x6 LADDER FRAMING @ 24" O.C. CONTINUOUS (2) 2×8 TRUSS SUPPORT 3'-0" landing with 3/0x6/8 door ROOF TRUSSES BY MANUFACTURER SEE "UPPER FLOORS" OF ITEM #4 OF "FRAMING NOTES" (2) 2xlO ALTERNATE SECOND FLOOR PLAN w/ OPT. SECONDARY OWNER'S SUITE W/ LOFT 'FARMHOUSE' SCALE: 1/8"=1'-0" ON 11x17, 1/4"=1'-0" ON 22x34

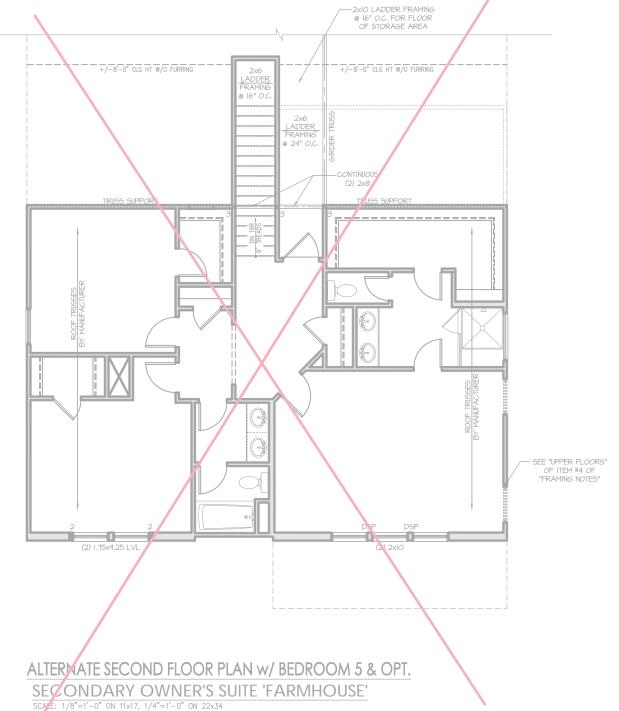

REFER TO "SD" SHEET(S) FOR STANDARD DETAILS, BRACING DETAILS AND STRUCTURAL NOTES. PROJECT # 21-2818-LH

nons.
In sare to be brought to the neers. Failure to do so will year from date of seal.

not include construction means, methods, techni
s, procedures or safety precautions.
tions or discrepancies on plans are to be brought
entering of Southern Frontiers Failure to do s

NC 27609 sequences, procedures of 17
Any deviations or discretimediate attention of 5 void Southern Engineer's Seal is valid for projects 1

Southern Engineers, P
3716 Benson Drive, Raleigh, NC 27
Phone: (919) 878-1617
License: C-4772
www.southernenginers.com

SOUTH DESIGNS

Plan 06 - The Raleigh - Ll-NEW HOME, INC.

S-2.2.2


TRUSS SYSTEM REQUIREMENTS NC (2018 NCRC): Wind: 115-120 mph

- TRUSS SYSTEM LAYOUTS (PLACEMENT PLANS) SHALL BE DESIGNED IN ACCORDANCE WITH SEALED STRUCTURAL PLANS. ANY NEED TO CHANGE TRUSSES SHALL BE COORDINATED WITH SOUTHERN
- TRUSS SCHEMATICS (PROFILES) SHALL BE
 PREPARED AND SEALED BY TRUSS MANUFACTURER.
- ALL TRUSSES SHALL BE DESIGNED FOR BEARING ON SPF #2 OR #3 PLATES OR LEDGERS (UNO).
- ALL REQUIRED ANCHORS FOR TRUSSES DUE TO UPLIFT OR BEARING SHALL MEET THE REQUIREMENTS AS SPECIFIED ON THE TRUSS

ATTIC VENT SCHEDULE													
	FARMHOUSE												
М	MAIN HOUSE			SQ FTG	2431	AT / NEAR RIDGE			AT / NEAR EAVE				
VENT T	iYPE	SQ. FT. REQUIRED RANGE		SQ. FT. SUPPLIED	PERCENT OF TOTAL SUPPLIED	POT LARGE (SQ. FT. EACH)	POT SMALL (SQ. FT. EACH)	RIDGE VENT (SQ. FT. PER LF)	EAVE VENT (SQ. IN. EACH)	CONT. VENT (SQ. IN. PER LF)			
						0.4236	0.2778	0.125	0.1944	0.0625			
RIDGEV	/ENT	3.24	4.05	7.50	72.29	0	0	60.00					
SOFFIT VE	ENTS	4.86	4.05	2.88	27.71				0	46.00			
TOTAL (N	MIN)	8.10	8.10	10.38	100.00	POT VENTS MAY BE REQUIRED IF THERE IS INSUFFICIENT RIDGE AVAILABLE							

* SCHEDULE HAS BEEN CALCULATED ASSUMING EAVE VENTILATION AT 50-60% OF TOTAL AND RIDGE AT 40-50% OF TOTAL REQUIRED VENTILATION

See Sheet S-3.1.2 for third Car Garage Roof

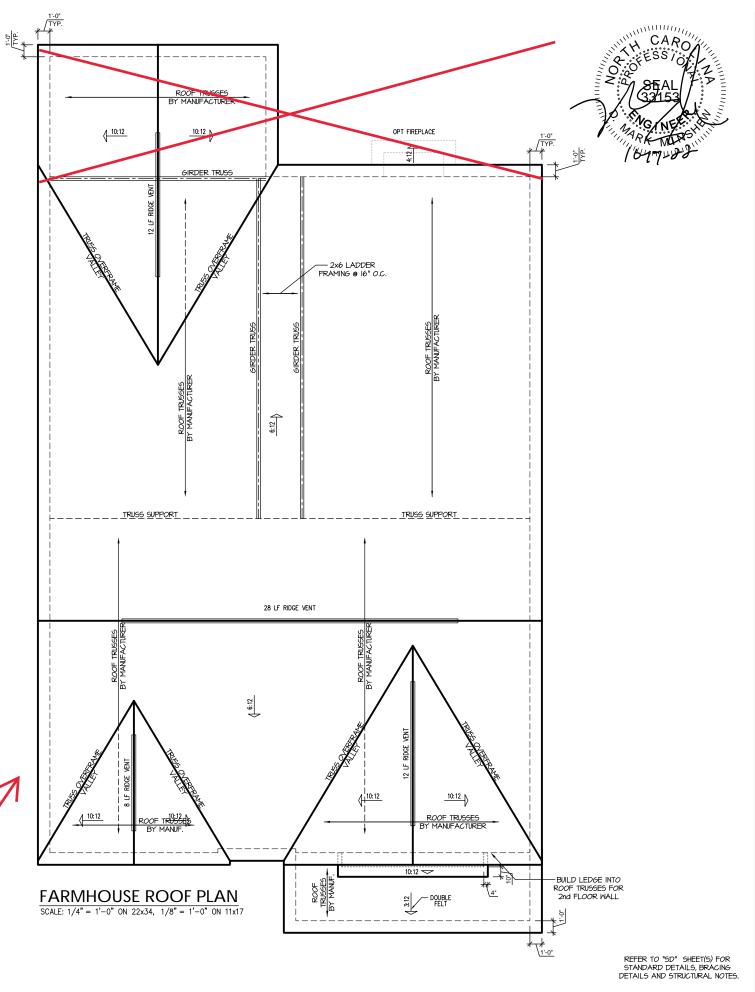

PROJECT # 21-2818-LH

P.A. 27609

Southern Engineers, P 3716 Benson Drive, Raleigh, NC 27 Phone: (919) 878-1617 License: C-4772

SOUTH DESIGNS

The Raleigh NEW HOME, Plan 06

TRUSS SYSTEM REQUIREMENTS


NC (2018 NCRC): Wind: 115-120 mph

- TRUSS SYSTEM LAYOUTS (PLACEMENT PLANS) SHALL BE DESIGNED IN ACCORDANCE WITH SEALED STRUCTURAL PLANS. ANY NEED TO CHANGE TRUSSES SHALL BE COORDINATED WITH SOUTHERN
- TRUSS SCHEMATICS (PROFILES) SHALL BE
 PREPARED AND SEALED BY TRUSS MANUFACTURER.
- ALL TRUSSES SHALL BE DESIGNED FOR BEARING ON SPF #2 OR #3 PLATES OR LEDGERS (UNO).
- ALL REQUIRED ANCHORS FOR TRUSSES DUE TO UPLIFT OR BEARING SHALL MEET THE REQUIREMENTS AS SPECIFIED ON THE TRUSS

ATTIC VENT SCHEDULE												
'LOW CKARMINYOUSEVATION												
MAIN HOUSE			SQ FTG	260	AT	/ NEAR RID	AT / NEAR EAVE					
VENT TYPE	SQ. FT. REQUIRED RANGE		SQ. FT. SUPPLIED	PERCENT OF TOTAL SUPPLIED	POT LARGE (SQ. FT. EACH)	POT SMALL (SQ. FT. EACH)	RIDGE VENT (SQ. FT. PER LF)	EAVE VENT (SQ. IN. EACH)	CONT. VENT (SQ. IN. PER LF)			
					0.4236	0.2778	0.125	0.1944	0.0625			
RIDGE VENT	0.35	0.43	1.00	44.44	0	0	8.00					
SOFFIT VENTS	0.52	0.43	1.25	55.56	0 20.00				20.00			
TOTAL (MIN)	0.87	0.87	2.25	100.00	POT VENTS MAY BE REQUIRED IF THERE IS INSUFFICIENT RIDGE AVAILABLE							

^{*} SCHEDULE HAS BEEN CALCULATED ASSUMING EAVE VENTILATION AT 50-60% OF TOTAL AND RIDGE AT 40-50% OF TOTAL REQUIRED VENTILATION



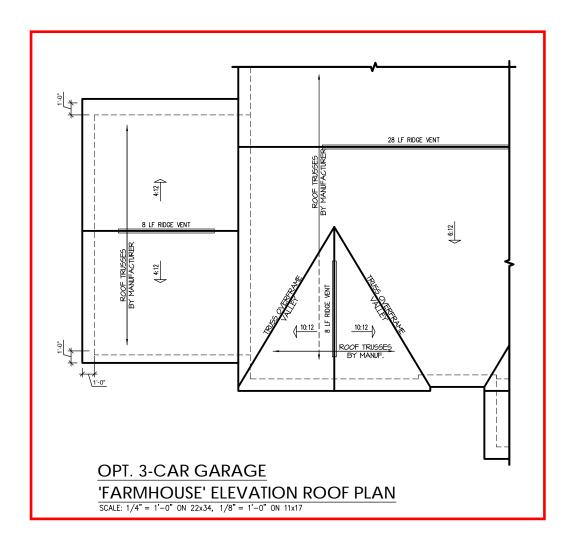

PROJECT #

21-2818-LH


P.A. 27609


Southern Engineers, P

SOUTH DESIGNS

Raleigh NEW HOME, The

REFER TO "SD" SHEET(S) FOR STANDARD DETAILS, BRACING DETAILS AND STRUCTURAL NOTES.

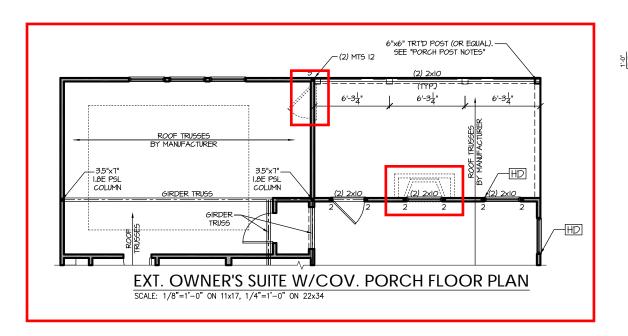


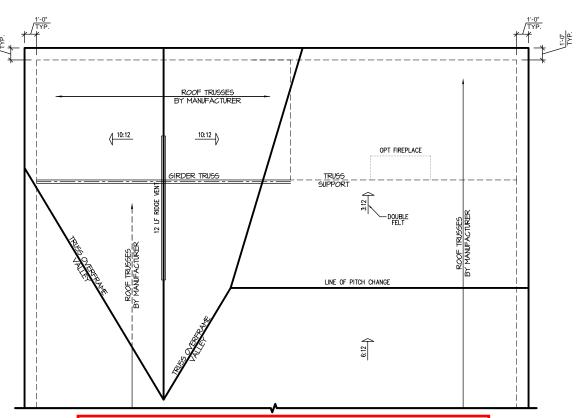

EXT. OWNER'S SUITE W/COV. PORCH ROOF PLAN

TRUSS SYSTEM REQUIREMENTS NC (2018 NCRC): Wind: 115-120 mph

- I. TRUSS SYSTEM LAYOUTS (PLACEMENT PLANS)
 SHALL BE DESIGNED IN ACCORDANCE WITH SEALED
 STRUCTURAL PLANS, ANY NEED TO CHANGE
 TRUSSES SHALL BE COORDINATED WITH SOUTHERN
 ENGINEERS.
- 2. TRUSS SCHEMATICS (PROFILES) SHALL BE PREPARED AND SEALED BY TRUSS MANUFACTURER.
- 3. ALL TRUSSES SHALL BE DESIGNED FOR BEARING ON SPF #2 OR #3 PLATES OR LEDGERS (UNO).
- 4. ALL REQUIRED ANCHORS FOR TRUSSES DUE TO UPLIFT OR BEARING SHALL MEET THE REQUIREMENTS AS SPECIFIED ON THE TRUSS SCHEMATICS.

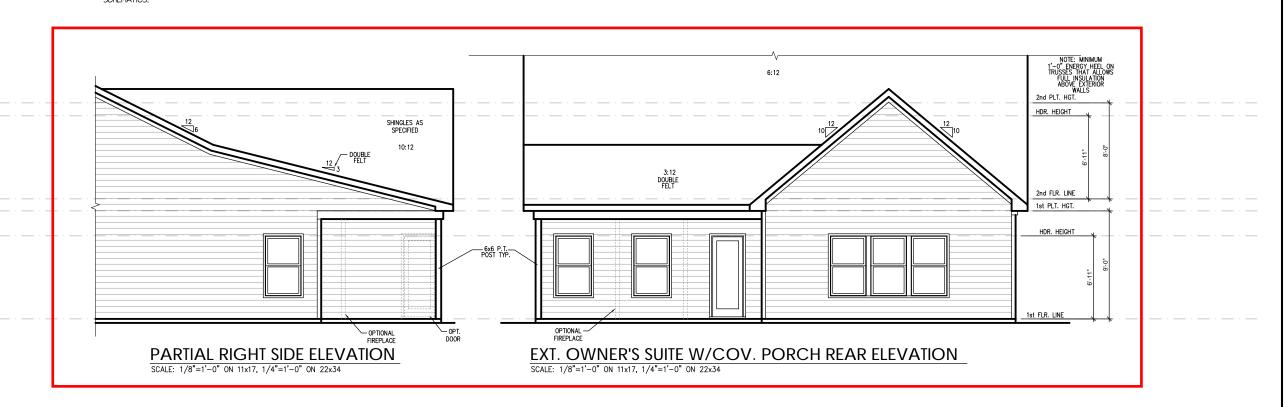

SCALE: 1/8"=1'-0" ON 11x17, 1/4"=1'-0" ON 22x34

PROJECT # 21-2818-LH

ans are to be brought to the ineers. Failure to do so will year from date of seal.

rounneur.

Seal does not include construction means, methods, te sequences, procedures or safety precautions.

Any deviations or discrepancies on plans are to be broom mimediate attention of Southern Engineers. Failure to old Southern Engineers, Failure to see the constant of the const


Southern Engineers, P.A. 3716 Benson Drive, Raleigh, NC 27609 Phone: (919) 878-1617


SOUTH DESIGNS


Plan 06 - The Raleigh - L.I NEW HOME, INC.


|| S-2.6


REFER TO "5D" SHEET(5) FOR STANDARD DETAILS, BRACING DETAILS AND STRUCTURAL NOTES.

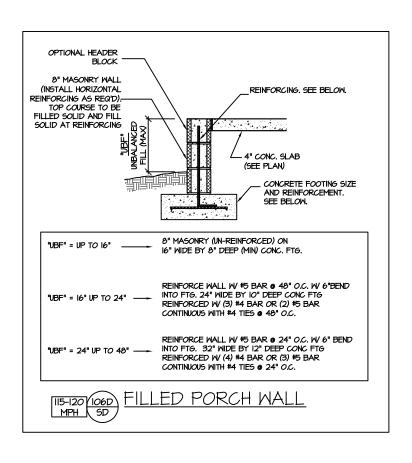

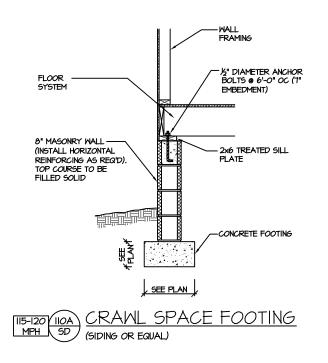

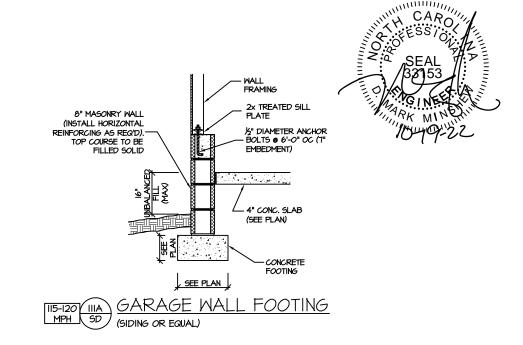


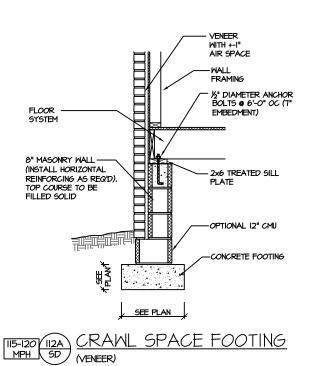

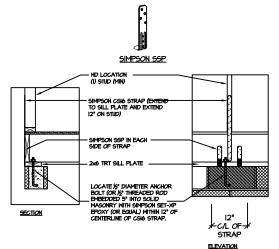



NOTE: SIMPSON DTT-IZ IS ACCEPTABLE ALTERNATE NOTE: ALTERNATE HD HOLD-DOWN DEVICES OR SYSTEMS MAY BE USED TO MEET THE CODE REQUIRED 800 LB CAPACITY IN LIEU OF THE ABOVE DETAIL.

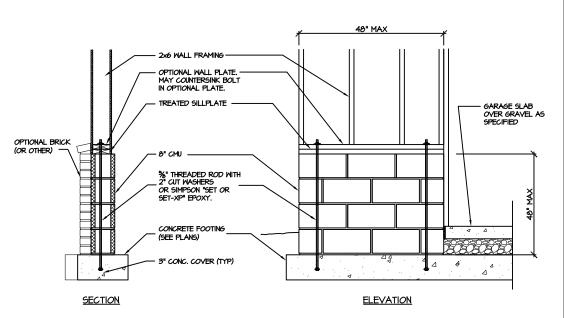

GARAGE 'WING WALL' REINFORCING
PER IRC FIGURE R602.10.4.3

STRUCTURAL DETAILS: CRAWL SPACE FOUNDATION PROJECT # 21-2818

or include construction means, methods, techniques, rocedures or safety precautions. may or discountions on plans are to be brought to the man of Southern Engineers. Failure to do so will m Engineer's liability.

Southern Engineers, P.A. 3716 Benson Drive, Raleigh, NC 27609 Phone: (919) 878-1617


License: C-4772

www.southernengineers.com


NEW HOME, INC.


PLAN 06 - THE RALEIGH



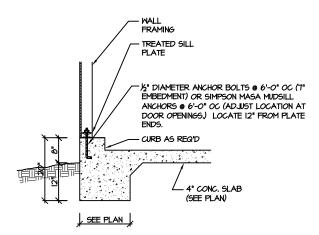





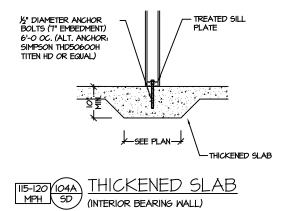

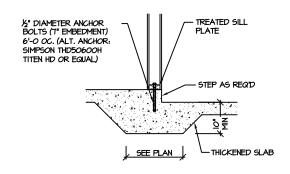



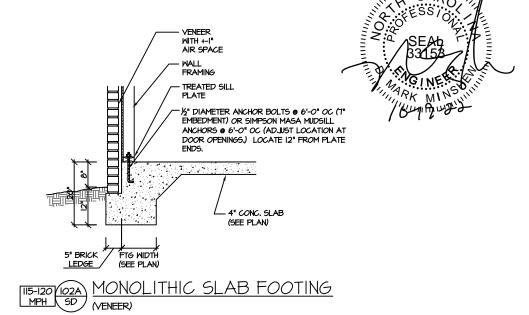

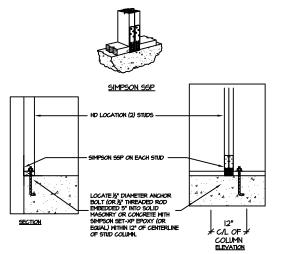

BRACED WALL END CONDITION "HD" HOLD-DOWN DETAIL

NOTE: SIMPSON DTT-IZ IS ACCEPTABLE ALTERNATE NOTE: ALTERNATE HD HOLD-DOWN DEVICES OR SYSTEMS MAY BE USED TO MEET THE CODE REQUIRED 800 LB CAPACITY IN LIEU OF THE ABOVE DETAIL.


> STRUCTURAL DETAILS: MONO SLAB FOUNDATION

PROJECT # 21-2818


P.A. 27609 Southern Engineers, P. 3716 Benson Drive, Raleigh, NC 276
Phone: (919) 878-1617
License: C-4772
www.southernengineers.com

NEW HOME,

- THE RALEIGH PLAN 06

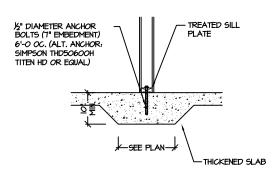





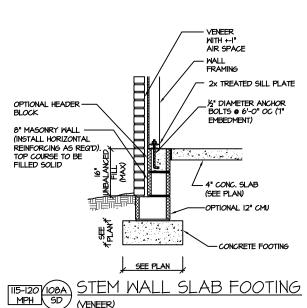


(FOR UNBALANCED FILL EXCEEDING 16" O.C.


SEE DETAIL "IO6F/SD")

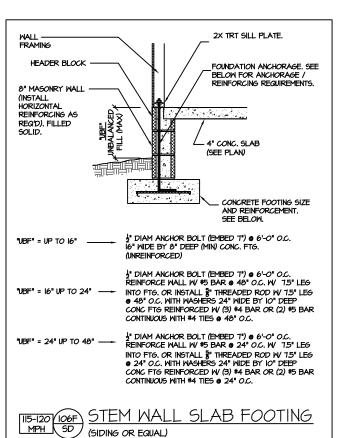

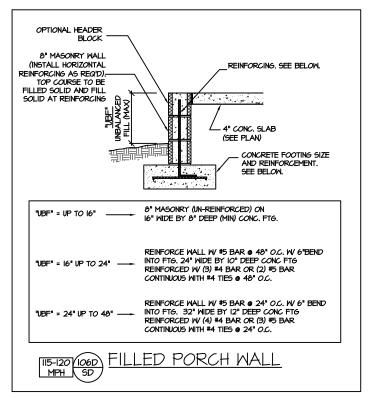


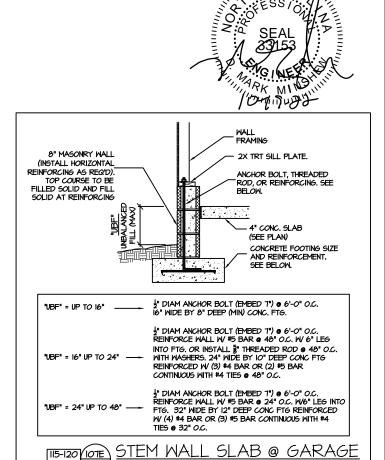

CARO

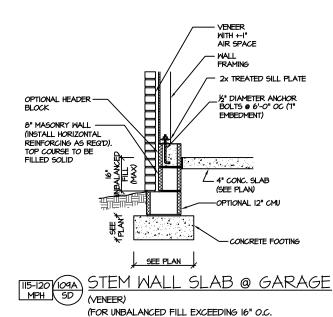


SEE DETAIL "IO6E/SD")

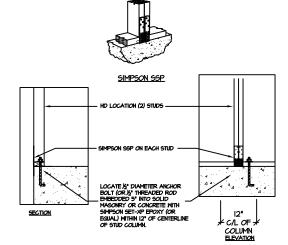

BRACED WALL END CONDITION "HD" HOLD-DOWN DETAIL

NOTE: SIMPSON DTT-IZ IS ACCEPTABLE ALTERNATE NOTE: ALTERNATE HD HOLD-DOWN DEVICES OR SYSTEMS MAY BE USED TO MEET THE CODE REQUIRED 800 LB CAPACITY IN LIEU OF THE ABOVE DETAIL.

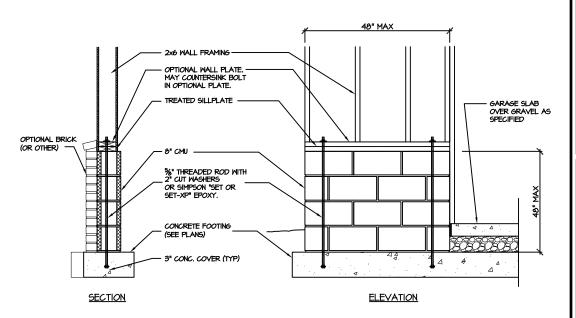

GARAGE 'WING WALL' REINFORCING PER IRC FIGURE R602.10.4.3

> STRUCTURAL DETAILS: STEMWALL SLAB FOUNDATION


PROJECT # 21-2818

P.A. 27609

Southern Engineers, P 3716 Benson Drive, Raleigh, NC 2' Phone: (919) 878-1617 License: C-4772

HOME, NEW]

RALEIGH THE 90 PLAN (

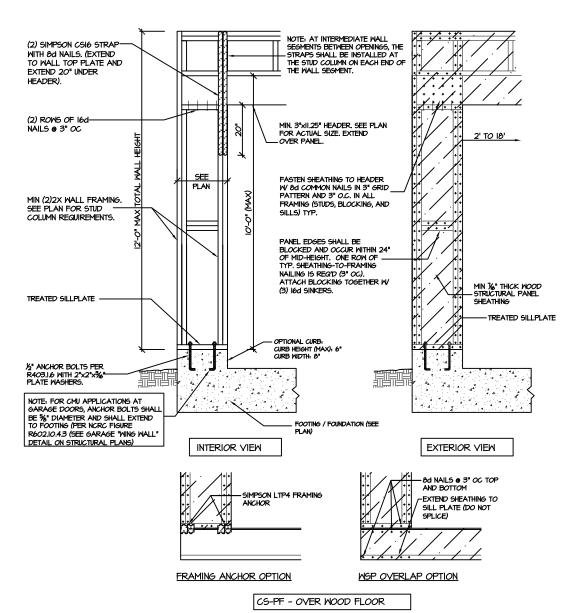

<u>CS-PF: CONTINUOUS PORTAL FRAME CONSTRUCTION</u> DETAIL AND APPLICATION BASED ON NORC FIGURE R602.IO.I - PORTAL FRAME CONSTRUCTION

STRUCTURAL NOTES

NC (2018 NCRC): Wind: 115-120 mph

- ENGINEER'S SEAL APPLIES ONLY TO STRUCTURAL COMPONENTS INCLUDING ROOF RAFTERS, HIPS, VALLEYS, RIDGES, FLOORS, WALLS, BEAMS AND HEADERS, COLUMNS, CANTILEVERS, OFFSET LOAD BEARING WALLS, PIER & GIRDER SYSTEM, FOOTING, AND PILING SYSTEM. ENGINEER'S SEAL DOES NOT CERTIFY DIMENSIONAL ACCURACY OR ARCHITECTURAL LAYOUT INCLUDING ROOF SYSTEM, ALL REQUIREMENTS FOR PROFESSIONAL CERTIFICATION SHALL BE PROVIDED BY THE APPROPRIATE PROFESSIONAL. SOUTHERN ENGINEERS, P.A. CERTIFIES ONLY THE STRUCTURAL COMPONENTS AS SPECIFICALLY STATED.
- 2. ALL CONSTRUCTION SHALL CONFORM TO THE LATEST REQUIREMENTS OF THE 2018 NC RESIDENTIAL CODE, PLUS ALL LOCAL CODES AND REGULATIONS. THE STRUCTURAL ENGINEER IS NOT RESPONSIBLE FOR, AND WILL NOT HAVE CONTROL OF, CONSTRUCTION MEANS, METHODS, TECHNIQUES, SEQUENCES OR PROCEDURES, OR FOR SAFETY PRECAUTIONS AND PROGRAMS II CONNECTION WITH THE CONSTRUCTION WORK, NOR WILL THE ENGINEER BE RESPONSIBLE FOR THE CONTRACTOR'S FAILURE TO CARRY OUT THE CONSTRUCTION WORK IN ACCORDANCE WITH THE CONTRACT DOCUMENTS. "CONSTRUCTION REVIEW" SERVICES ARE NOT PART OF OUR CONTRACT. ALL MEMBERS SHALL BE FRAMED ANCHORED, TIED AND BRACED IN ACCORDANCE WITH GOOD CONSTRUCTION PRACTICE AND THE BUILDING CODE.
- 3. DESIGN LOADS (LISTED AS: LIVE LOAD, DEAD LOAD, DEFLECTION)
- ROOMS OTHER THAN SLEEPING ROOMS: (40 PSF, IO PSF, L/360)
- SLEEPING ROOMS: (30 PSF, IO PSF, L/360)
- ATTIC WITH PERMANENT STAIR: (40 PSF, IO PSF, L/360)
- ATTIC WITHOUT PERMANENT STAIR: (20 PSF, IO PSF, L/360) ATTIC WITHOUT STORAGE: (10 PSF, 10 PSF, L/240)
- STAIRS: (40 PSF, IO PSF, L/360)
- EXTERIOR BALCONIES: (60 PSF, IO PSF, L/360)
- DECKS: (40 PSF, IO PSF, L/360) GUARDRAILS AND HANDRAILS: (200 LBS)
- PASSSENGER VEHICLE GARAGES: (50 PSF, IO PSF, L/360)
- FIRE ESCAPES: (40 PSF, IO PSF, L/360)
- 4. WALLS SHALL BE BRACED BY SHEATHING WALLS ON ALL STORIES WITH WOOD STRUCTURAL PANELS. SEE FRAMING NOTES FOR THICKNESS AND NAILING REQUIREMENTS.
- 5. SEE APPENDIX M (DCA6) FOR EXTERIOR DECK REQUIREMENTS INCLUDING ATTACHMENTS FOR
- 6. CONCRETE SHALL HAVE A MINIMUM 28 DAY STRENGTH OF 3000 PSI AND A MAXIMUM SLUMP OF 5 INCHES UNLESS NOTED OTHERWISE (UNO). AIR ENTRAINED PER TABLE 402.2. ALL CONCRETE SHALL BE PROPORTIONED, MIXED, HANDLED, SAMPLED, TESTED, AND PLACED IN ACCORDANCE WITH ACI STANDARDS, ALL SAMPLES FOR PUMPING SHALL BE TAKEN FROM THE EXIT END OF THE PUMP, CONTROL JOINTS IN SLABS SHALL BE SPACED ON A GRID OF +-30 TIMES THE DEPTH (D). CONTROL JOINTS SHALL BE SAWCUT TO A DEPTH OF I/D. (I.E. 4" CONCRETE SLABS SHALL HAVE 1/4" DEEP CONTROL JOINTS SAWCUT IN SLAB ON A +-10'-0" x +-10'-0" GRID).
- 1. ALLOWABLE SOIL BEARING PRESSURE ASSUMED TO BE 2000 PSF. THE CONTRACTOR MUST CONTACT A GEOTECHNICAL ENGINEER AND THE STRUCTURAL ENGINEER IF UNSATISFACTORY SUBSURFACE CONDITIONS ARE ENCOUNTERED. THE SURFACE AREA ADJACENT TO THE FOUNDATION WALL SHALL BE PROVIDED WITH ADEQUATE DRAINAGE, AND SHALL BE GRADED SO AS TO DRAIN SURFACE WATER AWAY FROM FOUNDATION WALLS.
- 8. ALL FRAMING LUMBER SHALL BE SPF #2 (Fb = 875 PSI) UNLESS NOTED OTHERWISE (UNO). ALL TREATED LUMBER SHALL BE SYP # 2. PLATE MATERIAL MAY BE SPF # 3 OR SYP #3 (Fc(perp) =
- q. L.V.L. SHALL BE LAMINATED VENEER LUMBER: Fb=2600 PSI, Fv=265 PSI, E=1.9xi0 PSI.
 q.I. P.S.L. SHALL BE PARALLEL STRAND LUMBER: Fb=2900 PSI, Fv=290 PSI, E=2.0xi0 PSI.
 q.2. L.S.L. SHALL BE LAMINATED STRAND LUMBER: Fb=2250 PSI, Fv=400 PSI, E=1.55xi0 PSI. INSTALL ALL CONNECTIONS PER MANUFACTURERS INSTRUCTIONS.
- IO. ALL ROOF TRUSS AND I-JOIST LAYOUTS SHALL BE PREPARED IN ACCORDANCE WITH THE SEALED STRUCTURAL DRAWINGS. TRUSSES AND I-JOISTS SHALL BE INSTALLED ACCORDING TO THE MANUFACTURE'S SPECIFICATIONS. ANY CHANGE IN TRUSS OR I-JOIST LAYOUT SHALL BE COORDINATED WITH SOUTHERN ENGINEERS.
- II. ALL STRUCTURAL STEEL SHALL BE ASTM A-36. STEEL BEAMS SHALL BE SUPPORTED AT EACH END WITH A MINIMUM BEARING LENGTH OF 3 I/2" INCHES AND FULL FLANGE WIDTH. PROVIDE SOLID BEARING FROM BEAM SUPPORT TO FOUNDATION. BEAMS SHALL BE ATTACHED TO EACH SUPPORT WITH TWO LAG SCREWS (1/2" DIAMETER x 4" LONG). LATERAL SUPPORT IS CONSIDERED ADEQUATE PROVIDING THE JOIST ARE TOE NAILED TO THE SOLE PLATE, AND SOLE PLATE IS NAILED OR BOLTED TO THE BEAM FLANGE @ 48" O.C. ALL STEEL TUBING SHALL BE ASTM A500.
- 12. REBAR SHALL BE DEFORMED STEEL, ASTM615, GRADE 60. LAP ALL REBAR SPLICES 30 BAR
- 13. FLITCH BEAMS SHALL BE BOLTED TOGETHER USING (2) ROWS OF 1/2" DIAMETER BOLTS (ASTM A325) WITH WASHERS PLACED UNDER THE THREADED END OF BOLT. BOLTS SHALL BE SPACED AT 24" O.C. (MAX), AND STAGGERED AT THE TOP AND BOTTOM OF BEAM (2" EDGE DISTANCE), WITH 2 BOLTS LOCATED AT 6" FROM EACH END.
- 14. BRICK LINTELS (WHEN REQUIRED) SHALL BE 3 1/2"x3 1/2"x1/4" STEEL ANGLE FOR UP TO 6'-0" SPAN AND 6"x4"x5/16" STEEL ANGLE WITH 6" LEG VERTICAL FOR SPANS UP TO 9'-O". SEE PLANS FOR SPANS OVER 9'-0". SEE ALSO SECTION R703.8.3 LINTELS.

STRUCTURAL DETAILS: ALL FOUNDATION TYPES



PROJECT #

21-2818

P.A. 27609 Engineers, Drive, Raleigh, NC : (919) 878-1617 Southern Engis 3716 Benson Drive, Ra Phone: (919) 8

> HOME, NEW

RALEIGH THE] 90 PLAN (