

### **FRONT ELEVATION**

Scale: 1/4" = 1'0"

9'0" CEILING HEIGHT FIRST FLOOR (HEADER HEIGHT 7'6") 8'0" CEILING HEIGHT SECOND FLOOR (Frame Headers to Top Plates)

FRAME WINDOWS TO HEADER HEIGHT



### **REAR ELEVATION**

Scale: 1/8" = 1'0"





### **RIGHT ELEVATION**

Scale: 1/8" = 1'0"

PLAN: Anconia W/ Porch

ELEVATIONS

SHEET TITLE:

PROJECT ADDRESS: 139 Rush Ln. Liberty Meadows Lot 61

om Homes

DESIGNED BY:
Precision Custom Home:
Raeford, NC
naun@PrecisionCustomHome:

DATE:


3/8/24


SCALE:

1/4" = 1'

...\_\_

SHEET:

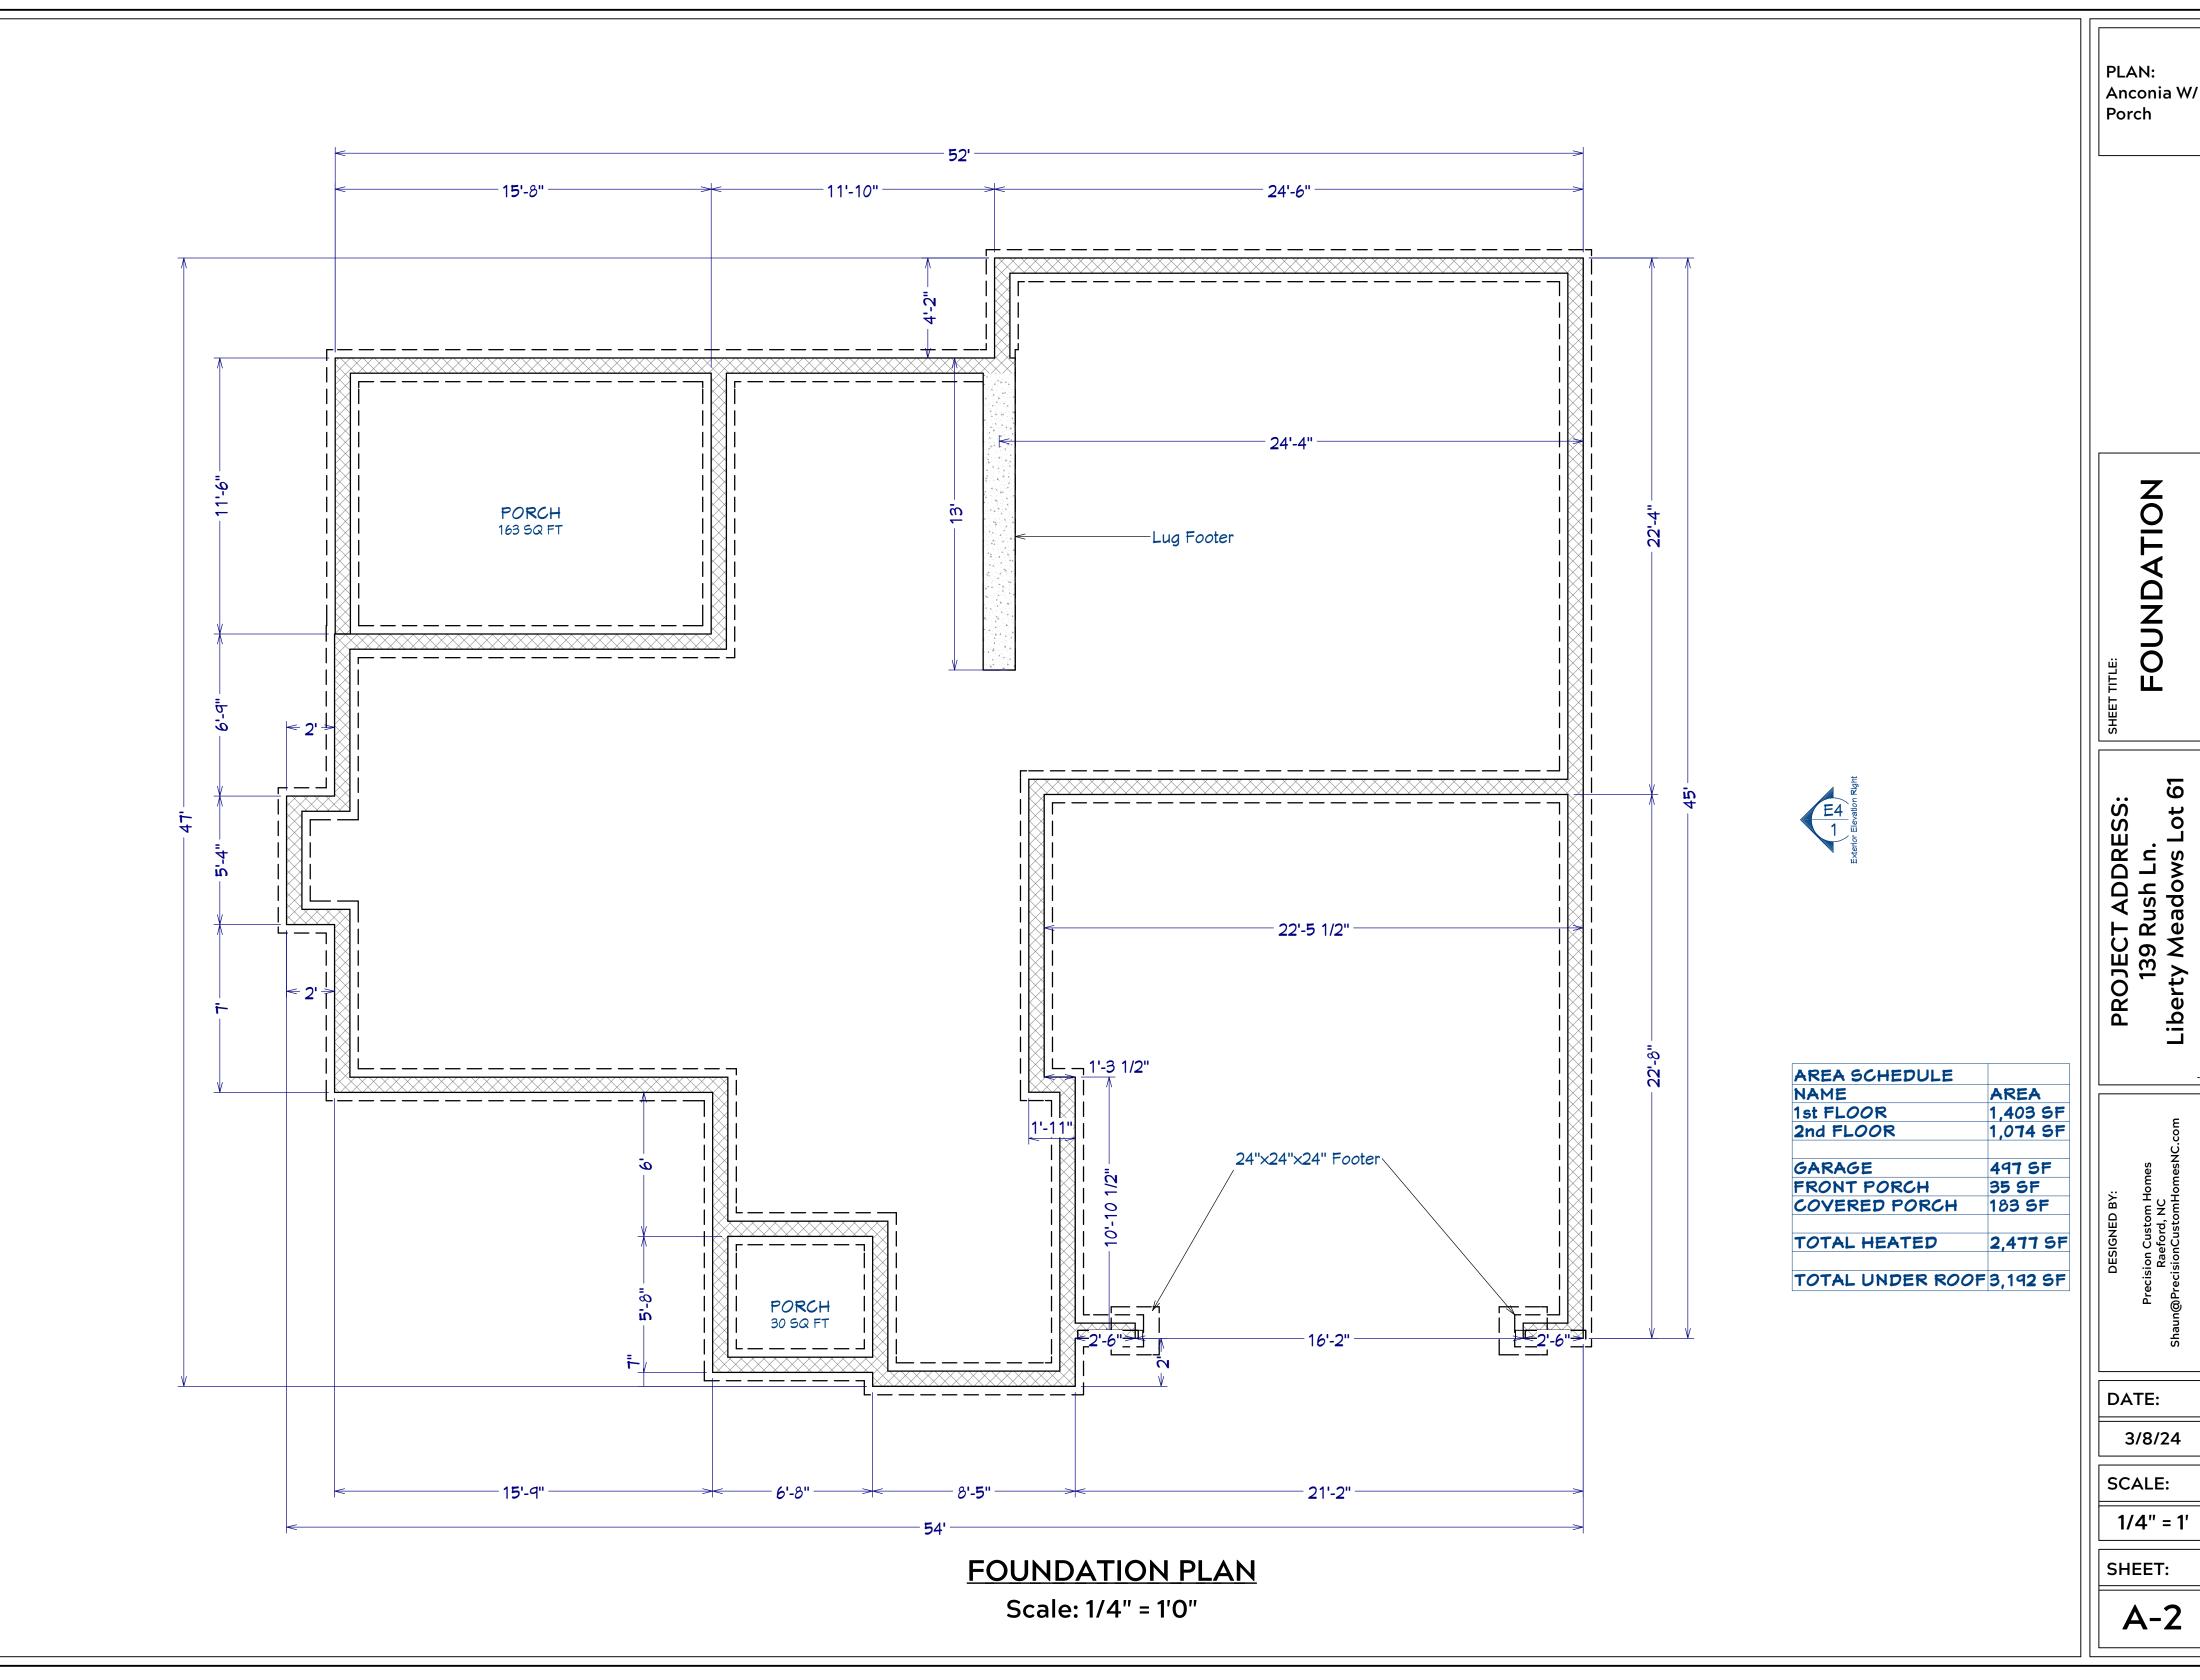

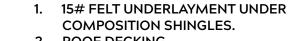

2. ROOF DECKING.

3. 2 X RAFTERS / ENGINEERED TRUSSES

DOUBLE TOP PLATE.

2 X 4 RETURN.

3/4" FASCIA OR PVC TRIM COIL 7. 2 X FASCIA

8. 1/4" PLYWOOD OR VINYL SOFFIT

9. 1X FREIZE BOARD (TO BE USED WITH **BRICK VENEERS)** 

10. INSULATION BOARD OR HOUSE WRAP

11. AIR SPACE.

12 BRICK WITH BRICK TIES PER MANUFACTURER'S SPECIFICATIONS.

13. 1/2" X 12" ANCHOR BOLTS, 6'-0" O.C., 12" FROM CORNERS.

14. FLASHING WITH WEEP HOLES @ 48" O.C.

15. FINISHED GRADE.

16. FOOTING

17. COMPACTED EARTH FILL. 18. 6 MIL VAPOR BARRIER

19. 4" CONCRETE SLAB, 3,000 P.S.I. WITH 6" X 6" 10 GA. X 10 GA. WELDED WIRE FABRIC.

20. 1/2" GYPSUM BOARD.

#### **FOUNDATION NOTES:**


ALL FOOTINGS SHALL BEAR ON ORIGINAL **UNDISTURBED SOIL** THE 28 DAY COMPRESSIVE STRENGTH OF ALL FOOTINGS IS 3000 PSI

PROVIDE WATER PROOFING AND PERIMTER DRAINS AS REQUIRED

FOOTING WIDTHS ARE BASED ON A LOAD **BEARING SOIL CAPACITY OF 2000 PSI** 

PROVIDE 6 MIL POLY VAPOR BARRIER TO **COVER GROUND IN CRAWL SPACE AND** GROUND UNDER POURED CONCRETE

ALL ANCHOR BOLTS TO BE 1/2" X 12" LONG. ANCHOR BOLTS SHALL BE SPACED AT A MAXIMUM OF 6' ON CENTER AND NO MORE THEN 1' FROM EACH CORNER

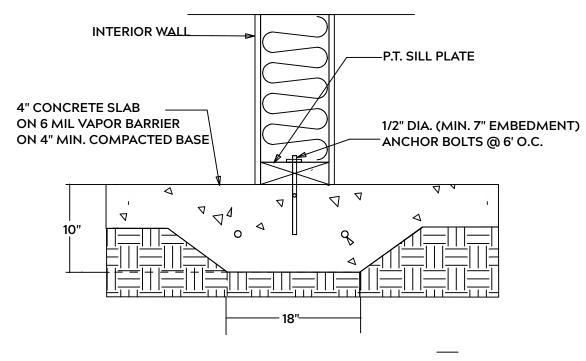

**LUG FOOTING** 

#### **GENERAL FRAMING NOTES:**

ALL LUMBER IN CONTACT WITH CONCRETE OR MASONRY SHALLE BE PRESSURE TREATED

FRAMING LUMBER SHALL BE SYP #2 GRADE AND / OR SPRUCE PINE FIR #1 AND / OR KILN DRIED

WHERE PRE-ENGINEERED JOISTS AND TRUSSES ARE USED, MANUFACTURER SHALL PROVIDE DRAWINGS / SCHEMATICS, WHICH SHALL BEAR OF A N.C. **ENGINEER** 

STUDS AND JOISTS SHALL NOT BE CUT TO INSTALL PLUMBING OR WIRING WITHOUT ADDING METAL OR WOOD SIDE PANELS TO STRENGTHEN MEMBER TO ITS ORIGINAL CAPACITY

NAIL MULTIPLE MEMBERS WITH 2 ROWS OF 16d NAILS STAGGERED 32" O.C. AND USE 3 X 16d NAILS 2" IN AT EACH END.

NAIL FLOOR JOISTS TO SILL PLATE WITH WITH 8d TOE NAILS


ALL EXPOSED FRAMING ON PORCHES OR DECKS SHALL BE PRESSURE **TREATED** 

PROVIDE WATERPROOFING AND DRAINS AS REQUIRED

ALL FRAMING TO BE 16" O.C. WALL FRAMING DIMENSIONS ARE BASED ON 2X4 OR 2X6 EXTERIOR WALLS AND 2X4 INTERIOR WALLS. DOULBE / TRIPLE JACK STUDS AS NECESSARY UNDER HEADERS AS REQUIRED

LVL'S TO BE SIZED BY OTHERS (TRUSS MANUFACTURER)

## **EXTERIOR WALL SECTION**

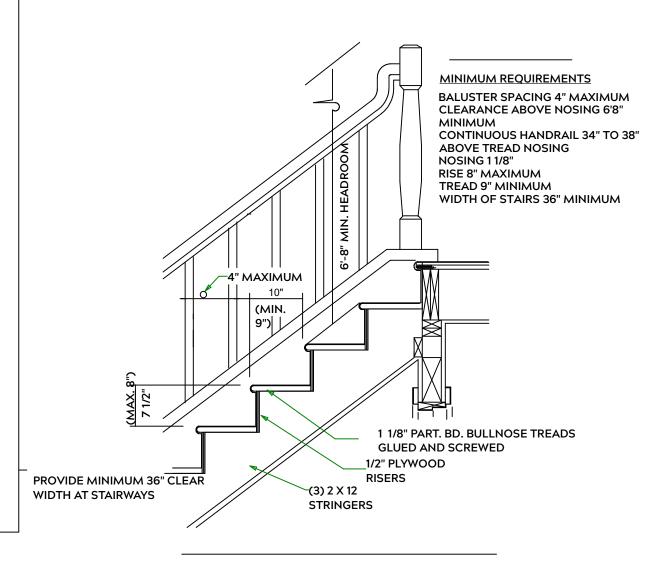

STAIR DETAIL

PLAN: Anconia W/ Porch

> SHEETS Ħ Ë

6 **ADDRES** Liberty Meadows Rush **PROJECT O** 


Precision Custom Hor Raeford, NC @PrecisionCustomHor

DATE:

3/8/24

SCALE: 1/4" = 1'

SHEET:

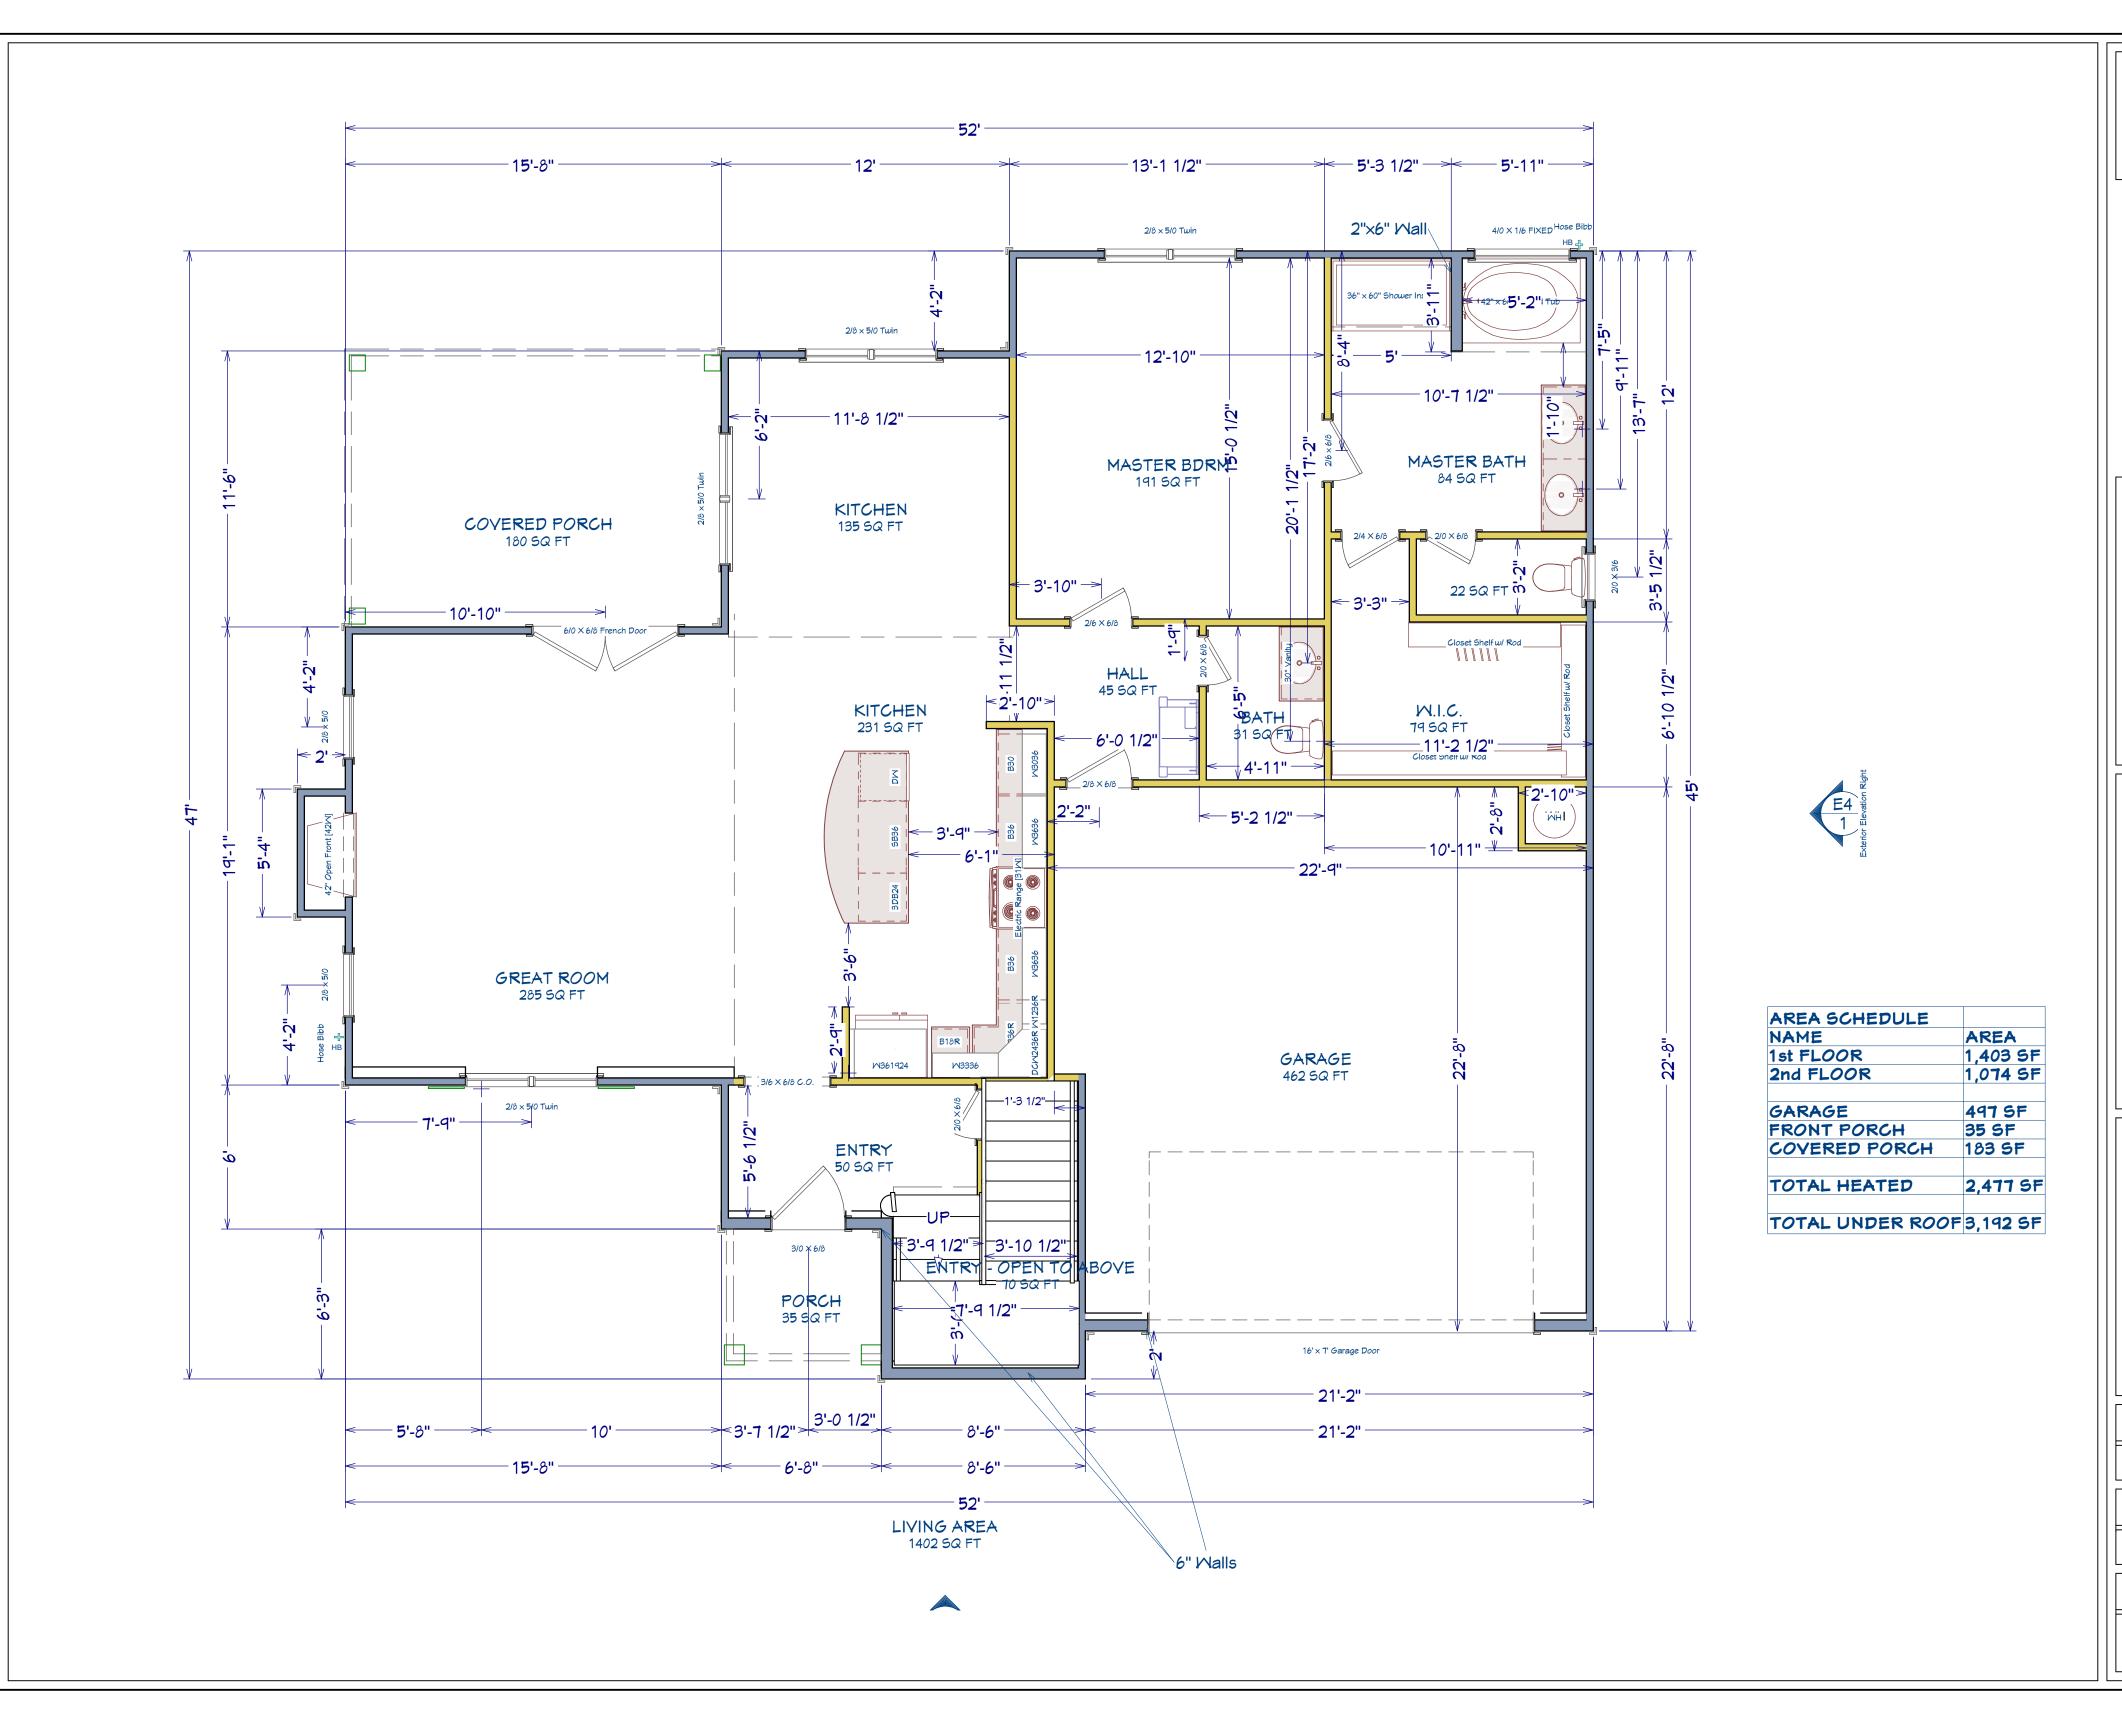

PLAN: Anconia W/ Porch

> FLOOR st

PROJECT ADDRESS: 139 Rush Ln. Liberty Meadows Lot 61

61


Precision Custom Hom Raeford, NC n@PrecisionCustomHom

DATE:

3/8/24

SCALE: 1/4" = 1'

SHEET:

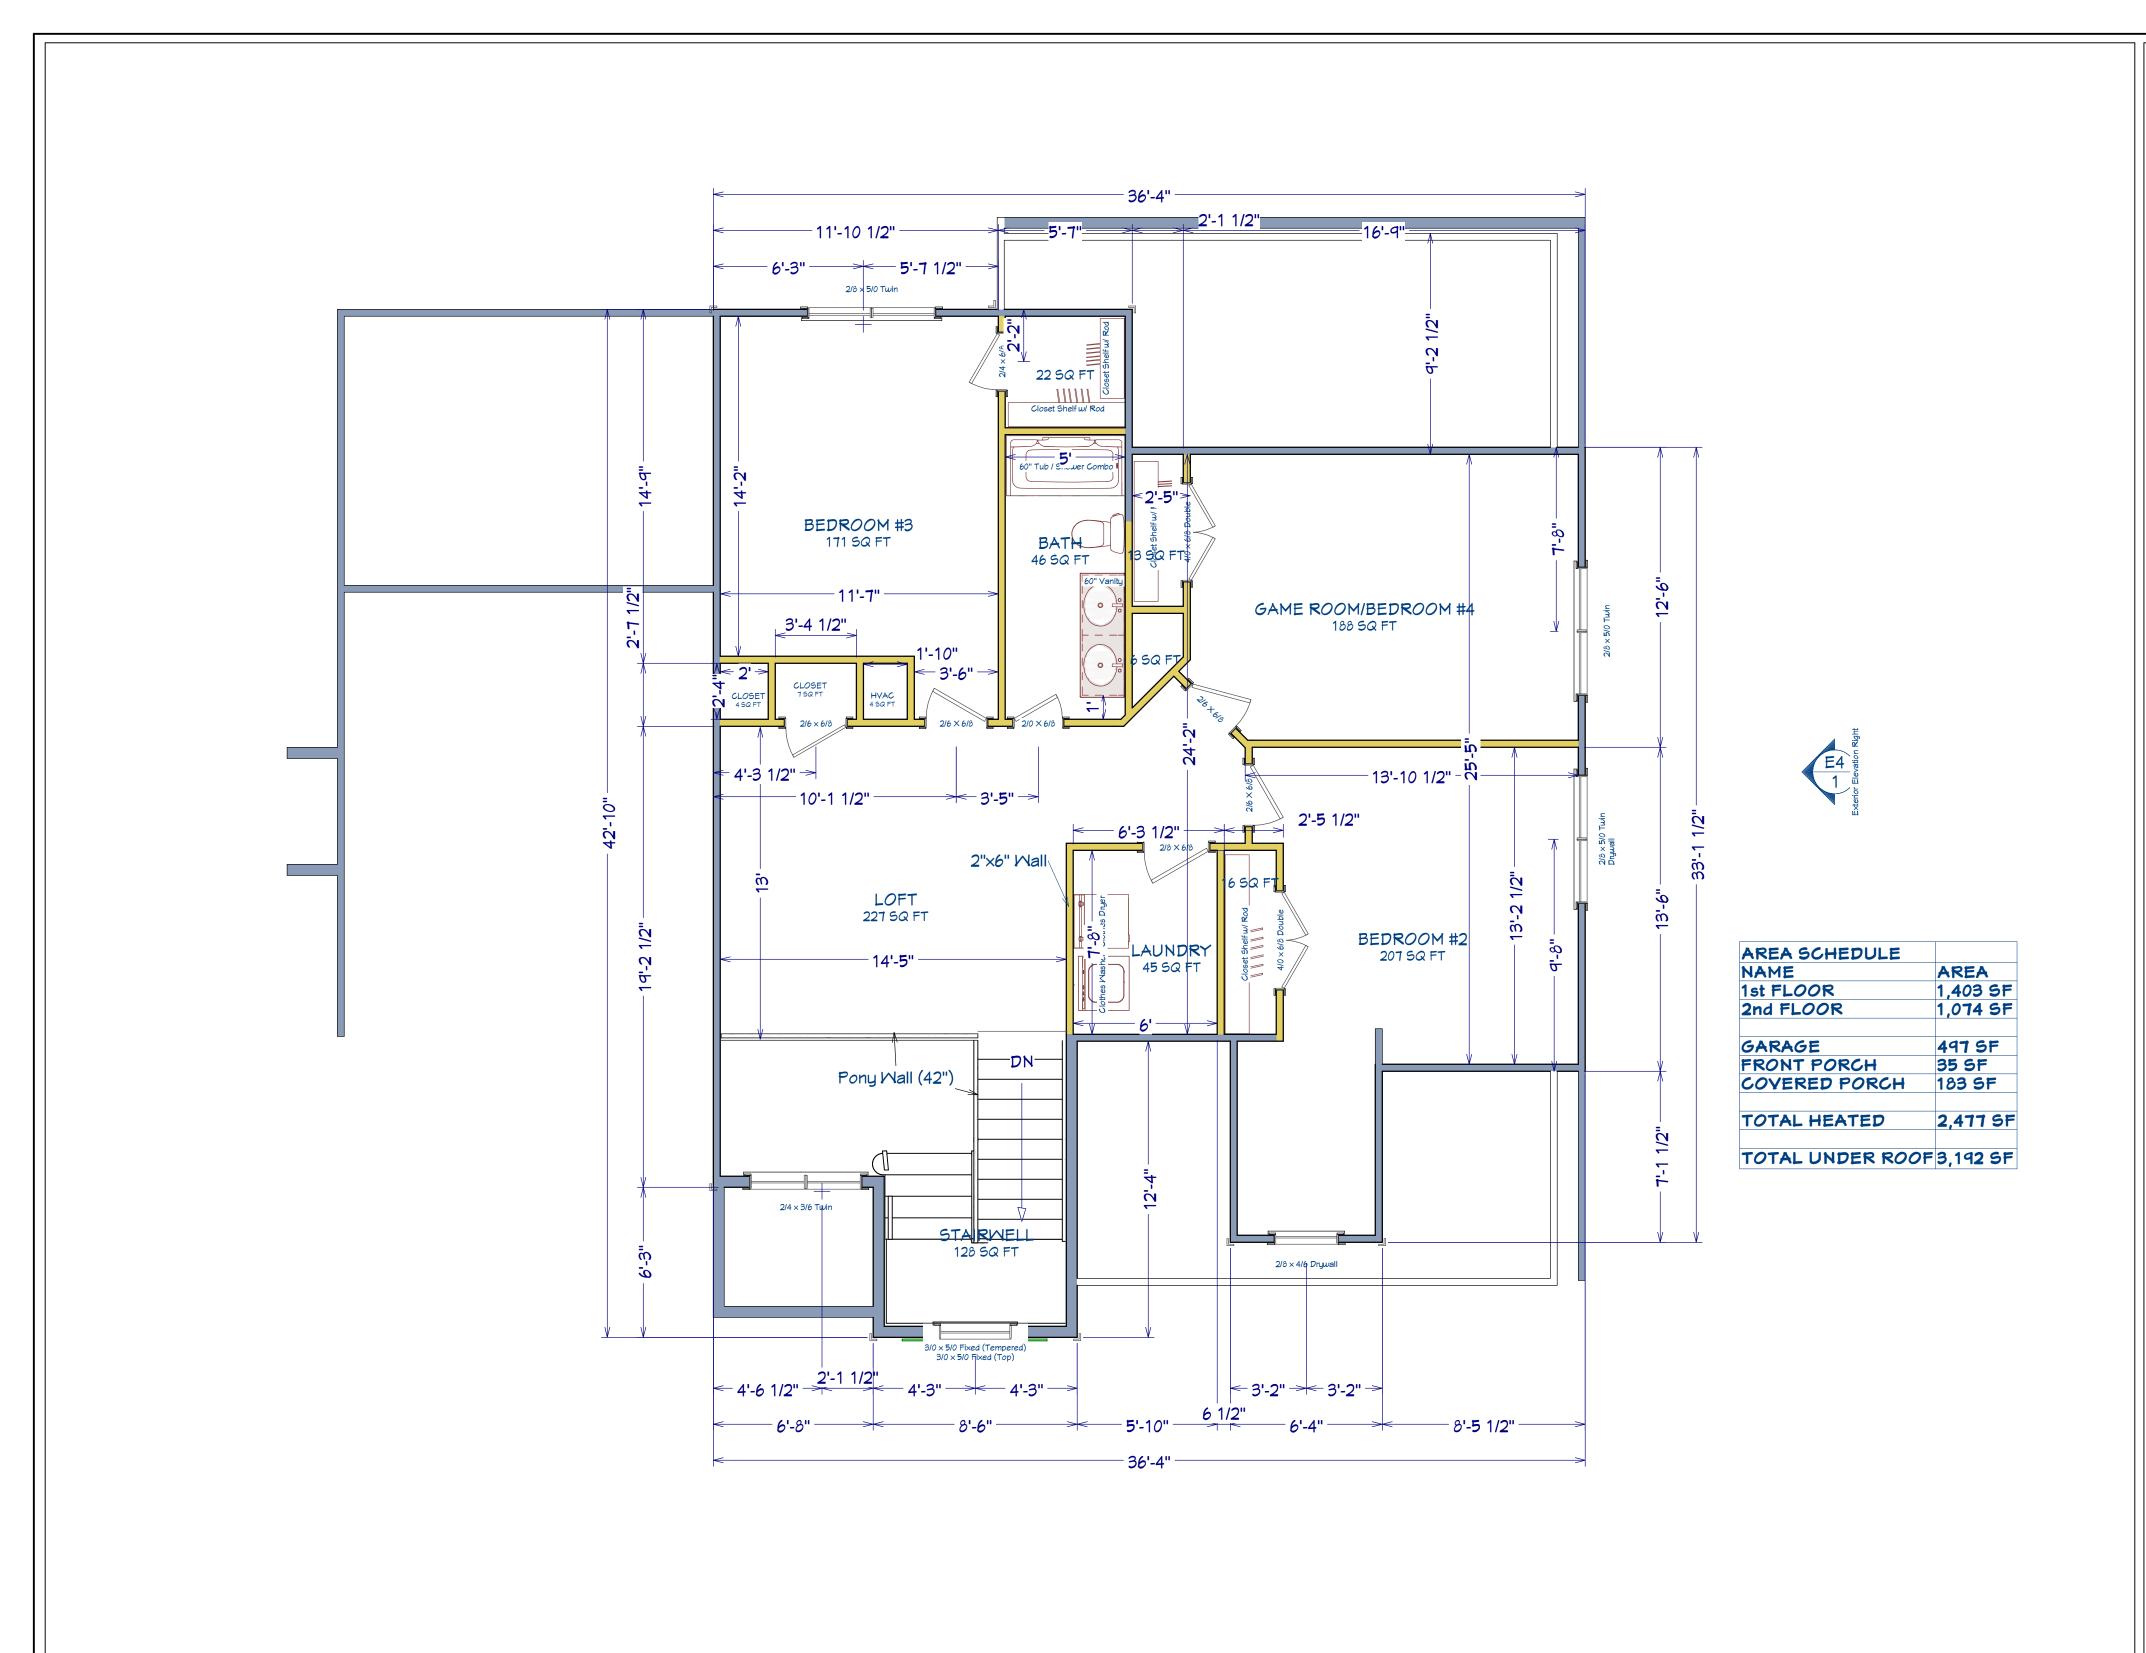

PLAN: Anconia W/ Porch

2nd FLOOR

SHEET TITLE:

PROJECT ADDRESS: 139 Rush Ln. Liberty Meadows Lot 61


> Precision Custom Homes Raeford, NC In@PrecisionCustomHomesNC.cor

DATE:

3/8/24

SCALE: 1/4" = 1'

SHEET:

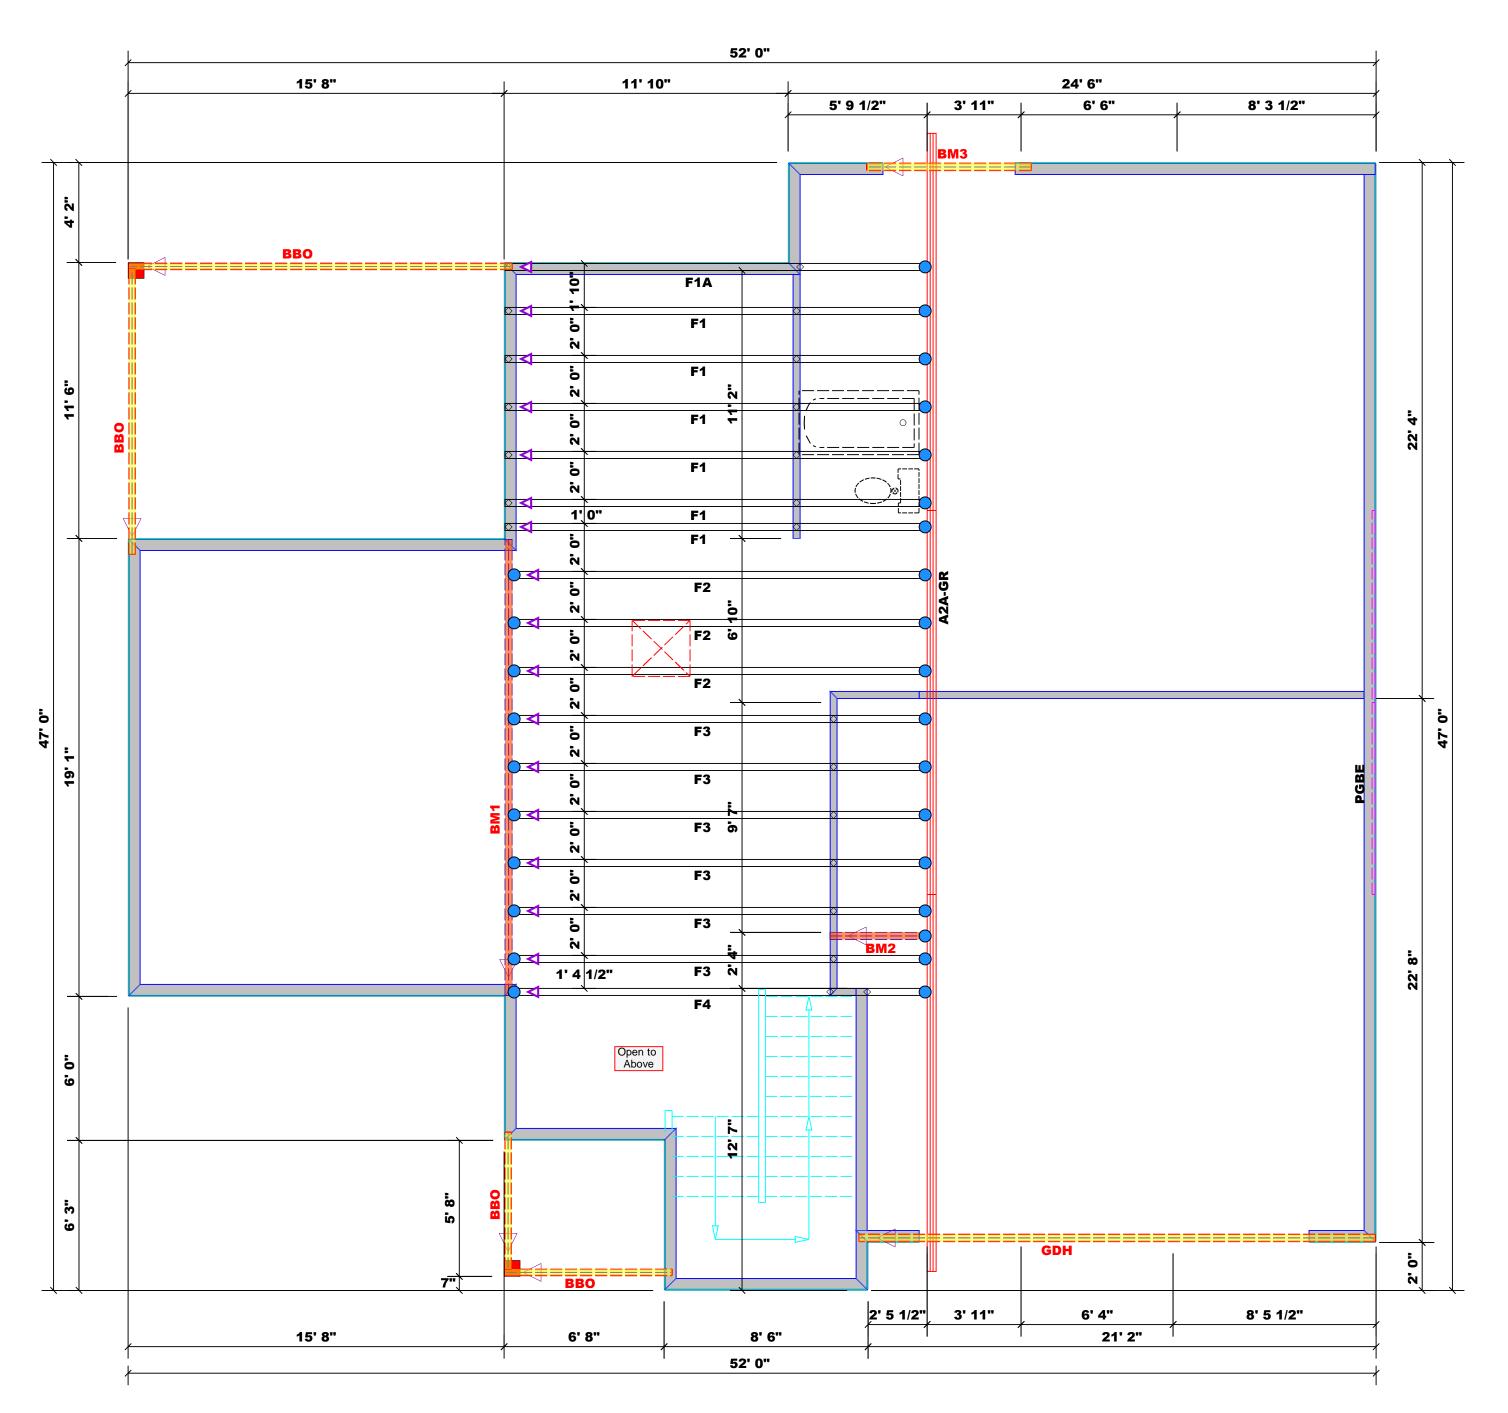

Dimension Notes

1. All exterior wall to wall dimensions are to face of sheathing unless noted otherwise
2. All interior wall dimensions are to face of frame wall unless noted otherwise
3. All exterior wall to truss dimensions are to face of frame wall unless noted otherwise

# All Walls Shown Are Considered Load Bearing

Plumbing Drop Notes
, ,
1. Plumbing drop locations shown are NOT exact.
Contractor to verify ALL plumbing drop
locations prior to setting Floor Trusses.
3. Adjust spacing as needed not to exceed 24"oc.

	Conne	ctor Info	rmat	ion	Nail Info	ormation
Sym	Product	Manuf	Qty	Supported Member	Header	Truss
	HUS410	USP	28	NA	16d/3-1/2"	16d/3-1/2"

		Products - Field Framed		
PlotID	Length	Product	Plies	Net Qty
BM1	19' 0"	1-3/4"x 18" LVL Kerto-S	2	2
BM2	5' 0"	1-3/4"x 14" LVL Kerto-S	2	2
BM3	7' 0"	1-3/4"x 9-1/4" LVL Kerto-S	2	2
GDH	22' 0"	1-3/4"x 18" LVL Kerto-S	2	2

Truss Placement Plan
Scale: 1/4"=1'

ROOF & FLOOR TRUSSES & BEAMS

Reilly Road Industrial Park Fayetteville, N.C. 28309 Phone: (910) 864-8787 Fax: (910) 864-4444

Bearing reactions less than or equal to 3000# are deemed to comply with the prescriptive Code requirements. The contractor shall refer to the attached Tables ( derived from the prescriptive Cod requirements ) to determine the minimum foundatio size and number of wood studs required to support reactions greater than 3000# but not greater than 15000#. A registered design professional shall be retained to design the support system for any reaction that exceeds those specified in the attache Tables. A registered design professional shall be retained to design the support system for all reactions that exceed 15000#.

ture David Landry

David Landry

LOAD CHART FOR JACK STUDS
(BASED ON TABLES R502.5(1) & (b))

NU	NUMBER OF JACK STUDS REQUIRED @ EA END OF HEADER/GIRDER							
END REACTION (UP TO)	REQ'D STUDS FOR (2) PLY HEADER		END REACTION (UP TO)	REQ'D STUDS FOR (3) PLY HEADER		END REACTION (UP TO)	REQ'D STUDS FOR	
1700	1		2550	1		3400	1	
3400	2		5100	2		6800	2	
5100	3		7650	3		10200	3	
6800	4		10200	4		13600	4	
8500	5		12750	5		17000	5	
10200	6		15300	6				
11900	7							
13600	8							
15300	9							

CITY / CO.Cameron / HarnettADDRESSLot 30 Liberty MeadowMODELFloorDATE REV.03/04/24DRAWN BYDavid LandrySALES REP.Neil Baggett

Precision Custom Homes and Renc Lot 61 Liberty Meadows


ovations

BUILDERPrecision CusJOB NAMELot 61 LibertPLANAnconiaSEAL DATESeal DateQUOTE #Quote #JOB #J0224-0809

THIS IS A TRUSS PLACEMENT DIAGRAM ONLY.

These trusses are designed as individual building components to be incorporated into the building design at the specification of the building designer. See individual design sheets for each truss design identified on the placement drawing. The building designer is responsible for temporary and permanent bracing of the roof and floor system and for the overall structure. The design of the truss support structure including headers, beams, walls, and columns is the responsibility of the building designer. For general guidance regarding bracing, consult BCSI-B1 and BCSI-B3 provided with the truss delivery package or online @ sbcindustry.com

= Indicates Left End of Truss
(Reference Engineered Truss Drawing)
Do NOT Erect Truss Backwards

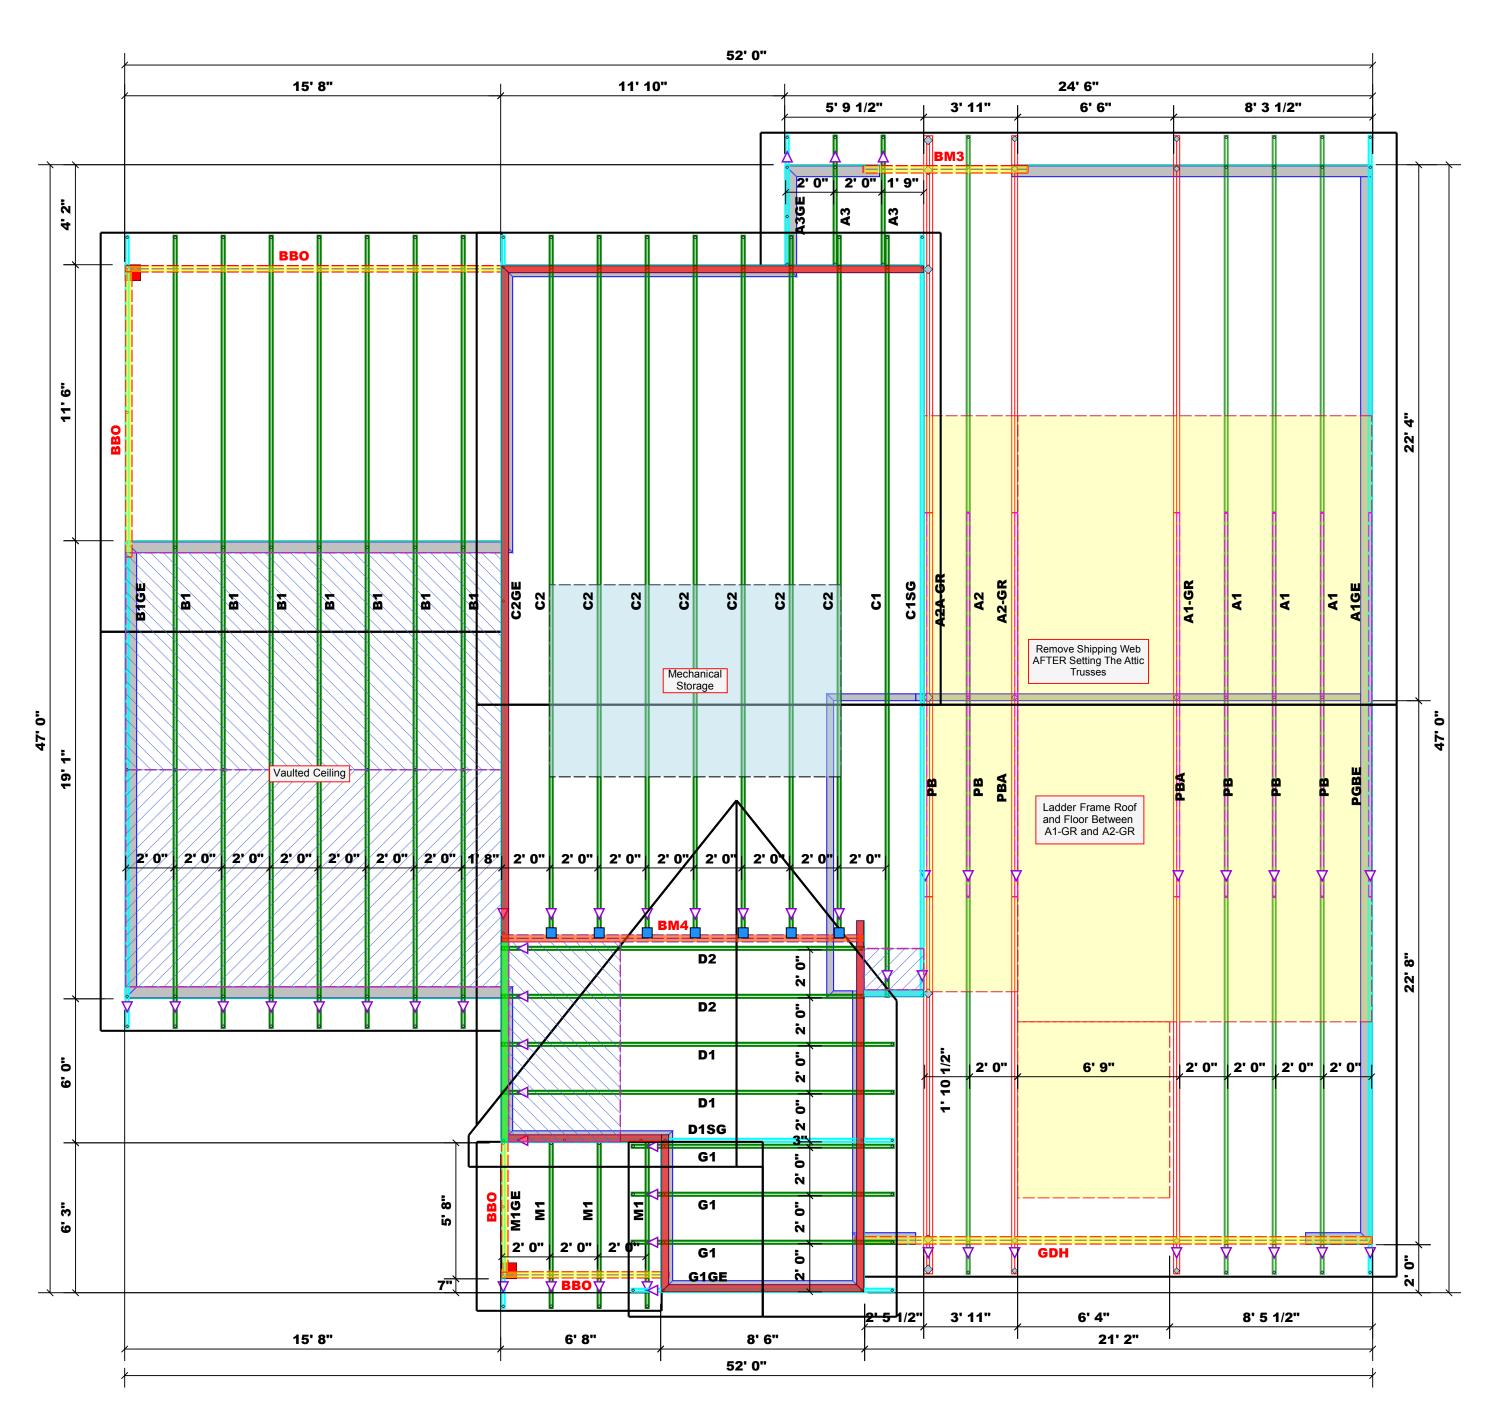

Dimension Notes

1. All exterior wall to wall dimensions are to face of sheathing unless noted otherwise
2. All interior wall dimensions are to face of frame wall unless noted otherwise
3. All exterior wall to truss dimensions are to face of frame wall unless noted otherwise

### All Walls Shown Are Considered Load Bearing

Roof Area = 2878.47 sq.ft. Ridge Line = 77.6 ft. Hip Line = 0 ft. Horiz. OH = 131.95 ft. Raked OH = 221.96 ft. Decking = 99 sheets

Product

HUS26

Connector Information

USP

Manuf Qty

	Box Storage		
	6' 11-3/4" Walls		
	14' 7-1/4" Walls		
	2nd Floor Walls		
	Vaulted Ceiling		
	Drop Beam		
Nail Information			

Header

16d/3-1/2" | 16d/3-1/2"

Hatch Legend

Truss

		Products - Field Framed		
PlotID	Length	Product	Plies	Net Qty
BM1	19' 0"	1-3/4"x 18" LVL Kerto-S	2	2
BM2	5' 0"	1-3/4"x 14" LVL Kerto-S	2	2
BM3	7' 0"	1-3/4"x 9-1/4" LVL Kerto-S	2	2
GDH	22' 0"	1-3/4"x 18" LVL Kerto-S	2	2
		Products - Field Framed		
PlotID	Length	Product	Plies	Net Qty
BM4	16' 0"	1-3/4"x 14" LVL Kerto-S	2	2

Supported

Truss Placement Plan
Scale: 1/4"=1'

ROOF & FLOOR TRUSSES & BEAMS

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Fax: (910) 864-4444

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David Landry

David Landry

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(BASED ON TABLES R502.5(1) & (b))

	(D	ASED O	IN INDEE	S KOUL.	.υ(1) α (I	7))	
NUA	MBER C		STUDS R			A END O	F
END REACTION (UP TO)	REQ'D STUDS FOR (2) PLY HEADER		END REACTION (UP TO)	REQ'D STUDS FOR (3) PLY HEADER		END REACTION (UP TO)	REQ'D STUDS FOR
1700	1		2550	1		3400	3
3400	2		5100	2		6800	ä
5100	3		7650	3		10200	3
6800	4		10200	4		13600	
3500	5		12750	5		17000	Ę
0200	6		15300	6			
1900	7						
3600	8						
5300	9						

MODEL Roof	<b>DATE REV</b> . 03/04/24
	DRAWN BY David Landry

RUTIDER	Precision Custom Homes and Renovations	02 / XTT2	
JOB NAME	JOB NAME Lot 61 Liberty Meadows	ADDRESS	
PLAN	Anconia	MODEL	
SEAL DATE N/A	N/A	DATE REV.	
QUOTE#		DRAWN BY	
			1

J0224-0808

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#### North Carolina 2018 - R402.1.5 Total UA

Property

32 Brewster Ct Cameron, NC 28326 Model: Anconia

Community: Liberty Meadows

Template - SMG Precision - Liberty Meadows Lot 33 - CZ 4 slab -Liberty Meadows Lot 33 Organization

Southern Energy Manager

Justin Smith

Builder

SMG Precision Properties



This report is based on a proposed design and does not confirm field enforcement of design elements.

Inspection Status

Results are projected

#### Building UA

Elements	NC Reference	As Designed
Ceilings	52.2	49.6
Above-Grade Walls	219.5	163.0
Windows, Doors and Skylights	122.3	110.4
Slab Floor:	95.1	123.3
Framed Floors	15.8	17.2
Foundation Walls	0.0	0.0
Rim Joists	7.4	6.0
Overall UA (Design must be equal or lower):	512.3	469.5

#### Requirements

_			
	R402.1.5	Total UA alternative compliance passes by 8.4%.	The proposed home meets the UA requirement by 8.4%
$\bigcirc$	402.3.2	Average SHGC: 0.28 Max SHGC: 0.30	Average SHGC of 0.28 is greater than the maximum of 0.30.
	R402.4.2.2	Air Leakage Testing	Air sealing is 0.27 CFM50 / ft² Shell Area. It must not exceed 0.30 CFM50 / ft² Shell Area.
	R402.5	Area-weighted average fenestration SHGC	Area-weighted average fenestration SHGC is 0.28. The maximum allowed value is [No Limit].
	R402.5	Area-weighted average fenestration U-Factor	
	R404.1	Lighting Equipment	At least 75.0% of fixtures shall be high-efficacy lamps, currently 100.0% are high- efficacy.
	Mandatory Checklist	Mandatory code requirements that are not checked by Ekotrope must be met.	2015 IECC Mandatory Checklist must be checked as complete.
	R403.3.1	Duct Insulation	Duct insulation meets the requirements specified in North Carolina 2018 Code Section 403.3.1.
	403.3.3	Duct Testing	

#### Design exceeds requirements for North Carolina 2018 Prescriptive compliance by 8.4%.

Name:	Justin Smith	Signature:	Justin Smith
Organization:	Southern Energy Management	Digitally signed:	2/1/23 at 10:15 AM

Property
32 Brewster Ct
Cameron, NC 28326
Model: Anconia Community: Liberty Meadows

Template - SMG Precision - Liberty Meadows Lot 33

- CZ 4 slab - ecoSelect Liberty Meadows Lot 33 Organization

Southern Energy Management Justin Smith

Builder

SMG Precision Properties

Inspection Status Results are projected



General Building Information	n
Number Of Bedrooms	4
Number Of Floors	2
Conditioned Floor Area [sq. ft.]	2,477
Has Electric Vehicle Ready Space	No
Unconditioned, attached garage?	Yes
Conditioned Volume [cu. ft.]	22,622
Total Units in Building	1
Residence Type	Single family detached
Number of Floors in Building	-
Floor Number	-
Model	Anconia
Community	Liberty Meadows
RESNET/IECC 2006-2018 Climate Zone	4A
IECC 2021 Climate Zone	3A

#### **Foundation Wall**

None Present

#### **Foundation Wall Library List**

None Present

Slab								
Name	Library Type	e Perimeter	Floor Grade	Carpet R	Exposed Masonry Area	Surface Area	Location	Enclosing
slab	Uninsulated	200	On Grade	1	0	1,403.0 ft²	Exposed Exterior	Conditioned Space

	Slab Library	List						
ı	Name	Wall Construction Type	Slab Completely Insulated?			Perimeter Insulation R Value	Thermal Break	Effective R-value
	Uninsulated	Wood Frame / Other	No	0	0	0	No	0.00

Property
32 Brewster Ct
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Template - SMG Precision - Liberty Meadows Lot 33

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**Organization**Southern Energy Management
Justin Smith

Builder SMG Precision Properties Inspection Status Results are projected



Framed Floor	r				
Name	Library Type	Carpet R	Floor Grade	Surface Area	Location
over garage	R 19, 16"OC G1 Carpet	0	Above Grade	337.0 ft²	Unconditioned, attached garage

Framed Floor	Library List	
	Name	Effective R-value
R 19, 16"OC G	1 Carpet	19.566

Rim Joist			
Name	Library Type	Surface Area	Location
1st floor ambient	R 19 G1, 16"OC	87.0 ft²	Exposed Exterior
1st floor garage	R 19 G1, 16"OC	47.0 ft²	Unconditioned, attached garage

Rim Joist Library I	ist
Name	Effective Insulation R-value
5 40 04 40000	
R 19 G1, 16"OC	17.30

Wall				
Name	Library Type	Surface Color	Surface Area	Location
1st floor ambient	R 19 Adv. Framing G1 16" O.C	Medium	1,381.0 ft²	Exposed Exterior
1st floor garage	R 19 Adv. Framing G1 16" O.C	Medium	419.0 ft²	Unconditioned, attached garage
2nd floor ambient	R 19 Adv. Framing G1 16" O.C	Medium	694.0 ft²	Exposed Exterio
2nd floor attic	R 19 Adv. Framing G1 16" O.C	Medium	706.0 ft²	Atti

Property
32 Brewster Ct
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Template - SMG Precision - Liberty Meadows Lot 33 - CZ 4 slab - ecoSelect Liberty Meadows Lot 33

Organization Southern Energy Management Justin Smith

Builder

SMG Precision Properties



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<b>SOUTHERNENERGY</b>
MANAGEMENT

Wall Library List		
Na	me Effective R-val	lue
R 19 Adv. Framing G1 16" C	O.C 17.4	492

Glazing									
Name	Library Type	Wall Assignment	Foundation Wall Assignment	is Operable	Overhang Depth	Overhang Ft To Top	Overhang Ft To Bottom	Orientation	Surface Area
front 2nd unshaded	33/28	2nd floor ambient		Yes	0	0	0	Southeast	42.2 ft²
front unshaded	33/28	1st floor ambient		Yes	0	0	0	Southeast	27.0 ft²
left shaded	33/28	1st floor ambient		Yes	15	1	6	Southwest	27.0 ft²
left unshaded	33/28	1st floor ambient		Yes	0	0	0	Southwest	27.0 ft²
rear 2nd unshaded	33/28	2nd floor ambient		Yes	0	0	0	Northwest	27.0 ft²
rear shaded	33/28	1st floor ambient		Yes	12	2	9	Northwest	40.2 ft²
rear unshaded	33/28	1st floor ambient		Yes	0	0	0	Northwest	60.0 ft²
right 2nd unshaded	33/28	2nd floor ambient		Yes	0	0	0	Northeast	54.0 ft²
right unshaded	33/28	1st floor ambient		Yes	0	0	0	Northeast	7.0 ft²

Glazing Library List			
Name	Shgc	U-factor	
33/28	0.28	0.330	

Skylight	
	None Present

Property
32 Brewster Ct
Cameron, NC 28326
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Community: Liberty Meadows

Template - SMG Precision - Liberty Meadows Lot 33 - CZ 4 slab - ecoSelect Liberty Meadows Lot 33

**Organization** Southern Energy Management Justin Smith

Builder

SMG Precision Properties

Inspection Status Results are projected



#### **Skylight Library List**

None Present

Opaque Door								
Name	Library Type	Wall Assignment	Foundation Wall Assignment	Emittance	Solar Absorptance	Surface Color	Surface Area	Location
front entry	Fiberglass R-5	1st floor ambient		0.9	0.75	Medium	20.0 ft²	Exposed Exterior
garage entry	Fiberglass R-5	1st floor garage		0.9	0.75	Medium	18.0 ft²	Unconditioned, attached garage

### Opaque Door Library List

Name Effective U-factor

Fiberglass R-5

0.200

Roof Insulati	on					
Name	Library Type	Attic Exterior Area [ft²]	Clay or Concrete Roof Tiles	Surface Colo	r Surface Area	a Location
attic	R 38 Attic BLOWN FG G1 2x10 24"OC NO	2,557.8	No	Dark	1,740.0 ft²	Attic

Roof Insulation Library List					
Name	Has Radiant Barrier	Effective R-value			
R 38 Attic BLOWN FG G1 2x10 24"OC NO	No	35.115			

Whole House Infile	ration		
Infiltration	Measurement Type	Shelter Class	
1809 CFM at 50 Pa	Blower-door tested	4	

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SMG Precision Properties



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<b>SOUTHERNENERGY</b>
MANAGEMENT
ENERGY EEDICIENCY & SOLAD POWER

Mechanical Ventilation	
	None Present

Inspection Status

Results are projected

	Lighting					
ı	% Interior Fluorescent Lighting	% Interior LED Lighting	% Exterior Fluorescent Lighting	% Exterior LED Lighting	% Garage Fluorescent Lighting	% Garage LED Lighting
ı	10	90	0	0	0	0

1	Lighting		Lighting		Lighting	
	10	90	0	0	0	0
	Onsite Gener	ation				

#### **Onsite Generation Library List** None Present

None Present

Solar Generation	
N	one Present

Dehumidifier			
	None Present		

Dehumidifier Library List	
	None Present

Property
32 Brewster Ct
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Template - SMG Precision - Liberty Meadows Lot 33

- CZ 4 slab - ecoSelect Liberty Meadows Lot 33 Organization

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Builder

SMG Precision Properties

Inspection Status Results are projected



#### Whole House Fan

None Present

#### Whole House Fan Library List

None Present

Conditioning	Equipment					
Name	Library Type	Serial Number	Heating Percent Load	Cooling Percent Load	Hot Water Percent Load	Location
1st floor heat pump	z 24k 14 SEER 8.2hspf		57%	57%	0%	Attic
2nd floor heat pump	z 30k 14 SEER 8.2hspf		43%	43%	0%	Attic
Water Heating	z 50 gal. 0.95 EF Elec		0%	0%	100%	Unconditioned Garage

Equipment Type: z 24k 14 SEER 8.2hspf		
Equipment Type	Air Source Heat Pump	
Fuel Type	Electric	
Distribution Type	Forced Air	
Motor Type	PSC (Single Speed)	
Heating Efficiency	8.2 HSPF	
Heating Capacity [kBtu/h]	24	
Backup Fuel Type	Electric	
Switchover Temperature [°F]	0	
Backup Heating Efficiency	1 COP	
Use default Supplemental Heat	Yes	
Cooling Efficiency	14 SEER	
Cooling Capacity [kBtu/h]	24	

Property
32 Brewster Ct
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Template - SMG Precision - Liberty Meadows Lot 33 - CZ 4 slab - ecoSelect

Liberty Meadows Lot 33

Organization Southern Energy Management Justin Smith

Builder

SMG Precision Properties

Inspection Status SOUTHERN ENERGY M A N A G E M E N T ENERGY EFFICIENCY & SOLAR POWER Results are projected

Equipment Type: z 30k 14 SEER 8.2hspf		
Equipment Type	Air Source Heat Pump	
Fuel Type	Electric	
Distribution Type	Forced Air	
Motor Type	PSC (Single Speed)	
Heating Efficiency	8.2 HSPF	
Heating Capacity [kBtu/h]	30	
Backup Fuel Type	Electric	
Switchover Temperature [°F]	0	
Backup Heating Efficiency	1 COP	
Use default Supplemental Heat	Yes	
Cooling Efficiency	14 SEER	
Cooling Capacity [kBtu/h]	30	

Equipment Type: z 50 gal. 0.95 EF Elec		
Equipment Type	Residential Water Heater	
Fuel Type	Electric	
Distribution Type	Hydronic Delivery (Radiant)	
Hot Water Efficiency	0.95 Energy Factor	
Tank Capacity (gal.)	50	
Hot Water Capacity [kBtu/h]	40	
Recovery Efficiency	0.98	

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Liberty Meadows Lot 33

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Inspection Status Results are projected



Distribution System	
Distribution Type	Forced Air
Heating Equipment	1st floor heat pump
Cooling Equipment	1st floor heat pump
Sq. Feet Served	1,403
# Return Grilles	2
Supply Duct R Value	8
Return Duct R Value	8
Supply Duct Area [ft²]	378.81
Return Duct Area [ft²]	140.3
Leakage to Outdoors	56 CFM @ 25Pa (3.99 / 100 ft²)
Total Leakage	56 CFM25
Total Leakage Duct Test Conditions	Post-Construction
Use Default Flow Rate	Yes
Duct 1	
Duct Location	Attic (well vented)
Percent Supply Area	100
Percent Return Area	100
Duct 2	
Duct Location	Conditioned Space
Percent Supply Area	0
Percent Return Area	0
Duct 3	
Duct Location	Conditioned Space
Percent Supply Area	0
Percent Return Area	0
Duct 4	
Duct Location	Conditioned Space
Percent Supply Area	0
Percent Return Area	0
Duct 5	0 177 10
Duct Location	Conditioned Space
Percent Supply Area	0
Percent Return Area	0
Duct 6	Conditioned Conse
Duct Location	Conditioned Space
Percent Supply Area Percent Return Area	0
Percent Return Area	0

Property
32 Brewster Ct
Cameron, NC 28326
Model: Anconia Community: Liberty Meadows

Template - SMG Precision - Liberty Meadows Lot 33

- CZ 4 slab - ecoSelect Liberty Meadows Lot 33 Organization

Southern Energy Management Justin Smith

Inspection Status

Results are projected

Builder

SMG Precision Properties



Distribution Type	Forced Air
Heating Equipment	2nd floor heat pump
Cooling Equipment	2nd floor heat pump
Sq. Feet Served	1,074
# Return Grilles	2
Supply Duct R Value	8
Return Duct R Value	8
Supply Duct Area [ft²]	289.98
Return Duct Area [ft²]	107.4
Leakage to Outdoors	42 CFM @ 25Pa (3.91 / 100 ft²)
Total Leakage	42 CFM25
Total Leakage Duct Test Conditions	Post-Construction
Use Default Flow Rate	Yes
Duct 1	
Duct Location	Attic (well vented)
Percent Supply Area	100
Percent Return Area	100
Duct 2	
Duct Location	Conditioned Space
Percent Supply Area	0
Percent Return Area	0
Duct 3	
Duct Location	Conditioned Space
Percent Supply Area	0
Percent Return Area	0
Duct 4	
Duct Location	Conditioned Space
Percent Supply Area	0
Percent Return Area	0
Duct 5	
Duct Location	Conditioned Space
Percent Supply Area	0
Percent Return Area	0
Duct 6	
Duct Location	Conditioned Space
Percent Supply Area	0
Percent Return Area	0

#### **HVAC Grading**

HVAC Grading Not Conducted

Ceiling Fan		
Has Ceiling Fan	No	
Cfm Per Watt	100	

Property
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Template - SMG Precision - Liberty Meadows Lot 33 - CZ 4 slab - ecoSelect

Liberty Meadows Lot 33

Organization

Southern Energy Management Justin Smith

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SMG Precision Properties



Water Distribution	
Water Fixture Type	Low-flow
Use Default Hot Water Pipe Length	No
Hot Water Pipe Length [ft]	100
At Least R3 Pipe Insulation?	No
Hot Water Recirculation System?	No
Recirculation System Pipe Loop Length [ft]	20
Drain Water Heat Recovery?	No

Clothes Dryer	
Cef	3.01
Fuel Type	Electric
Field Utilization	Timer Controls
Is Outside Conditioned Space	No
Clothes Dryer Available	Yes
Defaults Type	HERS Reference

Clothes Washer	
Label Energy Rating	153 kWh/Year
Annual Gas Cost	\$12.00
Electric Rate	\$0.11/kWh
Gas Rate	\$1.22/Therm
Capacity	3.31
Imef	2.1547
Defaults Type	Custom
Load Type	Front-load
Loads Per Week	6
Is Outside Conditioned Space	No
Clothes Washer Available	Yes
·	***

Dishwasher	
Dishwasher Efficiency	270 kWh
Dishwasher Size	Standard
Annual Gas Cost	\$22.23
Electric Rate	\$0.12/kWh
Gas Rate	\$1.09/Therm
Is Outside Conditioned Space	No

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Southern Energy Management Justin Smith

Builder

SMG Precision Properties





Appliances and Controls	
Thermostat Cooling Setpoint	* * * * 75.0
Thermostat Heating Setpoint	* * * * 70.0
Range/Oven Fuel	Electric
Convection Oven?	No
Induction Range?	No
Range/Oven Outside Conditioned Space?	No
Refrigerator Consumption	538 kWh/Year
Refrigerator Outside Conditioned Space?	No

#### Notes

Initial Inputs \_\_\_\_\_JS 02/01/22\_\_\_\_\_

- -confirm HVAC specs
- -confirm water heater specs
- -confirm ventilation entry
- -modeled to worst case orientation -confirm cfl lighting %