

Lot 2 Lemuel Black 2919 Lemuel black Road

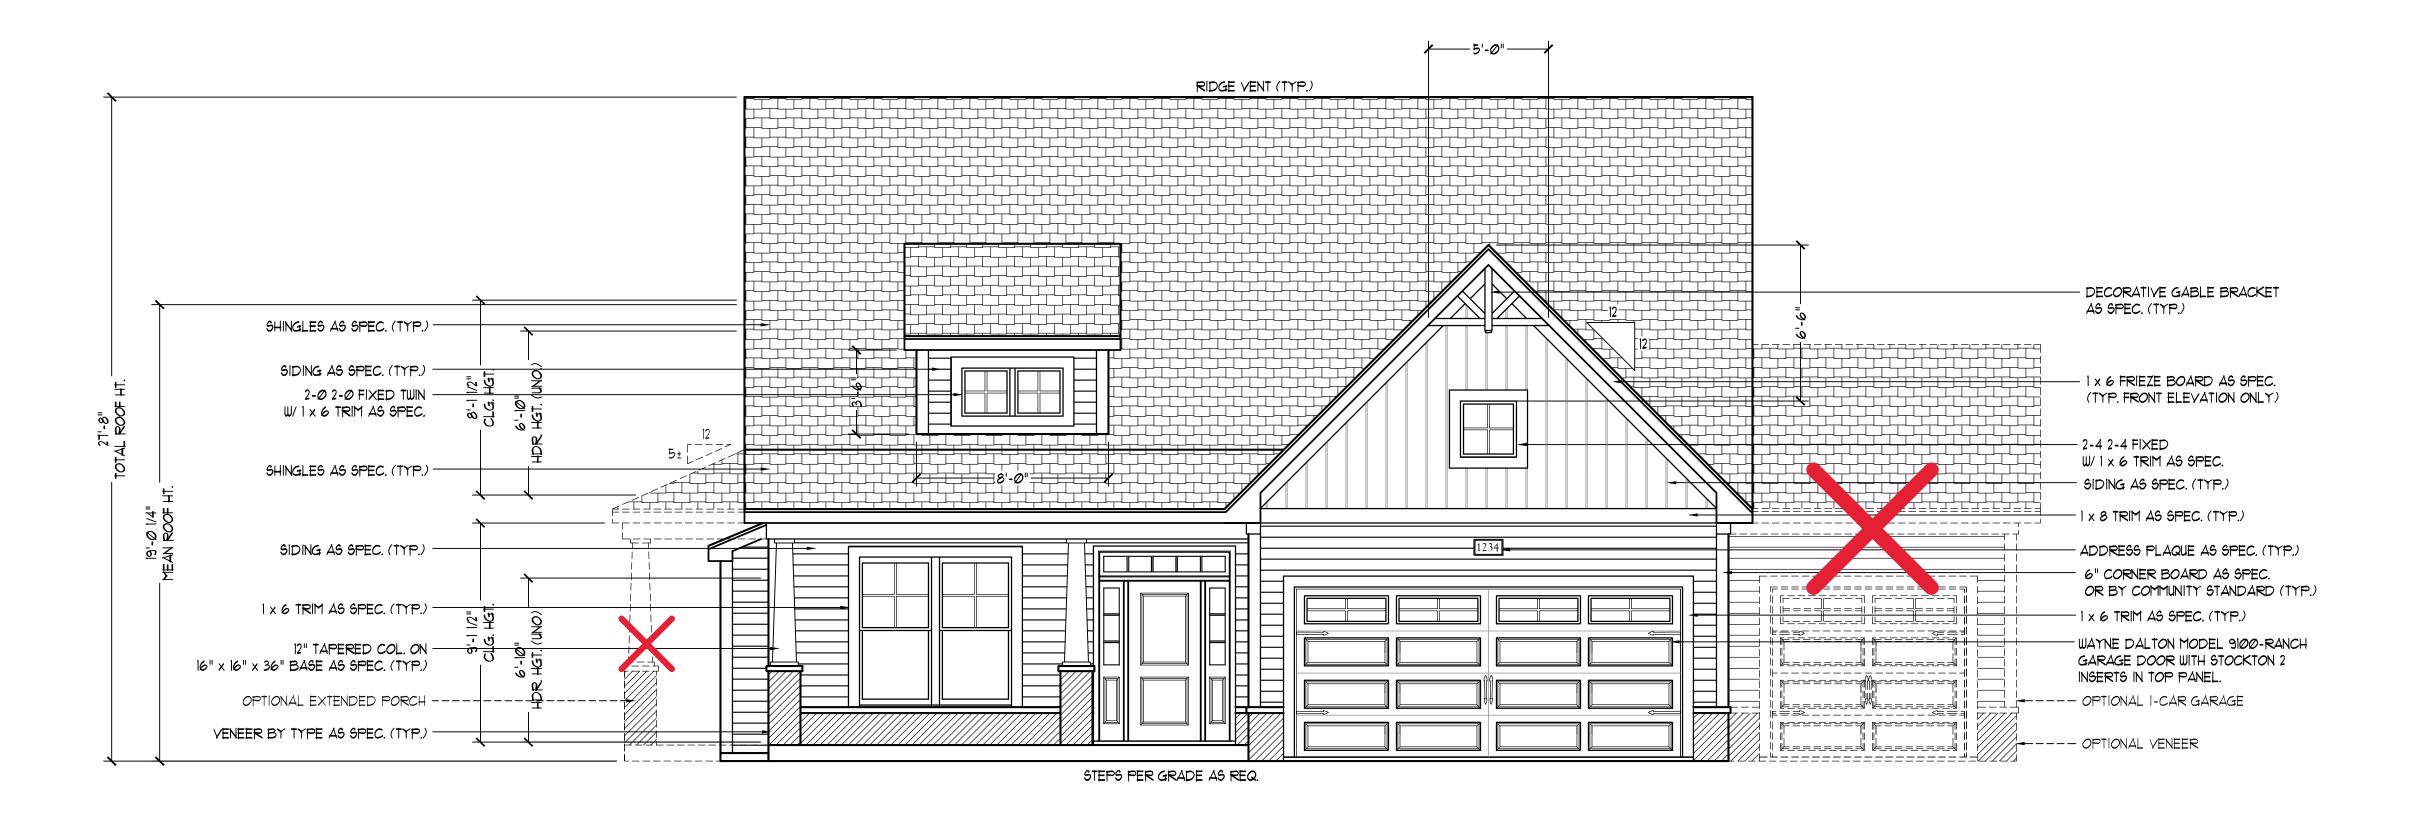

FRONT ELEVATION-B SCALE: 1/4" = 1'-0"

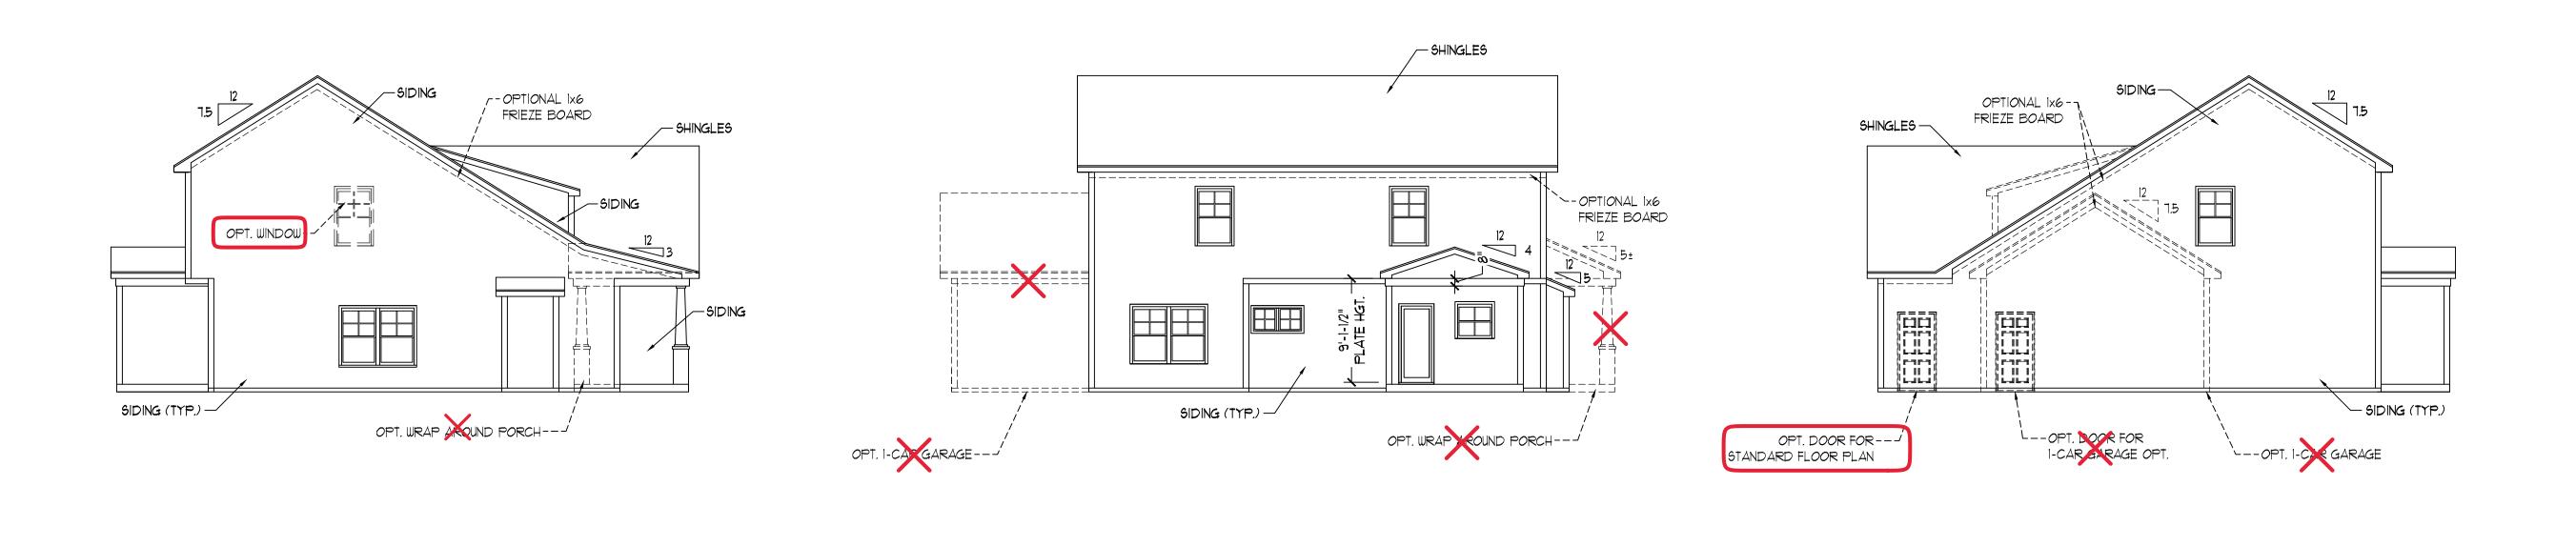

REAR ELEVATION SCALE: 1/8" = 1'-0"

RIGHT ELEVATION SCALE: 1/8" = 1'-0"

 $C: \label{locuments} \label{locuments} C: \label{locuments} \label{locuments} C: \label{locuments} C: \label{locuments} \label{locuments} C: \label{locuments} \label{locuments} C: \label{locuments} \label{locuments} C: \label{locuments} \label{locuments} \label{locuments} C: \label{locuments} \label{locuments} \label{locuments} \label{locuments} \label{locuments} \label{locuments} C: \label{locuments} \label{locuments} \label{locuments} \label{locuments} C: \label{locuments} \label{locuments$

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N.C. LICENSE NO.: C-1733



ONSITE HOMES STEDMAN

DATE: MARCH 31, 2021

<u>LEFT ELEVATION</u> SCALE: 1/8" = 1'-0"

SCALE: AS NOTED DRAWN BY: WG

ENGINEERED BY: JAG


REVIEWED BY: MGS

B - ELEVATIONS

A-2

SQUARE FOOTAGE (STUD)

1177 SQ. FT. 1st FLOOR: 908 SQ. FT. 2nd FLOOR: 2085 SQ. FT. FRONT PORCH: 119 SQ. FT. 96 SQ. FT. REAR PORCH: 96 SQ. FT. OPT. PATIO: GARAGE: 423 SQ. FT. OPT. 1-CAR GARAGE: 240 SQ. FT. OPT. PORCH WRAP: 60 SQ. FT.

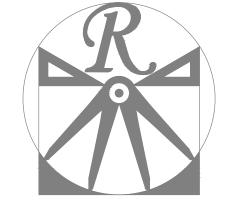

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ONSITE HOMES STEDMAN

DATE: MARCH 31, 2021

REV.:

SCALE: 1/4"=1'-0"


DRAWN BY: WG

ENGINEERED BY: JAG

REVIEWED BY: MGS

FIRST FLOOR PLAN

A-3

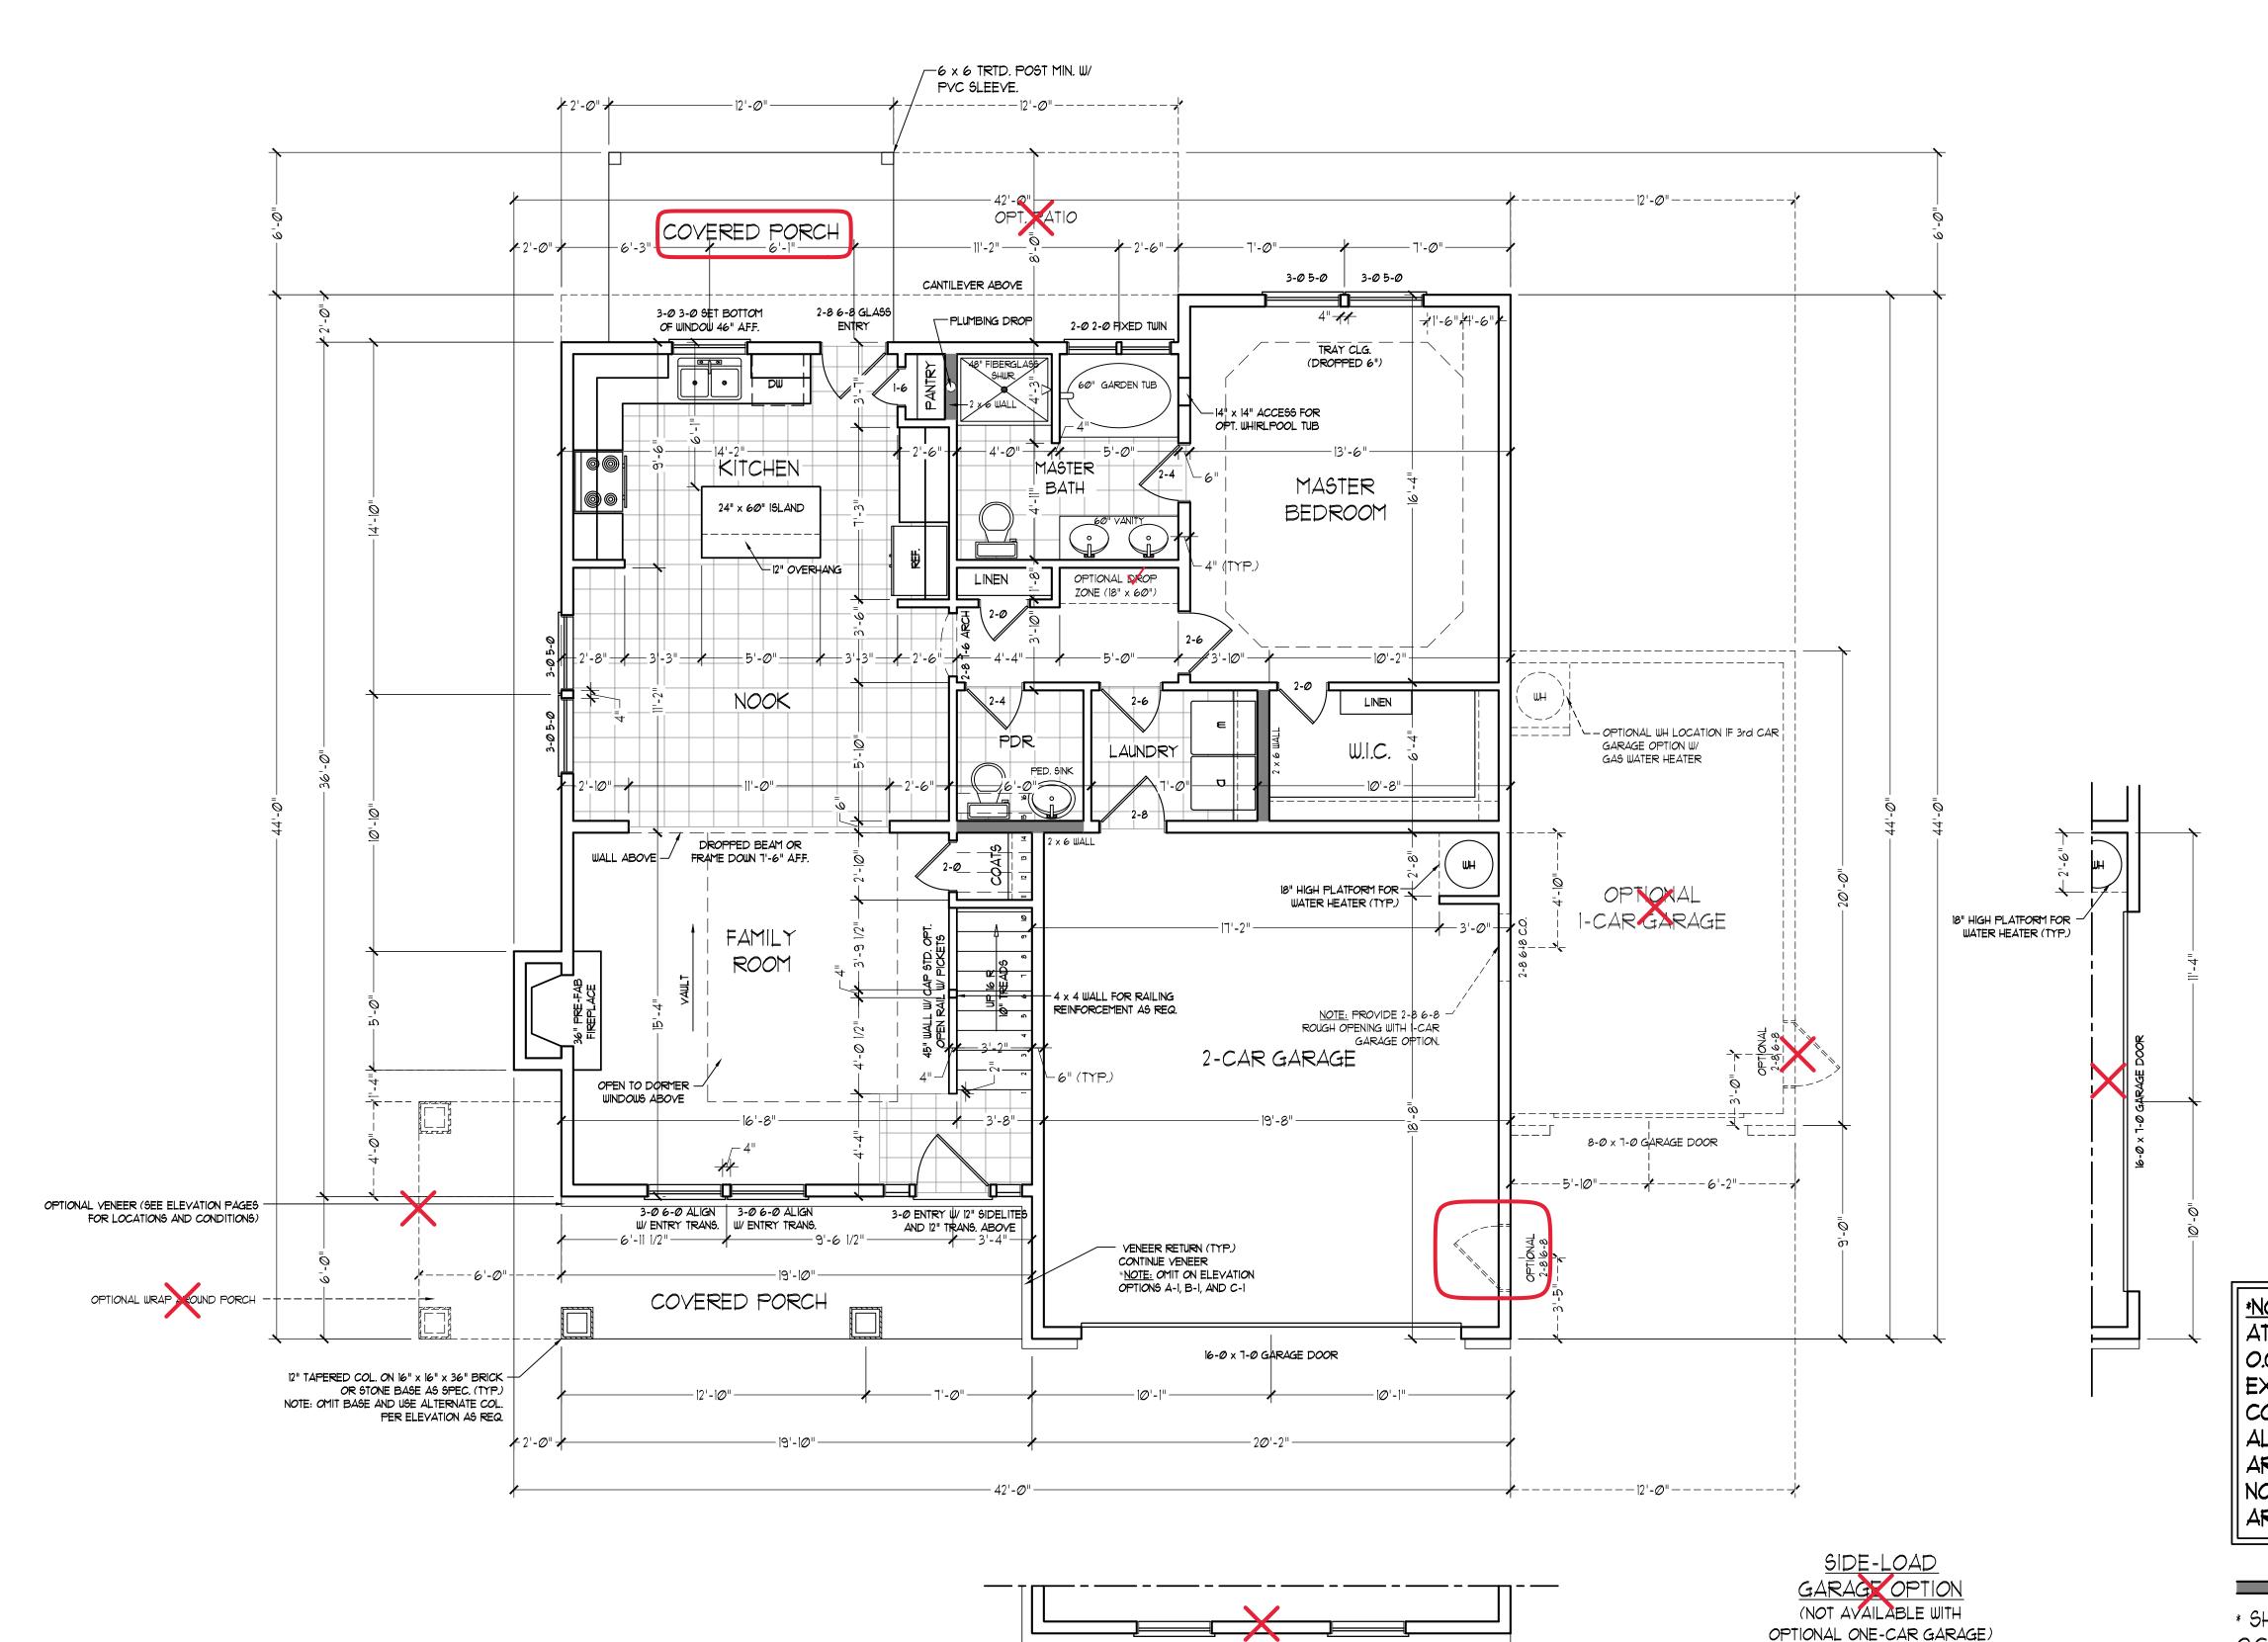

3-06-0

ALIGN W/ ENTRY TRANS.


3-06-0


ALIGN W/ ENTRY TRANS.

*NOTE: ALL EXTERIOR WALLS AND ATTIC WALLS ARE TO BE 2 x 4 @ 16"
O.C. MIN. (UNO). 2 x 6 @ 16" O.C.
EXTERIOR WALLS MAY BE
CONSTRUCTED IN LIEU OF 2 x 4 WALLS.
ALL INTERIOR LOAD BEARING WALLS
ARE TO BE 2 x 4 @ 16" O.C. (UNO) AND
NON-LOAD BEARING INTERIOR WALLS
ARE TO BE 2 x 4 @ 24" O.C. (UNO).

2x6 WALL

* SHADED WALLS ARE TO BE 2 x 6 @ 16" O.C. (LOAD BEARING) OR 2 x 6 @ 24" O.C. (NON-LOAD BEARING) REGARDLESS OF EXTERIOR WALL CONDITION

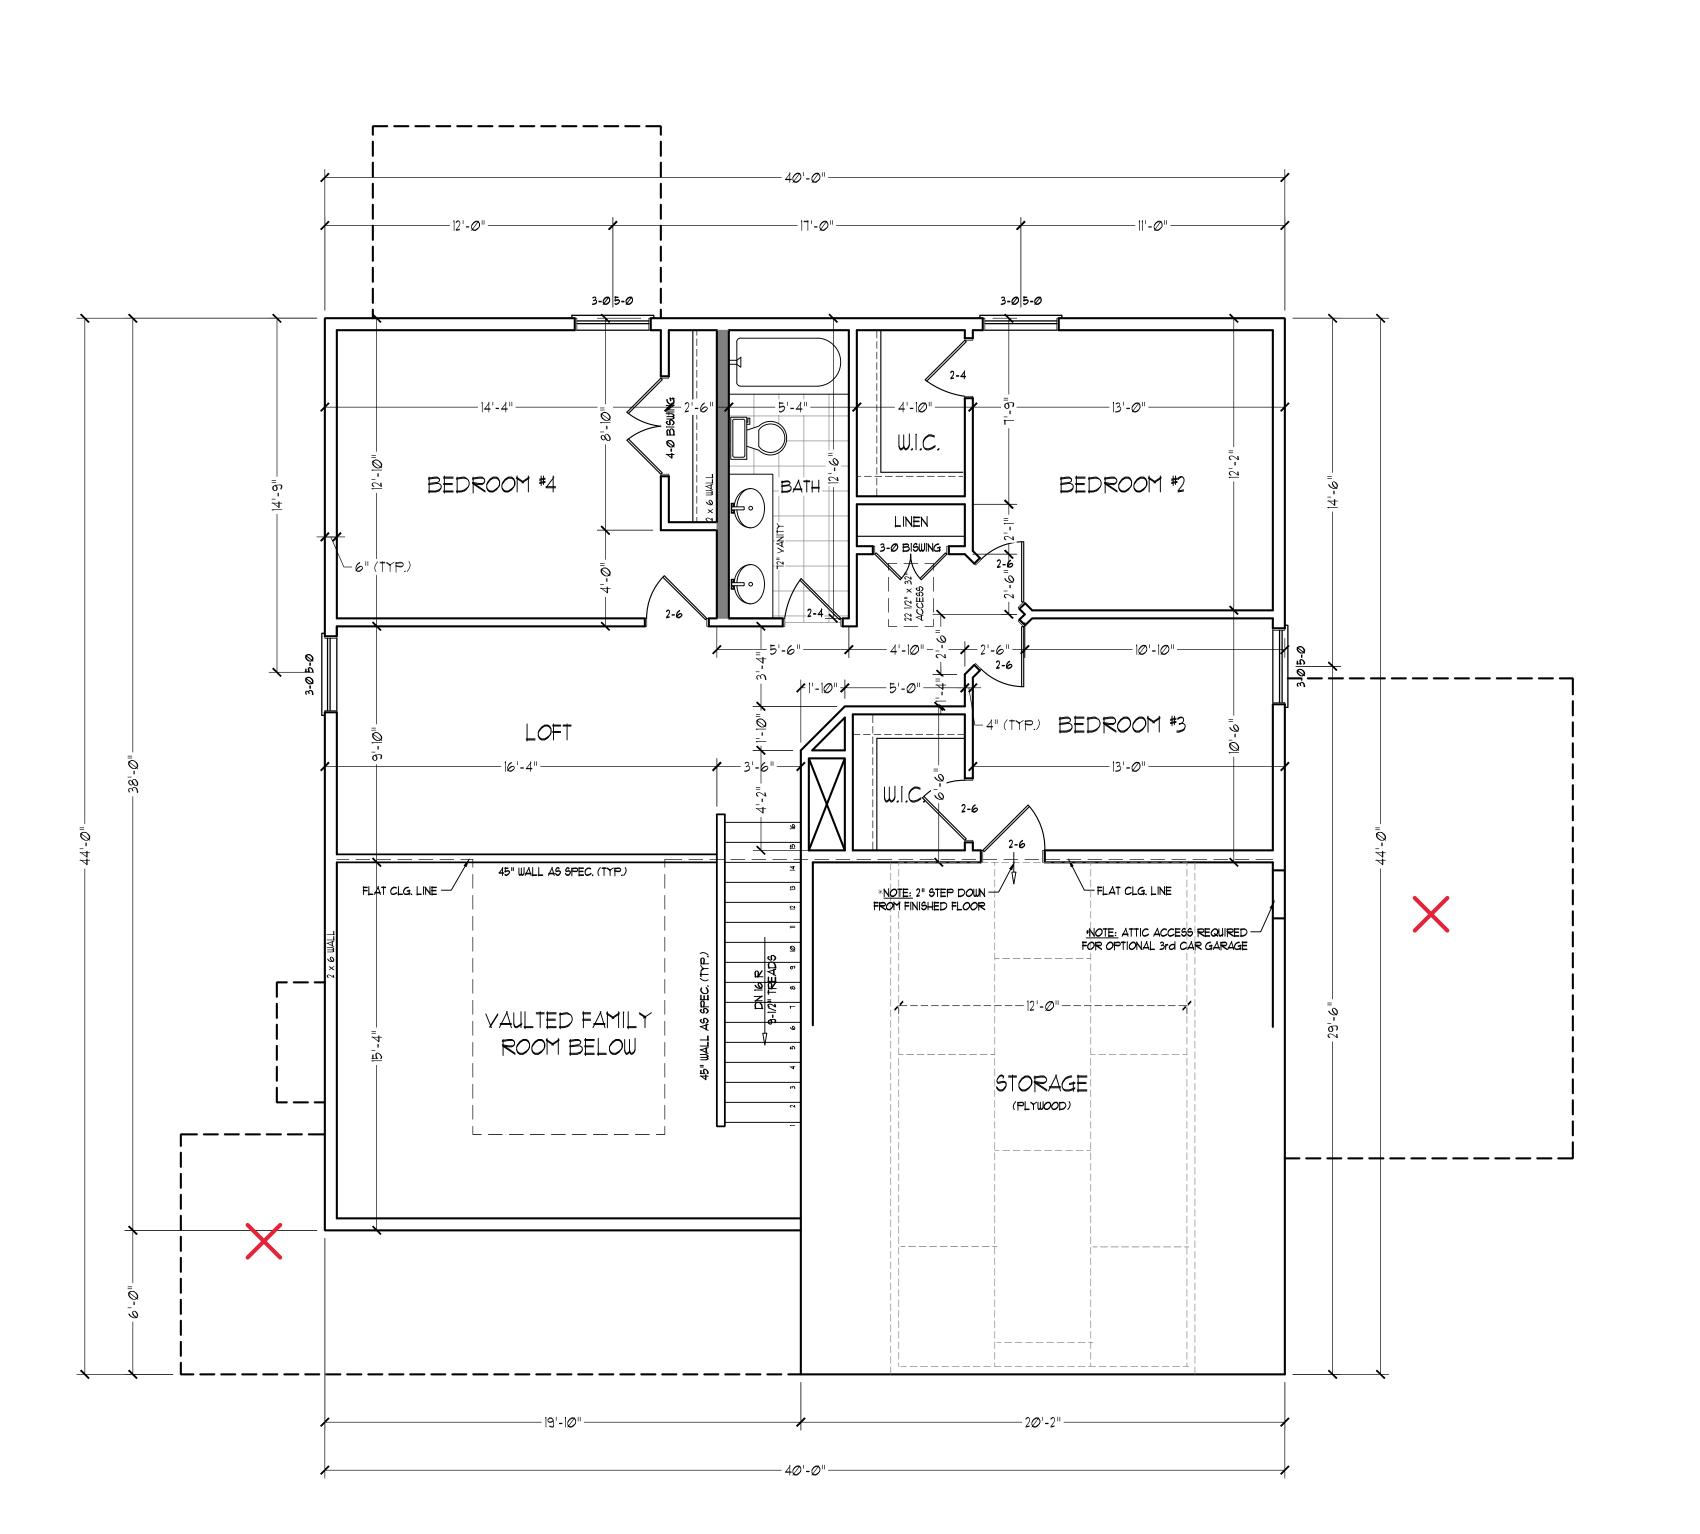

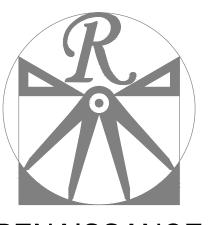

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ONSITE HOMES STEDMAN

DATE: MARCH 31, 2021

SCALE: 1/4"=1'-0"

DRAWN BY: WG

ENGINEERED BY: JAG

REVIEWED BY: MGS


SECOND FLOOR PLAN

A-4

*NOTE: ALL EXTERIOR WALLS AND ATTIC WALLS ARE TO BE 2 x 4 @ 16" O.C. MIN. (UNO). 2 x 6 @ 16" O.C. EXTERIOR WALLS MAY BE CONSTRUCTED IN LIEU OF 2 x 4 WALLS. ALL INTERIOR LOAD BEARING WALLS ARE TO BE 2 x 4 @ 16" O.C. (UNO) AND NON-LOAD BEARING INTERIOR WALLS ARE TO BE 2 x 4 @ 24" O.C. (UNO).

2x6 WALL

* SHADED WALLS ARE TO BE 2 x 6 @ 16" O.C. (LOAD BEARING) OR 2 x 6 @ 24" O.C. (NON-LOAD BEARING) REGARDLESS OF EXTERIOR WALL CONDITION

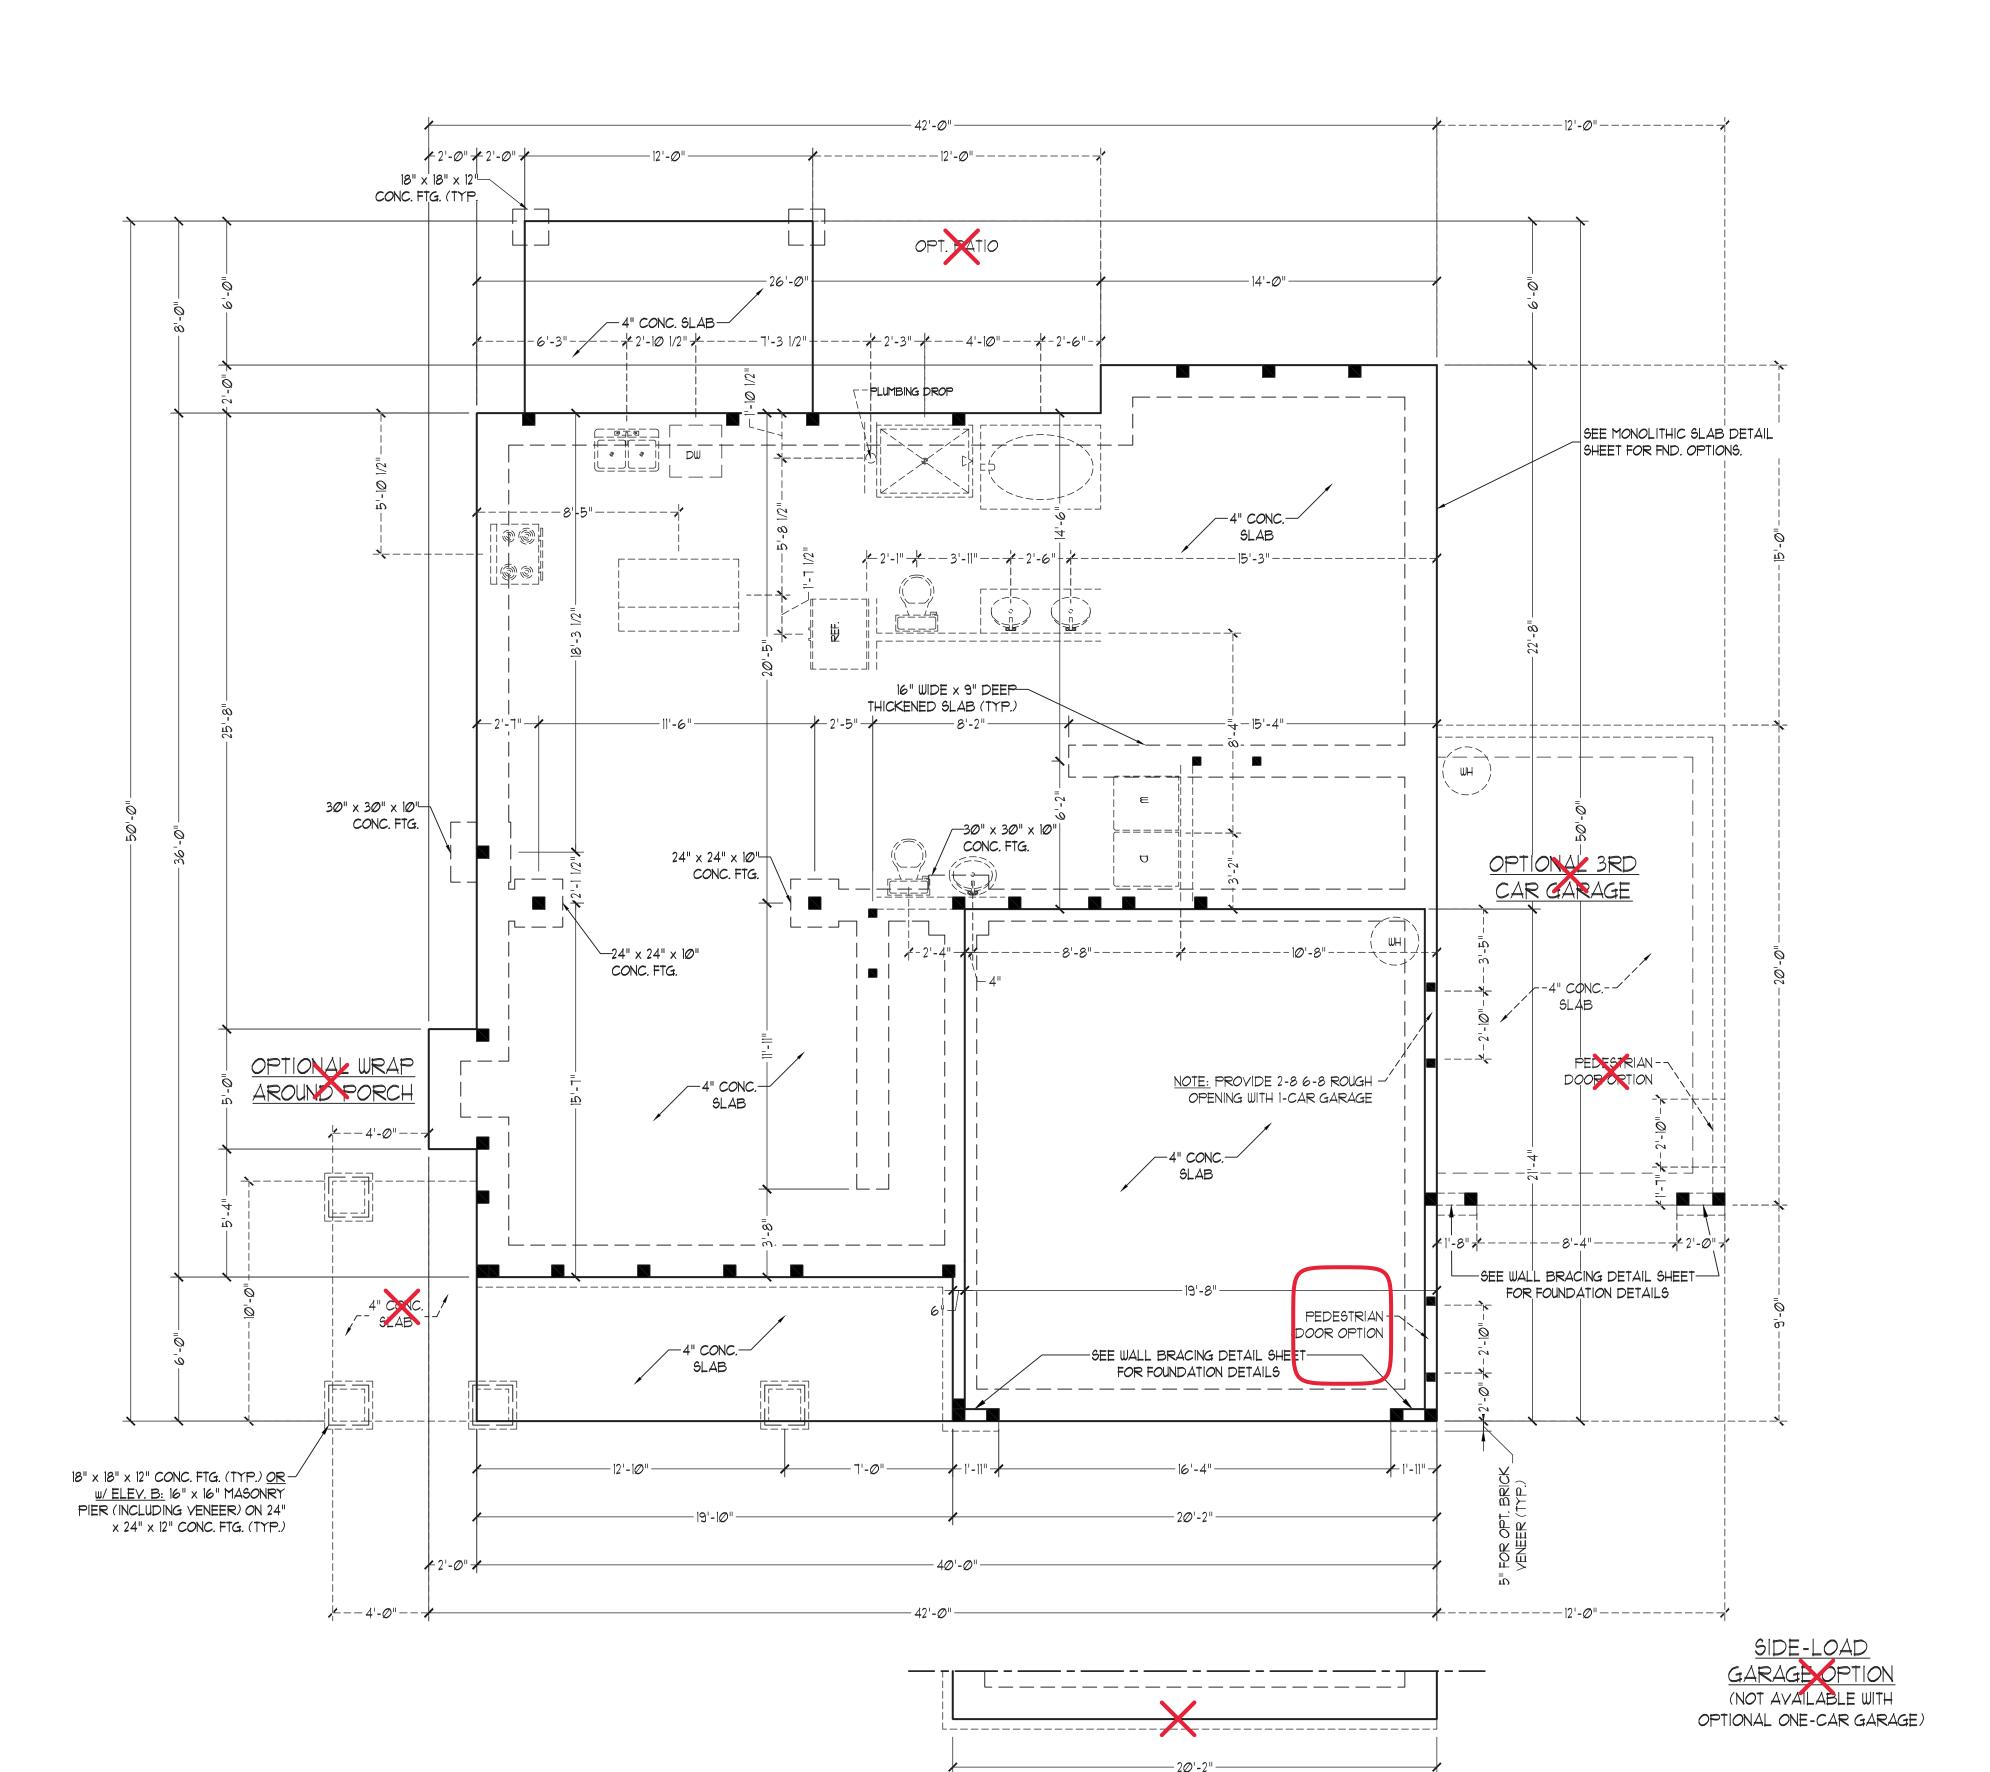

120 MPH ULTIMATE DESIGN WIND SPEED NOTES FOR LESS THAN <u>30' MEAN ROOF HEIGHT:</u>

- ENGINEER'S SEAL APPLIES ONLY TO STRUCTURAL COMPONENTS. ENGINEER'S SEAL DOES NOT CERTIFY DIMENSIONAL
- ACCURACY OR ARCHITECTURAL LAYOUT INCLUDING ROOF SYSTEM. STRUCTURAL DESIGN PER NORTH CAROLINA
- RESIDENTIAL CODE, 2018 EDITION. . INSTALL 1/2" ANCHOR BOLTS 6'-0" O.C. AND WITHIN 1'-0" FROM END OF EACH CORNER. ANCHOR BOLTS MUST EXTEND A MINIMUM OF 1" INTO MASONRY OR CONCRETE. LOCATE BOLT WITHIN MIDDLE THIRD OF PLATE WIDTH.
- 4. MEAN ROOF HEIGHT IS LESS THAN 30 FEET. 5. EXTERIOR WALLS DESIGNED FOR 120 MPH
- 6. WALL CLADDING DESIGNED FOR +15.5 PSF AND -20 PSF (+/- INDICATE POSITIVE /
- NEGATIVE PRESSURE (TYP). ROOF CLADDING DESIGNED FOR +14.2 PSF AND -18 PSF FOR ROOF PITCHES 7/12 TO 12/12 AND +10 PSF AND -36 PSF FOR ROOF PITCHED 2.25/12 TO 7/12.
- B. INSTALL 1/16" OSB SHEATHING ON ALL EXTERIOR WALLS OF ALL STORIES IN ACCORDANCE WITH SECTION R602.10.3 OF THE NCRC, 2018 EDITION. SEE THE WALL BRACING NOTES AND DETAILS SHEET FOR MORE INFORMATION.
- 9. ENERGY EFFICIENCY COMPLIANCE AND INSULATION VALUES OF THE BUILDING TO BE IN ACCORDANCE WITH CHAPTER II OF THE NCRC, 2018 EDITION.
- 10. REFER TO NOTES AND DETAIL SHEETS FOR ADDITIONAL STRUCTURAL INFORMATION.



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DATE: MARCH 31, 2021 REV.:

SCALE: 1/4"=1'-0"

DRAWN BY: WG

ENGINEERED BY: JAG REVIEWED BY: MGS

MONO SLAB FOUNDATION PLAN



BRACED WALL DESIGN

RECTANGLE A SIDE IA (FRONT LOAD) METHOD: CS-WSP/PF/GB

TOTAL REQUIRED LENGTH: 13.85' TOTAL PROVIDED LENGTH: 20.17' <u>SIDE 2A</u> METHOD: CS-WSP

TOTAL REQUIRED LENGTH: 13.85' TOTAL PROVIDED LENGTH: 19.48' METHOD: CS-WSP TOTAL REQUIRED LENGTH: 12.55'

TOTAL PROVIDED LENGTH: 29.33' SIDE 4A (SIDE LOAD) METHOD: CS-WSP/PF TOTAL REQUIRED LENGTH: 12.55'

> (NOT AVAILABLE WITH OPTIONAL ONE-CAR GARAGE)

RECTANGLE B SIDE IB

TOTAL PROVIDED LENGTH: 6.0'

TOTAL REQUIRED LENGTH: 2.5'

TOTAL PROVIDED LENGTH: 12.0'

TOTAL REQUIRED LENGTH: 14.55'

TOTAL PROVIDED LENGTH: 27.17'

TOTAL REQUIRED LENGTH: 2.0'

<u> SIDE 2B</u>

SIDE 4B

TOTAL PROVIDED LENGTH: 31.0' TOTAL PROVIDED LENGTH: 15.58'

METHOD: CS-WSP

SIDE 3B/4A SHARED

METHOD: CS-WSP

METHOD: CS-WSP

BRACED WALL DESIGN PER SECTION R602.10 OF THE NCRC 2018 EDITION. CS-WSP REFERS TO "CONTINUOUS SHEATHING - WOOD METHOD: CS-WSP/PF TOTAL REQUIRED LENGTH: 2.5'

BRACED WALL DESIGN NOTES:

STRUCTURAL PANELS" CONTRACTOR IS TO INSTALL 1/16" OSB ON ALL EXTERIOR WALLS ATTACHED w/8d NAILS SPACED 6" O.C. ALONG PANEL EDGES AND 12" O.C. IN THE FIELD. *GB REFERS TO "GYPSUM BOARD" CONTRACTOR IS TO INSTALL 1/2" (MIN.) GYPSUM WALL BOARD WHERE NOTED ON THE PLANS.

BOTTOM PLATES. BRACED WALL DESIGN APPLIES IN WIND ZONES UP TO 130 MPH. FOR HIGH WIND ZONES, BRACE WALLS ARE TO BE CONSTRUCTED IN ACCORDANCE WITH CHAPTER 45 OF THE NCRC, 2018 EDITION. SEE NOTES AND DETAIL SHEETS FOR ADDITIONAL BRACED WALL INFORMATION.

FASTEN GB WITH 1 1/4" SCREWS OR 1 5/8" NAILS SPACED 7" O.C. RESIDENTIAL DESIGN, INC. ALONG PANEL EDGES AND IN THE FIELD INCLUDING TOP AND

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NOTE: BCI 50006-1.8 JOISTS MAY BE INSTALLED IN LIEU OF TJI 210 JOISTS AT THE DEPTH AND SPACING INDICATED ON THE PLAN

(3) 2 x 6 JACKS AND

(3) 2 x 6 KING STUDS

STRUCTURAL NOTES:

ALL FRAMING LUMBER TO BE SPF #2 (UNO). ALL TREATED LUMBER TO BE SYP #2 (UNO.) ALL LOAD BEARING HEADERS TO BE

(2) 2 x 6 SPF #2 OR SYP #2 (KILN DRIED) (UNO). HEADERS HAVE BEEN DESIGNED BASED ON CALCULATED LOADS. CODE TABLES HAVE NOT BEEN USED.

INSTALL AN EXTRA JOIST UNDER WALLS PARALLEL TO FLOOR JOISTS WHERE NOTED ON THE PLANS.

WINDOW AND DOOR HEADERS TO BE SUPPORTED w/(1) JACK STUD AND (1) KING STUD EA. END (UNO.). SEE TABLE R602.7.5 FOR ADDITIONAL KING STUD REQUIREMENTS.

SQUARES DENOTE POINT LOADS WHICH REQUIRE SOLID BLOCKING TO GIRDER OR FOUNDATION. ALL SQUARES TO BE (2) STUDS (UNO.)

6. ALL 4 x 4 POSTS SHALL BE ANCHORED TO SLABS W/ SIMPSON ABU44 POST BASES (OR EQUAL) AND 6 x 6 POSTS w/ ABU66 POST BASES (OR EQUAL) (UNO). ALL 4 x 4 AND 6 x 6 POSTS TO BE INSTALLED WITH 100 LB CAPACITY UPLIFT CONNECTORS AT TOP (UNO.)

FOR FIBERGLASS, ALUMINUM, OR COLUMN ENG. BY OTHERS, SECURE TO SLAB w/ (2) METAL ANGLES USING 2" CONC. SCREWS. FASTEN ANGLES TO COLUMNS w/ 1/4" THROUGH BOLTS w/ NUTS AND WASHERS. LOCATE ANGLES ON OPPOSITE SIDES OF COLUMN. THROUGH BOLTS MUST BE INSTALLED PRIOR TO SETTING COLUMN.


REFER TO NOTES AND DETAIL SHEETS FOR ADDITIONAL STRUCTURAL INFORMATION.

TABLE R602.7.5 MINIMUM NUMBER OF FULL HEIGHT STUDS AT EACH END OF HEADERS IN EXTERIOR WALLS

HEADER SPAN (FEET)	MAXIMUM STUD SPACING (INCHES) (PER TABLE R602.3(5)	
	16	24
UP TO 3'	1	1
4'	2	1
8'	3	2
12'	5	3
16'	6	4

	LEGEND		
CONT	CONTINUOUS		
XJ	EXTRA JOIST		
DJ	DOUBLE JOIST		
ŤJ	TRIPLE JOIST		
EΑ	EACH		
()	NUMBER OF STUDS		
DSP	DOUBLE STUD POCKET		
TSP	TRIPLE STUD POCKET		
oc	ON CENTER		
SPF	SPRUCE PINE FIR		
SYP	SOUTHERN YELLOW PINE		
TRTD	PRESSURE TREATED		
TYP	TYPICAL		
UNO	UNLESS NOTED OTHERWISE		



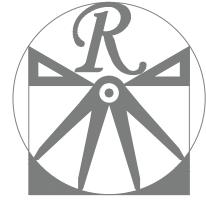

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DATE: MARCH 31, 2021


REV.: SCALE: 1/4"=1'-0"

DRAWN BY: WG

ENGINEERED BY: JAG **REVIEWED BY: MGS**

SECOND FLOOR FRAMING PLAN


S-2

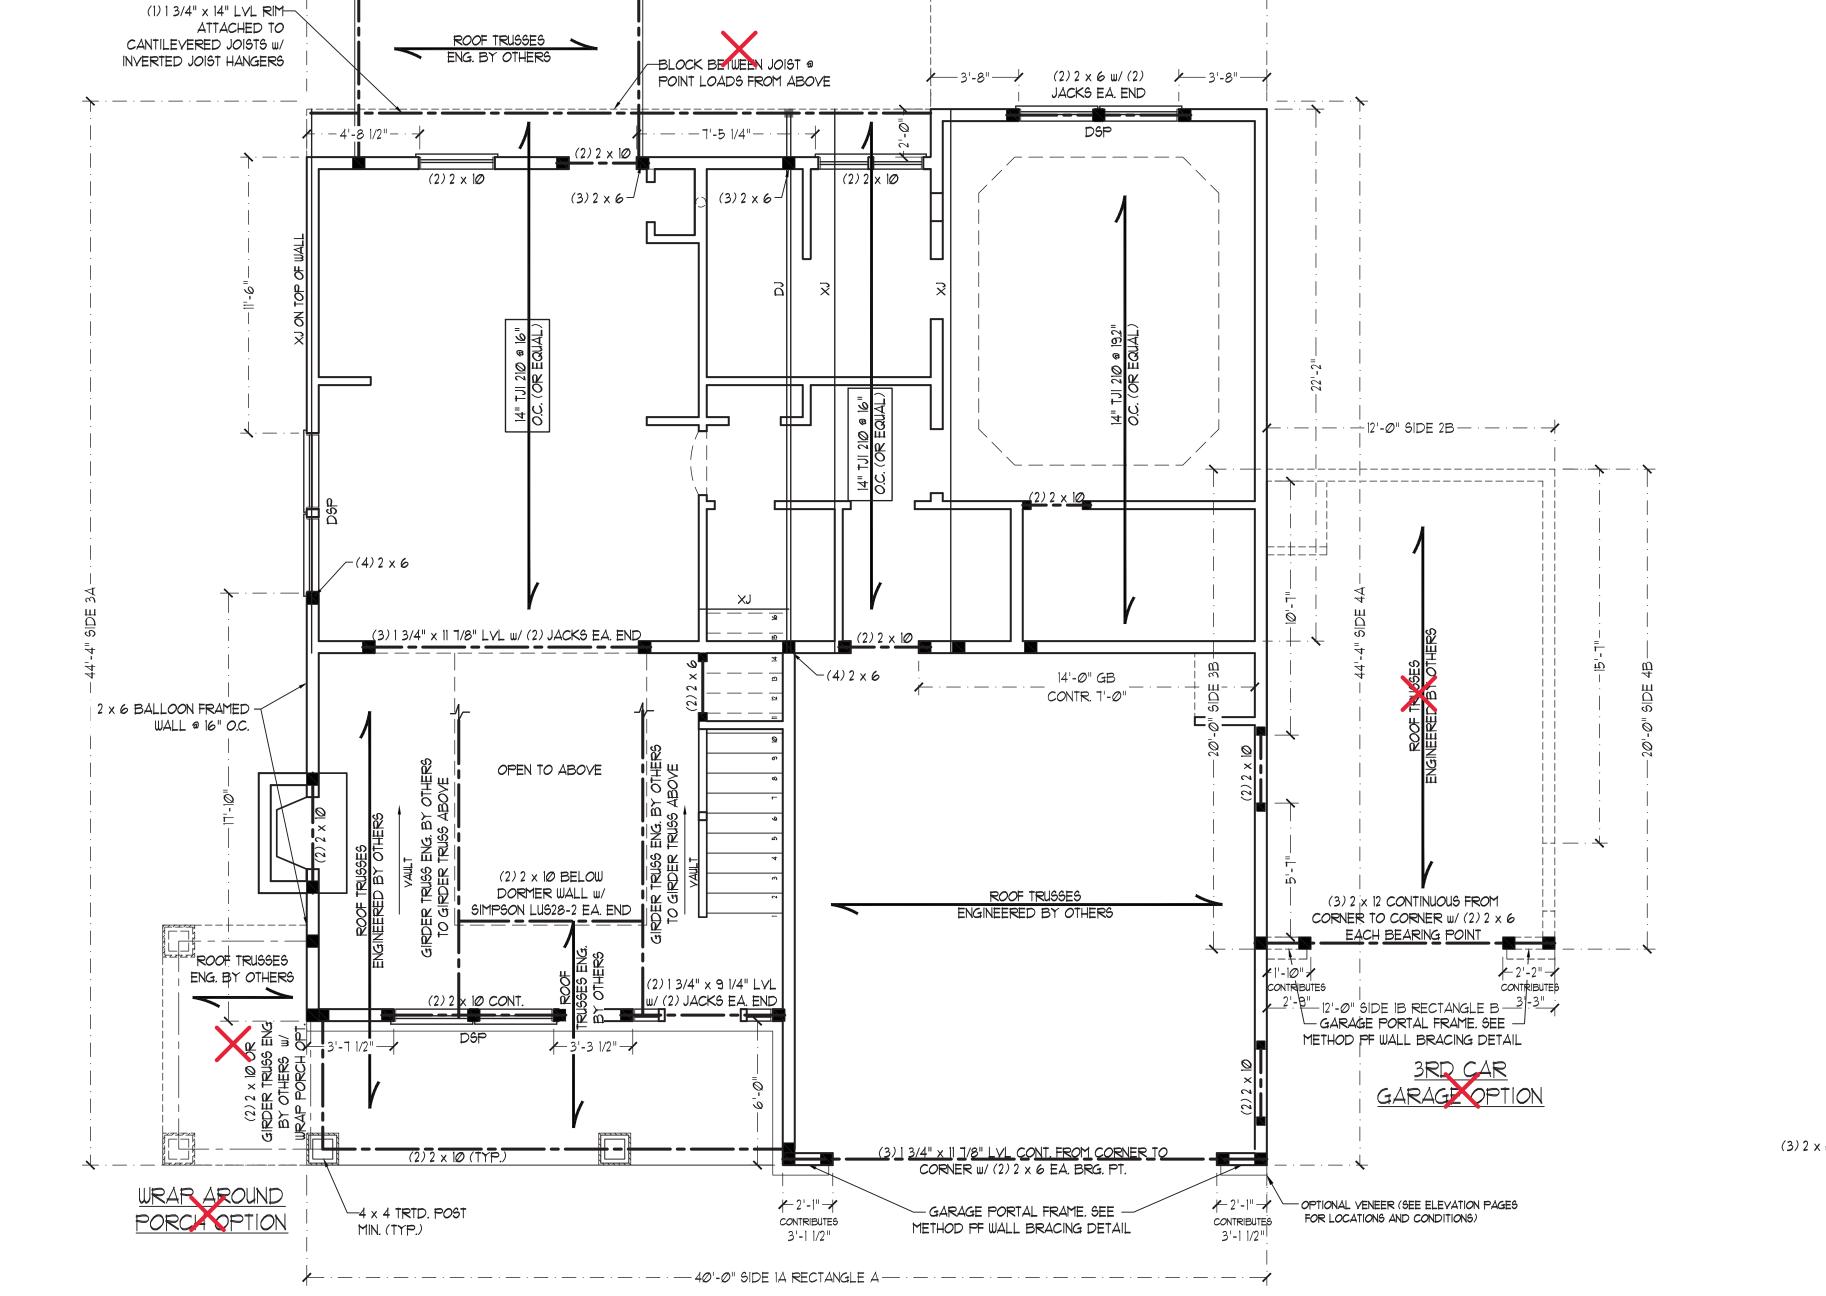

-4 x 4 TRTD. POST

MIN. (TYP.)

(2) $2 \times 10 \text{ (TYP.)}$

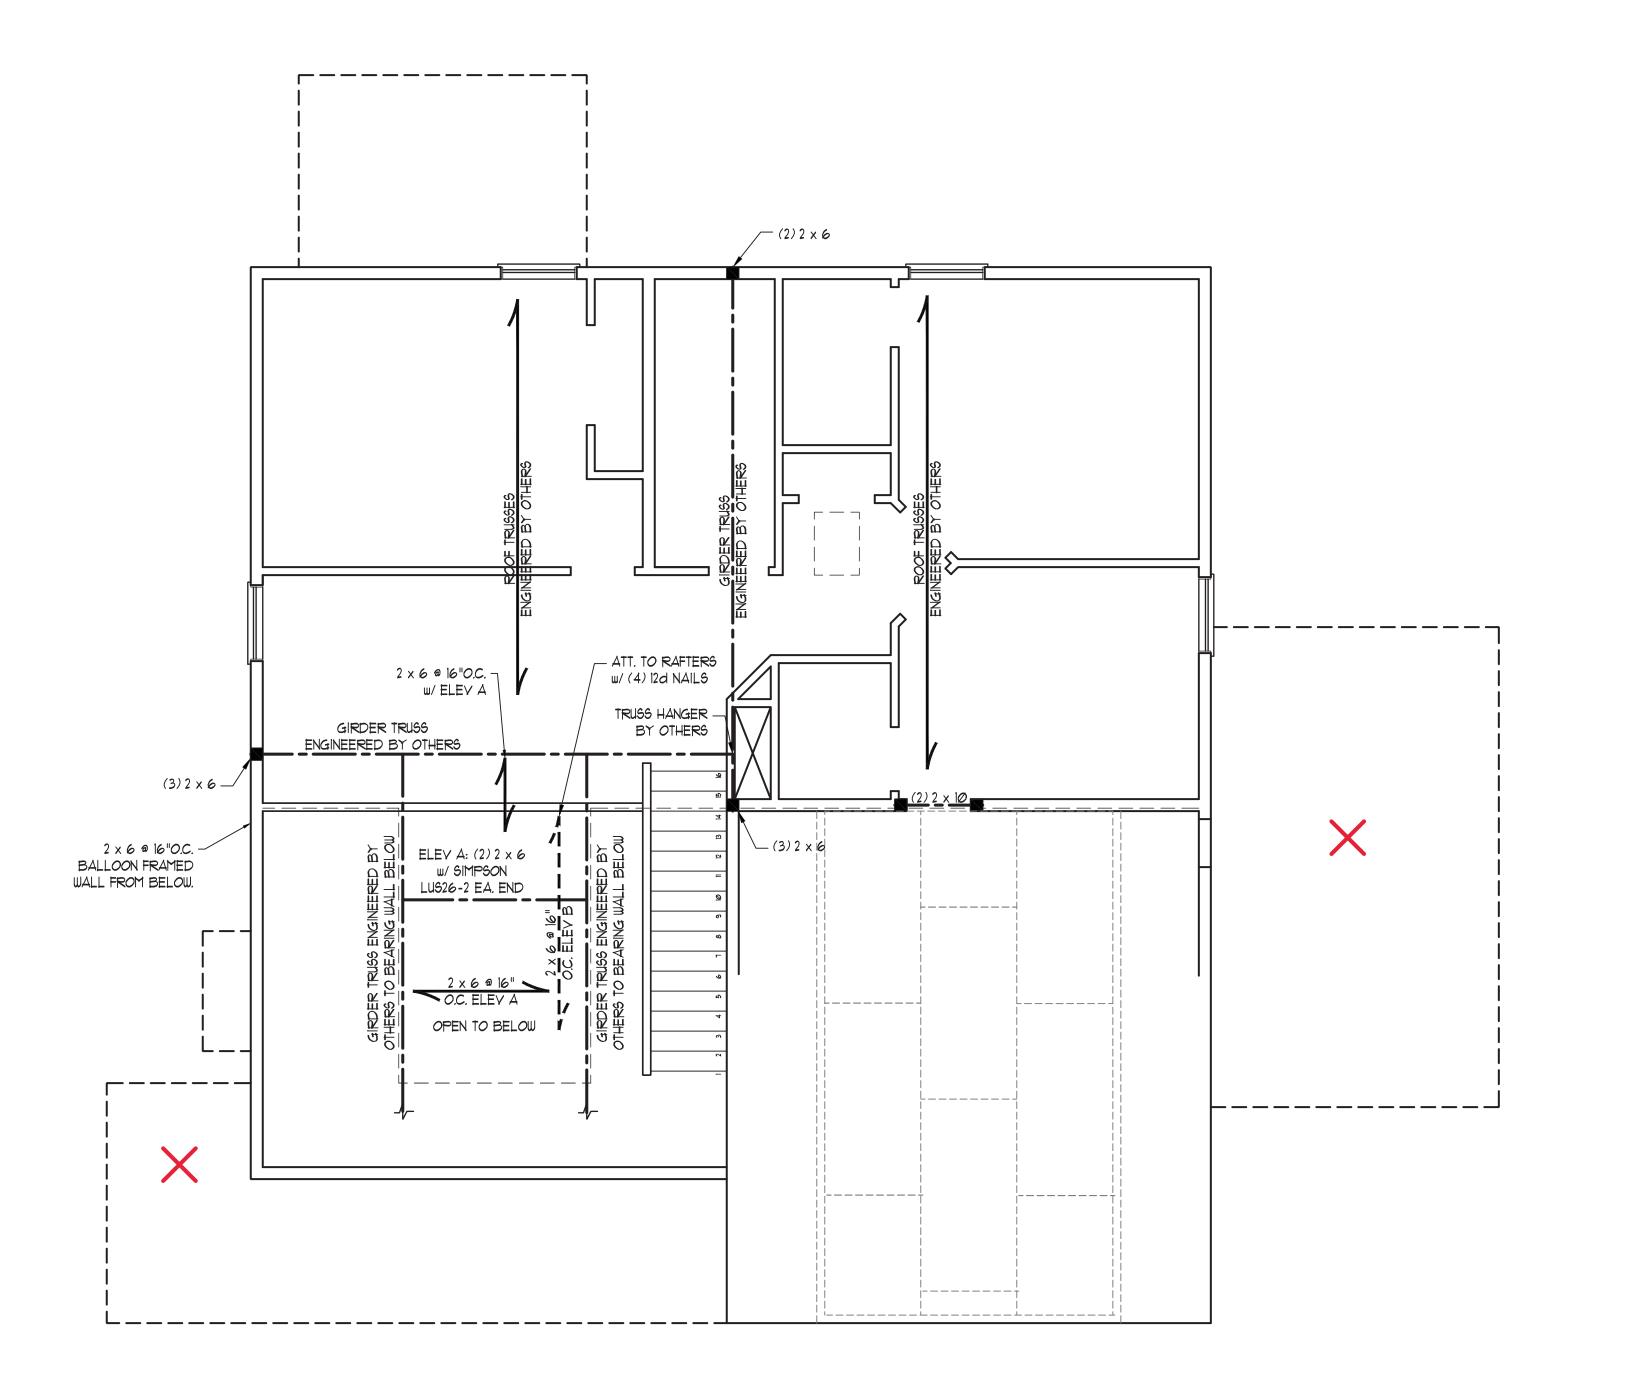

BRACED WALL DESIGN NOTES:

- BRACED WALL DESIGN PER SECTION R602.10 OF THE NCRC 2018 EDITION.
- . CS-WSP REFERS TO "CONTINUOUS SHEATHING WOOD STRUCTURAL PANELS" CONTRACTOR IS TO INSTALL 1/16" OSB ON ALL EXTERIOR WALLS ATTACHED W/8d NAILS SPACED 6" O.C. ALONG PANEL EDGES AND 12" O.C. IN THE FIELD.
- *GB REFERS TO "GYPSUM BOARD" CONTRACTOR IS TO INSTALL 1/2" (MIN.) GYPSUM WALL BOARD WHERE NOTED ON THE PLANS. FASTEN GB WITH 1 1/4" SCREWS OR 1 5/8" NAILS SPACED 1" O.C. ALONG PANEL EDGES AND IN THE FIELD INCLUDING TOP AND BOTTOM PLATES.
- 4. BRACED WALL DESIGN APPLIES IN WIND ZONES UP TO 130 MPH. FOR HIGH WIND ZONES, BRACE WALLS ARE TO BE CONSTRUCTED IN ACCORDANCE WITH CHAPTER 45 OF THE NCRC, 2018 EDITION.
- 5. SEE NOTES AND DETAIL SHEETS FOR ADDITIONAL BRACED WALL INFORMATION.

- 1. PER SECTION R602.10.3.2 OF THE 2018 NCRC, THE AMOUNT OF BRACING ON THE SECOND FLOOR EXCEEDS THE AMOUNT REQUIRED FOR THE FIRST FLOOR AND NO BRACED WALL ANALYSIS IS REQUIRED.
- 2. SHEATH ALL EXTERIOR WALLS WITH 1/16" OSB SHEATHING ATTACHED WITH 8d NAILS AT 6" O.C. ALONG PANEL EDGES AND 12" O.C. IN THE FIELD.

	LEGEND		
CONT	CONTINUOUS		
XJ	EXTRA JOIST		
DJ	DOUBLE JOIST		
TJ	TRIPLE JOIST		
EΑ	EACH		
()	NUMBER OF STUDS		
DSP	DOUBLE STUD POCKET		
TSP	TRIPLE STUD POCKET		
oc	ON CENTER		
SPF	SPRUCE PINE FIR		
SYP	SOUTHERN YELLOW PINE		
TRTD	PRESSURE TREATED		
TYP	TYPICAL		
UNO	UNLESS NOTED OTHERWISE		

STRUCTURAL NOTES:


- ALL FRAMING LUMBER TO BE #2 SPF
- ALL LOAD BEARING HEADERS TO BE (2) 2×6 (UNO). WINDOW AND DOOR HEADERS TO BE
- SUPPORTED w/(1) JACK STUD AND (1) KING STUD EA. END (UNO.). SEE TABLE R602.7.5 FOR ADDITIONAL KING STUD REQUIREMENTS. SQUARES DENOTE POINT LOADS

WHICH REQUIRE SOLID BLOCKING TO

GIRDER OR FOUNDATION. SQUARES TO BE (2) STUDS (UNO.) REFER TO NOTES AND DETAIL SHEETS FOR ADDITIONAL STRUCTURAL INFORMATION.

TABLE R602.7.5 MINIMUM NUMBER OF FULL HEIGHT STUDS AT EACH END OF HEADERS IN EXTERIOR WALLS

HEADER SPAN (FEET)	MAXIMUM STUD SPACING (INCHES) (PER TABLE R6023(5)		
	16	24	
UP TO 3'	1	1	
4'	2	1	
8'	3	2	
12'	5	3	
16'	6	4	

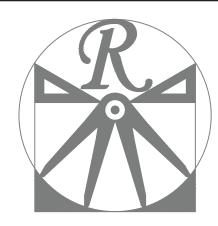

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DATE: MARCH 31, 2021


SCALE: 1/4"=1'-0"

DRAWN BY: WG ENGINEERED BY: JAG

REVIEWED BY: MGS

ATTIC FLOOR

FRAMING PLAN

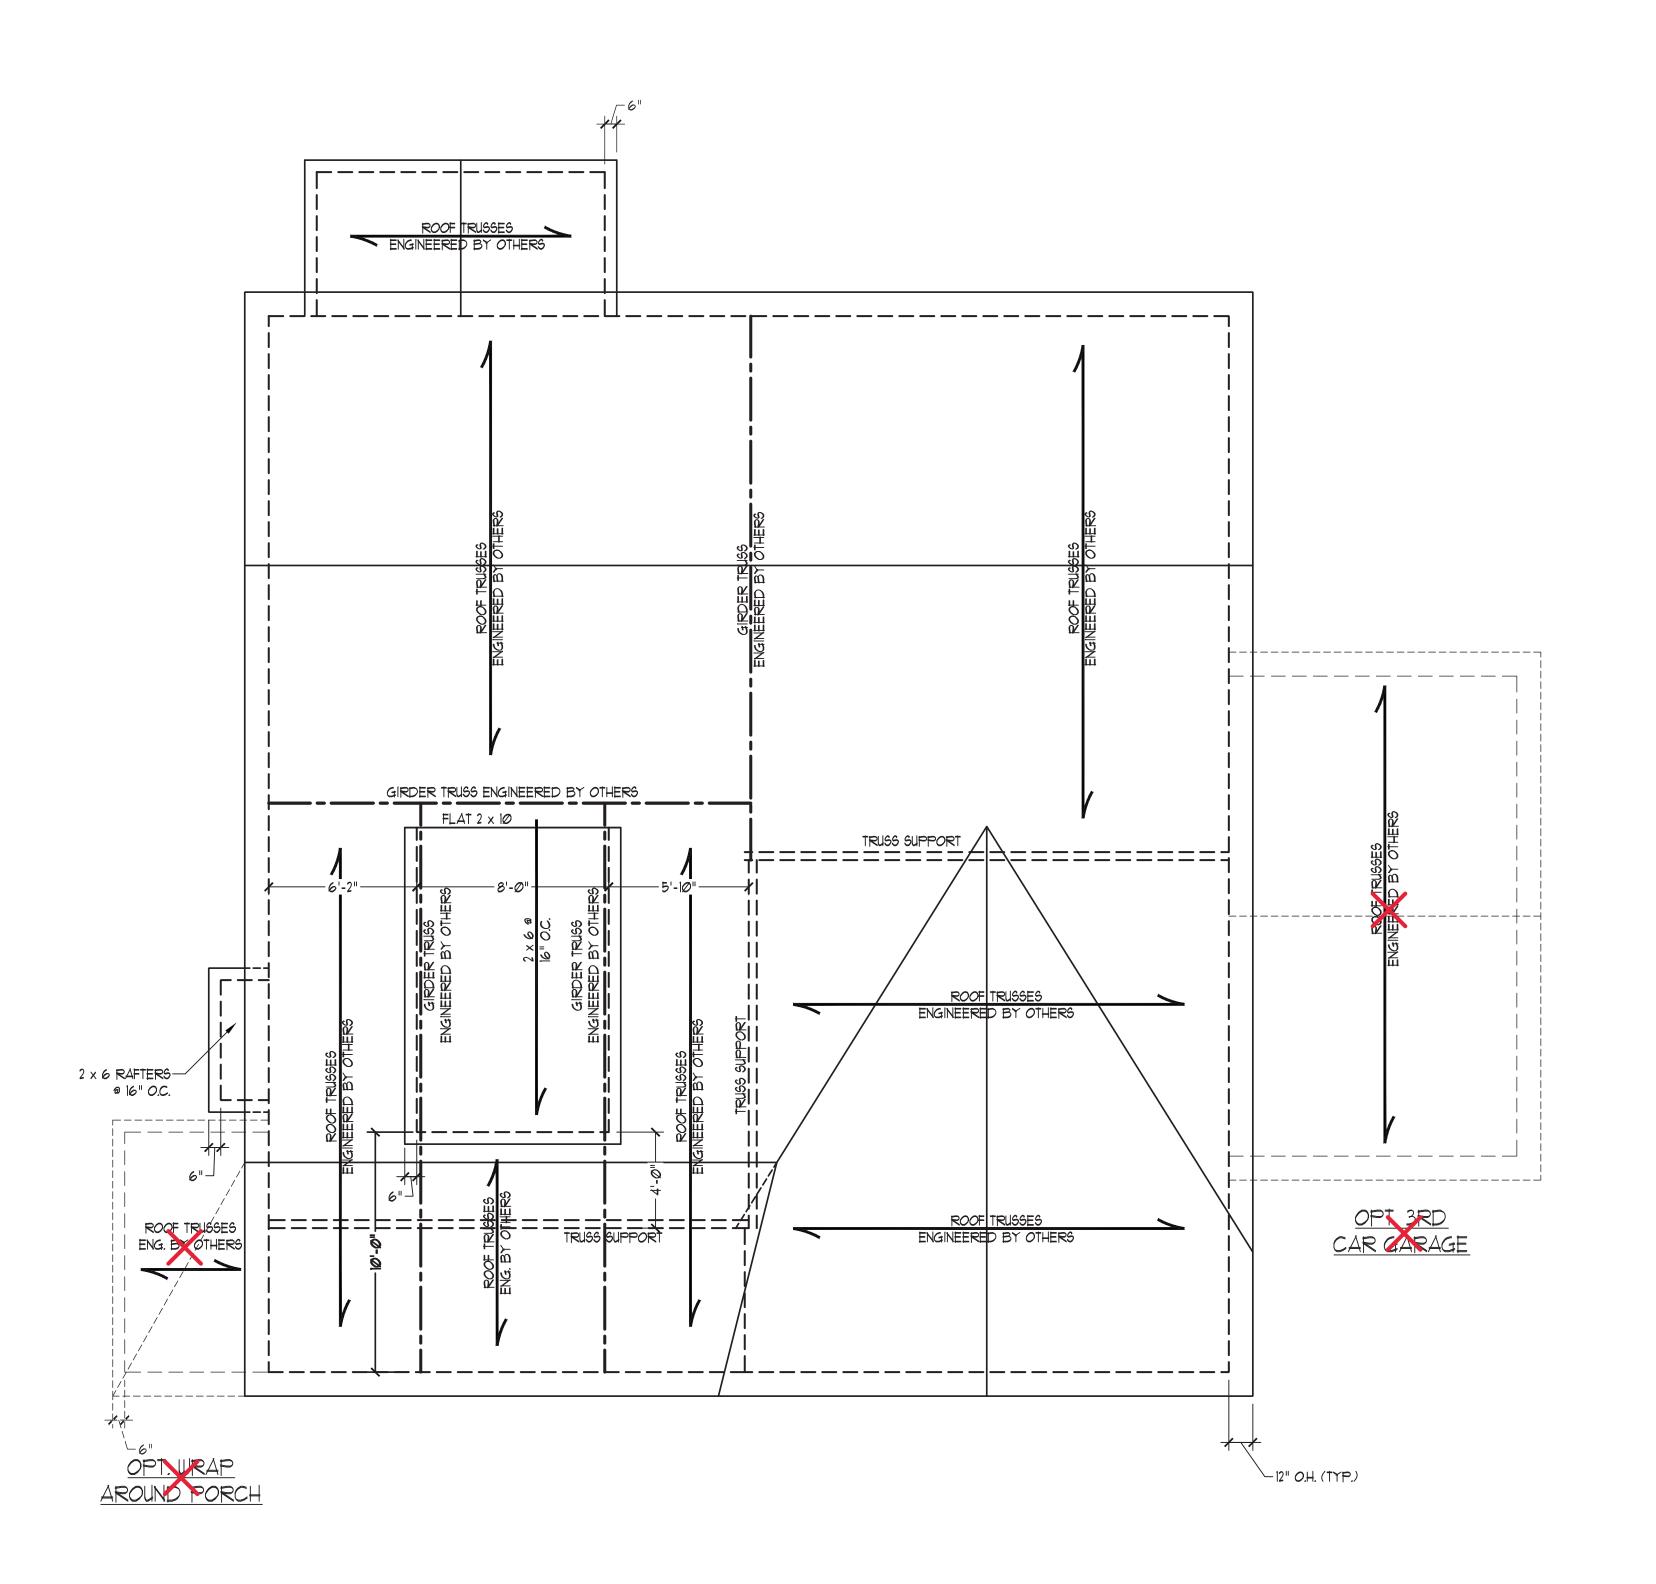

STRUCTURAL NOTES:


ALL FRAMING LUMBER TO BE #2 SPF (UNO).

CIRCLES DENOTE (3) 2 x 4 POSTS FOR ROOF SUPPORT.

- FRAME DORMER WALLS ON TOP
 OF DOUBLE OR TRIPLE RAFTERS.
 HIP SPLICES ARE TO BE SPACED
 A MIN. OF 8'-0". FASTEN
 MEMBERS WITH THREE ROWS OF
 12d NAILS @ 16" O.C. (TYP.)
- 5. STICK FRAME OVER-FRAMED
 ROOF SECTIONS W/ 2 x 8 RIDGES,
 2 x 6 RAFTERS @ 16" O.C. AND
 FLAT 2 x 10 VALLEYS OR USE
 VALLEY TRUSSES.
 6. FASTEN FLAT VALLEYS TO
- RAFTERS OR TRUSSES WITH
 SIMPSON H2.5A HURRICANE TIES @
 32" O.C. MAX. PASS HURRICANE
 TIES THROUGH NOTCH IN ROOF
 SHEATHING. EACH RAFTER IS TO
 BE FASTENED TO THE FLAT
 VALLEY WITH A MIN. OF (6) 12d
 TOE NAILS.
- REFER TO SECTION R802.11 OF THE 2018 NCRC FOR REQUIRED UPLIFT RESISTANCE AT RAFTERS AND TRUSSES.
- 3. REFER TO NOTES AND DETAIL SHEETS FOR ADDITIONAL STRUCTURAL INFORMATION.

NOTE: REFER TO ARCHITECTURAL
DRAWINGS FOR ROOF PITCHES, PLATE
HEIGHTS, DIMENSIONS, OVERHANG
WIDTHS, AND ATTIC VENT CALCS.

	LEGEND		
CONT	CONTINUOUS		
XR	EXTRA RAFTER		
DR	DOUBLE RAFTER		
TR	TRIPLE RAFTER		
EA	EACH		
oc	ON CENTER		
SPF	SPRUCE PINE FIR		
SYP	SOUTHERN YELLOW PINE		
TYP	TYPICAL		
UNO	UNLESS NOTED OTHERWISE		

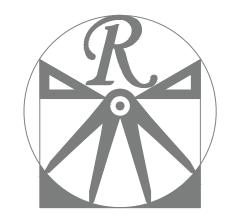

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DATE: MARCH 31, 2021

REV.:

SCALE: 1/4"=1'-0"


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ENGINEERED BY: JAG

REVIEWED BY: MGS

ROOF PLAN

ELEVATION - B S-4

ROOF PLAN ELEVATION-B

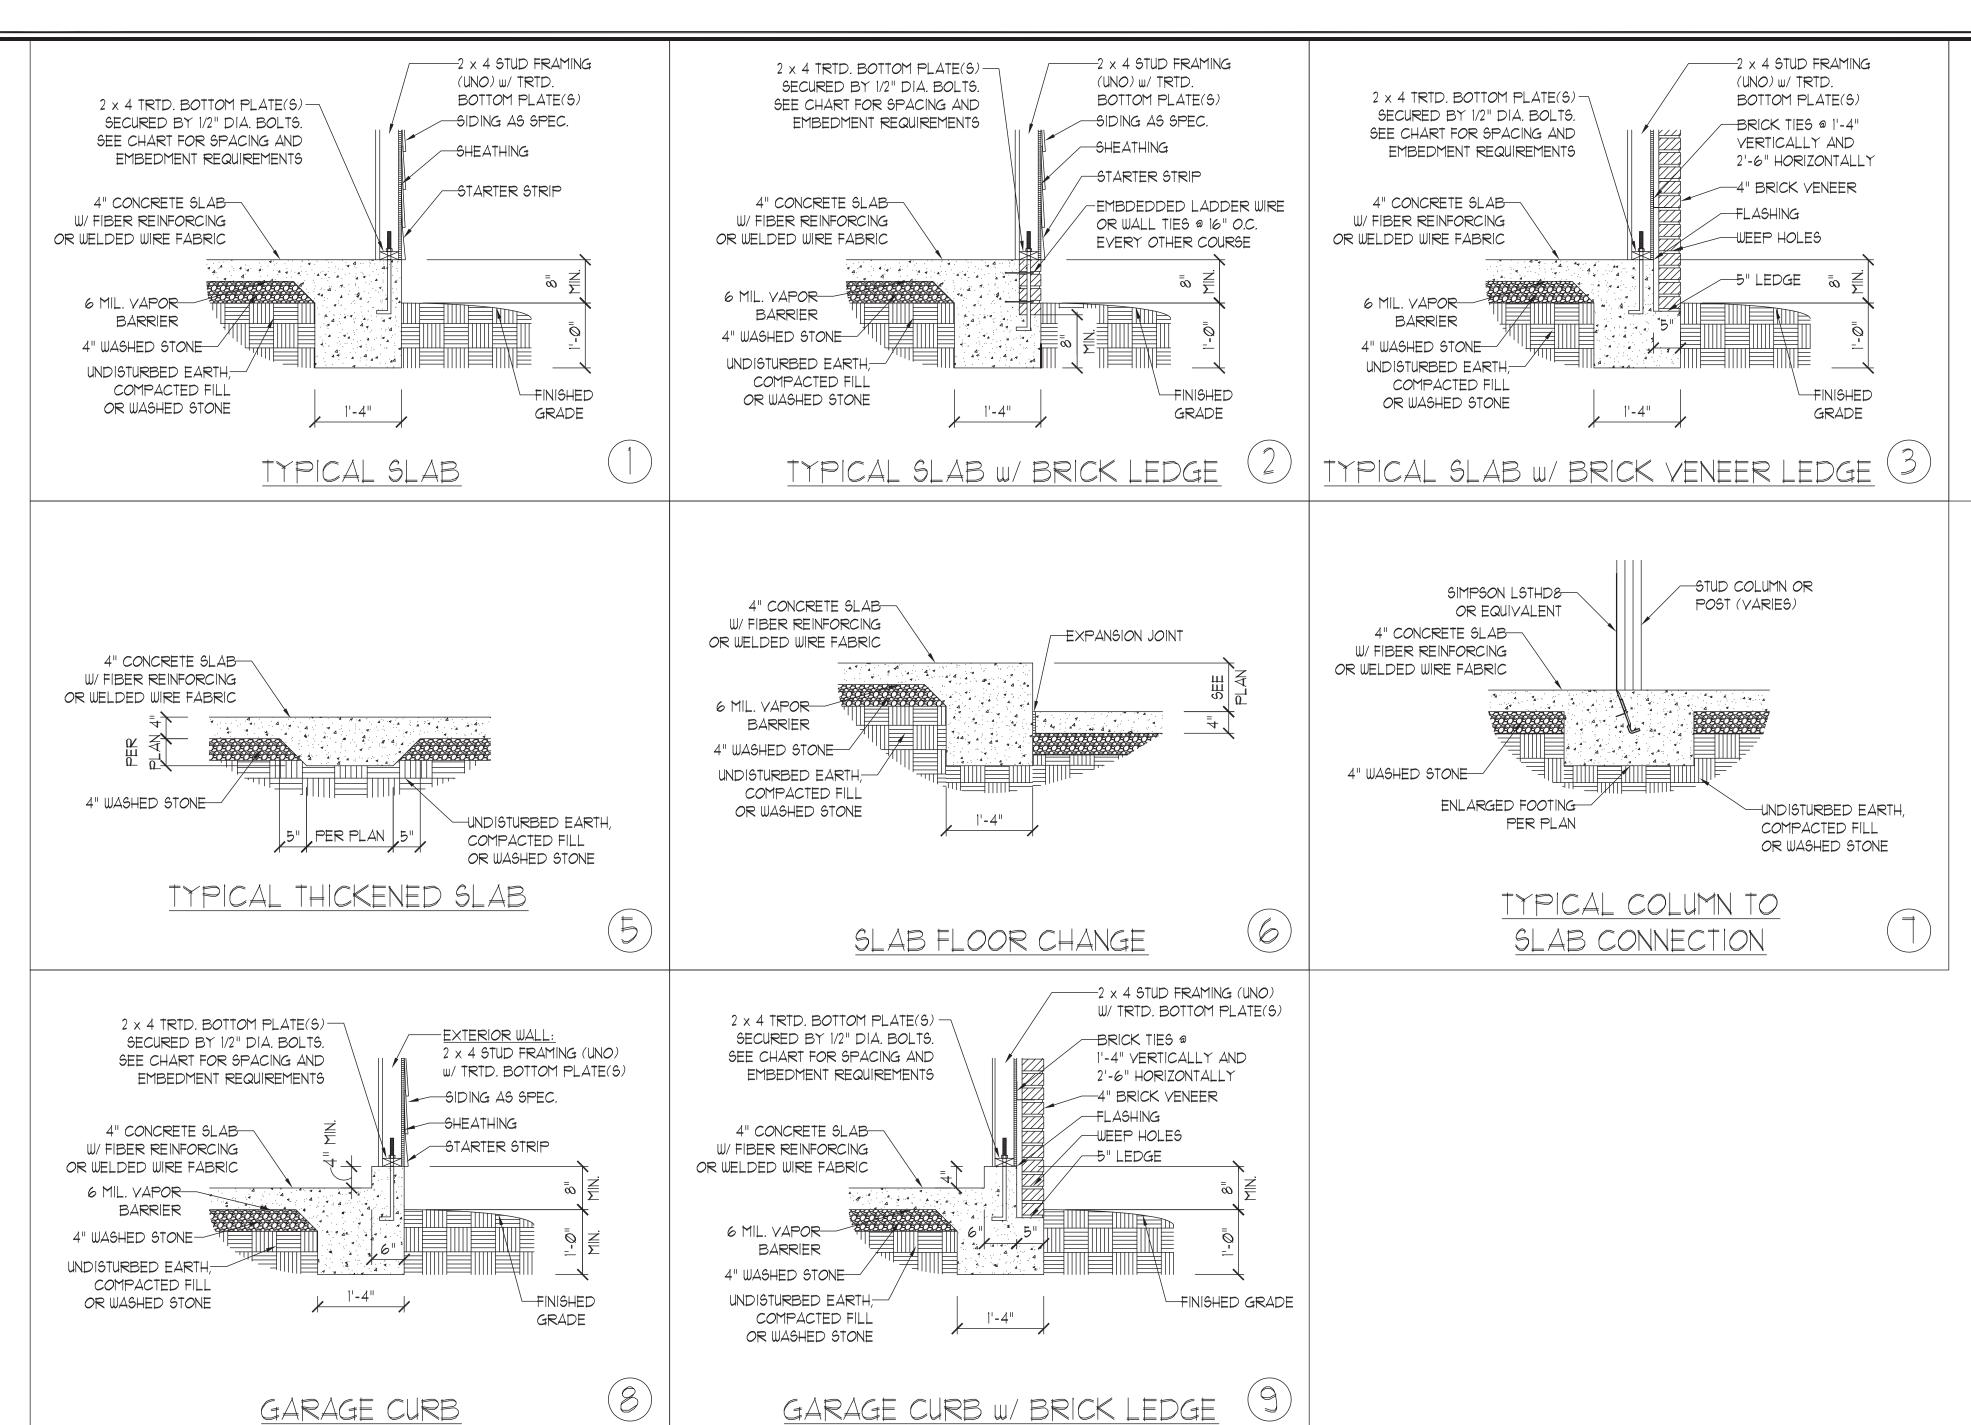

GARAGE DOOR JAMB

A . A . A . A . A . A . A . A . A

1'-4"

SLAB AT GARAGE DOOR

THREADED ROD WITH EPOXY,

TO PROVIDE EQUIVALENT

LIEU OF 1/2" ANCHOR BOLTS.

SIMPSON TITEN HD, OR APPROVED

ANCHORS SPACED AS REQUIRED

ANCHOR BOLTS MAY BE USED IN

ANCHORAGE TO 1/2" DIAMETER

NOTE:

SLOPE SLAB 1/8" PER FOOT

4" CONCRETE SLAB

W/ FIBER REINFORCING

OR WELDED WIRE FABRIC

6 MIL. VAPOR BARRIER

4" WASHED STONE

UNDISTURBED EARTH,-

COMPACTED FILL OR

130 MPH

4'-Ø" O.C.

INSTALL MIN. (2) ANCHORS PER

PLATE SECTION AND (1)

ANCHOR WITHIN 12" OF CORNERS

15" INTO MASONRY

7" INTO CONCRETE

WASHED STONE

2 x 4 STUD FRAMING (UNO) W/ TRTD.

BOTTOM PLATE(S)

UNDISTURBED EARTH, 6" 6" 6" 6" 6" 6" 6" 6"

STEP IN GARAGE

120 MPH

6'-0" O.C.

INSTALL MIN. (2) ANCHORS PER

PLATE SECTION AND (1)

ANCHOR WITHIN 12" OF CORNERS

7"

4" CONCRETE-SLAB W/ FIBER REINFORCING

4" WASHED STONE

WIND ZONE

SPACING

EMBEDMENT

 -2×4 TRTD. BOTTOM PLATE(5)

EMBEDMENT REQUIREMENTS

ANCHOR SPACING AND EMBEDMENT

SECURED BY 1/2" DIA. BOLTS. SEE CHART FOR SPACING AND

-4" CONCRETE \$LAB w/ FIBER REINFORCING OR

WELDED WIRE FABRIC

-TREATED POST PER PLAN 4" CONCRETE SLAB POST BASE PER PLAN W/ FIBER REINFORCING OR WELDED WIRE FABRIC -FINISHED GRADE 4" WASHED STONE UNDISTURBED EARTH, COMPACTED FILL OR WASHED STONE PORCH/SCREEN PORCH

SLAB ETAIL MONOLITHIC S FOUNDATION DE



DATE: NOVEMBER 1, 2018 SCALE: NTS

ENGINEERED BY: JST

DRAWN BY: JST

FOUNDATION DETAILS

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This sealed page is to be used in

LIEU OF CORNER RETURN -

ORIENTATION OF STUD MAY

VARY. SEE FIGURE R602.3(2)-

IN ACCORDANCE WITH

AND INSTALLED IN ACCORDANCE

STRUCTURAL PANEL

WITH CHAPTER 1 (TYP.)-

FILLER PANEL

-ORIENTATION OF STUD MAY

VARY. SEE FIGURE R602.3(2)

FOR FASTENING

 \sim continuous wood structural

PANEL BRACED WALL LINE

16d NAIL (3 1/2" x Ø.131") -GYPSUM WALLBOARD AS REQUIRED a 12" O.C. -AND INSTALLED IN ACCORDANCE WITH CHAPTER 1 (TYP.) OPTIONAL NON-STRUCTURAL

> SEE TABLE R602.3(1) FOR FASTENING (a) outside corner detail (5a)


16d NAIL (3 1/2" x Ø.131") -CONTINUOUS WOOD STRUCTURAL a 12" O.C. -PANEL BRACED WALL LINE -SEE TABLE R6*0*2.3(1) GYPSUM WALLBOARD AS FOR FASTENING REQUIRED AND INSTALLED MIN. 24" WOOD STRUCTURAL PANEL

CHAPTER 1 (TYP.)-DOWN DEVICE MAY BE INSTALLED IN LIEU OF CORNER RETURN (b) Inside corner detail (5b)GYPSUM WALLBOARD AS REQUIRED - SEE TABLE R6*0*2.3(1)

16d NAIL (3 1/2" x Ø.131") (2 ROWS @ 24" O.C. --MIN. 24" WOOD STRUCTURAL SHEATHING PER PLAN-PANEL CORNER RETURN. AN 800 LB HOLD DOWN DEVICE MAY BE INSTALLED IN LIEU OF CORNER RETURN CONTINUOUS WOOD


FASTENERS ON EACH STUD (5C) BRACED WALL LINE-AT EACH PANEL EDGE (c) GARAGE DOOR CORNER DETAIL (SEE PLAN FOR ADDITIONAL STRUCTURAL INFORMATION OR ALTERNATE CONFIGURATIONS)

KING STUDS BETWEEN GARAGE HEADERS PER PLAN- \pm pony wall per GRADE AND PORTAL FRAME DETAIL -GARAGE HEADER PER PLAN (2) 5'-LONG SIMPSON CSI6 STRAPS TOP AND BOTTOM ON VERTICAL STRAPS PER INSIDE FACE OF BEAM TO TIE PORTAL FRAME DETAIL-HEADERS TOGETHER - JACK STUDS SUPPORTING HEADERS PER PLAN BETWEEN GARAGE DOOR HEADERS (REFERENCE PORTAL FRAME DETAIL FOR ALL OTHER PORTAI FRAME INFORMATION)

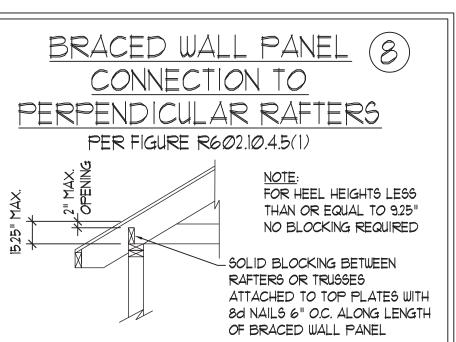

CONNECTION TO PERPENDICULAR ROOF PER FIGURE R602.10.4.5(3) (OR ALTERNATIVE: FIGURE R602.10.4.5(2))

CORNER RETURN. AN 800 LB HOLD

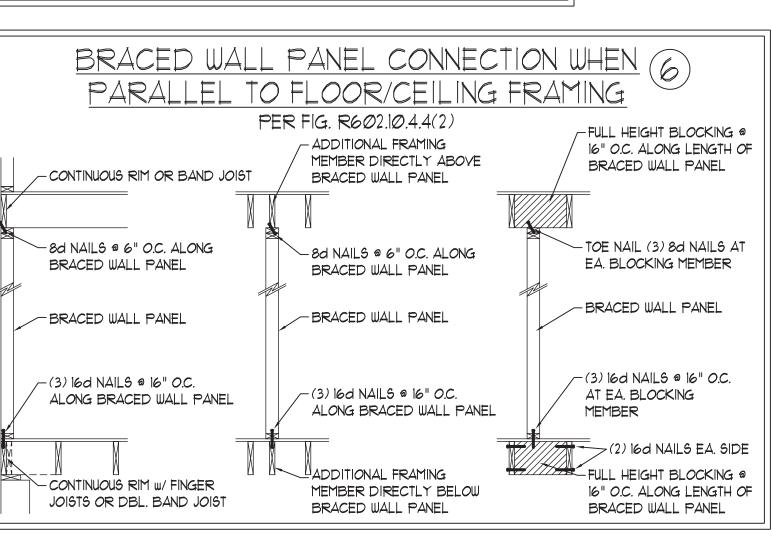

SEAL 33736 4/30/2021

TRUSSES

6'-0" MAX.

2 x BLOCKING

NAILING PER

TABLE

R602.3(1)



ES

DATE: MAY 18, 2020

SCALE: 1/4" = 1'-0" DRAWN BY: JST

ENGINEERED BY: JST

BRACED WALL NOTES AND DETAILS AND PF DETAIL

GENERAL WALL BRACING NOTES WALL BRACING DESIGNED IN ACCORDANCE WITH CHAPTER 6 OF THE 2018 NC RESIDENTIAL BUILDING CODE (NCRC).

TABLES AND FIGURES REFERENCED ARE FROM THE 2018 NCRC. SEE THIS SHEET FOR GENERAL DETAILS. REFER TO THE 2018 NCRC FOR ADDITIONAL INFORMATION AS NEEDED BRACED EXTERIOR WALLS SUPPORTING ROOF TRUSSES AND RAFTERS, INCLUDING STORIES BELOW THE TOP FLOOR, HAVE BEEN DESIGNED PER R602.3.5 (3). WALL SHEATHING AND FASTENERS HAVE BEEN DESIGNED TO RESIST COMBINED UPLIFT AND SHEAR FORCES IN ACCORDANCE WITH ACCEPTED ENGINEERED PRACTICE.

SEE STRUCTURAL SHEETS FOR BRACED WALL LOCATIONS, DIMENSIONS, HOLD DOWN TYPE AND LOCATIONS, BRACED WALL LINE KEY WITH WALL DESIGN SUMMARY OF REQUIRED/PROVIDED TOTALS FOR EACH WALL LINE AND ANY SPECIAL NOTES OR REQUIREMENTS.


5. ALL EXTERIOR WALLS ARE TO BE SHEATHED WITH CS-WSP IN ACCORDANCE WITH SECTION R602.10.3 UNLESS NOTED


6. ALL EXTERIOR AND INTERIOR WALLS TO HAVE 1/2" GYPSUM INSTALLED. WHEN NOT USING METHOD "GB", GYPSUM TO BE FASTENED PER TABLE R102.3.5. METHOD GB TO BE FASTENED PER TABLE R602.10.1 CS-WSP REFERS TO THE "CONTINUOUS SHEATHING - WOOD STRUCTURAL PANELS" WALL BRACING METHOD. 1/16" OSB


SHEATHING IS TO BE INSTALLED ON ALL EXTERIOR WALLS ATTACHED W/6d COMMON NAILS OR 8d (2 1/2" LONG x Ø.113" DIAMETER) NAILS SPACED 6" O.C. ALONG PANEL EDGES AND 12" O.C. IN THE FIELD (U.N.O., GB REFERS TO THE "GYPSUM BOARD" WALL BRACING METHOD. 1/2" (MIN.) GYPSUM WALL BOARD IS TO BE INSTALLED ON


BOTH SIDES OF THE BRACED WALL FASTENED WITH 1 1/4" SCREWS OR 1 5/8" NAILS SPACED 1" O.C. ALONG PANEL EDGES INCLUDING TOP AND BOTTOM PLATES AND INTERMEDIATE SUPPORTS (U.N.O.). VERIFY ALL FASTENER OPTIONS FOR 1/2" AND 5/8" GYPSUM PRIOR TO CONSTRUCTION. FOR INTERIOR FASTENER OPTIONS SEE TABLE R7/02.3.5. FOR EXTERIOR FASTENER OPTIONS SEE TABLE R602.3(1). EXTERIOR GB TO BE INSTALLED VERTICALLY.

REQUIRED BRACED WALL LENGTH FOR EACH SIDE OF THE CIRCUMSCRIBED RECTANGLE ARE INTERPOLATED PER TABLE R602. 10.3. METHOD CS-WSP CONTRIBUTES ITS ACTUAL LENGTH, METHOD GB CONTRIBUTES .5 ITS ACTUAL LENGTH, AND METHOD PF CONTRIBUTES 1.5 TIMES ITS ACTUAL LENGTH.

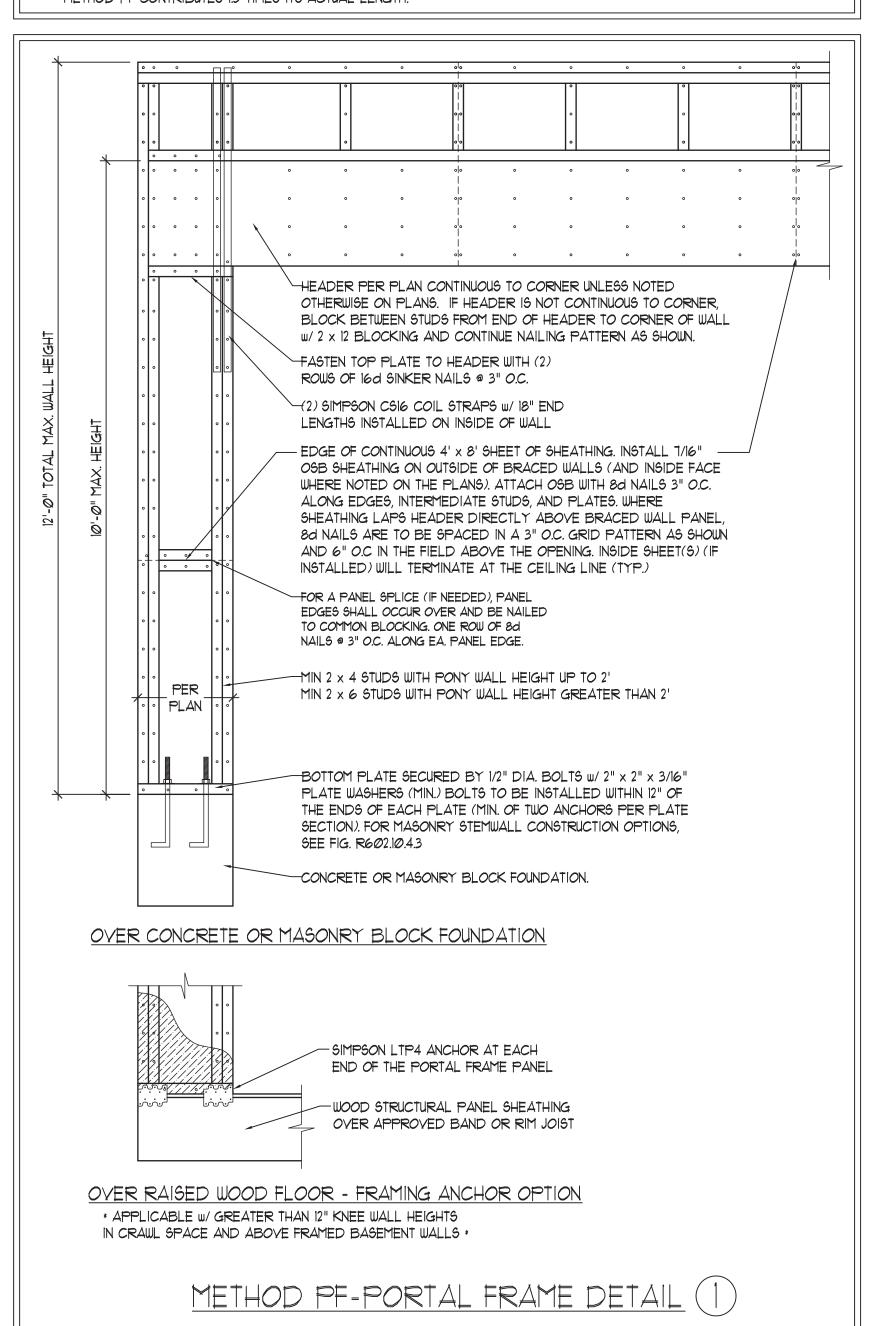

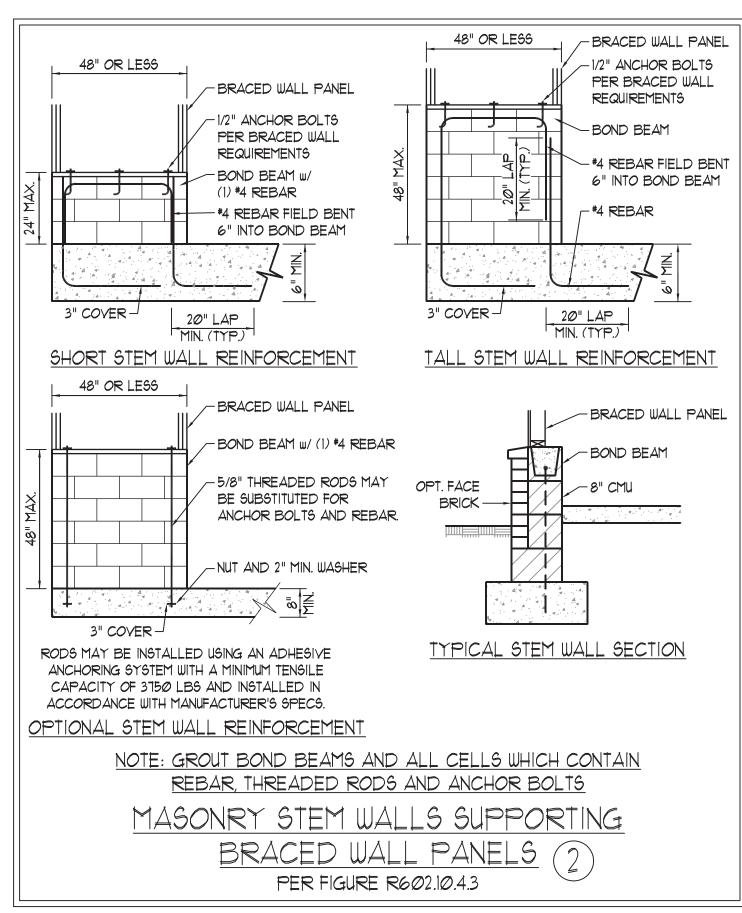

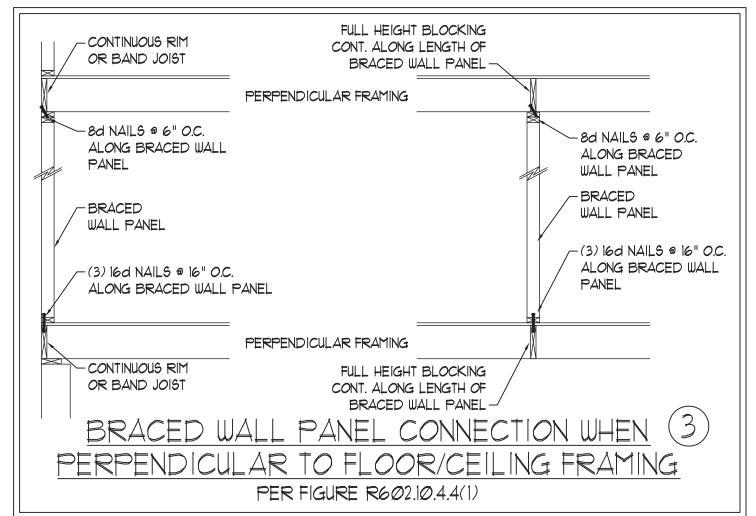

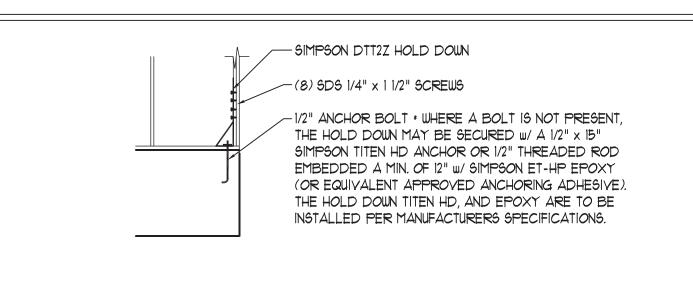

HOLD DOWN DETAIL FOR MASONRY FOUNDATION OR MONOLITHIC SLAB * APPLICABLE ONLY WHERE SPECIFIED ON PLAN !

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SCALE: 1/4" = 1'-0"

STRUCTURAL NOTES

GENERAL NOTES

- ENGINEER'S SEAL APPLIES ONLY TO STRUCTURAL COMPONENTS INCLUDING ROOF RAFTERS, HIPS, VALLEYS, RIDGES, FLOORS, WALLS, BEAMS, HEADERS, COLUMNS, CANTILEVERS, OFFSET LOAD BEARING WALLS, PIERS, GIRDER SYSTEM AND FOOTING. ENGINEER'S SEAL DOES NOT CERTIFY DIMENSIONAL ACCURACY OF ARCHITECTURAL LAYOUT INCLUDING ROOF. ENGINEER'S SEAL DOES NOT APPLY TO 1-JOIST OR FLOOR/ROOF TRUSS LAYOUT DESIGN AND ACCURACY.
- 2. ALL CONSTRUCTION SHALL CONFORM TO THE LATEST REQUIREMENTS OF THE NORTH CAROLINA RESIDENTIAL CODE (NCRC), 2018 EDITION, PLUS ALL LOCAL CODES AND REGULATIONS. THE STRUCTURAL ENGINEER IS NOT RESPONSIBLE FOR, AND WILL NOT HAVE CONTROL OF, CONSTRUCTION MEANS, METHODS, TECHNIQUES, SEQUENCES OR PROCEDURES, OR SAFETY PRECAUTIONS AND PROGRAMS IN CONNECTION WITH THE CONSTRUCTION WORK. NOR WILL THE ENGINEER BE RESPONSIBLE FOR THE CONTRACTORS FAILURE TO CARRY OUT THE CONSTRUCTION WORK IN ACCORDANCE WITH THE CONTRACT DOCUMENTS.
- 3. STRUCTURAL DESIGN BASED ON THE PROVISIONS OF THE NCRC, 2018 EDITION (R301.4 R301.7)

DESIGN CRITERIA:	LIVE LOAD (PSF)	DEAD LOAD (PSF)	DEFLECTION (IN)	
ATTIC WITH LIMITED STORAGE	2Ø	10	L/240 (L/360 w/ BRITTLE FINISHES)	
ATTIC WITHOUT STORAGE	10	10	L/360	
DECK5	40	10	L/36Ø	
EXTERIOR BALCONIES	40	10	L/360	
FIRE ESCAPES	40	10	L/360	
HANDRAILS/GUARDRAILS	200 LB OR 50 (PLF)	10	L/36Ø	
PASSENGER VEHICLE GARAGE	50	10	L/360	
ROOMS OTHER THAN SLEEPING ROOM	40	10	L/360	
SLEEPING ROOMS	3Ø	10	L/360	
STAIRS	40	10	L/360	
WIND LOAD	(BASED ON TABLE R3Ø1.2(4) WIND ZONE AND EXPOSURE)			
GROUND SNOW LOAD: Pg	20 (PSF)			

- I-JOIST SYSTEMS DESIGNED WITH 12 PSF DEAD LOAD AND DEFLECTION (IN) OF L/480 - FLOOR TRUSS SYSTEMS DESIGNED WITH 15 PSF DEAD LOAD
- 4. FOR 115 AND 120 MPH WIND ZONES, FOUNDATION ANCHORAGE 15 TO COMPLY WITH SECTION R403.1.6 OF THE NCRC, 2018 EDITION. FOR 130 MPH, 140 MPH, AND 150 MPH WIND ZONES, FOUNDATION ANCHORAGE IS TO COMPLY WITH SECTION 4504 OF THE NCRC, 2018 EDITION.
- 5. ENERGY EFFICIENCY COMPLIANCE AND INSULATION VALUES OF THE BUILDING TO BE IN ACCORDANCE WITH CHAPTER II OF THE NCRC, 2018 EDITION.

FOOTING AND FOUNDATION NOTES

- 1. FOUNDATION DESIGN BASED ON A MINIMUM ALLOWABLE BEARING CAPACITY OF 2000 PSF. CONTACT GEOTECHNICAL ENGINEER IF BEARING CAPACITY IS NOT ACHIEVED.
- 2. FOR ALL CONCRETE SLABS AND FOOTINGS, THE AREA WITHIN THE PERIMETER OF THE BUILDING ENVELOPE SHALL HAVE ALL VEGETATION, TOP SOIL AND FOREIGN MATERIAL REMOVED. FILL MATERIAL SHALL BE FREE OF VEGETATION AND FOREIGN MATERIAL. THE FILL SHALL BE COMPACTED TO ASSURE UNIFORM SUPPORT OF THE SLAB, AND EXCEPT WHERE APPROVED, THE FILL DEPTHS SHALL NOT EXCEED 24" FOR CLEAN SAND OR GRAVEL. A 4" THICK BASED COURSE CONSISTING OF CLEAN GRADED SAND OR GRAVEL SHALL BE PLACED. A BASE COURSE IS NOT REQUIRED WHERE A CONCRETE SLAB IS INSTALLED ON WELL-DRAINED OR SAND-GRAVEL MIXTURE SOILS CLASSIFIED AS GROUP I, ACCORDING TO THE UNITED SOIL CLASSIFICATION SYSTEM IN ACCORDANCE WITH TABLE R405.1 OF THE NCRC, 2018 EDITION.
- 3. PROPERLY DEWATER EXCAVATION PRIOR TO POURING CONCRETE WHEN BOTTOM OF CONCRETE SLAB IS AT OR BELOW WATER TABLE. IF APPLICABLE, 3/4" - 1" DEEP CONTROL JOINTS ARE TO BE SAWED WITHIN 4 TO 12 HOURS OF CONCRETE FINISHING AND WALL LOCATIONS HAVE BEEN MARKED. ADJUST WHERE NECESSARY.
- 4. CONCRETE SHALL CONFORM TO SECTION R402.2 OF THE NCRC, 2018 EDITION, CONCRETE REINFORCING STEEL TO BE ASTM A615 GRADE 60. WELDED WIRE FABRIC TO BE ASTM A185. MAINTAIN A MINIMUM CONCRETE COVER AROUND REINFORCING STEEL OF 3" IN FOOTINGS AND 1 1/2" IN SLABS. FOR POURED CONCRETE WALLS, CONCRETE COVER FOR REINFORCING STEEL MEASURED FROM THE INSIDE FACE OF THE WALL SHALL NOT BE LESS THAN 3/4". CONCRETE COVER FOR REINFORCING STEEL MEASURED FROM THE OUTSIDE FACE OF THE WALL SHALL NOT BE LESS THAN 1 1/2" FOR #5 BARS OR SMALLER, AND NOT LESS THAN 2" FOR #6 BARS OR LARGER.
- 5. MASONRY UNITS TO CONFORM TO ACE 530/ASCE 5/TMS 402. MORTAR SHALL COMFORM TO ASTM C270.
- 6. THE UNSUPPORTED HEIGHT OF MASONRY PIERS SHALL NOT EXCEED FOUR TIMES THEIR LEAST DIMENSION FOR UNFILLED HOLLOW CONCRETE MASONRY UNITS AND TEN TIMES THEIR LEAST DIMENSION FOR SOLID OR SOLID FILLED PIERS. PERS MAY BE FILLED SOLID WITH CONCRETE OR TYPE M OR 5 MORTAR PIERS AND WALLS SHALL BE CAPPED WITH 8" OF SOLID MASONRY
- 1. THE CENTER OF EACH OF THE PIERS SHALL BEAR IN THE MIDDLE THIRD OF ITS RESPECTIVE FOOTING. EACH GIRDER SHALL BEAR IN THE MIDDLE THIRD OF THE PIERS.
- 8. ALL CONCRETE AND MASONRY FOUNDATION WALLS ARE TO BE CONSTRUCTED IN ACCORDANCE WITH THE PROVISIONS OF SECTION R404 OF THE NCRC, 2018 EDITION OR IN ACCORDANCE WITH ACI 318, ACI 332, NCMA TR68-A OR ACE 530/ASCE 5/TMS 402. MASONRY FOUNDATION WALLS ARE TO BE REINFORCED PER TABLE R404.1.1(1), R404.1.1(2), R404.1.1(3), OR R404.1.1(4) OF THE NCRC, 2018 EDITION. CONCRETE FOUNDATION WALLS ARE TO BE REINFORCED PER TABLE R404.1.1(5) OF THE NCRC, 2018 EDITION. STEP CONCRETE FOUNDATION WALLS TO 2 x 6 FRAMED WALLS AT 16" O.C. WHERE GRADE PERMITS (UNO).

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plan set engineered by J.S. Thompson Engineering, Inc. only. Use of this individual sealed page within

architectural pages or shop drawings by others is a punishable offense under N.C. Statute § 89C-23 8'-0". FASTEN MEMBERS WITH THREE ROWS OF 12d NAILS AT 16" O.C. FRAME DORMER WALLS ON TOP OF DOUBLE OR TRIPLE RAFTERS AS SHOWN (UNO).

- 14. FOR TRUSSED ROOFS: FRAME DORMER WALLS ON TOP OF 2 x 4 LADDER FRAMING AT 24" O.C. BETWEEN ADJACENT ROOF TRUSSES. STICK FRAME OVER-FRAMED ROOF SECTIONS WITH 2 x 8 RIDGES, 2 x 6 RAFTERS AT 16" O.C. AND FLAT 2 x 10 YALLEYS (UNO).
- 15. ALL 4 x 4 AND 6 x 6 POSTS TO BE INSTALLED WITH 100 LB CAPACITY UPLIFT CONNECTORS TOP AND BOTTOM (UNO.) POSTS MAY BE SECURED USING ONE SIMPSON HE OR LTS12 UPLIFT CONNECTOR FASTENED TO THE BAND AT THE BOTTOM AND THE BEAM AT THE TOP OF EACH POST. ONE 16" SECTION OF SIMPSON CS16 COIL STRAPPING WITH (8) 8d HDG NAILS AT EACH END MAY BE USED IN LIEU OF EACH TWIST

- FRAMING NOTES
- 1. ALL FRAMING LUMBER SHALL BE #2 SPF MINIMUM (Fb = 875 PSI, Fv = 375 PSI, E = 1600000 PSI) UNLESS NOTED OTHERWISE (UNO). ALL TREATED LUMBER SHALL BE #2 SYP MINIMUM (Fb = 975 PSI, Fv = 175 PSI, E = 1600000 PSI) UNLESS NOTED OTHERWISE (UNO).
- LAMINATED VENEER LUMBER (LVL) SHALL HAVE THE FOLLOWING MINIMUM PROPERTIES: Fb =2600 PSI, Fv = 285 PSI, E = 1900000 PSI. LAMINATED STRAND LUMBER (LSL) SHALL HAVE THE FOLLOWING MINIMUM PROPERTIES: Fb = 2325 PSI, Fv = 310 PSI, E = 1550000 PSI. PARALLEL STRAND LUMBER (PSL) UP TO 1" DEPTH SHALL HAVE THE FOLLOWING MINIMUM PROPERTIES: Fc = 2500 PSI, E = 1800000 PSI. PARALLEL STRAND LUMBER (PSL) MORE THAN 1" DEPTH SHALL HAVE THE FOLLOWING MINIMUM PROPERTIES: Fc = 2900 PSI, E = 20000000 PSI. INSTALL ALL CONNECTIONS PER MANUFACTURER'S SPECIFICATIONS.
- 3. STRUCTURAL STEEL SHALL CONFORM TO THE FOLLOWING ASTM SPECIFICATIONS

W AND WT SHAPES: ASTM A992 CHANNELS AND ANGLES: ASTM A36 ASTM A36 PLATES AND BARS: HOLLOW STRUCTURAL SECTIONS: ASTM A500 GRADE B ASTM A53, GRADE B, TYPE E OR S E. STEEL PIPE:

4. STEEL BEAMS SHALL BE SUPPORTED AT EACH END WITH A MINIMUM BEARING LENGTH OF 3 1/2" AND FULL FLANGE WIDTH (UNO). PROVIDE SOLID BEARING FROM BEAM SUPPORT TO FOUNDATION. BEAMS SHALL BE ATTACHED AT THE BOTTOM FLANGE TO EACH SUPPORT AS FOLLOWS (UNO):

A. WOOD FRAMING (2) 1/2" DIA. x 4" LONG LAG SCREWS B. CONCRETE (2) 1/2" DIA. x 4" WEDGE ANCHORS C. MASONRY (FULLY GROUTED) (2) 1/2" DIA. x 4" LONG SIMPSON TITEN HD ANCHORS

LATERAL SUPPORT IS CONSIDERED ADEQUATE PROVIDING THE JOISTS ARE TOE NAILED TO THE 2x NAILER ON TOP OF THE STEEL BEAM, AND THE 2x NAILER IS SECURED TO THE TOP OF THE STEEL BEAM w/ (2) ROWS OF SELF TAPPING SCREWS @ 16" O.C. OR (2) ROWS OF 1/2" DIAMETER BOLTS @ 16" O.C. IF 1/2" BOLTS ARE USED TO FASTEN THE NAILER, THE STEEL BEAM SHALL BE FABRICATED W/ (2) ROWS OF 9/16" DIAMETER HOLES @ 16" O.C.

- 5. SQUARES DENOTE POINT LOADS WHICH REQUIRE SOLID BLOCKING TO GIRDER OR FOUNDATION, SHADED SQUARES DENOTE POINT LOADS FROM ABOVE WHICH REQUIRE SOLID BLOCKING TO SUPPORTING MEMBER BELOW.
- 6. ALL LOAD BEARING HEADERS TO CONFORM TO TABLE R602.7(1) AND R602.7(2) OF THE NCRC, 2018 EDITION OR BE (2) 2 x 6 WITH (1) JACK AND (1) KING STUD EACH END (UNO), WHICHEVER IS GREATER ALL HEADERS TO BE SECURED TO EACH JACK STUD WITH (4) 8d NAILS. ALL BEAMS TO BE SUPPORTED WITH (2) STUDS AT EACH BEARING POINT (UNO). INSTALL KING STUDS PER SECTION R602.7.5 OF THE NORTH CAROLINA RESIDENTIAL CODE, 2018 EDITION.
- 1. ALL BEAMS, HEADERS, OR GIRDER TRUSSES PARALLEL TO WALL ARE TO BEAR FULLY ON (1) JACK OR (2) STUDS MINIMUM OR THE NUMBER OF JACKS OR STUDS NOTED. ALL BEAMS OR GIRDER TRUSSES PERPENDICULAR TO WALL AND SUPPORTED BY (3) STUDS OR LESS ARE TO HAVE 1 1/2" MINIMUM BEARING (UNO). ALL BEAMS OR GIRDER TRUSSES PERPENDICULAR TO WALL AND SUPPORTED BY MORE THAN (3) STUDS OR OTHER NOTED COLUMN ARE TO BEAR FULLY ON SUPPORT COLUMN FOR ENTIRE WALL DEPTH (UNO). BEAM ENDS THAT BUTT INTO ONE ANOTHER ARE TO EACH BEAR EQUAL LENGTHS (UNO).
- 8. FLITCH BEAMS SHALL BE BOLTED TOGETHER USING 1/2" DIAMETER BOLTS (ASTM A3ØT) WITH WASHERS PLACED AT THREADED END OF BOLT. BOLTS SHALL BE SPACED AT 24" CENTERS (MAXIMUM), AND STAGGERED AT TOP AND BOTTOM OF BEAM (2" EDGE DISTANCE), WITH (2) BOLTS LOCATED AT 6" FROM EACH END (UNO).
- 9. ALL 1-JOIST OR TRUSS LAYOUTS ARE TO BE IN COMPLIANCE WITH THE OVERALL DESIGN SPECIFIED ON THE PLANS. ALL DEVIATIONS ARE TO BE BROUGHT TO THE ATTENTION OF THE ENGINEER OF RECORD PRIOR TO INSTALLATION.
- 10. BRACED WALL PANELS SHALL BE CONSTRUCTED ACCORDING TO THE NORTH CAROLINA RESIDENTIAL CODE 2018 EDITION WALL BRACING CRITERIA. THE AMOUNT, LENGTH, AND LOCATION OF BRACING SHALL COMPLY WITH ALL APPLICABLE TABLES IN SECTION R602.10.
- 11. PROVIDE DOUBLE JOIST UNDER ALL WALLS PARALLEL TO FLOOR JOISTS. PROVIDE SUPPORT UNDER ALL WALLS PARALLEL TO FLOOR TRUSSES OR I-JOISTS PER MANUFACTURER'S SPECIFICATIONS. INSTALL BLOCKING BETWEEN JOISTS OR TRUSSES FOR POINT LOAD SUPPORT FOR ALL POINT LOADS ALONG OFFSET LOAD LINES.
- 12. FOR ALL HEADERS SUPPORTING BRICK VENEER THAT ARE LESS THAN 8'-0" IN LENGTH, REST A 6" x 4" x 5/16" STEEL ANGLE WITH 6" MINIMUM EMBEDMENT AT SIDES FOR BRICK SUPPORT (UN.O.). FOR ALL HEADERS 8'-Ø" AND GREATER IN LENGTH, BOLT A 6" x 4" x 5/16" STEEL ANGLE TO HEADER WITH 1/2" LAG. SCREWS AT 12" O.C. STAGGERED FOR BRICK SUPPORT. FOR ALL BRICK SUPPORT AT ROOF LINES, BOLT A 6" x 4" x 5/16" STEEL ANGLE TO (2) 2 x 10 BLOCKING INSTALLED w/ (4) 12d NAILS EA. PLY BETWEEN WALL STUDS WITH (2) ROWS OF 1/2" LAG SCREWS AT 12" O.C. STAGGERED AND IN ACCORDANCE WITH SECTION RT03.8.2.1 OF THE NCRC, 2018 EDITION.
- 13. FOR STICK FRAMED ROOFS: CIRCLES DENOTE (3) 2 x 4 POSTS FOR ROOF MEMBER SUPPORT. HIP SPLICES ARE TO BE SPACED A MINIMUM OF
- STRAP IF DESIRED. FOR MASONRY OR CONCRETE FOUNDATION USE SIMPSON POST BASE.

4/30/2021