#### **REVISION LOG**

REVISION:001

ADJUST OPTION SQUARE FOOTAGES TO ACCURATELY SHOW THE DIFFERENCES FROM THE BASE PLAN SQUARE FOOTAGE TOTALS.

REVISION:002

RELOCATE FRONT DOOR TO ALIGN W/ GARAGE WALL. ADJUST FOUNDATION AND OPTIONS

a.ccordingly.

2. Add wall & door at foyer for optional smart door delivery center.

3. Note door into main house w/ optional smart door delivery center to be 3068 3/4

CHANGE DOOR WIDTH FROM 2/6 TO 2/4 @ BATH #3, BED #3 CLOSET, BATH #2, BED #2

CLOSET AND OPT. BED #5.

6. FUP PANTRY SHELVES, DELETE DOOR ACCESSED FROM DROP ZONE & ADD 2/4 DOOR

ACCESSED FROM MESSY KITCHEN.
DIMENSION TO CENTER OF TRIPLE WINDOWS ONLY.

MAKE ALL STUD POCKETS 4 1/2".

ADD NOTE AT FIREPLACE FOR A "42"X39" R.O." FOR FIREBOX

9. AUD NOTE AT PREPARE FOR A 42 AS9 K.U. FOR TREBUS.
10. RELOCATE WALL UNDER STAR & NOTE © 36" WALL HT (V.L.F.).
11. ADD GOURMET KITCHEN, ALTERNATE KITCHEN AND ALTERNATE GOURMET KITCHEN OPTIONS.
12. DELETE 2ND WINDOW NEAREST TO CORNER ® POCKET OFFICE OPTION.
13. DELETE OPTIONAL PAINTY DOOR LOCATION.
14. CHANGE SIDELOAD GARAGE FRONT WINDOWS FROM 5/0 HT TO 6/0 HT.

15. ADD 8" DEEP CHASE BEHIND 2ND FL LINEN CLOSET @ HALL.

10. RELOCATE WATER HEATER AT SIDELOAD GARAGE UNDER NEW LINEN CLOSET CHASE.

17. DECOREASE DEPTH OF CHASE BEHIND OWNERS BATH WATER CLOSET TO 10" TO INCREASE WATER CLOSET DEPTH TO 6'-1".

18. MOVE OWNERS VANITY WALL UP TO ALLOW ROOM IN LAUNDRY FOR CHASE @ LINEN, OPT 30"
CAB W/ OPT L.T. AND WASHER/DRYER.

19. ADD PULL DOWN STAIR IN LAUNDRY. NOTE "25 1/2" X 54 1/2" R.O."

20. ADD 18"X24" CHASE IN OWNERS WIC CLOSET @ SHOWER WALL.

21. MAKE BATH#2 VANITY 60".

22. MAKE WC @ BED#2 5"-4" DEEP, ADDING 3" TO BATH #2.

23. MOVE BATH#2 TOLET, TUB AND WINDOW 3" TOWARD FRONT OF HOUSE.

24. MAKE WINDOW IN BED #2 CLOSET TEMPERED.

REVISION:003

DATE: 2/4/2022

DIMENSION TRIPLE STUD POCKETS

DMENSION TRIPLE STUD POCKETS
RELOCATE ISLAND PER REDUNES.
REMOVE WINDOW IN MESSY KITCHEN
FULL HEIGHT WALL AT END OF CABINETS ON GARAGE ADJACENT WALL.
REMOVE UNDER-COUNTER SIDE WALLS IN ISLAND.
SHOW AND CALL OUT DROP ZONE BENCH AS 18" DEEP.

VERIFY CASE OF PRINCS ARE 3/0x6/8 ON 1ST FLOOR.
ELIMINATE ALT KITCHEN
MATCH BASE PLAN LOCATION FOR WATER HEATER IN SIDE LOAD GARAGE.

10. Syf die Lynn book.

11. Create Sower Option with 18" seat.

12. Resize Standard Shower to 60x36. Extend full height wall at Standard Shower.

13. Add 2x6 wall just inside exterior wall for opt. Super Shower w/ opt. 2nd floor.

13. ADD ZAO WAL USST INSUE EXTERIOR WALL FOR OPT. SUPER STUMER BY OPT. ZND FLOUR.

14. ALL LINEN CALLED OUT SA (4) SHELVES.

15. POCKET DOORS CHANCE TO STANDARD 2/4 IN OWNER'S WC TO LAUNDRY.

16. EXTEND REAR PORCH 6" SO BEAM BEARS ON CAFE WALL.

17. CHANGE COLUMINS TO 6X6 P.T. WITH 1X WRAP FOR TRADITIONAL ELEVATION.

18. CHANGE REAR PORCH COLUMINS TO 6X6 P.T. POST, NO WRAP.

19. CHANGE ENTRY DOOR TO 3/4 LITE

20. EXTEND PORCH SLAB 4" AT FRONT AND EXTEND AROUND CORNER 20" TO SUPPORT STONE VENEER.

21. REMOVED HALF WALLS AT KITCHEN ISLAND AND UPDATED PER CABINET PROVIDER
22. CHANGED THE BASE OWNER'S BATH WINDOW TO 4010
24. CHANGED THE OWNER'S BATH OPTION SHOWER W/18" SEAT WINDOW TO 4010

24. CHANGED THE OWNER'S BATH OPTION SUPER SHOWER MINDOWS TO (2)3010
25. CHANGED THE OPTION 2ND FLOOR OWNER'S BATH WINDOW TO 4010
26. CHANGED THE OPTION 2ND FLOOR OWNER'S BATH OPTION SUPER SHOWER WINDOWS TO (2)3010

20. CHANGED IND FLOOR WINDOW OVER PORCH TO BE 2040 ALL ELEVATIONS
28. UPDATED THE WINDOW HEADER AT THE STAIR LANDING TO BE 8'-10" ABOVE LANDING
29. RE-CENTERED GEORGIAN PORCH TO BE CENTERED ON THE WINDOW ABOVE
30. ADDED AN EXTENDED PORCH OPTION TO THE TRADITIONAL ELEVATION ONLY

REVISION:004

CHANGED 2ND FLOOR WINDOW OVER PORCH TO BE 2040 ALL ELEVATIONS

CHANGED ZND FLOOR WINDOW OVER FORCH TO BE ZURD JULE LELEVATION OF THE WINDOW HEADER AT THE STAIR LANDING TO BE 8"-10" ABOVE LANDING CHANGED SIZE OF GEORGIAN PORCH TO BE CENTERED ON THE WINDOW ABOVE CHANGED STYLE OF GEORGIAN COLUMNS FROM ROUND TO SQUARE ADDED AN EXTENDED PORCH OPTION TO THE TRADITIONAL ELEVATION ONLY ADDED REXTENDED PORCH OPTION TO THE TRADITIONAL ELEVATION ONLY

REVISION:005

ADD "STEM WALL" TO CRAWL ELEVATION TITLES AND ADD NOTE "SEE FOUNDATION

PAGES FOR FOUNDATION TYPE". UPDATE SHEET TITLES

REVISION:007

DATE: 11/28/2023

ADD 6" TO THE SIDE OF THE PATIO/DECK/COVERED PORCH TO THE BEAM FOR THE ROOF OF THE COVERED PORCH HAS A BEARING POINT.

## Redlines Completed 15-May - DP

# Lot 13 - Heritage at Neills Creek

97 Whistling Way Lillington, NC 27546

# **NC.**



#### Total Heated: 2.710 Total Unheated: 783

# PLAN 4 The Selma RH **'ENGLISH COUNTRY'**

heet No.	Sheet Description						
0.0	Cover Sheet						
1.1 Foundation (Slab) 1.1.1 Foundation Options (Slab)							
1.2.1	Foundation Options (Crawl)						
1.3	Foundation (Stem Wall Slab)						
1.3.1	Foundation Options (Stem Wall Slab)						
2.1	First Floor Plan						
2.1.1	First Floor Plan Options						
2.2	Second Floor Plan						
2.2.1	Second Floor Plan Options						
2.4	Covered Porch Plans & Elevations (Slab)						
2.4.1	Covered Porch Plans & Elevations (Crawl/Stem Wall)						
2.5	Side Load Garage Elevations (Slab)						
2.5.1	Side Load Garage Elevations (Crawl/ Stem Wall)						
3.1	Front & Rear Elevations (Slab)						
3.1.1	Front & Rear Elevations (Crawl/Stem Wall)						
3.2	Side Elevations (Slab)						
3.2.1	Side Elevations (Crawl/Stem Wall)						
3.3	Roof Plan						
5.1	First Floor Electrical						
5.1.1	First Floor Options Electrical						
5.2	Second Floor Electrical						
5.2.1	Second Floor Options Electrical						

SQUARE	FOOT/	4GE								
	'ENGLISH COUNTRY' ELEVATION									
	UNHEATED HEATED									
FIRST FLOOR	0	1194								
SECOND FLOOR	0	1452								
FRONT PORCH (CRAWL)	149	Ù								
FRONT PORCH (SLAB)	158	0								
REAR PATIC/DECK	210	Û								
2 CAR GARAGE	415	0								
SUBTOTALS	930	2646								
	<u>'</u>									
TOTAL UNDER ROOF	35	76								
1										
OI	PTIONS									
	UNHEATED S.F.	HEATED S.F.								
OPT. POCKET OFFICE	0	+64								
FIREFLACE BUMPOUT	0	-04								
COVERED PATIO/DECK	210	0								
3rd Car Carage	+323	+40								

### **DESIGN CRITERIA:**

THIS PLAN IS TO BE BUILT IN CONFORMANCE WITH THE 2018 NORTH CAROLINA STATE BUILDING CODE: RESIDENTIAL CODE

DIMENSIONS SHALL GOVERN OVER SCALE, AND CODE SHALL GOVERN OVER DIMENSIONS.

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Cover Sheet 'English Country

THE SELMA


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**PLAN** 

DRAWN BY: South Designs ISSUE DATE:

7/1/2021 RRENT REVISION DATE

1/8" = 1'-0"



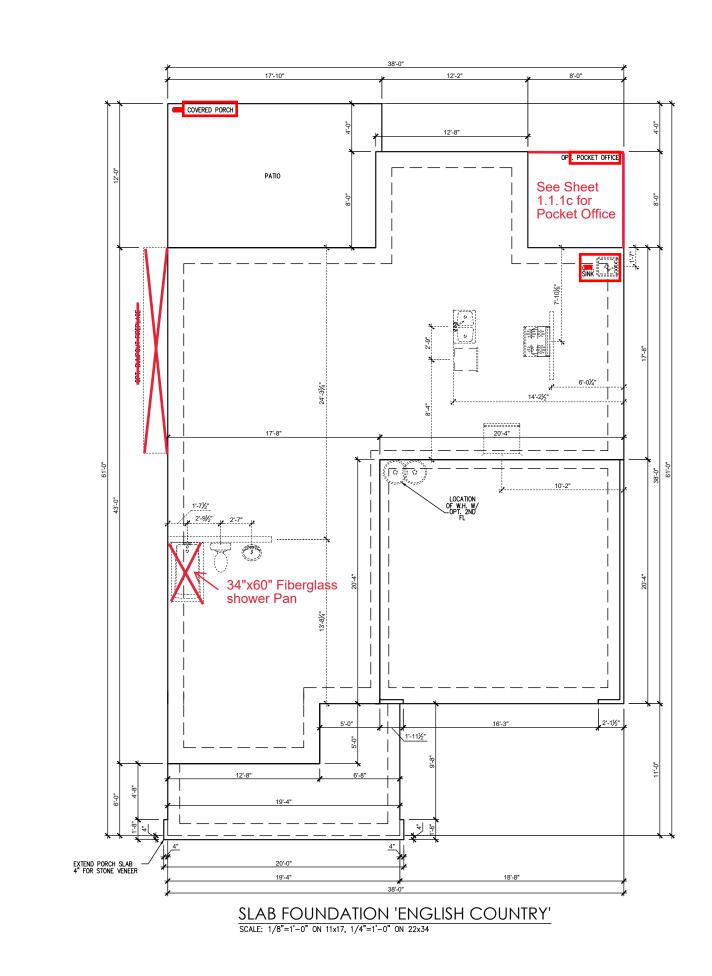


	REV.#	DESCRIPTION	۵
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	5	-	
Slab Foundation 'English Country'	9		
	7	-	
	8	-	

PLAN 4 - THE SELMA -

DRAWN BY: South Designs ISSUE DATE: 7/1/2021

URRENT REVISION DATE:

SCALE: 1/8" = 1'-0" 1.1c

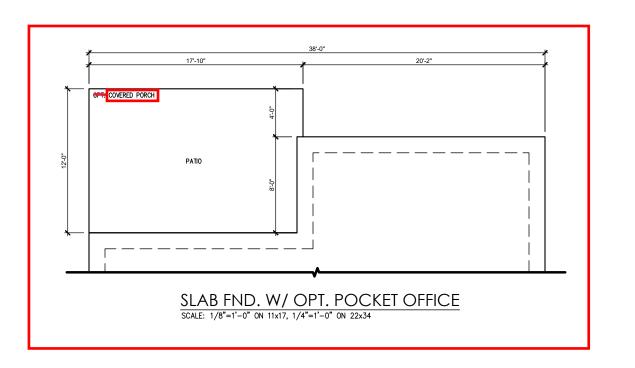


DRAWN BY: South Designs

ISSUE DATE: 7/1/2021 CURRENT REVISION DATE:

SCALE: 1/8" = 1'-0"


General Floor Plan Notes shall apply unless noted otherwise on plan.


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- Soffits, Coffered Ceilings, Trey Ceilings and other significant ceiling pian elements are shown on the floor pians and are denoted as single dashed lines. Unless specifically call out as included, Kitchens do not include soffits over wall cabinety.
- Door & Window Frames, where occurring near corners, shall be a minimum of 4 1/2" from corner. Except for walk-in- closets with doors near a corner, doors at closets shall be centered on closet.
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- Closets for clothing or coat storage shall be equipped with 1 rod/shelf. Closets for linen shall have 4 open equal shelves. Closets for pantries shall have 4 equal wood shelves, painted.
- Stair treads shall be a min of 9" deep, risers shall be a maximum of 8 1/4", unless noted otherwise, per the current North Carolina Residential Code
- 10. Handralls and Guards at stairs shall be 34" above the finished surface of the ramp surface of the stair. Handralls at landings and overlooks of multilevel spaces shall be 36" above finished floor. Guards (pickets or balusters) shall be spaced with no more than 4" between guards.
- 11. Attic Access shall be provided at all attic area with a height greater than 30". Minimum clear attic access shall be 20" x 30". Pull down stairs and access doors in knee walls meeting minimum criteria are also acceptable.
- 12. Garage Door to Living Space shall be 2'-8" x 6'-8" minimum size and shall be 20 minute fire rated and weather sealed
- 13. Garage Walls, as a minimum, shall be separated from living space by installing 1/2" gypsum board on the garage side of the wall. With habitable space above, the inside of all garage walls require 1/2" GWB supporting 5/8" type X GWB on ceiling.

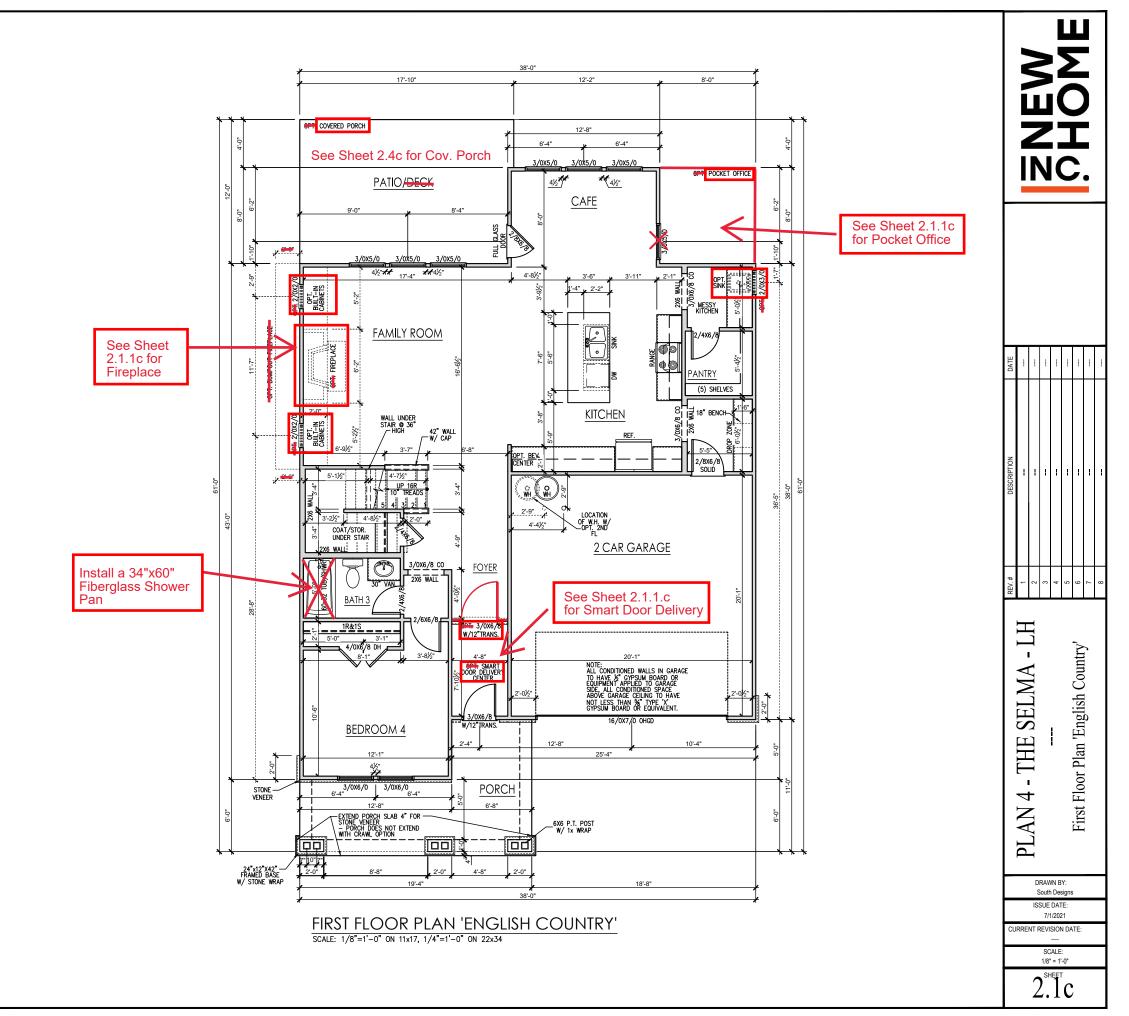


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PLAN 4 - THE SELMA

First Floor Plan Options

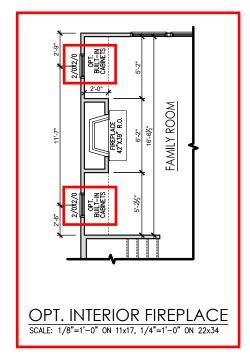1

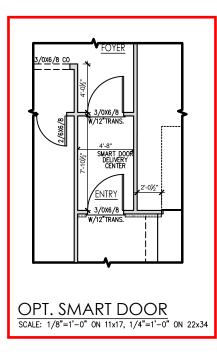DRAWN BY: South Designs ISSUE DATE:

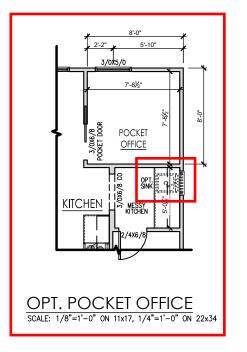
CURRENT REVISION DATE:

7/1/2021

1/8" = 1'-0"

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NEW SHOME

PLAN 4 - THE SELMA - LH
--Second Floor Plan 'English Country'

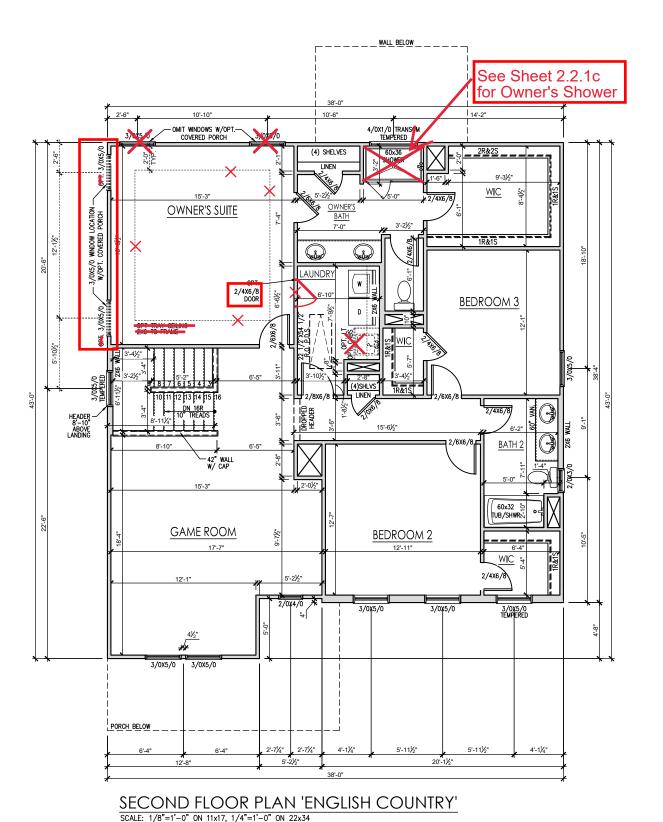DRAWN BY: South Designs


ISSUE DATE: 7/1/2021

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---SCALE:
1/8" = 1'-0"

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PLAN 4 - THE SELMA - L ---


Second Floor Plan Options

DRAWN BY: South Designs ISSUE DATE:

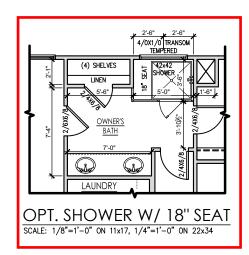7/1/2021 CURRENT REVISION DATE:

> SCALE: 1/8" = 1'-0"

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#### **General Elevation Notes**

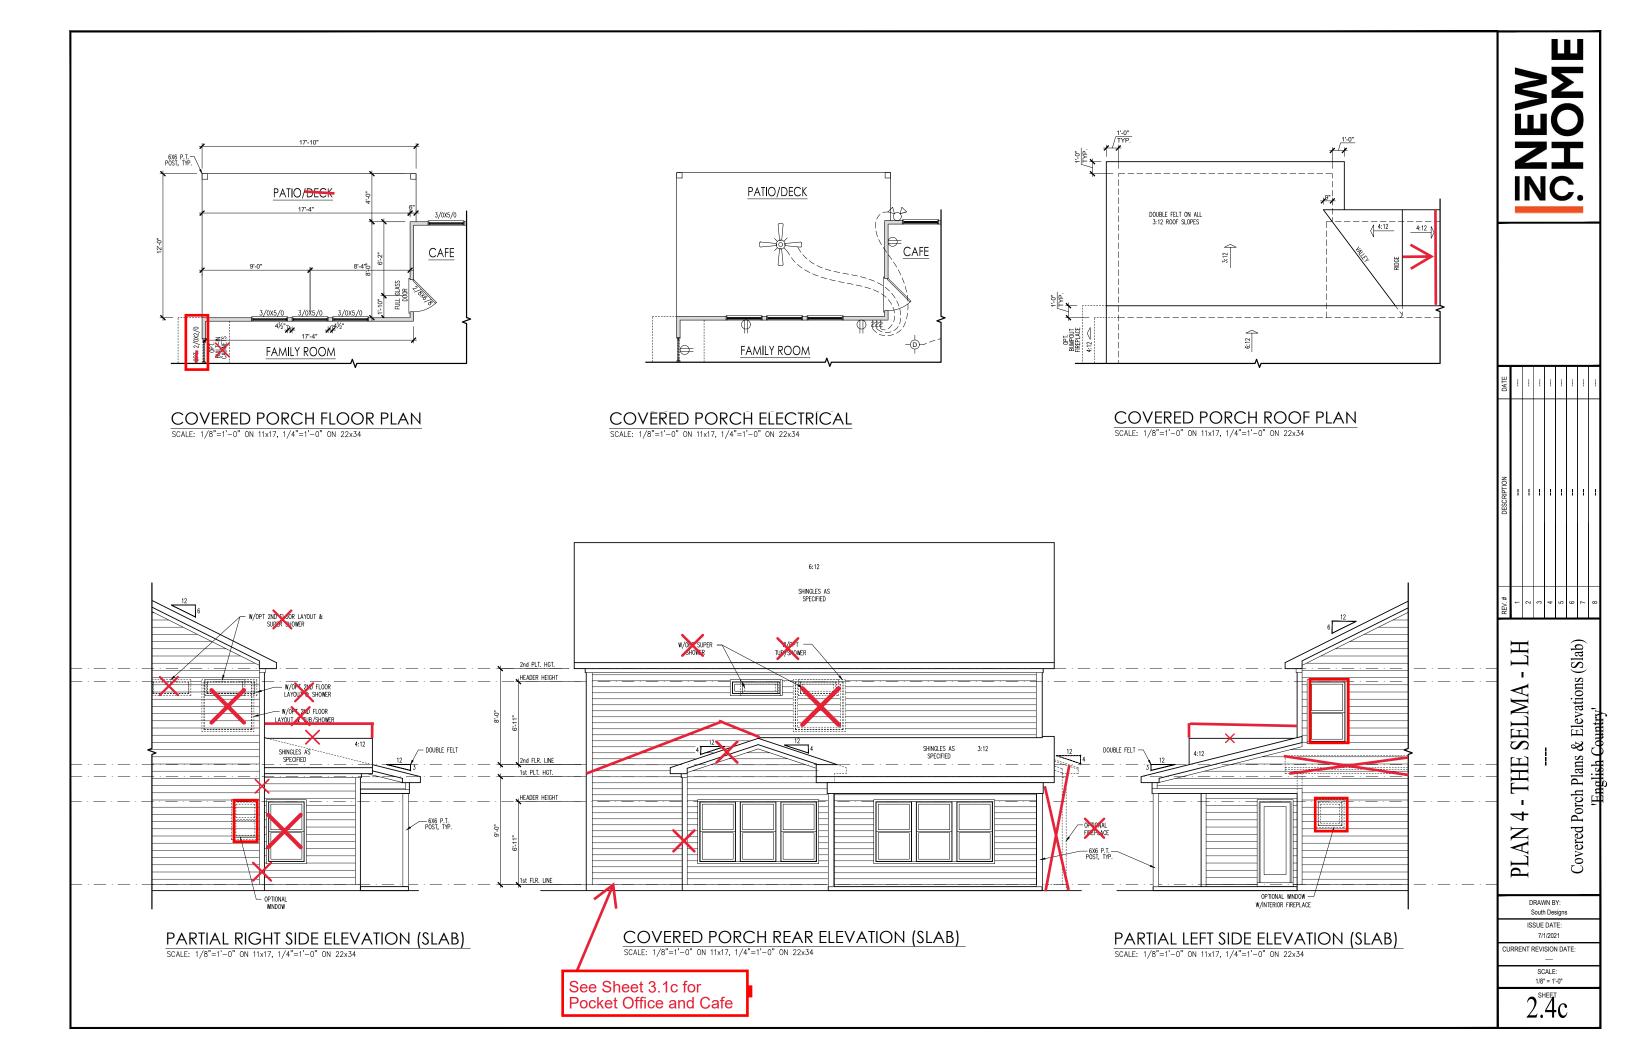
General Elevation Notes shall apply unless


- Roof shall be finished with architectural composition shingles with slopes as noted on plan.
- Ridge Vent shall be provided and installed on all ridges greater than 6' in length per manufacturer's specifications.
- 3. Soffit Vent shall be continuous soffit vent
- House Wrap, "tyvek" or approved equal shall be installed over entire exterior wall per manufacturer's
- Flashing shall be provided above all door and window openings, above finish wall material changes and at wall surfaces where lower roof areas abut vertical wall surfaces.
- Porch Railings shall be provided at all porch walking surfaces greater than 30" above adjacent finished grade. It shall be 36" high with guards spaced no more than 4" apart. Consult community
- Finish Wall Material shall be as noted on elevation drawings.
- Brick Veneer, if included on elevation shall be tied to wall surface with galvanized corrugated metal ties at a rate of 24" oc horizontally and 16" oc vertically so a rate of 24" oc horizontally and 16" oc vertically so that no more than 2.67st of brick is supported by (1) the. Space between face of wall and back face of brick shall be limited to a maximum of 1". Rashing shall be provided behind brick above all wall openings and at base of brick wall. Rashing shall be a minimum of 6-mil poly or other corrosion resistant material and shall be installed so that it laps under the house wrap material a minimum of 2". Weepholes shall be provided at a rate of 48" oc and shall not be less than 3/16" in diameter and shall be located immediately above flashing.
- Brick Veneer Support Lintels shall be provided if brick veneer is included on elevation. Lintels shall be provided as listed in the following schedule and shall have a minimum bearing length of 6". Masonry Lintels shall be provided so that deflection is limited to L/600.

Masonry Opening Lintel Schedule

Opening Size

up to	4'-0"		3-1/2" x 3-1/2" x 5/1
4'-1"	to	5'-6"	4" x 3-1/2" x 5/16" LL
5'-7"	to	6'-6"	5" x 3-1/2" x 5/16" LL
6'-7"	to	8'-4"	6" x 3-1/2" x 5/16" LL
8'-5"	to	16'-4"	7" x 4" x 3/8" LLV

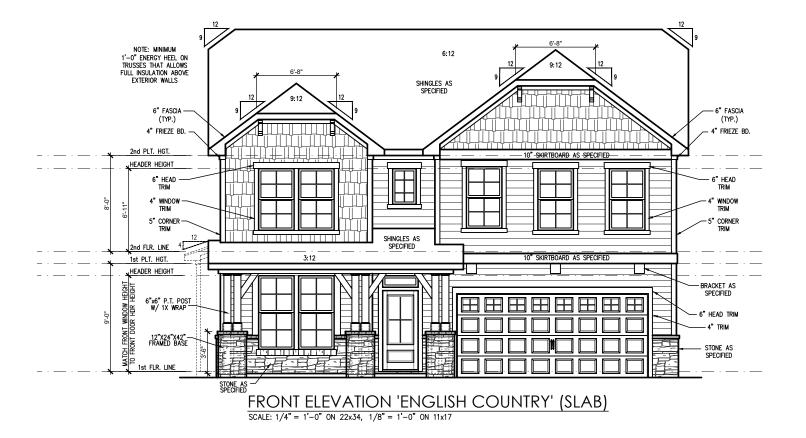

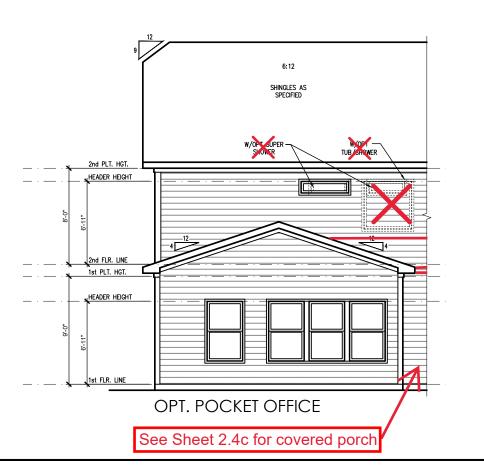



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- LH Rear Elevations (Slab) 'English Country' THE SELMA 4 PLAN

> DRAWN BY: South Designs ISSUE DATE: 7/1/2021

Front & I

JRRENT REVISION DATE

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1/8" = 1'-0"


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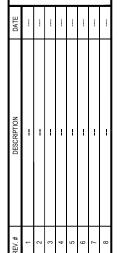
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- Porch Railings shall be provided at all porch walking surfaces greater than 30" above adjacent finished grade. It shall be 36" high with guards spaced no more than 4" apart. Consult community specifications for material.
- Finish Wall Material shall be as noted on elevation drawings.
- 8. Brick Veneer, if included on elevation shall be tied to wall surface with galvanized corrugated metal ties at a rate of 24" oc horizontally and 16" oc vertically so that no more than 2.67sf of brick is supported by (1) tie. Space between face of wall and back face of brick shall be limited to a maximum of 1". Flashing shall be provided behind brick above all wall openings and at base of brick wall. Flashing shall be a minimum of 6-mil poly or other corrosion resistant material and shall be installed so that it laps under the house wrap material a minimum of 2". Weepholes shall be provided at a rate of 46" oc and shall not be less than 3/16" in diameter and shall be located immediately above flashing.
- Brick Veneer Support Lintels shall be provided if brick veneer is included on elevation. Lintels shall be provided as listed in the following schedule and shall have a minimum bearing length of 6". Masonry Lintels shall be provided so that deflection is limited to 1/600.

#### Masonry Opening Lintel Schedule

Open	ing S	ize	Angle					
up to	4'-0"		3-1/2" x 3-1/2" x 5/16"					
4'-1"	to	5'-6"	4" x 3-1/2" x 5/16" LLV					
5'-7"	to	6'-6"	5" x 3-1/2" x 5/16" LLV					
6'-7"	to	8'-4"	6" x 3-1/2" x 5/16" LLV					
8'-5"	to	16'-4"	7" x 4" x 3/8" LLV					





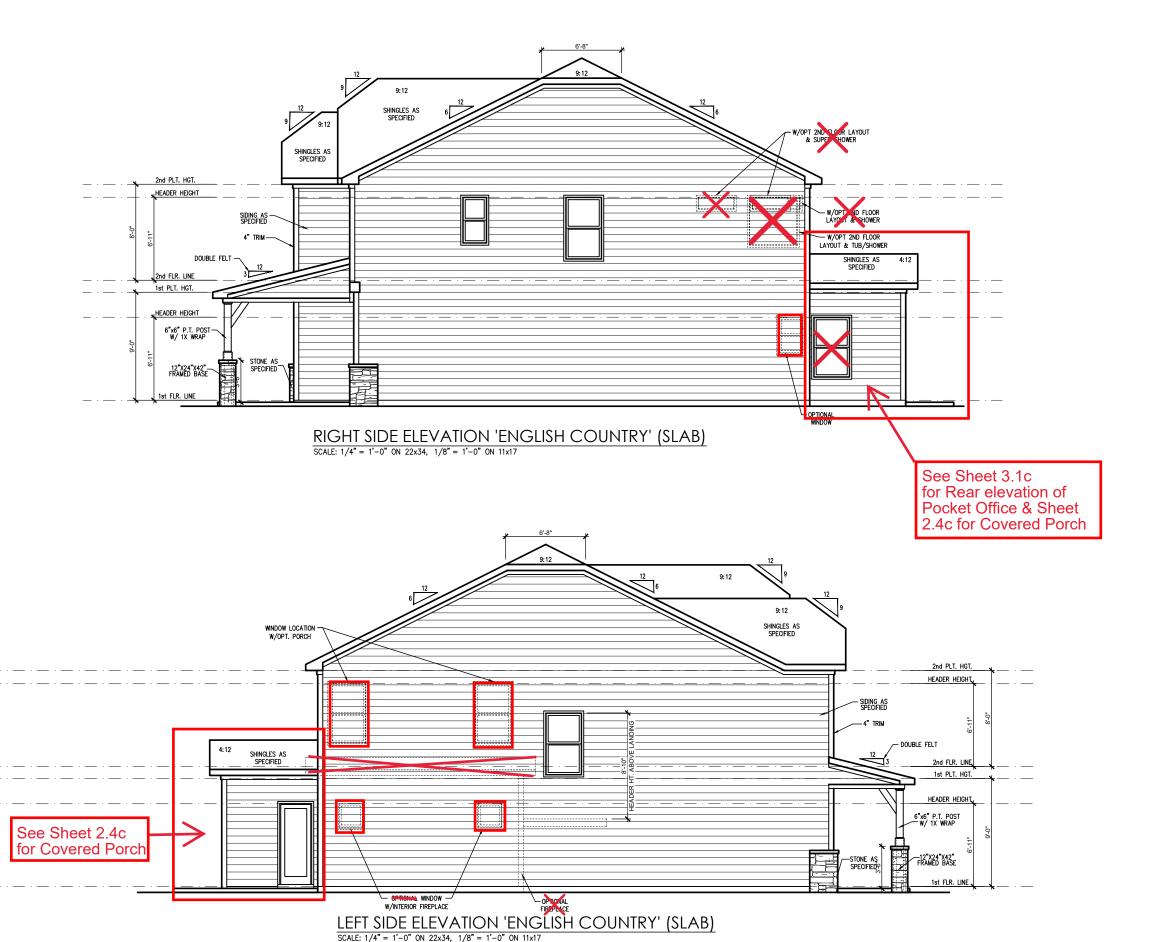


PLAN 4 - THE SELMA - LH
--Side Elevations (Slab) 'English Country'

DRAWN BY: South Designs ISSUE DATE: 7/1/2021

JRRENT REVISION DATE:
--SCALE:
1/8" = 1'-0"

3.2c

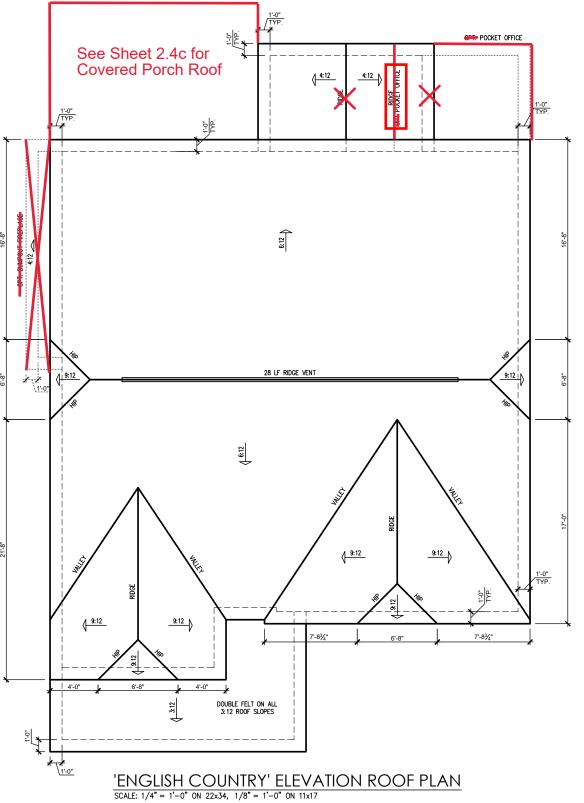

			A	TTIC \	VENT SO	CHEDU	LE				
			'E	:NGLISH	COUNTRY	y' elevatio	ИС				
MAIN I	HOUSE		SQ FTG	1514	AT	/ NEAR RID	GE	AT / NE/	AT / NEAR EAVE		
VENT TYPE	SQ. F		SQ. FT.		POT LARGE (SQ. FT. EACH)	POT SMALL (SQ. FT. EACH)	RIDGE VENT (SQ. FT. PER LF)	EAVE VENT (SQ. IN. EACH)	CONT. VENT (SQ. IN. PER LF)		
8	RAN		SUPPLIED	SUPPLIED	0.4236	0.2778	0.125	0.1944	0.0625		
RIDGE VENT	2.02	2.52	3.50	48.28	0	0	28.00				
SOFFIT VENTS	3.03	2.52	3.75	51.72				0	60.00		
TOTAL (MIN)	5.05	5.05	7.25	100.00	POT VENTS MAY BE	E REQUIRED IF THERE	E IS INSUFFICIENT RID	GE AVAILABLE			

<sup>\*</sup> SCHEDULE HAS BEEN CALCULATED ASSUMING EAVE VENTILATION AT 50-60% OF TOTAL AND RIDGE AT 40-50% OF TOTAL REQUIRED VENTILATION

BWGNC.

DATE			i					-	
DESCRIPTION			1	1	1	1	1		
REV.#	1	2	3	4	2	9	7	8	

PLAN 4 - THE SELMA - LH
--Roof Plan 'English Country'

DRAWN BY: South Designs ISSUE DATE: 7/1/2021

URRENT REVISION DATE:

SCALE: 1/8" = 1'-0" 3.3c

SCALE: 1/8"=1'-0" ON 11x17, 1/4"=1'-0" ON 22x34

PROJECT # 21-2817-RH


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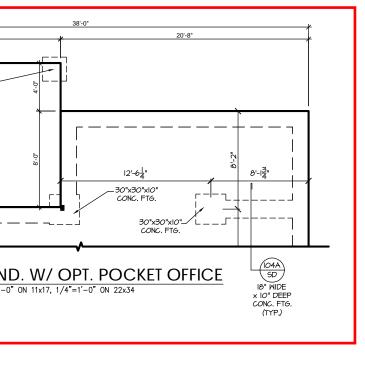
SOUTH DESIGNS

RH Selma 8 Plan

NEW HOME,

S-1.1



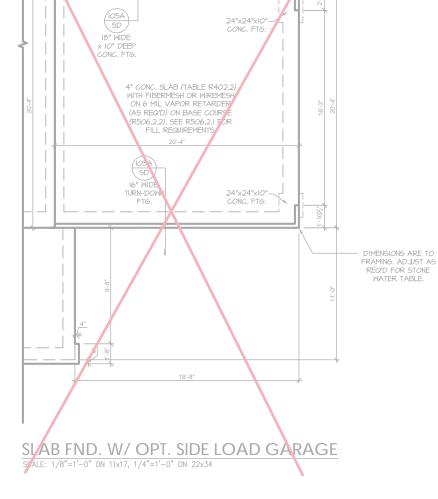

SLAB FND. W/ OPT. BUMPOUT FIREPLACE
SCALE: /8"=1'-0" ON 11x17, 1/4"=1'-0" ON 22x34

PROJECT # 21-2817-RH

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SOUTH DESIGNS

RH The Selma NEW HOME, INC. Plan 04

S-1.1

REFER TO "SD" SHEET(S) FOR STANDARD DETAILS, BRACING DETAILS AND STRUCTURAL NOTES.

## TRUSS SYSTEM REQUIREMENTS NC (2018 NCRC): Wind: 115-120 mph

- I. TRUSS SYSTEM LAYOUTS (PLACEMENT PLANS) SHALL BE DESIGNED IN ACCORDANCE WITH SEALED STRUCTURAL PLANS, ANY NEED TO CHANGE TRUSSES SHALL BE COORDINATED WITH SOUTHERN ENGINEERS.
- TRUSS SCHEMATICS (PROFILES) SHALL BE PREPARED AND SEALED BY TRUSS MANUFACTURER.
- 3. ALL TRUSSES SHALL BE DESIGNED FOR BEARING ON SPF #2 OR #3 PLATES OR LEDGERS (UNO).
- 4. ALL REQUIRED ANCHORS FOR TRUSSES DUE TO UPLIFT OR BEARING SHALL MEET THE REQUIREMENTS AS SPECIFIED ON THE TRUSS SCHEMATICS.


#### HEADER/BEAM & COLUMN NOTES

- I. ALL EXTERIOR AND LOAD BEARING HEADERS SHALL BE MIN. (2)2x6 (4" WALL) OR (3)2x6 (6" WALL) WITH (I) SUPPORT STUD, UNLESS NOTED OTHERWISE.
- 2. THE NUMBER SHOWN AT BEAM AND HEADER SUPPORTS INDICATES THE NUMBER OF SUPPORT STUDS REQUIRED IN STUD POCKET OR COLUMN. THE NUMBER OF KING STUDS AT EACH END OF HEADERS IN EXTERIOR WALLS SHALL BE ACCORDING TO ITEM "d" IN TABLE R602.3(5) OR AS BELOW PER NCDOI COMMENTARY "KING STUDS AT WALL OPENINGS" DEVISED 14.2.2020.
- AT WALL OPENINGS" REVISED I-9-2020: UP TO 3' SPAN: (I) KING STUD
- OVER 3' UP TO 6' SPAN: (2) KING STUDS
- OVER 6' UP TO 9' SPAN: (3) KING STUDS
- OVER 9' UP TO 12' SPAN: (4) KING STUDS
- OVER 12' UP TO 15' SPAN: (5) KING STUDS

#### FRAMING NOTES

NC (2018 NCRC): Wind: 115-120 mph

- I. BRACING METHOD AND TYPE: CONTINUOUSLY SHEATHED WGP: C5-MSP. NOTE THAT THE WALL BRACING AMOUNT PROVIDED ON THE PLANS (DETAILS AND SPECIFICATIONS) IS GREATER THAN THE AMOUNT OF WALL BRACING REQUIRED BY SECTION R602.10 OF THE CODE. SEE NOTES BELOW FOR DETAILS AND SPECIFICATIONS FOR WALL BRACING AND WALL FRAMING.
- 2. EXTERIOR WALL SHEATHING: WALLS SHALL BE BRACED BY SHEATHING WALLS ON ALL STORIES WITH MOOD STRUCTURAL PANEL SHEATHING (MSP) (EXPOSURE is 17/16". EXPOSURE is 15/32"). SHEATHING SHALL BE ATTACHED WITH 8d NAILS AT A 6"/12" NAILING PATTERN (6" OC AT PANEL EDGES AND 12" OC AT INTERMEDIATE SUPPORTS). INSTALL BLOCKING AT ALL PANEL EDGES.
- 3. WSP SHEATHING SHALL EXTEND TO THE UPPERMOST DOUBLE BEARING PLATE. BLOCK AT ROOF PER SECTION REO2.IO.4.5 AND ATTACH BRACED WALLS PER CODE. WSP SHEATHING BETWEEN FLOORS SHALL BE SPLICED ALONG CONTINUOUS BAND OR THE WSP SHEATHING MAY BE SPLICED ACROSS STUDS (CONTINUOUS ACROSS FLOOR SYSTEM) WITH BLOCKING AT PANEL EDGES. (MINIMUM I2" BEYOND FLOOR BREAK) OR OTHER APPROYED METHOD.
- 4. "HD" = HOLDOWN: HOLD-DOWN DEVICE (NOTED AS "HD" ON PLANS) SHALL BE AN 800 POUND CAPACITY ASSEMBLY AS NOTED ON PLANS, SEE DETAILS FOR HD ASSEMBLY.
- ""GROUND/FIRST FLOOR: USE "HD HOLD-DOWN DETAIL" ON SD SHEET (OR EQUIV.)
- \*\*UPPER FLOORS: ATTACH BASE OF KING STUD WITH A SIMPSON C522 STRAP DOWN ACROSS THE BAND AND DOWN TO A STUD BELOW OR HEADER BELOW. EXTEND STRAP T\* MIN ALONG EACH STUD (OR HEADER) AND ATTACH EACH END W (1) &d NAILS.
- INTERIOR BRACED WALL: (NOTED AS "IBW" ON PLANS) ATTACH I/2" GYPSUM BOARD (GB) ON EACH SIDE OF WALL WITH A MIN. OF 5d COOLER NAILS OR #6 SCREMS ® 7" O.C. ALONG THE EDGES AND AT INTERMEDIATE SUPPORTS.
- 6. INTERIOR BRACED WALL-WOOD STRUCTURAL PANEL: (NOTED AS "IBM-MSP" ON PLANS). ATTACH ONE SIDE WITH 36" WSP SHEATHING WITH 36 NAILS AT A 6"/12" NAILING PATTERN (6" OC AT PANEL EDGES AND 12" OC AT INTERMEDIATE SUPPORTS). INSTALL BLOCKING AT ALL PANEL EDGES. ATTACH 6B OVER WSP AS REQUIRED. ATTACH OPPOSITE SIDE WITH 1/2" GB WITH A MIN. OF 5d COOLER NAILS OR #6 SCREMS @ 7" OC ALONG THE EDGES AND AT INTERMEDIATE SUPPORTS

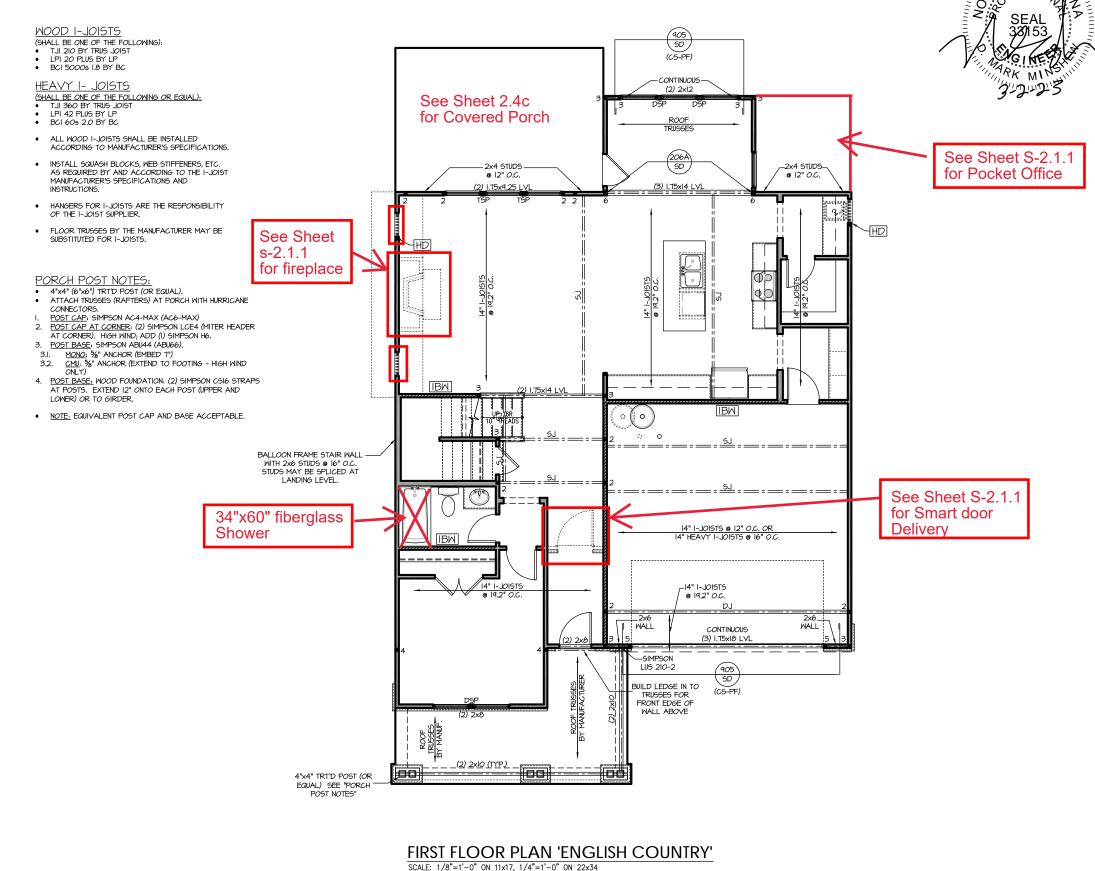

REFER TO "SD" SHEET(S) FOR STANDARD DETAILS, BRACING DETAILS AND STRUCTURAL NOTES. 21-2817-RH

PROJECT #

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sequences, procedures or safety precautions.

Any deviations or discrepancies on plans a immediate attention of Southern Engineer void Southern Engineer void Southern Engineer's liability.

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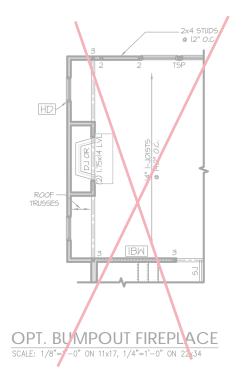
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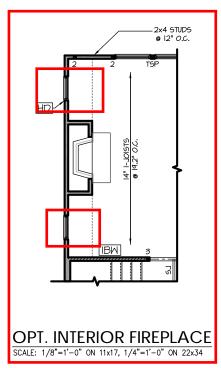
SOUTH DESIGNS


4 - The Selma - RH NEW HOME, INC.


S-2.1


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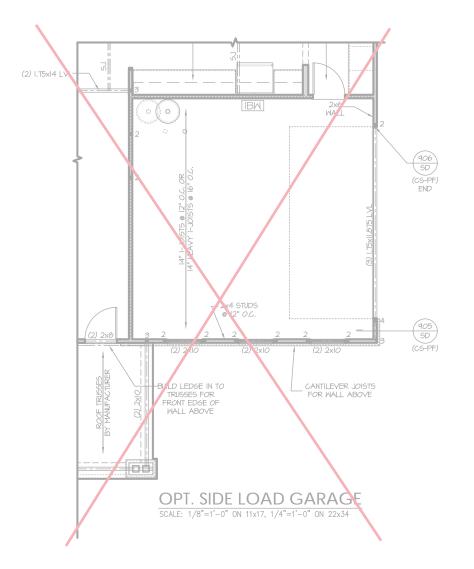






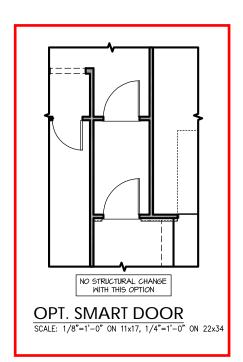

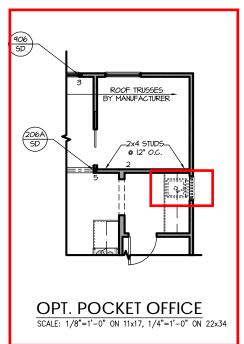

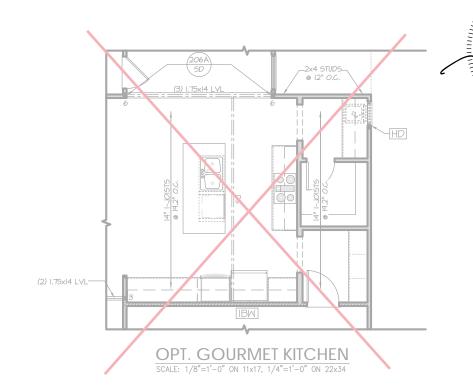

PROJECT # 21-2817-RH

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abed does not include construction means, methods, technique sequences, procedures or safety prevantions.
Any deviations or discrepancies on plans are to be brought to immediate attention of Southern Engineers. Failure to do so void Southern Engineers inhality.

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SOUTH DESIGNS

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NEW HOME, INC.

REFER TO "SD" SHEET(S) FOR STANDARD DETAILS, BRACING DETAILS AND STRUCTURAL NOTES.

#### TRUSS SYSTEM REQUIREMENTS

NC (2018 NCRC): Wind: 115-120 mph

- TRUSS SYSTEM LAYOUTS (PLACEMENT PLANS) SHALL BE DESIGNED IN ACCORDANCE WITH SEALED STRUCTURAL PLANS. ANY NEED TO CHANGE TRUSSES SHALL BE COORDINATED WITH SOUTHERN ENGINEERS.
- TRUSS SCHEMATICS (PROFILES) SHALL BE PREPARED AND SEALED BY TRUSS MANUFACTURER.
- ALL TRUSSES SHALL BE DESIGNED FOR BEARING ON SPF #2 OR #3 PLATES OR LEDGERS (UNO).
- ALL REQUIRED ANCHORS FOR TRUSSES DUE TO UPLIFT OR BEARING SHALL MEET THE REQUIREMENTS AS SPECIFIED ON THE TRUSS SCHEMATICS.

#### HEADER/BEAM & COLUMN NOTES

- ALL EXTERIOR AND LOAD BEARING HEADERS SHALL SUPPORT STUD, UNLESS NOTED OTHERWISE.
- 2. THE NUMBER SHOWN AT BEAM AND HEADER SUPPORTS INDICATES THE NUMBER OF SUPPORT STUDS REQUIRED IN STUD POCKET OR COLUMN. THE NUMBER OF KING STUDS AT EACH END OF HEADERS IN EXTERIOR WALLS SHALL BE ACCORDING TO ITEM "d" IN TABLE R602.3(5) OR AS BELOW PER NCDOI COMMENTARY "KING STUDS AT WALL OPENINGS" REVISED 1-9-2020: UP TO 3' SPAN: (1) KING STUD
- OVER 3' UP TO 6' SPAN: (2) KING STUDS
- OVER 6' UP TO 9' SPAN: (3) KING STUDS
- OVER 9' UP TO 12' SPAN: (4) KING STUDS
- OVER 12' UP TO 15' SPAN: (5) KING STUDS


#### FRAMING NOTES

NC (2018 NCRC): Wind: 115-120 mph

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- EXTERIOR WALL SHEATHING: WALLS SHALL BE BRACED BY
  SHEATHING WALLS ON ALL STORIES WITH WOOD STRUCTURAL PANEL SHEATHING (WGP) (EXPOSURE B: T/16", EXPOSURE C: 15/32").
  SHEATHING SHALL BE ATTACHED WITH 8d NAILS AT A 6"/12" NAILING PATTERN (6" OC AT PANEL EDGES AND 12" OC AT INTERMEDIATE SUPPORTS). INSTALL BLOCKING AT ALL PANEL EDGES.
- 3. WSP SHEATHING SHALL EXTEND TO THE UPPERMOST DOUBLE BEARING PLATE. BLOCK AT ROOF PER SECTION R602.10.4.5 AND ATTACH BRACED WALLS PER CODE. WSP SHEATHING BETWEEN FLOORS SHALL BE SPLICED ALONG CONTINUOUS BAND OR THE WSP SHEATHING MAY BE SPLICED ACROSS STUDS (CONTINUOUS ACROSS FLOOR SYSTEM) WITH BLOCKING AT PANEL EDGES. (MINIMUM 12" BEYOND FLOOR BREAK) OR OTHER APPROVED METHOD.
- 4. "HD" = HOLDOWN: HOLD-DOWN DEVICE (NOTED AS "HD" ON PLANS) SHALL BE AN 800 POUND CAPACITY ASSEMBLY AS NOTED ON PLANS, SEE DETAILS FOR HD ASSEMBLY.
- \*\*GROUND/FIRST FLOOR: USE "HD HOLD-DOWN DETAIL" ON SD SHEET (OR EQUIV.)
- STEEL (OR EGOIV)

  "UPPER ILOORS, ATTACH BASE OF KING STUD WITH A SIMPSON C522 STRAP DOWN ACROSS THE BAND AND DOWN TO A STUD BELOW OR HEADER BELOW. EXTEND STRAP T" MIN ALONG EACH STUD (OR HEADER) AND ATTACH EACH END W (1) 8d NAILS.
- 5. INTERIOR BRACED WALL: (NOTED AS "IBW" ON PLANS) ATTACH I/2" GYPSUM BOARD (GB) ON EACH SIDE OF WALL WITH A MIN. OF 5d COOLER NAILS OR #6 SCREWS @ 7" O.C. ALONG THE EDGES AND AT INTERMEDIATE SUPPORTS.
- 6. INTERIOR BRACED WALL-WOOD STRUCTURAL PANEL: (NOTED AS "IBM-WSP" ON PLANS). ATTACH ONE SIDE WITH 1/6" WSP SHEATHING WITH 8d NAILS AT A 6"/12" NAILING PATTERN (6" OC AT PANEL EDGES AND 12" OC AT INTERMEDIATE SUPPORTS). INSTALL BLOCKING AT ALL PANEL EDGES, ATTACH 6B OVER WEP AS REQUIRED. ATTACH OPPOSITE SIDE WITH 1/2" 6B WITH A MIN. OF 5d COOLER NAILS OR #6 SCREWS @ 1" OC ALONG THE EDGES AND AT



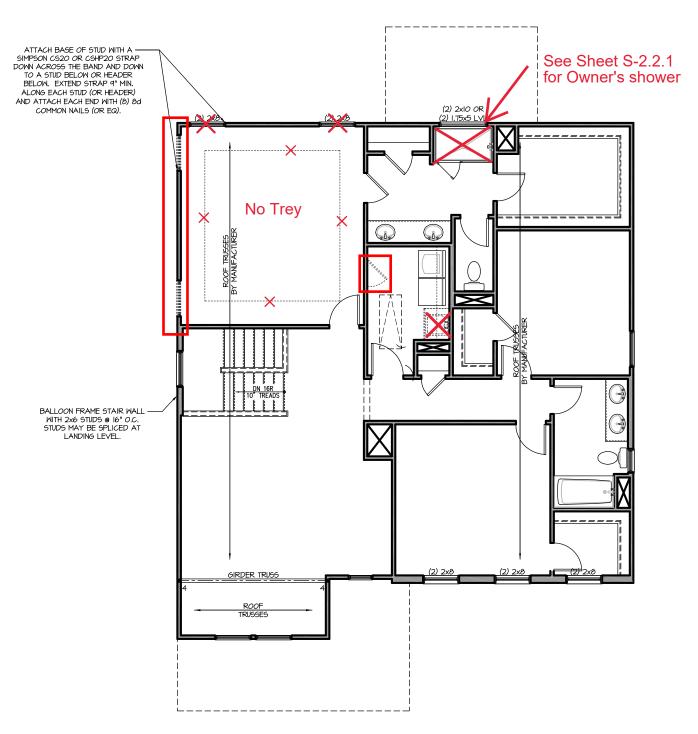

SECOND FLOOR PLAN 'ENGLISH COUNTRY' SCALE: 1/8"=1'-0" ON 11x17, 1/4"=1'-0" ON 22x34

> REFER TO "SD" SHEET(S) FOR STANDARD DETAILS BRACING DETAILS AND STRUCTURAL NOTES.


PROJECT # 21-2817-RH


P.A. 27609 Engineers, Drive, Raleigh, NC Southern E
3716 Benson Dri
Phone: (

SOUTH DESIGNS

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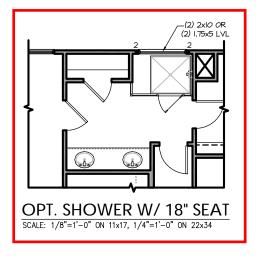
Plan



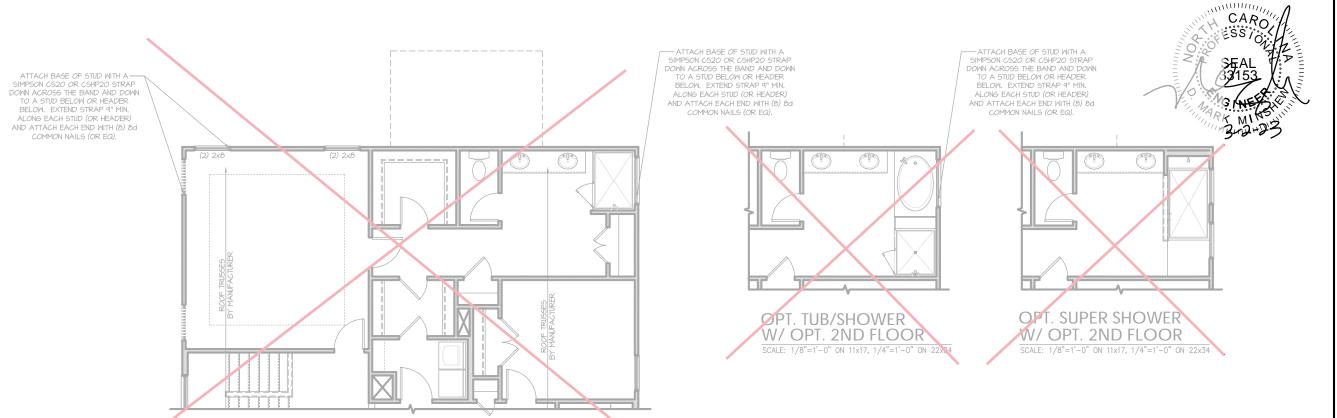

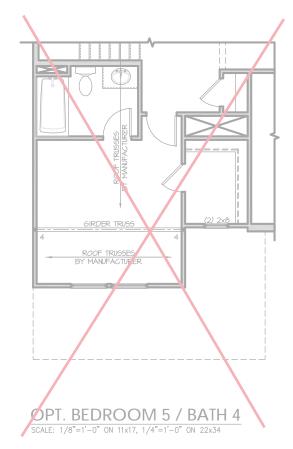OPT. 2ND FLOOR

SCALE: 1/8"=1'-0" ON 11x17, 1/4"=1'-0" ON 22x34







REFER TO "SD" SHEET(S) FOR STANDARD DETAILS, BRACING DETAILS AND STRUCTURAL NOTES. PROJECT # 21-2817-RH

Engineers seal applies only to succession.

document.
Seal does not include construction means, methods, techniques, sequences, procedures or safety precautions.

Any deviations or discrepancies on plans are to be brought to the immediate attention of Southern Engineers. Failure to do so will void Southern Engineers' liability.

Seal is valid for projects permitted one year from date of seal.
Use of these plans constitutes approval of terms & conditions as defined in the customer agreement.

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SOUTH DESIGNS

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S-2.2.

#### TRUSS SYSTEM REQUIREMENTS

NC (2018 NCRC): Wind: 115-120 mph

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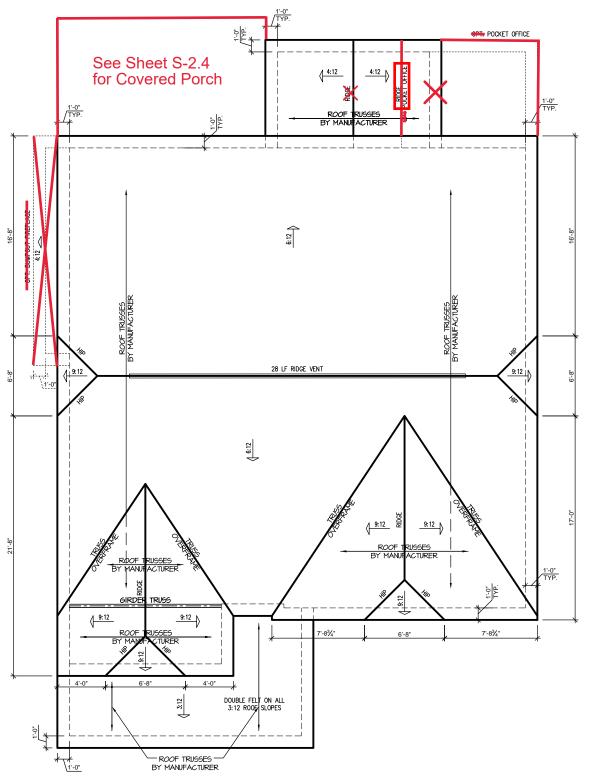
#### TRUSS SYSTEM REQUIREMENTS NC (2018 NCRC): Wind: 115-120 mph

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  SHALL BE DESIGNED IN ACCORDANCE WITH SEALED
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- ALL REQUIRED ANCHORS FOR TRUSSES DUE TO UPLIFT OR BEARING SHALL MEET THE REQUIREMENTS AS SPECIFIED ON THE TRUSS SCHEMATICS.

ATTIC VENT SCHEDULE													
'ENGLISH COUNTRY' ELEVATION													
MAIN HOUSE			SQ FTG	1514	AT / NEAR RIDGE			AT / NEAR EAVE					
VENT TYPE	SQ. FT. REQUIRED RANGE		SQ. FT. SUPPLIED	PERCENT OF TOTAL SUPPLIED	POT LARGE (SQ. FT. EACH)	POT SMALL (SQ. FT. EACH)	RIDGE VENT (SQ. FT. PER LF)	EAVE VENT (SQ. IN. EACH)	CONT. VENT (SQ. IN. PER LF)				
					0.4236	0.2778	0.125	0.1944	0.0625				
RIDGE VENT	2.02	2.52	3.50	48.28	0	0	28.00						
SOFFIT VENTS	3.03	2.52	3.75	51.72	0 60.00			60.00					
TOTAL (MIN)	5.05	5.05	7.25	100.00	POT VENTS MAY BE REQUIRED IF THERE IS INSUFFICIENT RIDGE AVAILABLE								

<sup>\*</sup> SCHEDULE HAS BEEN CALCULATED ASSUMING EAVE VENTILATION AT 50-60% OF TOTAL AND RIDGE AT 40-50% OF TOTAL REQUIRED VENTILATION

CAROLLA SEAL AND SEAL



'ENGLISH COUNTRY' ELEVATION ROOF PLAN
SCALE: 1/4" = 1'-0" ON 22x34, 1/8" = 1'-0" ON 11x17

PROJECT # 21-2817-RH

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ude construction means, methods, techniq diuces or safety precautions. discrepancies on plans are to be brought on of Southern Engineers. Failure to do so gineer's liability.

P.A. Seal does not include construction and advantage of the construction of the construction of South with soid Southern Engineer's liabilities of these plans constitutes.

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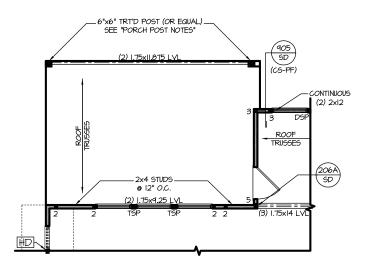
SOUTH DESIGNS

14 - The Selma - RH NEW HOME, INC.

S-3.1


Plan

REFER TO "SD" SHEET(S) FOR STANDARD DETAILS, BRACING DETAILS AND STRUCTURAL NOTES.




**COVERED PORCH FLOOR PLAN** SCALE: 1/8"=1'-0" ON 11x17, 1/4"=1'-0" ON 22x34

Pocket Office

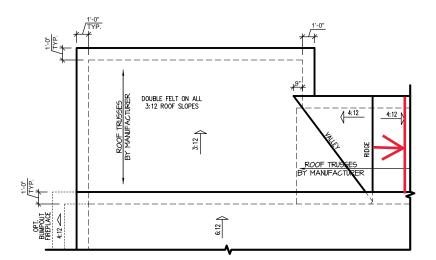

**COVERED PORCH ROOF PLAN** SCALE: 1/8"=1'-0" ON 11x17, 1/4"=1'-0" ON 22x34

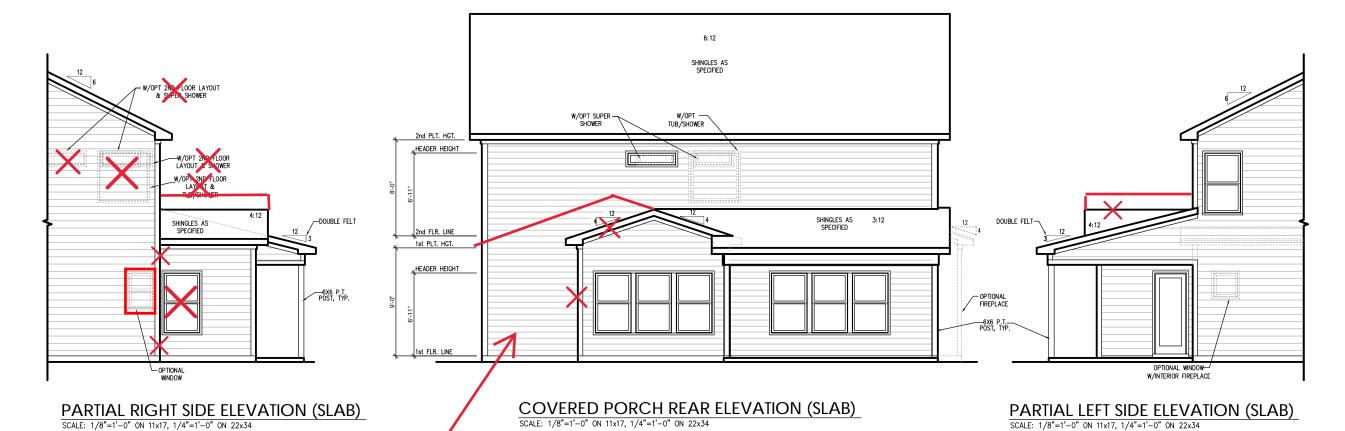


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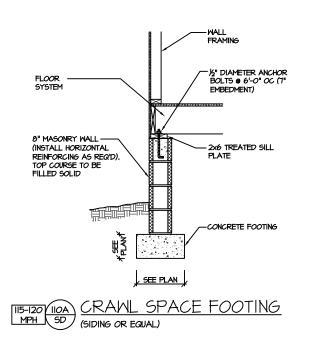
PROJECT # 21-2817-RH


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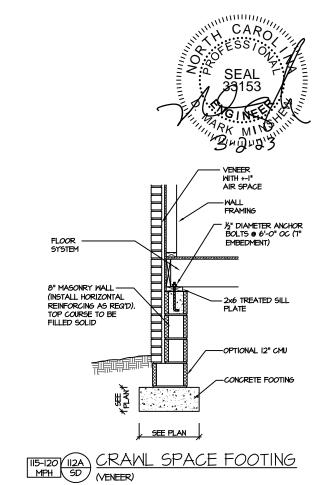
SOUTH DESIGNS


RH The Selma NEW HOME, INC. Plan 04





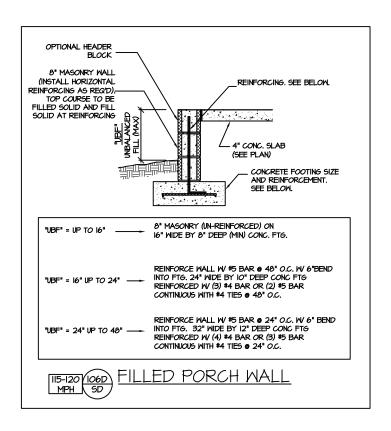


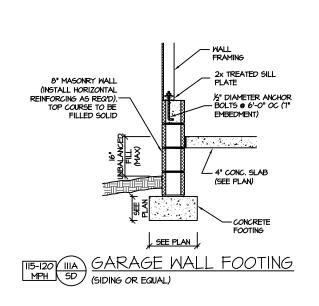

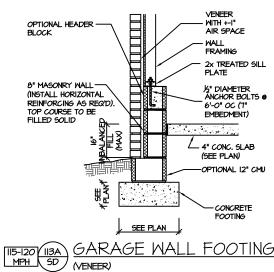


GARAGE WALI FOOTING (VENEER)

(FOR UNBALANCED FILL EXCEEDING 16" O.C. SEE DETAIL "IO6D/SD")

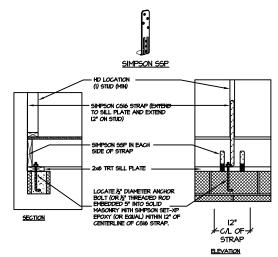

BRACED WALL END CONDITION " HD" HOLD-DOWN DETAIL

NOTE: SIMPSON DTT-IZ IS ACCEPTABLE ALTERNATE NOTE: ALTERNATE HD HOLD-DOWN DEVICES OR SYSTEMS MAY BE USED TO MEET THE CODE REQUIRED 800 LB CAPACITY IN LIEU OF THE ABOVE DETAIL.

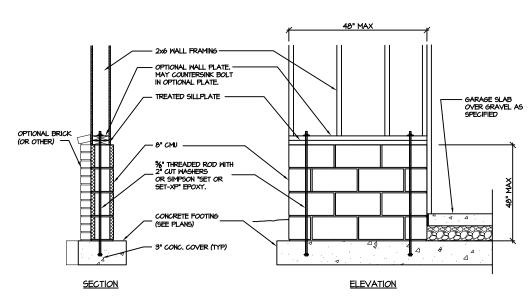

GARAGE 'WING WALL' REINFORCING PER IRC FIGURE R602.IO.4.3

CRAWL SPACE FOUNDATION


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SELMA THE 4 PLAN



# MITH +-I" AIR SPACE - WALL FRAMING - TREATED SILL PLATE - ½" DIAMETER ANCHOR BOLTS @ 6'-O" OC (7" EMBEDMENT) OR SIMPSON MASA MUDSILL ANCHORS @ 6'-O" OC (ADJUST LOCATION AT DOOR OPENINGS.) LOCATE 12" FROM PLATE 4" CONC. SLAB (SEE PLAN)




MONOLITHIC SLAB @ GARAGE

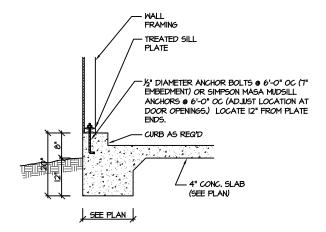
MONOLITHIC SLAB FOOTING (MPH SD) MONOLITHIC SLAB FOOTING

VENEER


MPH SD (SIDING OR FOLK)

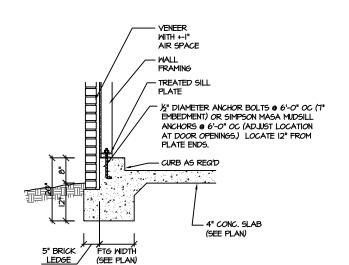


MONOLITHIC SLAB @ GARAGE (VENEER)

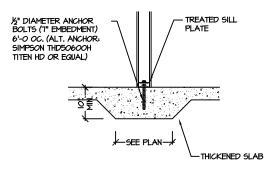



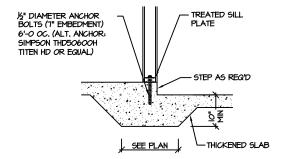

THICKENED SLAB @ GARAGE (INTERIOR GARAGE WALL)

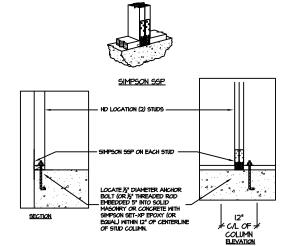

II5-I20 IOIA MPH SD

(SIDING OR EQUAL)

BRACED WALL END CONDITION "HD" HOLD-DOWN DETAIL

NOTE: SIMPSON DTT-IZ IS ACCEPTABLE ALTERNATE NOTE: ALTERNATE HD HOLD-DOWN DEVICES OR SYSTEMS MAY BE USED TO MEET THE CODE REQUIRED 800 LB CAPACITY IN

LIEU OF THE ABOVE DETAIL.

SLAB FOUNDATION


PROJECT # 21-2817

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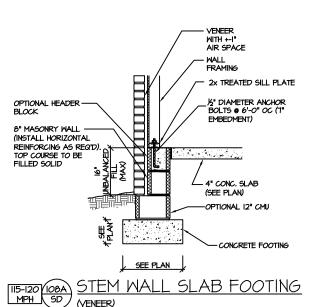
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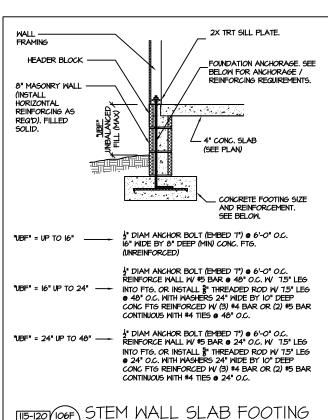





(FOR UNBALANCED FILL EXCEEDING 16" O.C.

(VENEER)

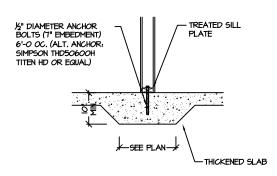
SEE DETAIL "IO6E/SD")




(SIDING OR EQUAL)

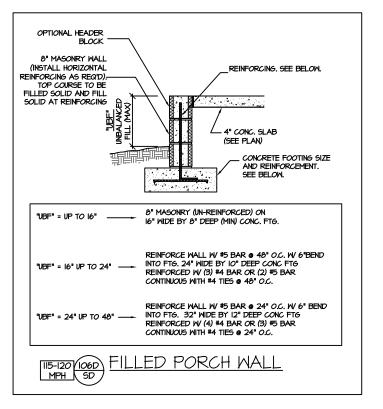




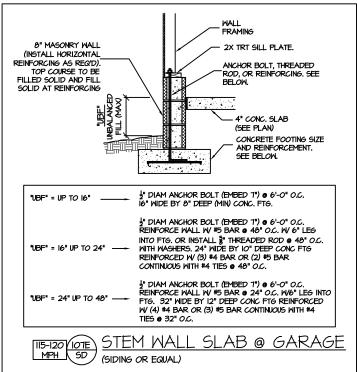

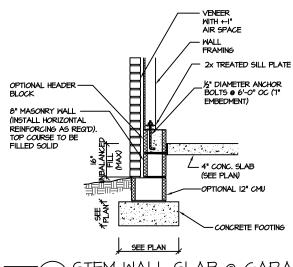


STEM WALL SLAB @ GARAGE 115-120 109A MPH SD (VENEER) (FOR UNBALANCED FILL EXCEEDING 16" O.C.

SEE DETAIL "IO6E/SD")

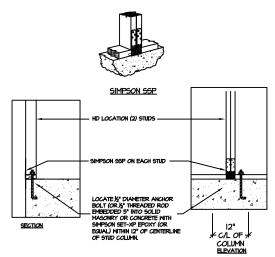

BRACED WALL END CONDITION "HD" HOLD-DOWN DETAIL

NOTE: SIMPSON DTT-IZ IS ACCEPTABLE ALTERNATE NOTE: ALTERNATE HD HOLD-DOWN DEVICES OR SYSTEMS MAY BE USED TO MEET THE CODE REQUIRED 800 LB CAPACITY IN LIEU OF THE ABOVE DETAIL.

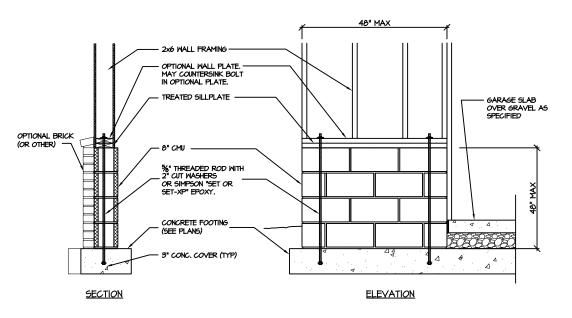

GARAGE 'WING WALL' REINFORCING PER IRC FIGURE R602.IO.4.3

STEMMALL SLAB FOUNDATION


PROJECT # 21-2817


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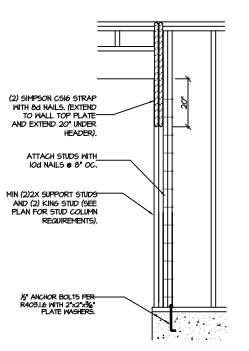
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CS-PF: CONTINUOUS PORTAL FRAME CONSTRUCTION

CS-PF - OVER WOOD FLOOR

DETAIL AND APPLICATION BASED ON NORC FIGURE R602.IO.I - PORTAL FRAME CONSTRUCTION

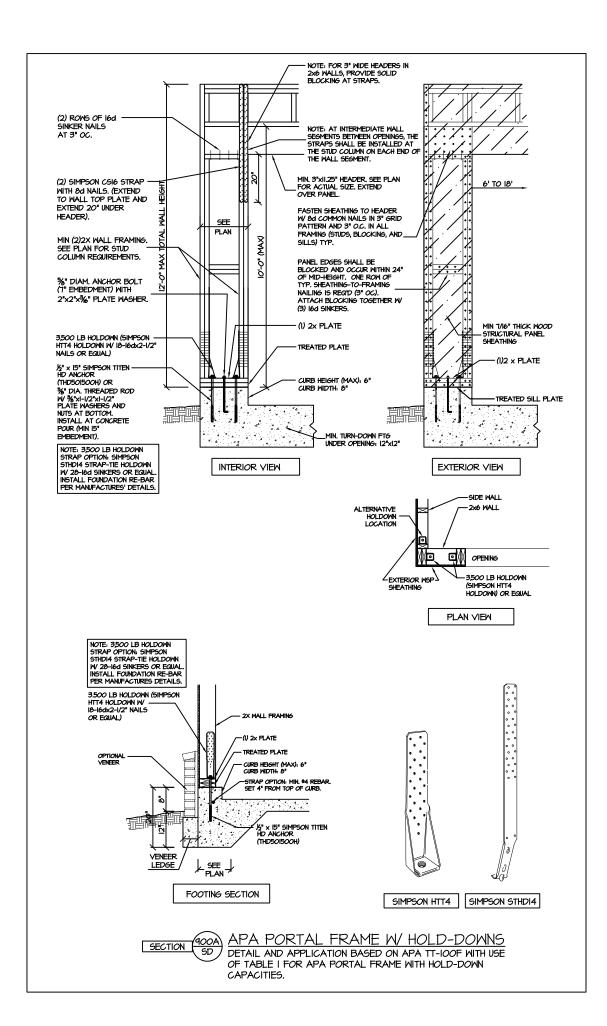

<u> CS-PF: END CONDITION DETAIL</u> (FOR USE WITH SINGLE CS-PF CONDITION) DETAIL AND APPLICATION BASED ON NORC FIGURE R602.IO.I - PORTAL FRAME CONSTRUCTION

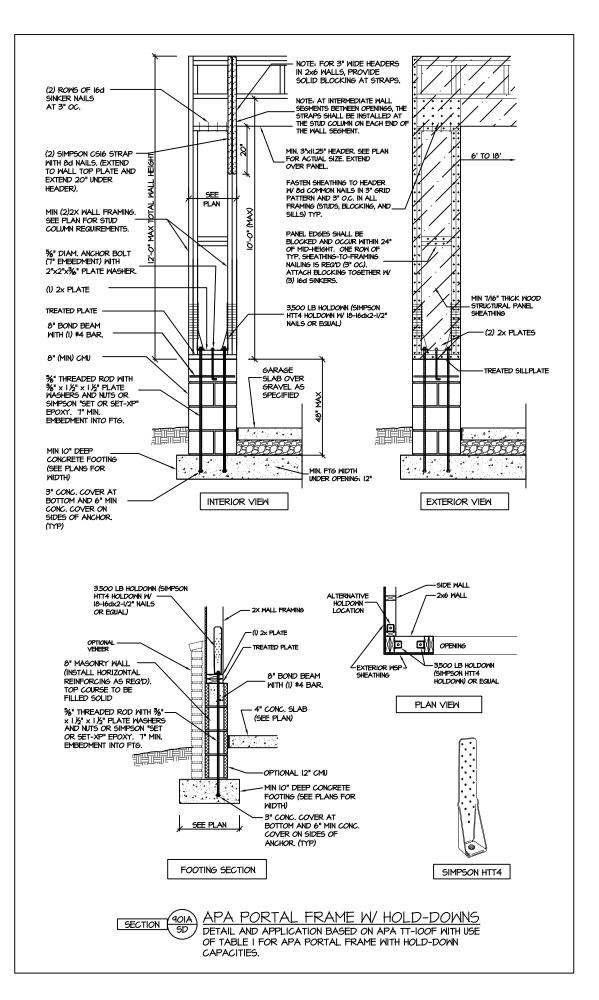

#### STRUCTURAL NOTES

NC (2018 NCRC): Wind: 115-120 mph

- I. ENGINEER'S SEAL APPLIES ONLY TO STRUCTURAL COMPONENTS INCLUDING ROOF RAFTERS, HIPS, VALLEYS, RIDGES, FLOORS, WALLS, BEAMS AND HEADERS, COLUMNS, CANTILEVERS, OFFSET LOAD BEARING WALLS, PIER & GIRDER SYSTEM, FOOTING, AND PILING SYSTEM. ENGINEER'S SEAL DOES NOT CERTIFY DIMENSIONAL ACCURACY OR ARCHITECTURAL LAYOUT INCLIDING ROOF SYSTEM. ALL REQUIREMENTS FOR PROFESSIONAL CERTIFICATION SHALL BE PROVIDED BY THE APPROPRIATE PROFESSIONAL. SOUTHERN ENGINEERS, P.A. CERTIFIES ONLY THE STRUCTURAL COMPONENTS AS SPECIFICALLY STATED
- ALL CONSTRUCTION SHALL CONFORM TO THE LATEST REQUIREMENTS OF THE 2018 NC RESIDENTIAL CODE, PLUS ALL LOCAL CODES AND REGULATIONS. THE STRUCTURAL ENGINEER IS NOT RESPONSIBLE FOR, AND WILL NOT HAVE CONTROL OF, CONSTRUCTION MEANS, METHODS, TECHNIQUES, SEQUENCES OR PROCEDURES, OR FOR SAFETY PRECAUTIONS AND PROGRAMS IN CONNECTION WITH THE CONSTRUCTION WORK, NOR WILL THE ENGINEER BE RESPONSIBLE FOR THE CONTRACTOR'S FAILURE TO CARRY OUT THE CONSTRUCTION WORK IN ACCORDANCE WITH THE CONTRACT DOCUMENTS, "CONSTRUCTION REVIEW" SERVICES ARE NOT PART OF OUR CONTRACT ALL MEMBERS SHALL BE FRAMED ANCHORED, TIED AND BRACED IN ACCORDANCE WITH 600D CONSTRUCTION PRACTICE AND THE BUILDING CODE.
- 3. DESIGN LOADS (LISTED AS: LIVE LOAD, DEAD LOAD, DEFLECTION)
- ROOMS OTHER THAN SLEEPING ROOMS: (40 PSF, IO PSF, L/360) SLEEPING ROOMS: (30 PSF, IO PSF, L/360)
- ATTIC WITH PERMANENT STAIR: (40 PSF, IO PSF, L/360)
- ATTIC WITHOUT PERMANENT STAIR: (20 PSF, I/0 PSF, L/360) ATTIC WITHOUT STORAGE: (10 PSF, I/0 PSF, L/240)
- STAIRS: (40 PSF, IO PSF, L/360)
  DECKS AND EXTERIOR BALCONIES: (40 PSF, IO PSF, L/360)
- PASSENGER VEHICLE GARAGES: (50 PSF, 10 PSF, L/360)
- SNOW: (20 PSF)
- MALLS SHALL BE BRACED BY SHEATHING WALLS ON ALL STORIES WITH MOOD STRUCTURAL PANELS. SEE FRAMING NOTES FOR THICKNESS AND NAILING REQUIREMENTS.
- 5. SEE APPENDIX M (DCA6) FOR EXTERIOR DECK REQUIREMENTS INCLUDING ATTACHMENTS FOR
- 6. CONCRETE SHALL HAVE A MINIMUM 26 DAY STRENGTH OF 3000 PSI AND A MAXIMUM SLUMP OF 5 INCHES UNLESS NOTED OTHERWISE (UNO). AIR ENTRAINED PER TABLE 402.2. ALL CONCRETE SHALL BE PROPORTIONED, MIXED, HANDLED, SAMPLED, TESTED, AND PLACED IN ACCORDANCE WITH ACI STANDARDS, ALL SAMPLES FOR PUMPING SHALL BE TAKEN FROM THE EXIT END OF THE PUMP. CONTROL JOINTS IN SLABS SHALL BE SPACED ON A GRID OF +30 TIMES THE DEPTH (D). CONTROL JOINTS SHALL BE SANCUT TO A DEPTH OF I/D. (I.E. 4" CONCRETE SLABS SHALL HAVE 1/4" DEEP CONTROL JOINTS SAWCUT IN SLAB ON A +-10'-0" x +-10'-0" GRID)
- ALLOWABLE SOIL BEARING PRESSURE ASSUMED TO BE 2000 PSF. THE CONTRACTOR MUST CONTACT A GEOTECHNICAL ENGINEER AND THE STRUCTURAL ENGINEER IF UNSATISFACTORY SUBSURFACE CONDITIONS ARE ENCOUNTERED. THE SURFACE AREA ADJACENT TO THE FOUNDATION WALL SHALL BE PROVIDED WITH ADEQUATE DRAINAGE, AND SHALL BE GRADED SO AS TO DRAIN SURFACE WATER AWAY FROM FOUNDATION WALLS.
- 8. ALL FRAMING LUMBER SHALL BE SPF #2 (Fb = 875 PSI) UNLESS NOTED OTHERWISE (UNO). ALL TREATED LUMBER SHALL BE SYP # 2. PLATE MATERIAL MAY BE SPF # 3 OR SYP #3 (Fc(perp) =
- q. L.V.L. SHALL BE LAMINATED VENEER LIMBER: Fb=2600 PSI, Fv=285 PSI, E=1.9xIO PSI.
  q.I. P.S.L. SHALL BE PARALLEL STRAND LIMBER: Fb=2400 PSI, Fv=240 PSI, E=2.0xIO PSI.
  q.2. L.S.L. SHALL BE LAMINATED STRAND LIMBER: Fb=2250 PSI, Fv=400 PSI, E=1.55xIO PSI. INSTALL ALL CONNECTIONS PER MANUFACTURERS INSTRUCTIONS.
- IO. ALL ROOF TRUSS AND I-JOIST LAYOUTS SHALL BE PREPARED IN ACCORDANCE WITH THE SEALED STRUCTURAL DRAWINGS. TRUSSES AND I-JOISTS SHALL BE INSTALLED ACCORDING TO THE MANUFACTURE'S SPECIFICATIONS. ANY CHANGE IN TRUSS OR I-JOIST LAYOUT SHALL BE COORDINATED WITH SOUTHERN ENGINEERS
- II. ALL STRUCTURAL STEEL SHALL BE ASTM A-36. STEEL BEAMS SHALL BE SUPPORTED AT EACH END WITH A MINIMUM BEARING LENGTH OF 3 1/2" INCHES AND FULL FLANGE MIDTH, PROVIDE SOLID BEARING FROM BEAM SUPPORT TO FOUNDATION. BEAMS SHALL BE ATTACHED TO EACH SUPPORT MITH TIMO LAG SCRENG (1/2" DIAMETER x 4" LONG). LATERAL SUPPORT 15 CONSIDERED ADEQUATE PROVIDING THE JOIST ARE TOE NAILED TO THE SOLE PLATE, AND SOLE PLATE IS NAILED OR BOLTED TO THE BEAM FLANGE @ 48" O.C. ALL STEEL TIBING SHALL BE ASTM A500.
- 12. REBAR SHALL BE DEFORMED STEEL, ASTM615, GRADE 60. LAP ALL REBAR SPLICES 30 BAR
- 13. FLITCH BEAMS SHALL BE BOLTED TOGETHER USING (2) ROWS OF 1/2" DIAMETER BOLTS (ASTM A325) MITH WASHERS PLACED INDER THE THREADED END OF BOLT. BOLTS SHALL BE SPACED AT 24" O.C. (MAX), AND STAGGERED AT THE TOP AND BOTTOM OF BEAM (2" EDGE DISTANCE),
- I4. BRICK LINTELS (WHEN REQUIRED) SHALL BE 3 I/2'x3 I/2'x1/4" STEEL ANGLE FOR UP TO 6'-0" SPAN AND 6'x4'x5/16" STEEL ANGLE WITH 6" LEG VERTICAL FOR SPANS UP TO 9'-0". SEE PLANS FOR SPANS OVER 9'-0". SEE ALSO SECTION RT03.8.3 LINTELS.

PROJECT # 21-2817

P.A. 27609

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