REVISION LOG

REVISION:001

ADJUST OPTION SQUARE FOOTAGES TO ACCURATELY SHOW THE DIFFERENCES FROM THE BASE PLAN SQUARE FOOTAGE TOTALS.

REVISION:002

- ADJUST OPTION SQUARE FOOTAGES TO ACCURATELY SHOW THE DIFFERENCES FROM THE BASE PLAN

- ADJUST OPTION SQUARE FOOTAGES TO ACCURATELY SHOW THE DIFFERENCES FROM THE SQUARE FOOTAGE TOTALS.

 EXTENDED TRIM AT GARAGE DOOR DOWN TO BASE AND CUT STONE BACK ADJUSTED KITCHEN ISLAND
 RESIZED THE FIREPLACE OPTION
 RELOCATED THE WINDOW IN THE MESSY KITCHEN TO BEHIND THE OPT. SINK CHANGED MESSY KITCHEN MINDOW TO OPTIONAL
- CHANGED MESSY KITCHEN WINDOW TO OPTIONAL ADDED CHASE TO OWNER'S WIC ADDED DIMS TO 0. BATH VANITY FOR CLARIFICATION REMOVED OPT. DOOR TO LOFT ADDED CHASE TO LOFT WIC RELOCATED LINEN IN THE 0. BATH OPTIONS

- 11. RELOCATED LINEN IN THE C. SAIT OF VIOLOGY
 12. REMOVED THE OPT. SUPER SHOWER (ZERO ENTRY)
 13. FLIPPED SWART DOOR DELIVERY DOOR HANDING
 14. CHANGED ALL LINEN CLOSETS TO HAVE ONLY 4 SHELVES
 15. CHANGED SIZE OF BASE SHOWER TO 60X36
 16. UPDATED OPTIONAL SQ. FTG. CHART
 17. REMOVED HALF WALLS AT KITCHEN ISLAND AND UPDATED PER CABINET PROVIDER
 18. EXTEND PORCH SLAB 4" AT FRONT AND EXTEND AROUND CORNER 20" TO SUPPORT STONE VENEER

 CHEN DESIGNATION OF THE PROVIDER OF THE PROVIDER STONE VENEER CONTROL OF THE PROVIDER STONE VENEER
- EXTEND PORCH SLAB 4" AROUND THE PERIMETER AT THE 'CRAFTSMAN' ELEVATION

DATE: 3/30/2022

- EXTEND PORCH SLAB 4" AROUND THE PERIMETER AT THE 'CRAFTSMAN' ELEVATION ADDED A COLUMN DETAIL FOR CLARITY ON THE 'CRAFTSMAN' ELEVATION ADDED A SEPARATE OPTION FOR THE POCKET OFFICE WITH THE SMART DELIVERY DOOR ADDED A SEP

DATE: 7/22/2022

REVISION:004 DATE: 6/20/2022

ADD SIDE LOAD GARAGE.

REVISION:005

ADD STEM WALL SLAB FOUNDATION SHEETS
CORRECT OPTIONAL SMART DELIVERY DOOR LOCATION ON FOUNDATION PLANS TO
MATCH FLOOR PLAN.

REVISION:006

- Changed 48X42 Shower to 42X42.

 Added Side Load Garage Foundation for extended Cafe Option.

 Updated Square Footage Chart to Add extended Patio to the extended Cafe
- 4. MOVED WATER HEATER TO INNER CORNER FOR ALL SIDE LOAD OPTIONS.

Redlines Completed 24-May - DP

Lot 22 - Heritage at Neills Creek

119 Whistling Way Lillington, NC 27546

NC.



DESIGN CRITERIA:

THIS PLAN IS TO BE BUILT IN CONFORMANCE WITH THE 2018 NORTH CAROLINA STATE BUILDING CODE: RESIDENTIAL CODE

DIMENSIONS SHALL GOVERN OVER SCALE, AND CODE SHALL GOVERN OVER DIMENSIONS.

> Heated: 2.459 Total Unheated: 698

PLAN 2 The Holly - RH 'CRAFTSMAN' ELEVATION

Sheet No.	Sheet Description
	·
0.0	Cover Sheet
1.1	Foundation (Slab)
1.1.1	Foundation Options (Slab)
1.1.2	Foundation Options (Slab)
1.2	Foundation (Crawl)
1.2.1	Foundation Options (Crawl)
1.2.2	Foundation Options (Crawl)
1.3	Foundation (Stem Wall Slab)
1.3.1	Foundation Options (Stem Wall Slab)
1.3.2	Foundation Options (Stem Wall Slab)
2.1	First Floor Plan
2.1.1	First Floor Plan Options
2.2	Second Floor Plan
2.2.1	Second Floor Plan Options
2.4	Covered Porch Plans & Elevations (Slab)
2.4.1	Covered Porch Plans & Elevations (Crawl/Stem Wall)
2.5	Covered Porch w/ Extended Cafe Plans & Elevations (Slab)
2.5.1	Covered Porch w/ Extended Cafe Plans & Elevations (Crawl/ Stem Wal
2.6	Extended Cafe Plans & Elevations (Slab)
2.6.1	Extended Cafe Plans & Elevations (Crawl/ Stem Wall)
2.7	2-Car Sideload Garage Plans
2.7.1	2-Car Sideload Garage Elevations
3.1	Front & Rear Elevations (Slab)
3.1.1	Front & Rear Elevations (Crawl/ Stem Wall)
3.2	Side Elevations (Slab)
3.2.1	Side Elevations (Crawl/ Stem Wall)
3.3	Roof Plan
5.1	First Floor Electrical
5.1.1	First Floor Options Electrical
5.2	Second Floor Electrical
5.2.1	Second Floor Options Electrical

	SQUARE	FOOTA	4GE]
		CRAFT	SMAN	1
		UNHEATED	HEATED	1
	FIRST FLOOR	0	872	
	SECOND FLOOR	0	1345	
	FRONT PORCH	131	0	
	2 CAR GARAGE	437	0	
_	PATIO	100	0	
	SUBTOTALS	731	2217	
	TOTAL UNDER ROOF	29	48	
	Ol	PTIONS		
	OF	PTIONS UNHEATED S.F.	HEATED S.F.	
_	OF		HEATED S.F.	
_	0.01/5050 0.170	UNHEATED S.F.		Covered Patio
_ 	COVERED PATIO EXTENDED CAFE w/	UNHEATED S.F.	0	Covered Patio
-	EXTENDED CAFE W/ PATIO	UNHEATED S.F. 160 +148	+152	Covered Patio
	COVERED PATIO EXTENDED CAFE W/ PATIO REAR FOCKET OFFICE	UNHEATED S.F. 160 +148	+152 +00	Covered Patio
	EXTENDED CAFE W/ PATIO REAR POCKET OFFICE FRONT POCKET OFFICE FRONT PORCH W/	UNHEATED S.F. 160 +148 0	+152 +60 +39	Covered Patio



 1	2	3	4	2	9	7	8


Cover Sheet 'Craftsman' THE HOLLY

- RH

South Designs ISSUE DATE: 7/1/2021 CURRENT REVISION DATE

1/8" = 1'-0"

SCALE:

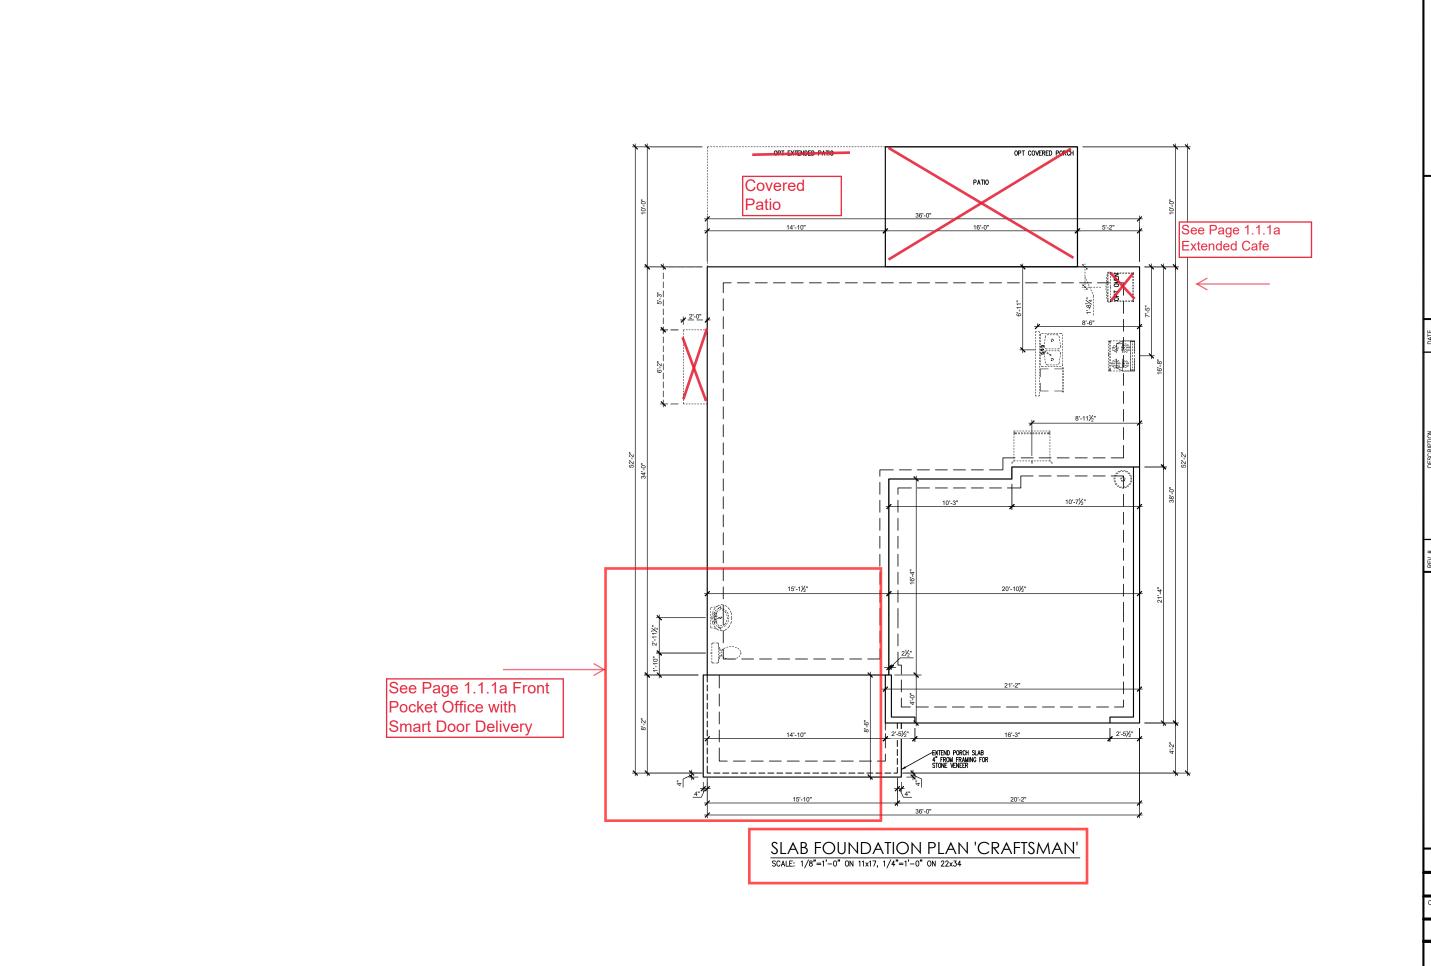

1	REFER TO COVER SHEET	11/22/2021
2	REFER TO COVER SHEET	2/4/2022
3	REFER TO COVER SHEET	3/30/2022
4	-	
5	-	
9	-	
7	-	
8	-	

PLAN 2 - THE HOLLY - RH ---

Foundation Slab 'Craftsman'


DRAWN BY: South Design


ISSUE DATE:
7/1/2021

CURRENT REVISION DATE:

SCALE: 1/8" = 1'-0"

1.Îa

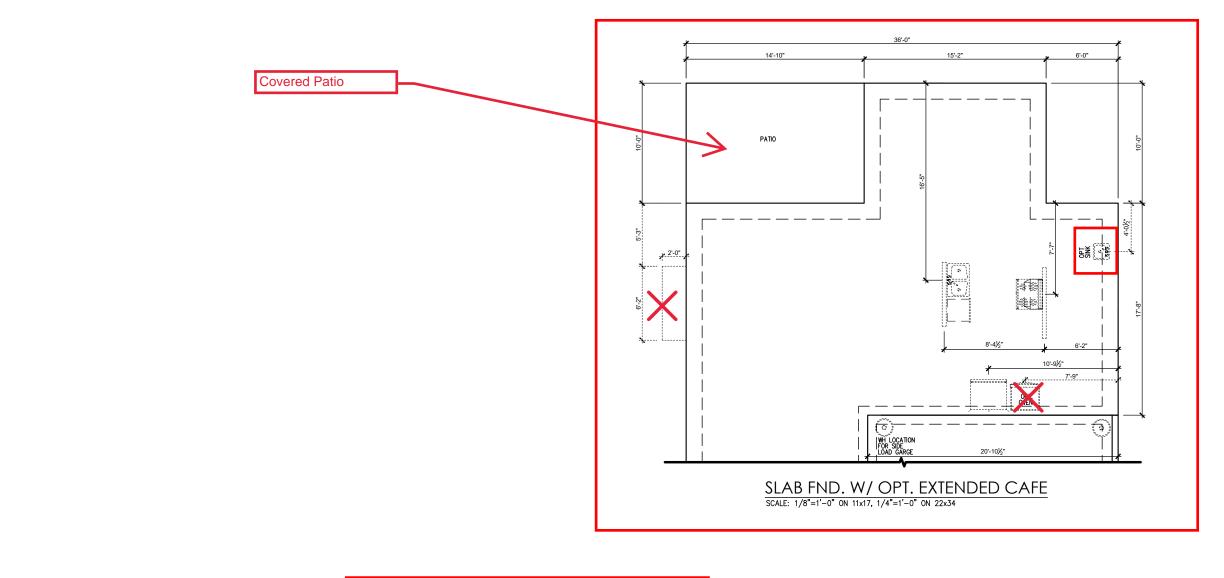

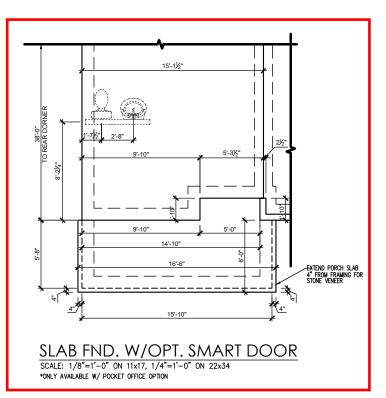

REV. # DESCRIPTION	-		7	 9	'Craffeman' 7	8
	HOLLA		! !		Ontions Slab 'Craffeman	uons sino


DRAWN BY: South Designs

ISSUE DATE:

CURRENT REVISION DATE SCALE: 1/8" = 1'-0"

General Floor Plan Notes shall apply unless noted otherwise on plan.

- Wall Heights: Typically 9'-1 1/2" at first floor and 8'-1 1/2" at second floor and attics U.N.O. All walls are constructed using a double top pidne. Splices at Double Top Pidne do not need to occur at Vertical Studs but must be at least 24" apart from Joint in other Top Pidne layer. Special wall heights are noted on plans where they occur.
- Wall Thickness is typically 3 1/2". 2x6 frame shall be used at walls that back up to plumbing fixtures.
 Walls greater than 10' high shall be framed with 2x6 framing or greater and will be noted as a special condition where it occurs on plan.
- Typical header height shall be 6'-11" AFF at First Floor, and 6'-11" AFF at Second Floor U.N.O. on elevation drawings. Windows at front elevation may be higher at the first floor.
- Jacks: Openings up to 3'-4" wide shall have (1) 2x4 jack stud SPF on each side. Openings greater than 3'-4" wide shall have (2) 2x4 jack studs SPF on each side.
- Soffits, Coffered Ceilings, Trey Ceilings and other significant ceiling plan elements are shown on the floor plans and are denoted as single dashed lines. Unless specifically call out as included, Kitchens do not include soffits over wall cabinetry.
- Door & Window Frames, where occurring near corners, shall be a minimum of 4 1/2" from corner. Except for walk-in closets with doors near a corner, doors at closets shall be centered on closet.
- Windows: Shall have at least (1) window in each sleeping room, that meets egress. Shall be provided with tempered glass at hazardous glazing areas. False windows shall be installed with obscure alazina.
- Closets for clothing or coat storage shall be equipped with 1 rod/shelf. Closets for linen shall have 4 open equal shelves. Closets for panties shall have 4 equal wood shelves, painted.
- Stair treads shall be a min of 9" deep, risers shall be a maximum of 8 1/4", unless noted otherwise, per the current North Carolina Residential Code
- 10. Handrails and Guards at stairs shall be 34" above the finished surface of the ramp surface of the stair. Handrails at landings and overlooks of multilevel spaces shall be 36" above finished floor. Guards (pickets or balusters) shall be spaced with no more than 4" between guards.
- 11.Attic Access shall be provided at all attic area with a height greater than 30". Minimum clear attic access shall be 20" x 30". Pull down stairs and access doors in knee walls meeting minimum criteria are also acceptable.
- 12.Garage Door to Living Space shall be 2'-8" x 6'-8" minimum size and shall be 20 minute fire rated and weather sealed.
- 13. Garage Walls, as a minimum, shall be separated from living space by installing 1/2" gypsum board on the garage side of the wall. With habitable space above, the inside of all garage walls require 1/2" GWB supporting 5/8" type X GWB on ceiling.

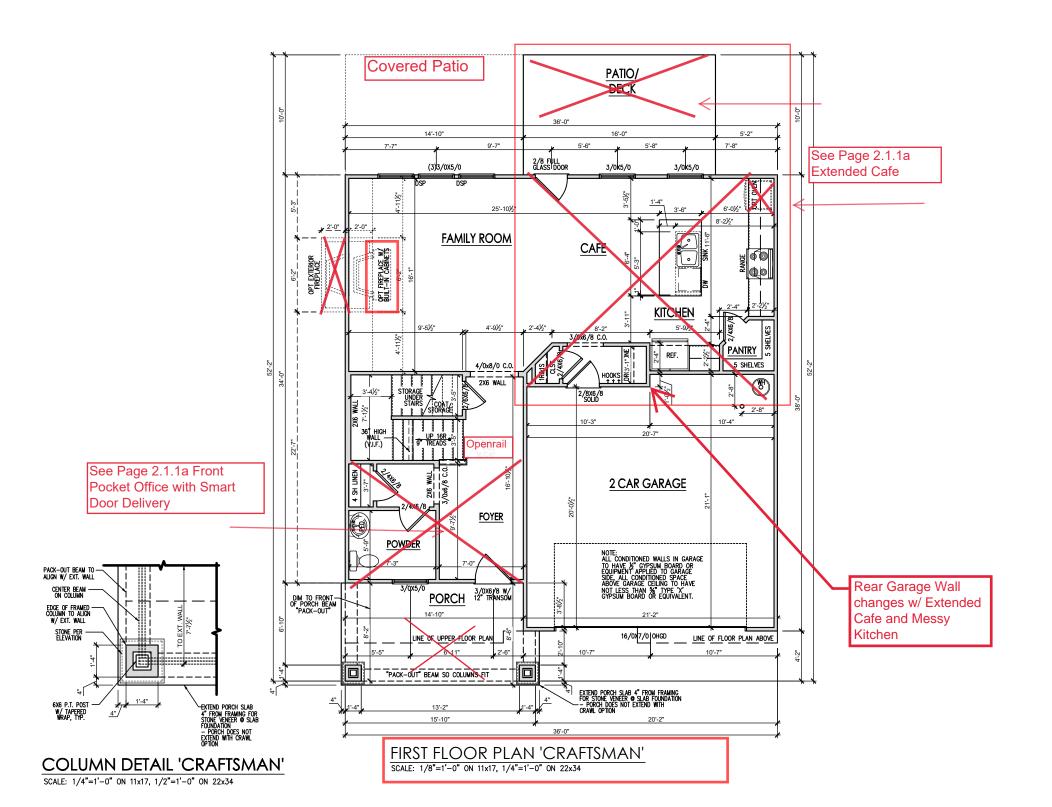

RH

.

THE HOLLY

~

PLAN

DRAWN BY:

ISSUE DATE:
7/1/2021

UURRENT REVISION DATE
SCALE:
1/8" = 1'-0"

SHEET

SHEET

South Designs

'Craftsman'


Plan

Floor]

First


General Floor Plan Notes shall apply unless noted otherwise on plan.

- Wall Heights: Typically 9°-1 1/2" at first floor and 8'-1
 1/2" at second floor and attics U.N.O. All walls are
 constructed using a double top plate. Splices at
 Double Top Plate do not need to occur at Vertical
 Studs but must be at least 24" apart from Joint in
 other Top Plate layer. Special wall heights are noted
 on plans where they occur.
- Wall Thickness is typically 3 1/2". 2x6 frame shall be used at walls that back up to plumbing fixtures.
 Walls greater than 10' high shall be framed with 2x6 framing or greater and will be noted as a special condition where it occurs on plan.
- Typical header height shall be 6'-11" AFF at First Floor, and 6'-11" AFF at Second Floor U.N.O. on elevation drawings. Windows at front elevation may be higher at the first floor.
- Jacks: Openings up to 3'-4" wide shall have (1) 2x4
 jack stud SPF on each side. Openings greater than
 3'-4" wide shall have (2) 2x4 jack studs SPF on each
 side
- Soffits, Coffered Ceilings, Trey Ceilings and other significant ceiling pian elements are shown on the floor pians and are denoted as single dashed lines. Unless specifically call out as included, Kitchens do not include soffits over wall cabinety.
- Door & Window Frames, where occurring near corners, shall be a minimum of 4 1/2" from corner. Except for walk-in closets with doors near a corner, doors at closets shall be centered on closet.
- Windows: Shall have at least (1) window in each sleeping room, that meets egress. Shall be provided with tempered glass at hazardous glazing areas. False windows shall be installed with obscure glazing.
- Closets for clothing or coat storage shall be equipped with 1 rod/shelf. Closets for linen shall have 4 open equal shelves. Closets for pontries shall have 4 equal wood shelves, painted.
- Stair treads shall be a min of 9" deep, risers shall be a maximum of 8 1/4", unless noted otherwise, per the current North Carolina Residential Code
- 10. Handrails and Guards at stairs shall be 34" above the finished surface of the ramp surface of the stair. Handrails at landings and overlooks of multilevel spaces shall be 36" above finished floor. Guards (pickets or balusters) shall be spaced with no more than 4" between guards.
- 11. Attic Access shall be provided at all attic area with a height greater than 30". Minimum clear attic access shall be 20" x 30". Pull down stairs and access doors in knee walls meeting minimum criteria are also acceptable.
- 12. Garage Door to Living Space shall be 2'-8" x 6'-8" minimum size and shall be 20 minute fire rated and weather sealed.
- 13. Garage Walls, as a minimum, shall be separated from living space by installing 1/2" gypsum board on the garage side of the wall. With habitable space above, the inside of all garage walls require 1/2" GWB supporting 5/8" type X GWB on ceiling.

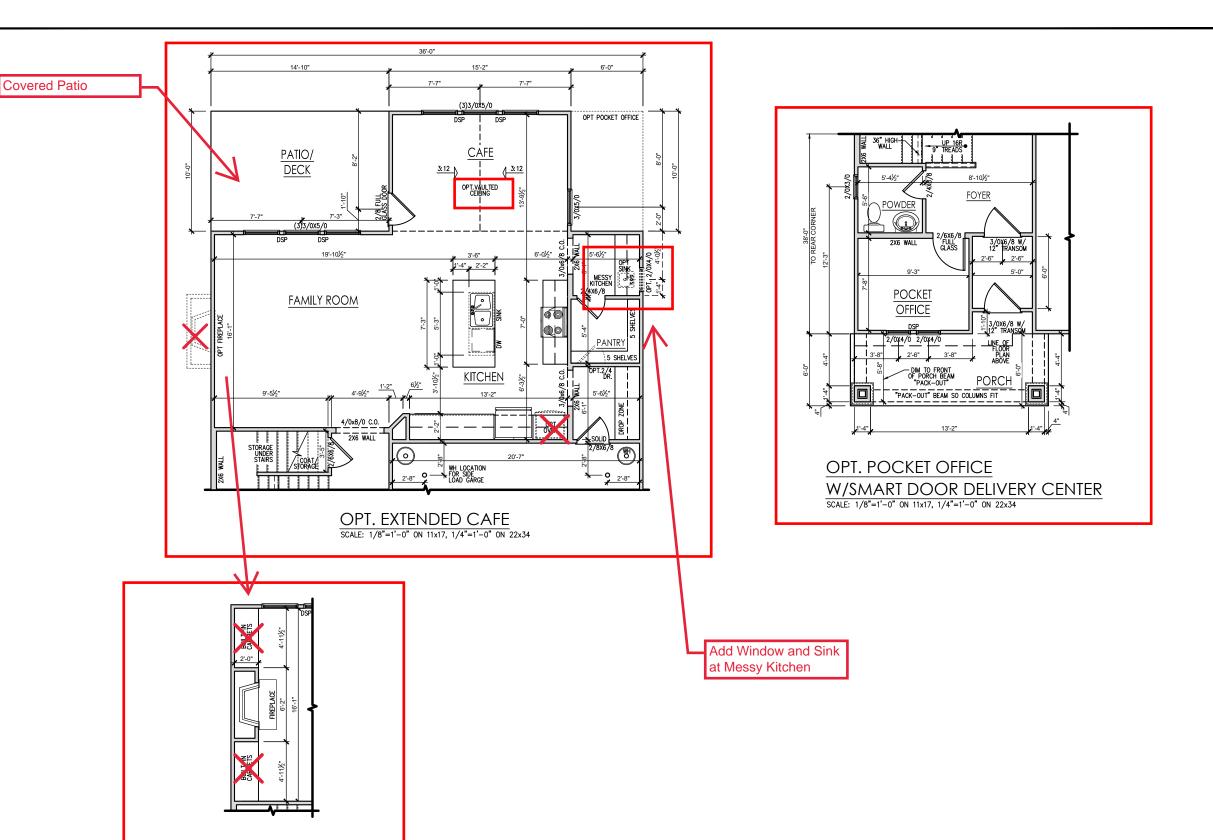

OPT. INTERIOR FIREPLACE
SCALE: 1/8"=1'-0" ON 11x17, 1/4"=1'-0" ON 22x34

MOH C.

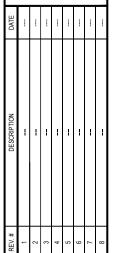

THE HOLLY - RH
--First Floor Plan Options 'Craftsman'

DRAWN BY: South Designs


ISSUE DATE: 7/1/2021

CURRENT REVISION DATE:
---SCALE:
1/8" = 11.0"

2 1 1 a

General Floor Plan Notes shall apply unless noted otherwise on plan.

- Wall Heights: Typically 9'-1 1/2" at first floor and 8'-1 1/2" at second floor and attics U.N.O. All walls are constructed using a double top pidne. Splices at Double Top Pidne do not need to occur at Vertical Studs but must be at least 24" apart from Joint in other Top Pidne layer. Special wall heights are noted on plans where they occur.
- Wall Thickness is typically 3 1/2". 2x6 frame shall be used at walls that back up to plumbing fixtures.
 Walls greater than 10' high shall be framed with 2x6 framing or greater and will be noted as a special condition where it occurs on plan.
- Typical header height shall be 6'-11" AFF at First Floor, and 6'-11" AFF at Second Floor U.N.O. on elevation drawings. Windows at front elevation may be higher at the first floor.
- Jacks: Openings up to 3'-4" wide shall have (1) 2x4 jack stud SPF on each side. Openings greater than 3'-4" wide shall have (2) 2x4 jack studs SPF on each side.
- 5. Soffits, Coffered Ceilings, Trey Ceilings and other significant ceiling plan elements are shown on the floor plans and are denoted as single dashed lines. Unless specifically call out as included, Kitchens <u>do</u> <u>not</u> include soffits over wall cabinetry.
- Door & Window Frames, where occurring near corners, shall be a minimum of 4 1/2" from corner. Except for walk-in closets with doors near a corner, doors at closets shall be centered on closet.
- Windows: Shall have at least (1) window in each sleeping room, that meets egress. Shall be provided with tempered glass at hazardous glazing areas. False windows shall be installed with obscure glazing.
- Closets for clothing or coat storage shall be equipped with 1 rod/shelf. Closets for linen shall have 4 open equal shelves. Closets for pantries shall have 4 equal wood shelves, painted.
- Stair treads shall be a min of 9" deep, risers shall be a maximum of 8 1/4", unless noted otherwise, per the current North Carolina Residential Code
- 10. Handrails and Guards at stairs shall be 34" above the finished surface of the ramp surface of the stair. Handrails at landings and overlooks of multilevel spaces shall be 36" above finished floor. Guards (pickets or balusters) shall be spaced with no more than 4" between guards.
- 11.Attic Access shall be provided at all attic area with a height greater than 30". Minimum clear attic access shall be 20" x 30". Pull down stairs and access doors in knee walls meeting minimum criteria are also acceptable.
- 12.Garage Door to Living Space shall be 2'-8" x 6'-8" minimum size and shall be 20 minute fire rated and weather sealed.
- 13. Garage Walls, as a minimum, shall be separated from living space by installing 1/2" gypsum board on the garage side of the wall. With habitable space above, the inside of all garage walls require 1/2" GWB supporting 5/8" type X GWB on ceiling.

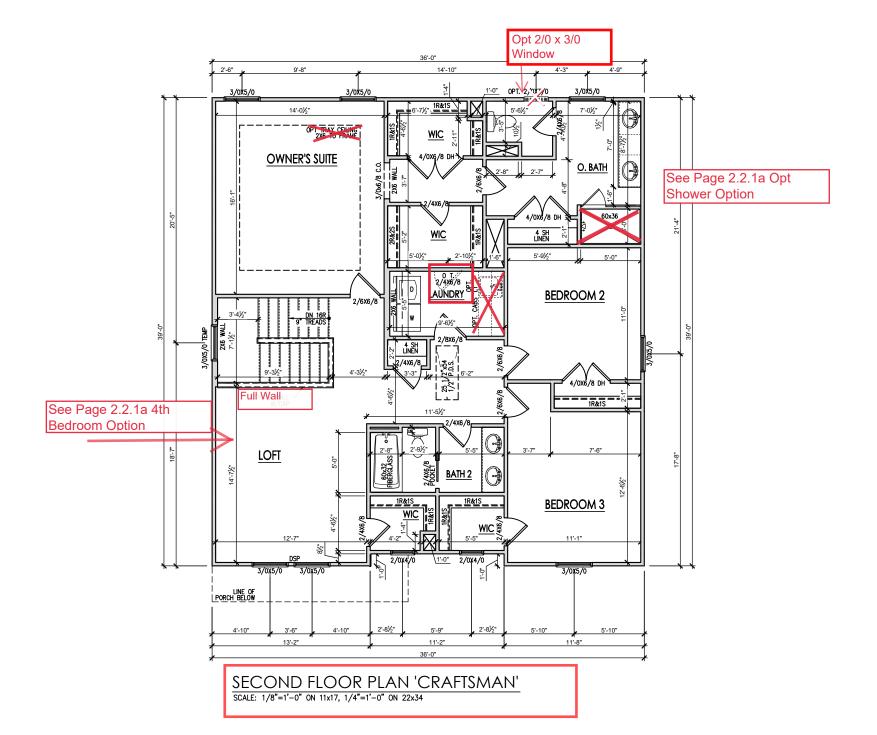



DATE	11/22/2021	2/4/2022	3/30/2022					
DESCRIPTION	REFER TO COVER SHEET	REFER TO COVER SHEET	REFER TO COVER SHEET	-	-	-	1	-
REV.#	-	2	3	4	2	9	7	8

PLAN 2 - THE HOLLY

Second Floor Plan 'Craftsman'

RH

DRAWN BY: South Designs ISSUE DATE:


7/1/2021 CURRENT REVISION DATE:


> SCALE: 1/8" = 1'-0"

2.2a

General Floor Plan Notes shall apply unless noted otherwise on plan.

- Wall Heights: Typically 9°-1 1/2" at first floor and 8'-1 1/2" at second floor and attics U.N.O. All walls are constructed using a double top plate. Splices at Double Top Plate do not need to occur at Vertical Studs but must be at least 24" apart from Joint in other Top Plate layer. Special wall heights are noted on plans where they occur.
- Wall Thickness is typically 3 1/2". 2x6 frame shall be used at walls that back up to plumbing fixtures. Walls greater than 10' high shall be framed with 2x6 framing or greater and will be noted as a special condition where it occurs on plan.
- Typical header height shall be 6'-11" AFF at First Floor, and 6'-11" AFF at Second Floor U.N.O. on elevation drawings. Windows at front elevation may be higher at the first floor.
- Jacks: Openings up to 3'-4" wide shall have (1) 2x4
 jack stud SPF on each side. Openings greater than
 3'-4" wide shall have (2) 2x4 jack studs SPF on each
 side.
- Soffits, Coffered Ceilings, Trey Ceilings and other significant ceiling plan elements are shown on the floor plans and are denoted as single dashed lines. Unless specifically call out as included, Kitchens do not include soffits over wall cabinety.
- Door & Window Frames, where occurring near corners, shall be a minimum of 4 1/2" from corner. Except for walk-in closets with doors near a corner, doors at closets shall be centered on closet.
- Windows: Shall have at least (1) window in each sleeping room, that meets egress. Shall be provided with tempered glass at hazardous glazing areas. False windows shall be installed with obscure glazing.
- Closets for clothing or coat storage shall be equipped with 1 rod/shelf. Closets for linen shall have 4 open equal shelves. Closets for panties shall have 4 equal wood shelves, painted.
- Stair treads shall be a min of 9" deep, risers shall be a maximum of 8 1/4", unless noted otherwise, per the current North Carolina Residential Code
- 10. Handrails and Guards at stairs shall be 34" above the finished surface of the ramp surface of the stair. Handrails at landings and overlooks of multillevel spaces shall be 36" above finished floor. Guards (pickets or balusters) shall be spaced with no more than 4" between guards.
- 11. Attic Access shall be provided at all attic area with a height greater than 30". Minimum clear attic access shall be 20" x 30". Pull down stairs and access doors in knee walls meeting minimum criteria are also acceptable.
- 12. Garage Door to Living Space shall be 2'-8" x 6'-8" minimum size and shall be 20 minute fire rated and weather sealed.
- 13. Garage Walls, as a minimum, shall be separated from living space by installing 1/2" gypsum board on the garage side of the wall. With habitable space above, the inside of all garage walls require 1/2" GWB supporting 5/8" type X GWB on ceiling.

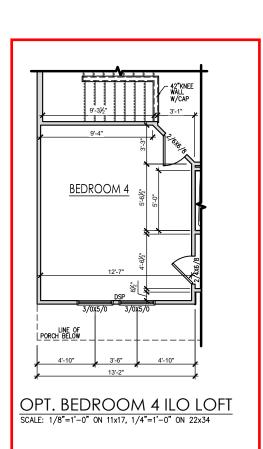

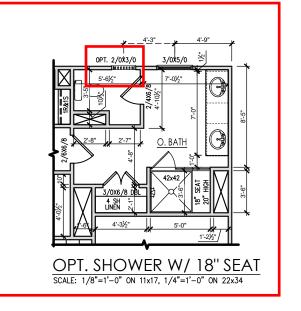

ZNEW ZHOME

DATE									
DESCRIPTION			-	-	-	-	-		
REV.#	1	2	3	7	9	9	2	8	

THE HOLLY - RH --- Second Floor Plan Options 'Craftsman'


DRAWN BY: South Designs

ISSUE DATE: 7/1/2021

CURRENT REVISION DATE:

1/8" = 1'-0" SHEET

 2.2^{SHEET}

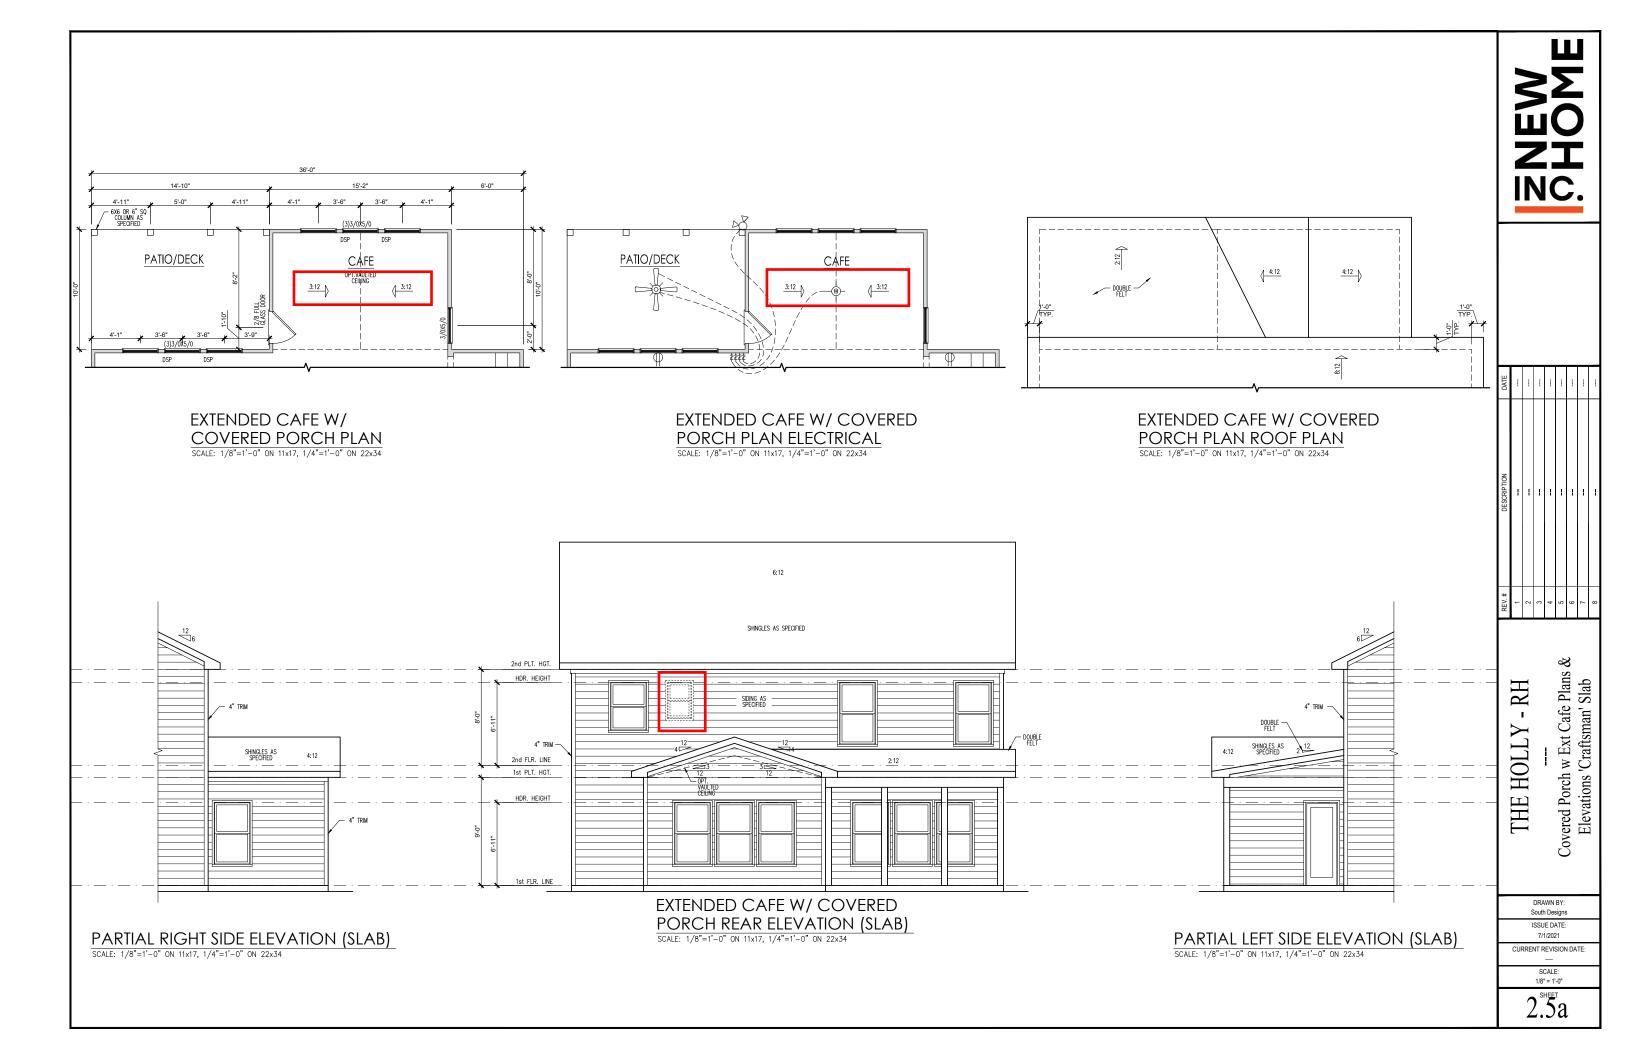

General Elevation Notes

General Elevation Notes shall apply unless


- Roof shall be finished with architectural composition shingles with slopes as noted on plan.
- Ridge Vent shall be provided and installed on all ridges greater than 6' in length per manufacturer's specifications.
- 3. Soffit Vent shall be continuous soffit vent
- House Wrap, "tyvek" or approved equal shall be installed over entire exterior wall per manufacturer's specifications and recommendations
- Flashing shall be provided above all door and window openings, above finish wall material changes and at wall surfaces where lower roof areas abut vertical wall surfaces.
- Porch Railings shall be provided at all porch walking surfaces greater than 30" above adjacent finished grade. It shall be 36" high with guards spaced no more than 4" apart. Consult community specifications for material.
- Finish Wall Material shall be as noted on elevation drawings.
- 8. Brick Veneer, if included on elevation shall be tied to wall surface with galvanized corrugated metal ties at a rate of 24" oc horizontally and 16" oc vertically so that no more than 2.67st of brick is supported by (1) tie. Space between face of wall and back face of brick shall be limited to a maximum of 1". Flashing shall be provided behind brick above all wall openings and at base of brick wall. Flashing shall be a minimum of 6-mil poly or other corrosion resistant material and shall be installed so that it laps under the house wrap material a minimum of 2".


 Weepholes shall be provided at a rate of 48" oc and shall not be less than 3/16" in diameter and shall be located immediately above (fashing. located immediately above flashing
- Brick Veneer Support Lintels shall be provided if brick veneer is included on elevation. Lintels shall be provided as listed in the following schedule and shall have a minimum bearing length of 6". Masonry Lintels shall be provided so that deflection is limited to 1/600.

Masonry Opening Lintel Schedule

Opening Size Angle

up to 4'-0'		3-1/2" x 3-1/2" x 5/16"
4'-1" to	5'-6"	4" x 3-1/2" x 5/16" LLV
5'-7" to	6'-6"	5" x 3-1/2" x 5/16" LLV
6'-7" to	8'-4"	6" x 3-1/2" x 5/16" LLV
8'-5" to	16'-4"	7" x 4" x 3/8" LLV

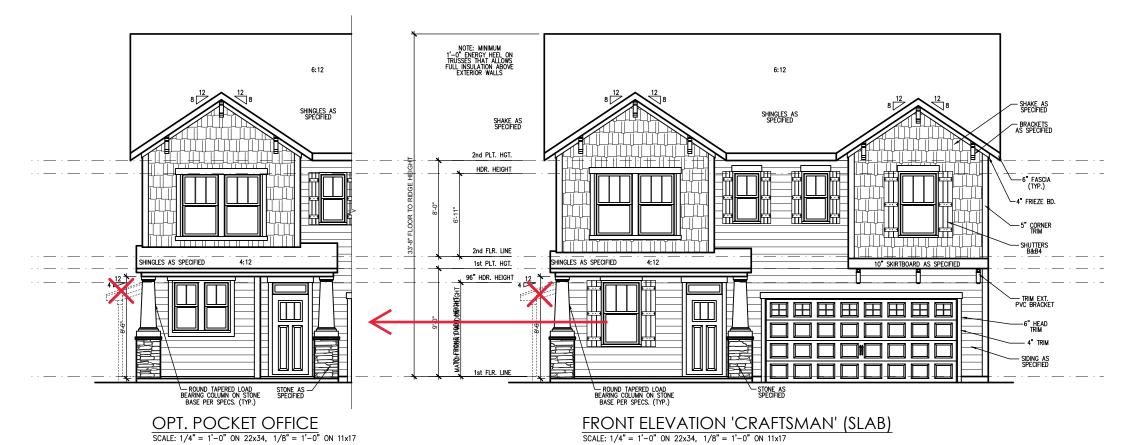

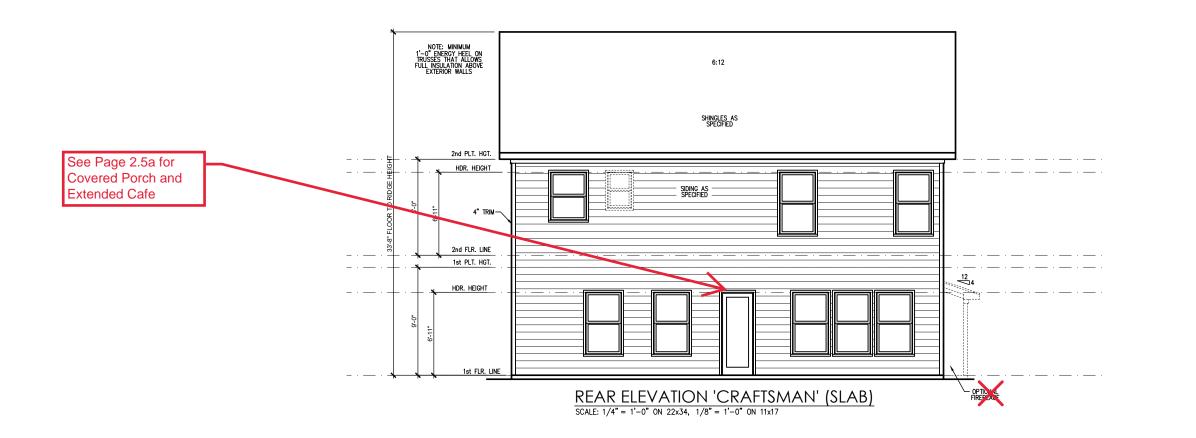



_	_							
DATE	-	1	ı					
DESCRIPTION		-	-	-		-	-	
REV.#	1	2	3	4	9	9	7	8
							ah	

& Rear Elevations 'Craftsman' Sl - RH THE HOLLY

> DRAWN BY: South Designs

Front

ISSUE DATE: 7/1/2021

CURRENT REVISION DATE: SCALE: 1/8" = 1'-0"

3.1a

General Elevation Notes


General Elevation Notes shall apply unless noted otherwise on plan.


- Roof shall be finished with architectural composition shingles with slopes as noted on plan.
- Ridge Vent shall be provided and installed on all ridges greater than 6' in length per manufacturer's specifications.
- 3. Soffit Vent shall be continuous soffit vent
- House Wrap, "tyvek" or approved equal shall be installed over entire exterior wall per manufacturer's specifications and recommendations.
- Flashing shall be provided above all door and window openings, above finish wall material changes and at wall surfaces where lower roof areas abut vertical wall surfaces.
- Porch Raillings shall be provided at all porch walking surfaces greater than 30" above adjacent finished grade. It shall be 36" high with guards spaced no more than 4" apart. Consult community specifications for material.
- 7. Finish Wall Material shall be as noted on elevation drawings
- 8. Brick Veneer, if included on elevation shall be fied to wall surface with galvanized corrugated metal ties at a rate of 24" oc horizontally and 16" oc vertically so that no more than 2.67s of brick is supported by (1) fie. Space between face of wall and back face of brick shall be limited to a maximum of 1". Flashing shall be provided behind brick above all wall openings and at base of brick wall. Flashing shall be a minimum of 6-mil poly or other corrosion resistant material and shall be installed so that it laps under the house wrap material a minimum of 2". Weepholes shall be provided at a rate of 48" oc and shall not be less than 3/16" in diameter and shall be located immediately above flashing.
- Brick Veneer Support Lintels shall be provided if brick veneer is included on elevation. Lintels shall be provided as listed in the following schedule and shall have a minimum bearing length of 6". Masonry Lintels shall be provided so that deflection is limited to 1/600.

Masonry Opening Lintel Schedule


Size	Angl
	Size

up to 4'-0" 3-1/2" x 3-1/2" x 5/16" 4'-1" to 5'-6" 4" x 3-1/2" x 5/16" LLV 5'-7" to 6'-6" 5" x 3-1/2" x 5/16" LLV 6'-7" to 8'-5" to 16'-4" 7" x 4" x 3/8" LLV

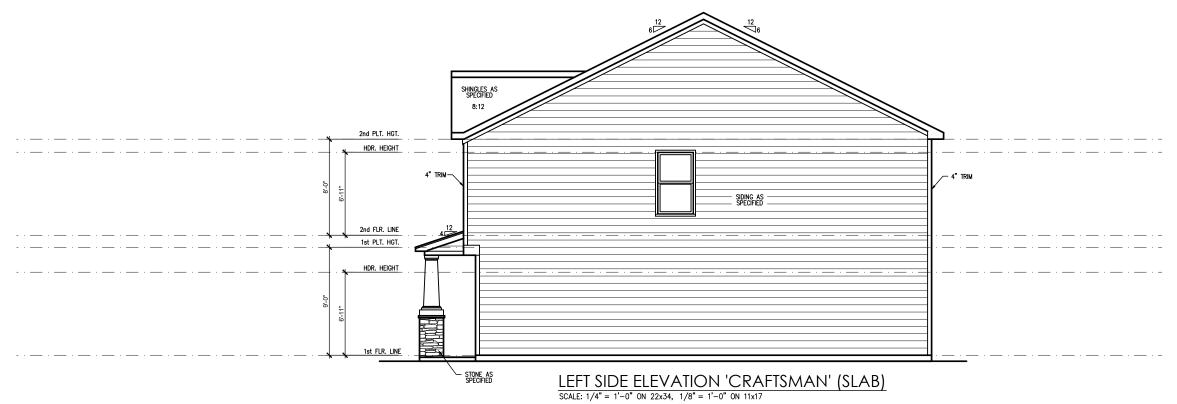

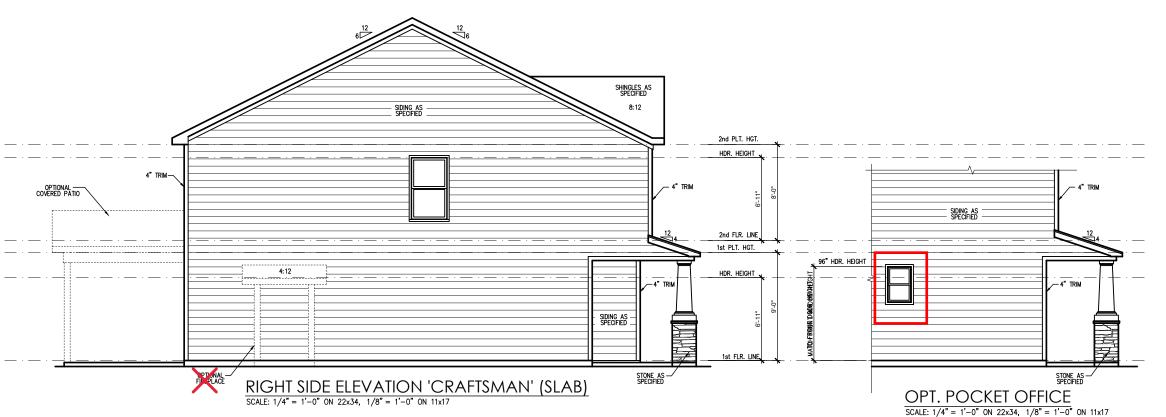



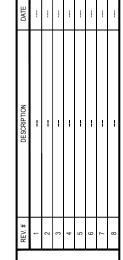


THE HOLLY - RH
--Side Elevations 'Craftsman' Slab

DRAWN BY: South Designs ISSUE DATE: 7/1/2021

CURRENT REVISION DATE:
---SCALE:
1/8" = 1'-0"

3.2a

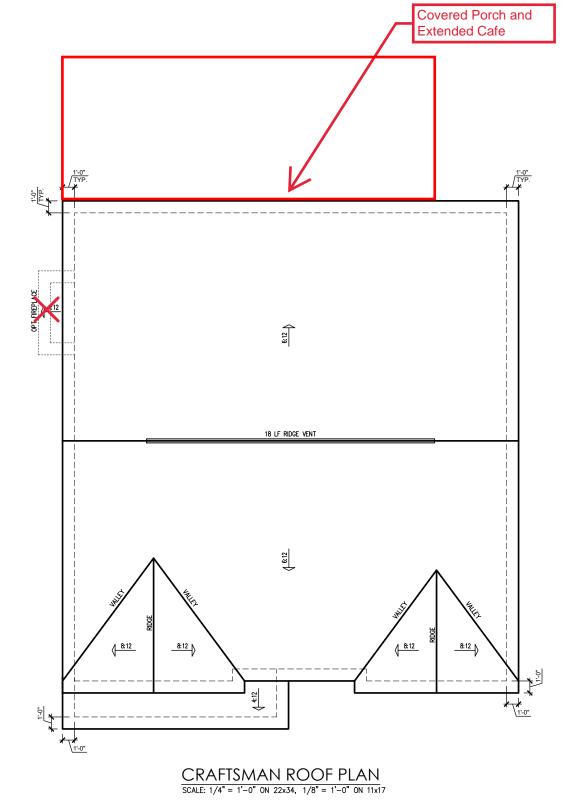

	ATTIC VENT SCHEDULE														
	CRAFTSMAN														
MAIN	MAIN HOUSE SQ FTG 1393 AT / NEAR RIDGE AT / NEAR EAVE														
VENT TYPE		. FT. JIRED	SQ. FT.	PERCENT OF TOTAL	POT LARGE (SQ. FT. EACH)	POT SMALL (SQ. FT. EACH)	RIDGE VENT (SQ. FT. PER LF)	EAVE VENT (SQ. IN. EACH)	CONT. VENT (SQ. IN. PER LF)						
		\GE	SUPPLIED	SUPPLIED	0.4236	0.2778	0.125	0.1944	0.0625						
RIDGE VENT	RIDGE VENT 1.86 2.32 3.00 44.44 0 0 24.00														
SOFFIT VENTS	2.79	2.32	3.75	55.56	0 60.00										
TOTAL (MIN) 4,64 4,64 6,75 100,00 POT VENTS MAY BE REQUIRED IF THERE IS INSUFFICIENT RIDGE AVAILABLE															

* SCHEDULE HAS BEEN CALCULATED ASSUMING EAVE VENTILATION AT 50-60% OF TOTAL AND RIDGE AT 40-50% OF TOTAL REQUIRED VENTILATION


THE HOLLY - RH
--Roof Plan 'Craftsman'

DRAWN BY: South Designs

ISSUE DATE: 7/1/2021

CURRENT REVISION DATE:
---SCALE:
1/8" = 1'-0"

3.3a

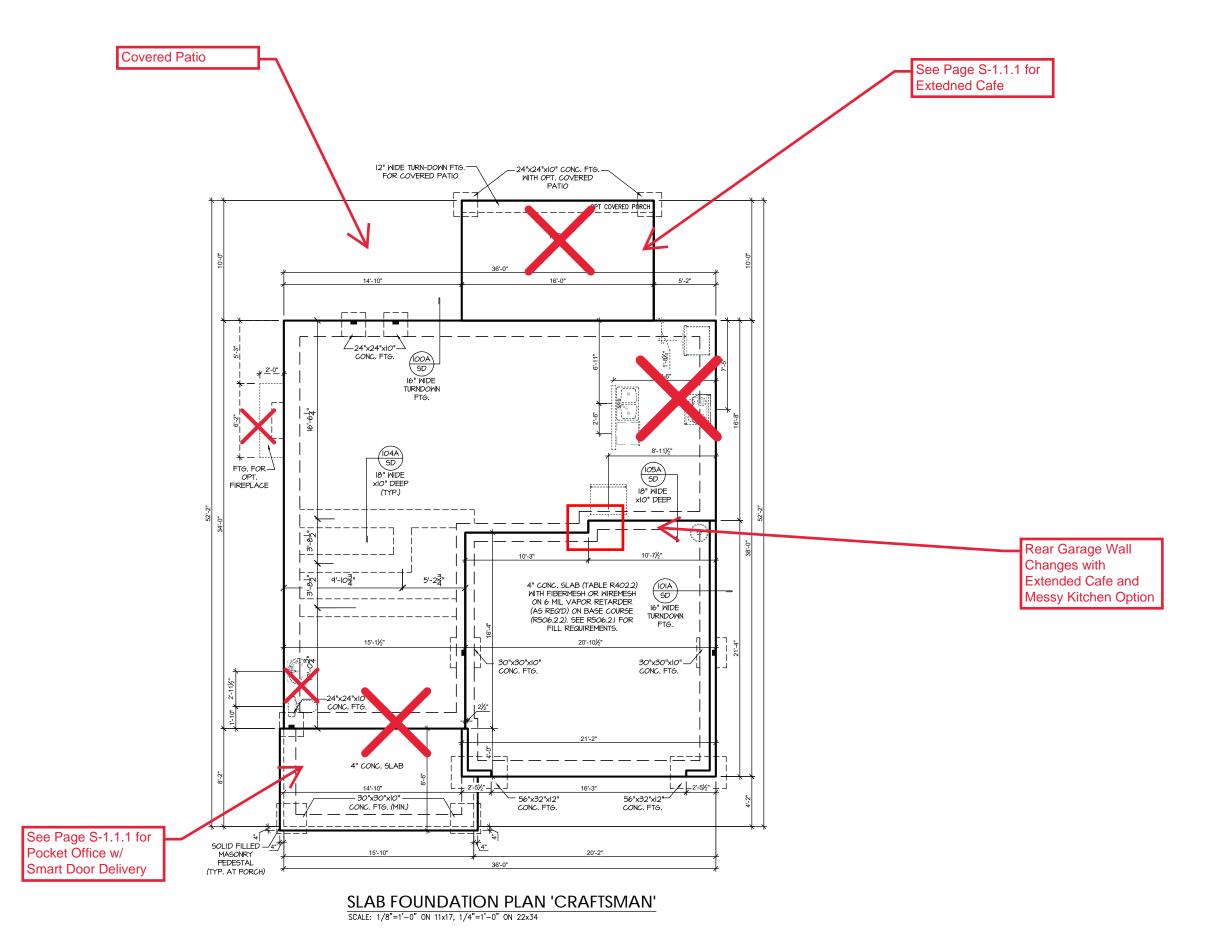

PROJECT # 21-2816.1-RH


Southern Engineers, P.A. 3716 Benson Drive, Raleigh, NC 27609 Phone: (919) 878-1617 License: C-4772 www.southernengineers.com


SOUTH DESIGNS

The Holly -RH NEW HOME, INC.

Plan

S-1.1

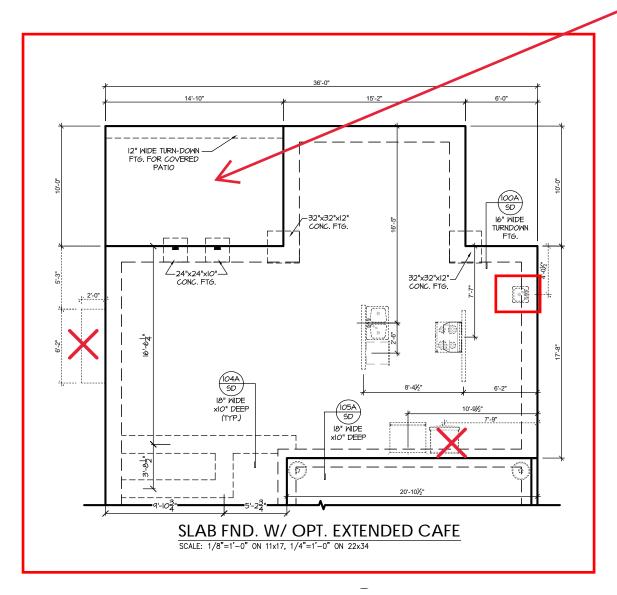

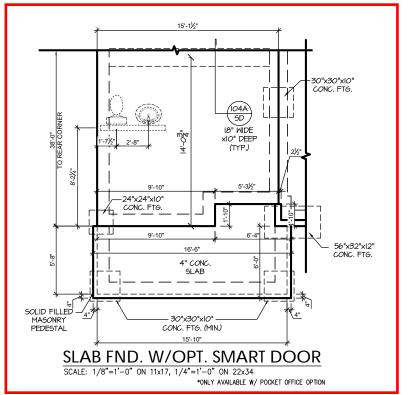

PROJECT #

21-2816.1-RH

Southern Engineers, P.A. 3716 Benson Drive, Raleigh, NC 27609 Phone: (919) 878-1617 License: C-4772 www.southernengineers.com

SOUTH DESIGNS

The Holly -RH NEW HOME, INC. Plan

SCALE: 1/8"=1'-0" ON 11x17, 1/4"=1'-0" ON 22x34

See Page S-2.1.1 for

Pocket Office w/ **Smart Door Delivery**

TRUSS SYSTEM REQUIREMENTS NC (2018 NCRC): Wind: 115-120 mph

- TRUSS SYSTEM LAYOUTS (PLACEMENT PLANS)
 SHALL BE DESIGNED IN ACCORDANCE WITH SEALED STRUCTURAL PLANS. ANY NEED TO CHANGE
 TRUSSES SHALL BE COORDINATED WITH SOUTHERN
- TRUSS SCHEMATICS (PROFILES) SHALL BE PREPARED AND SEALED BY TRUSS MANUFACTURER.
- ALL TRUSSES SHALL BE DESIGNED FOR BEARING ON SPF #2 OR #3 PLATES OR LEDGERS (UNO).
- ALL REQUIRED ANCHORS FOR TRUSSES DUE TO UPLIET OR BEARING SHALL MEET THE REQUIREMENTS AS SPECIFIED ON THE TRUSS SCHEMATICS

HEADER/BEAM & COLUMN NOTES

- ALL EXTERIOR AND LOAD BEARING HEADERS SHALL BE MIN. (2)2x6 (4" WALL) OR (3)2x6 (6' WALL) WITH (I) SUPPORT STUD, UNLESS NOTED
- 2. THE NUMBER SHOWN AT BEAM AND HEADER SUPPORTS INDICATES THE NUMBER OF SUPPORT STUDS REQUIRED IN STUD POCKET OR COLUMN. THE NUMBER OF KING STUDS AT EACH END OF HEADERS IN EXTERIOR WALLS SHALL BE ACCORDING TO ITEM "d" IN TABLE R602.3(5) OR AS BELOW PER NCDOI COMMENTARY "KING STUDS AT WALL OPENINGS" REVISED I-9-2020: UP TO 3' SPAN: (I) KING STUD
- OVER 3' UP TO 6' SPAN: (2) KING STUDS
- OVER 6' UP TO 9' SPAN: (3) KING STUDS OVER 9' UP TO 12' SPAN: (4) KING STUDS
- OVER 12' UP TO 15' SPAN: (5) KING STUDS

FRAMING NOTES

SCALE: 1/4"=1'-0" ON 11x17, 1/2"=1'-0" ON 22x34

NC (2018 NCRC): Wind: 115-120 mph

- BRACING METHOD AND TYPE: CONTINUOUSLY SHEATHED WSP: CS-WSP. NOTE THAT THE WALL BRACING AMOUNT PROVIDED ON THE PLANS (DETAILS AND SPECIFICATIONS) IS GREATER THAN THE AMOUNT OF WALL BRACING REQUIRED BY SECTION R602.10 OF THE CODE. SEE NOTES BELOW FOR DETAILS AND SPECIFICATIONS FOR WALL BRACING AND WALL FRAMING.
- EXTERIOR WALL SHEATHING: WALLS SHALL BE BRACED BY SHEATHING WALLS ON ALL STORIES WITH WOOD STRUCTURAL PANEL SHEATHING (WSP) (EXPOSURE B: 7/16". EXPOSURE C: 15/32"). SHEATHING SHALL BE ATTACHED WITH 8d NAILS AT A 6"/12" NAILING PATTERN (6" OC AT PANEL EDGES AND 12" OC AT INTERMEDIATE SUPPORTS). INSTALL BLOCKING AT ALL PANEL EDGES.
- 3. WSP SHEATHING SHALL EXTEND TO THE UPPERMOST DOUBLE BEARING PLATE, BLOCK AT ROOF PER SECTION R602 IO.45 AND ATTACH BRACED WALLS PER CODE. WSP SHEATHING BETWEEN FLOORS SHALL BE SPLICED ALONG CONTINUOUS BAND OR THE WSP SHEATHING MAY BE SPLICED ACROSS STUDS (CONTINUOUS ACROSS FLOOR SYSTEM) WITH BLOCKING AT PANEL EDGES. (MINIMUM 12" BEYOND FLOOR BREAK) OR OTHER APPROVED METHOD.
- "HD" = HOLDOWN: HOLD-DOWN DEVICE (NOTED AS "HD" ON PLANS)
 SHALL BE AN 800 POUND CAPACITY ASSEMBLY AS NOTED ON PLANS. SEE DETAILS FOR HD ASSEMBLY.

 **GROUND/FIRST FLOOR: USE "HD HOLD-DOWN DETAIL" ON SD SHEET
- **UPPER FLOORS: ATTACH BASE OF KING STUD WITH A SIMPSON CS20 OR CSHP20 STRAP DOWN ACROSS THE BAND AND DOWN TO A STUD BELOW OR HEADER BELON. EXTEND STRAP 7" MIN ALONG EACH STUD (OR HEADER) AND ATTACH EACH END W (7) 8d NAILS.
- 5. INTERIOR BRACED WALL: (NOTED AS "IBW" ON PLANS) ATTACH I/2" GYPSIM BOARD (GB) ON EACH SIDE OF WALL WITH A MIN. OF 5d COOLER NAILS OR #6 SCREWS @ 7" O.C. ALONG THE EDGES AND AT INTERMEDIATE SUPPORTS. SEE SECTION R602.10.4.4 OF THE CODE.
- 6. INTERIOR BRACED WALL-WOOD STRUCTURAL PANEL: (NOTED AS "IBW-WSP" ON PLANS). ATTACH ONE SIDE WITH 1/6" WSP SHEATHING WITH 8d NAILS AT A 6"/12" NAILING PATTERN (6" OC AT PANEL EDGES AND 12" OC AT INTERMEDIATE SUPPORTS). INSTALL BLOCKING AT ALL PANEL EDGES. ATTACH GB OVER WSP AS REQUIRED. ATTACH OPPOSITE SIDE WITH I/2" GB WITH A MIN. OF 5d COOLER NAILS OR #6 SCREWS @ 7° OC ALONG THE EDGES AND AT INTERMEDIATE SUPPORTS. SEE SECTION R602.IO.4.4 OF THE CODE.

REFER TO "SD" SHEET(S) FOR STANDARD DETAILS BRACING DETAILS AND STRUCTURAL NOTES. PROJECT # 21-2816.1-RH

CARO

P.A. 27609

Engineers, Drive, Raleigh, NC e: (919) 878-1617 Southern Engi 3716 Benson Drive, Ra Phone: (919) 8


SOUTH DESIGNS


HOME,

 Ξ

Holly

Plan

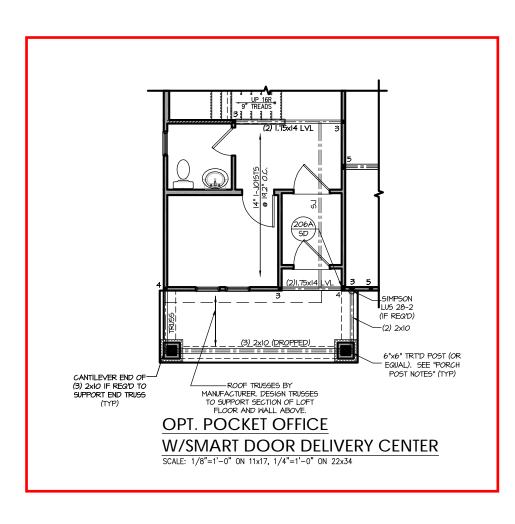

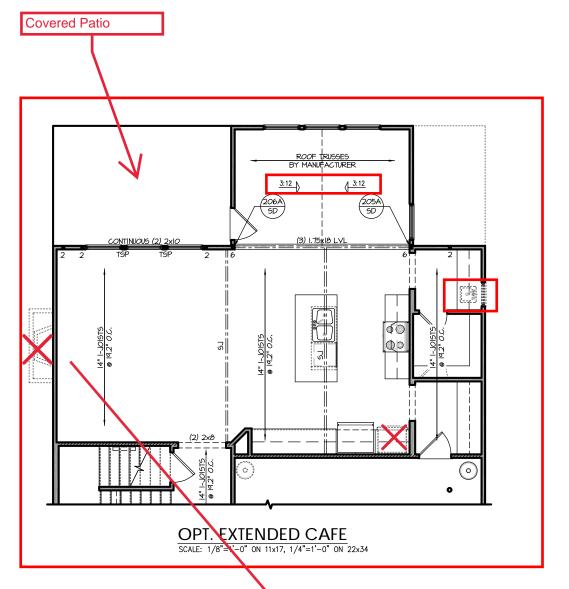

OPT. INTERIOR FIREPLACE
SCALE: 1/8"=1'-0" ON 11x17, 1/4"=1'-0" ON 22x34




PROJECT # 21-2816.1-RH

Southern Engineers, P.A. 3716 Benson Drive, Raleigh, NC 27609 Phone: (919) 878-1617 License: C-4772 www.southernengineers.com

SOUTH DESIGNS

The Holly -RH NEW HOME, INC. Plan

REFER TO "SD" SHEET(S) FOR STANDARD DETAILS, BRACING DETAILS AND STRUCTURAL NOTES.

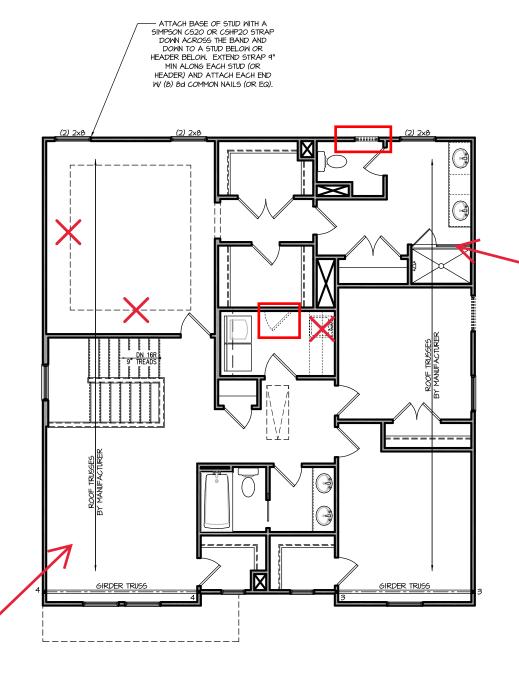

Shower w/ Bench

SECOND FLOOR PLAN 'CRAFTSMAN'

SCALE: 1/8"=1'-0" ON 11x17, 1/4"=1'-0" ON 22x34

Ded 4 ILO Loft



TRUSS SYSTEM REQUIREMENTS NC (2018 NCRC): Wind: 115-120 mph

- TRUSS SYSTEM LAYOUTS (PLACEMENT PLANS)
 SHALL BE DESIGNED IN ACCORDANCE WITH SEALED
 STRUCTURAL PLANS, ANY NEED TO CHANGE
 TRUSSES SHALL BE COORDINATED WITH SOUTHERN
 ENGINEERS.
- 2. TRUSS SCHEMATICS (PROFILES) SHALL BE PREPARED AND SEALED BY TRUSS MANUFACTURER.
- ALL TRUSSES SHALL BE DESIGNED FOR BEARING ON SPF #2 OR #3 PLATES OR LEDGERS (UNO).
- ALL REQUIRED ANCHORS FOR TRUSSES DUE TO UPILIFT OR BEARING SHALL MEET THE REQUIREMENTS AS SPECIFIED ON THE TRUSS SCHEMATICS.

HEADER/BEAM & COLUMN NOTES

- I. ALL EXTERIOR AND LOAD BEARING HEADERS SHALL BE MIN. (2)2x6 (4" WALL) OR (3)2x6 (6" WALL) WITH (I) SUPPORT STUD, UNLESS NOTED OTHERWISE.
- 2. THE NUMBER SHOWN AT BEAM AND HEADER SUPPORTS INDICATES THE NUMBER OF SUPPORT STUDS REQUIRED IN STUD POCKET OR COLUMN. THE NUMBER OF KING STUDS AT EACH END OF HEADERS IN EXTERIOR WALLS SHALL BE ACCORDING TO ITEM "d" IN TABLE R602.3(5) OR AS BELOW PER NCDOI COMMENTARY "KING STUDS AT WALL OPENINGS" REVISED 1-4-2020:
- UP TO 3' SPAN: (I) KING STUD
- OVER 3' UP TO 6' SPAN: (2) KING STUDS
- OVER 6' UP TO 9' SPAN: (3) KING STUDS
 OVER 9' UP TO 12' SPAN: (4) KING STUDS
- OVER 9 UP TO 12 SPAN: (4) KING STUDS
 OVER 12' UP TO 15' SPAN: (5) KING STUDS

FRAMING NOTES

NC (2018 NCRC): Wind: 115-120 mph

- I. BRACING METHOD AND TYPE: CONTINUOUSLY SHEATHED WSP: CS-WSP. NOTE THAT THE WALL BRACING AMOUNT PROVIDED ON THE PLANS (DETAILS AND SPECIFICATIONS) IS GREATER THAN THE AMOUNT OF WALL BRACING REQUIRED BY SECTION R602.10 OF THE CODE. SEE NOTES BELOW FOR DETAILS AND SPECIFICATIONS FOR WALL BRACING AND WALL FRAMING.
- 2. EXTERIOR WALL SHEATHING: WALLS SHALL BE BRACED BY SHEATHING WALLS ON ALL STORIES WITH WOOD STRUCTURAL PANEL SHEATHING (WSP) (EXPOSURE 5. 1/16", EXPOSURE 6. 15/2"), SHEATHING SHALL BE ATTACHED WITH 8d NAILS AT A 6"/12" NAILING PATTERN (6" OC AT PANEL EDGES AND 12" OC AT INTERNEDIATE SUPPORTS). INSTALL BLOCKING AT ALL PANEL EDGES.
- 3. MSP SHEATHING SHALL EXTEND TO THE UPPERMOST DOUBLE BEARING PLATE. BLOCK AT ROOF PER SECTION REO.21.0.4.5 AND ATTACH BRACED WALLS PER CODE. WSP SHEATHING BETNEEN FL.OORS SHALL BE SPLICED ALONG CONTINUOUS BAND OR THE WSP SHEATHING MAY BE SPLICED ACROSS STUDS (CONTINUOUS ACROSS FL.OOR SYSTEM) WITH BLOCKING AT PANEL EDGES. (MINIMUM 12" BEYOND FLOOR BREAK) OR OTHER APPROVED METHOD.
- 4. "HD" = HOLDOWN: HOLD-DOWN DEVICE (NOTED AS "HD" ON PLANS) SHALL BE AN 800 POUND CAPACITY ASSEMBLY AS NOTED ON PLANS, SEE DETAILS FOR HID ASSEMBLY
- SEE DETAILS FOR HD ASSEMBLY.

 **GROUND/FIRST FLOOR: USE "HD HOLD-DOWN DETAIL" ON SD SHEET (OR EQUIV.)
- (OK EGUIV)

 ***IPPER FLOORS: ATTACH BASE OF KING STUD WITH A SIMPSON C520 OR C5HP20 STRAP DOWN ACROSS THE BAND AND DOWN TO A STUD BELOW OR HEADER BELOW. EXTEND STRAP 7" MIN ALONG EACH STUD (OR HEADER) AND ATTACH EACH END W (1) 8d NAILS.
- 5. INTERIOR BRACED WALL: (NOTED AS "IBM" ON PLANS) ATTACH I/2" GYPSM BOARD (GB) ON EACH SIDE OF WALL WITH A MIN. OF 5d COOLER NAILS OR #6 SCREMS @ 1" O.C. ALONG THE EDGES AND AT INTERMEDIATE SUPPORTS, SEE SECTION R602.10.4.4 OF THE CODE.
- 6. INTERIOR BRACED WALL-WOOD STRUCTURAL PANEL: (NOTED AS "IBN-NSP" ON PLANS). ATTACH ONE SIDE WITH 1/6" WSP SHEATHING WITH BO MAILS AT A 6"1/2" NAILING PATTERN (6" OC AT PANEL EDGES AND 12" OC AT INTERMEDIATE SUPPORTS). INSTALL BLOCKING AT ALL PANEL EDGES. ATTACH 6B OVER WSP AS REQUIRED. ATTACH OPPOSITE SIDE WITH 1/2" GB WITH A MIN. OF 50 COOLER NAILS OR #6 SCREWS @ 1" OC ALONG THE EDGES AND AT INTERMEDIATE SUPPORTS. SEE SECTION R60210.4.4 OF THE CODE.

REFER TO "5D" SHEET(5) FOR STANDARD DETAILS, BRACING DETAILS AND STRUCTURAL NOTES. PROJECT # 21-2816.1-RH

ude construction means, methods, techniques, res or safety precautions. discrepancies on plans are to be brought to the on of Southern Engineers. Failure to do so will interest lability.

Engineers seal applied document.

27609 Sequences, procedure Any deviations or distributed and a manedate attention void Southern Engine Use of these plans co

Southern Engineers, P
3716 Benson Drive, Raleigh, NC 27
Phone: (919) 878-1617
License: C-4772
www.southernengineers.com


SOUTH DESIGNS


2 - The Holly -RH NEW HOME, INC.

S-2.2

Plan



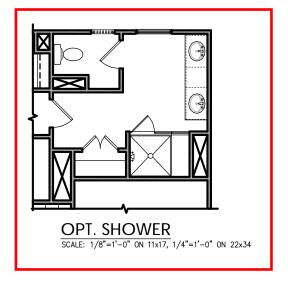

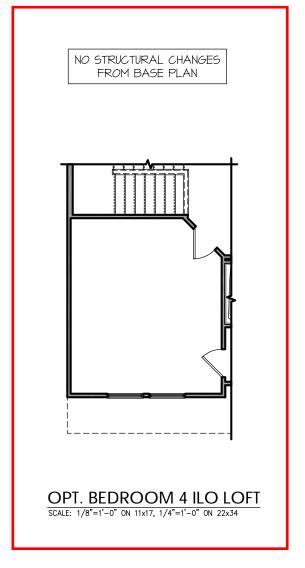


Southern Engineers, P.A. 3716 Benson Drive, Raleigh, NC 27609 Phone: (919) 878-1617 License: C-4772 www.southernengineers.com

PROJECT # 21-2816.1-RH

SOUTH DESIGNS

The Holly -RH NEW HOME, INC.

Plan

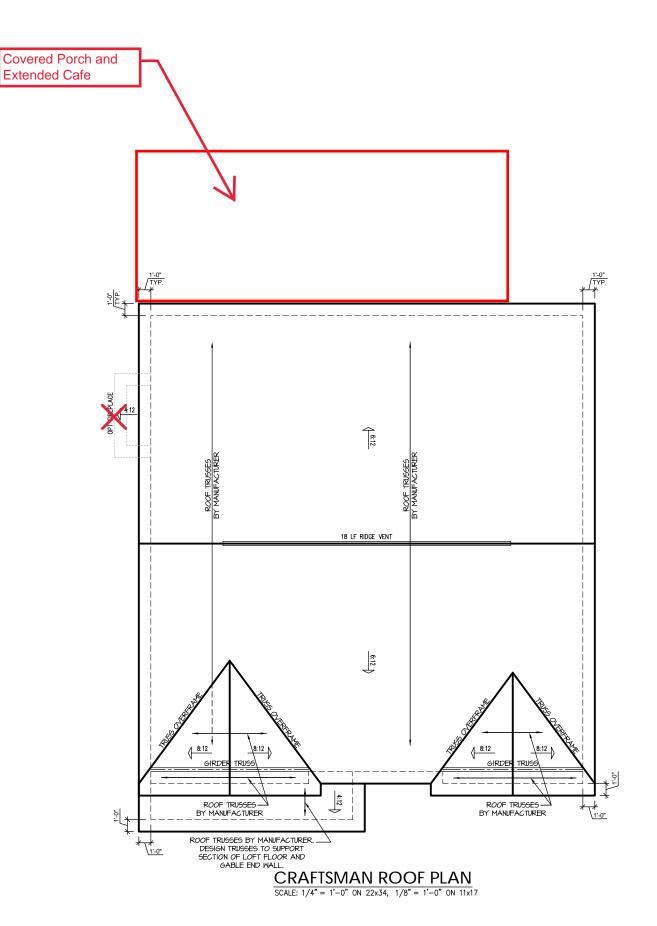

TRUSS SYSTEM REQUIREMENTS NC (2018 NCRC): Wind: 115-120 mph

TRUSS SYSTEM LAYOUTS (PLACEMENT PLANS)
SHALL BE DESIGNED IN ACCORDANCE WITH SEALED
STRUCTURAL PLANS. ANY NEED TO CHANGE
TRUSSES SHALL BE COORDINATED WITH SOUTHERN

- 2. TRUSS SCHEMATICS (PROFILES) SHALL BE PREPARED AND SEALED BY TRUSS MANUFACTURER.
- ALL TRUSSES SHALL BE DESIGNED FOR BEARING ON SPF #2 OR #3 PLATES OR LEDGERS (UNO).
- ALL REQUIRED ANCHORS FOR TRUSSES DUE TO UPLIFT OR BEARING SHALL MEET THE REQUIREMENTS AS SPECIFIED ON THE TRUSS SCHEMATICS.



PROJECT # 21-2816.1-RH

P.A. 27609

Southern Engineers, P 3716 Benson Drive, Raleigh, NC 25 Phone: (919) 878-1617

SOUTH DESIGNS


-RH Holly NEW HOME, The

Plan

REFER TO "SD" SHEET(S) FOR STANDARD DETAILS, BRACING DETAILS AND STRUCTURAL NOTES.


S-3.1



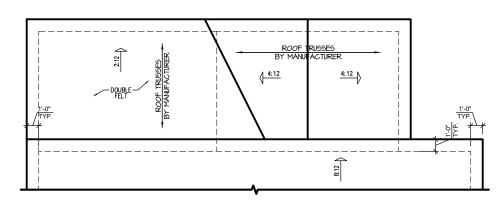

EXTENDED CAFE W/ COVERED PORCH PLAN ROOF PLAN
SCALE: 1/8"=1'-0" ON 11x17, 1/4"=1'-0" ON 22x34

EXTENDED CAFE W/
COVERED PORCH PLAN
SCALE: 1/8"=1'-0" ON 11x17, 1/4"=1'-0" ON 22x34

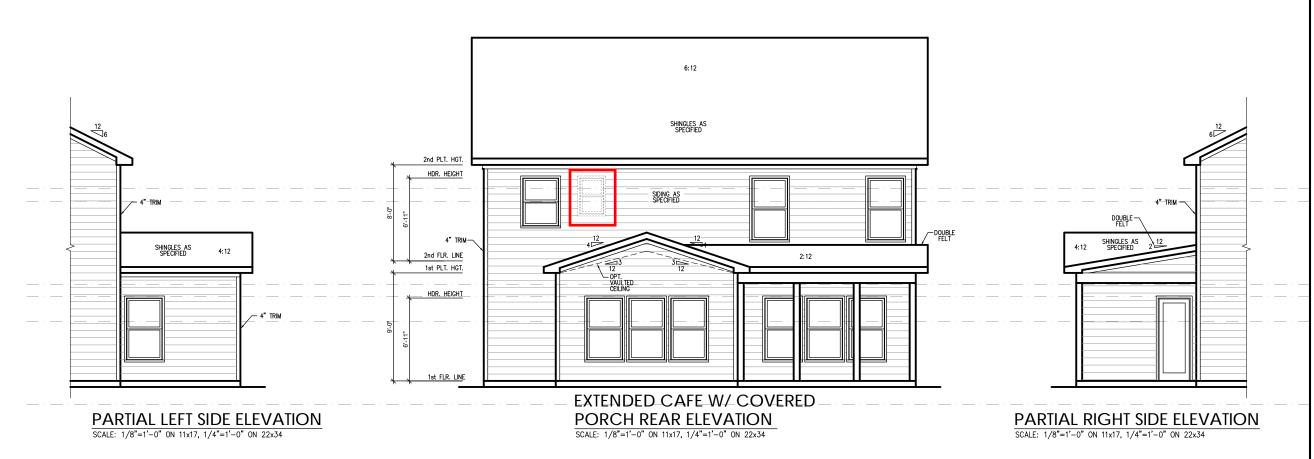

REFER TO "5D" SHEET(5) FOR STANDARD DETAILS, BRACING DETAILS AND STRICTURAL NOTES. PROJECT # 21-2816.1-RH

clude construction means, methods, techniques, clude construction means, methods, techniques, ratificres or safety precautions.

The discrepancies on plans are to be brought to the fron of Southern Engineers, Failure to do so will


Seal does not include construction means, methor sequences, procedures or safety precautions. Any deviations or discrepancies on plans are to immediate attention of Southern Engineers Tailing, yould Southern Engineers I listing, and these plans constitutes annivol of terms.


Southern Engineers, P.A. 3716 Benson Drive, Raleigh, NC 27609 Phone: (919) 878-1617 License: C-4772 www.southernengineers.com


SOUTH DESIGNS


Plan 2 - The Holly -RH
NEW HOME, INC.

S-6.1

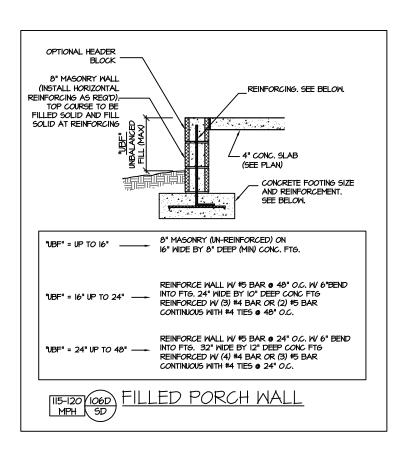

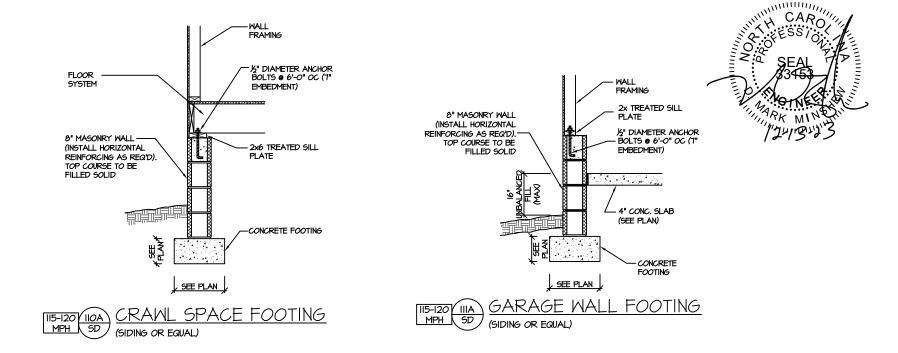

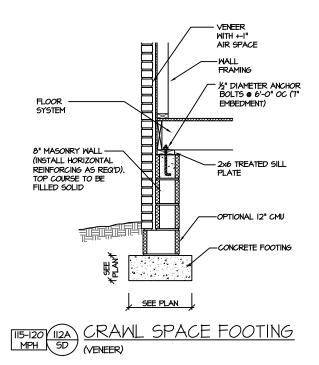

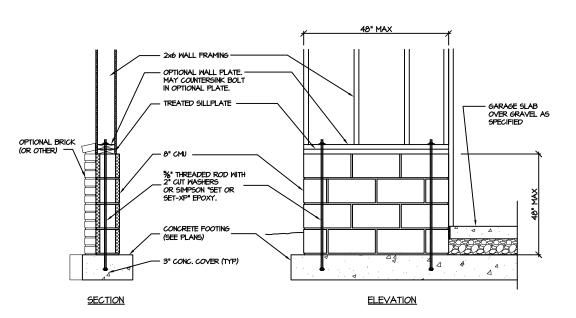

GARAGE 'WING WALL' REINFORCING
PER IRC FIGURE R602.10.4.3

CRAWL SPACE FOUNDATION

PROJECT # 21-2816.1

are to be brought to the rs. Failure to do so will r from date of seal.


does not include construction means, methods, techni ences, procedures or safety precautions. deviations or discrepanicies on plans are to be brought eclate attention of Southern Engineers. Failure to do. Southern Engineer's liability.

Southern Engineers, P.A. 3716 Benson Drive, Raleigh, NC 27609 Phone: (919) 878-1617 License: C-4772 www.southernengineers.com


SOUTH DESIGNS


PLAN 2 - THE HOLLY
NEW HOME, INC.


SD

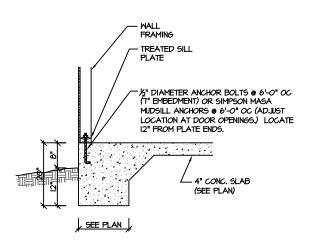



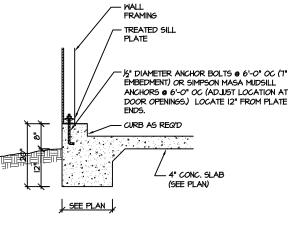

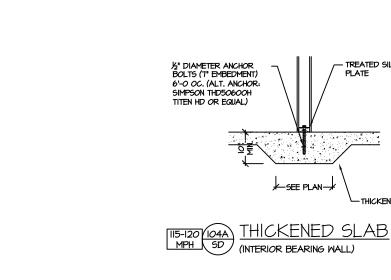

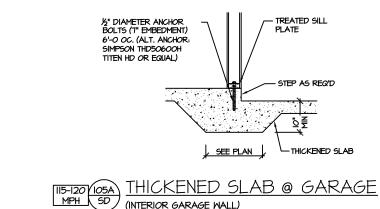



PROJECT # 21-2816.1


Southern Engineers, P.A. 3716 Benson Drive, Raleigh, NC 27609 Phone: (919) 878-1617 License: C-4772 www.southernengineers.com

SOUTH DESIGNS

THE HOLLY NEW HOME, INC. \sim **PLAN**

SD

SLAB FOUNDATION

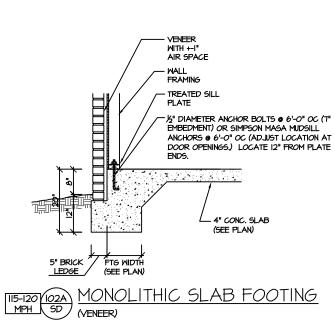

MONOLITHIC SLAB @ GARAGE II5-I20 IOIA MPH SD (SIDING OR EQUAL)


-SEE PLAN-


TREATED SILL


-THICKENED SLAB

PLATE


(INTERIOR GARAGE WALL)

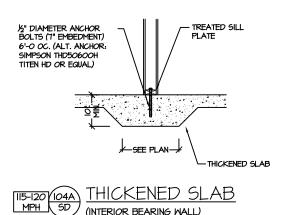


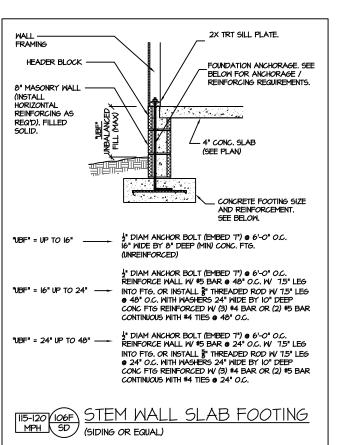


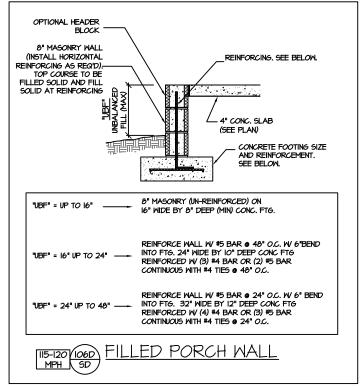




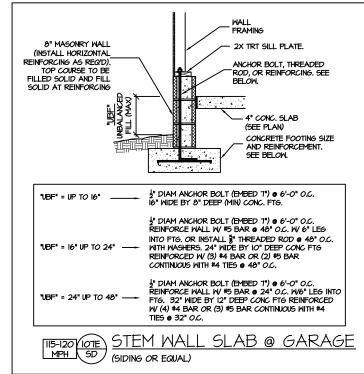

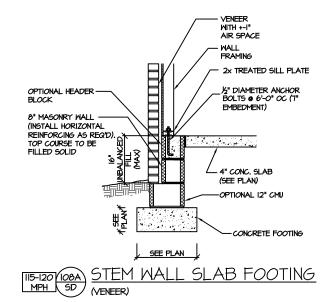

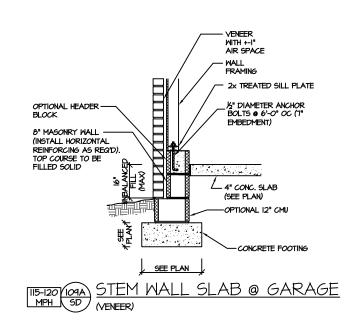

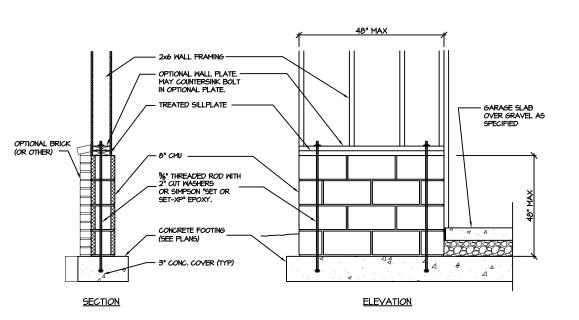

GARAGE 'WING WALL' REINFORCING PER IRC FIGURE R602.IO.4.3

STEM WALL SLAB FOUNDATION

PROJECT # 21-2816.1

P.A. 27609

Southern Engineers, P 3716 Benson Drive, Raleigh, NC 2' Phone: (919) 878-1617 License: C-4772 www.southernengineers.com

SOUTH DESIGNS

HOLLY THE HOME, \sim AN

SD

 \mathbf{L}

2. ALL CONSTRUCTION SHALL CONFORM TO THE LATEST REQUIREMENTS OF THE 2018 NO ALL CONSTRUCTION SHALL CONFORM TO THE LATEST REQUIREMENTS OF THE 2018 NO RESIDENTIAL CODE, PLUS ALL LOCAL CODES AND REGULATIONS. THE STRUCTURAL ENGINEER IS NOT RESPONSIBLE FOR, AND WILL NOT HAVE CONTROL OF, CONSTRUCTION MEANS, METHODS, TECHNIQUES, SEQUENCES OR PROCEDURES, OR FOR SAFETY PRECAUTIONS AND PROGRAMS IN CONNECTION WITH THE CONSTRUCTION WORK, NOR WILL THE ENGINEER BE RESPONSIBLE FOR THE CONTRACTOR'S FAILURE TO CARRY OUT THE CONSTRUCTION WORK IN ACCORDANCE WITH THE CONTRACT DOCUMENTS. "CONSTRUCTION REVIEW" SERVICES ARE NOT PART OF OUR CONTRACT. ALL MEMBERS SHALL BE FRAMED ANCHORED, TIED AND BRACED IN ACCORDANCE WITH GOOD CONSTRUCTION PRACTICE AND THE BUILDING CODE.

DESIGN LOADS (LISTED AS: LIVE LOAD, DEAD LOAD, DEFLECTION)

ROOMS OTHER THAN SLEEPING ROOMS: (40 PSF, IO PSF, L/360)

ATTIC WITHOUT STORAGE: (IO PSF, IO PSF, L/240)

STAIRS: (40 PSF, IO PSF, L/360)

4. WALLS SHALL BE BRACED BY SHEATHING WALLS ON ALL STORIES WITH MOOD STRUCTURAL PANELS. SEE FRAMING NOTES FOR THICKNESS AND NAILING REQUIREMENTS.

5. SEE APPENDIX M (DCA6) FOR EXTERIOR DECK REQUIREMENTS INCLUDING ATTACHMENTS FOR

CONCRETE SHALL HAVE A MINIMUM 20 DAY STRENGTH OF 3000 PSI AND A MAXIMUM SLUMP OF 5 INCHES UNLESS NOTED OTHERWISE (UNO). AIR ENTRAINED PER TABLE 402.2. ALL CONCRETE SHALL BE PROPORTIONED, MIXED, HANDLED, SAMPLED, TESTED, AND PLACED IN ACCORDANCE WITH ACI STANDARDS, ALL SAMPLES FOR PUMPING SHALL BE TAKEN FROM THE EXTRIDANCE THE PUMP. CONTROL JOINTS IN SLABS SHALL BE SPACED ON A GRID OF 1-30 TIMES THE DEPTH (D). CONTROL JOINTS SHALL BE SANCUT TO A DEPTH OF I/D. (I.E. 4" CONCRETE SLABS SHALL

CONTACT A GEOTECHNICAL ENGINEER AND THE STRUCTURAL ENGINEER IF UNGATISFACTORY SUBSURFACE CONDITIONS ARE ENCOUNTERED. THE SURFACE AREA ADJACENT TO THE FOUNDATION WALL SHALL BE PROVIDED WITH ADEQUATE DRAINAGE, AND SHALL BE GRADED SO

9. L.V.L. SHALL BE LAMINATED VENEER LUMBER: Fb=2600 PSI, Fv=285 PSI, E=1.9xIO PSI. P.S.L. SHALL BE PARALLEL STRAND LUMBER: Fb=2900 PSI, Fv=240 PSI, E=2.0xi0 PSI. L.S.L. SHALL BE LAMINATED STRAND LUMBER: Fb=2250 PSI, Fv=400 PSI, E=1.55xi0 PSI.

SEALED STRUCTURAL DRAWINGS, TRUSSES AND I-JOISTS SHALL BE INSTALLED ACCORDING TO THE MANUFACTURE'S SPECIFICATIONS, ANY CHANGE IN TRUSS OR I-JOIST LAYOUT SHALL BE



STRUCTURAL NOTES NC (2018 NCRC): Wind: 115-120 mph

ENGINEER'S SEAL APPLIES ONLY TO STRUCTURAL COMPONENTS INCLUDING ROOF RAFTERS, HIPS, VALLEYS, RIDGES, FLOORS, WALLS, BEAMS AND HEADERS, COLUMNS, CANTILEVERS, OFFGET LOAD BEARING WALLS, PIER & GIRDER SYSTEM, FOOTING, AND PILING SYSTEM. ENGINEER'S SEAL DOES NOT CERTIFY DIMENSIONAL ACCURACY OR ARCHITECTURAL LAYOUT INCLUDING ROOF SYSTEM. ALL REQUIREMENTS FOR PROFESSIONAL CERTIFICATION SHALL BE PROVIDED BY THE APPROPRIATE PROFESSIONAL, SOUTHERN ENGINEERS, P.A. CERTIFIES ONLY THE STRUCTURAL CONTROLLING AND CONTROLLIN COMPONENTS AS SPECIFICALLY STATED.

SLEEPING ROOMS: (30 PSF, IO PSF, L/360)

ATTIC WITH PERMANENT STAIR: (40 PSF, IO PSF, L/360)

ATTIC WITHOUT PERMANENT STAIR: (20 PSF, IO PSF, L/360)

DECKS AND EXTERIOR BALCONIES: (40 PSF, IO PSF, L/360)

PASSENGER VEHICLE GARAGES: (50 PSF, IO PSF, L/360)

HAVE 以" DEEP CONTROL JOINTS SAWCUT IN SLAB ON A +-10'-0" x +-10'-0" GRID).

ALLOWABLE SOIL BEARING PRESSURE ASSUMED TO BE 2000 PSF. THE CONTRACTOR MUST AS TO DRAIN SURFACE WATER AWAY FROM FOUNDATION WALLS.

8. ALL FRAMING LUMBER SHALL BE SPF #2 (Fb = 675 PSI) UNLESS NOTED OTHERWISE (UNO). ALL TREATED LUMBER SHALL BE SYP # 2. PLATE MATERIAL MAY BE SPF # 3 OR SYP #3 (Fc(perp))

INSTALL ALL CONNECTIONS PER MANUFACTURERS INSTRUCTIONS.

IO. ALL ROOF TRUSS AND I-JOIST LAYOUTS SHALL BE PREPARED IN ACCORDANCE WITH THE COORDINATED WITH SOUTHERN ENGINEERS.


ALL STRUCTURAL STEEL SHALL BE ASTM A-36, STEEL BEAMS SHALL BE SUPPORTED AT EACH END WITH A MINIMUM BEARING LENGTH OF 3 1/2" INCHES AND FULL FLANGE WIDTH, PROVIDE SOLID BEARING FROM BEAM SUPPORT TO FOUNDATION, BEAMS SHALL BE ATTACHED TO EACH SUPPORT WITH TWO LAG SCRENG (1/2" DIAMETER X 4" LONG), LATTERAL SUPPORT IS CONSIDERED ADEQUATE PROVIDING THE JOIST ARE TOE NAILED TO THE SOLE PLATE, AND SOLE PLATE IS NAILED OR BOLTED TO THE BEAM FLANGE @ 48" O.C. ALL STEEL TUBING SHALL BE ASTM ASOO.

12. REBAR SHALL BE DEFORMED STEEL, ASTM615, GRADE 60. LAP ALL REBAR SPLICES 30 BAR

13. FLITCH BEAMS SHALL BE BOLTED TOGETHER USING (2) ROWS OF 1/2" DIAMETER BOLTS (ASTM A325) WITH WASHERS PLACED UNDER THE THREADED END OF BOLT. BOLTS SHALL BE SPACED AT 24" O.C. (MAX), AND STAGGERED AT THE TOP AND BOTTOM OF BEAM (2" EDGE DISTANCE), WITH 2 BOLTS LOCATED AT 6" FROM EACH END.

I4. BRICK LINTELS (WHEN REQUIRED) SHALL BE 3 I/2'x3 I/2'x1/4" STEEL ANGLE FOR UP TO 6'-0" SPAN AND 6'x4"x5/16" STEEL ANGLE WITH 6" LEG VERTICAL FOR SPANS UP TO 4'-0". SEE PLANS FOR SPANS OVER 9'-0". SEE ALSO SECTION R703.8.3 LINTELS.

15. METAL CONNECTORS REFERENCED ON PLANS CORRESPOND TO SIMPSON STRONG-TIE BRAND. CONNECTORS OF EQUAL OR BETTER CAPACITY ARE ACCEPTABLE. CORROSION RESISTANCE PER CODE AND AS RECOMMENDED BY MANUFACTURER.

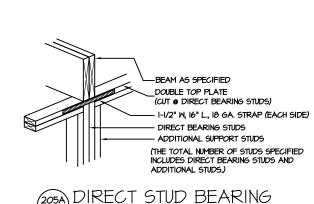



MAIN GARAGE BEAM AS SPEC'D STEEL OR LVL (STEEL SHOWN) BEAM SHALL BEAR ON END

- ATTACH STEEL BEAMS TO STUDS WITH (2) I/2" DIA. x 4" LONG LAG SCREMS

NUMBER OF STUDS SPEC'D (SEE PLANS) INCLUDES ALL

204A TYP. GARAGE BEAM BEARING SD NTS

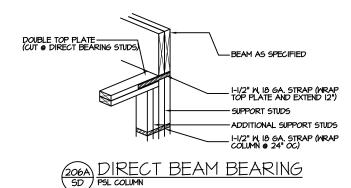

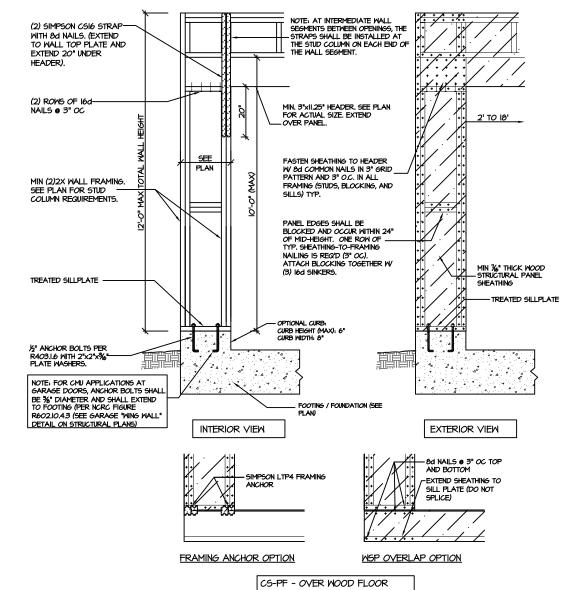

CS-PF: CONTINUOUS PORTAL FRAME CONSTRUCTION DETAIL AND APPLICATION BASED ON NORC FIGURE R602.IO.I - PORTAL FRAME CONSTRUCTION

SD

 \sim

HOME,

PROJECT # 21-2816.1

P.A. 27609

Engineers, Drive, Raleigh, NC : e: (919) 878-1617

Southern 3716 Benson Dr

enson Drive, R. Phone: (919) 8 License: C

DESIGNS

SOUTH]