REVISION LOG

REVISION:001

ADJUST OPTION SQUARE FOOTAGES TO ACCURATELY SHOW THE DIFFERENCES FROM THE BASE PLAN SQUARE FOOTAGE TOTALS.

REVISION:002

ADJUST OPTION SQUARE FOOTAGES TO ACCURATELY SHOW THE DIFFERENCES FROM THE BASE PLAN ADJUST OPTION SQUARE FOOTAGES TO ACCURATELY SHOW THE DIFFERENCES FROM THE SQUARE FOOTAGE TOTALS.

EXTENDED TRIM AT GARAGE DOOR DOWN TO BASE AND CUT STONE BACK ADJUSTED KITCHEN ISLAND
RESIZED THE FIREPLACE OPTION
RELOCATED THE WINDOW IN THE MESSY KITCHEN TO BEHIND THE OPT. SINK CHANGED MESSY KITCHEN MINDOW TO OPTIONAL

CHANGED MESSY KITCHEN WINDOW TO OPTIONAL ADDED CHASE TO OWNERS'S WC ADDED DIMS TO 0. BATH VANITY FOR CLARIFICATION REMOVED OPT. DOOR TO LOFT ADDED CHASE TO LOFT WC RELOCATED LINEN IN THE 0. BATH OPTIONS

11. RELOCATED LINEN IN THE O. BATH OFFICIANS
12. REMOVED THE OPT. SUPER SHOWER CZERO ENTRY)
13. FLIPPED SMART DOOR DELIVERY DOOR HANDING
14. CHANGED ALL LINEN CLOSETS TO HAVE ONLY 4 SHELVES
15. CHANGED SIZE OF BASE SHOWER TO 60X36
16. UPDATED OPTIONAL SQ. FTG. CHART
17. REMOVED HALF WALLS AT KITCHEN ISLAND AND UPDATED PER CABINET PROVIDER
18. EXTEND PORCH SLAB 4" AT FRONT AND EXTEND AROUND CORNER 20" TO SUPPORT STONE VENEER

EXTEND PORCH SLAB 4" AROUND THE PERIMETER AT THE 'CRAFTSMAN' ELEVATION

DATE: 3/30/2022

EXTEND PORCH SLAB 4" AROUND THE PERIMETER AT THE 'CRAFTSMAN' ELEVATION ADDED A COLUMN DETAIL FOR CLARITY ON THE 'CRAFTSMAN' ELEVATION

ADDED A SEPARATE OPTION FOR THE POCKET OFFICE WITH THE SMART DELIVERY DOOR

DATE: 7/22/2022

REVISION:004 DATE: 6/20/2022

1 ADD SIDE LOAD GARAGE

REVISION:005

ADD STEM WALL SLAB FOUNDATION SHEETS CORRECT OPTIONAL SMART DELIVERY DOOR LOCATION ON FOUNDATION PLANS TO

MATCH FLOOR PLAN.

REVISION:006

Changed 48x42 shower to 42x42. Added Side Load Garage foundation for extended cafe option. Updated Square footage chart to add extended patio to the extended cafe OPTION. REVISED PORCH/ POCKET OFFICE/ SMART DOOR DELIVERY SQUARE FOOTAGE MOVED WATER HEATER TO INNER CORNER FOR ALL SIDE LOAD OPTIONS. REMOVED OPT. EXTENDED PATIO FROM BASE DRAWINGS

ADD FARMHOUSE AND TRADITIONAL ELEVATIONS TO THE PLAN
 UPDATE ELECTRICAL PLANS— MOVE EV OUTLET TO EP AND REMOVE ALL OTHER OUTLETS FROM PLAN.

SQUARE FOOTAGE UNHEATED HEATED FIRST FLOOR 872 SECOND FLOOR 1345 FRONT PORCH 2 CAR GARAGE 437 2217 OTAL LINDER ROOF **OPTIONS** UNHEATED S.F. HEATED S.F. EXTENDED CAFE w/ +148 +152 PATIO FRONT PORCH W/ 0 +51 W/ SMART DOOR

2420 heated

832 unheated

3 H@NC - 60 Eagle Crest Court, Lillington, NC 27546

The Holly - LH 'CRAFTSMAN' ELEVATION

NC.



Sheet No.	Sheet Description
0.0	Cover Sheet
1.1	Foundation (Slab)
1.1.1	Foundation Options (Slab)
1.1.2	Foundation Options (Slab)
1.2	Foundation (Crawl)
1.2.1	Foundation Options (Crawl)
1.2.2	Foundation Options (Crawl)
1.3	Foundation (Stem Wall Slab)
1.3.1	Foundation Options (Stem Wall Slab)
1.3.2	Foundation Options (Stem Wall Slab)
2.1	First Floor Plan
2.1.1	First Floor Plan Options
2.2	Second Floor Plan
2.2.1	Second Floor Plan Options
2.4	Covered Porch Plans & Elevations (Slab)
2.4.1	Covered Porch Plans & Elevations (Crawl/Stem Wall)
2.5	Covered Porch w/ Extended Cafe Plans & Elevations (Slab)
2.5.1	Covered Porch w/ Extended Cafe Plans & Elevations (Crawl/ Stem Wall
2.6	Extended Cafe Plans & Elevations (Slab)
2.6.1	Extended Cafe Plans & Elevations (Crawl/ Stem Wall)
2.7	2-Car Sideload Garage Plans
2.7.1	2-Car Sideload Garage Elevations
3.1	Front & Rear Elevations (Slab)
3.1.1	Front & Rear Elevations (Crawl/ Stem Wall)
3.2	Side Elevations (Slab)
3.2.1	Side Elevations (Crawl/ Stem Wall)
3.3	Roof Plan
5.1	First Floor Electrical
5.1.1	First Floor Options Electrical
5.2	Second Floor Electrical
5.2.1	Second Floor Options Electrical

DESIGN CRITERIA:

THIS PLAN IS TO BE BUILT IN CONFORMANCE WITH THE 2018 NORTH CAROLINA STATE BUILDING CODE; RESIDENTIAL CODE

DIMENSIONS SHALL GOVERN OVER SCALE, AND CODE SHALL

9-26-24 - Redlines - JJ 9-27-24 - Remove Gourmet Kitchen - JJ





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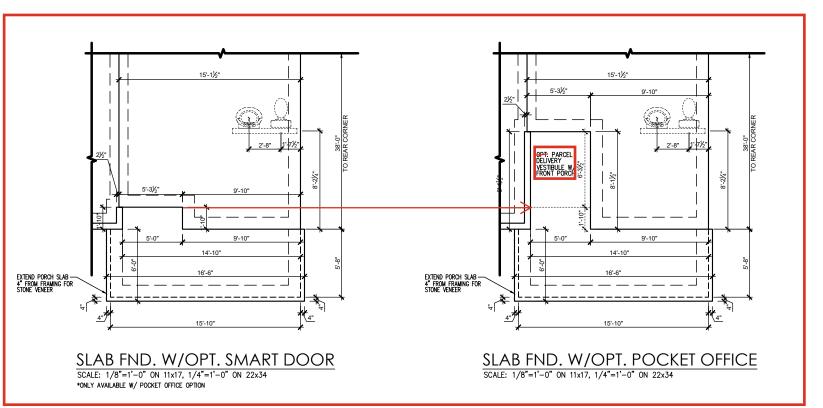
Cover Sheet 'Craftsman' THE HOLLY

South Designs ISSUE DATE: 7/1/2021 CURRENT REVISION DATE

> SCALE: 1/8" = 1'-0"



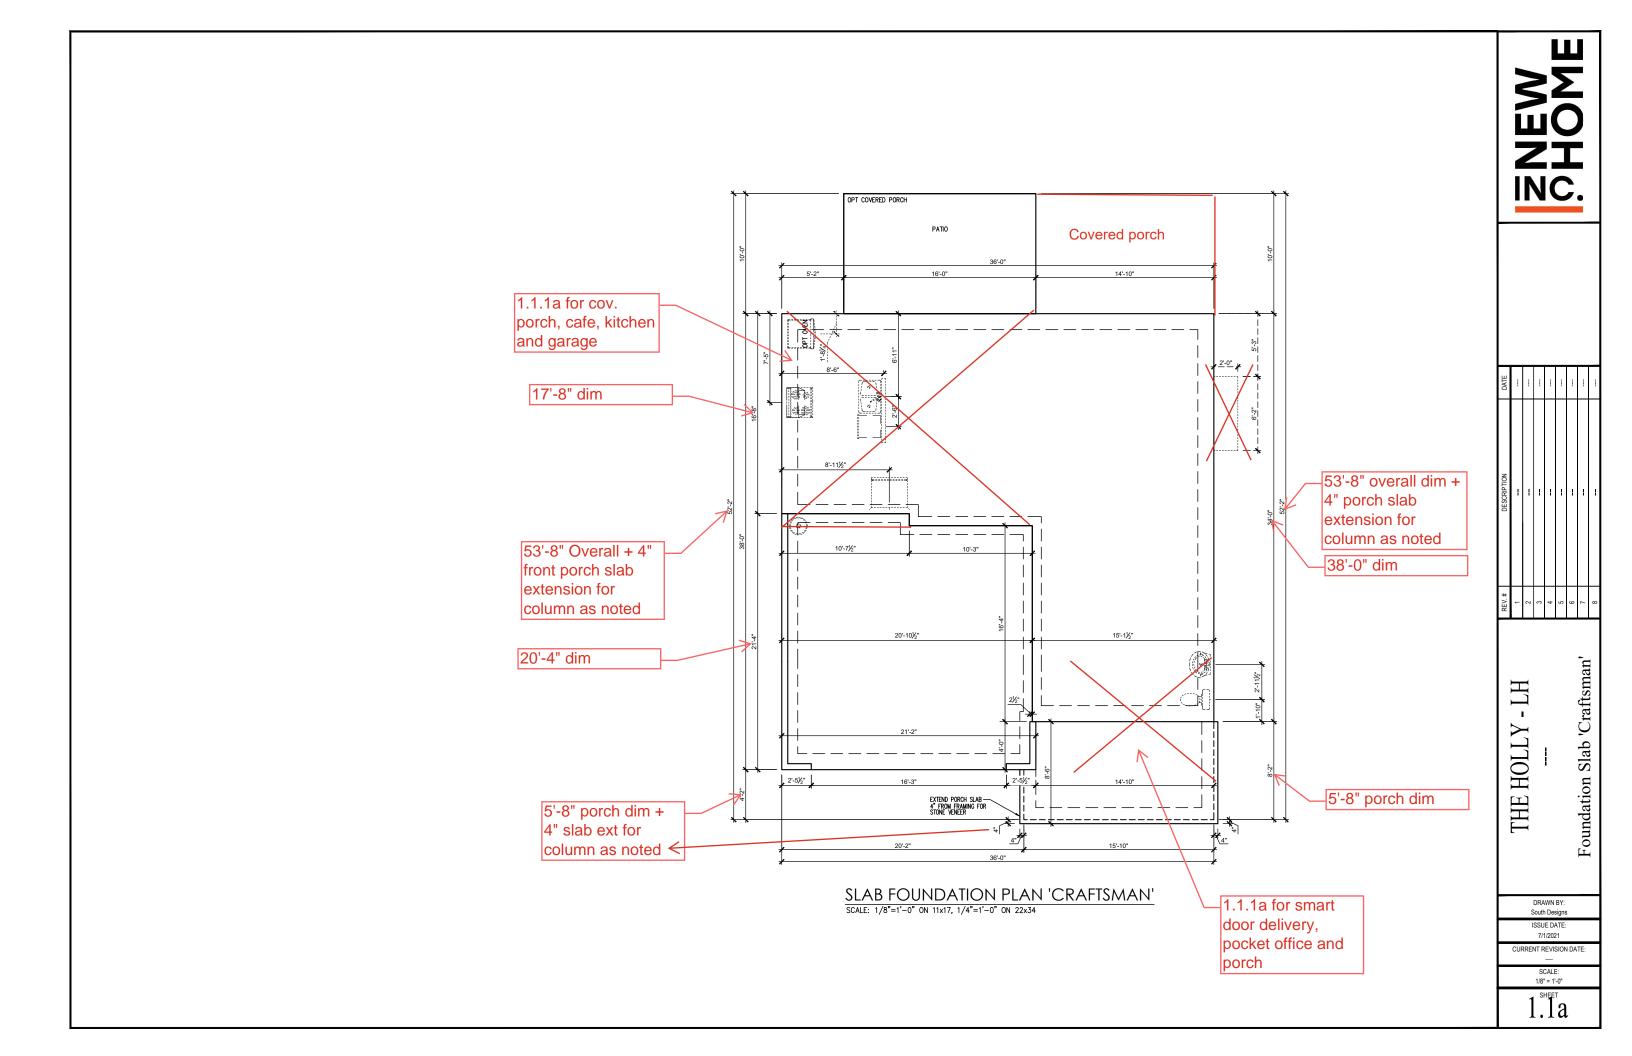

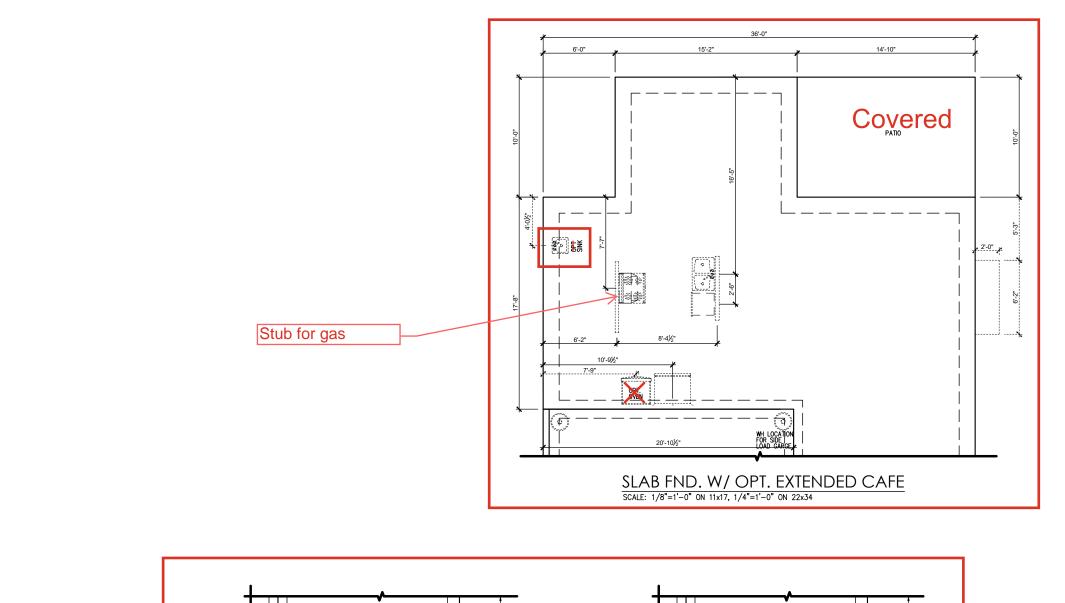



REV. #	DESCRIPTION	DATE
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THE HOLLY - LH
--Foundation Options Slab 'Craftsman'

DRAWN BY: South Designs


ISSUE DATE: 7/1/2021 CURRENT REVISION DATE:

SCALE: 1/8" = 1'-0"

1.1.1a

General Floor Plan Notes shall apply unless noted otherwise on plan.

- Wall Heights: Typically 9'-1 1/2" at first floor and 8'-1 1/2" at second floor and attics U.N.O. All walls are constructed using a double top plate. Splices at Double Top Plate do not need to occur at Vertical Studs but must be at least 24" apart from Joint in other Top Plate layer. Special wall heights are noted on plans where they occur.
- Wall Thickness is typically 3 1/2". 2x6 frame shall be used at walls that back up to plumbing fixtures.
 Walls greater than 10' high shall be framed with 2x6 framing or greater and will be noted as a special condition where it occurs on plan.
- Typical header height shall be 6'-11" AFF at First Floor, and 6'-11" AFF at Second Floor U.N.O. on elevation drawings. Windows at front elevation may be higher at the first floor.
- 4. Jacks: Openings up to 3'-4" wide shall have (1) 2x4 jack stud SPF on each side. Openings greater than 3'-4" wide shall have (2) 2x4 jack studs SPF on each
- Soffits, Coffered Ceilings, Trey Ceilings and other significant ceiling plan elements are shown on the floor plans and are denoted as single dashed lines. Unless specifically call out as included, Kitchens do not include soffits over wall cabinetry.
- Door & Window Frames, where occurring near corners, shall be a minimum of 4 1/2" from corner. Except for walk-in closets with doors near a corner, doors at closets shall be centered on closet.
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- Closets for clothing or coat storage shall be equipped with 1 rod/shelf. Closets for linen shall have 4 open equal shelves. Closets for pantries shall have 4 equal wood shelves, painted.
- Stair treads shall be a min of 9" deep, risers shall be a maximum of 8 1/4", unless noted otherwise, per the current North Carolina Residential Code
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- 12.Garage Door to Living Space shall be 2'-8" x 6'-8" minimum size and shall be 20 minute fire rated and
- 13. Garage Walls, as a minimum, shall be separated from living space by installing 1/2" gypsum board on the garage side of the wall. With habitable space above, the inside of all garage walls require 1/2" GWB supporting 5/8" type X GWB on ceiling.

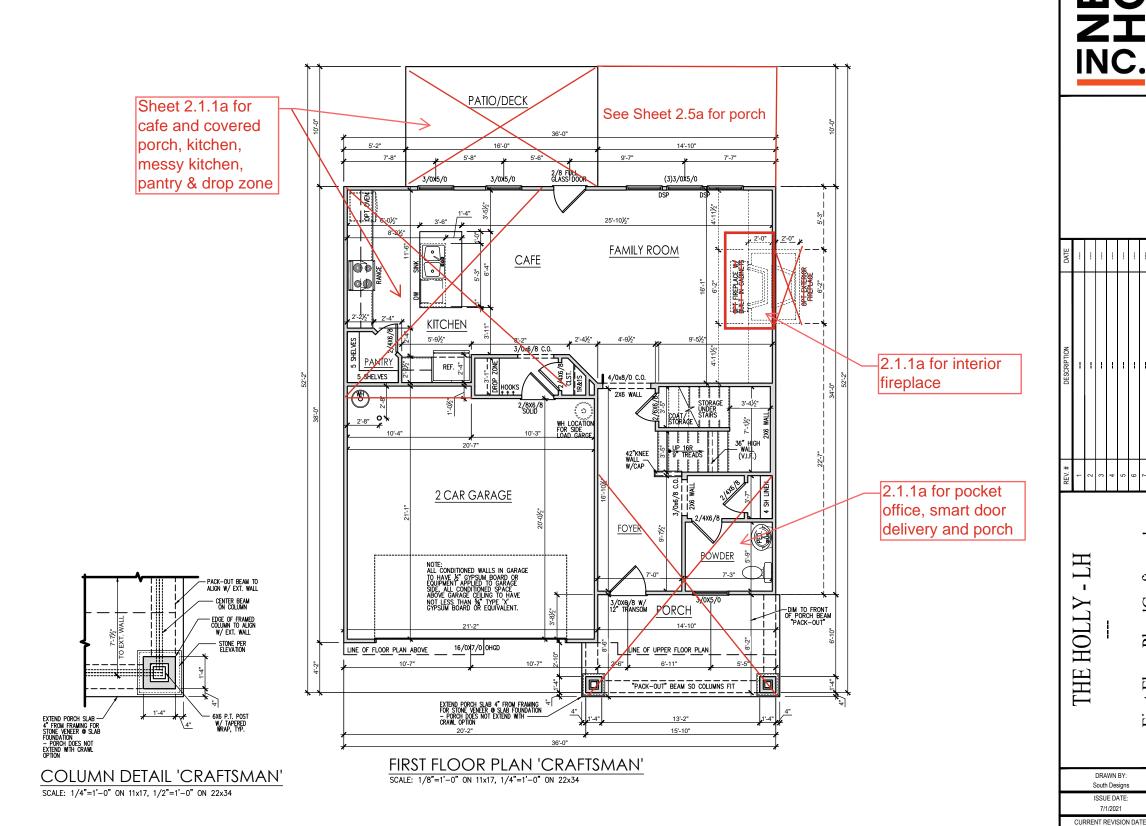

'Craftsman'

Plan

First Floor

DRAWN BY:


South Designs


ISSUE DATE: 7/1/2021

1/8" = 1'-0" 2.Îa

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- Stair treads shall be a min of 9" deep, risers shall be a maximum of 8 1/4", unless noted otherwise, per the current North Carolina Residential Code
- 10. Handrails and Guards at stairs shall be 34" above the finished surface of the ramp surface of the stair. Handrails at landings and overlooks of multilevel spaces shall be 36" above finished floor. Guards (pickets or balusters) shall be spaced with no more than 4" between guards.
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OPT. POCKET OFFICE
W/SMART DOOR DELIVERY CENTER
SCALE: 1/8"=1'-0" ON 11x17, 1/4"=1'-0" ON 22x34

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---First Floor Plan Options 'Craftsman'

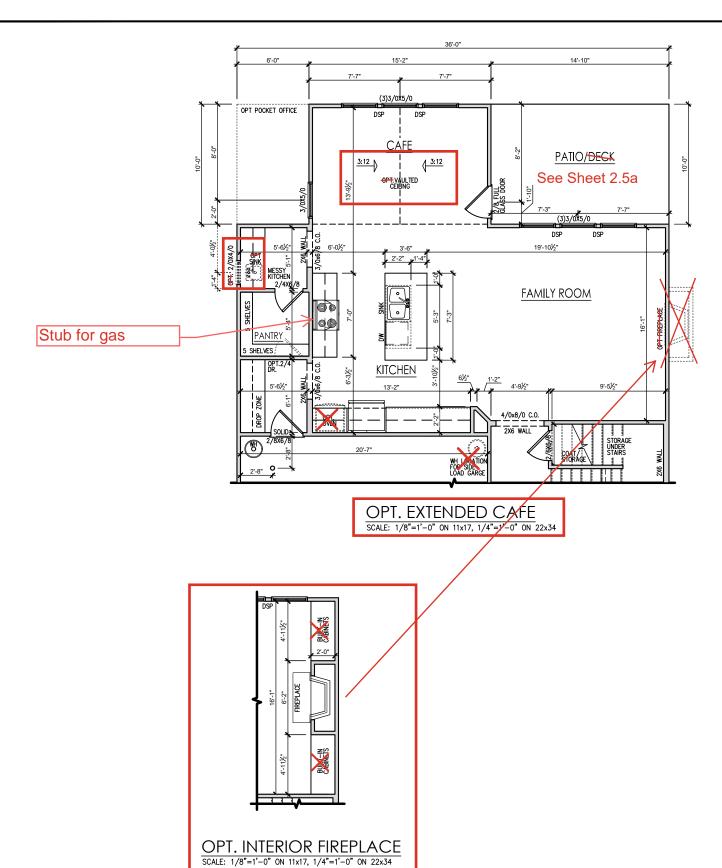- LH

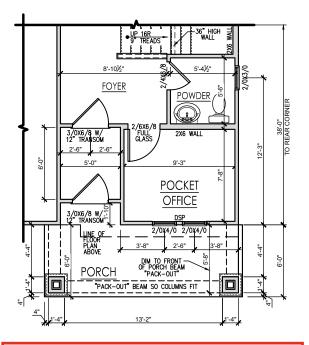THE HOLLY

DRAWN BY: South Designs


ISSUE DATE:

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---SCALE:
1/8" = 11.0"

2.1.1a

General Floor Plan Notes shall apply unless noted otherwise on plan.

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---Second Floor Plan 'Craftsman'

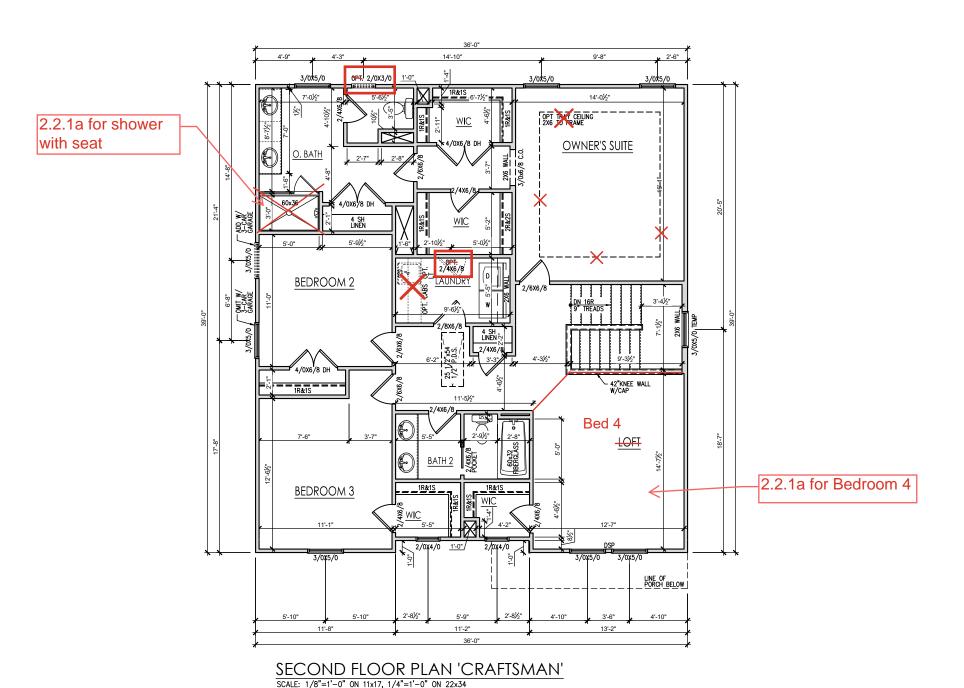- LH

THE HOLLY

DRAWN BY: South Designs

South Designs
ISSUE DATE:
7/1/2021


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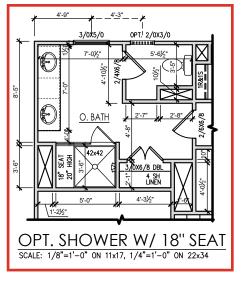
1/8" = 1'-0" SHEET

2.23

General Floor Plan Notes shall apply unless noted otherwise on plan.

- Wall Heights: Typically 9'-1 1/2" at first floor and 8'-1 You'reignis. Typicully 7-11/2 an iss noot and 5-11/2" at second floor and affics U.N.O. All walls are constructed using a double top plate. Splices at Double Top Plate do not need to occur at Vertical Studs but must be at least 24" apart from Joint in other Top Plate layer. Special wall heights are noted on plans where they occur.
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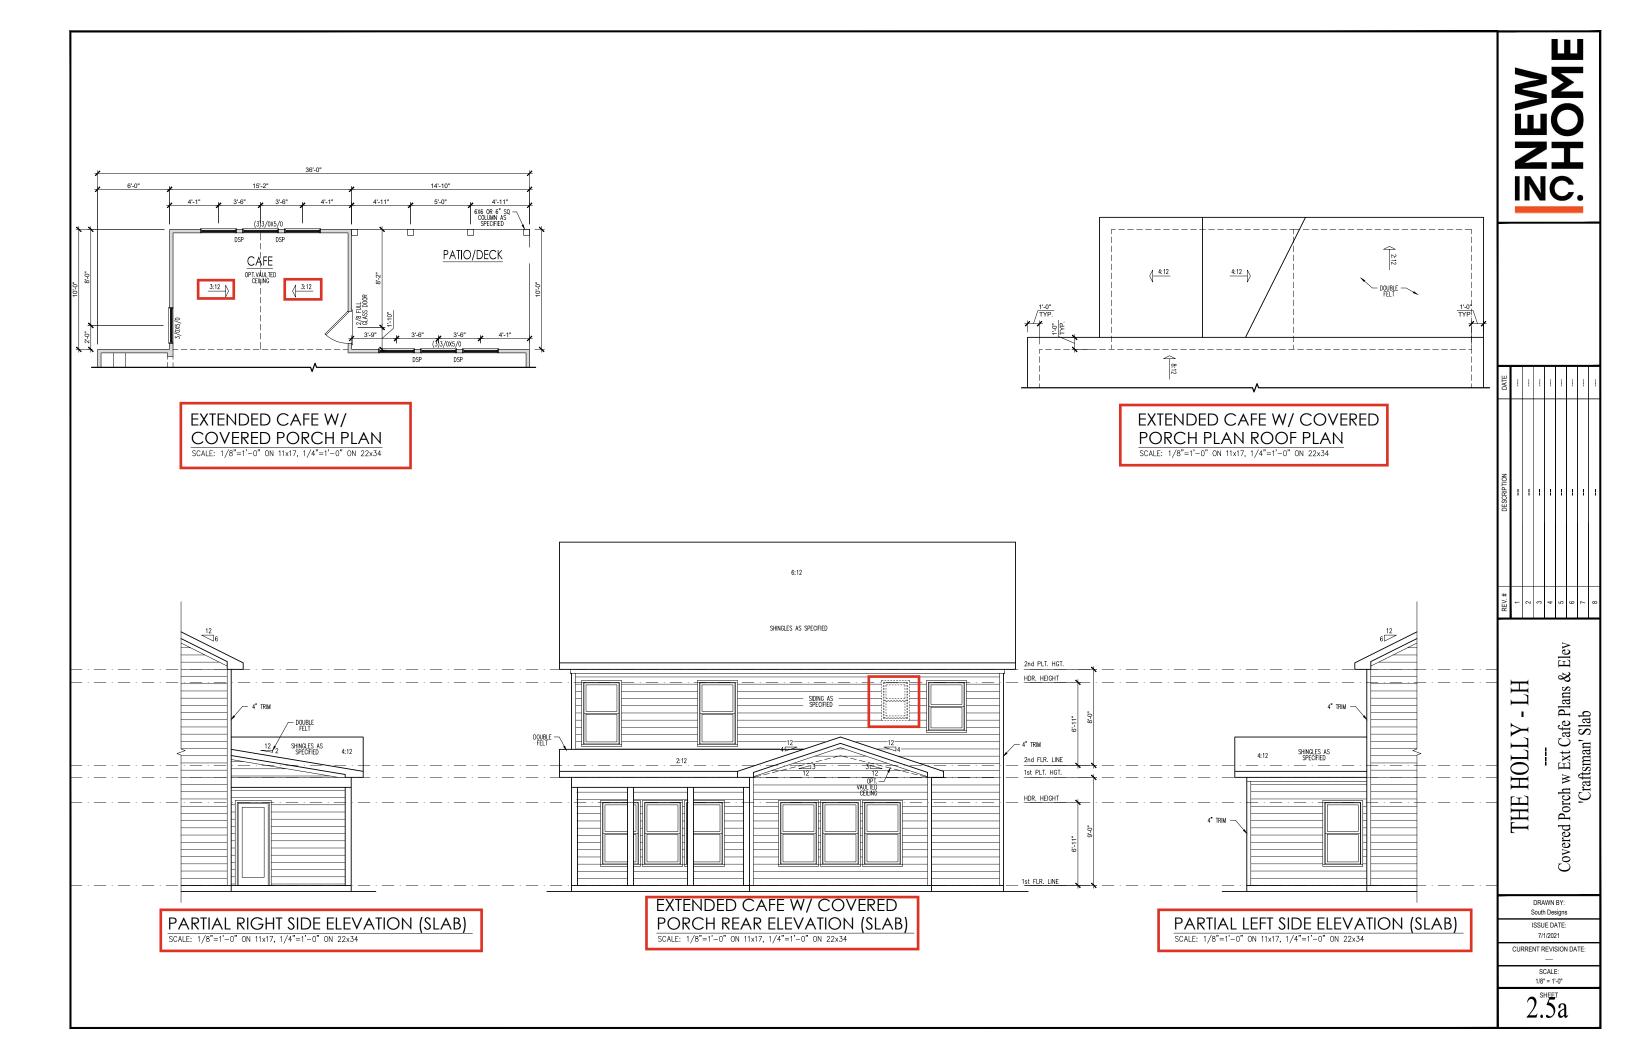
Second Floor Plan Options 'Craftsman' - LH THE HOLLY

> DRAWN BY: South Designs

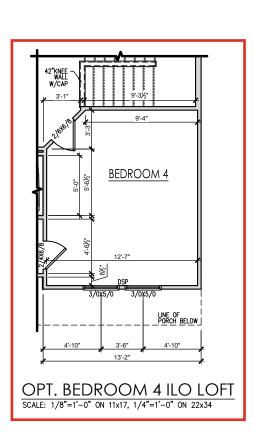ISSUE DATE: 7/1/2021

CURRENT REVISION DATE:

1/8" = 1'-0"



General Elevation Notes

General Elevation Notes shall apply unless noted otherwise on plan.


- Roof shall be finished with architectural composition shingles with slopes as noted on plan.
- Ridge Vent shall be provided and installed on all ridges greater than 6' in length per manufacturer's specifications.
- 3. Soffit Vent shall be continuous soffit vent
- House Wrap, "tyvek" or approved equal shall be installed over entire exterior wall per manufacturer's specifications and recommendations.
- Flashing shall be provided above all door and window openings, above finish wall material changes and at wall surfaces where lower roof areas abut vertical wall surfaces.
- Porch Roilings shall be provided at all porch walking surfaces greater than 30" above adjacent finished grade. It shall be 36" high with guards spaced no more than 4" apart. Consult community specifications for material.
- Finish Wall Material shall be as noted on elevation drawings.
- 8. Brick Veneer, if included on elevation shall be tied to wall surface with galvanized corrugated metal ties at a rate of 24" oc horizontally and 16" oc vertically so that no more than 2.67st of brick is supported by (1) tie. Space between face of wall and back face of brick shall be limited to a maximum of 1". Flashing shall be provided behind brick above all wall openings and at base of brick wall. Flashing shall be a minimum of 6 and 10 poly or other corrosion resistant material and shall be installed so that it laps under the house wrap material a minimum of 2".

 Weepholes shall be provided at a rate of 48" oc and shall not be less than 3/16" in diameter and shall be located immediately above flashing.
- Brick Veneer Support Lintels shall be provided if brick veneer is included on elevation. Lintels shall be provided as listed in the following schedule and shall have a minimum bearing length of 6". Masonry Lintels shall be provided so that deflection is limited to 1/600.

Masonry Opening Lintel Schedule

Opening Size Angle

ot au	4'-0"		3-1/2" x 3-1/2" x 5/
4'-1"	to	5'-6"	4" x 3-1/2" x 5/16" L
5'-7"	to	6'-6"	5" x 3-1/2" x 5/16" L
6'-7"	to	8'-4"	6" x 3-1/2" x 5/16" L
8'-5"	to	16'-4"	7" x 4" x 3/8" LLV

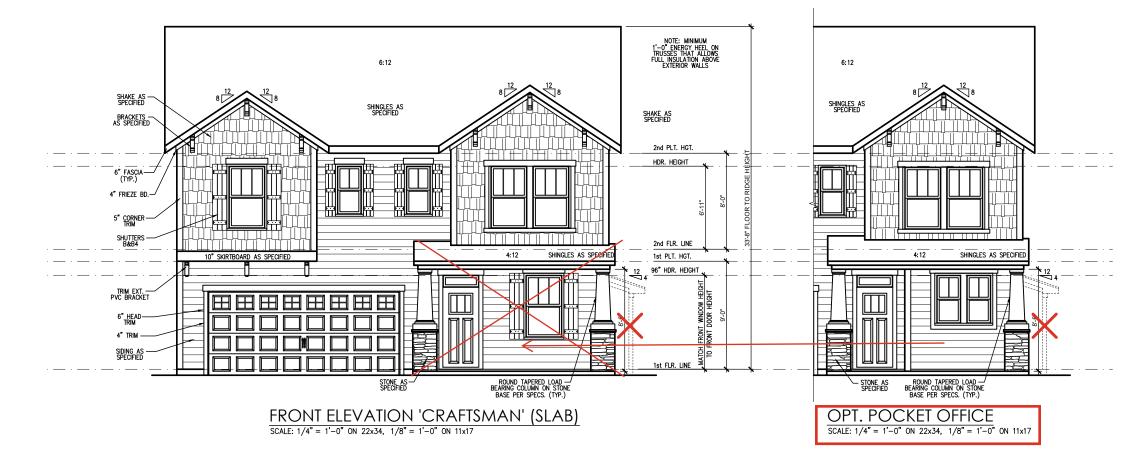



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THE HOLLY - LH --- Front & Rear Elevations 'English Country' Slab

DRAWN BY: South Designs

ISSUE DATE: 7/1/2021

CURRENT REVISION DATE:
---SCALE:
1/8" = 1'-0"

3.Îa

General Elevation Notes


General Elevation Notes shall apply unless noted otherwise on plan.


- Roof shall be finished with architectural composition shingles with slopes as noted on plan.
- Ridge Vent shall be provided and installed on all ridges greater than 6' in length per manufacturer's specifications.
- 3. Soffit Vent shall be continuous soffit vent
- House Wrap, "tyvek" or approved equal shall be installed over entire exterior wall per manufacturer's specifications and recommendations.
- Flashing shall be provided above all door and window openings, above finish wall material changes and at wall surfaces where lower roof areas abut vertical wall surfaces.
- Porch Railings shall be provided at all porch walking surfaces greater than 30" above adjacent finished grade. It shall be 36" high with guards spaced no more than 4" apart. Consult community specifications for material.
- Finish Wall Material shall be as noted on elevation
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Masonry Opening Lintel Schedule


Opening Size	Ang
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3-1/2" x 3-1/2" x 5/16" 4" x 3-1/2" x 5/16" LLV 5" x 3-1/2" x 5/16" LLV 6" x 3-1/2" x 5/16" LLV 7" x 4" x 3/8" LLV up to 4'-0" 4'-1" to 5'-6" 5'-7" to 6'-6" 6'-7" to 8'-4" 8'-5" to 16'-4"





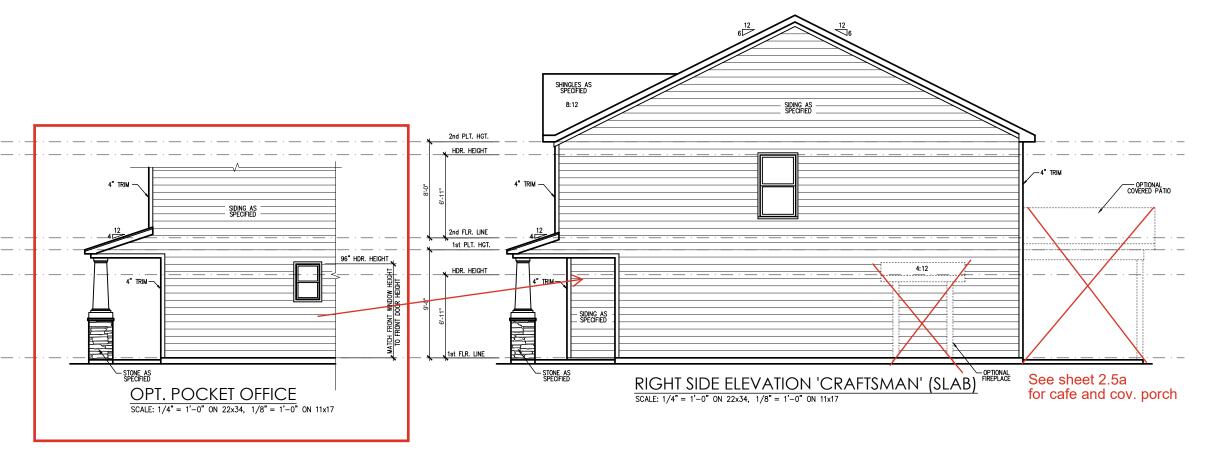

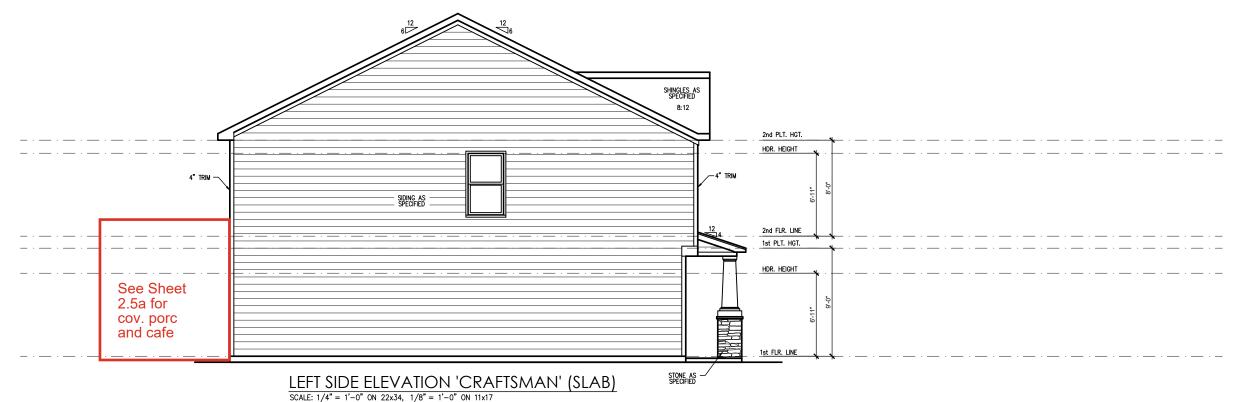

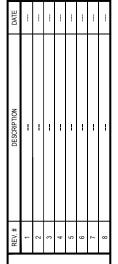
Slab HT Side Elevations 'Craftsman' THE HOLLY

1

DRAWN BY: South Designs ISSUE DATE:

7/1/2021 CURRENT REVISION DATE:

SCALE: 1/8" = 1'-0"

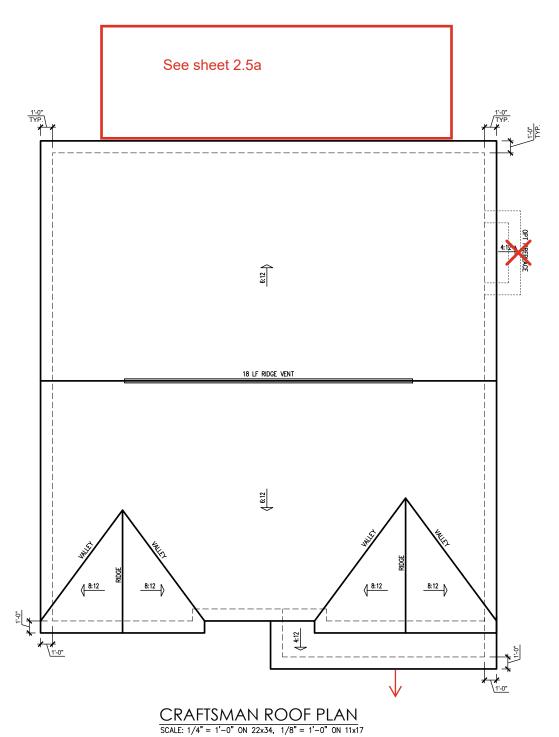

	ATTIC VENT SCHEDULE												
	CRAFTSMAN												
MAIN	HOUSE		SQ FTG	1393	AT / NEAR RIDGE			AT / NEAR EAVE					
VENT TYPE	SQ. FT. VENT TYPE REQUIRED		SQ. FT.	PERCENT OF TOTAL	POT LARGE (SQ. FT. EACH)	POT SMALL (SQ. FT. EACH)	RIDGE VENT (SQ. FT. PER LF)	EAVE VENT (SQ. IN. EACH)	CONT. VENT (SQ. IN. PER LF)				
	RAN		SUPPLIED	SUPPLIED	0.4236	0.2778	0.125	0.1944	0.0625				
0													
RIDGE VENT	1.86	2.32	3.00	44.44	0	0	24.00						
SOFFIT VENTS	2.79	2.32	3.75	55.56				0	60.00				
TOTAL (MIN)	4.64	4.64	6.75	100.00	POT VENTS MAY BE	POT VENTS MAY BE REQUIRED IF THERE IS INSUFFICIENT RIDGE AVAILABLE							

* SCHEDULE HAS BEEN CALCULATED ASSUMING EAVE VENTILATION AT 50-60% OF TOTAL AND RIDGE AT 40-50% OF TOTAL REQUIRED VENTILATION

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THE HOLLY - LH
--Roof Plan 'Craftsman'

DRAWN BY: South Designs

ISSUE DATE:
7/1/2021

CURRENT REVISION DATE:

SCALE: 1/8" = 1'-0"

3.3a

PROJECT # 21-2816.1-LH

Southern Engineers, P.A.
3716 Benson Drive, Raleigh, NC 27609
Phone: (919) 878-1617
License: C-4772

SOUTH DESIGNS

- LH NEW HOME, INC.

The Holly Plan

S-1.1

- 12" WIDE TURN-DOWN FTG. FOR COVERED PATIO 32"x32"x12"-CONC. FTG.

SLAB FND. W/ EXT. CAFE & OPT. POCKET OFFICE

15'-2" - 12" WIDE TURN-DOWN FTG. FOR COVERED PATIO IOOA SD I6" WIDE TURNDOWN FTG. 32"x32"x12" — CONC. FTG. ∠24"x24"x10"∠ CONC. FTG. _32"x32"x12" CONC. FTG. IO4A SD I8" WIDE xIO" DEEP (TYP.) 18" WIDE


> SLAB FND. W/ OPT. EXTENDED CAFE SCALE: 1/8"=1'-0" ON 11x17, 1/4"=1'-0" ON 22x34

SLAB FND. W/OPT. FIREPLACE SCALE: 1/8"=1'-0" ON 11x17, 1/4"=1'-0" ON 22x34


32"x32"x12"_ CONC. FTG.

SCALE: 1/8"=1'-0" ON 11x17, 1/4"=1'-0" ON 22x34

*ONLY AVAILABLE W/ EXTENDED CAFE OPTION

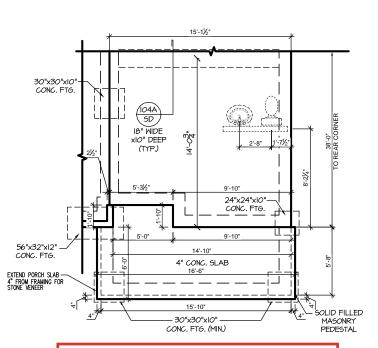

SLAB FND. W/OPT. SMART DOOR SCALE: 1/8"=1'-0" ON 11x17, 1/4"=1'-0" ON 22x34 *ONLY AVAILABLE W/ POCKET OFFICE OPTION

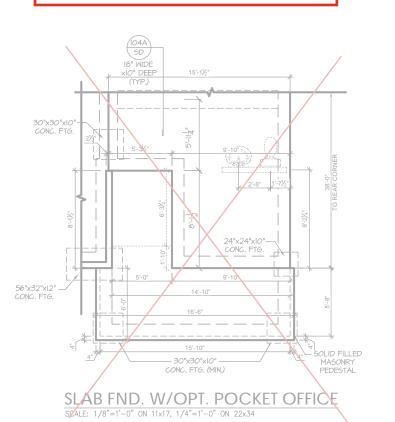

REFER TO "SD" SHEET(S) FOR STANDARD DETAILS, BRACING DETAILS AND STRUCTURAL NOTES. Southern Engineers, P. 3716 Benson Drive, Raleigh, NC 276 Phone: (919) 878-1617 License: C-4772 www.southernengineers.com SOUTH DESIGNS

P.A. 27609

The Holly NEW HOME, Plan

TRUSS SYSTEM REQUIREMENTS NC (2018 NCRC): Wind: 115-120 mph

- TRUSS SYSTEM LAYOUTS (PLACEMENT PLANS)
 SHALL BE DESIGNED IN ACCORDANCE WITH SEALED STRUCTURAL PLANS. ANY NEED TO CHANGE TRUSSES SHALL BE COORDINATED WITH SOUTHERN
- TRUSS SCHEMATICS (PROFILES) SHALL BE PREPARED AND SEALED BY TRUSS MANUFACTURER.
- ALL TRUSSES SHALL BE DESIGNED FOR BEARING ON SPF #2 OR #3 PLATES OR LEDGERS (UNO).
- ALL REQUIRED ANCHORS FOR TRUSSES DUE TO JIPLIET OR BEARING SHALL MEET THE REQUIREMENTS AS SPECIFIED ON THE TRUSS SCHEMATICS

HEADER/BEAM & COLUMN NOTES

- I. ALL EXTERIOR AND LOAD BEARING HEADERS SHALL BE MIN. (2)2x6 (4" WALL) OR (3)2x6 (6" WALL) WITH (1) SUPPORT STUD, UNLESS NOTED
- 2. THE NUMBER SHOWN AT BEAM AND HEADER SUPPORTS INDICATES THE NUMBER OF SUPPORT STUDS REQUIRED IN STUD POCKET OR COLUMN. THE NUMBER OF KING STUDS AT EACH END OF HEADERS IN EXTERIOR WALLS SHALL BE ACCORDING TO ITEM "d" IN TABLE R602.3(5) OR AS BELOW PER NCDOI COMMENTARY "KING STUDS AT WALL OPENINGS" REVISED I-9-2020:
- UP TO 3' SPAN; (I) KING STUD OVER 3' UP TO 6' SPAN: (2) KING STUDS
- OVER 6' UP TO 9' SPAN; (3) KING STUDS
- OVER 9' UP TO 12' SPAN: (4) KING STUDS
- OVER 12' UP TO 15' SPAN: (5) KING STUDS

- BCI 5000s 18 BY BC
- ALL WOOD "I"JOISTS SHALL BE INSTALLED ACCORDING TO MANUFACTURER'S SPECIFICATIONS.
- INSTALL SQUASH BLOCKS, WEB STIFFENERS, ETC. AS REQUIRED BY AND ACCORDING TO THE I-JOIST MANUFACTURER'S SPECIFICATIONS
- HANGERS FOR I-JOISTS ARE THE RESPONSIBILITY OF THE I-JOIST SUPPLIER.
- FLOOR TRUSSES BY MANUFACTURER MAY BE

PORCH POST NOTES:

- 4X4 (6x6) TRT'D POST (OR EQUAL).
 ATTACH TRUSSES (RAFTERS) AT PORCH WITH HURRICANE CONNECTORS.

 POST CAP: SIMPSON AC4-MAX (AC6-MAX)
- POST CAP AT CORNER: (2) SIMPSON LCE4
- SIMPSON H6.

 3. POST BASE: SIMPSON ABU44 (ABU66).
- 3.1. MOND: \$\frac{8}{8} \text{ ANCHOR (EMBED 1")}
 3.2. \text{CMU}. \$\frac{8}{8} \text{ ANCHOR (EXTEND TO FOOTING HIGH WIND ONLY)}
 4. \text{POST BASE. WOOD FOUNDATION: (2) SIMPSON
- NOTE: THE ABOVE CONNECTORS ARE AND/OR ARE APPROVED BY THE BUILDING INSPECTOR MAY BE SUBSTITUTED.

FRAMING NOTES

NC (2018 NCRC): Wind: 115-120 mph


- BRACING METHOD AND TYPE: CONTINUOUSLY SHEATHED WSP: CS-WSP. NOTE THAT THE WALL BRACING AMOUNT PROVIDED ON THE PLANS (DETAILS AND SPECIFICATIONS) IS GREATER THAN THE AMOUNT OF WALL BRACING REQUIRED BY SECTION R602 IO OF THE CODE, SEE NOTES BELOW FOR DETAILS AND SPECIFICATIONS FOR WALL BRACING AND WALL FRAMING.
- EXTERIOR WALL SHEATHING: WALLS SHALL BE BRACED BY SHEATHING WALLS ON ALL STORIES WITH WOOD STRUCTURAL PANEL SHEATHING (MSP) (EXPOSURE B: 7/16". EXPOSURE C: 15/32"). SHEATHING SHALL BE ATTACHED WITH 8d NAILS AT A 6"/12" NAILING PATTERN (6" OC AT PANEL EDGES AND 12" OC AT INTERMEDIATE SUPPORTS). INSTALL BLOCKING AT ALL PANEL EDGES.
- 3. WSP SHEATHING SHALL EXTEND TO THE UPPERMOST DOUBLE BEARING PLATE, BLOCK AT ROOF PER SECTION R602.10.45 AND ATTACH BRACED WALLS PER CODE. MSP SHEATHING BETWEEN FLOORS SHALL BE SPLICED ALONG CONTINUOUS BAND OR THE MSP SHEATHING MAY BE SPLICED ACROSS STUDS (CONTINUOUS ACROSS FLOOR SYSTEM) WITH BLOCKING AT PANEL EDGES. (MINIMUM 12" BEYOND FLOOR BREAK) OR OTHER APPROVED METHOD.
- "<u>HD" = HOLDOWN:</u> HOLD-DOWN DEVICE (NOTED AS "HD" ON PLANS) SHALL BE AN 800 POUND CAPACITY ASSEMBLY AS NOTED ON PLANS. SEE DETAILS FOR HD ASSEMBLY.
- **GROUND/FIRST FLOOR: USE "HD HOLD-DOWN DETAIL" ON SD SHEET (OR EQUIV.)
- **UPPER FLOORS: ATTACH BASE OF KING STUD WITH A SIMPSON C520 OR C5HP20 STRAP DOWN ACROSS THE BAND AND DOWN TO A STUD BELOW OR HEADER BELOW. EXTEND STRAP T" MIN ALONG EACH STUD (OR HEADER) AND ATTACH EACH END W (7) 8d NAILS.
- 5. INTERIOR BRACED WALL: (NOTED AS "IBW" ON PLANS) ATTACH I/2" GYPSIM BOARD (GB) ON EACH SIDE OF WALL WITH A MIN. OF 5d COOLER NAILS OR #6 SCREWS @ 7" O.C. ALONG THE EDGES AND AT INTERMEDIATE SUPPORTS. SEE SECTION R602.10.4.4 OF THE CODE.
- 6. INTERIOR BRACED WALL-WOOD STRUCTURAL PANEL: (NOTED AS "IBW-WSP" ON PLANS). ATTACH ONE SIDE WITH 1/6" WSP SHEATHING WITH 8d NAILS AT A 6"/12" NAILING PATTERN (6" OC AT PANEL EDGES AND 12" OC AT INTERMEDIATE SUPPORTS). INSTALL BLOCKING AT ALL PANEL EDGES. ATTACH GB OVER WSP AS REQUIRED. ATTACH OPPOSITE SIDE WITH I/2" GB WITH A MIN. OF 5d COOLER NAILS OR #6 SCREWS @ 7" OC ALONG THE EDGES AND AT INTERMEDIATE SUPPORTS. SEE SECTION R602.10.4.4 OF THE CODE.

MOOD "I" JOISTS (SHALL BE ONE OF THE FOLLOWING):

- TJI 210 BY TRUS JOIST LPI 20 PLUS BY LP
- AND INSTRUCTIONS.

- (MITER HEADER AT CORNER). HIGH WIND; ADD (I)

- CSI6 STRAPS AT POSTS. EXTEND 12" ONTO EACH POST (UPPER AND LOWER) OR TO GIRDER
- SUGGESTIONS. EQUIVALENT CONNECTORS THAT MEET THE REQUIREMENTS OF THE NC RESIDENTIAL BUILDING CODE LOCAL CODES

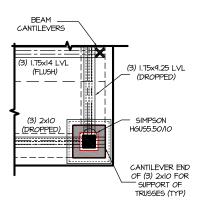


COLUMN DETAIL 'CRAFTSMAN'

SCALE: 1/4"=1'-0" ON 11x17, 1/2"=1'-0" ON 22x34

S-2.1.1 for cafe,

CARO

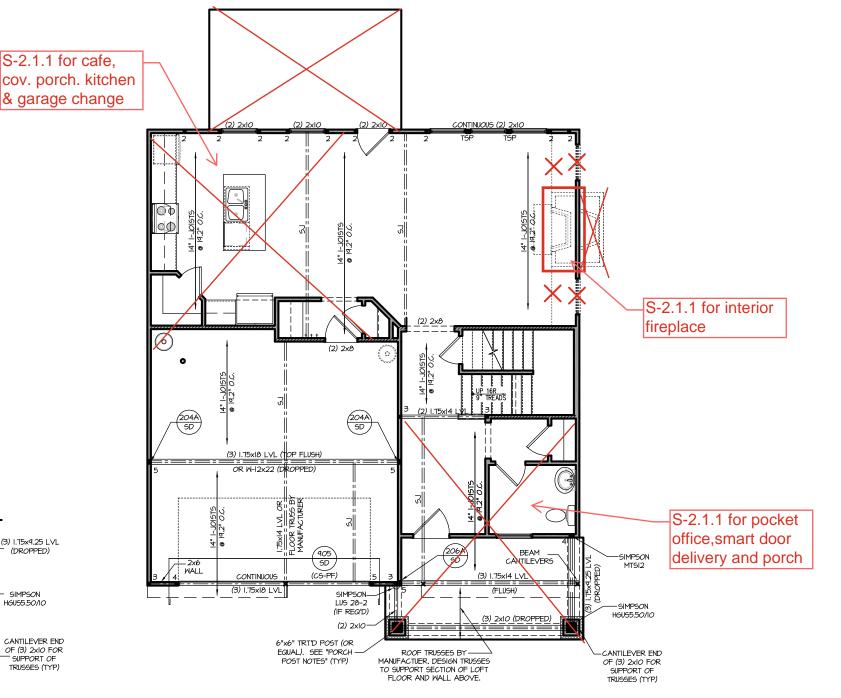


FIRST FLOOR PLAN 'CRAFTSMAN'

SCALE: 1/8"=1'-0" ON 11x17, 1/4"=1'-0" ON 22x34

PROJECT # 21-2816.1-LH

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REFER TO "SD" SHEET(S) FOR STANDARD DETAILS BRACING DETAILS AND STRUCTURAL NOTES.

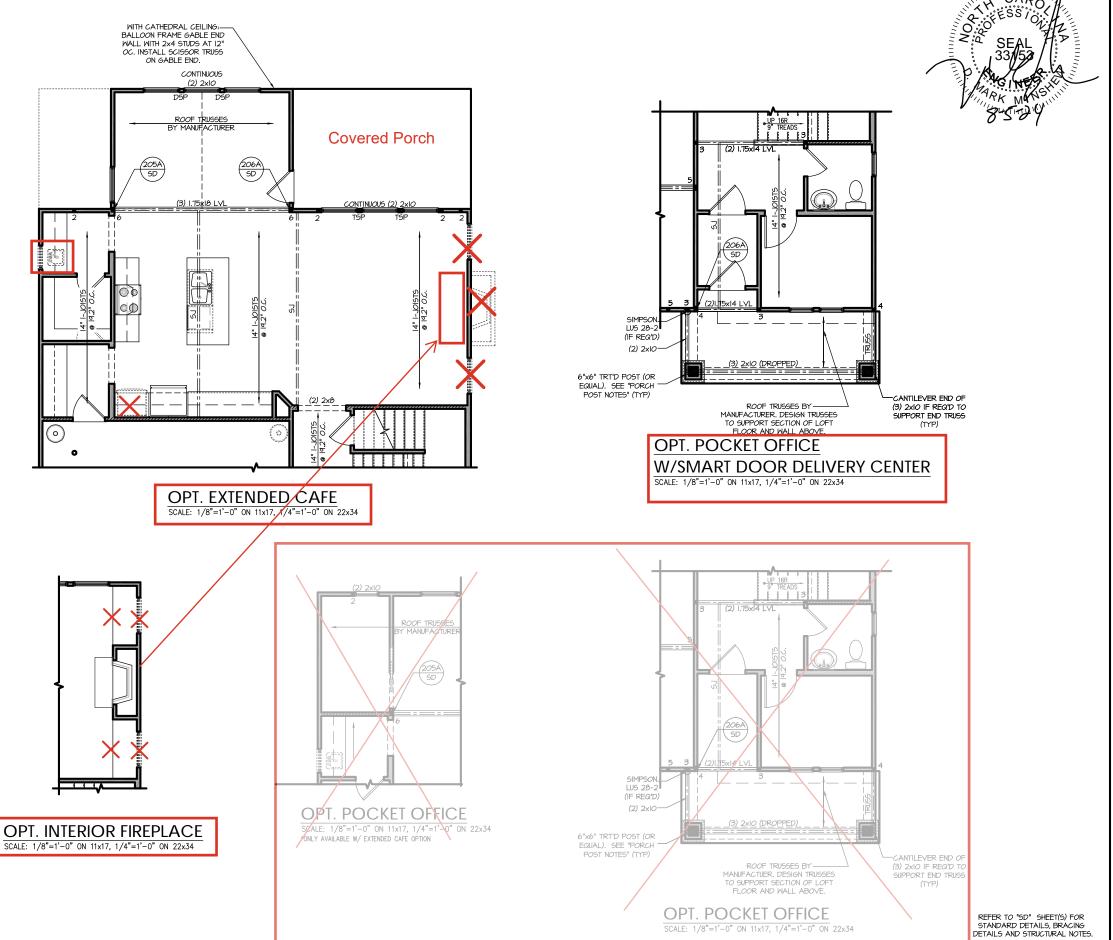

PROJECT # 21-2816.1-LH

2816.1-LI

eal does not include construction means, methods, techniques, squences, procedures or safety precautions.

ny deviations or discrepancies on plans are to be brought to this minediate attention of Southern Engineers. Failure to do so will minediate attention of Southern Engineers, Failure to do so will not show the Engineers at shalling as

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SOUTH DESIGNS

Plan 2 - The Holly - LH
NEW HOME, INC.

S-2.1.1

TRUSS SYSTEM REQUIREMENTS NC (2018 NCRC): Wind: 115-120 mph

- I. TRUSS SYSTEM LAYOUTS (PLACEMENT PLANS)
 SHALL BE DESIGNED IN ACCORDANCE WITH SEALED
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 TRUSSES SHALL BE COORDINATED WITH SOUTHERN
 ENGINEERS.
- TRUSS SCHEMATICS (PROFILES) SHALL BE
 PREPARED AND SEALED BY TRUSS MANUFACTURER.
- ALL TRUSSES SHALL BE DESIGNED FOR BEARING ON SPF #2 OR #3 PLATES OR LEDGERS (UNO).
- ALL REQUIRED ANCHORS FOR TRUSSES DUE TO UPLIFT OR BEARING SHALL MEET THE REQUIREMENTS AS SPECIFIED ON THE TRUSS SCHEMATICS

HEADER/BEAM & COLUMN NOTES

- I. ALL EXTERIOR AND LOAD BEARING HEADERS SHALL BE MIN. (2)2x6 (4" WALL) OR (3)2x6 (6" MALL) WITH (1) SUPPORT STUD, UNLESS NOTED OTHERWISE
- 2. THE NUMBER SHOWN AT BEAM AND HEADER SUPPORTS INDICATES THE NUMBER OF SUPPORT STUDS REQUIRED IN STUD POCKET OR COLUMN. THE NUMBER OF KING STUDS AT EACH END OF HEADERS IN EXTERIOR WALLS SHALL BE ACCORDING TO ITEM "d" IN TABLE R602.3(5) OR AS BELOW PER NCDOI COMMENTARY "KING STUDS AT WALL OPENINGS" REVISED 1-4-2020:
- •• UP TO 3' SPAN: (I) KING STUD
- OVER 3' UP TO 6' SPAN: (2) KING STUDS
- OVER 6' UP TO 9' SPAN: (3) KING STUDS
 OVER 9' UP TO 12' SPAN: (4) KING STUDS
- OVER 12' UP TO 15' SPAN: (5) KING STUDS

FRAMING NOTES

NC (2018 NCRC): Wind: 115-120 mph

- I. BRACING METHOD AND TYPE: CONTINUOUSLY SHEATHED WSP: CS-WSP. NOTE THAT THE WALL BRACING AMOUNT PROVIDED ON THE PLANS (DETAILS AND SPECIFICATIONS) IS GREATER THAN THE AMOUNT OF WALL BRACING REQUIRED BY SECTION R602.10 OF THE CODE. SEE NOTES BELOW FOR DETAILS AND SPECIFICATIONS FOR WALL BRACING AND WALL FRAMING.
- 2. EXTERIOR WALL SHEATHING: WALLS SHALL BE BRACED BY SHEATHING WALLS ON ALL STORIES WITH WOOD STRUCTURAL PANEL SHEATHING (WGP) (EXPOSURE B: 17/6", EXPOSURE C: 15/32"), SHEATHING SHALL BE ATTACHED WITH 8d NAILS AT A 6"/12" NAILING PATTERN (6" OC AT PANEL EDGES AND 12" OC AT INTERMEDIATE SUPPORTS), INSTALL BLOCKING AT ALL PANEL EDGES.
- 3. WSP SHEATHING SHALL EXTEND TO THE UPPERMOST DOUBLE BEARING PLATE. BLOCK AT ROOF PER SECTION R6021/0.45 AND ATTACH BRACED WALLS PER CODE. WSP SHEATHING BETWEEN FLOORS SHALL BE SPLICED ALONG CONTINUOUS BAND OR THE MSP SHEATHING MAY BE SPLICED ACROSS STUDS (CONTINUOUS ACROSS FLOOR SYSTEM) WITH BLOCKING AT PANEL EDGES. (MINIMUM 12" BEYOND FLOOR BREAK) OR OTHER APPROVED METHOD.
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- **GROUND/FIRST FLOOR: USE "HD HOLD-DOWN DETAIL" ON SD SHEET
 (OR EQUIV.)
- (UK ELGIUY)


 **!!!PER FLOORS: ATTACH BASE OF KING STUD WITH A SIMPSON

 GS20 OR GSHP20 STRAP DOWN ACROSS THE BAND AND DOWN TO A

 STUD BELOW OR HEADER BELOW. EXTEND STRAP T" MIN ALONG EACH

 STUD (OR HEADER) AND ATTACH EACH END W (7) 84 NAILS.
- INTERIOR BRACED WALL: (NOTED AS "IBM" ON PLANS) ATTACH I/2" GYPSIM BOARD (GB) ON EACH SIDE OF WALL WITH A MIN, OF 5d COOLER NAILS OR "6 SCREMS @ 1" O.C. ALONG THE EDGES AND AT INTERMEDIATE SUPPORTS, SEE SECTION R602.10.4.4 OF THE CODE.
- 6. INTERIOR BRACED WALL-WOOD STRUCTURAL PANEL: (NOTED AS "IBW-WSP" ON PLANS). ATTACH ONE SIDE WITH 1/6" WSP SHEATHING WITH 8d NAILS AT A 6"1/12" NAILING PATTERN (6" OC AT PANEL EDGES AND 12" OC AT INTERMEDIATE SUPPORTS). INSTALL BLOCKING AT ALL PANEL EDGES, ATTACH GB OVER WSP AS REQUIRED. ATTACH OPPOSITE SIDE WITH 1/2" GB WITH A MIN. OF 5d COOLER NAILS OR #6 SCREYS @ 1" OC ALONG THE EDGES AND AT INTERMEDIATE SUPPORTS. SEE SECTION R602.10.4.4 OF THE CODE.



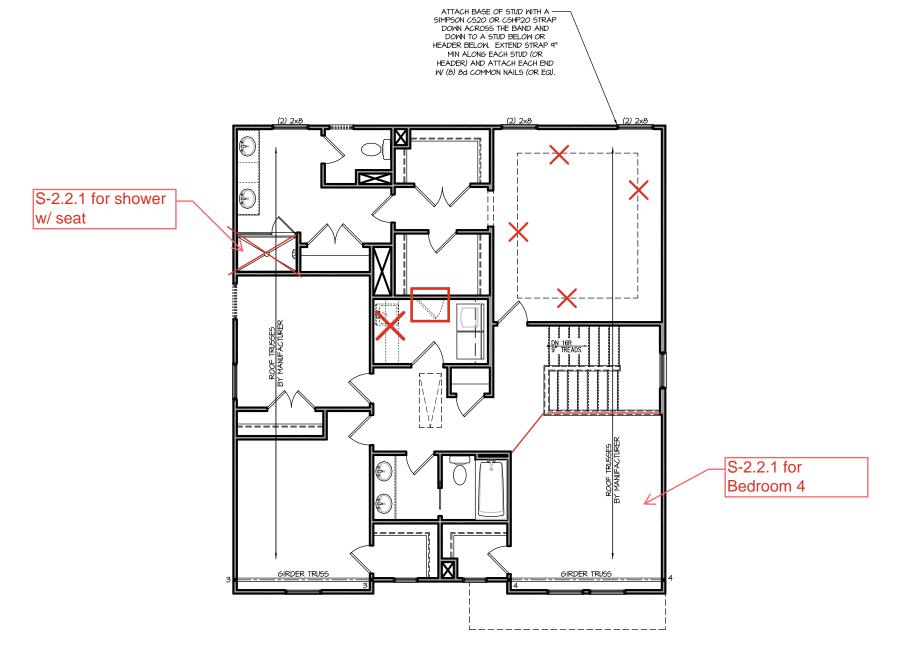

SECOND FLOOR PLAN 'CRAFTSMAN'

SCALE: 1/8"=1'-0" ON 11x17, 1/4"=1'-0" ON 22x34

PROJECT # 21-2816.1-LH

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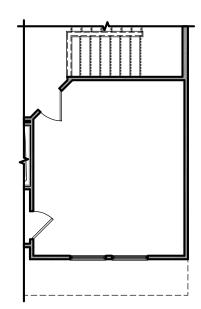
2 - The Holly - I NEW HOME, INC.

S-2.2


Plan

REFER TO "SD" SHEET(S) FOR

STANDARD DETAILS, BRACING DETAILS AND STRUCTURAL NOTES. NO STRUCTURAL CHANGES FROM BASE PLAN





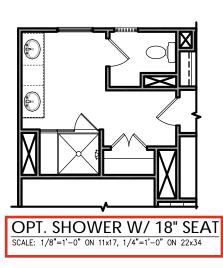





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PROJECT # 21-2816.1-LH

SOUTH DESIGNS

The Holly NEW HOME, INC.


Plan

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TRUSS SYSTEM REQUIREMENTS NC (2018 NCRC): Wind: 115-120 mph

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- ALL REQUIRED ANCHORS FOR TRUSSES DUE TO UPLIFT OR BEARING SHALL MEET THE REQUIREMENTS AS SPECIFIED ON THE TRUSS



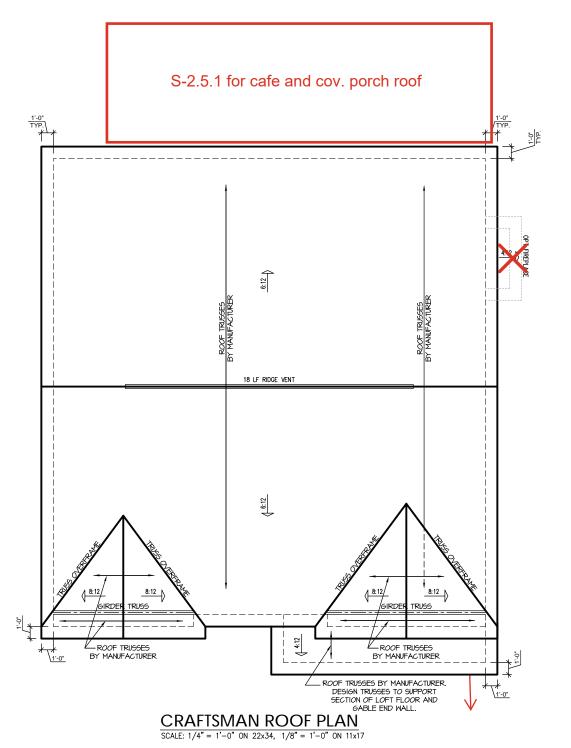

21-2816.1-LH

PROJECT #

Southern Engineers, P


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NEW HOME,


The Holly Plan

REFER TO "SD" SHEET(S) FOR STANDARD DETAILS, BRACING DETAILS AND STRUCTURAL NOTES.



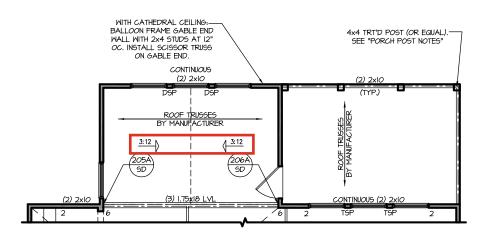

EXTENDED CAFE W/
COVERED PORCH PLAN
SCALE: 1/8"=1'-0" ON 11x17, 1/4"=1'-0" ON 22x34

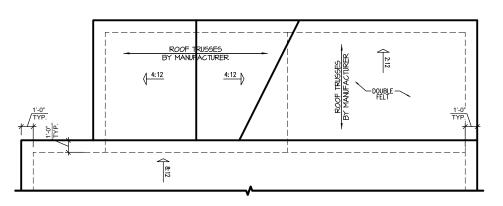

EXTENDED CAFE W/ COVERED PORCH PLAN ROOF PLAN

SCALE: 1/8"=1'-0" ON 11x17, 1/4"=1'-0" ON 22x34



REFER TO "SD" SHEET(S) FOR STANDARD DETAILS, BRACING DETAILS AND STRUCTURAL NOTES. PROJECT # 21-2816.1-LH


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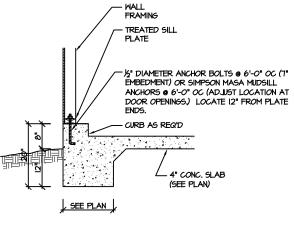
SOUTH DESIGNS

Plan 2 - The Holly - LH NEW HOME, INC.


S-2.5.







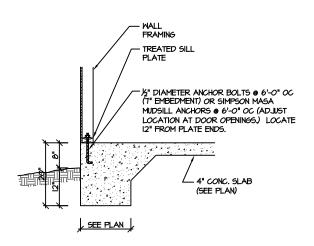



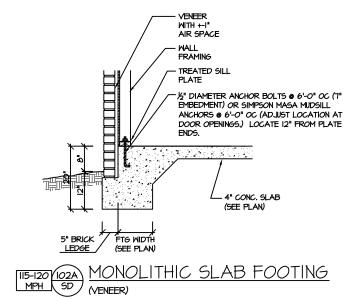

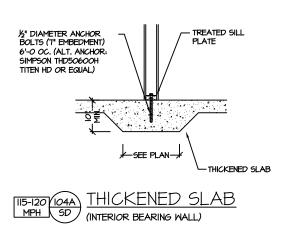

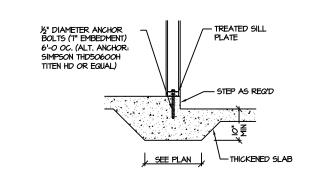



PROJECT # 21-2816.1

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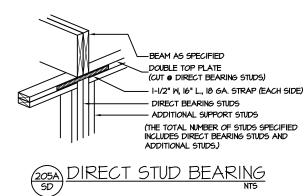
SOUTH DESIGNS


THE HOLLY NEW HOME, INC. \sim **PLAN**


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SLAB FOUNDATION







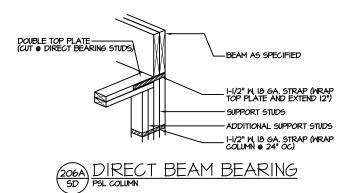

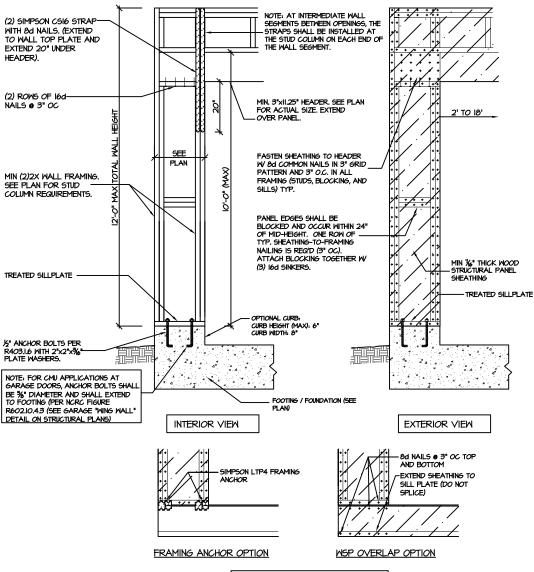CS-PF - OVER WOOD FLOOR

CS-PF: CONTINUOUS PORTAL FRAME CONSTRUCTION DETAIL AND APPLICATION BASED ON NORC FIGURE R602.IO.I - PORTAL FRAME CONSTRUCTION



STRUCTURAL NOTES

NC (2018 NCRC): Wind: 115-120 mph

- ENGINEER'S SEAL APPLIES ONLY TO STRUCTURAL COMPONENTS INCLUDING ROOF RAFTERS, HIPS, VALLEYS, RIDGES, FLOORS, WALLS, BEAMS AND HEADERS, COLUMNS, CANTILEVERS, OFFGET LOAD BEARING WALLS, PIER & GIRDER SYSTEM, FOOTING, AND PILING SYSTEM. ENGINEER'S SEAL DOES NOT CERTIFY DIMENSIONAL ACCURACY OR ARCHITECTURAL LAYOUT INCLUDING ROOF SYSTEM. ALL REQUIREMENTS FOR PROFESSIONAL CERTIFICATION SHALL BE PROVIDED BY THE APPROPRIATE PROFESSIONAL, SOUTHERN ENGINEERS, P.A. CERTIFIES ONLY THE STRUCTURAL CONTROLLING AND CONTROLLIN COMPONENTS AS SPECIFICALLY STATED.
- 2. ALL CONSTRUCTION SHALL CONFORM TO THE LATEST REQUIREMENTS OF THE 2018 NO ALL CONSTRUCTION SHALL CONFORM TO THE LATEST REQUIREMENTS OF THE 2018 NO RESIDENTIAL CODE, PLUS ALL LOCAL CODES AND REGULATIONS. THE STRUCTURAL ENGINEER IS NOT RESPONSIBLE FOR, AND WILL NOT HAVE CONTROL OF, CONSTRUCTION MEANS, METHODS, TECHNIQUES, SEQUENCES OR PROCEDURES, OR FOR SAFETY PRECAUTIONS AND PROGRAMS IN CONNECTION WITH THE CONSTRUCTION WORK, NOR WILL THE ENGINEER BE RESPONSIBLE FOR THE CONTRACTOR'S FAILURE TO CARRY OUT THE CONSTRUCTION WORK IN ACCORDANCE WITH THE CONTRACT DOCUMENTS. "CONSTRUCTION REVIEW" SERVICES ARE NOT PART OF OUR CONTRACT. ALL MEMBERS SHALL BE FRAMED ANCHORED, TIED AND BRACED IN ACCORDANCE WITH GOOD CONSTRUCTION PRACTICE AND THE BUILDING CODE.
- DESIGN LOADS (LISTED AS: LIVE LOAD, DEAD LOAD, DEFLECTION)
- ROOMS OTHER THAN SLEEPING ROOMS: (40 PSF, IO PSF, L/360)
- SLEEPING ROOMS: (30 PSF, IO PSF, L/360)
- ATTIC WITH PERMANENT STAIR: (40 PSF, IO PSF, L/360)
- ATTIC WITHOUT PERMANENT STAIR: (20 PSF, IO PSF, L/360)
- ATTIC WITHOUT STORAGE: (10 PSF, 10 PSF, L/240)
- STAIRS: (40 PSF, IO PSF, L/360)
- DECKS AND EXTERIOR BALCONIES: (40 PSF, IO PSF, L/360)
- PASSENGER VEHICLE GARAGES: (50 PSF, IO PSF, L/360)
- SNOW: (20 PSF)
- 4. WALLS SHALL BE BRACED BY SHEATHING WALLS ON ALL STORIES WITH MOOD STRUCTURAL PANELS. SEE FRAMING NOTES FOR THICKNESS AND NAILING REQUIREMENTS.
- 5. SEE APPENDIX M (DCA6) FOR EXTERIOR DECK REQUIREMENTS INCLUDING ATTACHMENTS FOR
- CONCRETE SHALL HAVE A MINIMUM 20 DAY STRENGTH OF 3000 PSI AND A MAXIMUM SLUMP OF 5 INCHES UNLESS NOTED OTHERWISE (UNO). AIR ENTRAINED PER TABLE 402.2. ALL CONCRETE SHALL BE PROPORTIONED, MIXED, HANDLED, SAMPLED, TESTED, AND PLACED IN ACCORDANCE WITH ACI STANDARDS, ALL SAMPLES FOR PUMPING SHALL BE TAKEN FROM THE EXTRIDANCE THE PUMP. CONTROL JOINTS IN SLABS SHALL BE SPACED ON A GRID OF 1-30 TIMES THE DEPTH (D). CONTROL JOINTS SHALL BE SANCUT TO A DEPTH OF I/D. (I.E. 4" CONCRETE SLABS SHALL HAVE 以" DEEP CONTROL JOINTS SAWCUT IN SLAB ON A +-10'-0" x +-10'-0" GRID).
- ALLOWABLE SOIL BEARING PRESSURE ASSUMED TO BE 2000 PSF. THE CONTRACTOR MUST CONTACT A GEOTECHNICAL ENGINEER AND THE STRUCTURAL ENGINEER IF UNGATISFACTORY SUBSURFACE CONDITIONS ARE ENCOUNTERED. THE SURFACE AREA ADJACENT TO THE FOUNDATION WALL SHALL BE PROVIDED WITH ADEQUATE DRAINAGE, AND SHALL BE GRADED SO AS TO DRAIN SURFACE WATER AWAY FROM FOUNDATION WALLS.
- 8. ALL FRAMING LUMBER SHALL BE SPF #2 (Fb = 675 PSI) UNLESS NOTED OTHERWISE (UNO). ALL TREATED LUMBER SHALL BE SYP # 2. PLATE MATERIAL MAY BE SPF # 3 OR SYP #3 (Fc(perp) :
- 9. L.V.L. SHALL BE LAMINATED VENEER LUMBER; Fb=2600 PSI, Fv=265 PSI, E=L9xi0 PSI, P.S.L. SHALL BE PARALLEL STRAND LUMBER: Fb=2900 PSI, Fv=240 PSI, E=2.0xi0 PSI. L.S.L. SHALL BE LAMINATED STRAND LUMBER: Fb=2250 PSI, Fv=400 PSI, E=1.55xi0 PSI. INSTALL ALL CONNECTIONS PER MANUFACTURERS INSTRUCTIONS.
- IO. ALL ROOF TRUSS AND I-JOIST LAYOUTS SHALL BE PREPARED IN ACCORDANCE WITH THE SEALED STRUCTURAL DRAWINGS, TRUSSES AND I-JOISTS SHALL BE INSTALLED ACCORDING TO THE MANUFACTURE'S SPECIFICATIONS, ANY CHANGE IN TRUSS OR I-JOIST LAYOUT SHALL BE COORDINATED WITH SOUTHERN ENGINEERS.
- ALL STRUCTURAL STEEL SHALL BE ASTM A-36, STEEL BEAMS SHALL BE SUPPORTED AT EACH END WITH A MINIMUM BEARING LENGTH OF 3 1/2" INCHES AND FULL FLANGE WIDTH, PROVIDE SOLID BEARING FROM BEAM SUPPORT TO FOUNDATION, BEAMS SHALL BE ATTACHED TO EACH SUPPORT WITH TWO LAG SCRENG (1/2" DIAMETER X 4" LONG), LATTERAL SUPPORT IS CONSIDERED ADEQUATE PROVIDING THE JOIST ARE TOE NAILED TO THE SOLE PLATE, AND SOLE PLATE IS NAILED OR BOLTED TO THE BEAM FLANGE @ 48" O.C. ALL STEEL TUBING SHALL BE ASTM ASOO.
- 12. REBAR SHALL BE DEFORMED STEEL, ASTM615, GRADE 60. LAP ALL REBAR SPLICES 30 BAR
- 13. FLITCH BEAMS SHALL BE BOLTED TOGETHER USING (2) ROWS OF 1/2" DIAMETER BOLTS (ASTM A325) WITH WASHERS PLACED UNDER THE THREADED END OF BOLT. BOLTS SHALL BE SPACED AT 24" O.C. (MAX), AND STAGGERED AT THE TOP AND BOTTOM OF BEAM (2" EDGE DISTANCE), WITH 2 BOLTS LOCATED AT 6" FROM EACH END.
- I4. BRICK LINTELS (WHEN REQUIRED) SHALL BE 3 I/2'x3 I/2'x1/4" STEEL ANGLE FOR UP TO 6'-0" SPAN AND 6'x4'x5/16" STEEL ANGLE WITH 6" LEG VERTICAL FOR SPANS UP TO 4'-0". SEE PLANS FOR SPANS OVER 9'-0". SEE ALSO SECTION R703.8.3 LINTELS.
- 15. METAL CONNECTORS REFERENCED ON PLANS CORRESPOND TO SIMPSON STRONG-TIE BRAND. CONNECTORS OF EQUAL OR BETTER CAPACITY ARE ACCEPTABLE. CORROSION RESISTANCE PER CODE AND AS RECOMMENDED BY MANUFACTURER.

PROJECT # 21-2816.1

P.A. 27609

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