ATE: MARCH 27, 2019

REV.: JUNE 01, 2020

GINEERED BY:

DRAWN BY: WG

## Dream Finders Homes

# KENT

## **KENT REVISION LIST - STRUCTURAL:**

## **KENT REVISION LIST - ARCHITECTURAL:**

LOT 690 MANOR LEXINGTON

- ADDED NOTE TO EXTEND STAIR CLIP IN POWDER ROOM THE LENGTH OF THE ROOM (3-19)
- SHOWED AHU AND MECH. LOCATIONS ON SECOND FLOOR (3-19)

**INVENTORY PLAN** 

- UPDATED PLAN TO NEW CAD FORMAT AND ADDED COVER SHEET (3-19)
- UPDATED CUTSHEETS (3-19)
- CHANGED FIREPLACE FROM STANDARD TO OPTIONAL (7-25)
- CHANGE FIREPLACE FROM 36" TO 32". (11-21-19)
- ADDED ROOM DIMENSIONS. (11-21-19)
- CHANGE ROOM NAMES FROM MASTERS TO OWNERS. (11-21-19)
- VERIFIED AND UPDATED SOUARE FOOTAGE ON FIRST AND SECOND FLOOR. (11-21-19)
- ADDED ROOF VENTING CALCULATIONS FOR ELEV A, B, AND C. (11-29-19)
- ADDED GOURMET KITCHEN LAYOUT OPTION. (12-23-19)
- CHANGE FIREPLACE FROM STANDARD TO OPTIONAL. (12-23-19)
- REMOVE GLASS INSERTS AT GARAGE DOORS. (12-23-19)
- REMOVE METAL ACCESSORIES AT GARAGE DOORS. (12-23-19)
- UPDATED CUTSHEETS PER H&H STANDARDS. (1-16-20)
- CHANGE FIREPLACE FROM STANDARD TO OPTIONAL (1.16.20)
- CALLED OUT REFRIGERATOR, WASHER, AND DRYER ARE OPTIONAL COMPONENTS. (1-16-20)
- VERIFIED COACH LIGHT LOCATIONS ON ALL ELEVATIONS (03-30-20)
- REMOVED GRIDS FROM WINDOWS AND DOORS ON ALL SIDE AND REAR ELEVATIONS (03-30-20)
- REMOVED ROOF HATCH FROM ALL ELEVATIONS (03-30-20)
- CHANGED NOTE FOR ALL GARAGES ON ELEVATIONS TO UPDATED NOTE (03-30-20)
- UPDATED HATCHES ON ALL ELEVATIONS TO REPRESENT STONE BETTER (03-30-20)
- ADDED ELEVATIONS TO SHOW STONE AND BRICK OPTIONS ON A-2, A-3, B-2, B-3, C-2, & C-3 (03-30-20)
- ADDED COLUMN DETAIL FOR B ELEVATIONS (03-30-20)
- FIXED WINDOW TRIM AND BRICK ROWLOCK ON B-3 & B-4 (03-30-20)
- VERIFIED AND UPDATED SQUARE FOOTAGE WITH & WITHOUT BRICK (03-30-20)
- ADDED DIAGONAL DIMENSIONS TO SLAB INTERFACE PLAN (03-30-20)
- ADDED OWNER'S BATH 2 & 3 IN OPTIONS SHEET (03-30-20)
- REPLACED OWNER'S BATH WITH OWNER'S BATH 1 ON BASE PLAN (03-30-20)
- CHANGED ALL WALLS FROM 2x6 TO 2x4 EXCEPT WHERE SHADED (03-30-20)
- CHANGED ROOM NAME "NOOK" TO "DINING ROOM" (03-30-20)
- ADDED HOSE BIB LOCATIONS TO OPPOSITE SIDES OF THE HOUSE ON FRONT AND REAR (03-30-20)
- CHANGED STANDARD PATIO TO 12'x10' (03-30-20)
- NOTED "TEMP" WINDOWS IN OWNER'S BATH (03-30-20)
- MOVED ALL OPTIONS TO SEPARATE SHEET (03-30-20)
- SHOWED DORMER WINDOWS ON SECOND FLOOR (03-30-20)
- ADDED NOTE FOR ATTIC ACCESS DOOR ON SECOND FLOOR (03-30-20) NOTED "TEMP." WINDOWS IN BEDROOM 2 AND BEDROOM 4 (03-30-20)
- CHANGED STANDARD LIGHT IN KITCHEN TO FLUORESCENT LIGHT (03-30-20)
- NOTED PENDANT LIGHTS AS OPTIONAL (03-30-20)
- ADDED OPTIONAL FLOOR OUTLETS IN FAMILY ROOM (03-30-20)
- REMOVED ALL OUTLETS EXCEPT OPTIONAL FLOOR OUTLET (03-30-20)
- VERIFIED ALL COACH LIGHT LOCATIONS (03-30-20)
- NOTED ALL FANS AS "STD LIGHT, OPT FAN/LT PREWIRE" IN ALL BEDROOMS (03-30-20)
- UPDATED ELECTRICAL LEGEND (03-30-20)
- NOTED FLOOD LIGHTS AS OPTIONAL (03-30-20)
- UPDATED OWNER'S BATHROOM WINDOWS TO REAR ELEVATIONS (08-29-22)
- OPTIONAL BRICK/STONE WATERTABLE ADDED TO SIDE & REAR ELEVATIONS (05-01-23)



FOOD PLANE ELIVATIONS DESIGNS, MATRIFALIS AND DIMENSIONS ARE SUBJECT TO CHANGE WITHOUT NOTICE. SO SQLARE POOTICE, AND DIMENSIONS ARE PERIMATIDE AND MAY VARY IN ACTILAL CONSTRUCTION, ACTILAL POSITION OF HOUSE ON LOT WILL BE PETERAINED BY THE SITE PLAN AND HIGT PLAN FLOOR PLANS AND ELIFVATION RENDEBINGS ARE ARTIST CONCEPTIONS. FLOOR PLANS ARE RENDEBINGS ARE ARTIST CONCEPTIONS. FLOOR PLANS ARE ARTIST CONCEPTIONS. FLOOR PLANS ARE AND SELF OF DEBLANCH TO DEBLAN TO THE TO DEBLAN TO THE TOP TO DEBLAN TO DEBLAN TO DEBLAN TO DEBLAN TO DEBL

DREAM FINDERS HOMES KENT

DATE: MARCH 27, 2019

REV.: JUNE 01, 2020

SCALE: AS NOTED
DRAWN BY: WG


ENGINEERED BY:

REVIEWED BY:

A - 2 & A - 3 ELEVATIONS W/

STONE

A-1.2

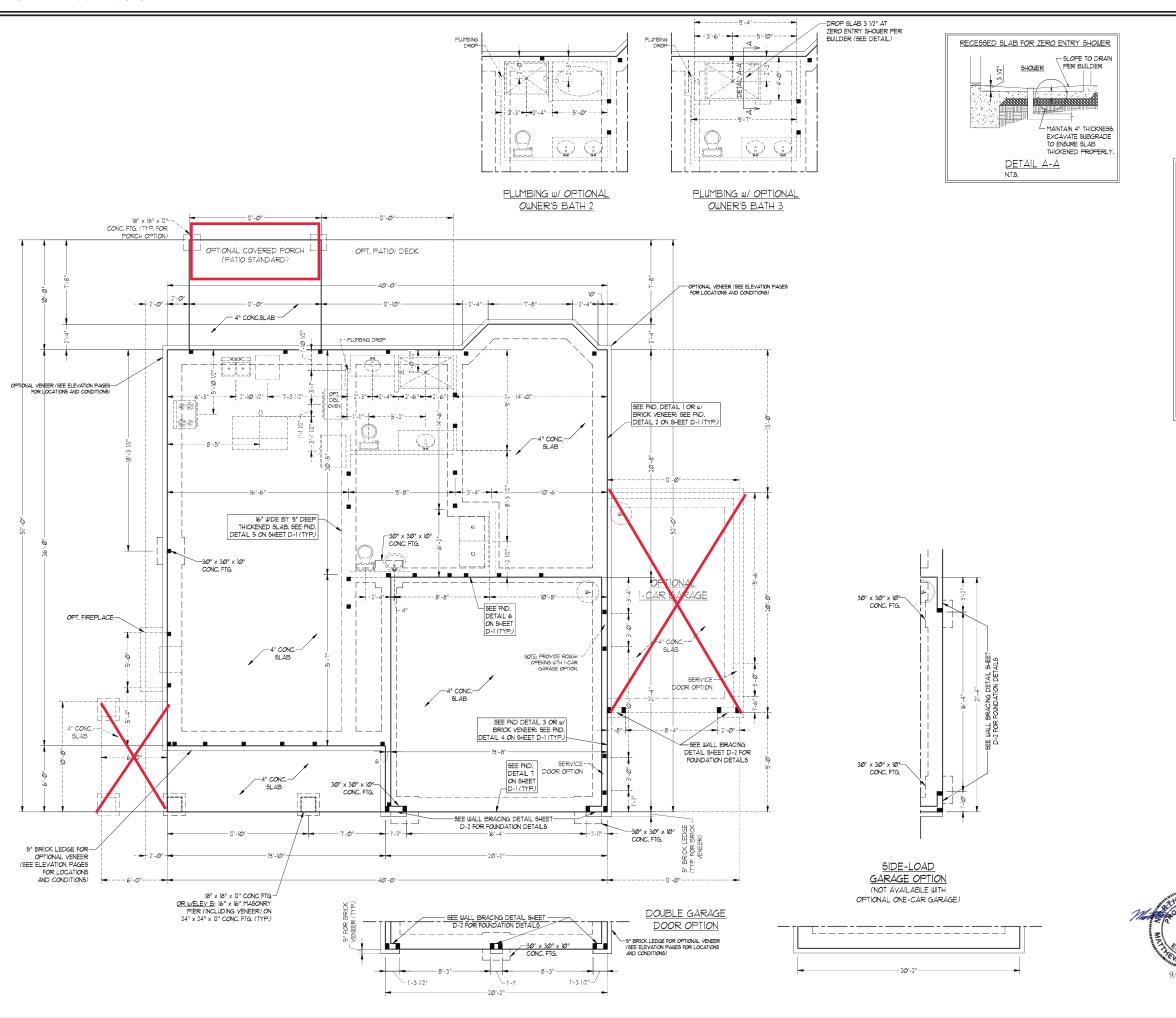



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2.27605 1921

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ERING, SUITE 104 RALEIGH, N PS9,9919 FAX. (919) 788 LICENSE NO.: C-1733

S.TH(
NGINE

606 WADE AVE. SUITI
PHONE (910x 7

120 MPH ULTIMATE DESIGN WIND SPEED NOTES FOR LESS THAN 30' MEAN ROOF HEIGHT:

- 1. BIGNEER'S SEAL APPLIES ONLY 10
  5 PRICINEAL COMPONENTS ENSINEER'S SEAL DOES NOT CERTIFY D'PENSIONAL ACCURACY OR ARCHITECTURAL LAYOUT NELLIDIAS ROOF SYSTEM.

  2. STRUCTURAL DESIGN FER NORTH CAROLINA RESIDENTIAL COOL, 20% EDITION.

  3. NSTALL LY "ACKOR BOLD SO 6"-0" OC., AND WITHIN 1-0" FEDD OF EACH CONNER.

  ANCIARD SIGN TO STRUCTURAL STRUCTURAL STRUCTURAL DESIGN FER OF THATE EDITION.

  5. ENTERIOR LIALLS DESIGNED FOR 10" PFP-1.

  5. ENTERIOR LIALLS DESIGNED FOR 142 PSP-1.

  5. ENTERIOR LIALLS DESIGNED FOR 10" PFP-1.

  5. ENTERIOR LIALLS DESIGNED FOR 142 PSP-1.

  5. ENTERIOR LIALLS DESIGNED FOR

15/0 MPH ULTIMATE DESIGN WIND SPEED NOTES FOR LESS THAN
30' MEAN ROOF HEIGHT:

- BOLIERAN BLOCH HEIGHTS:
  BEMLERS BEAL APPLIES OLY TO
  STRUCTURAL COMPONENTS, BYSINEERS
  SEAL DOES NOT CERTIFY DYNENSOVAL
  ACCURACY OR ARCHITECTURAL LAYOUT
  NULLIDING BOOF SYSTEM
  STRUCTURAL DESIGN PER NORTH
  CAROLINA RESIDENTIAL CODE, 2018
  EDITION LIMIT BEFCIAL CONSIDERATION TO
  CHAPTER 45 ("HIGH WIND ZONES" FOR 50
  IPPLI WINDS).
- EDITION LITH SPECIAL CONSIDERATION TO CHAPTER 48 ("India LIND ZOSE") FOR BO INFH LINDS.

  BULLDER IS TO FROVIDE FRAMING CONNECTIONS AS REGISTED BY CHAPTER 45 ("INGIA LIND ZOSE") FOR BO INFH LINDS) OF THE NORTH CAROLINA RESIDENTIAL CODE, 200 EDITION FOUNDATION ANCHORAGE TO CONFITY LITH SECTION. 1864 OF THE NORTH CAROLINA RESIDENTIAL CODE, 200 EDITION FEAN ROOF LINDS EDITION FEAN ROOF LINDS EDITION LINDS TO THE NORTH CAROLINA RESIDENTIAL CODE, 200 EDITION PEAN ROOF LAD THE NORTH CAROLINA RESIDENTIAL CODE, 200 EDITION PEAN ROOF LAD THE NORTH CAROLINA RESIDENTIAL CODE, 200 EDITION DESIGNATION EDITION OF SECTION DESIGNATION OF THE NORTH CAROLINA RESIDENTIAL CODE AND THE NORTH CAROLINA RESIDENTIAL CODE AND ASSETTION OF THE NORTH CAROLINA RESIDENTIAL CODE AND ASSETTION OF

KENT H&H HOMES, INC.

DATE: AUGUST 12, 2020

DRAWN BY: H&H HOMES

SCALE: 1/4" = 1'-0"

ENGINEERED BY: WFB

SHEET: 2 OF: 8 S-1.2 MONO SLAB FOUNDATION PLAN



HOOR PLANS, ELPAY MONG, BESGNA MATRRIALA AND
DIADRISHOONS ARE STRIKET TO CHANGE WITHOUT NOTICE.

SQLARE POOTAGE, NO DIADRISHOONS ARE ESTIMATED AND
MAY VARY IN ACTIVAL CONSTRUCTION, ACTU, AL POSTTON
OF HOUSE ON LOT WILL BE DETERMINED BY THE SITE PLA
AND FLOT PLAN, ELOOR PLANS AND ELEVATION
RENDERINGS ARE ARTIST CONCEPTIONS. FLOOR PLANS AND
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ANY USE, REPRODUCTION, ADAPTATION, OR DISPLAY

# DREAM FINDERS HOMES KENT

DATE: MARCH 27, 2019

REV.: JUNE 01, 2020


SCALE: 1/4"=1'-0"

DRAWN BY: WG
ENGINEERED BY:

REVIEWED BY:

SLAB INTERFACE PLAN

A-5

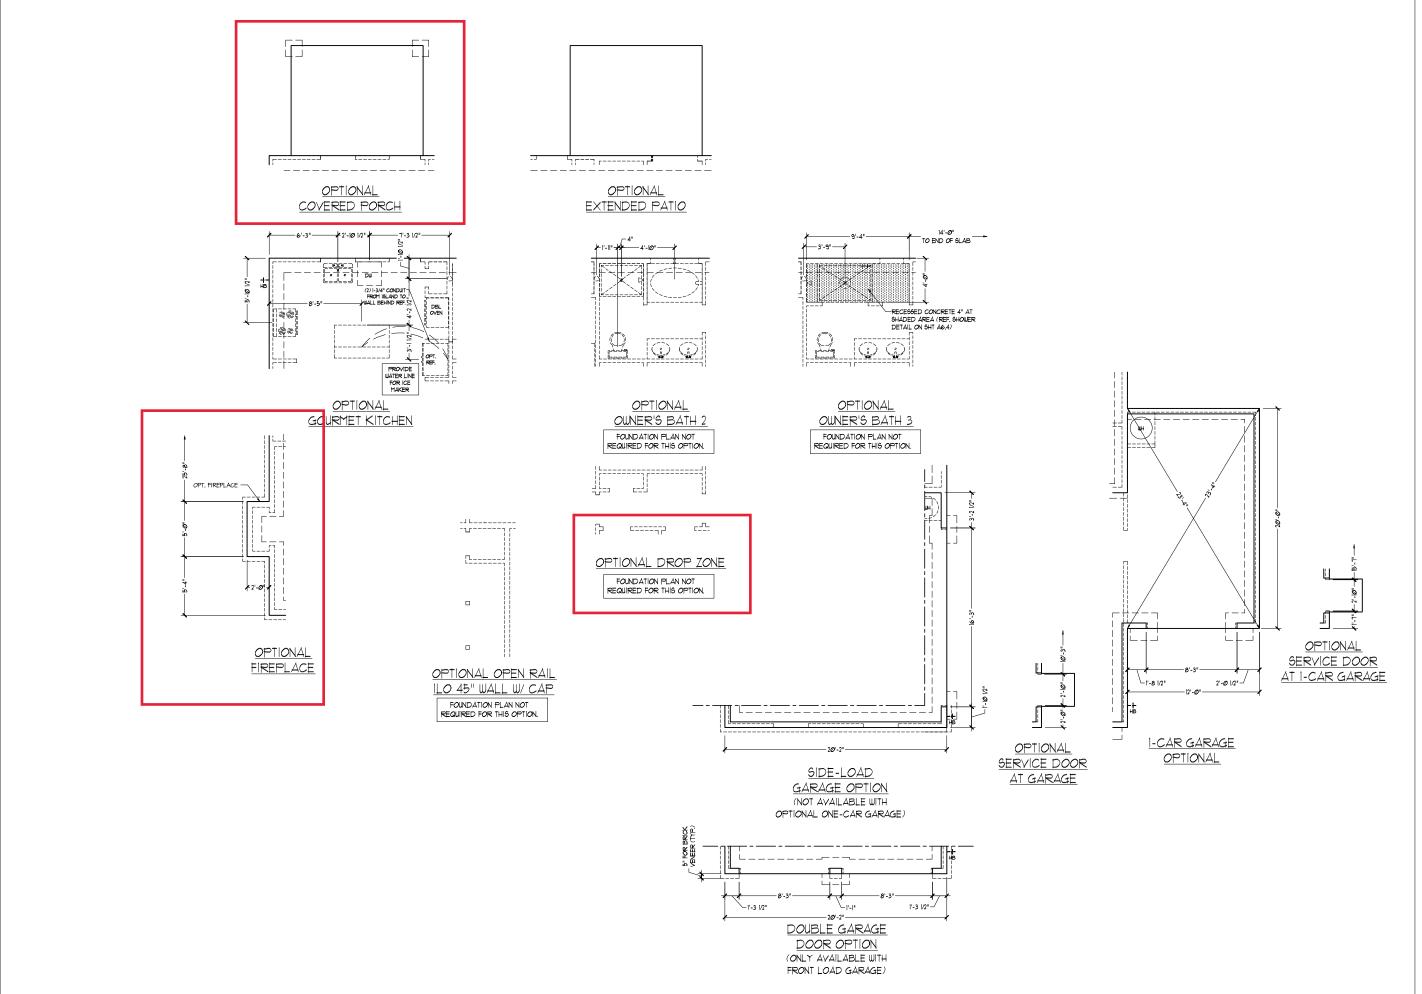



PLOOR TAKE ALLY MINE, DESIGNS WITH RRIAD AND THE DESIGN AND THE STATE OF THE STATE

DREAM FINDERS HOMES KENT

DATE: MARCH 27, 2019 REV.: JUNE 01, 2020


SCALE: 1/4"=1'-0"

DRAWN BY: WG

ENGINEERED BY:
REVIEWED BY:

SLAB INTERFACE PLAN - OPTIONS

A-5.1

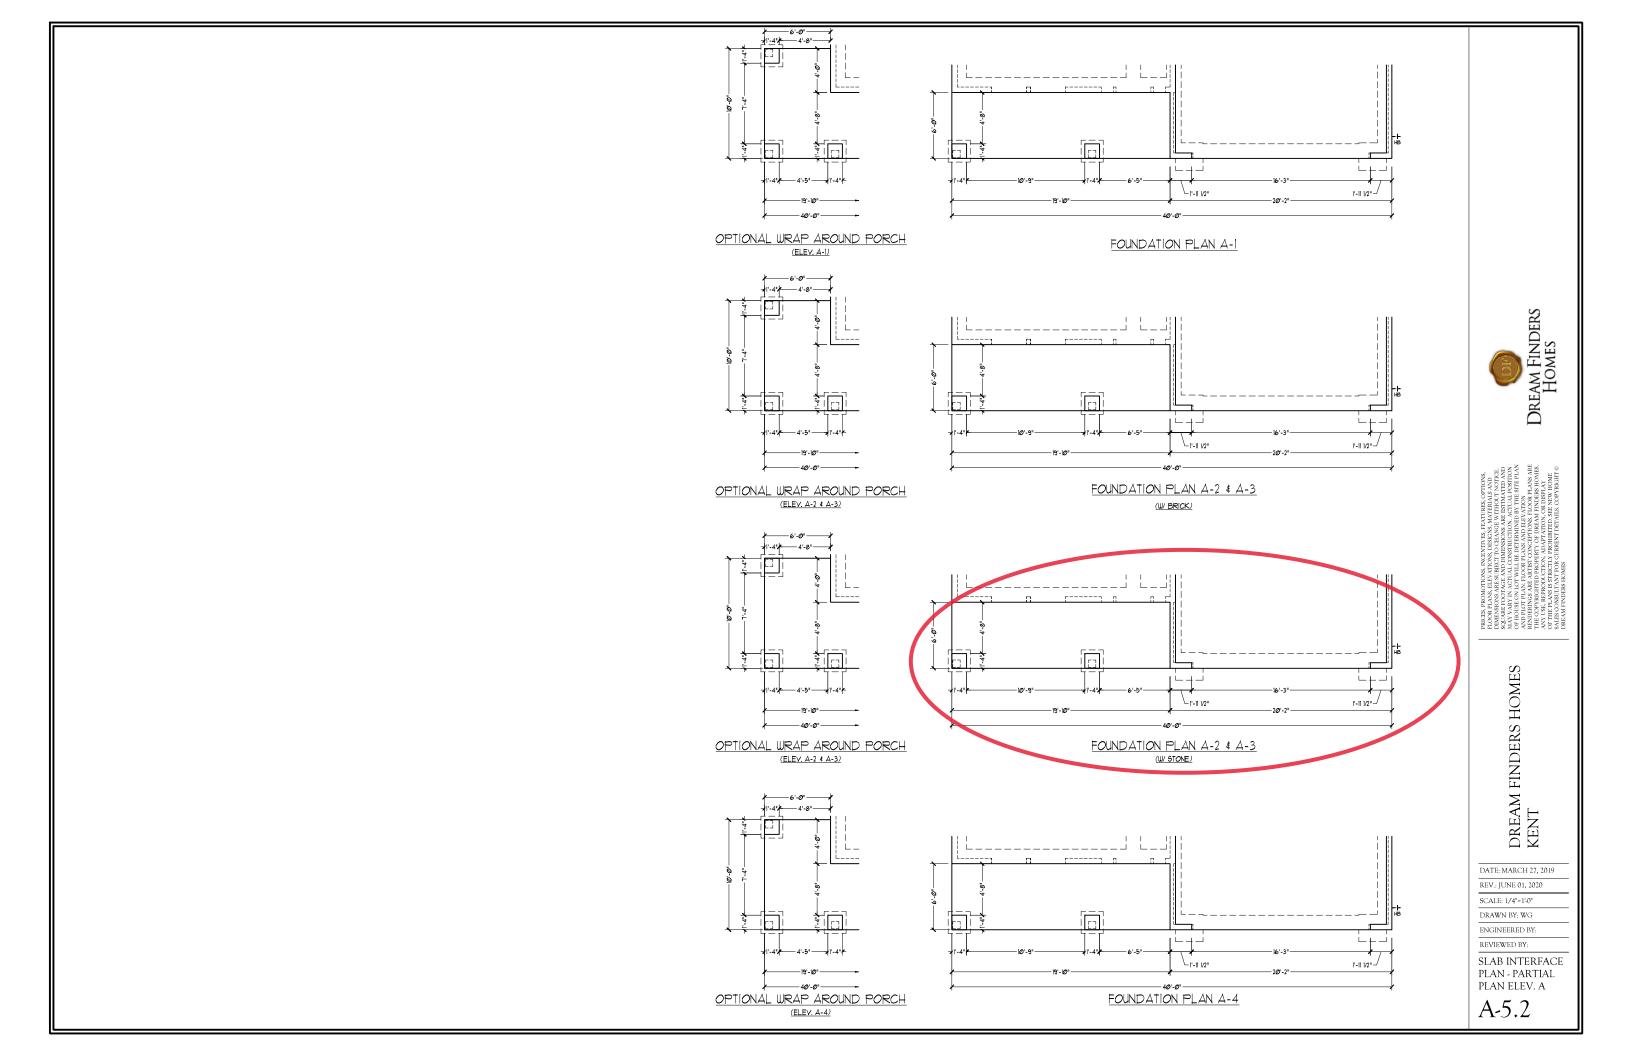

MOTE: ALL EXTERIOR WALLS AND ATTIC WALLS ARE TO BE 2 x 4 + 6 to CC. (UNO.). ALL INTERIOR LOAD BEARNS WALLS ARE TO BE 2 x 4 + 6 to CC. (UNO.) AND NON-LOAD BEARNS INTERIOR WALLS ARE TO BE 2 x 4 + 0 20°. CC. (UNO.).

2% WALL

\* SHADED WALLS ARE TO BE 2 × 6 \* 16\*
O.C. (LOAD BEARNA) OR 2 × 6 \* 24\* O.C.
(NON-LOAD BEARNA) REGARDLESS OF
EXTERIOR WALL CONDITION

DREAM FINDERS HOMES

DREAM FINDERS HOMES KENT

DATE: MARCH 27, 2019 REV.: JUNE 01, 2020


SCALE: 1/4"=1'-0"

DRAWN BY: WG
ENGINEERED BY:
REVIEWED BY:

FIRST FLOOR PLAN

A-6


FIRST FLOOR PLAN (A-1, B-1 AND C-1)

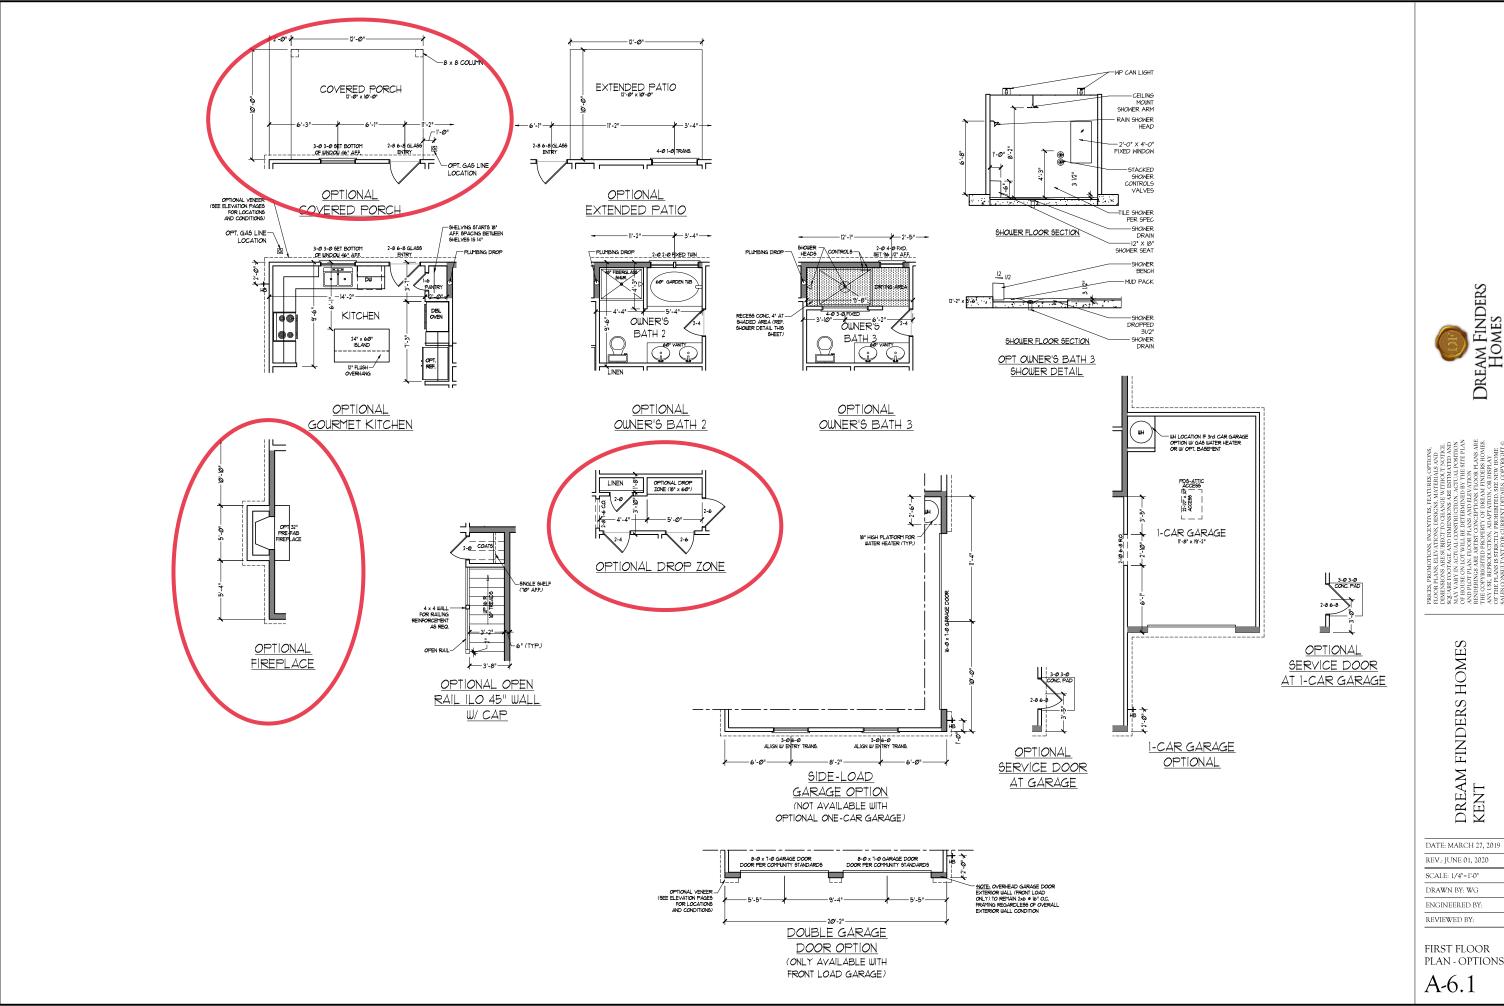




REV.: JUNE 01, 2020

FIRST FLOOR PLAN - OPTIONS

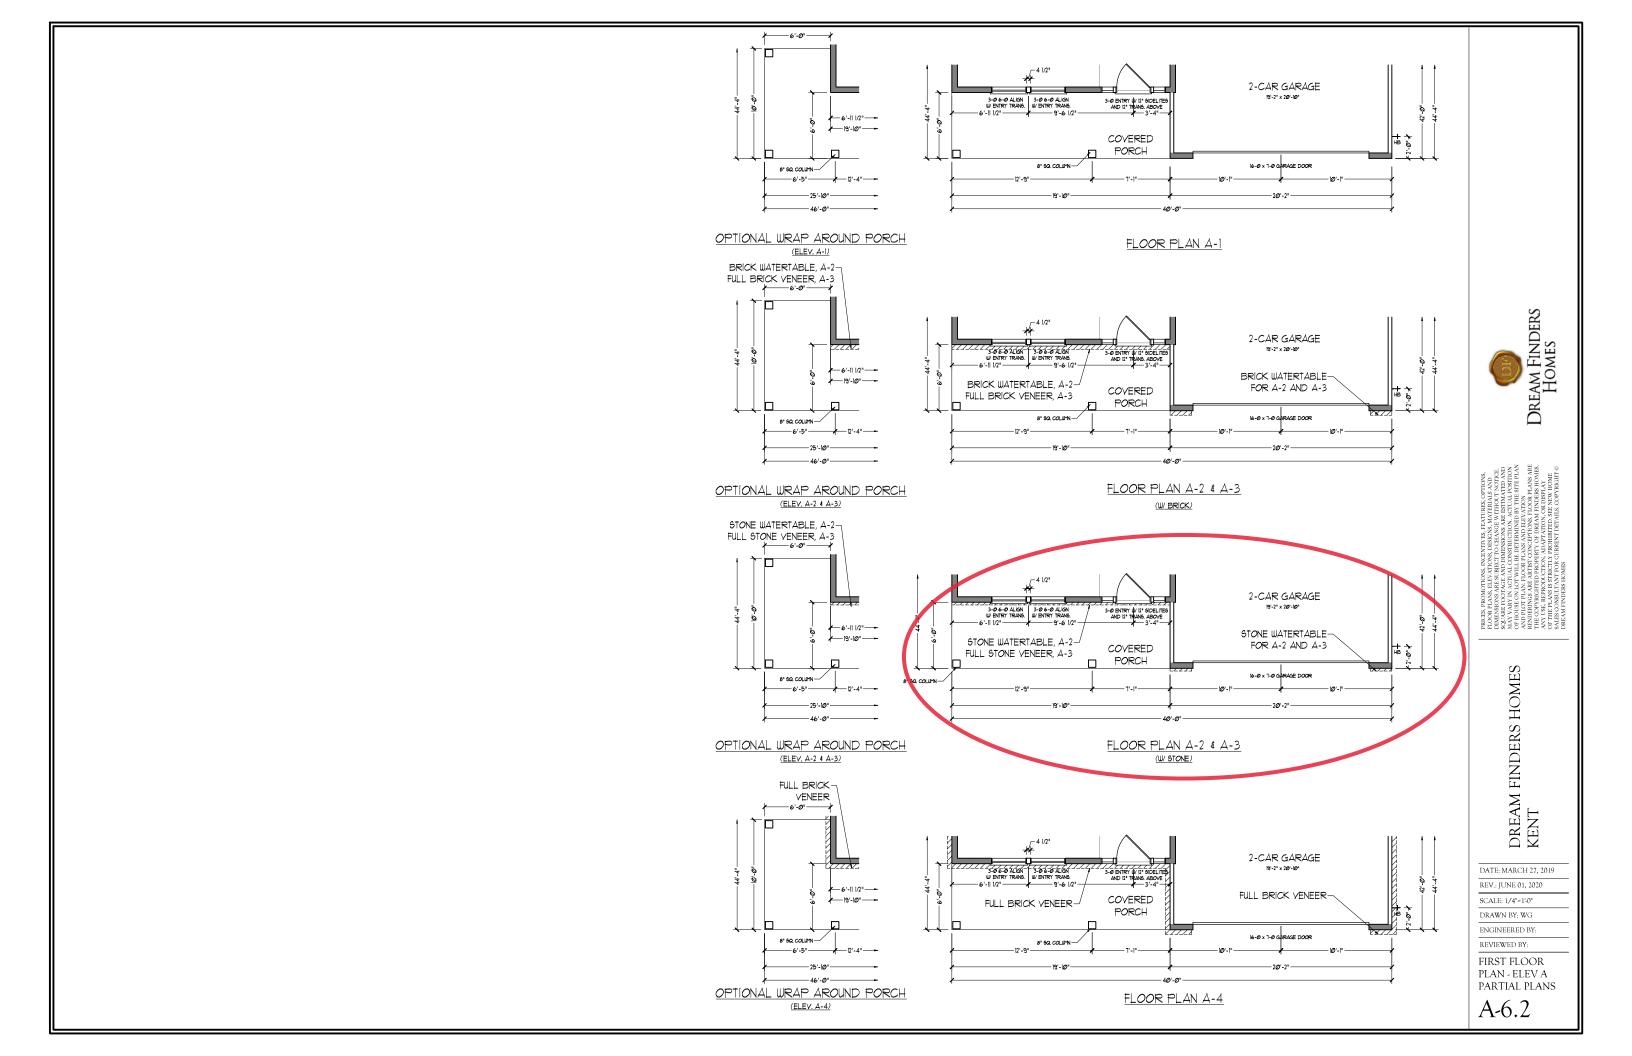

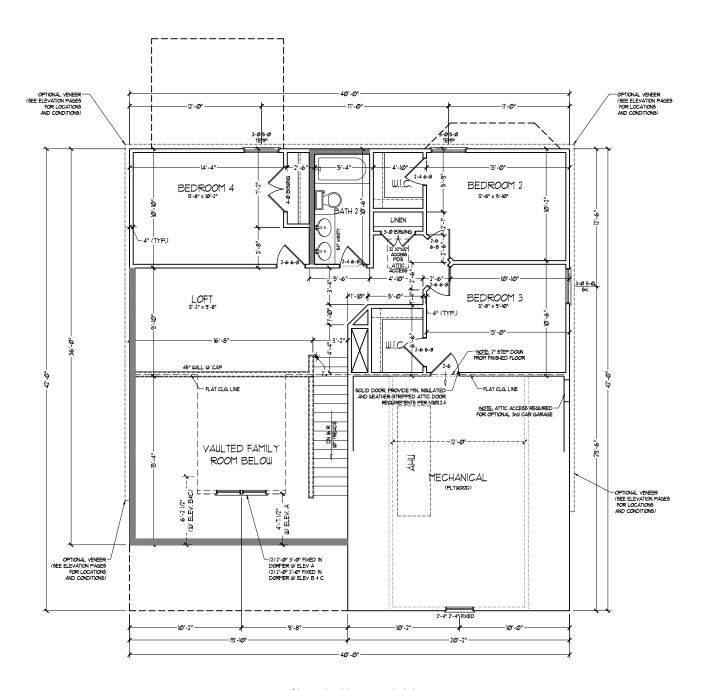

SECOND FLOOR PLAN

MOTE: ALL EXTERIOR WALLS AND ATTIC WALLS ARE TO BE 2 x 4 o \$6" CAC (UNCA). ALL INTERIOR LOAD BEARNS WALLS ARE TO BE 2 x 4 o \$6" CA. (UNCA) AND NON-LOAD BEARNS MITERIOR WALLS ARE TO BE 2 x 4 o 24" O.C. (UNCA).

2x6 WALL

\* SHADED WALLS ARE TO BE 2 x 6 \* 16\*
O.C. (LOAD BEARNS) OR 2 x 6 \* 24\* O.C.
(NON-LOAD BEARNS) REGARDLESS OF
EXTERIOR WALL CONDITION

PROVIDE MINIMUM INSULATION IN CEILINGS AND WALLS PER SECTION N 1102.1 DREAM FINDERS Homes

DIMENSIONA RESURENTO COLANGE WITHOUT COUNCE
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ANY VARY NACTULA, CONSTRUCTION AND ACTULAL ENGINE
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DREAM FINDERS HOMES KENT


DATE: MARCH 27, 2019 REV.: JUNE 01, 2020


SCALE: 1/4"=1'-0" DRAWN BY: WG

ENGINEERED BY:

SECOND FLOOR

PLAN
A-7

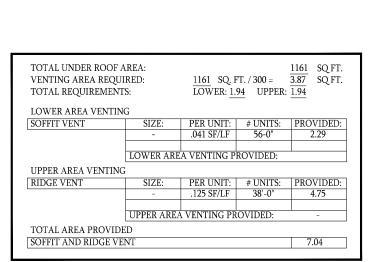

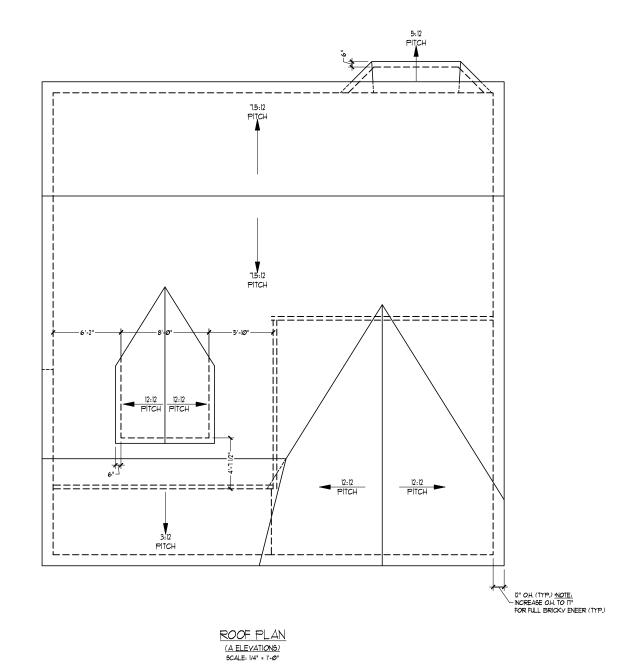

DREAM FIND HOMES

DREAM FINDERS HOMES KENT

DATE: MARCH 27, 2019

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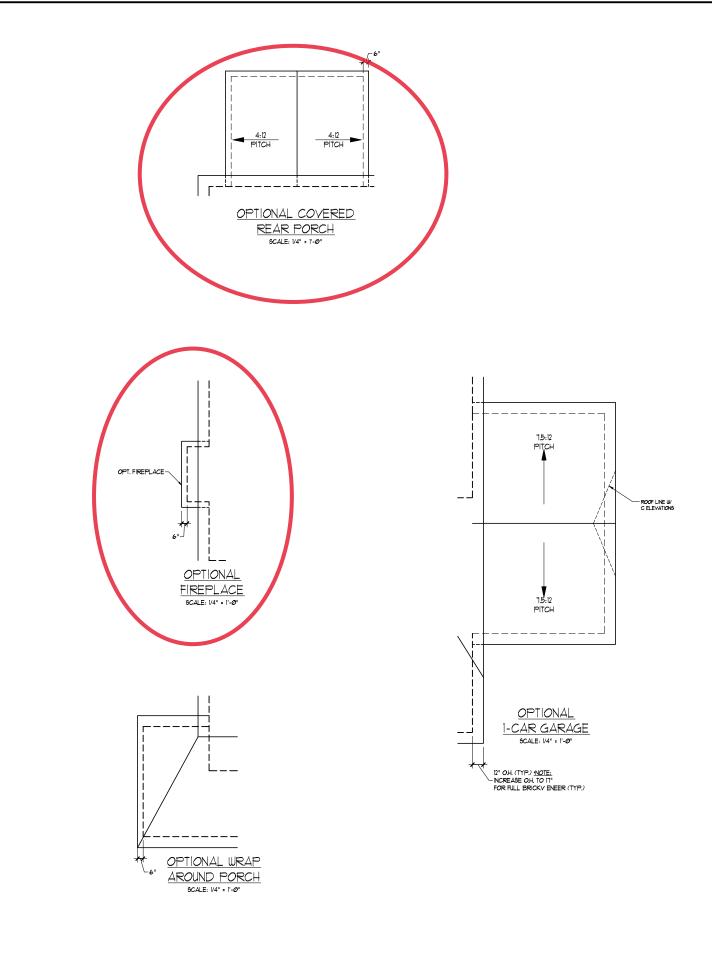
SCALE: 1/4"=1'-0"
DRAWN BY: WG

ENGINEERED BY:

REVIEWED BY:

ROOF PLAN ELEVATION - A

A-8





PRICES, PROMOTIONS, INCENTIVES, FEATURES, OPTIONS, FLOOR HANS, BLEVATONS, AND DIMENSIONS ARE STRANGED AND DIMENSIONS ARE ESTIMATED AND DIMENSIONS ARE ESTIMATED AND MAY VARY IN ACTUAL CONSTRUCTION, ACTUAL POSTION OF HOUSE ON LOT WILL BE DETERMINED BY THE REPORT AND DILAY HOW AND PLOT PLAN. AND BLEVATION AND ALTON AN

DREAM FINDERS HOMES KENT

DATE: MARCH 27, 2019


REV.: JUNE 01, 2020 SCALE: 1/4"=1'-0"

DRAWN BY: WG
ENGINEERED BY:


REVIEWED BY:


ROOF PLAN OPTIONS

A-8.3

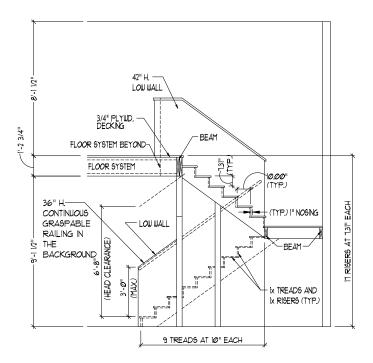


TYPICAL STAIR DETAIL (NTS)

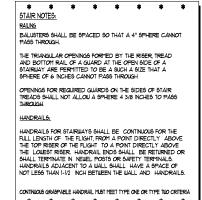

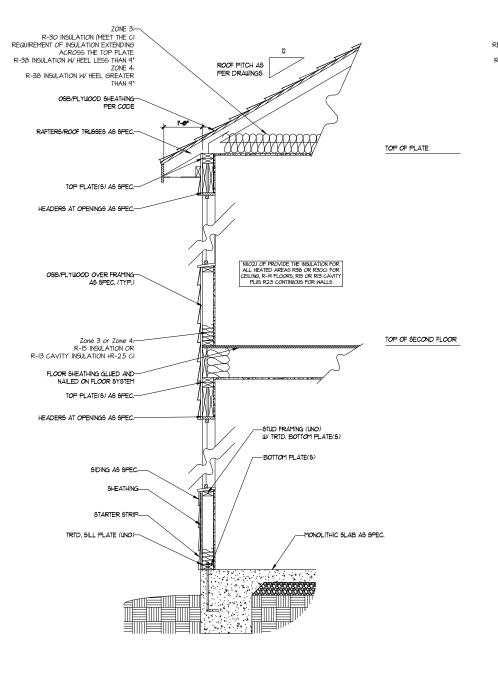

WALL SECTION W/ SLAB W/ STD. SIDING SHOWN (NTS)

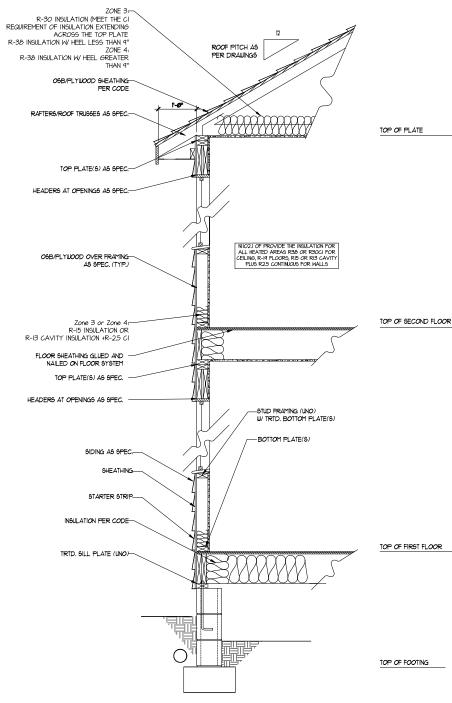

WALL SECTION W/ CRAWL SPACE W/ STD. SIDING SHOWN (NTS)

DREAM FINDERS Homes

PRICES, PROMOTHONS, INCENTIVES, EFFACIRES, OFFONS, FLOOR PLANS, ELEVATIONS, DESIGNS, MATERIALS AND DIMENSIONS ARE SUBERTY OFEA. WEITHOUT NOTICE. SQLARE FOOTIAGE, AND DIMENSIONS ARE ESTIMATED AND MAY WARY IN ACTIVAL OWNER INCIPION. ACTIVAL POSTRIC OFFON ACTIVAL POSTRIC ACTIVAL POSTRIC MAY AND PLOT PLANS THOSE PLANS AND ELEVATION AND PLOT PLANS. HOOR PLANS AND ELEVATION AND ELEVATION. THE COPYRIGHTED PREMA HOURES HOOR ENCOYNER TO CONCEPTIONS. A THOSE PLANS AND ELEVATION.

DREAM FINDERS HOMES KENT


DATE: MARCH 27, 2019

REV.: JUNE 01, 2020 SCALE: 1/4"=1'-0"

DRAWN BY: WG
ENGINEERED BY:
REVIEWED BY:

WALL SECTIONS AND STAIR

DETAIL AD-1

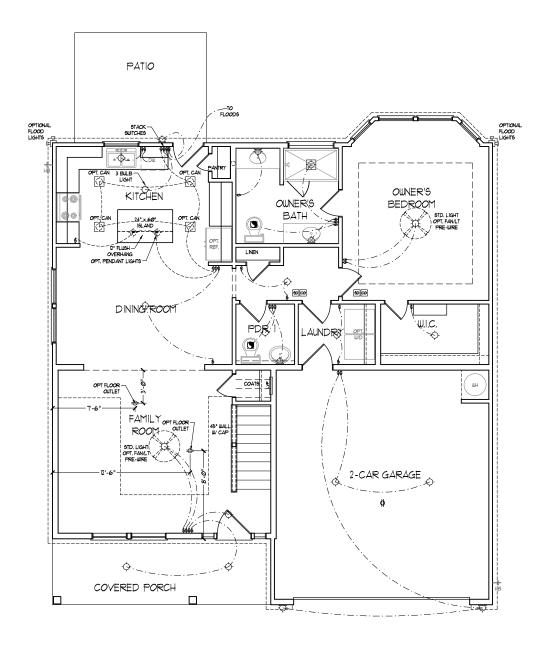

ELECTRICAL LAYOUT NOTES:

D BLOCK AND WIRE FOR ALL
CELLIS FAME DEED BLAN

2.) VANITY LIGHTS TO BE SET 9 90" AFF. (TYP.)

3) ADDITIONAL EXTERIOR OUTLETS REQUIRED BY CODE TO BE LOCATED BY ELECTRICIAN.

4.) PLACE SWITCHES 8" (MIN.) FROM ROUGH OPENINGS,

ELECTRICAL LEGEND			
<b></b>	IIØ V OUTLET		
ሷ	WALL MOUNT LIGHT		
<b>\( \rightarrow \)</b>	CEILING MOUNT LIGHT		
•	PENDANT LIGHT		
$\bigcirc$	RECESSED CAN LIGHT		
Ø	MINI CAN LIGHT		
<b>(</b>	EYEBALL LIGHT		
	FLUORESCENT LIGHT		
	2 LAMP, 4' FLUORESCENT LIGHT		
烃	FLOOD LIGHT		
\$	SWITCH		
š	3-WAY SWITCH		
\$	4-WAY SWITCH		
\$	DIMMER SWITCH		
(N)-	CONDUIT FOR COMPONENT WIRING		
6P	SPEAKER		
D-	DOORBELL CHIME		
90	10 V SMOKE DETECTOR		
<b>Ø</b>	CO DETECTOR		
<b>(3</b>	EXHAUST FAN		
LVP	LOW VOLTAGE PANEL		
	CEILING FAN		
	CEILING FAN W/ LIGHT		

DREAM FINDERS Homes

HEGON PLANS. ELIVATIONS, DISGIOSA MATERIAL, DISGIOSA MATERIAL, DISGIOSA DELLOS PLANS. ELIVATIONS, DISGIOSA MATERIAL, DIMENSIONS ARE SUBECTION ACTUAL, CONSTRUCTION, ACTUAL, OF HOUSE ON LOT WILL BE DETERNING BY THE COPYRIGHTED PROPRETY OF PREAM PRINTS OF P

DREAM FINDERS HOMES KENT

DATE: MARCH 27, 2019

REV.: JUNE 01, 2020 SCALE: 1/4"=1'-0"

DRAWN BY: WG

ENGINEERED BY:
REVIEWED BY:

FIRST FLOOR ELECTRICAL PLAN

E-1

FIRST FLOOR PLAN (A-1, B-1 AND C-1)

DOOR OPTION

ONLY AVAILABLE WITH

FRONT LOAD GARAGE)



DREAM FINDERS HOMES KENT

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ENGINEERED BY: REVIEWED BY:

FIRST FLOOR ELECTRICAL PLAN

E-1.1

Dream Finders Homes

DREAM FINDERS HOMES KENT

DATE: MARCH 27, 2019 REV.: JUNE 01, 2020

SCALE: 1/4"=1'-0" DRAWN BY: WG

ENGINEERED BY:

FIRST FLOOR
ELECTRICAL
PLAN - PARTIAL
PLANS
E-1.2

ELECTRICAL LAYOUT NOTES:

U BLOCK AND WIRE FOR ALL

2.) YANITY LIGHTS TO BE SET • 90" AFF. (TYP.)

3.) ADDITIONAL EXTERIOR OUTLETS REQUIRED BY CODE TO BE LOCATED BY ELECTRICIAN.

4.) PLACE SWITCHES 8" (MIN.) FROM ROUGH OPENINGS.

ELECTRICAL LEGEND			
#	IIØ V OUTLET		
₾	WALL MOUNT LIGHT		
<b>\( \rightarrow \)</b>	CEILING MOUNT LIGHT		
•	PENDANT LIGHT		
Ф	RECESSED CAN LIGHT		
Ø	MINI CAN LIGHT		
<b>(</b>	EYEBALL LIGHT		
$\coprod$	FLUORESCENT LIGHT		
====	2 LAMP, 4' FLUORESCENT LIGHT		
华	FLOOD LIGHT		
\$	9WITCH		
š	3-WAY SWITCH		
ŧ	4-WAY SWITCH		
\$	DIMMER SWITCH		
<b>CU</b> -	CONDUIT FOR COMPONENT WIRING		
8 <b>P</b>	SPEAKER .		
D-	DOORBELL CHIME		
SD	10 V SMOKE DETECTOR		
Ø	CO DETECTOR		
C)	EXHAUST FAN		
[MP]	LOW VOLTAGE PANEL		
	CEILING FAN		
	CEILING FAN W/ LIGHT		

W LIGHT

DREAM FINDERS HOMES KENT

DATE: MARCH 27, 2019

REV.: JUNE 01, 2020 SCALE: 1/4"=1'-0"

DRAWN BY: WG

ENGINEERED BY: REVIEWED BY:

SECOND FLOOR ELECTRICAL PLAN


E-2

SECOND FLOOR PLAN



4 x 4 TRTD, POST MIN. (TYP.)

ELEVATION B

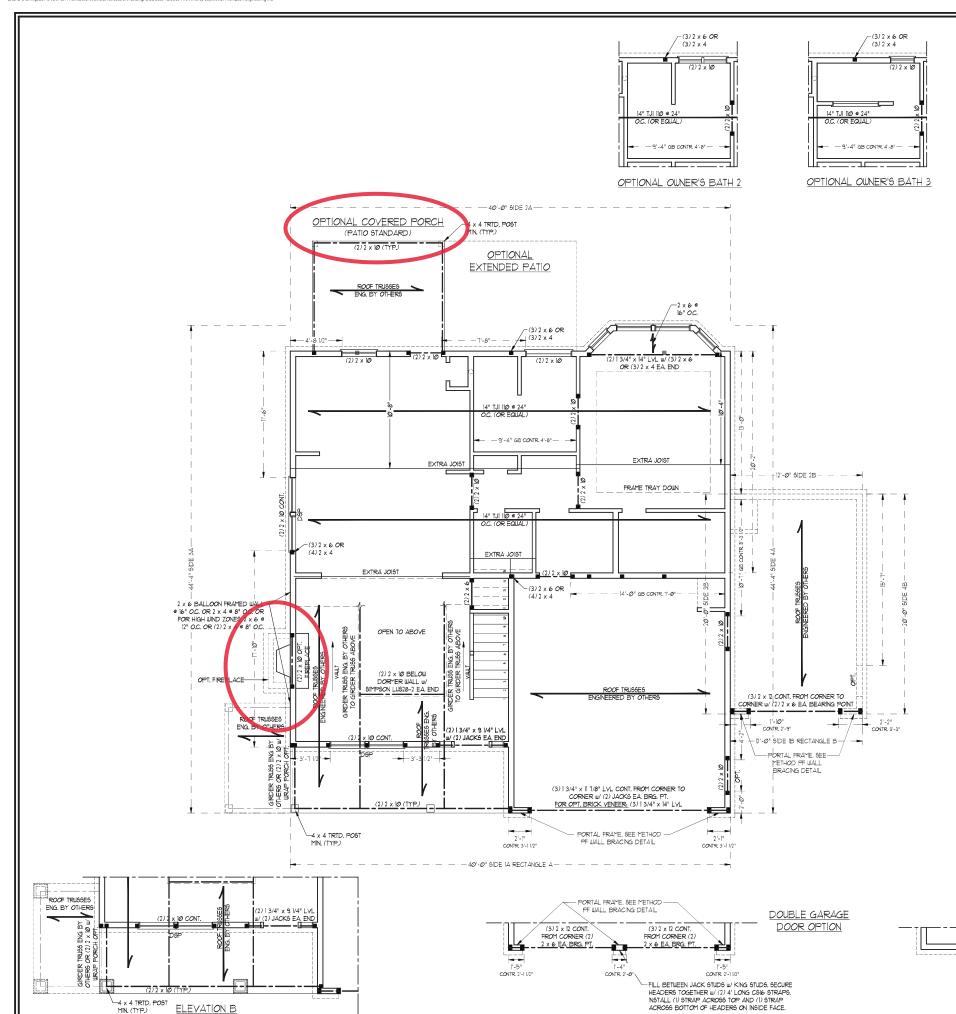

BRACED WALL DESIGN NOTES:

- BRACED IIIALL DESIGN PER SECTION R602 to DE THE NORC
- BRACED WALL DEDICTOR THEN SECTION REPORTS OF THE STATE OF THE STATE OF THE STRUCTURAL PANELS OF CONTRACTOR IS TO INSTALL THE OSE ON ALL EXTERIOR WALLS ATTACHED W & ANALS SPACED 6" OC. ALONG PANEL EDGES AND IS" OC. IN THE RIELD.
- O.C. A LONG PANEL EDGES AND 12" O.C. IN THE FIELD.

  (GB REETES TO "GYPGUN BOARD" CONTRACTOR IS TO NOTALL

  1/2" (MINU GYPGUN MALL BOARD WERER NOTED ON THE PLANS.

  FASTEN GB WITH I I/4" SCREED OR 15.9" ANLE SPACED "" O.C.

  ALONG PANEL EDCES AND IN THE FIELD INCLUDING TOP AND

  BOTTOM PLATES.

  BRACED MALL DESIGN APPLIED IN MIND ZONES UP TO 130 MPH.
- FOR HIGH WIND ZONES, BRACE WALLS ARE TO BE CONSTRUCTED IN ACCORDANCE WITH CHAPTER 45 OF THE NCRC 2018 EDITION, SEE NOTES AND DETAIL SHEETS FOR ADDITIONAL BRACED WALL INFORMATION.

BRACED WALL DESIGN

SIDE 14 (FRONT LOAD)
METHOD: C5-W5P/GB/PF
TOTAL REQUIRED LENGTH: 13.58' SIDE 2A METHOD: CS-WSP/GB TOTAL REQUIRED LENGTH: 13.58'

SIDE 3A METHOD: C6-W6P TOTAL REQUIRED LENGTH: 12:35'

SIDE 4A (SIDE LOAD)
METHOD: CS-WSP/PF
TOTAL REQUIRED LENGTH: 12.35' TOTAL PROVIDED LENGTH: 24.45' TOTAL PROVIDED LENGTH: 15.58'

RECTANGLE B SIDE IB METHOD: PF/CS-WSP TOTAL REQUIRED LENGTH: 2.85 TOTAL PROVIDED LENGTH: 20.16' TOTAL PROVIDED LENGTH: 6'

SIDE 2B METHOD: C5-W6P TOTAL REQUIRED LENGTH: 2.85 TOTAL PROVIDED LENGTH: 16.83' TOTAL PROVIDED LENGTH: 12' SIDE 3B / 4A SHARED METHOD: C5-WSP/GB TOTAL REQUIRED LENGTH: 14.45' TOTAL PROVIDED LENGTH: 29,33' TOTAL PROVIDED LENGTH: 24,45 SIDE 4B METHOD: CS-WSP TOTAL REQUIRED LENGTH: 2.1

TABLE R60215 MINIMUM NUMBER OF FULL HEIGHT STUDS
AT EACH END OF HEADERS IN EXTERIOR WALLS

	THE PROPERTY OF THE PARTY OF TH			
	HEADER SPAN (FEET)	MAXIMUM STUD SPACING (INCHES) (PER TABLE R602.3(5)		
ı		16	24	
	UP TO 3'	1	1	
	4'	2	1	
	8'	3	2	
	12'	5	3	
	16'	6	4	



SIDE-LOAD GARAGE OPTION (NOT AVAILABLE WITH OPTIONAL ONE-CAR GARAGE)

\*NOTE: ALL EXTERIOR WALLS AND ATTIC WALLS ARE TO BE 2 x 6 @ 16" O.C. MIN. (UNO). 2 x 4 @ 16" O.C. EXTERIOR WALLS MAY BE CONSTRUCTED IN LIEU OF 2 x 6 WALLS (UNO). ALL INTERIOR LOAD BEARING WALLS ARE TO BE 2 x 4 @ 16" O.C. (UNO) AND NON-LOAD BEARING INTERIOR WALLS ARE TO BE 2 x 4 @ 24" O.C. (UNO).

	CHEDULE FOR AL STONE SUPPORT
LENGTH (FT.)	SIZE OF LINTEL
UP TO 4 FT.	L 3 1/2 x 3 1/2 x 1/4
4-8	L 5 x 3 1/2 x 5/16 LLV
8 AND GREATER	L 6 x 4 x 5/16 LLV

## BRICK SUPPORT NOTES:

- LINTEL SCHEDULE APPLIES TO ALL OPENINGS IN BRICK VENEER (UNO), SEE ARCH DWGS. FOR SIZE AND LOCATION OF OPENINGS.
- (LLV) = LONG LEG VERTICAL
  LENGTH = CLEAR OPENING
  EMBED ALL ANGLE IRONG MIN. 4" EACH
  SIDE INTO VENEER TO PROVIDE BEARING.
- FOR ALL HEADERS 8'-0" AND GREATER FOR ALL HEADERS 8-6" ANGLE TO
  HEADER W I/2" LAG SCREWS = 12" O.C.
  STAGERED.
  FOR ALL BRICK SUPPORT = ROOF LINES,
  FASTEN (2) 2 x | 0 BLOCKING BETWEEN
- STUDS w/ (4) 12d NAILS PER PLY, FASTEN A 6" x 4" x 5/16" STEEL ANGLE TO (2) 2 > A S X 4 X 97/89 STEEL ANGLE D 10 (27) Z X B BLOCKING W/ (2) I/2" LAG SCREWS = 12" O.C. STAGGERED. SEE SECTION R103.82.1 OF THE 2018 NCRC FOR ADDITIONAL BRICK SUPPORT INFORMATION.
- PRECAST REINFORCED CONCRETE LINTELS ENGINEERED BY OTHERS MAY BE USED IN LIEU OF STEEL LINTELS.

## STRUCTURAL NOTES:

- ALL FRAMING LUMBER TO BE SPF 12 (UNO). ALL TREATED LUMBER TO BE SYP 12 (UNO). ALL LOAD BEARING HEADERS TO BE (2) 2 x 6 (UNO).
- PROVIDE AN EXTRA JOIST UNDER WALLS PARALLEL
   TO FLOOR JOISTS WHERE NOTED ON THE PLANS.
   WINDOW AND DOOR HEADERS TO BE SUPPORTED W/ (1)
- JACK STUD AND (1) KING STUD EA, END (UNO.), SEE TABLE R602.15 FOR ADDITIONAL KING STUD REQUIREMENTS.
  SQUARES DENOTE POINT LOADS WHICH REQUIRE SOLID
- BLOCKING TO GIRDER OR FOUNDATION. ALL SQUARES
- TO BE (2) STUDS (UNC.)
  FOR HIGH WIND ZONES, ALL EXTERIOR WALLS TO BE SHEATHED WITH 1/16" OSB SHEATHING WITH JOINTS BLOCKED AND SECURED WITH 8d NAILS AT 3" O.C.
- ALONG EDGES AND 6" O.C. IN THE FIELD.
  FOR HIGH WIND ZONES, SECURE ALL EXTERIOR WALL
  SHEATHING PANELS TO DOUBLE TOP PLATES, BANDS, JOISTS, AND GIRDERS WITH (2) ROWS OF 8d NAILS STAGGERED AT 3" OC. PANELS SHALL EXTEND 12" BEYOND CONSTRUCTION JOINTS AND SHALL OVERLAP GIRDERS AND DOUBLE SILL PLATES THEIR FULL
- DEPTH.
  ALL 4 x 4 PO6TS SHALL BE ANCHORED TO SLABS W/
  SIMPSON ABU44 PO6T BASES (OR EQUAL) AND 6 x 6
  PO6TS W/ ABU66 PO6T BASES (OR EQUAL) (UNO). ALL 4 x 4 AND 6 x 6 POSTS TO BE INSTALLED WITH TOO
- LB CAPACITY UPLIFT CONNECTORS AT TOP (UNO.) FOR FIBERGLASS, ALUMINUM, OR COLUMN ENG. BY OTHERS, SECURE TO SLAB w/ (2) METAL ANGLES USING 2" CONC. SCREWS, FASTEN ANGLES TO COLUMNS w/ 1/4 THROUGH BOLTS W/ NUTS AND WASHERS. LOCATE ANGLES ON OPPOSITE SIDES OF COLUMN. THROUGH BOLTS MUST BE INSTALLED PRIOR TO SETTING
- IØ. REFER TO NOTES AND DETAIL SHEETS FOR ADDITIONAL STRUCTURAL INFORMATION.

'DSP' INDICATES DOUBLE STUD POCKET BETWEEN



NOTE: BCI 45005-18 JOISTS MAY BE INSTALLED IN LIEU DEPTH AND SPACING

**S**27605 » NC ഗ ERING, EVITE 104 RALEIGH, D 89,3919 FAX. (919) 78 ICENSE NO.: C-1733 田山 

> INC. KENT H&H HOMES, I

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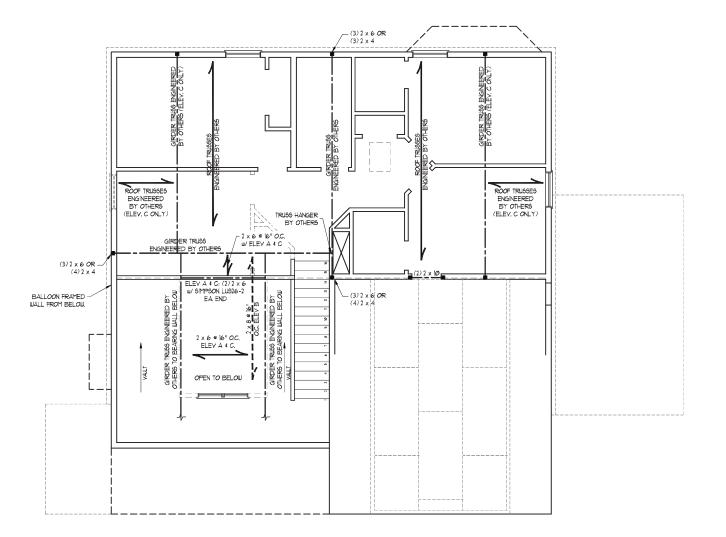
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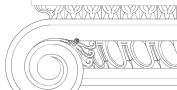
OF: 8

S-2 SECOND FLOOR FRAMING PLAN

OF TJI 110 JOISTS AT THE INDICATED ON THE PLAN



\*NOTE: ALL EXTERIOR WALLS AND ATTIC WALLS ARE TO BE 2 x 6 @ 16" O.C. MIN. (UNO). 2 x 4 @ 16" O.C. EXTERIOR WALLS MAY BE CONSTRUCTED IN LIEU OF 2 x 6 WALLS (UNO). ALL INTERIOR LOAD BEARING WALLS ARE TO BE 2 x 4 @ 16" O.C. (UNO) AND NON-LOAD BEARING INTERIOR WALLS ARE TO BE 2 x 4 @ 24" O.C. (UNO).



J.S. THOMPSON
ENGINEERING, INC
606 WADE AVE. SUITE OF RALEOH, NC.7665
PHONE (919) 789-9921
N.C. LICENSE NO.: C.773

## BRACED WALL DESIGN NOTES:

- BRACED WALL DESIGN PER SECTION R602.10 OF THE NORC 2018 EDITION. CS-WSP REFERS TO "CONTINUOUS SHEATHING - WOOD
- CS-USP REFERS TO "CONTINUOUS SHEATHING UDODO
  STRUCTURAL PANELS" CONTRACTOR IS TO NISTALL 176" 05B
  ON ALL EXTERIOR WALLS ATTACHED W 8d NAILS SPACED 6"
  OC. ALONG PANEL EDGES AND 1" 0" OC. NI THE FIELD.
  4GB REFERS TO "GYPSUM BOARD" CONTRACTOR 16 TO INSTALL
  12" ("MIN) GYPSUM WALL BOARD WHERE NOTED ON THE PLANS.
  FASTEN GB WITH I V4" SCREWS OR 15/8" NAILS SPACED 1" OC.
- FASTEN GE WITH 1/4" SCREWS OR 19/6" NALES FAZED 1" OZ.
  ALONG PAZALE DICES AND IN THE FELD INCLUDING TOP AND
  BOTTOM PLATES,
  BRACED WALL DESIGN APPLIED IN WIND ZONES UP TO 130 MPH.
  FOR HIGH WIND ZONES, BRACE WALLS ARE TO BE CONSTRUCTED
  IN ACCORDANCE WITH CHAPTER 45 OF THE NCRC 20/8 EDITION.
  SEE NOTES AND DETAIL SHEETS FOR ADDITIONAL BRACED
  WALL INFORMATION.

## NOTE:

- L PER SECTION R6021032 OF THE 2018 NCRC, THE AMOUNT OF BRACING ON THE SECOND FLOOR EXCEEDS THE AMOUNT REQUIRED FOR THE FIRST FLOOR AND NO BRACED WALL
- ANALY91S 16 REQUIRED.
  SHEATH ALL EXTERIOR WALLS WITH 1/16" OSB SHEATHING
  ATTACHED WITH 2d NAILS AT 6" O.C. ALONG PANEL EDGES AND
  12" O.C. IN THE FIELD.

LINTEL SCHEDULE FOR BRICKNATURAL STONE SUPPORT		
LENGTH (FT.)	SIZE OF LINTEL	
UP TO 4 FT.	L 3 1/2 x 3 1/2 x 1/4	
4-8	L 5 x 3 1/2 x 5/16 LLV	
8 AND GREATER	L 6 x 4 x 5/16 LLV	

## BRICK SUPPORT NOTES:

LINTEL SCHEDULE APPLIES TO ALL OPENINGS IN BRICK VENEER (UNO), SEE ARCH DWGS, FOR SIZE AND LOCATION OF OPENINGS.

(LLY) = LONG LEG VERTICAL

LENGTH = CLEAR OPENING

EMBED ALL ANGLE IRONS MIN. 4" EACH

EFIBEU ALL ANGLE INCHO PION, A" EACH SIDE NTO VENERE TO PROVIDE BEARING. FOR ALL HEADERS 9"-0" AND GREATER N LENGTH, ATTACH STEEL ANGLE TO HEADER W 12" LAG SCREWS 9 12" O.C. STAGGERED. FOR ALL BRICK SUPPORT 9 ROOF LINES, EASTEN (23" v. M.B. OCKNO PETILES).

FOR ALL BRICK SUPPORT & ROOF LINES, FASTEN (2) 2 x 10 BLOCKING BETWEEN STUDS W/ (4) 12d NAILS PER PLY, FASTEN A 6" x 4" x 5/16" STEEL ANGLE TO (2) 2 x D BLOCKING W/ (2) 1/2" LAG SCREUS & 12" OC. STAGGERED, SEE SECTION R103.82.1 OF THE 2018 NCRC FOR ADDITIONAL

BRICK SUPPORT INFORMATION. PRECAST REINFORCED CONCRETE
LINTELS ENGINEERED BY OTHERS MAY BE
USED IN LIEU OF STEEL LINTELS.

## SEAL 33736

## TABLE R602,7.5 MINIMUM NUMBER OF FULL HEIGHT STUDS AT EACH END OF HEADERS IN EXTERIOR WALLS

	HEADER SPAN (FEET)	MAXIMUM STUD SPACING (INCHES (PER TABLE R6023(5)	
		16	24
	UP TO 31	1	1
	4'	2	1
	8'	3	2
	12'	5	3
	16'	6	4

## STRUCTURAL NOTES:

- ALL TREATED LUMBER TO BE SYP 12 (UNO.)
  ALL LOAD BEARING HEADERS TO BE (2) 2 x
  6 (UNO.)
  WINDOW AND DOOR HEADERS TO BE
- SUPPORTED W/(I) JACK STUD AND (I) KING STUD EA END (UNO.). SEE TABLE R602.1.5 FOR ADDITIONAL KING STUD REQUIREMENTS. SQUARES DENOTE POINT LOADS WHICH
- REQUIRE SOLID BLOCKING TO GIRDER OR FOUNDATION. ALL SQUARES TO BE (2)
  STUDS (UNO.)
  FOR HIGH WIND ZONES, ALL EXTERIOR WALLS
- TO BE SHEATHED WITH THE" O'S SHEATHING WITH JOINTS BLOCKED AND SECURED WITH 8d NAILS AT 3" O.C. ALONG EDGES AND 6" O.C. IN THE FIELD.
- FOR HIGH WIND 70NES SECURE ALL EXTERIOR WALL SHEATHING PANELS TO DOUBLE TOP PLATES, BANDS, JOISTS, AND GIRDERS WITH (2) ROUS OF 8d NAILS STAGGERED AT 3" OC PANELS SHALL STAGGERED 12" BEYOND CONSTRUCTION JOINTS AND SHALL OVERLAP GIRDERS AND DOUBLE SILL PLATES THEIR FULL DEPTH. REFER TO NOTES AND DETAIL SHEETS FOR ADDITIONAL STRUCTURAL INFORMATION.

DATE: AUGUST 12, 2020 CALE: 1/4" = 1'-0"


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NGINEERED BY: WFB

SHEET: 5 OF: 8 S-3

CEILING FRAMING PLAN

INC. KENT H&H HOMES, I

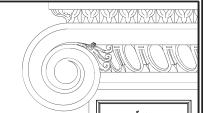

## ATTIC VENT CALCULATION:

1815 SQ. FT. OF ATTIC DIVIDED BY 150 REQUIRES 12.5 SQ. FT. OF NET FREE VENTILATING AREA (MIN.).

## BRICK SUPPORT NOTE:

- FASTEN (2) 2 × 10 BLOCKING BETWEEN WALL STUDS W (4) 12d NAILS FER PLY, FASTEN A 6\* x 4\* x 5/6\* 5 TEEL ANGLE TO (2) 2 x 10 BLOCKING W (2) 12\* 12d SCREIUS 6\* 12\* 0.C. STAGERED. SEE SECTION RI093821. OF THE 2/08 NCRC FOR ADDITIONAL BRICK SUPPORT INFORMATION.

  WHERE ROOF SLOPES EXCEED 1-12, NSTALL 3\* x 3\* x 1/4\* STEEL PLATE STOPS AT 24\* OC. PER SECTION RI093821 OF THE NORTH CAROLINA RESIDENTIAL CODE, 2018

  EDITION.

## STRUCTURAL NOTES:

- STRUCTURAL NOTES:

  ALL FRAMING LUMBER TO BE 12

  FOR (NO).

  CIRCLES DENOTE (3) 2 x 4 PO615
  FOR ROOF SUPPORT.

  FRAME DORFITE WALLS ON TOP
  OF DOUBLE OR TRIPLE RAFTERS.

  HIP SPLICES ARE TO BE SPACED
  A MIN OF 8'-0". FASTEN
  MEMBERS WITH THREE ROUS OF
  IZO NAILS & 16" OC. (17P)

  STICK FRAME OVER-FRAMED
  ROOF SECTIONS W 2 x 8 RIDGES
  2 x 6 RAFTERS & 16" OC. AND
  HLAT 2 x 10" VALLEYS OR USE
  VALLEY TRUSGES.

  FASTEN FLAT VALLEYS OR USE
  VALLEY TRUSGES.

  FASTEN FLAT VALLEYS OR USE
  VALLEY TRUSGES.

  FASTEN FLAT VALLEYS TO
  RAFTERS OR TRUSGES WITH
  SIMPSON 12.5A HURRICANE TIES 14 ROUSH NOOF
  SHEATHNG. EACH RAFTER 16 TO
  BE FASTENED TO THE FLAT
  VALLEY WITH A MIN. OF (6) 12'd
  TOE NAILS.

  REFER TO SECTION REQUII OF THE
  2018 NCRC FOR REGUIRED UPLIFT
  RESISTANCE AT RAFTERS AND
  TRUSGES.

  REFER TO NOTES AND DETAIL
  SHEETS FOR ADDITIONAL
  STRUCTURAL INFORMATION.

ENGINEERING, INC
606 WADE AVE, SUTE 104 RALEIGH, NC.27605
HONE, (919) 789-9919 FAX, (919) 789-9921
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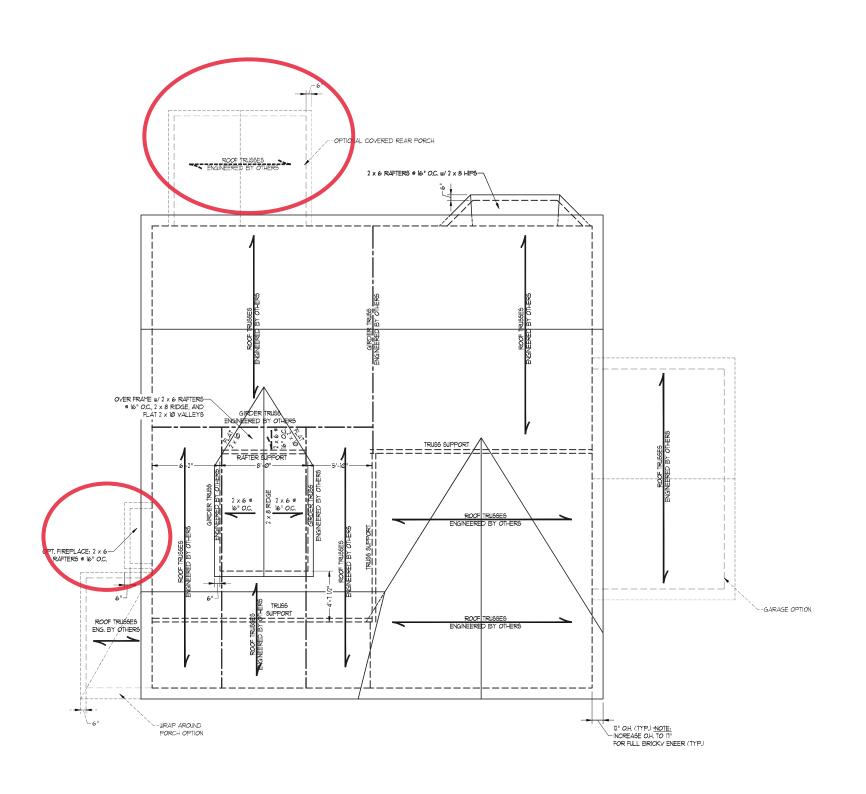
KENT H&H HOMES, INC.

DATE: AUGUST 12, 2020


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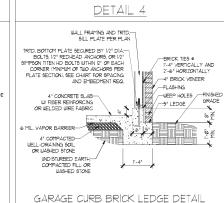
ENGINEERED BY: WFB

SHEET: 6 OF: 8 S-4a ROOF FRAMING PLAN





ELEVATION A




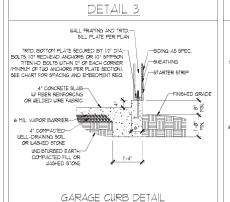


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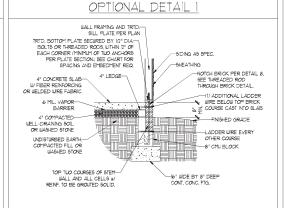


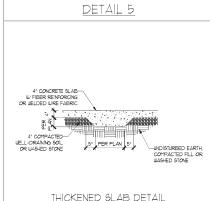

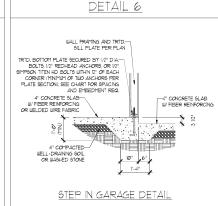

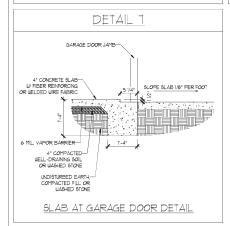
## STEMWALL DETAILS




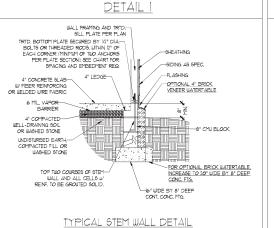



OPTIONAL STEM WALL DETAIL

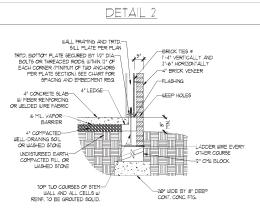


(W/ OPTIONAL WATERTABLE

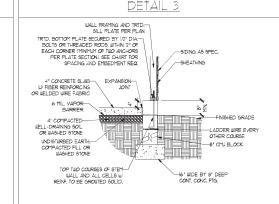

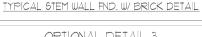

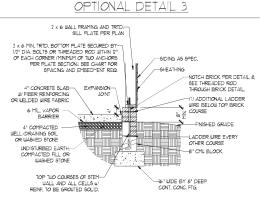

OPTIONAL STEM WALL FND. DETAIL W/ CURB @ GARAGE

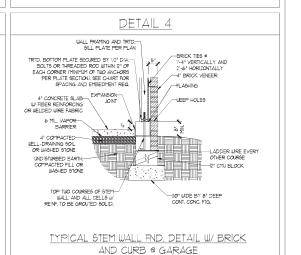

TYPICAL STEM WALL FND. DETAIL W/ CURB @ GARAGE

DETAIL 8 INSIDE EDGE OF 1/2" ANCHOR ROD MASONRY STEMWALL I ADDER WIRE BRICK MASONRY 000 000 000 OUTSIDE EDGE OF BRICK AND STICK FRAMED WALL ABOVE -ROD AND GROUT SOLID THREADED ROD THROUGH BRICK MASONRY

MASONRY STEMWALL SPECIFICATIONS MASONRY WALL TYPE WALL HEIGHT (FEET) 4" BRICK AND 4" 4" BRICK AND 8" 8" CMU 12" CMU 2 AND BELOW UNGROUTED GROUT SOLID UNGROUTED UNGROUTED UNGROUTED GROUT SOLID UNGROUTED UNGROUTED GROUT SOLID w/ \*4 REBAR @ 48" O.C. GROUT SOLID w/ \*4 REBAR @ 64" O.C. GROUT SOLID GROUT SOLID GROUT SOLID W/ \*4 GROUT SOLID W/ \*4 GROUT SOLID w/ #4 5 NOT APPLICABLE REBAR @ 36" O.C. NOT APPLICABLE GROUT SOLID W/ \*4 GROUT SOLID W/ \*4 REBAR @ 24\* O.C. REBAR @ 64\* O.C. GROUT SOLID w/ \*4 REBAR @ 24" O.C. 6

### STRUCTURAL NOTES:

WALL HEIGHT MEASURED FROM TOP OF FOOTING TO TOP OF THE WALL.
TIE MULTIPLE WITHES TOGETHER WITH LADDER WIRE AT 16" O.C. VERTICALLY.
CHART APPLICABLE FOR HOUSE FOUNDATION ONLY, CONSULT ENGINEER FOR DESIGN OF GARAGE FOUNDATION NOT COMMON TO HOUSE.

ENGINEERED DESIGN BASED ON SITE CONDITIONS

FOUNDATION NOT COMMON TO HOUSE.

BACKFILL OF CLEAN 51 / 51 MASHED STONE 16 ALLOWABLE.

BACKFILL OF WELL DRAINED OR SAND - GRAVEL MIXTURE SOILS (45 PSP.FT BELOW GRADE)

CLASSIFIED AS GROUP I ACCORDING TO INFIRED SOILS CLASSIFICATION SYSTEM IN ACCORDANCE

WITH TABLE RADS OF THE 708 INTERNATIONAL RESIDENTIAL CODE ARE ALLOWABLE.

PREP \$LAB PER RS0621 AND RS0622 BASE OF THE 2018 INTERNATIONAL RESIDENTIAL CODE.

MINIMUM 24" LAP SPLICE LENGTH.

1 AND GREATER

LOCATE REBAR IN CENTER GIF.

LOCATE REBAR IN CENTER OF FOUNDATION WALL.

WHERE REQUIRED, FILL BLOCK SOLID WITH TYPE "S" MORTAR OR 3000 PSI GROUT, USE OF "LOW LIFT GROUTING" METHOD REQUIRED WHEN FILLING WALLS WITH GROUT AT HEIGHTS OF 5" AND GREATER

ANCHOR SPACING AND EMBEDMENT			EMBEDMENT
l	WIND ZONE	120 MPH	130 MPH
	SPACING.	6'-0" O.C.	4'-0" O.C.
	EMBEDMENT	7 <sup>n</sup>	15" INTO MASONRY 1" INTO CONCRETE

SPEED WIND

CALE: NTS GINEERED BY: JES

D-1 FOUNDATION DETAILS







MPH ULTIMATE DESIGN FOUNDATION DETAILS 130] 120 MPH -


- WALL BRACING DESIGNED IN ACCORDANCE WITH CHAPTER 6 OF THE 2018 NC RESIDENTIAL BUILDING CODE (NCRC). TABLES AND FIGURES REFERENCED ARE FROM THE 2018 NCRC. SEE THIS SHEET FOR GENERAL DETAILS. REFER TO THE 2018 NORG FOR ADDITIONAL INFORMATION AS NEEDED
- SEE STRUCTURAL SHEETS FOR BRACED WALL LOCATIONS, DIMENSIONS, HOLD DOUR TYPE AND LOCATIONS, BRACED WALL LINE KEY WITH WALL DESIGN SUMMARY OF REQUIRED/PROVIDED TOTALS FOR EACH WALL LINE AND ANY SPECIAL NOTES
- 4. ALL EXTERIOR WALLS ARE TO BE SHEATHED WITH CS-WSP IN ACCORDANCE WITH SECTION R602.10.3 UNLESS NOTED OTHERWISE.
- O HERWISE.


  ALL EXTERIOR AND INTERIOR WALLS TO HAVE 1/2" GYPSUM INSTALLED, WHEN NOT USING METHOD "GB", GYPSUM TO BE FASTENED PER TABLE RIGOLS, METHOD GB TO BE FASTENED PER TABLE REGOL/Ø]

  6. CS-WSP REFERS TO THE "CONTINUOUS SHEATHING. WOOD STRUCTURAL PANELS" WALL BRACING METHOD. TI/6" OSB SHEATHING IS TO BE NISTALLED ON ALL EXTERIOR WALLS ATTACHED W 6d COMMON NAILS OR 8d (2) 1/2" LONG X Ø]13" DIAMETER) NAILS SPACED 6" O.C. ALONG PANEL EDGES AND 12" O.C. IN THE FIELD (UN.O.).
- GB REFERS TO THE "GTPSM" BOARD" WALL BRACING METHOD. 12" (MIN) GYPSM" WALL BOARD IS TO BE INSTALLED ON BOTH SIDES OF THE BRACED WALL FASTENED WITH 114" SCREWS OR 15.0" NALLS SPACED T" OC. ALONG PARAL EDGES NICLUDING TOP AND BOTHOM PLATES AND INTERMEDIATE SUPPORTS (MIN). VERBY ALL FASTENED WITH STORY AND SOTOM PLATES AND INTERMEDIATE SUPPORTS (MIN). VERBY ALL FASTENED WITH STORY AND 5/8" GYPSM" FRIOR TO CONSTRUCTION. FOR INTERIOR FASTENER OPTIONS SEE TABLE RT0235. FOR EXTERIOR FASTENER OPTIONS SEE TABLE R6023(1). EXTERIOR GB TO BE INSTALLED VERTICALLY.
- REQUIRED BRACED WALL LENGTH FOR EACH SIDE OF THE CIRCUMSCRIBED RECTANGLE ARE INTERPOLATED PER TABLE R602, 103, METHOD CS-USP CONTRIBUTES ITS ACTUAL LENGTH, METHOD GB CONTRIBUTES 5 ITS ACTUAL LENGTH, AND METHOD PF CONTRIBUTES IS TIMES ITS ACTUAL LENGTH.

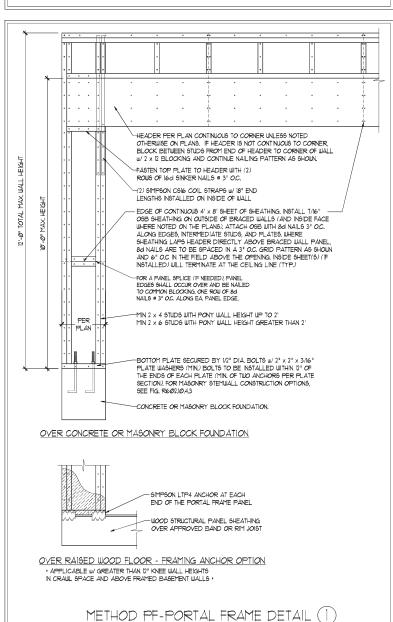

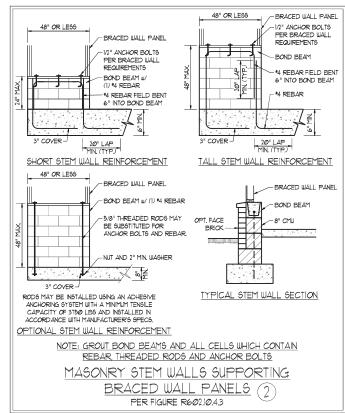

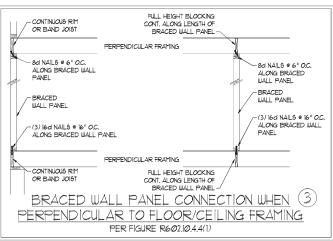


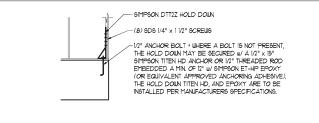



HOLD DOWN DETAIL FOR MASONRY FOUNDATION OR MONOLITHIC SLAB \* APPLICABLE ONLY WHERE SPECIFIED ON PLAN


TYPICAL EXTERIOR CORNER FRAMING FOR CONTINUOUS SHEATHING (5) PER FIGURE R602.10.3(5) MIN. 24" WOOD STRUCTURAL SEE TABLE R6@23(1) PANEL AN 800 LB HOLD DOWN VARY, SEE FIGURE R6023(2) -GYP9UM WALLBOARD AS REQUIRED AND INSTALLED IN ACCORDANCE WITH CHAPTER 1 (TYP) OPTIONAL NON-STRUCTURAL CONTINUOUS WOOD STRUCTURA FILLER PANEL -PANEL BRACED WALL LINE SEE TABLE R6023(1) FOR FASTENING (a) OUTSIDE CORNER DETAIL (5a) ORIENTATION OF STUD MAY VARY, SEE FIGURE R602.3(2) 16d NAIL (3 1/2" x Ø.131". CONTINUOUS WOOD STRUCTURAL PANEL BRACED WALL LINE SEE TABLE R602.3(1) GYPSIM IIIALI BOARD AS FOR FASTENING MIN. 24" WOOD STRUCTURAL PANEL CORNER RETURN, AN 800 LB HOLD CHAPTER 1 (TYP.) DOWN DEVICE MAY BE INSTALLED IN LIEU OF CORNER RETURN (b) INSIDE CORNER DETAIL (5b) GYPSUM WALLBOARD AS REQUIRED - SEE TABLE R602 3(1) AND INSTALLED IN ACCORDANCE WITH CHAPTER 1 (TYP. (2 ROUS @ 24" O.C. -MIN. 24" WOOD STRUCTURAL SHEATHING PER PLAN PANEL CORNER RETURN. AN 800 LB HOLD DOWN DEVICE MAY BE INSTALLED IN LIEU CONTINUOUS ILLOOD FASTENERS ON EACH STUD (5c) AT EACH PANEL EDGE

> (c) GARAGE DOOR CORNER DETAIL (SEE PLAN FOR ADDITIONAL STRUCTURAL INFORMATION OR ALTERNATE CONFIGURATIONS)

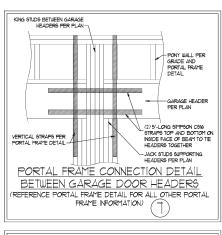

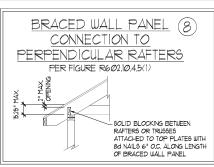

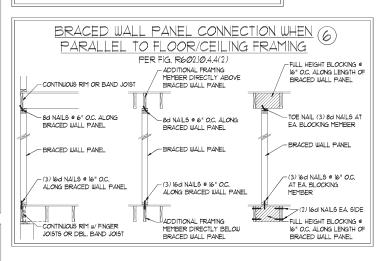

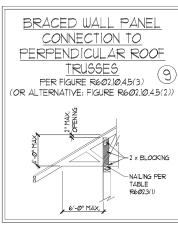

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CALE: 1/4" = 1'-0" DRAWN BY: IST

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SPEED S DESIGN WIND S AND DETAILS MPH ULTIMATE I BRACING NOTES MPH - 130 P WALL E

DATE: NOVEMBER 14, 2018

120

BRACED WALL NOTES AND DETAILS

ALL FRAMING LUMBER SHALL BE 12 SPF MINIMUM (Fb = 875 PS) Fv = 375 PS) F = 16,000,000 PS() LINLESS NOTED OTHERWISE (LINC) ALL TREATED LUMBER SHALL BE  $^{1}$ 2 SYP MINIMUM (Fb = 915 PSI, Fv =115 PSI, E = 1600000 PSI) UNLESS NOTED OTHERWISE (UNC

FRAMING NOTES

- LAMINATED VENEER LUMBER (LVL) SHALL HAVE THE FOLLOWING MINIMUM PROPERTIES: Fo =2600 PSI, Fv = 285 PSI, E = 19000000 PSI. LAMINATED STRAND LUMBER (LSL) SHALL HAVE THE FOLLOWING MINIMUM PROPERTIES; Fb = 2325 PSI, Fv = 310 PSI, E = 1550000 PSI, PARALLEL STRAND LUMBER (PSL.) UP TO 1" DEPTH SHALL HAVE THE FOLLOWING MINIMUM PROPERTIES: Fo = 2500 FSI, E = 15000000 FSI, PARALLEL STRAND LUMBER (PSL.) MORE THAN 1" DEPTH SHALL HAVE THE FOLLOWING MINIMUM PROPERTIES: Fo = 2900 FSI, E = 20000000 PSI. INSTALL ALL CONNECTIONS PER MANUFACTURER'S SPECIFICATIONS.
- 3. STRUCTURAL STEEL SHALL CONFORM TO THE FOLLOWING ASTM SPECIFICATIONS

W AND WT SHAPES: CHANNELS AND ANGLES: ASTM A36 HOLLOW STRUCTURAL SECTIONS: ASTM A500 GRADE B ASTM A53, GRADE B, TYPE E OR S

4. STEEL BEAMS SHALL BE SUPPORTED AT EACH END WITH A MINIMUM BEARING LENGTH OF 3 1/2" AND FULL FLANGE WIDTH (UNO). PROVIDE SOLID BEARING FROM BEAM SUPPORT TO FOUNDATION. BEAMS SHALL BE ATTACHED AT THE BOTTOM FLANGE TO EACH SUPPORT AS FOLLOWS (UNO):

A. WOOD FRAMING (2) 1/2" DIA. x 4" LONG LAG SCREWS B. CONCRETE C. MASONRY (FULLY GROUTED) (2) 1/2" DIA. x 4" LONG SIMPSON TITEN HD ANCHORS

LATERAL SUPPORT IS CONSIDERED ADEQUATE PROVIDING THE JOISTS ARE TOE NAILED TO THE 2x NAILER ON TOP OF THE STEEL BEAM, AND THE 2x NAILER 16 SECURED TO THE TOP OF THE STEEL BEAM w/ (2) ROUG OF SELF TAPPING SCREUG ® 16" O.C. OR (2) ROUG OF 1/2" DIAMETER BOLTS ® 16" O.C. IF 1/2" BOLTS ARE USED TO FASTEN THE NAILER, THE STEEL BEAM SHALL BE FABRICATED w/ (2) ROUG OF 9/6" DIAMETER

- 5. SQUARES DENOTE POINT LOADS WHICH REQUIRE SOLID BLOCKING TO GIRDER OR FOUNDATION, SHADED SQUARES DENOTE POINT LOADS
- $6. \quad \text{ALL LOAD BEARING HEADERS TO CONFORM TO TABLE R602.7(1) AND R602.7(2) OF THE NCRC, 2018 EDITION OR BE (2) 2 × 6 WITH (1) JACK } \\$ AND (1) KING STUD EACH END (UNO), WHICHEVER IS GREATER ALL HEADERS TO BE SECURED TO EACH JACK STUD WITH (4) 8d NAILS. ALL BEAMS TO BE SUPPORTED WITH (2) STUDS AT EACH BEARING POINT (UNO). INSTALL KING STUDS PER SECTION R602.7.5 OF THE NORTH CAROLINA RESIDENTIAL CODE, 2018 EDITION.
- 1. ALL BEAMS, HEADERS, OR GIRDER TRUSSES PARALLEL TO WALL ARE TO BEAR FULLY ON (1) JACK OR (2) STUDS MINIMUM OR THE NUMBER OF JACKS OR STUDS NOTED. ALL BEAMS OR GIRDER TRUSSES PERPENDICULAR TO WALL AND SUPPORTED BY (3) STUDS OR LESS ARE TO HAVE I 1/2" MINIMUM BEARING (UNO). ALL BEAMS OR GIRDER TRUSSES PERPENDICULAR TO WALL AND SUPPORTED BY MORE THAN (3) STUDS OR OTHER NOTED COLUMN ARE TO BEAR FULLY ON SUPPORT COLUMN FOR ENTIRE WALL DEPTH (UNO). BEAM ENDS THAT BUTT INTO ONE ANOTHER ARE TO EACH BEAR EQUAL LENGTHS (UNO).
- FLITCH BEAMS SHALL BE BOLTED TOGETHER USING 1/2" DIAMETER BOLTS (ASTM A3/01) WITH WASHERS PLACED AT THREADED END OF BOLT. BOLTS SHALL BE SPACED AT 24" CENTERS (MAXIMUM), AND STAGGERED AT TOP AND BOTTOM OF BEAM (2" EDGE DISTANCE), WITH (2) BOLTS OCATED AT 6" FROM EACH END (UNO)
- 9. ALL I-JOIST OR TRUSS LAYOUTS ARE TO BE IN COMPLIANCE WITH THE OVERALL DESIGN SPECIFIED ON THE PLANS, ALL DEVIATIONS ARE TO BE BROUGHT TO THE ATTENTION OF THE ENGINEER OF RECORD PRIOR TO INSTALLATION.
- IØ. BRACED WALL PANELS SHALL BE CONSTRUCTED ACCORDING TO THE NORTH CAROLINA RESIDENTIAL CODE 2018 EDITION WALL BRACING CRITERIA, THE AMOUNT, LENGTH, AND LOCATION OF BRACING SHALL COMPLY WITH ALL APPLICABLE TABLES IN SECTION R602.10.
- PROVIDE DOUBLE JOIST UNDER ALL WALLS PARALLEL TO FLOOR JOISTS. PROVIDE SUPPORT UNDER ALL WALLS PARALLEL TO FLOOR TRUSSES OR 1-JOISTS PER MANUFACTURER'S SPECIFICATIONS. INSTALL BLOCKING BETWEEN JOISTS OR TRUSSES FOR POINT LOAD SUPPORT FOR ALL POINT LOADS ALONG OFFSET LOAD LINES.
- 12. FOR ALL HEADERS SUPPORTING BRICK VENEER THAT ARE LESS THAN 8'-0" IN LENGTH, REST A 6" x 4" x 5/6" STEEL ANGLE WITH 6" MINIMUM EMBEDMENT AT SIDES FOR BRICK SUPPORT (UN.O.). FOR ALL HEADERS 8'-Ø" AND GREATER IN LENGTH, BOLT A 6" x 4" x 5/16" STEEL ANGLE TO HEADER WITH 1/2" LAG SCREWS AT 12" O.C. STAGGERED FOR BRICK SUPPORT. FOR ALL BRICK SUPPORT AT ROOF LINES, BOLT A 6" x 4" x 5/16" STEEL ANGLE TO (2) 2 x 10 BLOCKING INSTALLED W/ (4) 12d NAILS EA. PLY BETWEEN WALL STUDS WITH (2) ROWS OF 1/2" LAG SCREWS AT 12" O.C. STAGGERED AND IN ACCORDANCE WITH SECTION RT03.82.1 OF THE NCRC, 2018 EDITION.
- 13. FOR STICK FRAMED ROOFS: CIRCLES DENOTE (3)  $2 \times 4$  POSTS FOR ROOF MEMBER SUPPORT. HIP SPLICES ARE TO BE SPACED A MINIMUM OF 8'-0". FASTEN MEMBERS WITH THREE ROWS OF 12d NAILS AT 16" O.C. FRAME DORMER WALLS ON TOP OF DOUBLE OR TRIPLE RAFTERS AS
- 14. FOR TRUSSED ROOFS, FRAME DORMER WALLS ON TOP OF 2 x 4 LADDER FRAMING AT 24" O.C. BETWEEN ADJACENT ROOF TRUSSES, STICK FRAME OVER-FRAMED ROOF SECTIONS WITH 2 x 8 RIDGES, 2 x 6 RAFTERS AT 16" O.C. AND FLAT 2 x 10" VALLEYS (UNO).
- ALL 4 x 4 AND 6 x 6 POSTS TO BE INSTALLED WITH 100 LB CAPACITY UPLIFT CONNECTORS TOP AND BOTTOM (UNO.) POSTS MAY BE SECURED USING ONE SIMPSON H6 OR LTS12 UPLIFT CONNECTOR FASTENED TO THE BAND AT THE BOTTOM AND THE BEAM AT THE TOP OF EACH POST. ONE 16" SECTION OF SIMPSON CS16 COIL STRAPPING WITH (8) 8d HDG NAILS AT EACH END MAY BE USED IN LIEU OF EACH TWIST STRAP IF DESIRED. FOR MASONRY OR CONCRETE FOUNDATION USE SIMPSON POST BASE.

## GENERAL NOTES

- 1 ENGINEER'S SEAL APPLIES ONLY TO STRUCTURAL COMPONENTS INCLUDING ROOF RAFTERS HIPS VALLEYS RIDGES FLOORS WALLS BEAMS HEADERS, COLUMNS, CANTILEYERS, OFFSET LOAD BEARING WALLS, PIERS, GIRDER SYSTEM AND FOOTING. ENGINEER'S SEAL DOES NOT CERTIFY DIMENSIONAL ACCURACY OF ARCHITECTURAL LAYOUT INCLUDING ROOF, ENGINEER'S SEAL DOES NOT APPLY TO 1-JOIST OR FLOOR/ROOF TRUSS
- ALL CONSTRUCTION SHALL CONFORM TO THE LATEST REQUIREMENTS OF THE NORTH CAROLINA RESIDENTIAL CODE (NORC.), 2018 EDITION, PLUS
  ALL LOCAL CODES AND REGULATIONS. THE STRUCTURAL ENGINEER IS NOT RESPONSIBLE FOR, AND WILL NOT HAVE CONTROL OF, CONSTRUCTION MEANS METHODS TECHNIQUES SEQUENCES OR PROCEDURES OR SAFETY PRECAUTIONS AND PROGRAMS IN CONNECTION WITH THE CONSTRUCTION WORK. NOR WILL THE ENGINEER BE RESPONSIBLE FOR THE CONTRACTORS FAILURE TO CARRY OUT THE CONSTRUCTION WORK IN ACCORDANCE WITH THE CONTRACT DOCUMENTS.
- 3. STRUCTURAL DESIGN BASED ON THE PROVISIONS OF THE NCRC, 2018 EDITION (R3014 R3011)

DESIGN CRITERIA:	LIVE LOAD (PSF)	DEAD LOAD (PSF)	DEFLECTION (IN)
ATTIC WITH LIMITED STORAGE	2Ø	10	L/240 (L/360 w/ BRITTLE FINISHES)
ATTIC WITHOUT STORAGE	10	10	L/36Ø
DECK5	40	10	L/36Ø
EXTERIOR BALCONIES	40	10	L/36Ø
FIRE ESCAPES	40	10	L/36Ø
HANDRAILS/GUARDRAILS	2000 LB OR 50 (PLF)	10	L/36Ø
PASSENGER VEHICLE GARAGE	5Ø	10	L/36Ø
ROOMS OTHER THAN SLEEPING ROOM	40	10	L/36Ø
SLEEPING ROOMS	3Ø	10	L/36Ø
STAIRS	40	10	L/36Ø
WIND LOAD	(BASED ON TABLE R3Ø12(4	4) WIND ZONE AND EXPOSURE)	
GROUND SNOW LOAD: Pg	2Ø (PSF)		

- I-JOIST SYSTEMS DESIGNED WITH 12 PSF DEAD LOAD AND DEFLECTION (IN) OF L/480
- FLOOR TRUSS SYSTEMS DESIGNED WITH 15 PSF DEAD LOAD
- 4. FOR 115 AND 120 MPH WIND ZONES FOUNDATION ANCHORAGE IS TO COMPLY WITH SECTION R403.16 OF THE NCRC, 2018 EDITION, FOR 130 MPH, 140 MPH, AND 150 MPH WIND ZONES, FOUNDATION ANCHORAGE IS TO COMPLY WITH SECTION 4504 OF THE NCRC, 2018 EDITION.
- 5. ENERGY EFFICIENCY COMPLIANCE AND INSULATION VALUES OF THE BUILDING TO BE IN ACCORDANCE WITH CHAPTER II OF THE NCRC, 2018 EDITION.

## FOOTING AND FOUNDATION NOTES

- 1. FOUNDATION DESIGN BASED ON A MINIMUM ALLOWABLE BEARNG CAPACITY OF 2000 PSF. CONTACT GEOTECHNICAL ENGINEER IF BEARNG CAPACITY IS NOT ACHIEVED.
- 2. FOR ALL CONCRETE SLABS AND FOOTINGS, THE AREA WITHIN THE PERIMETER OF THE BUILDING ENVELOPE SHALL HAVE ALL VEGETATION, TOP FOR ALL CORCNETE IS LABS AND FOOTINGS, THE AREA WITHIN THE PERITE ERY OF THE BUILDING ENVELOYE SHALL HAVE ALL YESTETATION OF THE SULPHIAN ENVELOYE SHALL HAVE ALL YESTETATION CONTROL THE FILL DEPTHS SHALL HAVE ALL YESTETATION CONTROL THE FILL DEPTHS SHALL NOT EXCEED 24 FOR CLEAN SAND OR GRAYEL. A 4" THICK BASED CONSISTING OF CLEAN GRADED SAND OR GRAYEL SHALL BE PLACED. A BASE COURSE CONSISTING OF CLEAN GRADED SAND OR GRAYEL SHALL BE PLACED. A BASE COURSE IS NOT REQUIRED UNLETE A CONCRETE SLAB IS INSTALLED ON USELL-DRAINED OR SAND-GRAY INTURIES OF IS CLASSIFIED AS GROUP I, ACCORDING TO THE UNITED SOIL CLASSIFICATION SYSTEM IN ACCORDANCE WITH TABLE R4051 OF THE NORC, 2018 EDITION.
- 3. PROPERLY DEWATER EXCAVATION PRIOR TO POURING CONCRETE WHEN BOTTOM OF CONCRETE SLAB IS AT OR BELOW WATER TABLE. IF APPLICABLE, 3/4" - 1" DEEP CONTROL JOINTS ARE TO BE SAUED WITHIN 4 TO 12 HOURS OF CONCRETE FINISHING AND WALL LOCATIONS HAVE BEEN MARKED. ADJUST WHERE NECESSARY.
- 4. CONCRETE SHALL CONFORM TO SECTION R4022 OF THE NCRC, 2018 EDITION, CONCRETE REINFORCING STEEL TO BE ASTM A615 GRADE 60 WELDED WIRE FABRIC TO BE ASTM AIRS. MAINTAIN A MINIMUM CONCRETE COVER AROUND REINFORCING STEEL OF 3" IN FOOTINGS AND 1 1/2" IN SLABS, FOR POURED CONCRETE WALLS, CONCRETE COVER FOR REINFORCING STEEL MEASURED FROM THE INSIDE FACE OF THE WALL SHALL ONOT BE LESS THAN 3/4". CONCRETE COVER FOR REINFORCING STEEL MEASURED FROM THE OUTSIDE FACE OF THE WALL. SHALL NOT BE LESS THAN 11/2" FOR 15 BARS OR SMALLER, AND NOT LESS THAN 2" FOR 16 BARS OR LARGER.
- 5. MASONRY UNITS TO CONFORM TO ACE 530/ASCE 5/TMS 402. MORTAR SHALL COMFORM
- 6. THE UNSUPPORTED HEIGHT OF MASONRY PIERS SHALL NOT EXCEED FOUR TIMES THEIR LEAST DIMENSION FOR UNFILLED HOLLOW CONCRETE MASONRY UNITS AND TEN TIMES THEIR LEAST DIMENSION FOR SOLID OR SOLID FILLED PIERS. PERS MAY BE FILLED SOLID WITH CONCRETE OR TYPE M OR 5 MORTAR PIERS AND WALLS SHALL BE CAPPED WITH 8" OF SOLID MASONRY
- THE CENTER OF EACH OF THE PIERS SHALL BEAR IN THE MIDDLE THIRD OF ITS RESPECTIVE FOOTING, EACH GIRDER SHALL BEAR IN THE MIDDLE THIRD OF THE PIERS.
- 8. ALL CONCRETE AND MASONRY FOUNDATION WALLS ARE TO BE CONSTRUCTED IN ACCORDANCE WITH THE PROVISIONS OF SECTION RIPS OF INTENSIVE EDITION OR IN ACCORDANCE WITH ACI 318, ACI 332, NCM\* AREA-A OR ACE 350/ASCE 5/1705 462. WASONRY FOUNDATION WALLS ARE TO BE REINFORCED PER TABLE RAGALINI), RAGALINIZ), RAGALINIZ), OR RAGALINI OF THE NCRC, 2019 EDITION. CONCRETE FOUNDATION WALLS ARE TO BE REINFORCED PER TABLE RAGALINIZ) OF THE NCRC, 2019 EDITION. STEP CONCRETE FOUNDATION WALLS AT 16" OC. WHERE GRADE PERMITS (UNO).

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S-0 STRUCTURAL NOTES

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