

CONSTRUCTION SHEET LIST


SHEET NUMBER	SHEET NAME
E-0	COVER SHEET
E-1	FRONT & REAR ELEVATIONS
E-2	LEFT & RIGHT ELEVATIONS
E-3	ROOF OVERVIEW
F-1	FOUNDATION PLAN
F-1.1	CRAWL W/BRICK FOUNDATION DETAILS
F-2	FIRST FLOOR PLAN
F-3	FINISHED BONUS ROOM
GD-1	GARAGE DOOR DETAILS
H-1	FIRST FLOOR ELEC & HVAC PLAN
S-1	BONUS ROOM & STAIR SECTION
S-2	8" SITE BUILT COLUMN
S-3	FRAMING DETAILS
S-4	STANDARD DETAILS

ABBREVIATIONS LEGEND-

5 SH.-	FIVE SHELVES
6 SH.-	SIX SHELVES
A.F.F.-	ABOVE FINISHED FLOOR
B.C.-	BLIND CORNER (CABINET)
C.J.-	CEILING JOIST
C.M.U.-	CONCRETE MASONRY UNIT
C.O.-	CASED OPENING
CONC.-	CONCRETE
C.R.V.-	CONTINUOUS RIDGE VENT
DBL SH-RD-	DOUBLE SHELF AND ROD
DH-	DOUBLE HUNG
DR. or DRWR-	DRAWER
D.S.-	DRAWER SPACE
EXT.-	EXTERIOR
F.J.-	FLOOR JOIST
FS-	SUPPLY IN FLOOR (HVAC)
FTG.-	FOOTING
GYP. BD.-	GYPSUM BOARD
HB-	HOSE BIBB
HDG.-	HOT DIPPED GALVANIZED
HDWD-	HARDWOOD
HDR.-	HEADER
HT.-	HEIGHT
INT.-	INTERIOR
K.S.-	KNEE SPACE
KDAT-	KILN DRIED AFTER TREATMENT
L.B.W.-	LOAD BEARING WALL
L.S.-	LAUNDRY SINK or LAZY SUSAN
LVP-	LUXURY VINYL PLANK
LVT-	LUXURY VINYL TILE
O.C.-	ON CENTER
O.H.-	OVERHEAD
OPT.-	OPTIONAL
O.W.H.-	OVER THE WALL HEIGHT
P.T.-	PRESSURE TREATED
PANT.-	PANTRY
R/A-	RETURN AIR (HVAC)
REINF.-	REINFORCED
R.O.-	ROUGH OPENING
SC-	SUPPLY IN CEILING (HVAC)
SD-	SMOKE DETECTOR
SH-	SINGLE HUNG
SH-RD-	SHELF AND ROD
S.J.-	SINGLE JOIST
SM/CO-	SMOKE AND CARBON MONOXIDE DETECTOR
SPEC.-	SPECIFIED
SPF-	SPRUCE/PINE/FIR
S.R.O.-	SHEETROCK OPENING
SYP-	SOUTHERN YELLOW PINE
T & G-	TONGUE AND GROOVE
TEMP-	TEMPERED
T.O.P.-	TOP OF PLATE
TRAP.-	TRAPEZOID (WINDOW)
U.N.O.-	UNLESS NOTED OTHERWISE
UTIL-	UTILITY
VAN.-	VANITY
W/H-	WATER HEATER
W.H.H.-	WINDOW HEADER HEIGHT
W.I.C.-	WALK IN CLOSET



FRONT VIEW

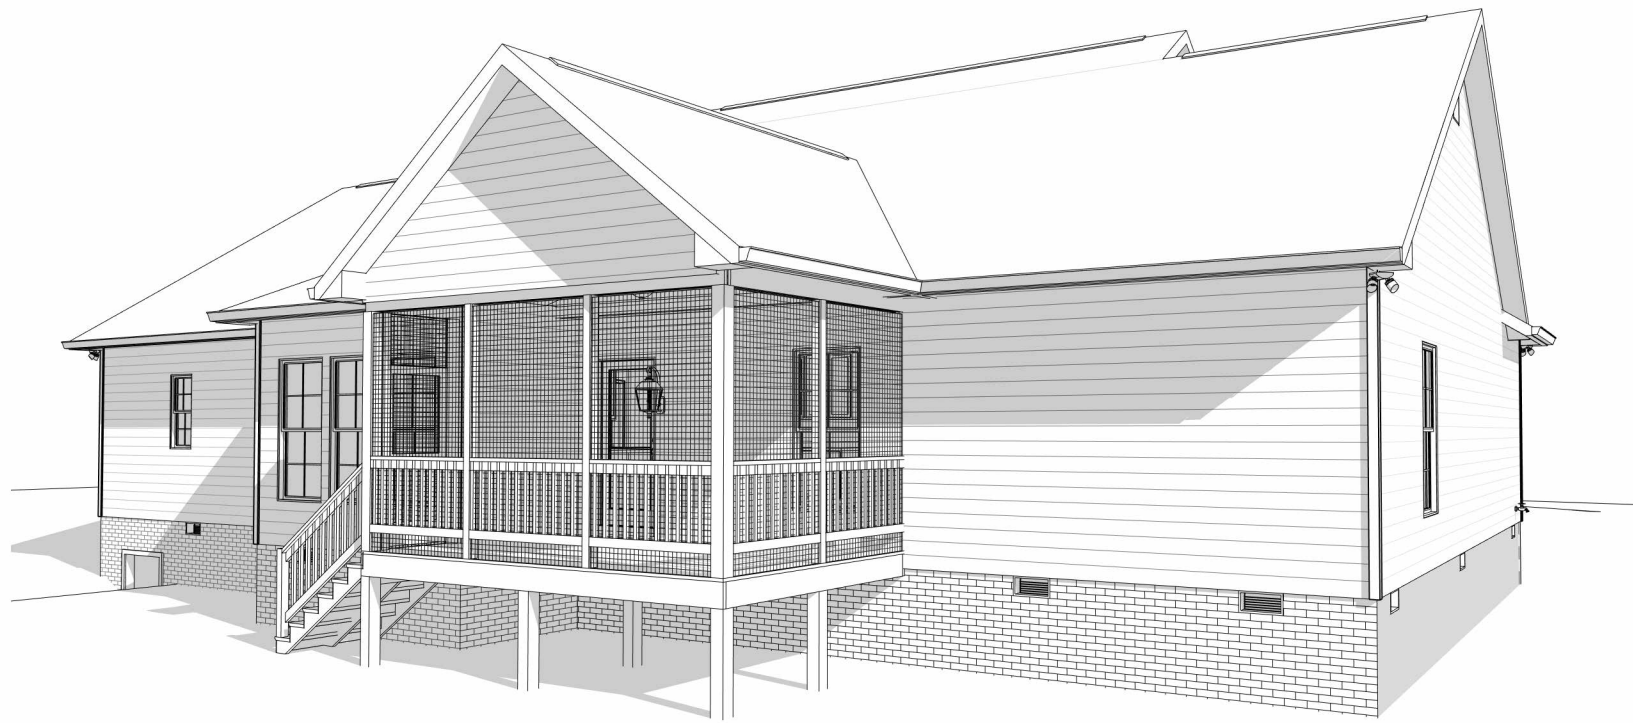

REAR VIEW




GENERAL NOTES

- MIN 9'-1 1/8" CEILING HEIGHT ON FIRST FLOOR
- MIN 8'-1 1/8" CEILING HEIGHT ON SECOND FLOOR
- ALL LOAD BEARING WALLS & EXT. OPENINGS TO HAVE (2) 2X10 HEADERS UNLESS NOTED OTHERWISE
- HEADERS FOR WINDOWS ABOVE KITCHEN COUNTERTOPS TO BE FRAMED DOWN 1'-5" FROM T.O.P.
- STANDARD FIRST FLOOR WINDOW HEADERS TO BE FRAMED DOWN 2'-2" FROM T.O.P. UNLESS NOTED OTHERWISE
- STANDARD SECOND FLOOR WINDOW HEADERS TO BE FRAMED DOWN 1'-2" FROM T.O.P. UNLESS NOTED OTHERWISE
- 7/16" O.S.B. AND HOUSEWRAP REQUIRED
- DIMENSIONS ARE TO SHEATHING EXTERIOR; SUBTRACT 1/2" FROM DIMENSIONS FOR EXTERIOR WINDOW AND DOOR FRAMING LOCATION IF OPENINGS ARE FRAMED BEFORE SHEATHING INSTALLATION
- ALL INTERIOR DOORS ARE EITHER CENTERED ON WALLS OR R.O. STARTED MIN OF 4" FROM ADJOINING WALL UNLESS OTHERWISE DIMENSIONED
- NUMBER OF EXTERIOR OR GARAGE STAIR TREADS & RISERS MAY VARY AS A RESULT OF LOCAL BUILDING CODES, STANDARDS AND FINAL GRADE
- CLOSET SHELF HEIGHT OFF FLOOR:
SINGLE - 68"
DOUBLE - 42" & 84"
- ALL PLUMBING FIXTURES SHOWN ARE A REPRESENTATION OF SIZE AND LOCATION ONLY. ACTUAL STYLE AND BRAND OF FIXTURES MAY VARY PER OFFICE LOCATION
- ALL TUBS/SHOWERS ARE TO HAVE NAILERS AT FLANGE
- INSTALL A 24" WIDE WALKWAY FROM ATTIC ACCESS TO FURNACE PLATFORM
- RAILINGS ARE A FORCED OPTION WHEN PORCH IS OVER 30" ABOVE FINISHED GRADE
- UTILITY STUB-OUT LOCATIONS TO BE VERIFIED ON SITE

SHEET #	PROPERTY OF:	DRAWN BY:	JOB #	THE:	REVISION SCHEDULE	
					REV #	DATE
E-0	AMERICA'S HOME PLACE	ANDREA S.	141-23-014	OXFORD MODERN FARMHOUSE-REVISED	2,113 SF	
					2,113 SF	
COVER SHEET	AMERICA'S HOME PLACE	US	2x4 EXTERIOR WALLS	SMITH, NATHAN	609 SF	
					197 SF	
COVER SHEET	AMERICA'S HOME PLACE	PRINTED: 3/11/2024 3:25:43 PM	FOUNDATION TYPE: CRAWL SPACE	5947 NC-27 W. LILLINGTON NC 27546	165 SF	
					160 SF	
COVER SHEET	AMERICA'S HOME PLACE	© COPYRIGHT - 2023	OFFICE: FAYETTEVILLE-141	SOLD BY: A.V.	1,131 SF	
					3,244 SF	

OPT. PAPER SIZE: for 1/4" = 1'-0" on 24" x 36" PAPER SIZE ENLARGE PRINTS TO 200%

FINAL CONSTRUCTION PLANS

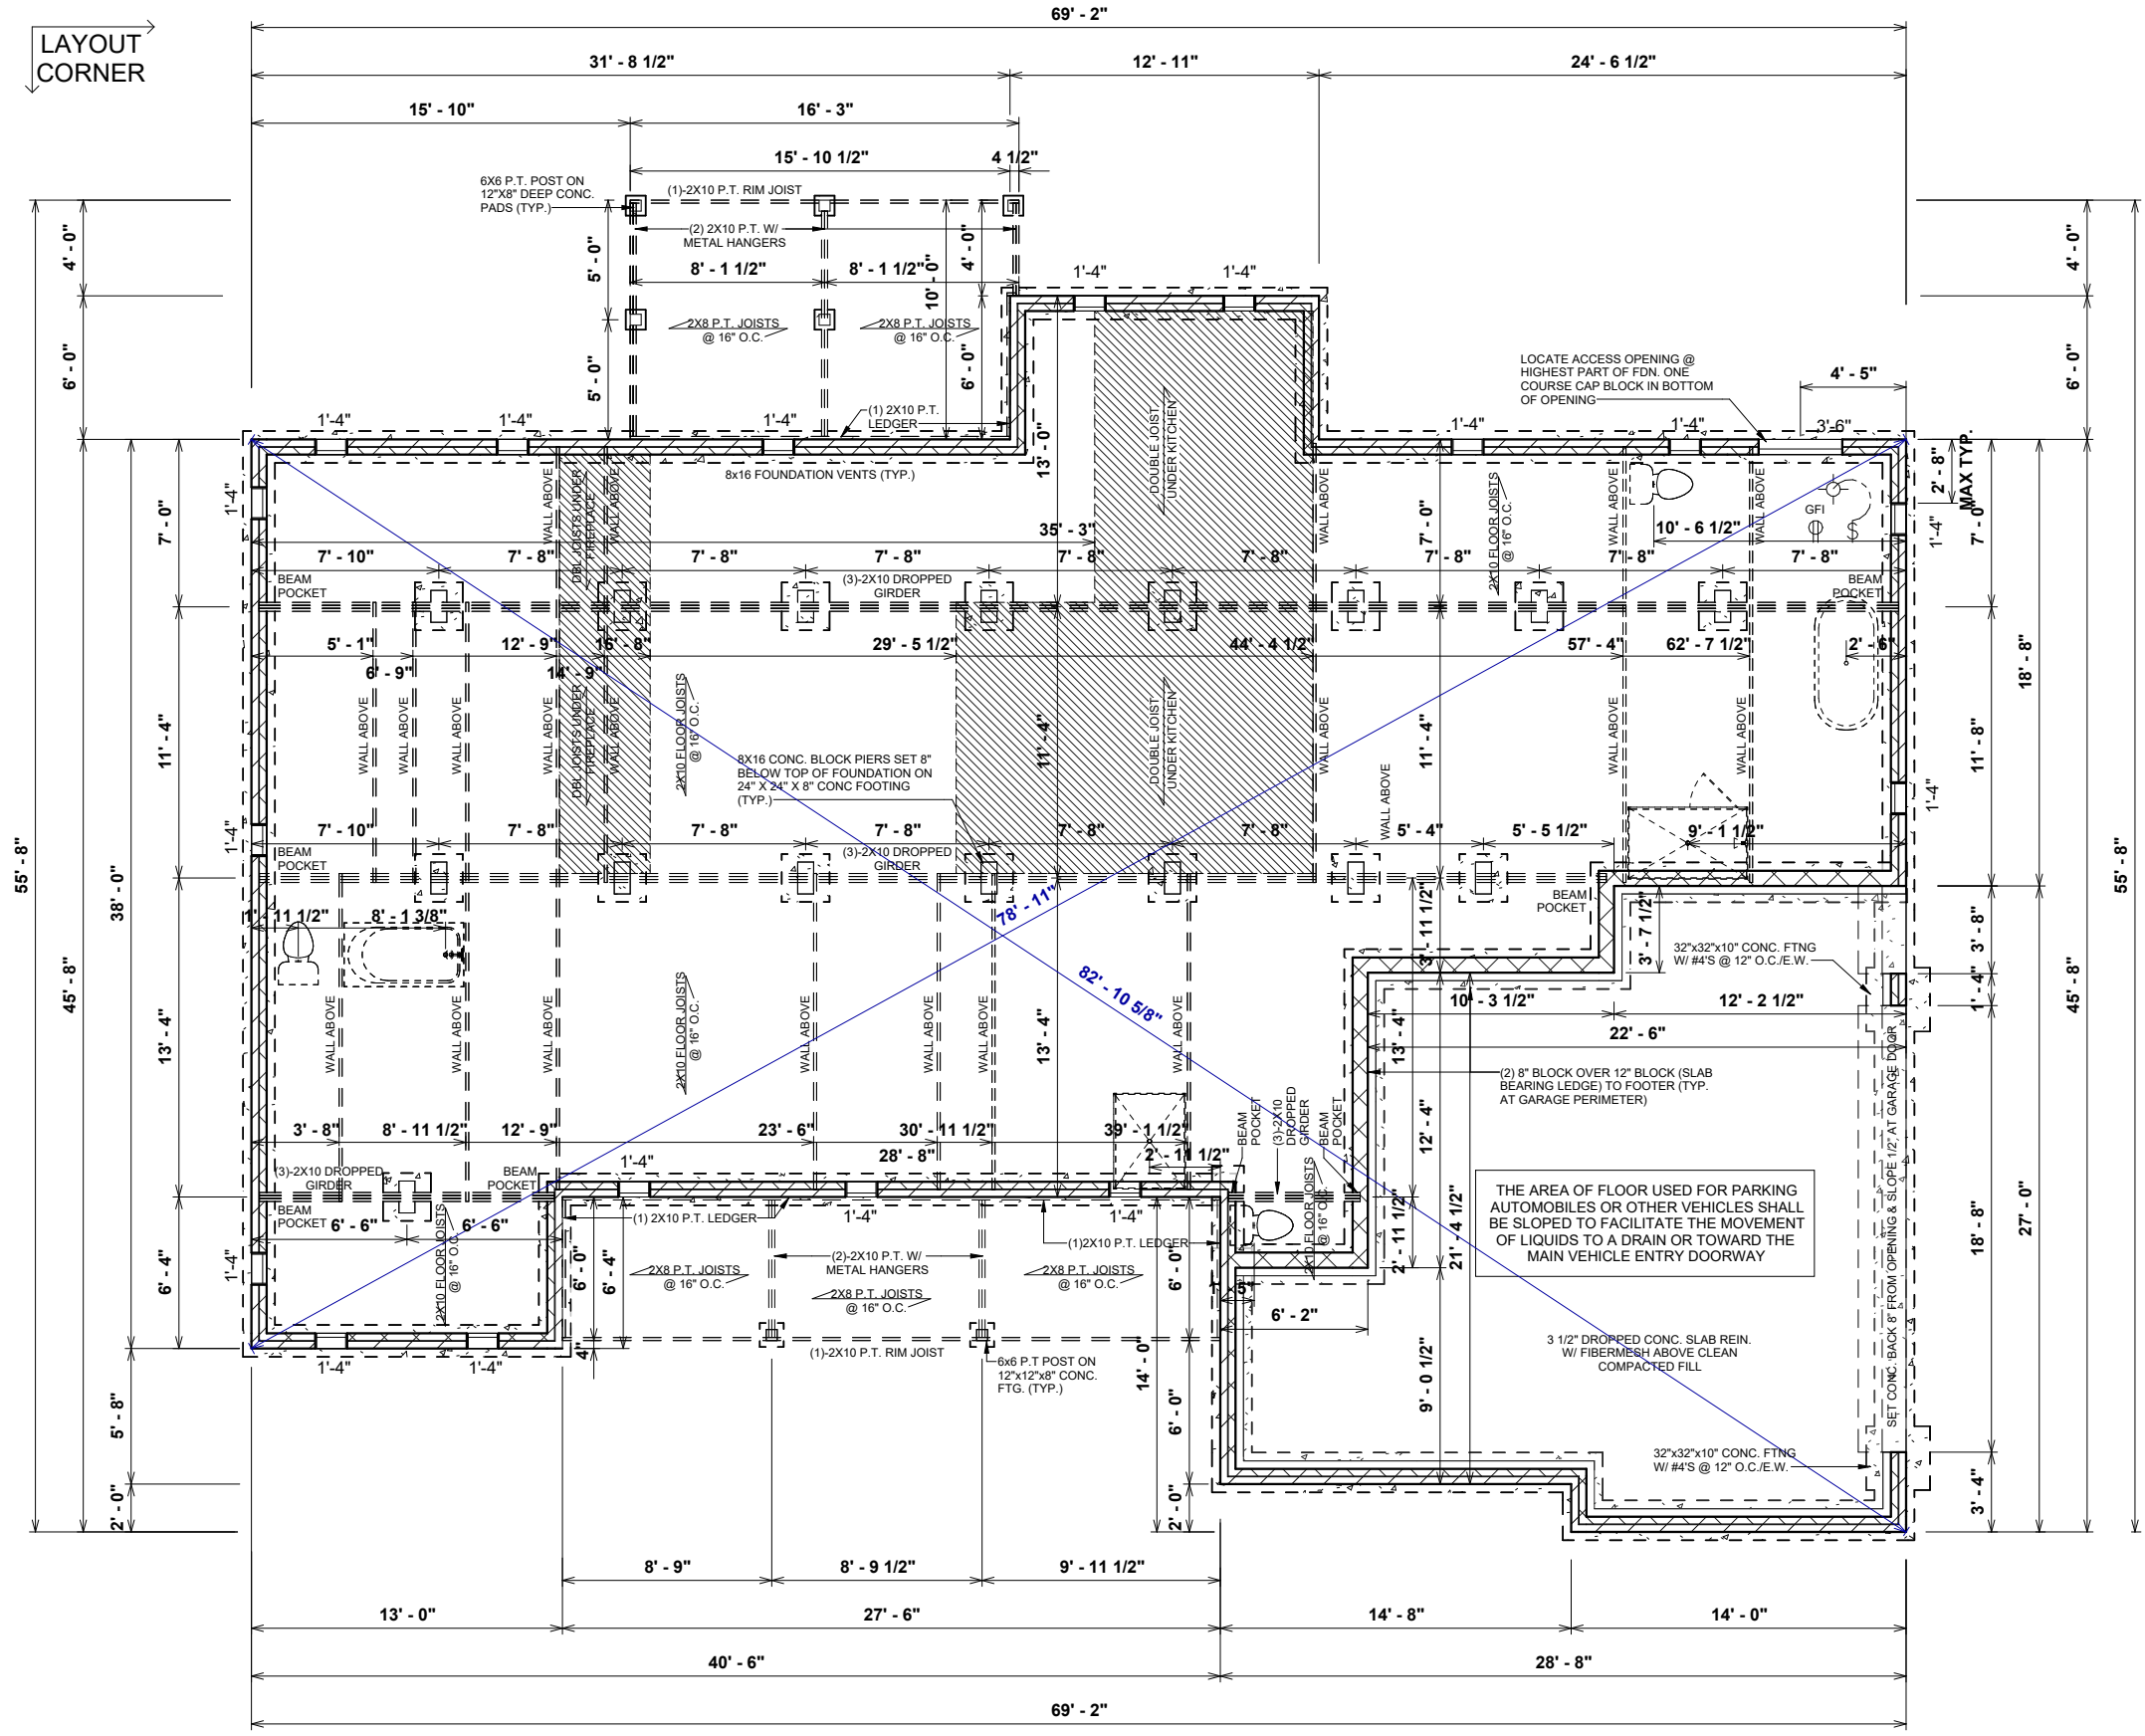

FOUNDATION NOTES




- TYPICAL FOUNDATION WALL: (2'-8") 4" BRICK W/ 4" BLOCK ON (2) 8" BASE BLOCK - ON TOP OF 16" x 8" d POURED CONCRETE FOOTING
- CRAWL SPACE ACCESS TO BE 42" WIDE
- ADD LIGHT AND SWITCH UNDER FLOOR NEAR ACCESS
- CRAWL SPACE VENT & ACCESS DIMENSIONS ARE APPROXIMATE, VENTS & ACCESSES SHOULD BE LOCATED WITHIN CONCRETE BLOCKS, DO NOT LOCATE UNDER BEAMS OR ANY OTHER STRUCTURAL LOCATIONS
- VENTS SHOULD BE INSTALLED PER LOCAL CODE
- ALL GIRDER BREAKS MUST BE ON PIERS OR POSTS
- NOTCH SILL PLATE AROUND DROPPED BEAM
- FILL ALL CELLS SOLID UNDER BEAM POCKET BEARING POINT
- POLY REQ'D IN CRAWL
- GRAVEL REQ'D UNDER GARAGE SLAB
- POLY REQ'D UNDER GARAGE SLAB

1 FOUNDATION PLAN
1/8" = 1'-0"


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FINAL CONSTRUCTION PLANS


SHEET #	PROPERTY OF:	DRAWN BY:	JOB #	THE:	REVISION SCHEDULE	
					REV #	DESCRIPTION
F-1	 © COPYRIGHT - 2023 FOUNDATION PLAN	ANDREA S.	141-23-014	OXFORD MODERN FARMHOUSE-REVISED	2,113 SF	DATE
		JS	2x4 EXTERIOR WALLS	FOR: SMITH, NATHAN	609 SF	
		PRINTED: 3/11/2024 3:25:50 PM	FOUNDATION TYPE: CRAWL SPACE	5947 NC-27 W. LILLINGTON NC 27546	197 SF	
				OFFICE: FAYETTEVILLE-141	165 SF	
				SOLD BY: A.V.	160 SF	
			TOTAL UNDER ROOF	3,244 SF		

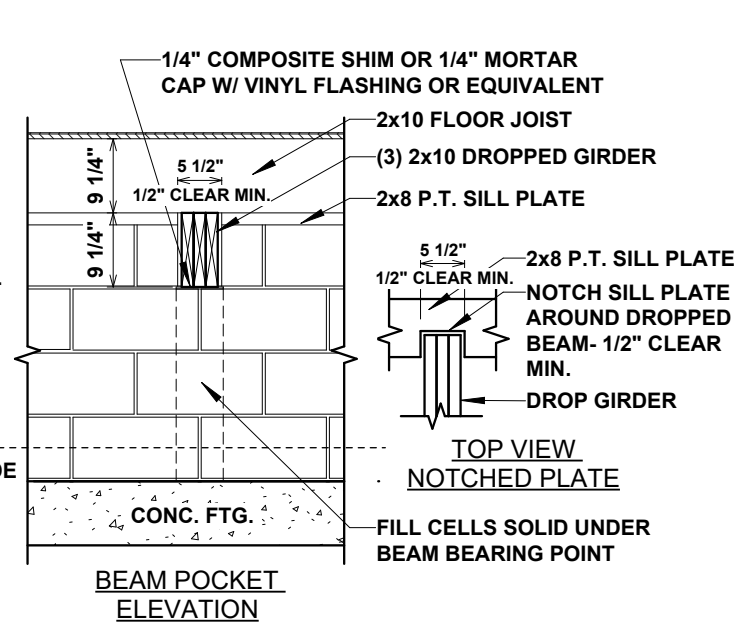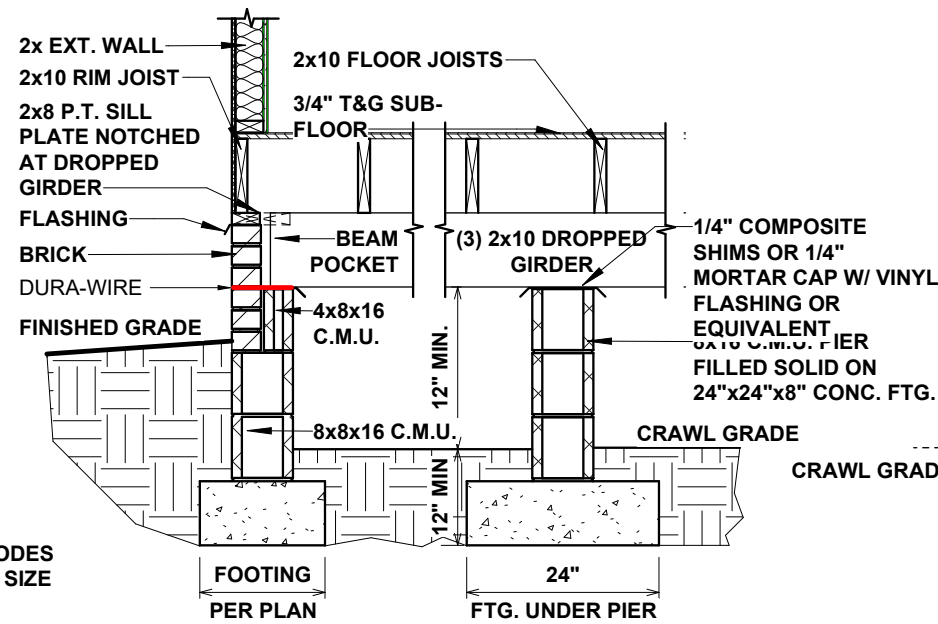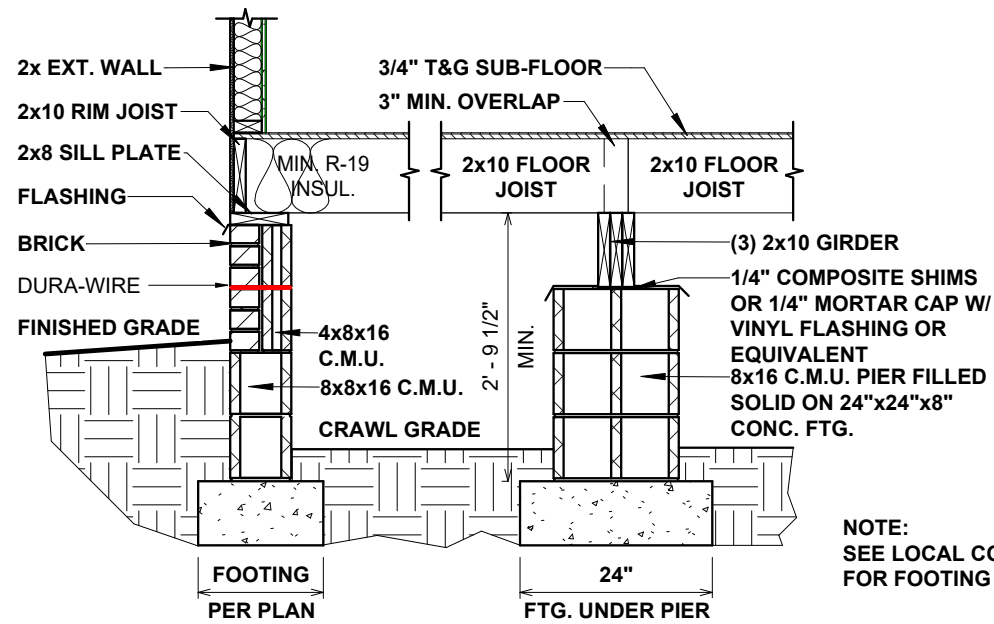

1 141-600.41 CRAWL FOUNDATION W/BRICK DETAIL
1/2" = 1'-0"

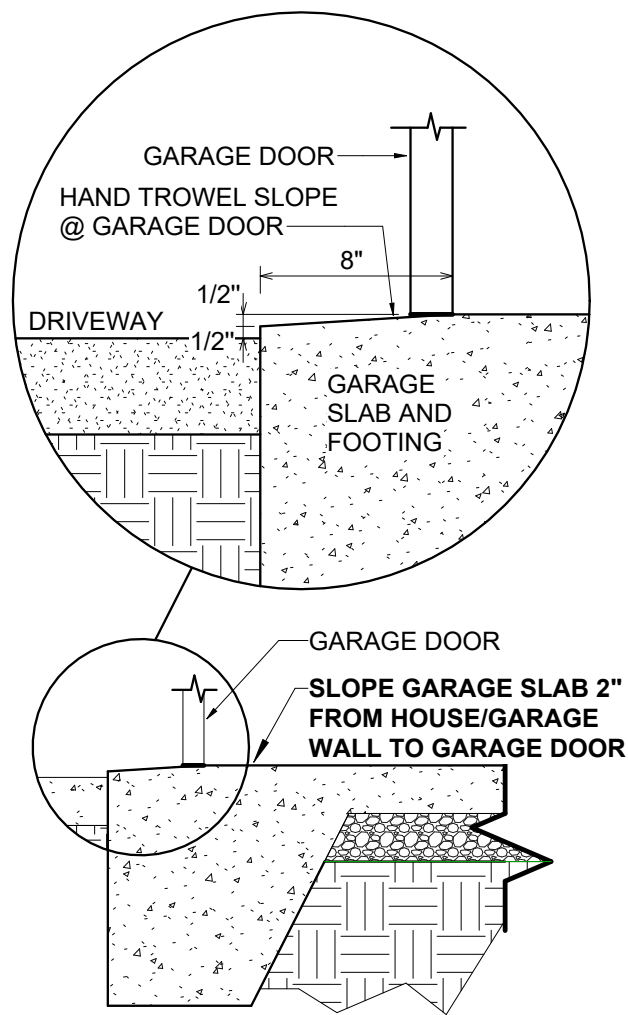

4 141-GARAGE DOOR SLOPE DETAIL
3/4" = 1'-0"

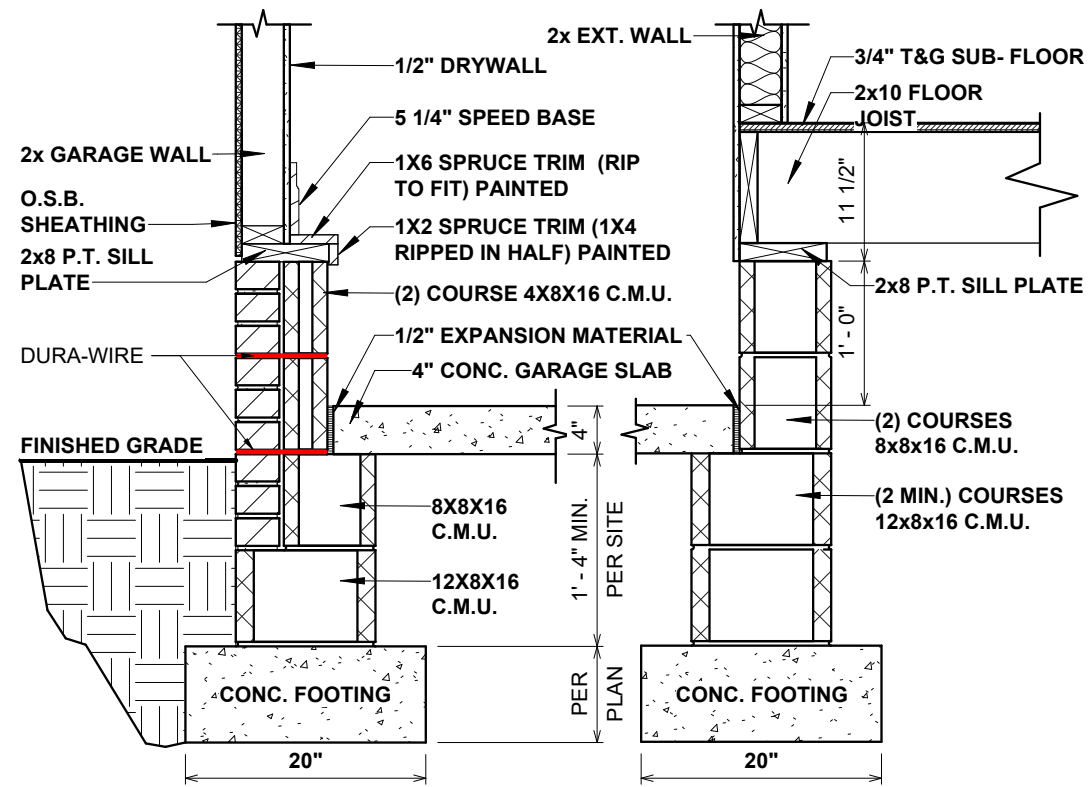

2 141-530.41 GARAGE CRAWL FOUNDATION W/BRICK
DETAIL
3/4" = 1'-0"


REVISION SCHEDULE	REV #	DESCRIPTION	DATE
AREAS:	2,113 SF	FIRST FLOOR HEATED	
	2,113 SF	GARAGE	
	609 SF	FINISHED BONUS ROOM	
	197 SF	FRONT PORCH	
	165 SF	SCREEN PORCH	
	160 SF	TOTAL UNDER ROOF	
	1,131 SF		
	3,244 SF		

THE:	OXFORD MODERN FARMHOUSE-REVISED
FOR:	SMITH, NATHAN
JOB #	141-23-014
FOUNDATION TYPE:	CRAWL SPACE
2x4 EXTERIOR WALLS	
ADDRESS:	5947 NC-27 W. LILLINGTON NC 27546
OFFICE:	FAYETTEVILLE-141
SOLD BY:	AV.
DRAWN BY:	ANDREA S.
CHECKED BY:	JS
PRINTED:	3/11/2024 3:25:51 PM
PROPERTY OF:	AMERICA'S HOME PLACE
© COPYRIGHT - 2023	
SHEET #	F-1.1
SCALE:	As indicated

OPT. PAPER SIZE: for 1/4" = 1'-0" on 24" x 36" PAPER SIZE ENLARGE PRINTS TO 200%

FINAL CONSTRUCTION PLANS

LAYOUT CORNER

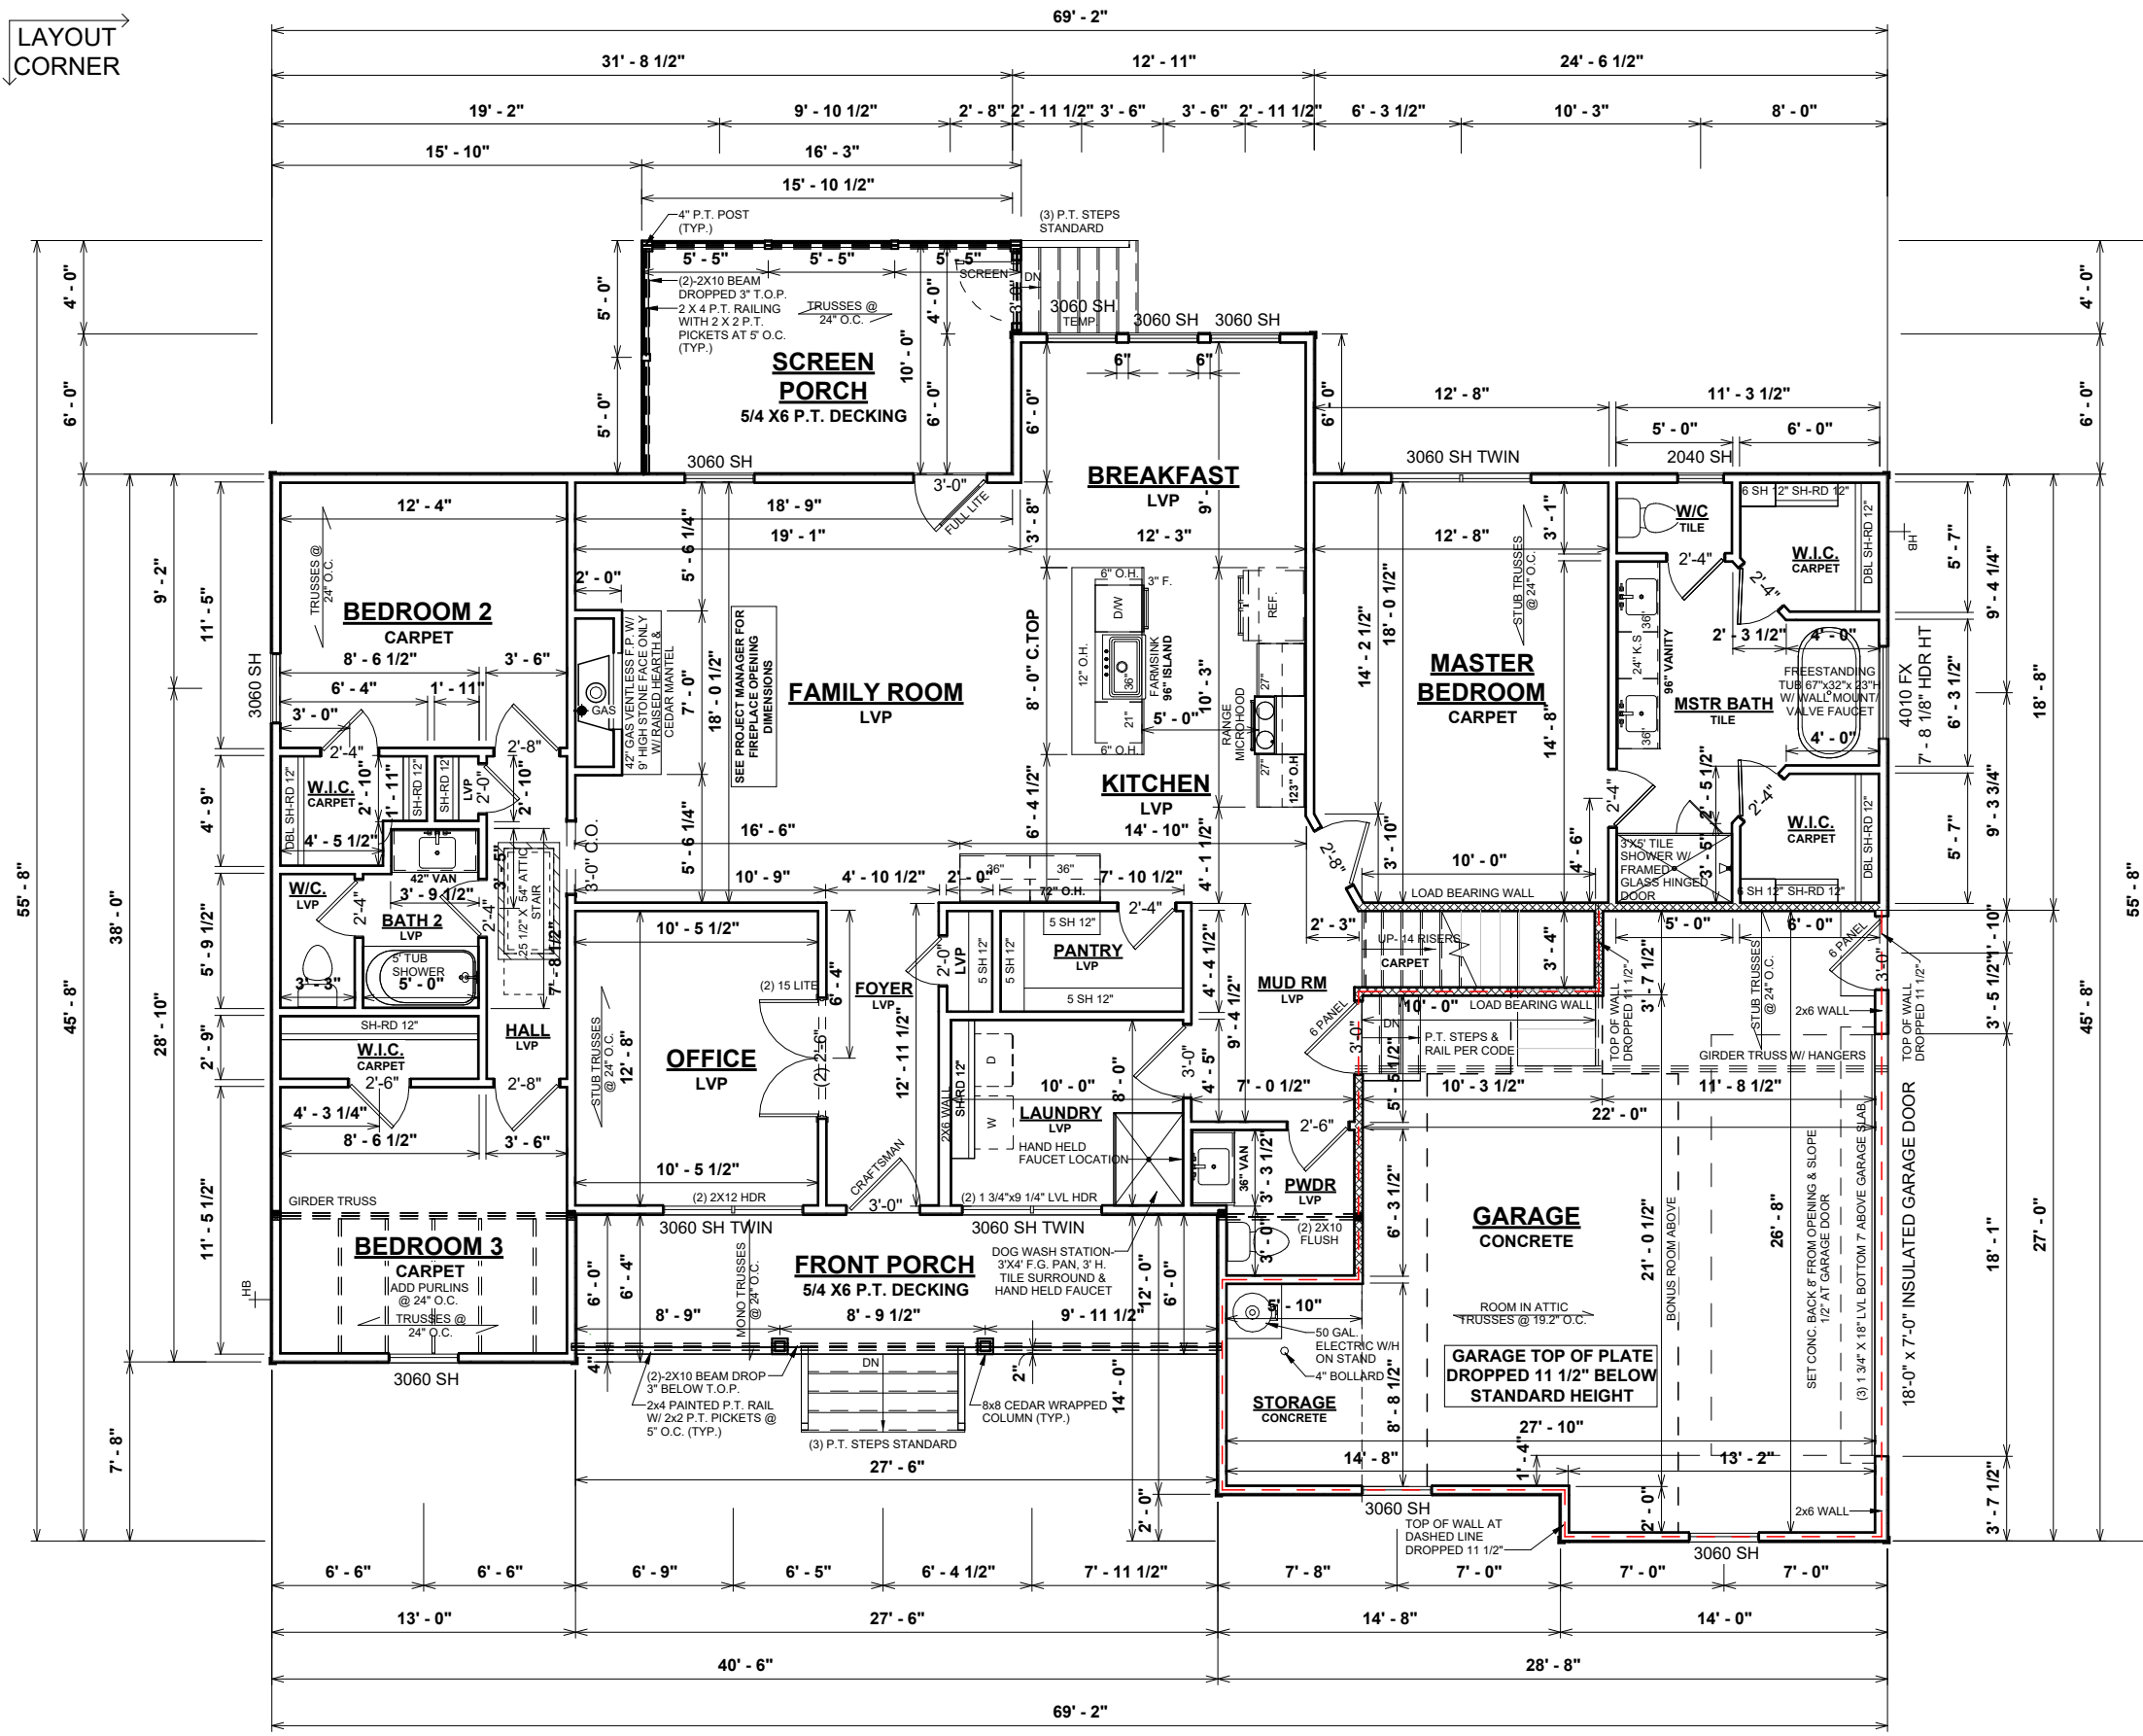


1 FIRST FLOOR PLAN
1/8" = 1'-0"

GENERAL NOTES

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SPECIAL NOTES

- UPGRADE CARPET PAD
- TILE BACKSPLASH IN KITCHEN

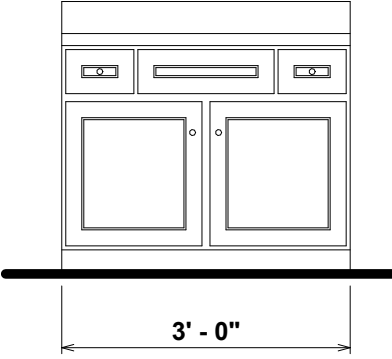

2 891.1 36" VANITY ELEVATION
1/2" = 1'-0"


OPT. PAPER SIZE: for 1/4" = 1'-0" on 24" x 36" PAPER SIZE ENLARGE PRINTS TO 200%

FINAL CONSTRUCTION PLANS


SHEET #	PROPERTY OF:	DRAWN BY:	JOB #	THE:	REVISION SCHEDULE		
					REV #	DATE	
F-2	 © COPYRIGHT - 2023 AMERICA'S HOME PLACE	ANDREA S.	141-23-014	OXFORD MODERN FARMHOUSE-REVISED	2,113 SF		
		JS	2X4 EXTERIOR WALLS	FARMHOUSE-REVISED	2,113 SF		
			FOUNDATION TYPE: CRAWL SPACE	SMITH, NATHAN	GARAGE	609 SF	
				5947 NC-27 W.	FINISHED BONUS ROOM	197 SF	
				LILLINGTON NC 27546	FRONT PORCH	165 SF	
				SCREEN PORCH	160 SF		
				TOTAL UNDER ROOF	3,244 SF		

SCALE: As indicated

FIRST FLOOR PLAN

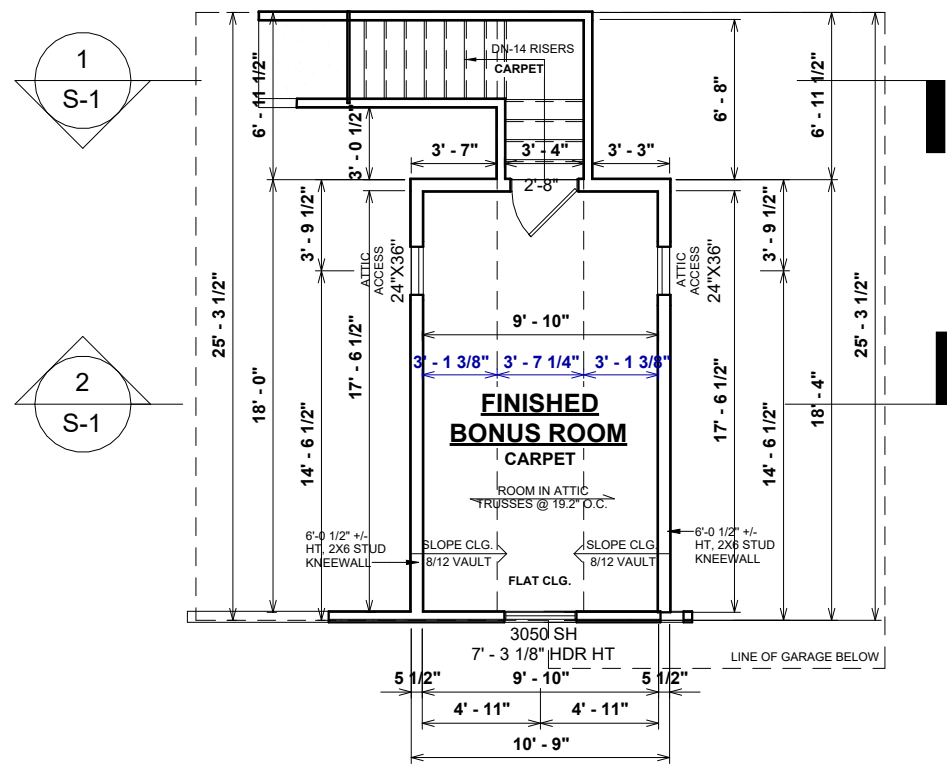

1 FINISHED BONUS ROOM PLAN
1/8" = 1'-0"

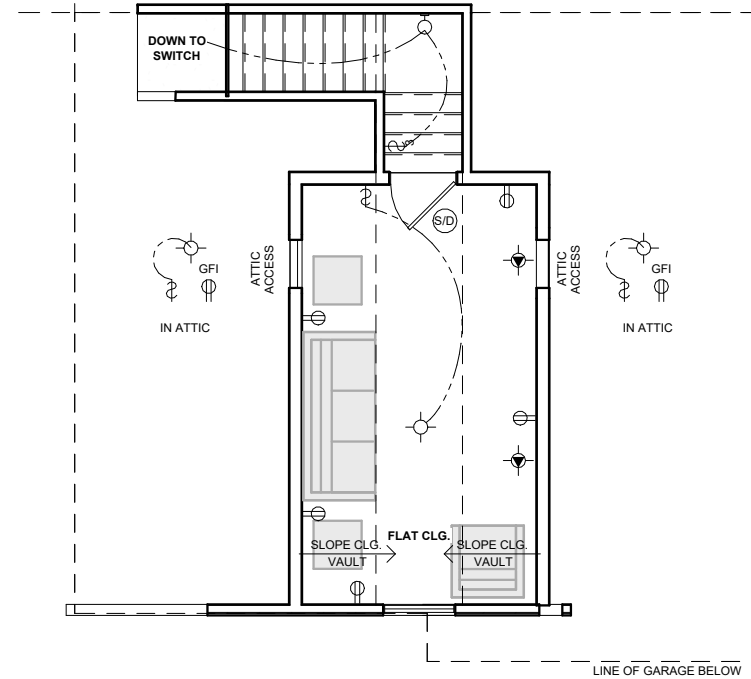


2 FINISHED BONUS ROOM ELEC. PLAN
1/8" = 1'-0"

ELECTRICAL LEGEND	
LIGHT FIXTURES	
CEILING FAN	
CEILING MOUNT	
COACH / SCONCE	
EXHAUST FAN	
EXHAUST FAN W/ LIGHT	
EXTERIOR FLOOD	
FLUORESCENT - CEILING	
FLUORESCENT - WALL	
LED DISC	
PENDANT	
RECESSED CAN	
RECESSED EYEBALL CAN	
UNDER / OVER CABINET LIGHT	
VANITY	
ELECTRICAL FIXTURES	
DOOR BELL BUTTON	
DOOR BELL CHIME	
GARAGE DOOR OPENER	
MEDIA	
OUTLET	
OUTLET - CEILING	
OUTLET - FLOOR	
OUTLET - GFI	
OUTLET - 220v	
SWITCH	
SWITCH - DIMMER	
SMOKE & CARBON DETECTOR	
SMOKE DETECTOR	
THERMOSTAT	

SHEET #	PROPERTY OF:	DRAWN BY:	JOB #	THE:	REVISION SCHEDULE	
					REV #	DATE
F-3	 © COPYRIGHT - 2023	ANDREA S.	141-23-014	OXFORD MODERN	2,113 SF	2,113 SF
		JS	2x4 EXTERIOR WALLS	FARMHOUSE-REVISED	609 SF	609 SF
				FOR:	FINISHED BONUS ROOM	197 SF
					FRONT PORCH	165 SF
					SCREEN PORCH	160 SF
					TOTAL UNDER ROOF	3,244 SF

OPT. PAPER SIZE: for 1/4" = 1'-0" on 24" x 36" PAPER SIZE ENLARGE PRINTS TO 200%

FINAL CONSTRUCTION PLANS

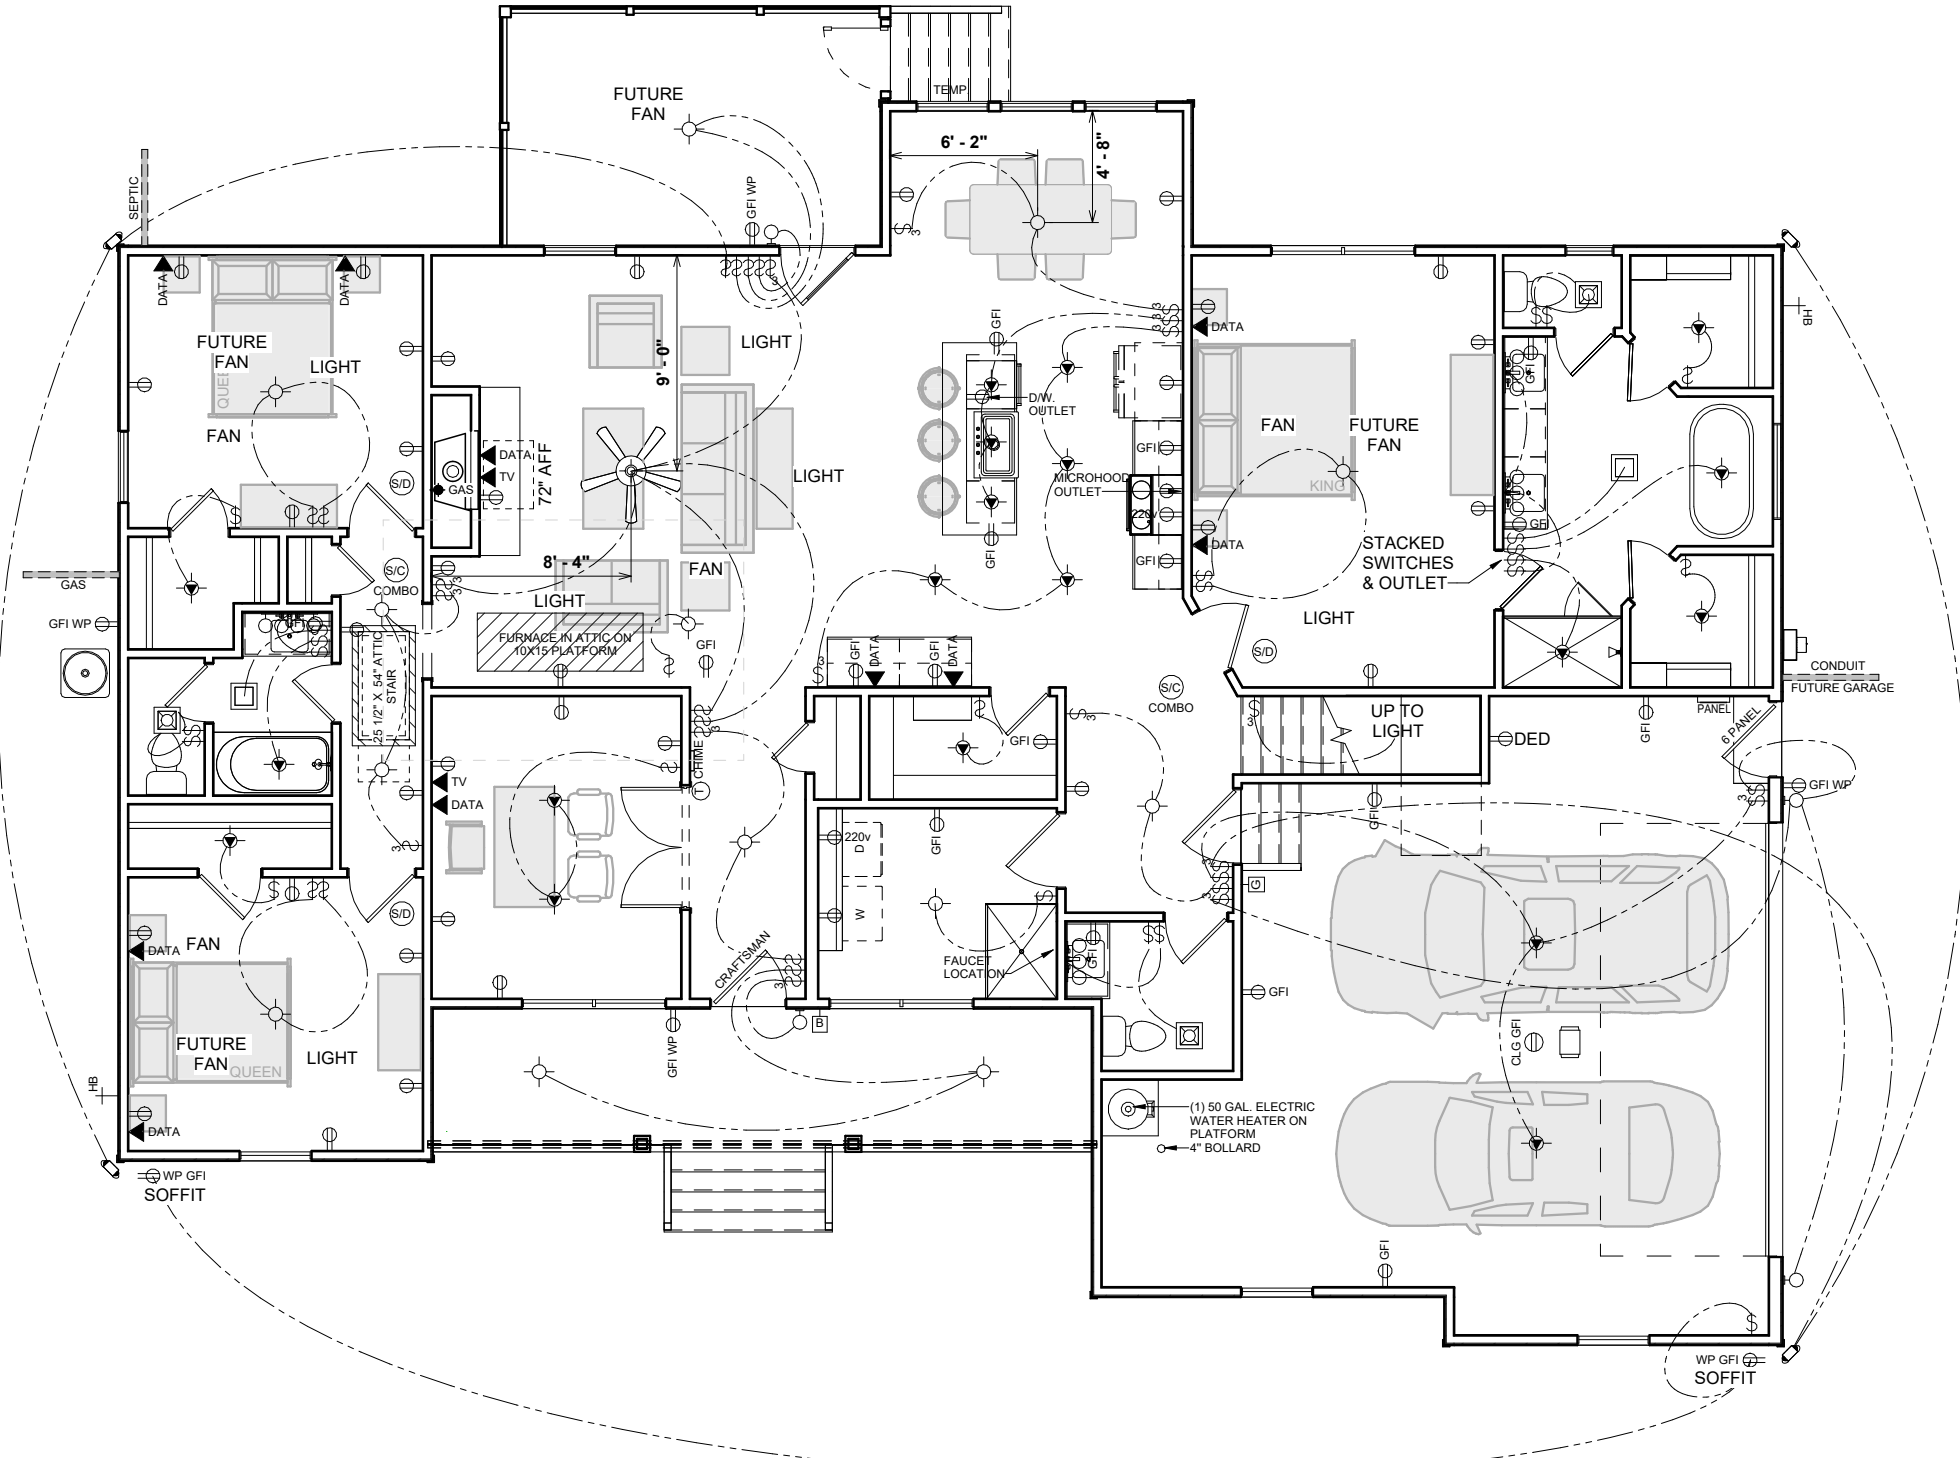

HVAC NOTES:

- FURNACE NOT LOCATED ON HEATED AREA IS TO BE AS CENTRALLY LOCATED AS POSSIBLE IN ACCORDANCE WITH ALL APPLICABLE CODES
- RETURN AIR REGISTERS TO BE AS CLOSE TO FURNACE UNIT & CENTRALLY LOCATED AS POSSIBLE
- OUTSIDE COMPRESSOR UNIT TO BE LOCATED AS CLOSE TO INTERIOR AIR HANDLER AS POSSIBLE
- OUTSIDE COMPRESSOR UNIT TO BE LOCATED 10'-0" AWAY MIN. FROM DRYER VENT
- HVAC, THERMOSTAT, RETURN AIR, AND SUPPLIES TO BE DESIGNED & LOCATED BY MECHANICAL CONTRACTOR
- BUILDER AND HVAC CONTRACTOR RESERVE THE RIGHT TO LOCATE SUPPLY VENTS AND/OR LINES TO ACCOMMODATE OPTIMUM USAGE AND RESTRICTIONS DUE TO CODE & DESIGN REQUIREMENTS

ELECTRICAL NOTES:

- BRANCH CIRCUITS THAT SUPPLY 125V, SINGLE PHASE, 15 & 20 AMP RECEPTACLE OUTLETS IN ALL ROOMS AS REQUIRED BY CODE, SHALL BE PROTECTED BY ARC-FAULT CIRCUIT INTERRUPTER, COMBINATION TYPE, INSTALLED TO PROVIDE PROTECTION OF THE BRANCH CIRCUIT N.C. ELECT.CODE SECT.210.12(b)
- CONFORM ELECT. WIRING & COMPONENTS TO CURRENT NEC PROVISIONS FOR 1 & 2 FAMILY DWELLINGS AS REQUIRED BY CODE
- OUTLET, FIXTURE, & COMPONENT LOCATIONS ARE APPROXIMATE AND WILL VARY DUE TO DESIGN AND CODE RESTRICTIONS & REQUIREMENTS
- SERVICE DISCONNECT REQUIRED
- CONDENSATE PUMP REQUIRED
- UTILITY STUB-OUT LOCATIONS TO BE VERIFIED ON SITE

SPECIAL NOTES

- AHP TO INSTALL OWNER SUPPLIED FANS IN MASTER BEDROOM, BEDROOM 2, BEDROOM 3 AND COVERED PORCH

ELECTRICAL LEGEND

LIGHT FIXTURES	
CEILING FAN	
CEILING MOUNT	
COACH / SCONCE	
EXHAUST FAN	
EXHAUST FAN W/ LIGHT	
EXTERIOR FLOOD	
FLUORESCENT - CEILING	
FLUORESCENT - WALL	
LED DISC	
PENDANT	
RECESSED CAN	
RECESSED EYEBALL CAN	
UNDER / OVER CABINET LIGHT	
VANITY	

ELECTRICAL FIXTURES	
DOOR BELL BUTTON	
DOOR BELL CHIME	
GARAGE DOOR OPENER	
MEDIA	
OUTLET	
OUTLET - CEILING	
OUTLET - FLOOR	
OUTLET - GFI	
OUTLET - 220v	
SWITCH	
SWITCH - DIMMER	
SMOKE & CARBON DETECTOR	
SMOKE DETECTOR	
THERMOSTAT	

REVISION SCHEDULE	REV #	DESCRIPTION	DATE

AREAS:	FIRST FLOOR HEATED	TOTAL UNDER ROOF
FIRST FLOOR HEATED	2,113 SF	2,113 SF
GARAGE	609 SF	609 SF
FINISHED BONUS ROOM	197 SF	197 SF
FRONT PORCH	165 SF	165 SF
SCREEN PORCH	160 SF	160 SF
TOTAL UNDER ROOF	1,131 SF	3,244 SF

THE:	FOR:	FOUNDATION TYPE:
OXFORD MODERN FARMHOUSE-REVISED	SMITH, NATHAN	CRAWL SPACE

JOB #	FOUNDATION TYPE:
141-23-014	CRAWL SPACE

PROPERTY OF:	DRAWN BY:	CHECKED BY:	PRINTED:
	ANDREA S.	JS	3/11/2024 3:25:56 PM


SHEET #	SCALE:
H-1	1/8" = 1'-0"

1 FIRST FLOOR ELEC & HVAC PLAN
1/8" = 1'-0"


OPT. PAPER SIZE: for 1/4" = 1'-0" on 24" x 36" PAPER SIZE ENLARGE PRINTS TO 200%

FINAL CONSTRUCTION PLANS

PAPER SIZE: 11" x 17"

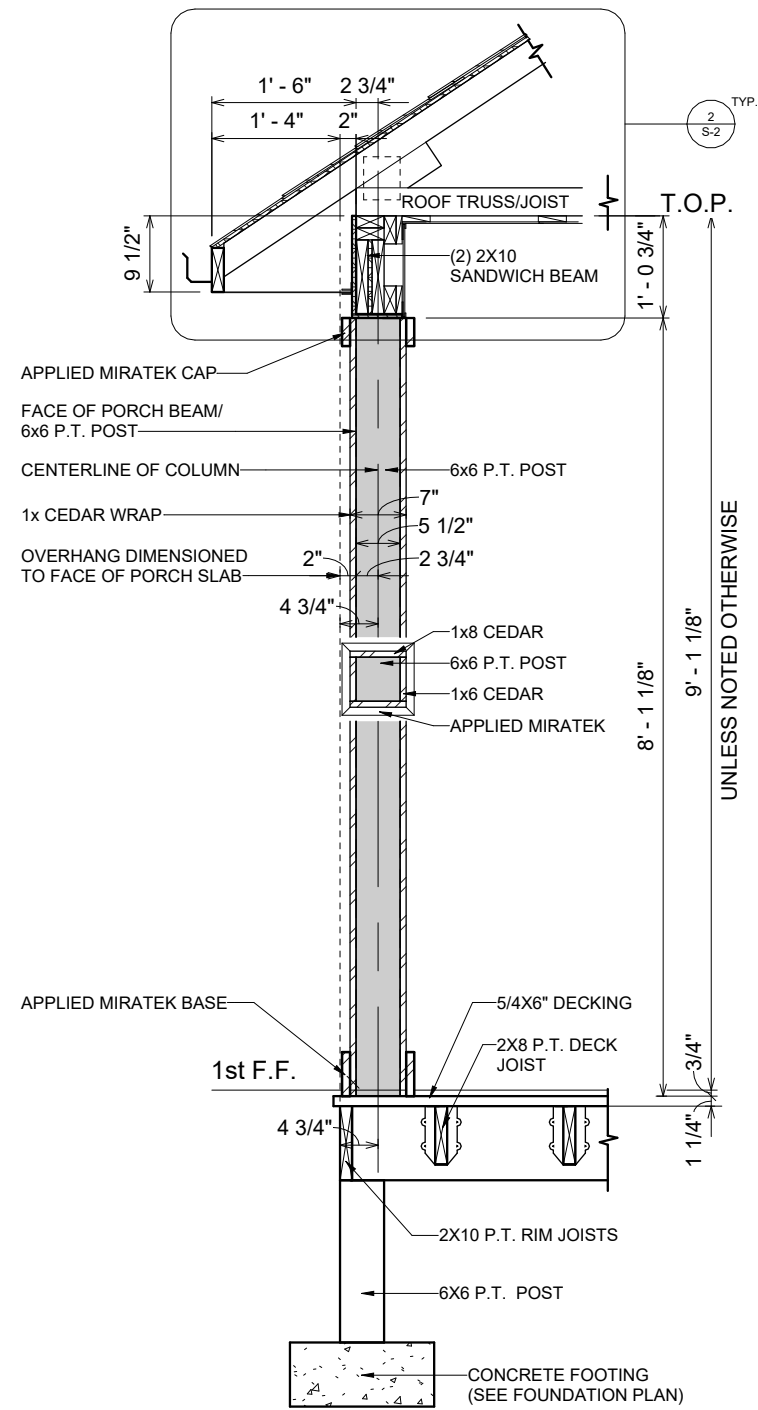

① 8" SITE BUILT COLUMN
1/2" = 1'-0"

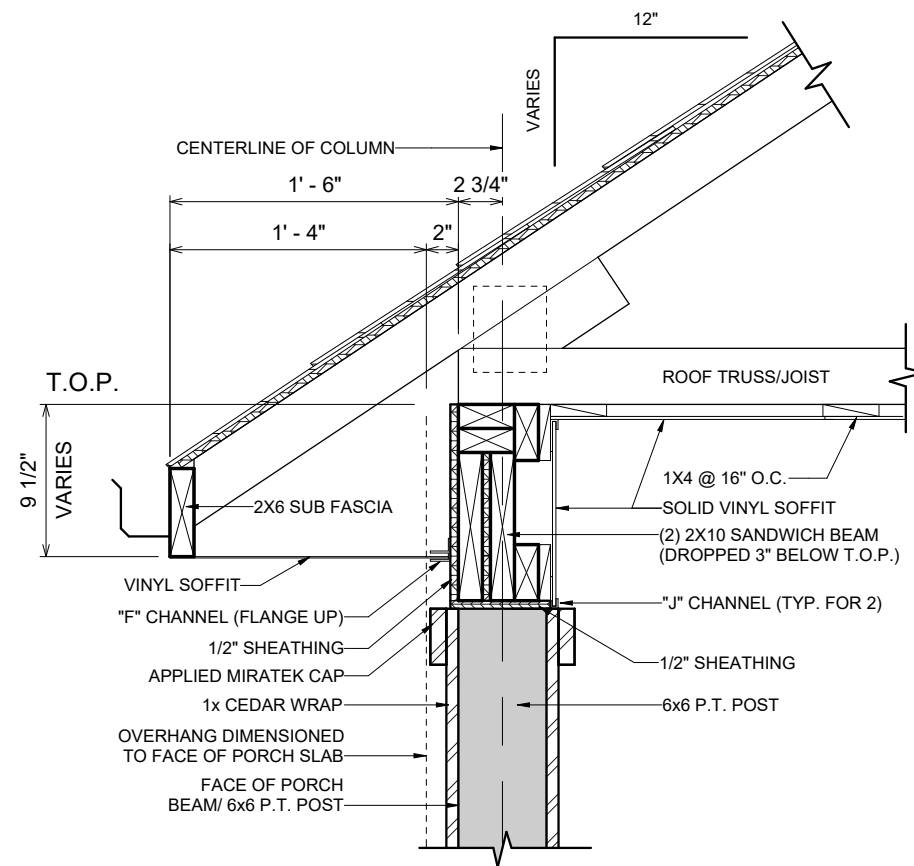


② 8" SITE BUILT COLUMN/EVE DETAIL
1" = 1'-0"

REVISION SCHEDULE		REV #	DESCRIPTION	DATE
AREAS:		2,113 SF	FIRST FLOOR HEATED	
		2,113 SF	GARAGE	
		609 SF	FINISHED BONUS ROOM	
		197 SF	FRONT PORCH	
		165 SF	SCREEN PORCH	
		1,131 SF	TOTAL UNDER ROOF	
		3,244 SF		
THE:	OXFORD MODERN FARMHOUSE-REVISED			
FOR:	SMITH, NATHAN			
JOB #	141-23-014	2x4 EXTERIOR WALLS		
FOUNDATION TYPE:	CRAWL SPACE			
DRAWN BY:	ANDREA S.	CHECKED BY:	JS	
PRINTED:	3/11/2024	3:25:57 PM		
PROPERTY OF:				
SHEET #	S-2			
SCALE:	As indicated			
PAPER SIZE: 11" x 17"		SCALE: As indicated		


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FINAL CONSTRUCTION PLANS


8" SITE BUILT COLUMN

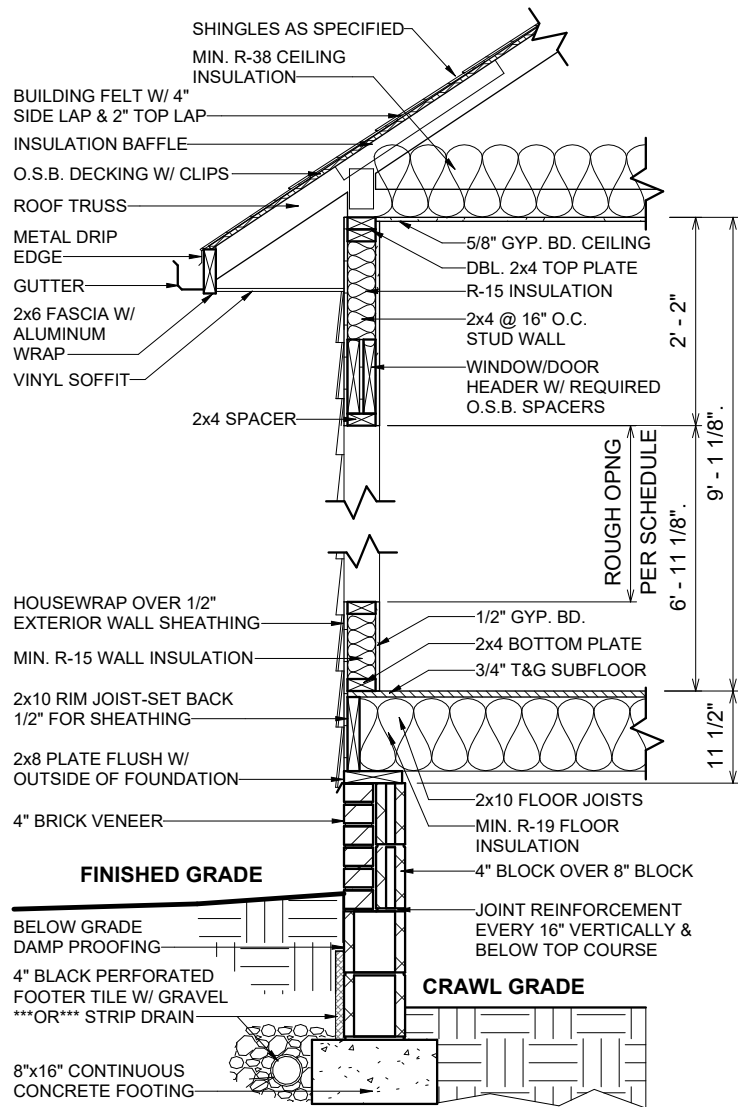


3 1 STORY-BRICK CRAWL W/2X4-SIDING-SECTION
1/2" = 1'-0"

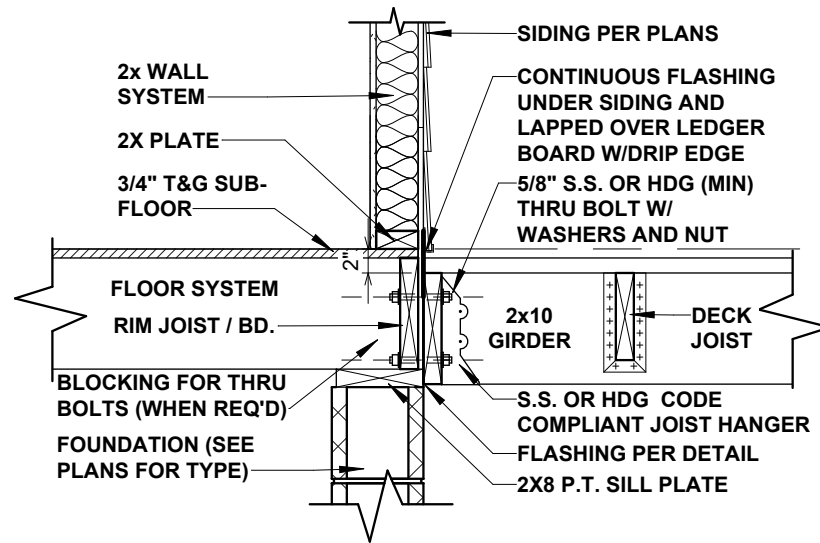

1 87-0.6-DECK LEDGER CONNECTION1
3/4" = 1'-0"

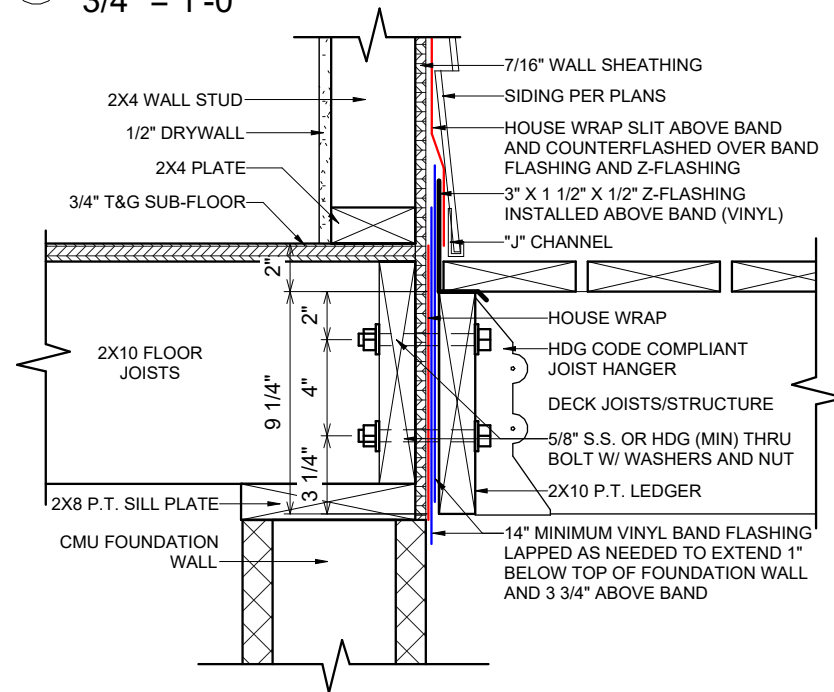


2 87-480.2 PORCH LEDGER FLASHING1
1 1/2" = 1'-0"

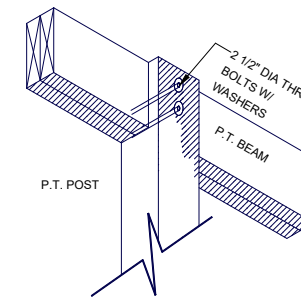

POST TO BEAM CONNECTION1

FASTNERS	8' MAX. JOIST SPAN	16' MAX. JOIST SPAN
5/8" HOT DIPPED GALV. BOLTS WITH NUT AND WASHER	1 @ 3'-6" O.C.	1 @ 1'-8" O.C.
AND	AND	AND
12 D COMMON HOT DIPPED GALV. NAILS	2 @ 8" O.C.	3 @ 6" O.C.

AM104.1.1 ALL STRUCTURES EXCEPT BRICK VENEER STRUCTURES

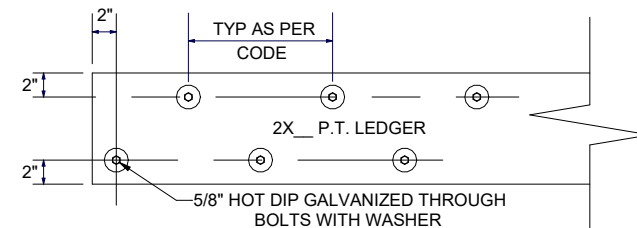

LEDGER BOARD AND FASTENER DETAIL1

REVISION SCHEDULE	REV #	DESCRIPTION	DATE

AREAS:	FIRST FLOOR HEATED	2,113 SF
	GARAGE	2,113 SF
	FINISHED BONUS ROOM	609 SF
	FRONT PORCH	197 SF
	SCREEN PORCH	165 SF
	TOTAL UNDER ROOF	160 SF
		1,131 SF
		3,244 SF


THE: OXFORD MODERN	FOR: SMITH, NATHAN	5947 NC-27 W.	LILLINGTON NC 27546
141-23-014	2x4 EXTERIOR WALLS	FOUNDATION TYPE: CRAWL SPACE	
DRAWN BY: ANDREA S.	CHECKED BY: JS	PRINTED: 3/11/2024 3:26:00 PM	OFFICE: FAYETTEVILLE-141
PROPERTY OF: AMERICA'S HOME PLACE	© COPYRIGHT - 2023		
S-4	STANDARD DETAILS		

OPT. PAPER SIZE: for 1/4" = 1'-0" on 24" x 36" PAPER SIZE ENLARGE PRINTS TO 200%

FINAL CONSTRUCTION PLANS

THIS IS A TRUSS PLACEMENT DIAGRAM (TPD) ONLY; NOT AN ENGINEERED DOCUMENT. Trusses are designed as individual building components to be incorporated into the building design at the specification of the building designer. See individual truss design drawings (TDD's) for each truss design identified on the TPD. The Contractor is responsible for the temporary bracing of the roof and floor system, and requirements for the permanent restraint/bracing of truss systems may be met by following the methods outlined in ANSI-TPI 1-2014 - 2.3.3. The design of the support structure including but not limited to headers, beams, walls, and columns is also the responsibility of the building designer. For general guidance regarding installation and bracing, consult "Building Component Safety Information" (BCSI) available from the SBC Association (www.sbcassociation.com). It is the responsibility of the General Contractor to verify that the provided component layout matches the final intended construction plans, loading conditions, and use. If they do not, it is the responsibility of the General Contractor to notify UFP and provide plans containing the latest specifications and designs. UFP will not be responsible for plan changes by others after final approval of shop drawings, or for errors or modifications made on-site during construction. DO NOT CUT, NOTCH, DRILL, OR OTHERWISE "REPAIR" MANUFACTURED TRUSSES IN ANY WAY WITHOUT PRIOR WRITTEN AUTHORIZATION BY A LICENSED PROFESSIONAL DESIGNATED BY UFP. The Framing is responsible to verify all dimensions, including adjusting member spacing within tolerances to allow for the drop and rise of plumbing/HVAC, unless noted otherwise. Truss-to-wall connections, if shown, are for uplift only and do not consider lateral loads. All connectors on this project are to be installed per the connector manufacturer's specifications. All connectors shown that are not truss-to-truss are suggestions only and are to be verified by the Building Designer or Engineer of Record for suitability to this particular project. UFP accepts no responsibility for the specific application or suitability of any connector that is not truss-to-truss as they apply to this specific structure.

ROOF PLACEMENT PLAN

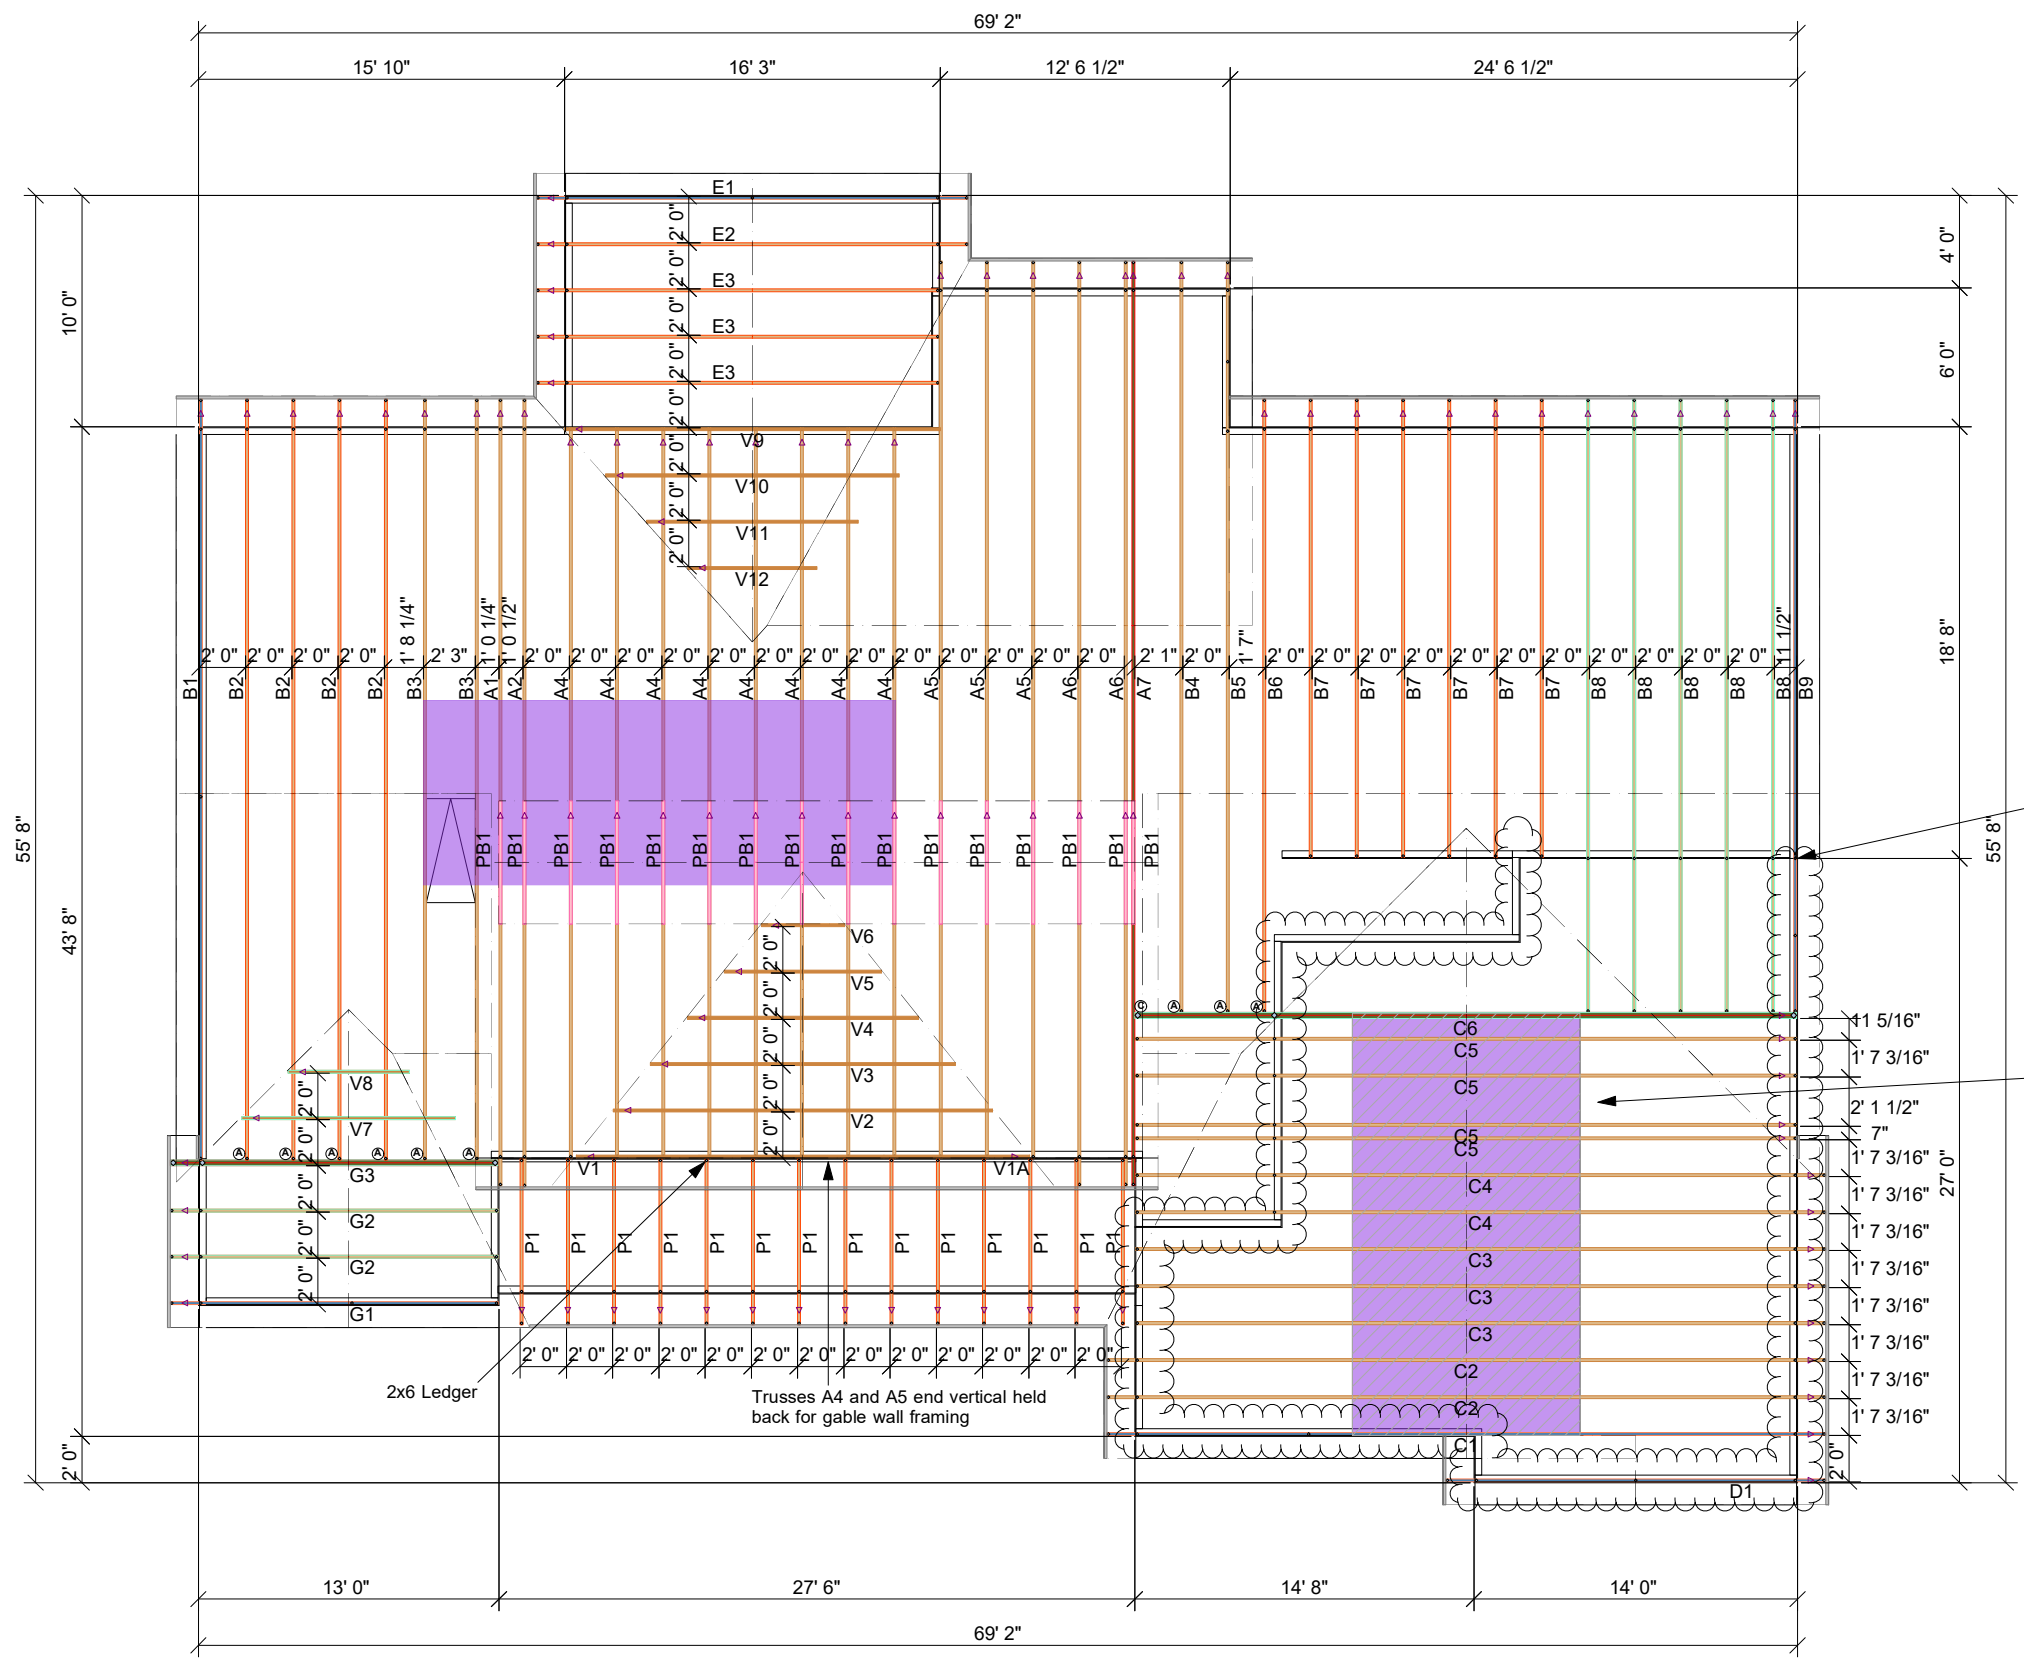

Roof Hanger List			
MARK	TYPE	DESCRIPTION	QTY
(A)	HUS26	FACE MOUNT HANGER	9
(B)	JUS26	FACE MOUNT HANGER	0
(C)	THD26-2	FACE MOUNT HANGER	1

Clouded walls in garage to be framed down 11 1/2" from main plate

Spaced for door access

△ INDICATES LEFT END OF TRUSS SCALE: N.T.S.

THESE VALUES ARE APPROXIMATE ONLY

ROOF AREA: 4251.49 ft² sqft **RIDGE LINE:** 150.44 ft **VALLEY LINES:** 157.43 ft **HIP LINES:** 0 ft

SMITH RES

REVISIONS	DATE	DESCRIPTION	DSN

DESIGNER BSC
LAYOUT DATE 01-25-24
ARCH DATE 01-12-24
STRUC DATE N/A
JOB #: 24011230

TRUSS TRAX
UFP CONSTRUCTION

TrussTrax.ufp.com

UFP SITE BUILT
A UFP INDUSTRIES COMPANY

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Chesapeake, VA Liberty, NC
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