

Architecture Plan Review: ■ No Comments ☐ See Comments Items drawn on any drawings and not written in the contract selctions WILL NOT be included in the site specific drawings. Customer Request: Design Solution: Reason For Modification: . XXX . XXX . XXX . XXX 2. XXX 2. XXX 2. XXX 2. XXX 3. XXX 3. XXX 3. XXX 3. XXX Customer: _ 4. XXX 4. XXX 4. XXX 4. XXX

may occur since every home that is built has it's own set of unique construction problems that must be dealt with as the home is being built.

HOMES_{SM} 7701 Six Forks Road, Suite 132, Raleigh, NC 27615 Phone: [919] 844-9288

GENERAL NOTES - RALEIGH

FOUNDATION NOTES

CRAWL SPACES:

- SLOPE CONCRETE SLAB 4" MINIMUM TOWARDS GARAGE DOOR

- EXTERIOR FLATWORK/GARAGES SHALL HAVE A MINIMUM CONCRETE SRENGTH OF 4.500 PSI

FOOTINGS TO A MINIMUM CONCRETE STRENGTH OF 2500 PSI, UNLESS OTHERWISE NOTED

ASSUMED ALLOWABLE SOIL BEARING PRESSURE: 2,000 p.s.f.

WATERPROOF FOUNDATION WITH BITUMINOUS SPRAY.

WALL TIES EMBEDDED IN THE HORIZONTAL MORTAR JOINT SHALL BE 16" ON CENTER, TIES IN ALTERNATE COURSES SHALL

BE STAGGERED, THE MAXIMUM VERTICAL DISTANCE BETWEEN TIES SHALL NOT EXCEED 16" AND THE MAXIMUM HORIZONTAL DISTANCE SHALL NOT EXCEED 16" ADDITIONAL TIES SHALL BE PROVIDED AT ALL OPENINGS, AND WITHIN 12"

CORE FILL ENTIRE BLOCK WALL WHEN THE WALL IS 4'-0" TALL OR HIGHER. INSTALL #4 REBAR IN EACH HOLLOW AREA OF

EACH BLOCK FROM FOOTING TO TOP OF WALL, ON THE ENTIRE WALL PRIOR TO CORE FILLING IT. TOP COURSE OF BLOCK ON ALL WALLS WILL BE FILLED SOLID WITH MORTAR PLACING THE FOUNDATION STRAPS OR

BOLTS IN THE MORTAR 6'-0" ON CENTER, AND 12" FROM EACH CORNER.

- 12"x16" PIERS: HOLLOW MASONRY UP TO 48" HIGH, SOLID MASONRY UP TO 9"0" HIGH

16"x16" PIERS: HOLLOW MASONRY UP TO 64" HIGH, SOLID MASONRY UP TO 12'0" HIGH

BLOCK PIERS SHOULD BE PLACED DIRECTLY ON CONCRETE FOOTINGS PER PLAN. THEY SHOULD BE PLUMBED AND SQUARE WITHIN 1/4"

- SILL PLATES TO BE A MINIMUM OF 2x4 NOMINAL LUMBER.

FRAMING NOTES

DESIGN LOADS:

FLOORS: 40 psf LIVE LOAD + 10 psf DEAD LOAD = 50 psf ROOF: 18 psf LIVE LOAD + 17psf DEAD LOAD = 35 psf

DESIGN DEFLECTION LIMITS (BASED ON LIVE LOAD, EXCEPT MASONRY):

RAFTERS GREATER THAN 3:12 L/180 MASONRY VENEER L/600

NOMINAL LUMBER FLOORS: L/360

MANUFACTURED WOOD FLOORS: DESIGNED TO MINIMUM PRO RATING OF 35 (OR EQUIVALENT). NO MORE THAN 8 POINT DIFFERENCE BETWEEN ADJACENT SPANS.

L/480 FOR SPANS UP TO 16'-0" AND NO GREATER THAN 1/2" DEFLECTION

L/240

GARAGE FLOOR: 50 psf LIVE LOAD

WIND SPEED: 120 MPH

CEILINGS

L/600 FOR SPANS OVER 16'-0" IF SIMPLE SPAN AND NO GREATER THAN 1/2" DEFLECTION L/840 FOR SPANS OVER 16'-0" IF CONTINUOUS SPAN. AND NO GREATER THAN 1/2" DEFLECTION

19.2" o.c. MAXIMUM SPACING JOIST SPACING:

DOUBLE EVERY OTHER FLOOR JOIST UNDER KITCHEN ISLANDS

INSTALL UNCOUPLING MEMBRANE IN TILE FLOOR AREAS IF 19.2" O.C. FLOOR JOIST SPACING

GLUE AND MECHANICALLY FASTEN [SCREWS] WOOD FLOOR IF 19.2" o.c. FLOOR JOIST SPACING

MANUFACTURED WOOD PRODUCTS (INCLUDING, BUT NOT LIMITED TO, STRUCTURAL WOOD BEAMS AND I-JOISTS) SHALL BE FABRICATED. HANDLED, AND INSTALLED IN ACCORDANCE WITH THE MANUFACTURER'S INSTRUCTIONS.

-JOISTS ARE NOT TO BE PLACED DIRECTLY OVER INTERIOR PARALLEL WALLS. (TO PREVENT UNEVEN FLOOR DEFLECTION FROM OCCURRING)

ALL WOOD BEAMS/HEADERS: 2x6's TO BE SPF STUD GRADE OR BETTER/ 2x8 OR LARGER TO BE SYP #2 [PER NDS 2012] OR BETTER, U.O.N.

ALL HEADERS SHALL BE SUPPORTED BY (1) 2x JACK STUD AND (1) 2x KING STUD MINIMUM. THE NUMBER OF STUDS SPECIFIED AT A SUPPORT INDICATES THE

NUMBER OF JACKS REQUIRED, U.N.O. AT FLUSH OR DROPPED BEAMS, THE NUMBER OF STUDS SPECIFIED INDICATES THE TOTAL NUMBER OF STUDS REQUIRED TO SUPPORT THE BEAM

EXTERIOR WALLS TO BE 2x4 SPF STUD GRADE AT 16" O.C. UNLESS OTHERWISE NOTED (10'4-1/2" MAXIMUM WALL HEIGHT)

ALL INTERIOR BEARING WALLS AND WALLS AT BASEMENT & FIRST FLOOR STAIRWELLS, KITCHEN, BATH, & GARAGE TO BE 2x4 SPF STUD GRADE @ 16" o.c.; ALL OTHER NON-BEARING INTERIOR WALLS TO BE 2x4 SPF STUD GRADE @ 24" o.c. U.O.N.

ALL WALLS TO BE 3 1/2" UNLESS OTHERWISE NOTED.

PROVIDE SOLID BEARING TO FOUNDATION OR BEAM BELOW FOR ALL BEAMS, HEADERS & GIRDER TRUSSES. PROVIDE BLOCKING BETWEEN JOISTS AS REQUIRED.

SEE SELECTION SHEET FOR SIZE AND STYLE OF FIREPLACE. SEE FIREPLACE ELEVATION DETAIL FOR ADDITIONAL FRAMING REQUIREMENTS, IF ANY. CHECK SELECTION SHEETS FOR FLOOR COVERING AT TOP AND BOTTOM OF STAIR RISERS AND ADJUST RISERS AS REQ'D.

PROVIDE BLOCKING AT ALL HANDRAIL TERMINATION AND BRACKET LOCATIONS.

20-MINUTE FIRE RATED DOOR BETWEEN GARAGE AND LIVING AREA.

EXTERIOR WALL TO BE 2x4 SPF STUD G AT 16" o.c., UNLESS OTHERWISE NOTED (10'-0" MAXIMUM UNBRACED WALL HEIGHT).

ALL EXTERIOR WALLS AND INTERIOR BEARING WALLS, FRAMED HIGHER THAN THE STANDARD PLATE HEIGHT, SHALL BE FRAMED WITH CONTINUOUS FULL HEIGHT STUDS TO THE HIGHEST CEILING (I.E. NO INTERMEDIATE BREAKS) TO PREVENT LATERAL HINGE CONDITIONS.

IN THE GARAGE, PROVIDE 1/2" GYP. BOARD AT ALL WALLS COMMON TO LIVING SPACE AND ALL STRUCTURAL MEMBERS SUPPORTING

FLOOR/CEILING ASSEMBLY. GARAGE CEILING TO BE 1/2" SAG RESISTANT GYP. BOARD WHEN THERE ARE NO HABITABLE SPACES ABOVE, OR 5/8" TYPE X GYP. BOARD WHEN HABITABLE SPACES ARE ABOVE.

ALL EMERGENCY ESCAPE & RESCUE OPENINGS TO BE A MAXIMUM OF 44" OFF OF FINISHED FLOOR AND HAVE MINIMUM OPENING DIMENSIONS OF 24" IN HEIGHT, 20" IN WIDTH, & HAVE A MINIMUM OPENING AREA OF 5.7 S.F.

ALL DOORS TO BE 6'-8" TALL LINLESS OTHERWISE NOTED

ALL GLASS IN INTERIOR AND EXTERIOR DOORS TO BE TEMPERED (INCLUDING SIDELITES AND TRANSOMS)

ALL LUMBER CONTACTING CONCRETE TO BE PRESSURE TREATED.

ALL FASTENERS, HANGERS, AND OTHER CONNECTORS TO BE USED WITH PRESSURE TREATED WOOD ARE TO HAVE ZMAX COATING (OR EQUIVALENT) HOT-DIPPED GALVANIZED OR STAINLESS STEEL.

AT STAIR HANDRAIL, ON ONE SIDE ONLY, SHALL BE CONTINUOUS FOR THE ENTIRE LENGTH OF THE STAIRWAY, AND ENDS SHALL BE RETURNED TO A WALL OR POST. THE HANDRAIL MAY BE INTERRUPTED AT A NEWEL POST AT A TURN.

ALL HANDRAIL GRIP PORTIONS SHALL NOT EXCEED 2-1/4" IN CROSS SECTIONAL DIMENSION.

HANDRAILS SHALL BE INSTALLED ON ALL STAIRS WITH 2 OR MORE RISERS, HANDRAIL HEIGHTS SHALL BE A MINIMUM OF 34" AND A MAXIMUM OF 38".

ALL STAIRS TO BE CONSTRUCTED SO AS NOT TO ALLOW A 4" SPHERE TO PASS THROUGH THE RISER.

GUARDRAILS MUST BE A MINIMUM OF 36" HIGH. GUARDRAILS AT THE OPEN SIDES OF STAIRS MUST BE A MINIMUM OF 34" HIGH MEASURED VERTICALLY

FROM THE NOSING AT THE TREADS. THE HORIZONTAL SPACING OF THE VERTICAL BALUSTERS SHALL BE 4" O.C.

- GUARDRAIL DESIGN TO RESIST A MINIMUM OF 200 LBS LATERAL FORCE

BASEMENTS:

- SLOPE CONCRETE SLAB 4" MINIMUM TOWARDS GARAGE DOOR

- EXTERIOR FLATWORK/GARAGES SHALL HAVE A MINIMUM CONCRETE SRENGTH OF 4 500 PSI - FOOTINGS TO A MINIMUM CONCRETE STRENGTH OF 2500 PSI, UNLESS

OTHERWISE NOTED- ALL FOUNDATION WALLS TO BE CAST IN PLACE CONCRETE 3000 PSI MIN. UNLESS OTHERWISE NOTED.

- BASEMENT WINDOW LOCATIONS MAY VARY FROM DRAWING DUE TO LOT CONDITIONS.

- BACKFILL ADJACENT TO FOUNDATION WALLS SHALL NOT BE PLACED UNTIL THE WALL HAS SUFFICIENT STRENGTH AND HAS BEEN ANCHORED TO THE FLOOR OR HAS BEEN SUFFICIENTLY BRACED TO PREVENT DAMAGE BY THE BACKFILL.

- ASSUMED ALLOWABLE SOIL BEARING PRESSURE: 2 000 p.s.f.

- WATERPROOF FOUNDATION WITH BITUMINOUS SPRAY.

- VERTICAL CONTROL JOINTS IN BASEMENT FOUNDATION WALLS - STANDARD LOCATION GUIDELINES: 1) PLACE A CONTROL JOINT IN ALL UNBRACED WALLS OVER 30' IN LENGTH.

(NOTE: "T" WALLS AND CORNERS COUNT AS A BRACE)

2) WINDOWS THAT ARE LARGER THAN THE STANDARD BASEMENT WINDOW REQUIRE A CONTROL JOINT.

3) CONTROL JOINTS ARE NOT REQUIRED AT EVERY WINDOW THAT IS STANDARD

4) IF THERE IS A STANDARD WINDOW LOCATED IN A WALL SEGMENT THAT REQUIRES A CONTROL JOINT, THEN THE CONTROL JOINT SHOULD BE PLACED ON THE SIDE OF THE WINDOW THAT IS ADJACENT TO THE LONG SIDE OF THE WALL. IF THERE IS MORE THAN ONE WINDOW IN A WALL THEN ONLY ONE WINDOW SHOULD HAVE A CONTROL JOINT.

5) DOORS DO NOT GET CONTROL JOINTS.

6) CONTROL JOINTS SHOULD NOT BE LOCATED WITHIN 3' OF A BEAM POCKET.

7) CONTROL JOINTS ARE REQUIRED AT THE FIRST AND LAST STEP DOWN AT STEPPED BASEMENT FOUNDATION WALLS.

- INTERIOR FLATWORK SHALL HAVE A MINIMUM CONCRETE STRENGTH OF 3.000

- ALL VERTICAL STEEL AND ALL STEEL IN STRUCTURAL SLABS TO BE GRADE 60. ALL HORIZONTAL STEEL IN FOUNDATION WALLS AND FOOTERS TO BE GRADE 40 STEEL. **SLAB ON GRADE:**

- ALL CONCRETE SLABS ON GRADE SHALL BE THE THICKNESS AS INDICATED ON THE DETAILS OVER MINIMUM 6 MIL. POLYETHYLENE (VISQUEEN) VAPOR BARRIER, SLABS SHALL BE REINFORCED WITH 6x6 W1 4 WWE LAPPED 8" AT EDGES AND ENDS IN

CONFORMANCE WITH ASTM-A 185, OR FIBERMESS REINFORCEMENT SHALL BE LISED WITH A MINIMUM FIBER LENGTH OF $\frac{1}{2}$ TO 2 $\frac{1}{4}$ COMPLYING WITH ASTM C 1116. THE DOSAGE AMOUNT SHALL BE 0.75 TO 3.0 POUNDS PER CUBIC YARD IN ACCORDANCE 2/OITAG//AMMOOSS 2'SSRIIT ASII/AM HTIW

- SLABS ON GRADE SHALL BEAR ON STRUCTURAL FILL WHICH SHALL BE CLEAN SAND FREE OF DEBRIS AND OTHER DELETERIOUS MATERIAL, STRUCTURAL FILL SHALL BE COMPACTED TO A DENSITY OF AT LEAST 95% OF THE MODIFIED PROCTOR MAXIMUMN DRY DENSITY (ASTM D1557). TERMITE PROTECTION SHALL BE PROVIDED IN ACCORDANCE WITH APPLICABLE CODE REQUIREMENTS. IF SOIL TREATMENT IS USED. THE TREATMENT SHALL BE DONE AFTER ALL EXCAVATION, BACKFILLING, AND COMPACTION IS COMPLETED.

- FOOTINGS MAY BEAR UPON UNDISTURBED SOIL OR UPON STRUCTURAL FILL. STRUCTURAL FILL SHALL BE COMPACTED TO A DENSITY OF AT LEAST 95% OF THE MODIFIED PROCTOR MAXIMUMN DRY DENSITY (ASTM D1557) FOR A DEPTH OF AT LEAST TWO FEET (2'-0") BELOW THE BOTTOM OF THE FOOTING.

- THE FOLLOWING MINIMUM CONCRETE COVER SHALL BE PROVIDED FOR REINFORCEMENT:

3" CONCRETE CAST AGAINST AND PERMANENTLY EXPOSED TO EARTH 2" CONCRETE EXPOSED TO EARTH AND WEATHER

1" CONCRETE NOT EXPOSED TO EARTH OR WEATHER

- SLOPÉ CONCRETE SLAB 4" MINIMUM TOWARDS GARAGE DOOR

- EXTERIOR FLATWORK/GARAGES SHALL HAVE A MINIMUM CONCRETE SRENGTH OF 4,500 PSI

- ASSUMED ALLOWABLE SOIL BEARING PRESSURE: 2,000 p.s.f.

- INTERIOR FLATWORK SHALL HAVE A MINIMUM CONCRETE STRENGTH OF 3.000 PSI.

- ALL STEEL IN STRUCTURAL SLABS TO BE GRADE 60. ALL HORIZONTAL STEEL IN FOUNDATION WALLS AND FOOTERS TO BE GRADE 40 STEEL

MECHANICAL/ELECTRICAL NOTES

- ANY GAS APPLIANCES MUST BE INSTALLED PER MANUFACTURER'S SPECIFICATIONS.

- HOLD THE CENTERLINE OF ALL EXTERIOR LIGHT FIXTURES AT 5'-8" OFF BOTTOM OF DOOR OPENING.

- ALL KITCHEN CABINET DIMENSIONS ARE CABINET TO CABINET.

- CABINET STYLES MAY VARY FROM INTERIOR ELEVATIONS DEPENDING ON STYLE, MANUFACTURER, ETC. FOR CABINET DETAILS SEE SHOP DRAWINGS

- CABINET SIZES MAY VARY WITH FULL-OVERLAY CABINETS.

- GROUND FAULT INTERRUPTER (GFCI) OUTLETS TO BE INSTALLED PER NEC 2017, SECT. 210.8

- PROVIDE HOSE BIBS PER DIVISION SPEC. SHEET. EXACT LOCATION TO BE FIELD DETERMINED UNLESS OTHERWISE NOTED ON THE PLANS.

- MIN. 50 C.F.M. FOR ALL EXHAUST FANS IN BATHROOMS

INSULATION DETAILS

EXTERIOR STUD WALL CAVITY: R-19

(2x4)

FLOOR JOIST CAVITY AT STANDARD PERIMETER: R-19

FLOOR JOIST CAVITY AT CANTILEVER: (OVER HORIZONTAL SPACE) (SLOPED AND VERTICAL SPACE) R-38 BATT

R-19 R-38 BLOWN

R-15

ELEVATION NOTES

- WINDOW STYLE AND MULLIONS MAY VARY FROM ELEVATION DEPENDING UPON MANUFACTURER, STYLE, PATTERN, TYPE, ETC.

- USE SECONDARY HEAT BARRIER ON ALL DIRECT VENT FIREPLACES 7' OR LESS ABOVE A WALKWAY

- Grade away from foundation walls shall fall a minimum of 6" within the first 10'.

- PROVIDE TYVEK OR EQUIVALENT HOUSE WRAP BEHIND BRICK AND STONE VENEER OVER WOOD SHEATHING. PROVIDE BRICK WEEP HOLES AT 24" O.C. WITH BRICK VENEER AND MORTER NET BEHIND AND THROUGH WEEP HOLES.

PROVIDE FLASHING AND WEEP HOLES ABOVE ALL BRICK ANGLE IRONS, BELOW ALL BRICK SILLS AND ABOVE SILL PLATE SEALERS.

- EXTERIOR STEPS TO HAVE A MAXIMUM 8" RISER. WHEN VERTICAL RISE EXCEEDS 30" OR FOUR OR MORE CONTINUOUS RISERS. A HANDRAIL IS REQUIRED

ROOF PLAN NOTES

- ALL OVERHANGS TO HAVE (2) SOFFIT VENTS PER EACH 8' SOFFIT SECTION.

- PROVIDE BAFFLES AT EXTERIOR TRUSS BEARING FOR VENTILATION.

PROVIDE 15# FELT PAPER LINDER SHINGLES

Space for Architect Seal



The Drees Company 12/22/2023 1:22:22 PM

RESIDENCE FOR:

ADAMS

127 DAYBREAK WAY SERENITY - 50

Job Number: Drawina Date STY5-0237-00

House Name:

11/27/23 **GREG PIEPER**

the HAVEN II

7701 Six Forks Road, Suite 132, Raleigh, NC 27615 Phone: [919] 844-9288

08/16/22 CDs Drawn By

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Elevation "A"

Coord Phone

Series

Plan No

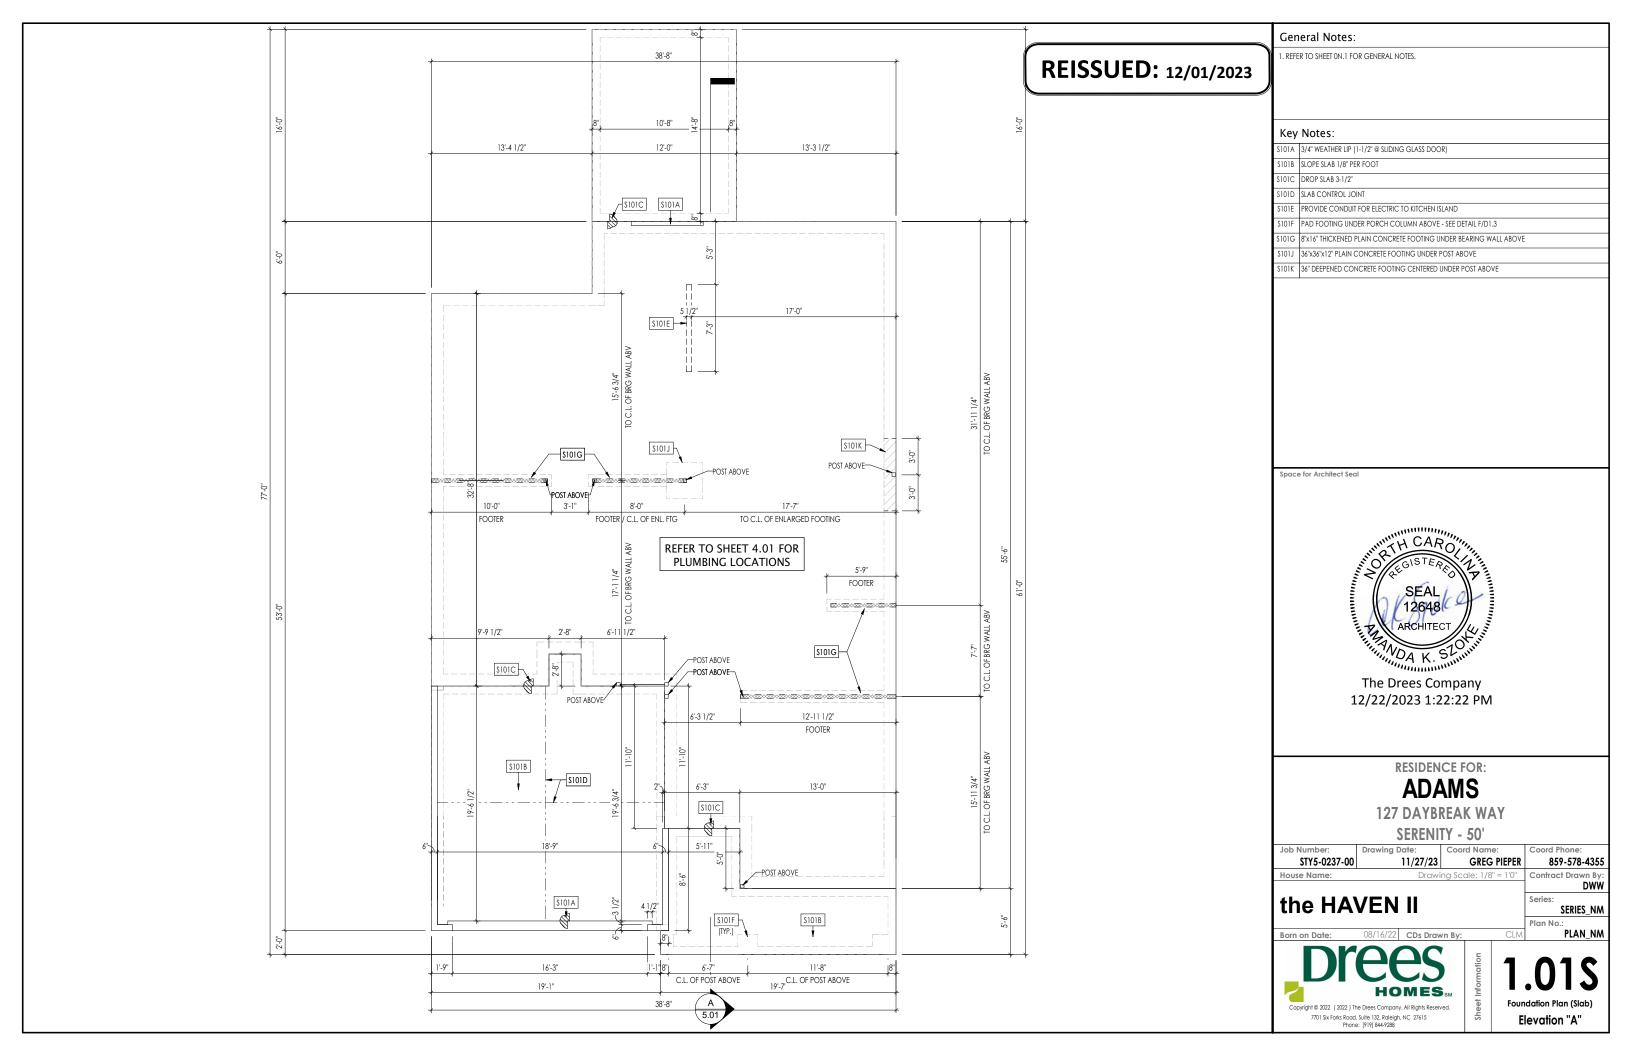
859-578-4355

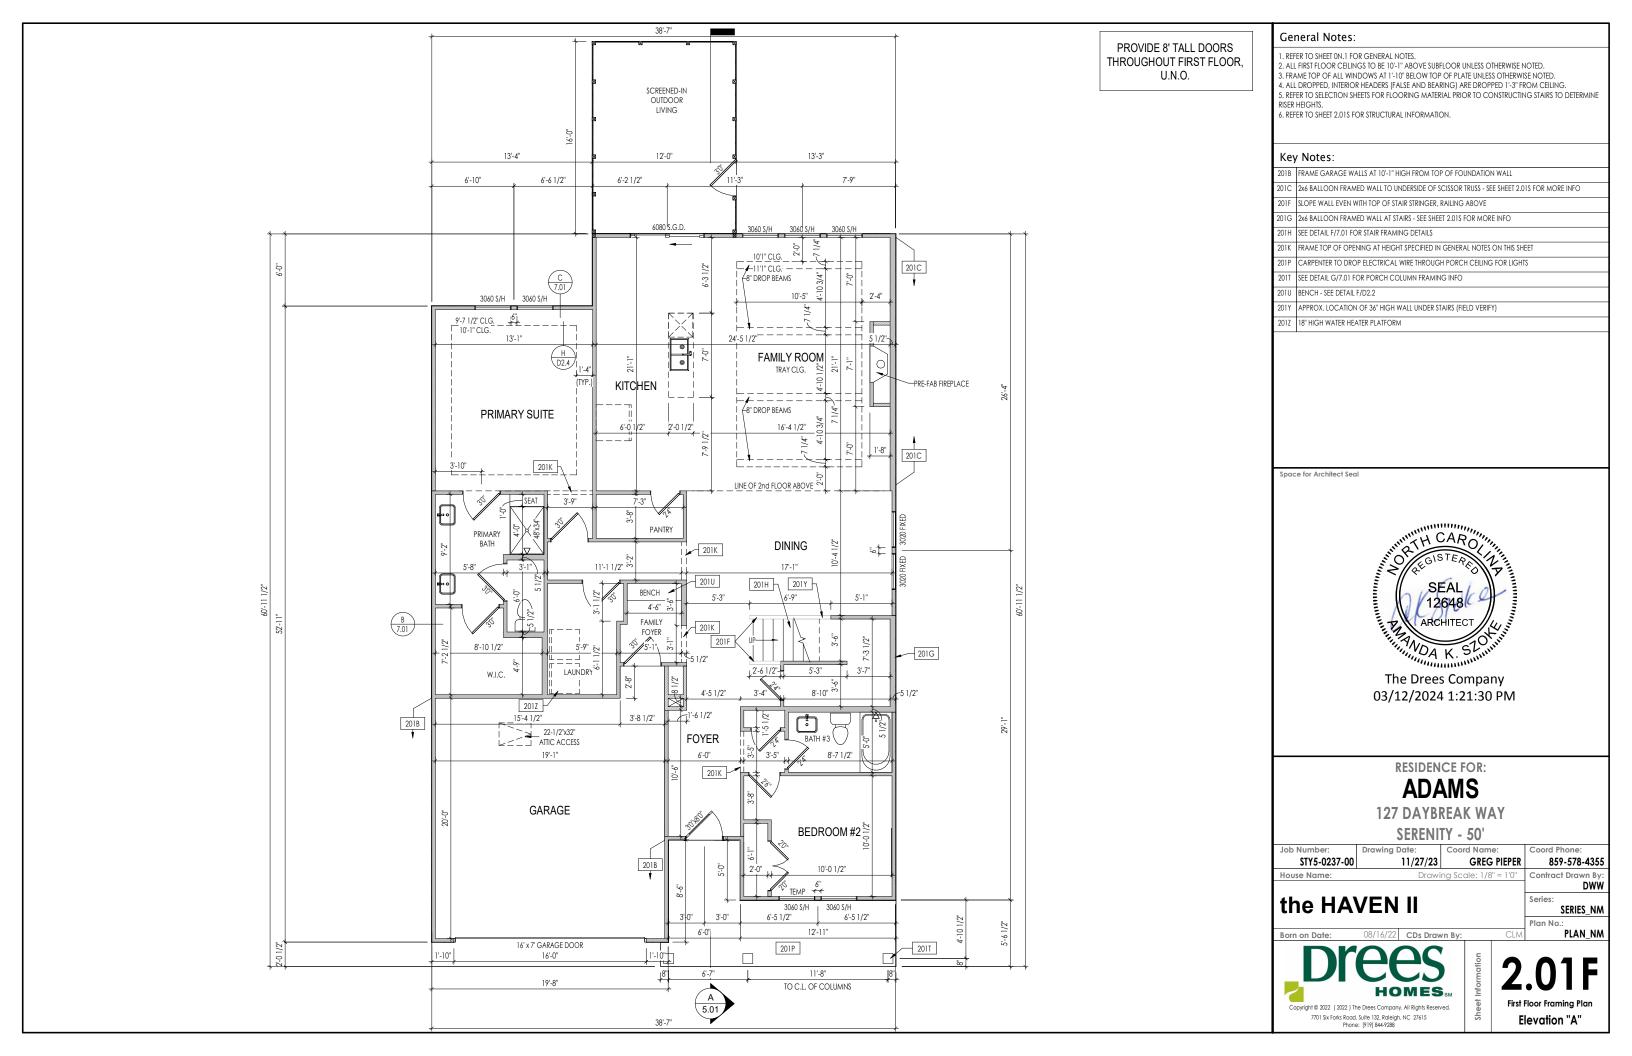
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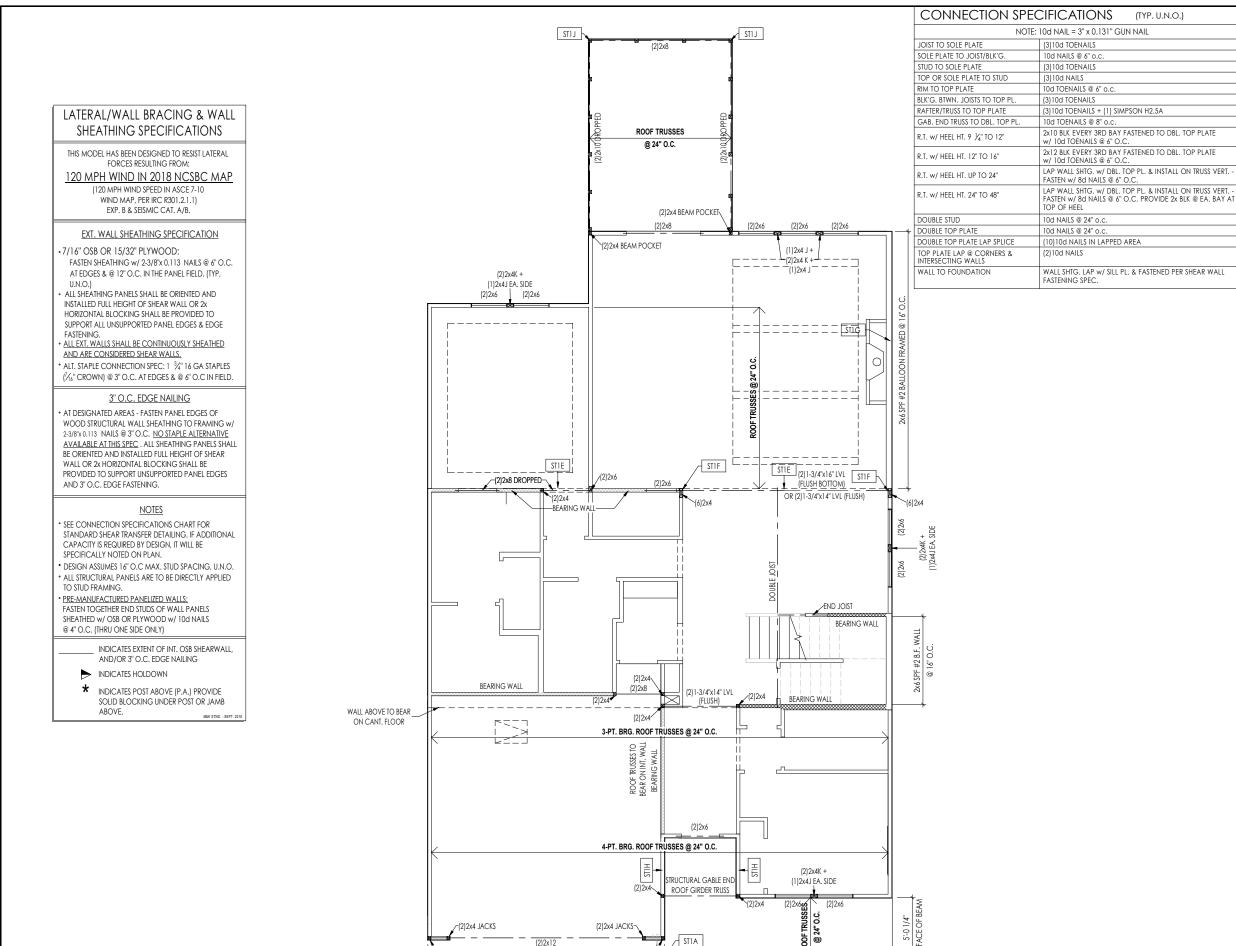
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PLAN NM

Contract Drawn B







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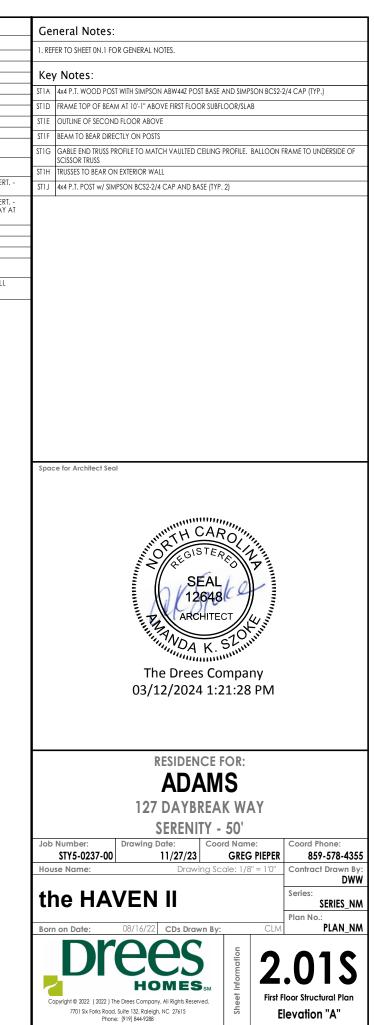
DROPPED CONT. FULL WIDTH OF PORTAL FRAME

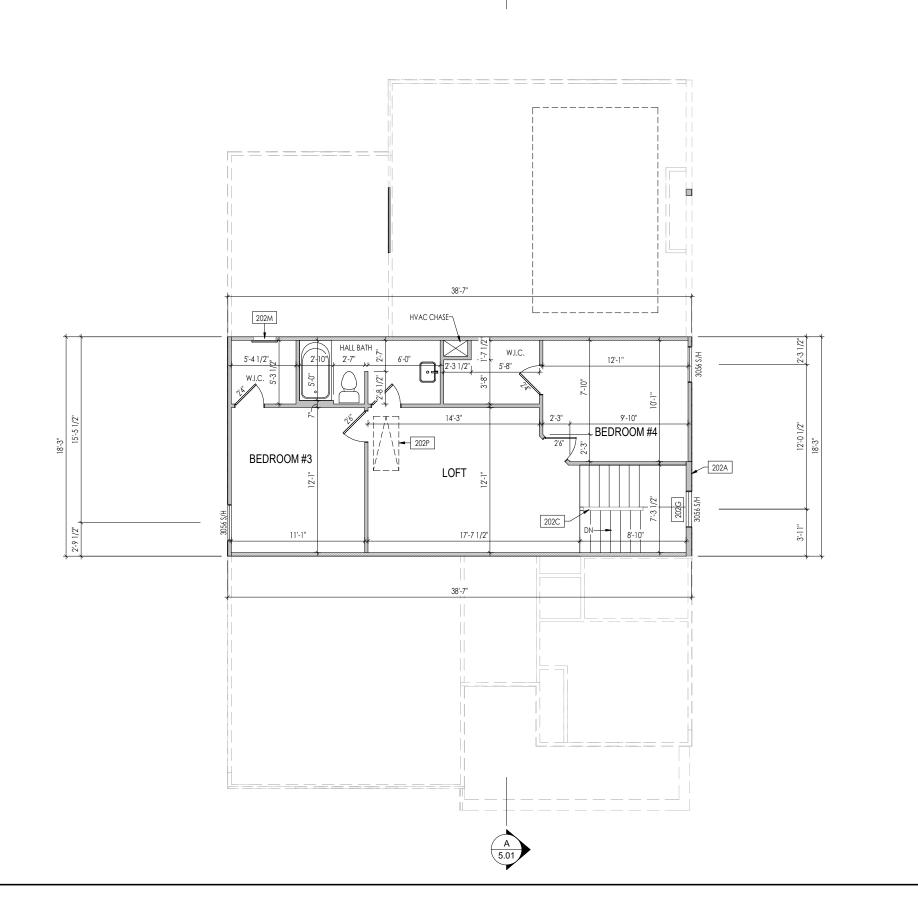
PORTAL FRAME - SEE DETAIL (1/SD-2)

-(1)2x4 J + (1)2x4 K

(1)2x4 J + (1)2x4 K-

STIA





General Notes:

- . REFER TO SHEET ON.1 FOR GENERAL NOTES.
- 1. ACE AND SHEED WITH TO MEDITARIA MOTED.

 2. ALL SECOND FLOOR CEILINGS TO BE 9'-1" ABOVE SUBFLOOR UNLESS OTHERWISE NOTED.

 3. FRAME TOP OF ALL WINDOWS AT 1'-0 1/4" BELOW TOP OF PLATE UNLESS OTHERWISE NOTED.

 4. ALL DROPPED, INTERIOR HEADERS (FALSE AND BEARING) ARE DROPPED 1'-0" FROM CEILING.
- 5. REFER TO SELECTION SHEETS FOR FLOORING MATERIAL PRIOR TO CONSTRUCTING STAIRS TO DETERMINE RISER HEIGHTS.

 6. REFER TO SHEET 2.02S FOR STRUCTURAL INFORMATION.

Key Notes:

- 202A 2x6 BALLOON FRAMED WALL AT STAIRS SEE SHEET 2,02S FOR MORE INFO
- 202C SLOPE WALL EVEN WITH TOP OF STAIR STRINGER, RAILING ABOVE
- 202G FRAME TOP OF WINDOW AT TO 3'-0 1/4" BELOW TOP PLATE
- 202M SEE DETAIL N/D2.1 FOR WALL ATTIC ACCESS DETAILS
- 202P PULL DOWN ATTIC ACCESS STAIRS (25-1/2" x 54") WITH LIGHT AND OUTLET

Space for Architect Seal



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RESIDENCE FOR:

ADAMS

127 DAYBREAK WAY

SERENITY - 50'

Job Number: STY5-0237-00 11/27/23

the HAVEN II

Coord Name:

GREG PIEPER 859-578-4355

SERIES_NM

PLAN_NM

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LATERAL/WALL BRACING & WALL SHEATHING SPECIFICATIONS

THIS MODEL HAS BEEN DESIGNED TO RESIST LATERAL FORCES RESULTING FROM:

120 MPH WIND IN 2018 NCSBC MAP

(120 MPH WIND SPEED IN ASCE 7-10 WIND MAP, PER IRC R301.2.1.1) EXP. B & SEISMIC CAT. A/B.

EXT. WALL SHEATHING SPECIFICATION

- 7/16" OSB OR 15/32" PLYWOOD:
 FASTEN SHEATHING W/ 2-3/8"x 0.113 NAILS @ 6" O.C. AT EDGES & @ 12" O.C. IN THE PANEL FIELD. (TYP, U.N.O.)
- ALL SHEATHING PANELS SHALL BE ORIENTED AND INSTALLED FULL HEIGHT OF SHEAR WALL OR 2x HORIZONTAL BLOCKING SHALL BE PROVIDED TO SUPPORT ALL UNSUPPORTED PANEL EDGES & EDGE FASTENING.
- ALL EXT. WALLS SHALL BE CONTINUOUSLY SHEATHED
 AND ARE CONSIDERED SHEAR WALLS.
- * ALT. STAPLE CONNECTION SPEC: 1 $^3\!\!/_4$ " 16 GA STAPLES ($^\prime\!\!/_6$ " CROWN) @ 3" O.C. AT EDGES & @ 6" O.C IN FIELD.

3" O.C. EDGE NAILING

• AT DESIGNATED AREAS - FASTEN PANEL EDGES OF WOOD STRUCTURAL WALL SHEATHING TO FRAMING W/ 2-3/8'x 0.113 NAILS @ 3" O.C. NO STAPLE ALTERNATIVE AVAILABLE AT THIS SPEC. ALL SHEATHING PANELS SHALL BE ORIENTED AND INSTALLED FULL HEIGHT OF SHEAR WALL OR 2x HORIZONTAL BLOCKING SHALL BE PROVIDED TO SUPPORT UNSUPPORTED PANEL EDGES AND 3" O.C. EDGE FASTENING.

NOTES

- SEE CONNECTION SPECIFICATIONS CHART FOR STANDARD SHEAR TRANSFER DETAILING. IF ADDITIONAL CAPACITY IS REQUIRED BY DESIGN, IT WILL BE SPECIFICALLY NOTED ON PLAN.
- DESIGN ASSUMES 16" O.C MAX. STUD SPACING, U.N.O.
 ALL STRUCTURAL PANELS ARE TO BE DIRECTLY APPLIED TO STUD FRAMING.
- * PRE-MANUFACTURED PANELIZED WALLS; FASTEN TOGETHER END STUDS OF WALL PANELS SHEATHED w/ OSB OR PLYWOOD w/ 10d NAILS @ 4" O.C. (THRU ONE SIDE ONLY)

_ INDICATES EXTENT OF INT. OSB SHEARWALL, AND/OR 3" O.C. EDGE NAILING

► INDICATES HOLDOWN

.....

INDICATES POST ABOVE (P.A.) PROVIDE SOLID BLOCKING UNDER POST OR JAMB ABOVE.

8 × × (2)2x6 BEARING WALL REARING WALL ST2F

General Notes:

1. REFER TO SHEET ON.1 FOR GENERAL NOTES.

Key Notes:

ST2F PROVIDE CONTINUOUS FULL HEIGHT SHEATHING DOWN TO SECOND FLOOR SOLE PLATE

CONNECTION SPECIFICATIONS (TYP. U.N.O.) NOTE: 10d NAIL = 3" x 0.131" GUN NAIL (3)10d TOENAILS OLE PLATE TO JOIST/BLK'G. 10d NAILS @ 6" o.c. UD TO SOLE PLATE (3) 10d TOENAILS OP OR SOLE PLATE TO STUD M TO TOP PLATE 10d TOENAILS @ 6" o.c. LK'G. BTWN. JOISTS TO TOP PL (3)10d TOENAILS (3)10d TOENAILS + (1) SIMPSON H2.5A AFTER/TRUSS TO TOP PLATE SAB, END TRUSS TO DBL, TOP PL 10d TOENAILS @ 8" o.c. 2x10 BLK EVERY 3RD BAY FASTENED TO DBL. TOP PLATE .T. w/ HEEL HT. 9 1/4" TO 12" 2x12 BLK EVERY 3RD BAY FASTENED TO DBL. TOP PLATE T. w/ HEEL HT. 12" TO 16" w/ 10d TOENAILS @ 6" O.C LAP WALL SHTG. w/ DBL. TOP PL. & INSTALL ON TRUSS VERT. FASTEN w/ 8d NAILS @ 6" O.C. .T. w/ HEEL HT. UP TO 24" LAP WALL SHTG. w/ DBL. TOP PL. & INSTALL ON TRUSS VERT. .T. w/ HEEL HT. 24" TO 48" FASTEN w/ 8d NAILS @ 6" O.C. PROVIDE 2x BLK @ EA. BAY AT TOP OF HEEL OUBLE STUD 10d NAILS @ 24" o.c. 10d NAILS @ 24" o.c. OUBLE TOP PLATE (10)10d NAILS IN LAPPED AREA OUBLE TOP PLATE LAP SPLICE TOP PLATE LAP @ CORNERS & NTERSECTING WALLS (2)10d NAILS WALL SHTG. LAP w/ SILL PL. & FASTENED PER SHEAR WALL FASTENING SPEC. VALL TO FOUNDATION

Space for Architect Seal



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RESIDENCE FOR:

ADAMS

127 DAYBREAK WAY

SERENITY - 50'

Job Number: Drawing Date: Coord Name

 STY5-0237-00
 11/27/23
 GREG PIEPER
 859-578-4355

 House Name:
 Drawing Scale: 1/8" = 1'0"
 Contract Drawn By: DWW

the HAVEN II

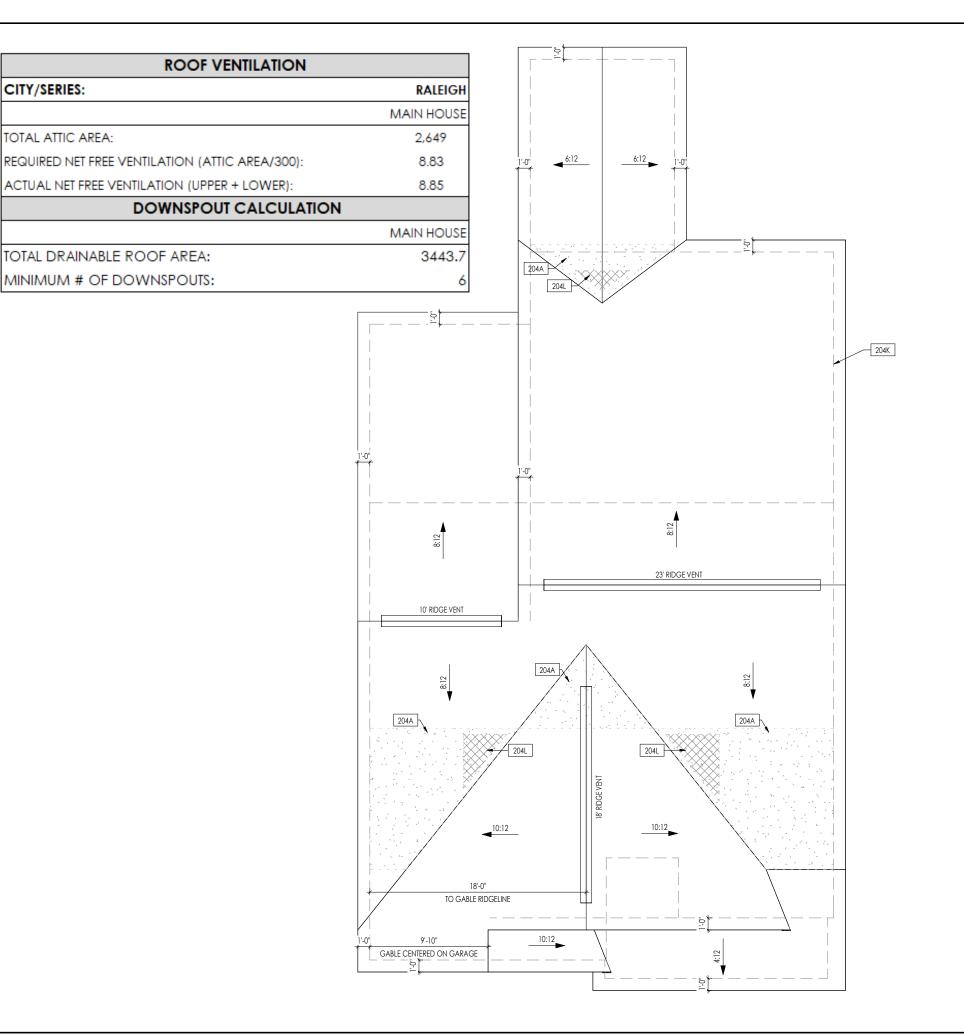
08/16/22 CDs Drawn By:

Series:
SERIES_NM
Plan No.:
PLAN NM

DICES
HOMES SM
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2.02 Second Floor Structural Elevation "A"

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CITY/SERIES:

TOTAL ATTIC AREA:

TOTAL DRAINABLE ROOF AREA:

MINIMUM # OF DOWNSPOUTS:

	HEEL CUT STANDARDS						
		OVER	HANG				
		1'-0"	2'-0"				
	4:12	3-3/4"	7-3/4"				
ROOF PITCH	5:12	4-3/4"	9-3/4"				
	6:12	5-3/4"	11-3/4"				
	7:12	6-3/4"	13-3/4"				
	8:12	7-3/4"	N/A				
	9:12	8-3/4"	N/A				
	10:12	9-3/4"	N/A				
	12:12	11-3/4"	N/A				
	14:12	13-3/4"	N/A				

General Notes: 1. REFER TO SHEET ON.1 FOR GENERAL NOTES. Key Notes: 204A VALLEY TRUSS OVER FRAMING @ 24" O.C. 204K GABLE END TRUSS PROFILE TO MATCH VAULTED CEILING PROFILE - SEE SHEET 2.01 NO ROOF DECKING UNDER OVERFRAMING IN THIS AREA TO ALLOW FOR PROPER ATTIC VENTILATION

CONNECTION SPECIFICATIONS (TYP. U.N.O.) NOTE: 10d NAIL = 3" x 0.131" GUN NAIL (3)10d TOENAILS SOLE PLATE TO JOIST/BLK'G. 10d NAILS @ 6" o.c. UD TO SOLE PLATE (3) 10d TOENAILS OP OR SOLE PLATE TO STUD M TO TOP PLATE 10d TOENAILS @ 6" o.c. LK'G. BTWN. JOISTS TO TOP PL (3)10d TOENAILS (3)10d TOENAILS + (1) SIMPSON H2.5A AFTER/TRUSS TO TOP PLATE SAB. END TRUSS TO DBL. TOP PL 10d TOENAILS @ 8" o.c. 2x10 BLK EVERY 3RD BAY FASTENED TO DBL. TOP PLATE w/ 10d TOENAILS @ 6" O.C. T. w/ HEEL HT. 9 1/4" TO 12" 2x12 BLK EVERY 3RD BAY FASTENED TO DBL. TOP PLATE T. w/ HEEL HT. 12" TO 16" w/ 10d TOENAILS @ 6" O.C LAP WALL SHTG. w/ DBL. TOP PL. & INSTALL ON TRUSS VERT. FASTEN w/ 8d NAILS @ 6" O.C. .T. w/ HEEL HT. UP TO 24" LAP WALL SHTG, w/ DBL, TOP PL. & INSTALL ON TRUSS VERT. -FASTEN w/ 8d NAILS @ 6" O.C. PROVIDE 2x BLK @ EA. BAY AT TOP OF HEEL T. w/ HEEL HT. 24" TO 48" 10d NAILS @ 24" o.c. OUBLE STUD OUBLE TOP PLATE 10d NAILS @ 24" o.c. (10)10d NAILS IN LAPPED AREA OUBLE TOP PLATE LAP SPLICE TOP PLATE LAP @ CORNERS & NTERSECTING WALLS (2)10d NAILS

WALL SHTG. LAP w/ SILL PL. & FASTENED PER SHEAR WALL FASTENING SPEC.

Space for Architect Seal

VALL TO FOUNDATION



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RESIDENCE FOR:

ADAMS

127 DAYBREAK WAY

SERENITY - 50' Coord Name Drawina Date:

STY5-0237-00 11/27/23 **GREG PIEPER** 859-578-4355

the HAVEN II

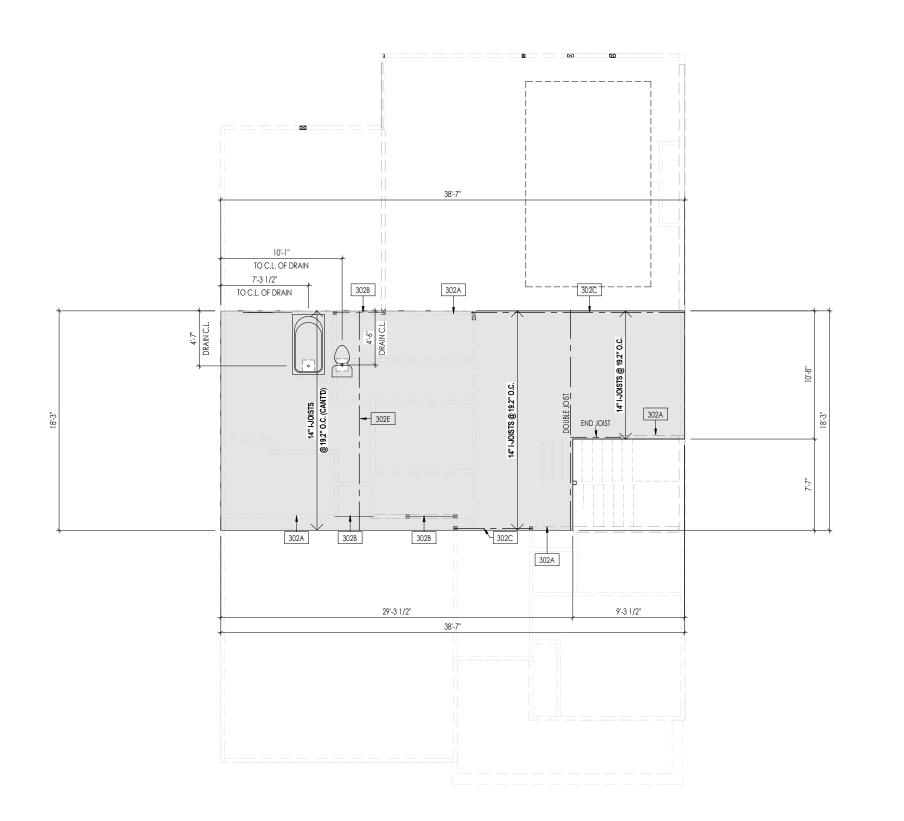
08/16/22 CDs Drawn By

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Job Number:

SERIES_NM PLAN NM

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General Notes:

- I. REFER TO SHEET ON.1 FOR GENERAL NOTES.
- 2. FLOOR JOISTS TO BE 14" TJI 210 SERIES I-JOISTS, OR EQUAL, @ 19.2" O.C., UNLESS OTHERWISE NOTED.
- 3. JOISTS ARE NOT TO BE PLACE DIRECTLY OVER INTERIOR PARALLEL WALL.
- (TO PREVENT UNEVEN FLOOR DEFLECTION FROM OCCURRING)
 4. ADD'L JOISTS MAY BE LOCATED UP TO 2" AWAY FROM THE PARTITION WALL ABOVE IN CASES WHERE MECHANICAL PENETRATIONS

Key Notes:

302A BEARING WALL BELOW

302B BEAM BELOW - SEE SHEET 2.01S FOR MORE INFO

302C FLUSH BEAM - SEE SHEET 2.01S FOR MORE INFO

302E ADDITIONAL JOIST UNDER PARTITION ABOVE

Space for Architect Seal



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RESIDENCE FOR:

ADAMS

127 DAYBREAK WAY

SERENITY - 50' Coord Name:

STY5-0237-00 GREG PIEPER 11/27/23 House Name:

the HAVEN II

SERIES_NM

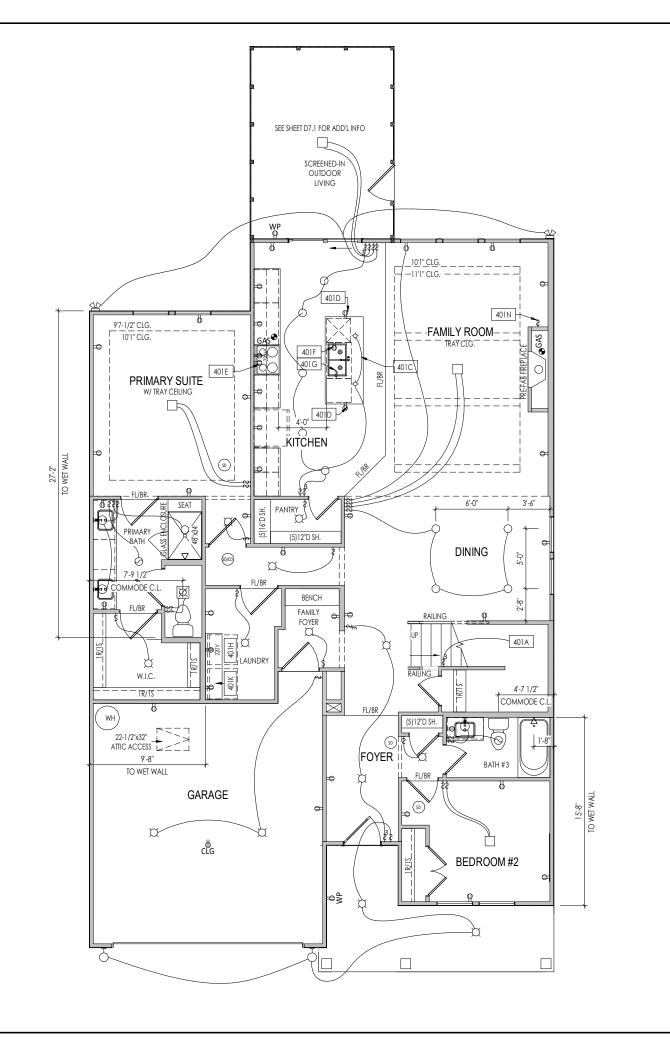
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DWW

PLAN NM 08/16/22 **CDs Drawn By:**

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Job Number:



PROVIDE 8' TALL DOORS THROUGHOUT FIRST FLOOR, U.N.O.

General Notes:

. REFER TO SHEET ON.1 FOR GENERAL NOTES.

Key Notes:

- 401A TO SWITCH OR LIGHT ABOVE
- 401C SEE DETAIL A/7.01 FOR KITCHEN ISLAND COUNTERTOP DIMENSIONS
- 401D HOLD OUTLET HIGH ON ISLAND
- 401E OUTLET FOR RANGE HOOD/MICROWAVE HELD HIGH, VENT TO EXTERIOR
- OUTLET FOR DISHWASHER LOCATED IN SINK CABINET
- PUSH BUTTON FOR GARBAGE DISPOSAL OR SWITCH LOCATED IN SINK CABINET REFER TO SELECTIONS
- LOCATE WASHER TO LEFT OF DRYER
- 401K 16" DEEP x 5'-6" LONG SHELF HELD AT 5'-7" A.F.F.
- 401N SWITCHES FOR BLOWER UNIT WITH DIRECT VENT FIREPLACE

MECHANICAL LEGEND

- CLG. MOUNTED LIGHT FIXT.
- DATA JACK ⇒ WALL OUTLET
- ₩EATHERPROOF GFCI OUTLET № 220 VOLT OUTLET
- 8 ← GFCI OUTLET
- FLOOR OUTLET
- (TV) CABLE TELEVISION JACK (PIN LIGHT
- ← SINGLE POLE SWITCH
- ⇔ 3-WAY SWITCH
- BLOCK, MOUNT, & SWITCH FOR FUTURE FAN/LIGHT COMBINATION (CENTER, UNLESS OTHERWISE NOTED)
- → WALL MOUNTED LIGHT FIXT. - DOUBLE SPOTLIGHT FIXT.
- DIRECTIONAL CAN LIGHT
- ₩ WALL SCONCE @ 5'-6" A.F.F. FLUORESCENT LIGHT
- UNDER CABINET LIGHTING
- EXHAUST FAN AND LIGHT COMBINATION

■ STAIR LIGHT

SHOWER HEAD

SD SMOKE DETECTOR

SMOKE DETECTOR/ CO DETECTOR COMBINATION

GAS GAS HOOK UP

+ HOSE BIB

CLG. MTD. EXHAUST FAN

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RESIDENCE FOR:

ADAMS

127 DAYBREAK WAY

SERENITY - 50' Coord Name Job Number: Drawina Date:

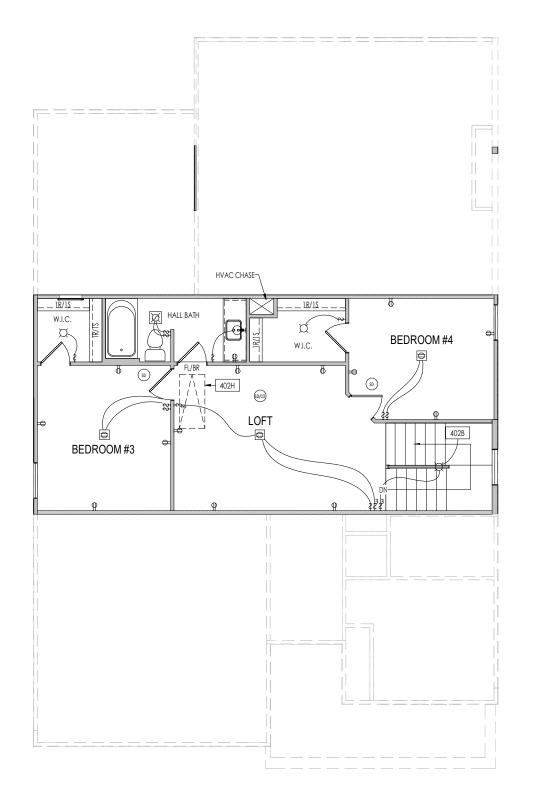
GREG PIEPER STY5-0237-00 11/27/23

the HAVEN II SERIES_NM PLAN NM 08/16/22 CDs Drawn By

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← SINGLE POLE SWITCH

⇔ 3-WAY SWITCH

BLOCK, MOUNT, & SWITCH FOR FUTURE FAN/LIGHT COMBINATION (CENTER, UNLESS OTHERWISE NOTED)

₩ WALL SCONCE @ 5'-6" A.F.F. FLUORESCENT LIGHT

UNDER CABINET LIGHTING

EXHAUST FAN AND LIGHT COMBINATION

CLG. MTD. EXHAUST FAN

Space for Architect Seal



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RESIDENCE FOR:

ADAMS

127 DAYBREAK WAY

SERENITY - 50'

Coord Name: Job Number: Drawing Date: **GREG PIEPER** STY5-0237-00 11/27/23 House Name:

the HAVEN II

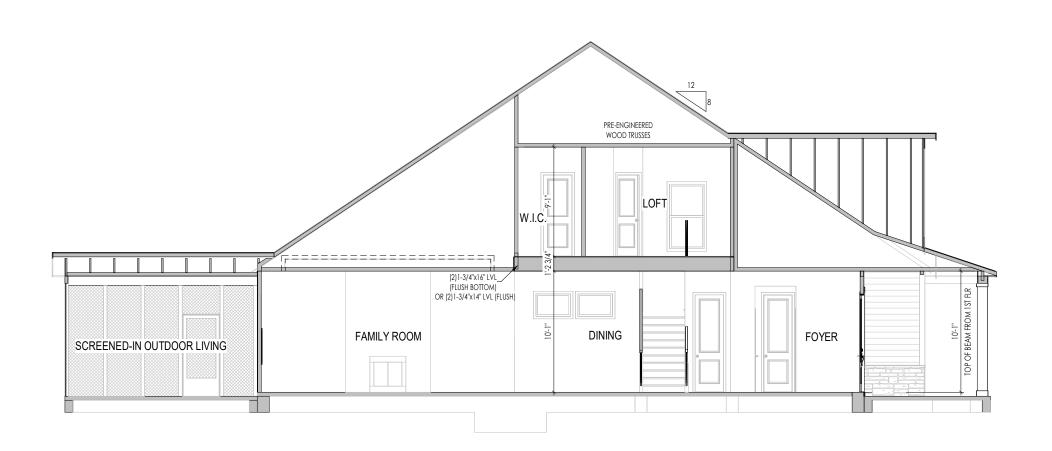
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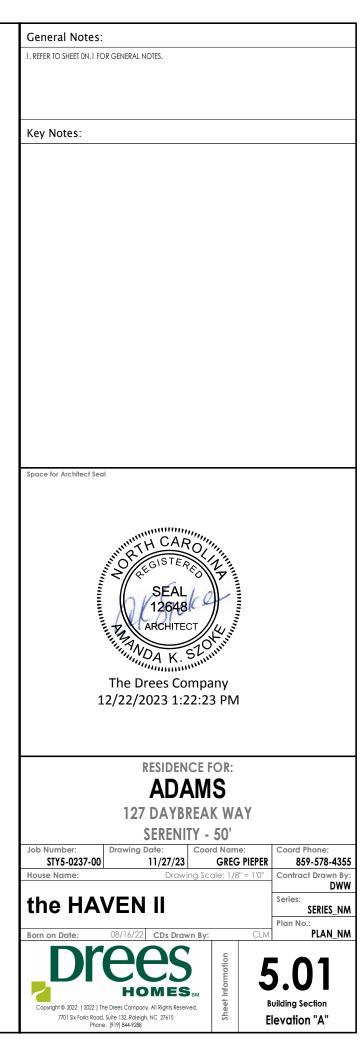
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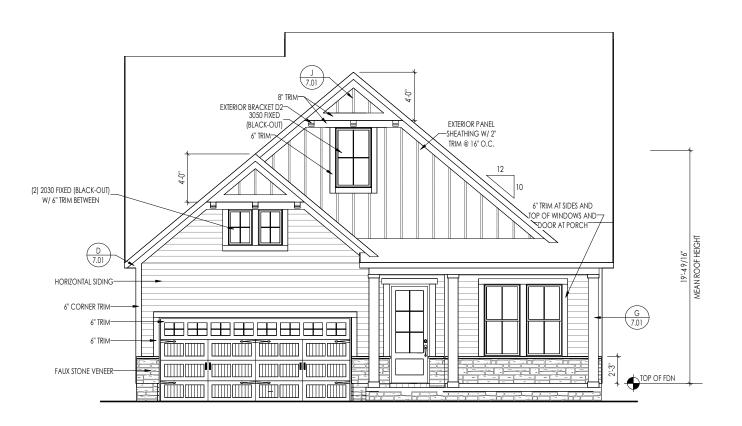
DWW





A BUILDING SECTION THRU FOYER
5.01 1/8"= 1'-0"





ELEVATION'A'

TYPICAL TRIM:

6" FASCIA (ALL SIDES)

8" FRIEZE (FRONT ONLY, UNLESS OTHERWISE NOTED)

General Notes:

- . REFER TO SHEET ON.1 FOR GENERAL NOTES.
- 2. ROOFING MATERIAL PER SELECTIONS.
 3. CONTACT M&K ENGINEERING FOR HEADER SIZE/BRICK SUPPORT IF GRADE DROPS AND THE AMOUNT OF BRICK OVER GARAGE DOOR SHOWN ON CURRENT ELEVATION IS NO LONGER ACCURATE

Key Notes:

BRICK and STONE LINTEL SCHEDULE WINDOW 36" HIGH 48" HIGH LINTEL SIZE ABOVE Up to 6'-0" L3 1/2 x 3 1/2 x 1/4 Up to 8'-3" L5 x 3 1/2 x 5/16 Up to 9'-3" L6 x 4 x 3/16 L7 x 4 x 3/8 Up to 16'-3" **per Design L7 x 4 x 3/8 L8 x 4 x 1/2 L8 x 4 x 1/2 Up to 6'-0" ----L4 x 3 1/2 x 1/4 Up to 8'-3" ----L5 x 3 1/2 x 5/14 Up to 9'-3" **per Design L6 x 4 x 3/8 L7 x 4 x 3/8 Up to 16'-3" **per Design **per Design L8 x 4 x 1/2

All Lintels: 4" Minimum bearing required each end

* Brick is based on 40psf and Stone is based on 60psf

** Any lintels not described by the above parameters shall be specifically designed.

Space for Architect Seal



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RESIDENCE FOR:

ADAMS

127 DAYBREAK WAY

SERENITY - 50'

Job Number: Drawina Date **GREG PIEPER** STY5-0237-00 11/27/23 859-578-4355 House Name: DWW

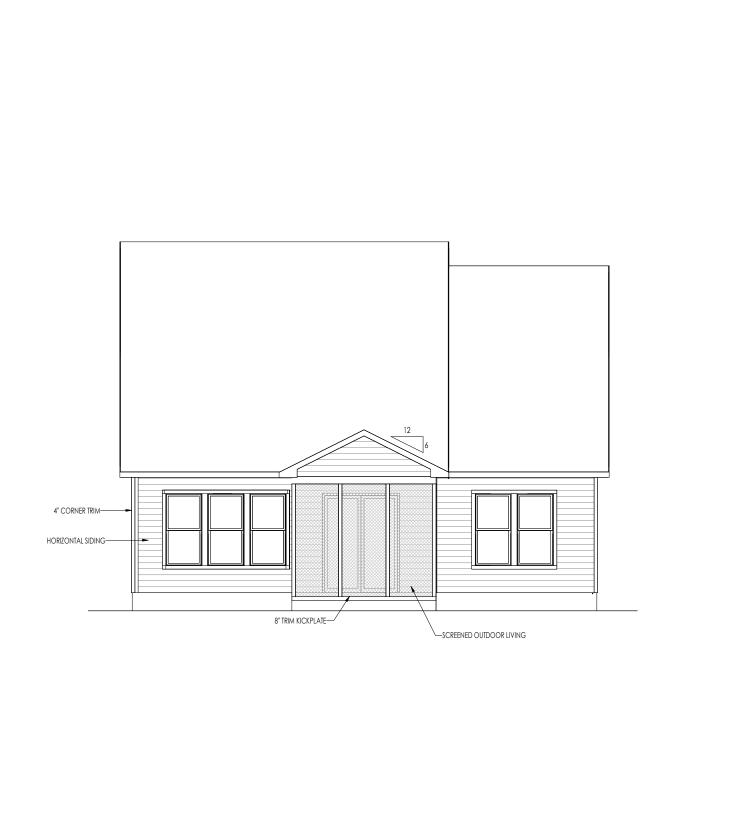
the HAVEN II

CDs Drawn Bv

SERIES_NM Plan No. PLAN NM

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		General Notes:
	TYPICAL TRIM:	1. REFER TO SHEET ON,1 FOR GENERAL NOTES.
	6" FASCIA (ALL SIDES)	REFER TO SHEET ON.1 FOR GENERAL NOTES. ROOFING MATERIAL PER SELECTIONS. REFER TO LINTEL SCHEDULE AS NEEDED ON SHEET 6.01.
	8" FRIEZE (FRONT ONLY, UNLESS OTHERWISE NOTED)	Key Notes:
	(FRONT ONLY, UNLESS OTHERWISE NOTED)	
8		
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SCREENED OUTDOOR LIVING— 4" CORNER TRIM— HORIZONTAL SIDING— AT CORNER TRIM— HORIZONTAL SIDING— AT CORNER TRIM— HORIZONTAL SIDING— AT CORNER TRIM— HORIZONTAL SIDING— HORIZONTAL SIDING— AT CORNER TRIM— HORIZONTAL SIDING— HORIZONTAL SIDI		
		DECIDENCE FOR
		RESIDENCE FOR:
		ADAMS
		127 DAYBREAK WAY
		SERENITY - 50' Job Number: Drawing Date: Coord Name: Coord Phone:
		STY5-0237-00 11/27/23 GREG PIEPER 859-578-4355
		House Name: Drawing Scale: 1/8" = 1'0" Contract Drawn By: DWW
		the HAVEN II SERIES_NM
		Plan No.:
		DYOOC 5
		DIEES 6.02
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TYPICAL TRIM:

6" FASCIA (ALL SIDES)

8" FRIEZE (FRONT ONLY, UNLESS OTHERWISE NOTED)

General Notes:

- 1. REFER TO SHEET ON.1 FOR GENERAL NOTES. 2. ROOFING MATERIAL PER SELECTIONS. 3. REFER TO LINTEL SCHEDULE AS NEEDED ON SHEET 6.01.

Key Notes:

Space for Architect Seal



RESIDENCE FOR:

ADAMS

127 DAYBREAK WAY

SERENITY - 50'

Coord Name: Job Number: Drawing Date: GREG PIEPER STY5-0237-00 11/27/23 Contract Drawn By: House Name:

the HAVEN II

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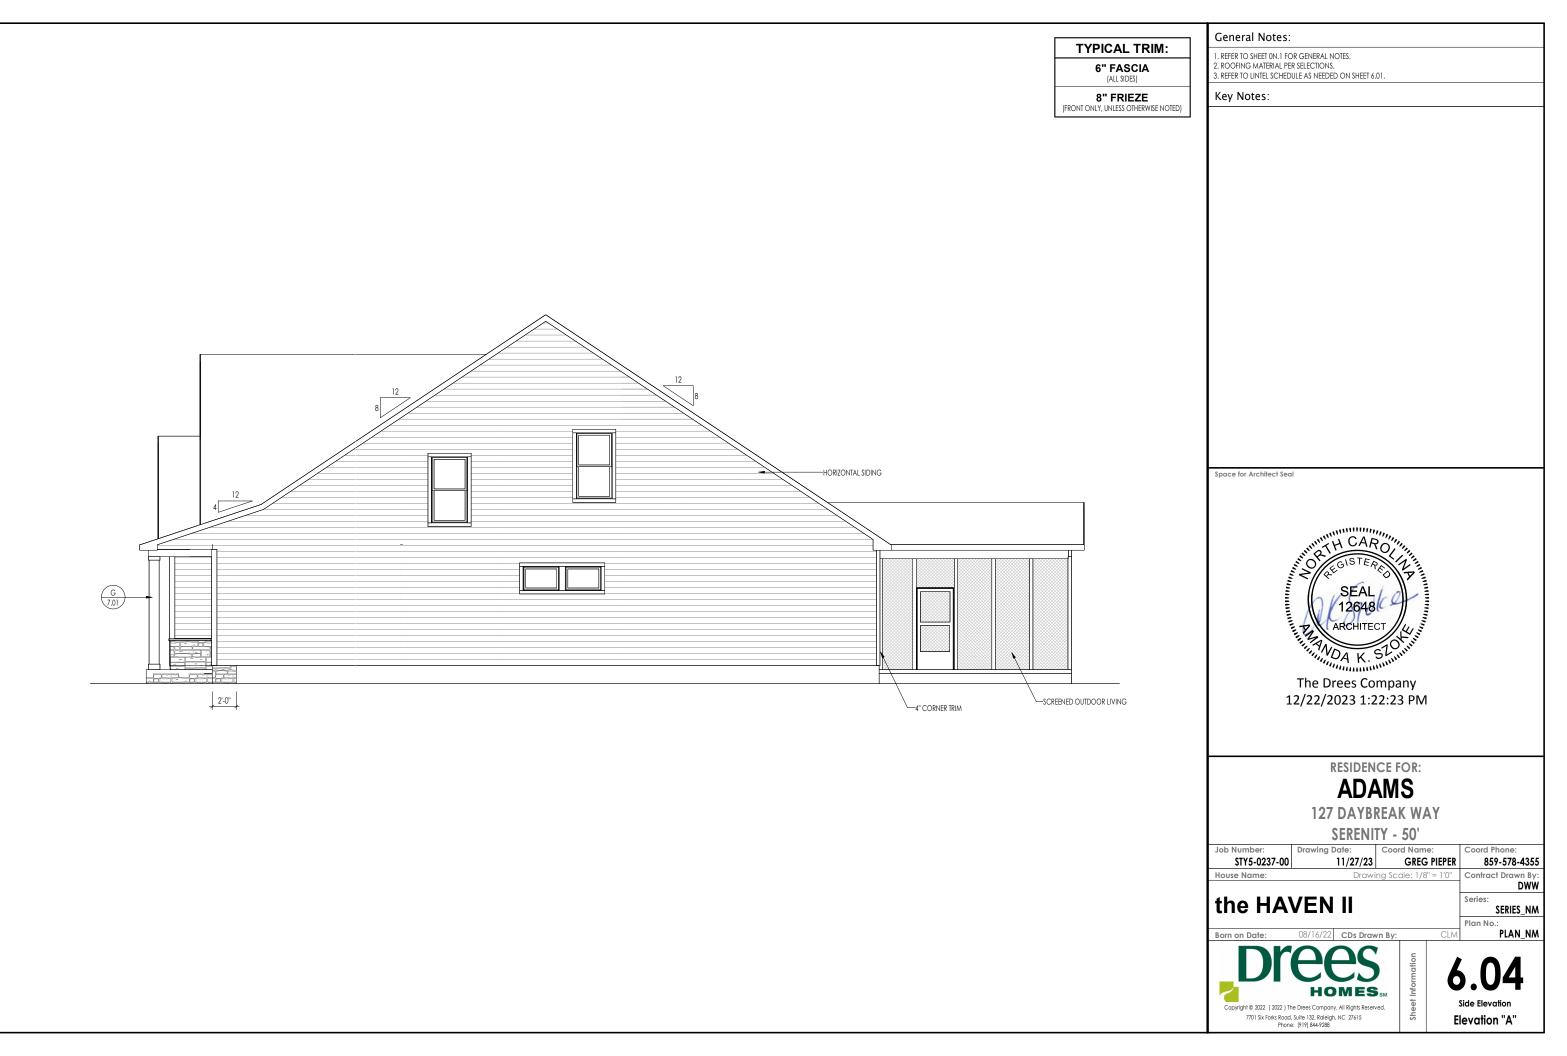
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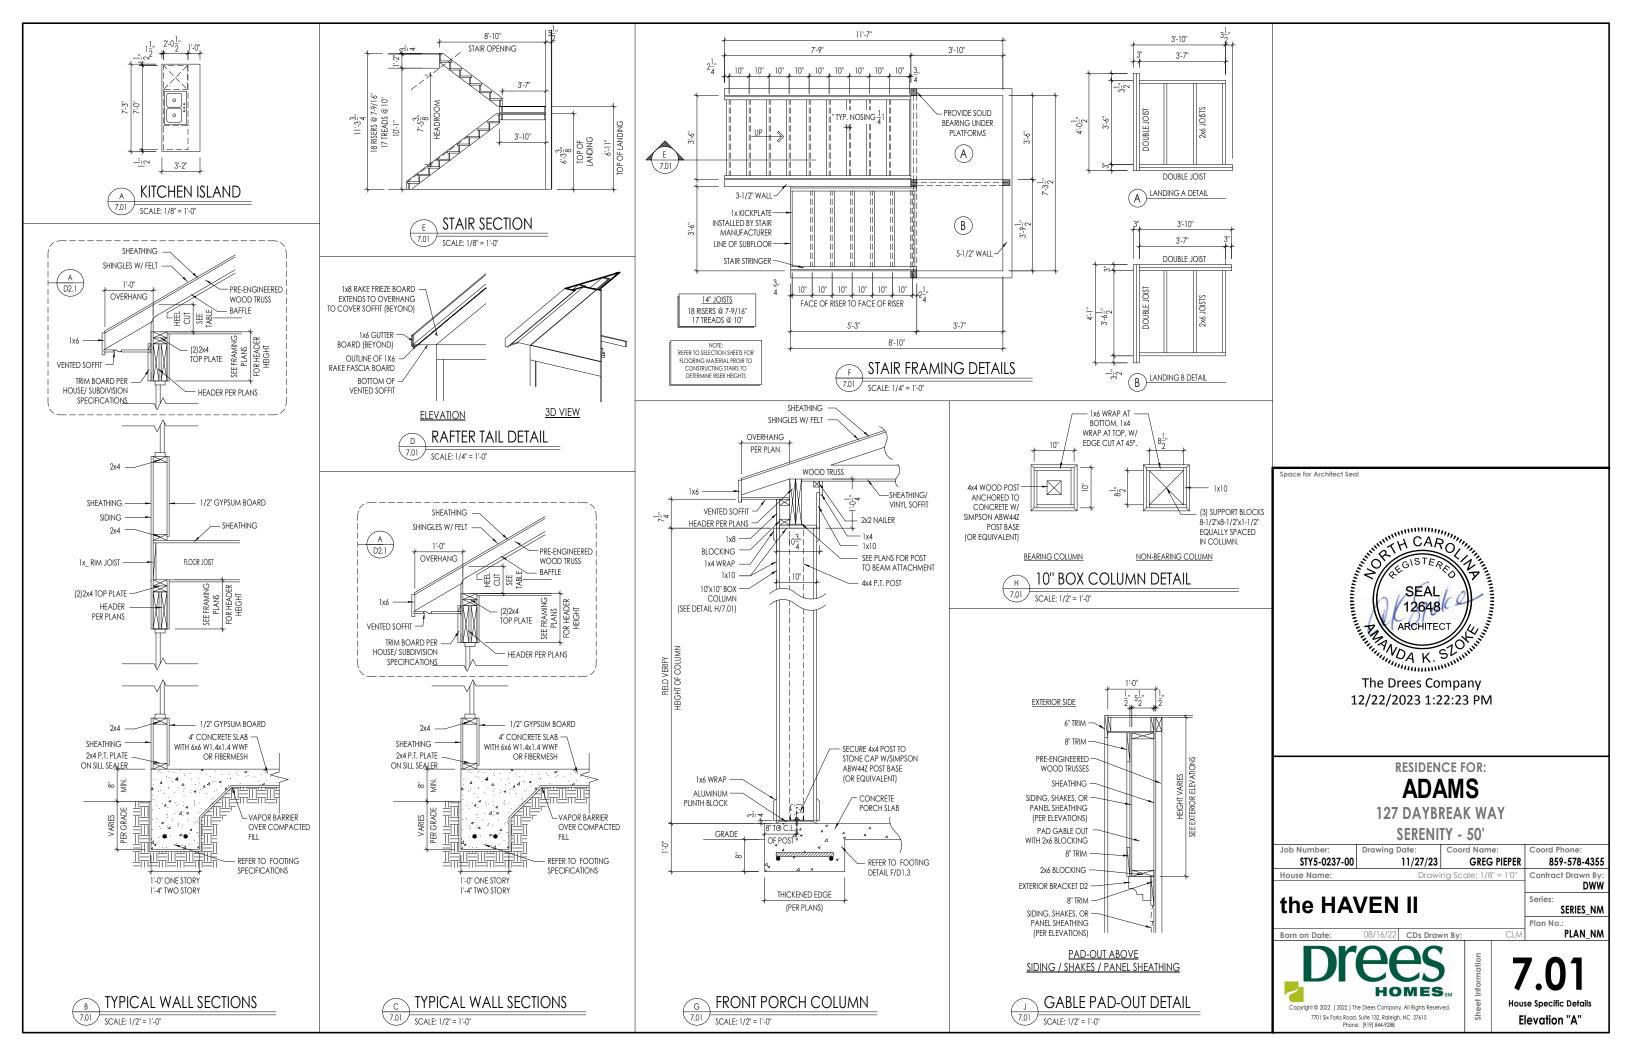
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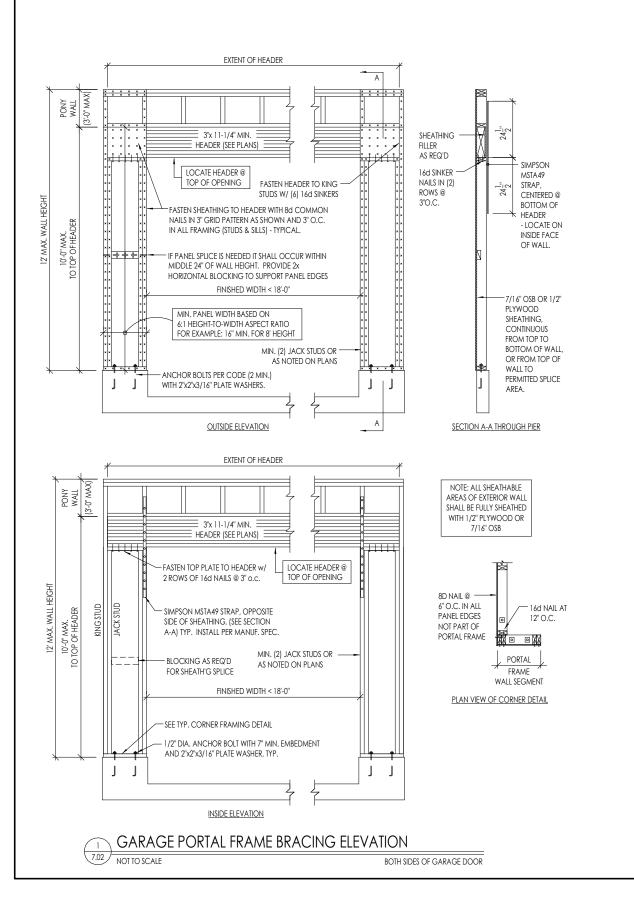
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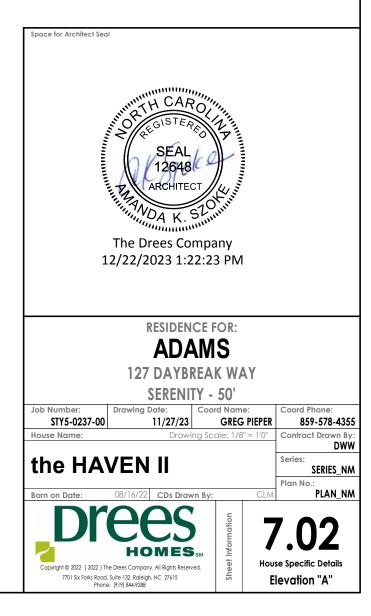
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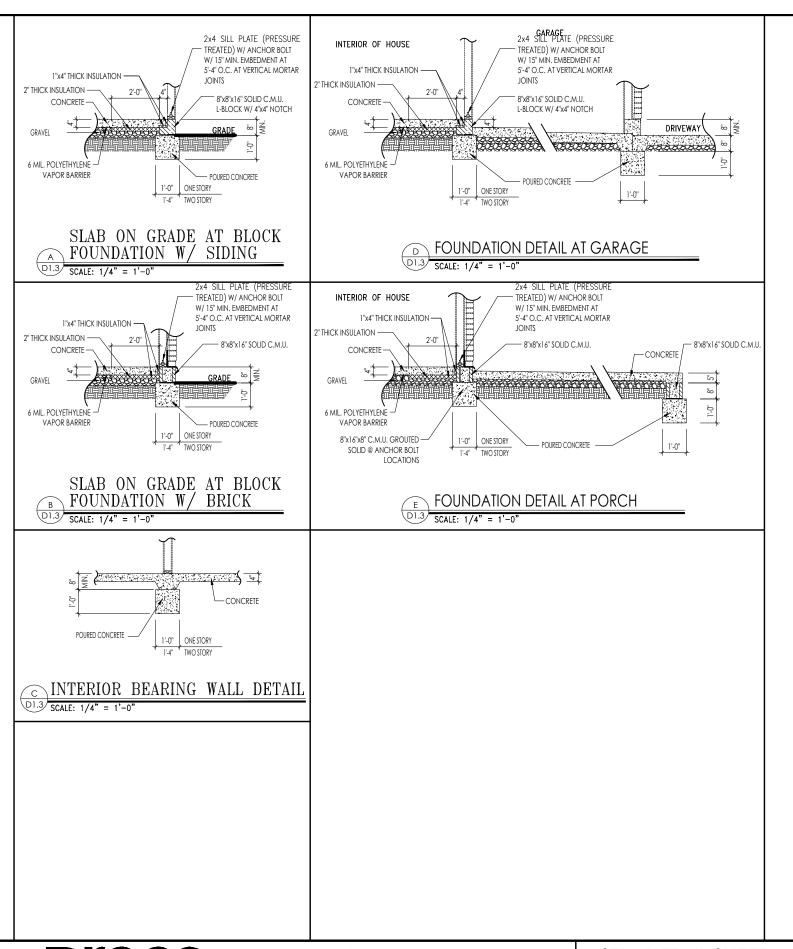
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HOMES.

Drees Homes

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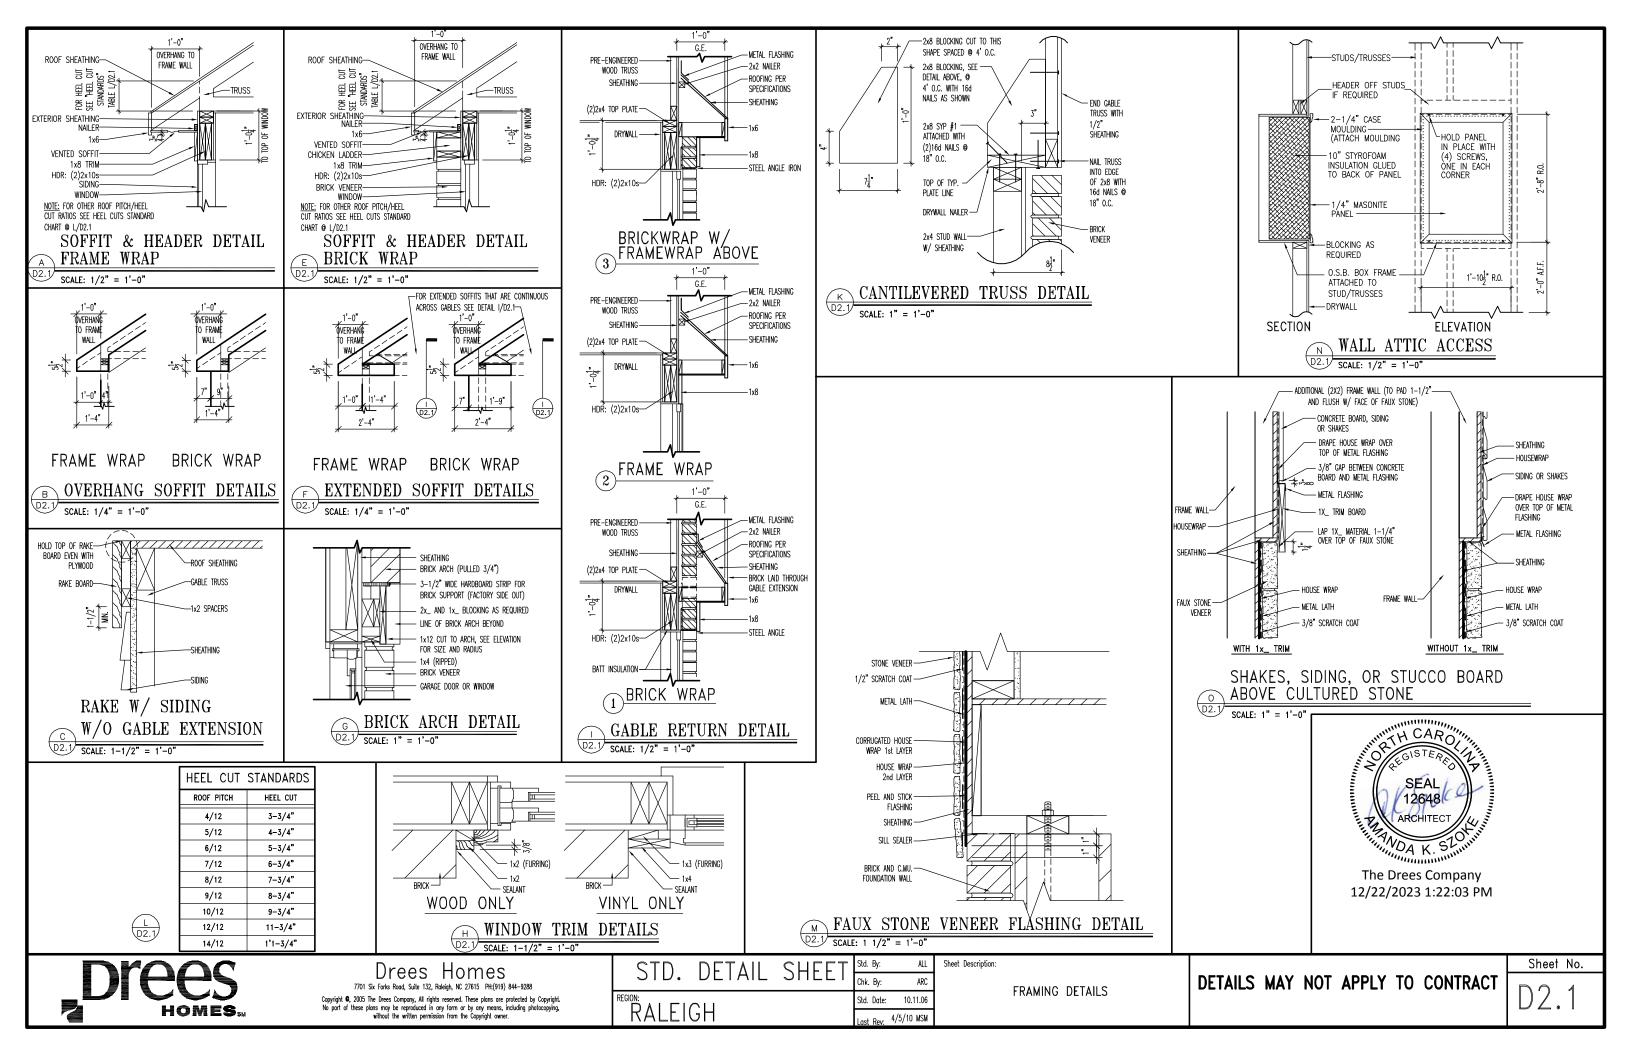
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RALEIGH	Date of	

Sheet Description:

CONC. BLOCK SLAB ON GRADE DETAILS

Sheet No. D1.3

RALEIGH - D-SHEETS.dwg Jul 31, 2023 - 4:07pm





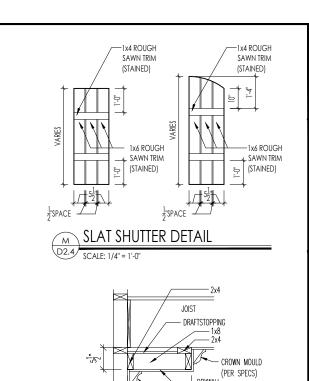
SEAL 12648 ARCHITECT

WOAK SZON

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D2.2







1'-4"

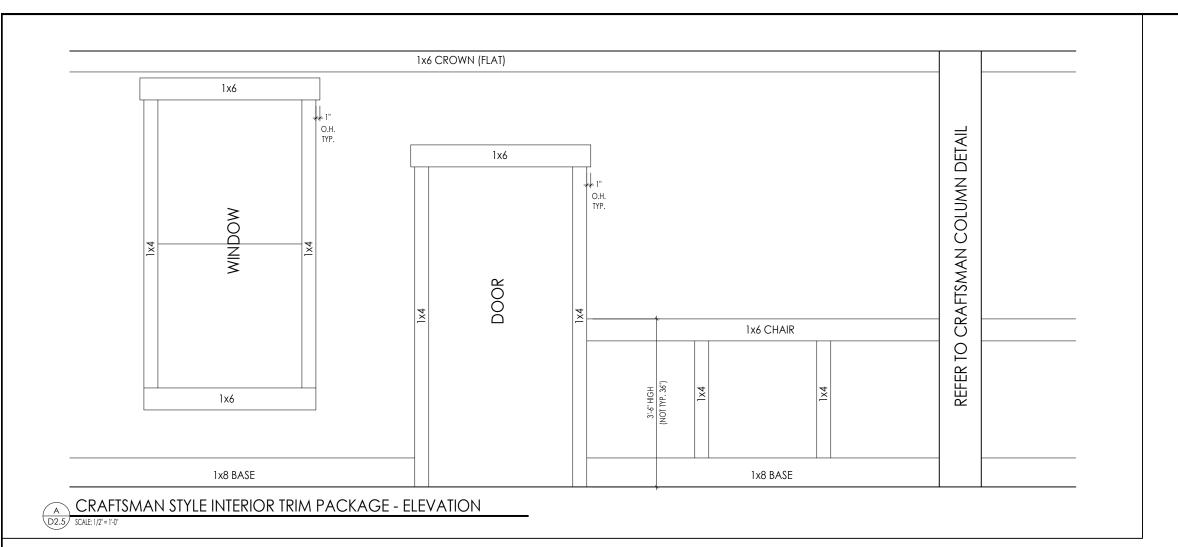
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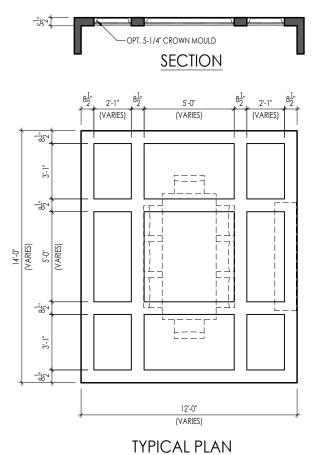


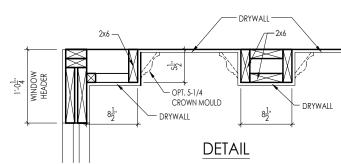
STANDARD FRAMING DETAILS
RALEIGH DIVISION
SCALE: AS NOTED

D2.5

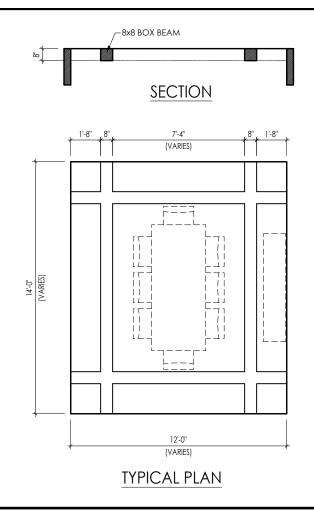


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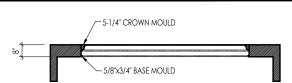


Note: Ceiling treatment details will tray down into space on enclosed rooms located on the 1st floor. On enclosed rooms on the 2nd floor, the ceiling treatment will tray up into the roof truss system. On 2-story spaces, the ceiling treatment will tray down into the space and require an appropriate sized header to capture the ceiling detail return.

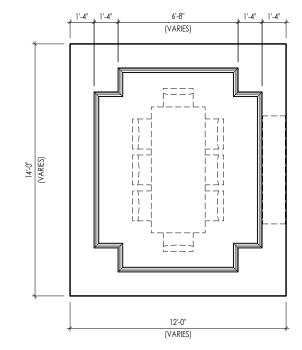


On enclosed rooms on the 2nd floor, the ceiling treatment will tray up into the roof truss system. On 2-story spaces, the ceiling treatment will tray down into the space and require an appropriate sized header to capture the ceiling detail return.

Note: Ceiling treatment details will tray down into space on enclosed rooms located on the 1st floor.



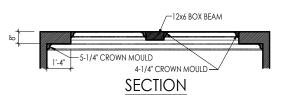
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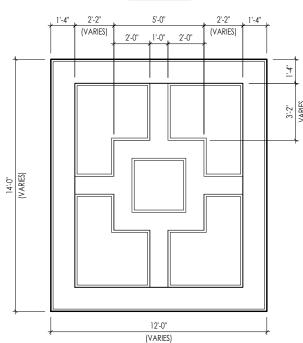


TYPICAL PLAN

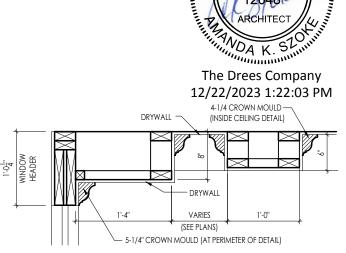


Note: Ceiling treatment details will tray down into space on enclosed rooms located on the 1st floor. On enclosed rooms on the 2nd floor, the ceiling treatment will tray up into the roof truss system. On 2-story spaces, the ceiling treatment will tray down into the space and require an appropriate sized header to capture the ceiling detail return.





TYPICAL PLAN

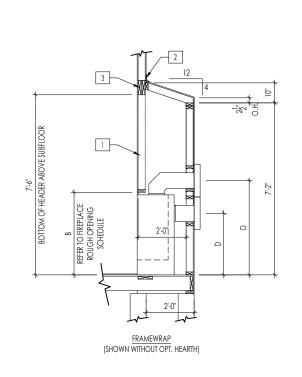


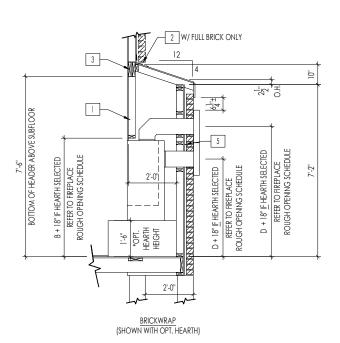
DETAIL

Note: Ceiling treatment details will tray down into space on enclosed rooms located on the 1st floor. On enclosed rooms on the 2nd floor, the ceiling treatment will tray up into the roof truss system. On 2-story spaces, the ceiling treatment will tray down into the space and require an appropriate sized header to capture the ceiling detail return.

CEILING TREATMENTS

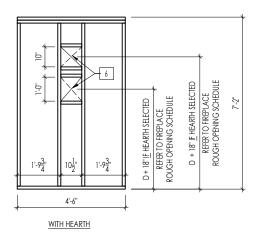
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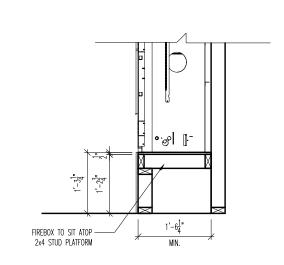


FIREPLACE DOGHOUSE SECTIONS

SCALE: 1/4" = 1'-0"

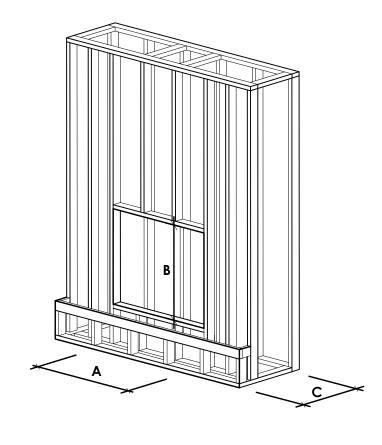


DIRECT VENT REAR WALL FRAMING



RAVE FIREPLACE PLATFORM DETAIL

SCALE: 1/2" = 1'-0"



NOTE: PROVIDE OSB SHEATHING WHEN STONE VENEER SELECTED

FIREPLACE ROUGH OPENING SCHEDULE						
	MODEL	А	В	С	D	
FIREPLACE MANUFACTURER		(FIREBOX REQUIRED WIDTH)	(FIREBOX REQUIRED HEIGHT) *ADD 18" W/ OPT. HEARTH	(FIREBOX REQUIRED DEPTH - INTERIOR REAR WALL TO FRONT EXTERIOR WALL)	(VENT CENTERLINE HEIGHT *ADD 18" W/ OPT. HEARTH	
	SLIMLINE SL-7	42"	38-1/4"	16-1/4"	TOP 40" SIDE 26-7/8"	
HEAT & GLO	COSMO 42	49"	32-3/4"	17-3/4"	TOP ONLY 47-1/16"	
	NOVUS 33	39"	34-7/8"	19-5/8"	TOP 40" SIDE 23-1/2"	
	COURTYARD 36	43-3/8"	44-1/8"	18-3/8"	SEE MANUFACTURER'S SPEC	
HEARTH & HOME	COURTYARD 42	48-1/2"	34-1/4"	20-1/4"	SEE MANUFACTURER'S SPEC	
REAKIN & NOME	LANAI *(NOT IN CINCY/NKY)	57-3/4"	39-1/2"	17-5/8"	SEE MANUFACTURER'S SPEC	
	RAVE	49"	32-3/4" *RAISED 15-1/4"*	18-1/4"	TOP ONLY 46-1/2"	
			all dimensions	are in inches	_	

General Notes

REFER TO SHEET ON.1 FOR GENERAL NOTES. VERIFY FIREPLACE MODEL AND HEARTH SELECTION WITH CUSTOMER'S SELECTIONS.

Key Notes

- 1 FUTURE FRAMING FOR F.P. OPENING AFTER INSULATION HAS BEEN INSTALLED IN EXT. WALLS
- 2 FLASHING
- 3 HEADER PER PLAN
- 4
- 5 1" AIRSPACE
- 6 BOX OUT FOR FLUE (REFER TO SELECTIONS FOR FIREPLACE AND OPENING HEIGHT)





The Drees Company 211 Grandview Drive Fort Mitchell, Kentucky 41017 PH:(859) 578-4200

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Std. Drawn By:	MRPH	Sheef Description: SC	CALE: VARIES
		FIREPLACE DETAIL	
Std. Date:	02.29.20		
Date of Last Rev:	7.10.2023	g:\architecture\cincinnati\cinti standard drawings\fireplace\fireplace detail sheets.dwg	

Sheet No.

F-1

RALEIGH WINDOW SCHEDULE

* MEETS EMERGENCY ESCAPE & RESCUE OPENING REQUIREMENTS

		MI Windows	and Doors			T				OPENING REQUIREMENTS
Drees General Callout	Window Type	Capitol Call No.	Series Rough Opening	Call No.	Rough Opening	Drees General Callout	Call No.	Rough Opening	Call No.	Rough Opening
1660	SINGLE/DOUBLE HUNG	CW3500 1/8 x 6/0		Call No.	Rough Opening		Call No.	Kough Opening	Call No.	Kough Opening
1670	SINGLE/DOUBLE HUNG	CW3500 1/8 x 7/0	20" x 84"							
1860	SINGLE/DOUBLE HUNG	CW3500 1/8 x 6/0	20" x 60-1/4"							
2030 2040	SINGLE/DOUBLE HUNG SINGLE/DOUBLE HUNG	CW3500 2/0 x 3/0 CW3500 2/0 x 4/0	24 X 36 24" x 48"							
2050	SINGLE/DOUBLE HUNG	CW3500 2/0 x 5/0	24" x 60-1/4"							
2060	SINGLE/DOUBLE HUNG	CW3500 2/0 x 6/0	24" x 72"							
2070 2430	SINGLE/DOUBLE HUNG SINGLE/DOUBLE HUNG	CW3500 2/0 x 7/0 CW3500 2/4 x 3/0	24" X 84" 28" x 36"							_
2440	SINGLE/DOUBLE HUNG	CW3500 2/4 x 4/0	28" x 48"							
2450	SINGLE/DOUBLE HUNG	CW3500 2/4 x 5/0	28" x 60-1/4"							
2460 2830	SINGLE/DOUBLE HUNG SINGLE/DOUBLE HUNG	CW3500 2/4 x 6/0 CW3500 2/8 x 3/0	28 X /2 32" x 36"							
2840	SINGLE/DOUBLE HUNG	CW3500 2/8 x 4/0	32" x 48"							
2850	SINGLE/DOUBLE HUNG	CW3500 2/8 x 5/0	32" x 60-1/4"							
* 2860 3030	SINGLE/DOUBLE HUNG SINGLE/DOUBLE HUNG	CW3500 2/8 x 6/0	32" X /2" 36-1/4" v 36"							
3040	SINGLE/DOUBLE HUNG	CW3500 3/0 x 3/0 CW3500 3/0 x 4/0	36-1/4" x 48"							
* 3050	SINGLE/DOUBLE HUNG	I CW3500 3/0 x 5/0	I 36-1/4" x 60-1/4"I							
* 3060 * 3070	SINGLE/DOUBLE HUNG SINGLE/DOUBLE HUNG	CW3500 3/0 x 6/0 CW3500 3/0 x 7/0								
* 3470	SINGLE/DOUBLE HUNG	CW3500 3/0 x 7/0	40" x 84"							
1050 FIXED		910T 5/0 x 1/0	59-5/8" x 11-1/2"							
1640 FIXED 2020 FIXED		910T 4/0 x 1/8 CW3500 2/0 x 2/0	47-1/4" x 19-1/2"							
2030 FIXED		CW3500 2/0 x 2/0 CW3500SL 2/0 x 3/	0 24" x 36"							
2040 FIXED		CW3500SL 2/0 x 4/	0 24" x 48"							
2050 FIXED		CW3500SL 2/0 x 5/								
2816 FIXED 2860 FIXED		910TSL 2/6 x 1/8 CW3500 3/0 x 6/0	29-1/4" x 19-1/2" 36" x 72"							
3016 FIXED		910TSL 3/0 x 1/8	35-1/4" x 19-1/2"							
3020 FIXED		910TSL 3/0 x 2/0	35-1/4" x 23-1/2"							
3030 FIXED 3040 FIXED		CW3500P 3/0 x 3/0 CW3500P 3/0 x 4/0	36-1/4 X 36 36-1/4" x 48"							
3050 FIXED		CW3500P 3/0 x 5/0	36-1/4" x 60-1/4"							
3060 FIXED		CW3500P 3/0 x 6/0	36-1/4" x 72"							
3070 FIXED 4010 FIXED		CW3500P 3/0 x 7/0 910T 4/0 x 1/0	36-1/4 X 84 47-1/4" x 11-1/2"							
4020 FIXED		910T 4/0 x 2/0	47-1/4" x 23-1/2"							
4030 FIXED		CW3500P 4/0 x 3/0	48" x 36"							
4040 FIXED 4044 FIXED		CW3500P 4/0 x 4/0 CW3500P 4/0 x 4/4	48 X 48 48" x 52"							
4050 FIXED		CW3500P 4/0 x 5/0	48" x 60-1/4"							
4060 FIXED		CW3500P 4/0 x 6/0	48" x 72"							
4070 FIXED 5030 FIXED		CW3500P 4/0 x 7/0 CW3500P 5/0 x 3/0								
5040 FIXED		CW3500P 5/0 x 4/0	60" x 48"							
5060 FIXED		CW3500P 5/0 x 6/0	60" x 72"							
5070 FIXED 6020 FIXED		CW3500P 5/0 x 7/0 910T 6/0 x 2/0	60" x 84" 71-5/8" x 23-1/2"							
6050 FIXED		CW3500P 6/0 x 5/0	72" x 60-1/4"							
6060 FIXED		CW3500P 6/0 x 6/0	72" x 72"							
3'-0" HALF ROUNI 4'-0" HALF ROUNI		CW3500 3/0 HC CW3500 3/0 HC	36-1/4" 48"							
5'-0" HALF ROUNI)	CW3500 3/0 HC	60"							
2020 OCTAGON		CW3500 2/0 OCT	60"							
2'-4" QUARTER RO 3'-0" QUARTER RO		CW3500 2/4 QC CW3500 3/0 QC	28" 36-1/4"		-					
J-0 QUARTER RO	סאטע	CW33003/0 QC	J 20-1/7							



Drees Homes

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Sheet Description:

WINDOW SCHEDULE

Sheet No.

MOULDED MILLWORK SCHEDULE

LAST REVISED 11/22/11

	HEADERS	
Drees General Callout	Nuwood	Fypon
ARCHED HEADER D1	H8xxEFR	N/A
ARCHED HEADER D1K	H8xxEFKR	N/A
ARCHED HEADER D2	H8xxEFTR	N/A
ARCHED HEADER D2K	H8xxEFTKR	N/A
ARCHED HEADER D3	AH10xx	WCHSEGxxX10
ARCHED HEADER D3K	N/A	WCHSEGxxX10K
ARCHED HEADER D4	AR5xx	ARxxX6M
ARCHED HEADER D4K	AR5xxK	ARxxX6MK
ARCHED HEADER D5	AR10xxEC	ARxxX6METAR6C
ARCHED HEADER D5K	AR10xxECK	ARxxX6METAR6CK
ARCHED HEADER D6	AR10xxC	ARxxX10MC
ARCHED HEADER D6K	AR10xxCK	ARxxX10MCK
ARCHED HEADER D7K	H7xxEF-4K	N/A
ARCHED HEADER D8	AR14xxC	ARxxX14MC
ARCHED HEADER D8K	AR14xxCK	ARxxX14MCK
ARCHED HEADER D9	H9xxE	WCHARSxx13
CROSSHEAD A1	H9xx	WCHxxX9N
CROSSHEAD A1K	H9xxK	WCHxxX9NK
CROSSHEAD B1	H14xxBT	WCHxxX14BT
CROSSHEAD B1K	H14xxBTK	WCHxxX14BTK
CROSSHEAD B2	H12xx	WCHxxX12
CROSSHEAD B2K	H12xxK	WCHxxX12K
CROSSHEAD C1	H18xxBT	WCHxxX14BT
CROSSHEAD C1K	H18xxBTK	WCHxxX14BTK
CROSSHEAD C2	H18xxBT-PA	LDCHxxX18
CROSSHEAD C2K	H18xxBTK-PA	LDCHxxX18K
CROSSHEAD Z-E1-HDR	Z-E1-HDR	Z-E1-HDR
CROSSHEAD Z-E2-HDR	Z-E2-HDR	Z-E2-HDR
CROSSHEAD Z-E3-HDR	Z-E3-HDR	Z-E3-HDR
CROSSHEAD Z-E3-ARCHHDR	Z-E3-ARCHHDR	Z-E3-ARCHHDR
CROSSHEAD Z-E3-CLHDR	Z-E3-CLHDR	Z-E3-CLHDR
CROSSHEAD Z-E5-HDR	Z-E5-HDR	Z-E5-HDR
WINDOW HEADER A1	H6xx	WCHxxX6
WINDOW HEADER A1K	H6xxK	WCHxxX6K
WINDOW HEADER B1	H9xx-2	WCHxxX9N
WINDOW HEADER B1K	H9xx-2K	WCHxxX9NK
WINDOW HEADER B2	H9xxBT	WCHxxX10NBT
WINDOW HEADER B2K	H9xxBTK	WCHxxX10NBTK
WINDOW HEADER C1	H9xx	CCAxxX10
WINDOW HEADER C1K	H9xxK	CCAxxX10K
WINDOW HEADER C2	H9xxT	WCHxxX9T
WINDOW HEADER C2K	H9xxTK	WCHxxX9TK
WINDOW HEADER C3	H12xxBT	WCHxxX10BT
WINDOW HEADER C3K	H12xxBTK	WCHxxX10BTK
WINDOW HEADER C4	H14xxBT	WCHxxX14BT
WINDOW HEADER D1	H7xxF-4	N/A
WINDOW HEADER DIK	H7xxF-4K	N/A
WINDOW HEADER D2K	H9xxK-1	N/A
WINDOW HEADER Z-W1	Z-W1	Z-W1
WINDOW HEADER Z-W3	Z-W3	Z-W3
WINDOW HEADER Z-W3K	Z-W3K	Z-W3K
WINDOW HEADER Z-W3D	Z-W3D	Z-W3D
WINDOW HEADER Z-W4	Z-W4	Z-W4
WINDOW HEADER Z-W4K	Z-W4K	Z-W4K
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PILASTERS						
Drees General Callout	Nuwood	Fypon				
FLUTED PILASTER A1	PL7xxF	PIL7Xxx				
FLUTED PILASTER B1	PL9xxF	PIL9Xxx				
FLUTED PILASTER C1	PL11xxFM	PIL11Xxx				
Panel Pilaster A2	PL7xxP	PIL7XxxDP				
PANEL PILASTER B2	PL9xxP	PIL9XxxDP				
Panel Pilaster C2	PL11xxPM	PIL11XxxDP				
PILASTER D1	M311-9	PIL10XxxA				
PILASTER D2	M323-9	N/A				
PILASTER Z-E1-PIL	Z-E1-PIL	Z-E1-PlL				
PILASTER Z-E2-PIL	Z-E2-PIL	Z-E2-PIL				
PILASTER Z-E3-PIL	Z-E3-PIL	Z-E3-PIL				
PILASTER Z-PIL-EXT	Z-PIL-EXT	Z-PIL-EXT				
PLAIN PILASTER A3	PL7xxS	PIL7XxxP				
PLAIN PILASTER B3	PL9xxS	PIL9XxxP				
PLAIN PILASTER C3	PL11xxS	PIL11XxxP				
PLINTH D1	PF10	ADD "P" TO END OF PILASTER				
PLINTH D2	P14.5	N/A				
	LOUVERS					

Drees General Callout	Nuwood	Fypon	Mid-America
CATHEDRAL LOUVER D1	CLV1224	CLV12X24	
CATHEDRAL LOUVER D1T	CLV1224TRIM4	CLV12X24X4F	
CATHEDRAL LOUVER D2	CLV1432	CLV14X32	
CATHEDRAL LOUVER D2T	CLV1432TRIM4	CLV14X32X4F	00 44 1422
CATHEDRAL LOUVER D3	CLV2232	CLV22X32	
CATHEDRAL LOUVER D3T	CLV2232TRIM4	CLV22X32X4F	
HALF CIRCLE LOUVER D1	HRLV32	HRLV32X16	
HALF CIRCLE LOUVER D1T	HRLV32TRIM4	HRLV32X4F	
HALF CIRCLE LOUVER D2	HRLV36	HRLV36X18	
HALF CIRCLE LOUVER D2T	HRLV36TRIM4	HRLV36X4F	00 43 2234
OCTAGONAL LOUVER D1	OLV24	OLV24	
OCTAGONAL LOUVER D12	OLV24TRIM4	OLV24X4F	
OVAL LOUVER D1	OLV2537	OLV37X25	
OVAL LOUVER DIT	OLV2537TRIM4	OLV37X25X4F	
RECTANGUAR LOUVER D1	LV1224V	LV12X24	00 45 1218
RECTANGUAR LOUVER D1T	LV1224VTRIM4	LV12X24-4F	00 45 1218
RECTANGUAR LOUVER D2	LV1636V	LV16X36	
RECTANGUAR LOUVER D2T	LV1636VTRIM4	LV16X36-4F	
RECTANGUAR LOUVER D3	LV2436V	LV24X36	
RECTANGUAR LOUVER D3T	LV2436VTRIM4	LV24X36-4F	
RECTANGUAR LOUVER D4	LV2424V	LV24X24	
RECTANGUAR LOUVER D4T	LV2424VTRIM4	LV24X24-4F	
ROUND LOUVER D1	RLV18	RLV18	
ROUND LOUVER D1T	RLV18TRIM4	RLV18X4F	
ROUND LOUVER D2	RLV22	RLV22	
ROUND LOUVER D2T	RLV22TRIM4	RLV22X4F	
TRIANGULAR LOUVER D1		TRLVxxX36	00 47 0x0x
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BRACKETS

Drees General Callout	Nuwood	Fypon
EXTERIOR BRACKET D1	BR437	N/A
EXTERIOR BRACKET D2	DB102	DTLB6X4X6
EXTERIOR BRACKET D3	BR304 (7" WIDE)	BKT24X24X7
EXTERIOR BRACKET D4	BR455	N/A
EXTERIOR BRACKET D5	BR300-1	BKT12X12X6
EXTERIOR BRACKET D6	BR300	BKT12X12
EXTERIOR BRACKET D7	BR409	BKT16X18X3
EXTERIOR BRACKET D8	BR413	DTLB5X5X3
EXTERIOR BRACKET D9	TBD	BKT11X20
EXTERIOR BRACKET D10	TBD	BKT12X24X3
EXTERIOR BRACKET D11	BR435	BKT25X27
EXTERIOR BRACKET D12	BR404	BKT16X30X4
EXTERIOR BRACKET D13	BR23.13x10.13x5.5	N/A
GABLE BRACKET D1	TBD	DTLB6X4X6R(OR L)PITCH
GABLE BRACKET D2	BR423-x:12	BKT5X20
GABLE BRACKET D3	BR424-x:12	BKT5X20 (CUT 2" PROJECTION)
		•

MOULDINGS						
Drees General Callout	Nuwood	Fypon				
BAND MOULD D1	M210-16	MLD612-12				
BAND MOULD D2	M301-16	MLD220-16				
BARGE MOULD D1	WM210	WM210				
CASE MOULD D1	M320-16	MLD226-16				
CASE MOULD D2	N/A	MLD244-12				
CROWN MOULD D1	M404-16	MLD572-16				
DENTIL MOULD D1	M105-16	MLD310-16				
DENTIL MOULD D2	M108-8	MLD353-8				
HALF ROUND MOULD D1	N/A	MLD605-12				
PANEL MOULD D1	M310-8 OR 16	MLD612-12				

PEDIMENTS / COMBO HEADERS

Drees General Callout	Nuwood	Fypon
BROW COMBO D1	BCxx	CSAPxx
PEAK PEDIMENT D1	Pxx-4 (6:12)	PCPxx
PEAK PEDIMENT Z-E1-PED	Z-E1-PED	Z-E1-PED
PEAKED COMBO D1	PCxx-4	CPCPxx
RAMS HEAD PEDIMENT D1	Rxx	RHPxx00
ROUND PEDIMENT D1	Bxx-4	PSPxx
SUNRISE COMBO D1	SCxx-4	CSPxx
VICTORIAN PEDIMENT D1	VPxx	DVPxx w/ SWDHxxXxx
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WINDOW DECORATION

Drees General Callout	Nuwood	Fypon
HALF CIRCLE SUNBURST D1	SPxxxx	SWDHxxXxx
PALLADIAN WINDOW D1	H9AR10-xx xx" FL/FR	ARxxX10MFLxxx
PALLADIAN WINDOW D1K	H9AR10-xxK xx" FL/FR	ARxxX10MFLxxx with K10TM
PALLADIAN WINDOW D2	H9AR10SPxxxx	ARxxX10MFLxxx with
		SWDHxxXxx
PALLADIAN WINDOW D2K	H9AR10SPxxxxK	ARxxX10MFLxxx with
		SWDHxxXxx and K10TM
PEAKED CAP HEADER D1	N/A	CHPCxxX15
PLAIN SEGMENT D1	SPxxxxP	PSPxx
SEGMENT SUNBURST D1	SPxxxx	SWDHxxXxx

ACCESSORIES

Drees General Callout	Nuwood	Fypon
GABLE D1	PGDx12	GPA (width X height)
KEYSTONE D1	KY14F-3	KY14
KEYSTONE D2	КҮНМ9F	К9М
WREATH D1	N/A	WAB34



MOULDED MILLWORK SCHEDULE

Sheet No.