

may occur since every home that is built has it's own set of unique construction problems that must be dealt with as the home is being built.

Date:

Customer: _

HOMES_{SM}

Elevation "D"

8521 Six Forks Road, Suite 500, Raleigh, NC 27615 Phone: [919] 844-9288

2. XXX 2. XXX 2. XXX 3. XXX 3. XXX 3. XXX 4. XXX 4. XXX 4. XXX

Items drawn on any drawings and not written in the contract selctions **WILL NOT** be included in the site specific drawings.

. XXX

Reason For Modification:

. XXX

Architecture Plan Review:

Customer Request:

1. XXX

2. XXX

3. XXX

4. XXX

☑ No Comments

☐ See Comments

Design Solution:

. XXX

GENERAL NOTES - RALEIGH

FOUNDATION NOTES

CRAWL SPACES:

- SLOPE CONCRETE SLAB 4" MINIMUM TOWARDS GARAGE DOOR

- EXTERIOR FLATWORK/GARAGES SHALL HAVE A MINIMUM CONCRETE SRENGTH OF 4.500 PSI

FOOTINGS TO A MINIMUM CONCRETE STRENGTH OF 2500 PSI, UNLESS OTHERWISE NOTED

ASSUMED ALLOWABLE SOIL BEARING PRESSURE: 2,000 p.s.f.

WATERPROOF FOUNDATION WITH BITUMINOUS SPRAY.

WALL TIES EMBEDDED IN THE HORIZONTAL MORTAR JOINT SHALL BE 16" ON CENTER, TIES IN ALTERNATE COURSES SHALL

BE STAGGERED, THE MAXIMUM VERTICAL DISTANCE BETWEEN TIES SHALL NOT EXCEED 16" AND THE MAXIMUM HORIZONTAL DISTANCE SHALL NOT EXCEED 16" ADDITIONAL TIES SHALL BE PROVIDED AT ALL OPENINGS, AND WITHIN 12"

CORE FILL ENTIRE BLOCK WALL WHEN THE WALL IS 4'-0" TALL OR HIGHER. INSTALL #4 REBAR IN EACH HOLLOW AREA OF

EACH BLOCK FROM FOOTING TO TOP OF WALL, ON THE ENTIRE WALL PRIOR TO CORE FILLING IT. TOP COURSE OF BLOCK ON ALL WALLS WILL BE FILLED SOLID WITH MORTAR PLACING THE FOUNDATION STRAPS OR

BOLTS IN THE MORTAR 6'-0" ON CENTER, AND 12" FROM EACH CORNER.

- 12"x16" PIERS: HOLLOW MASONRY UP TO 48" HIGH, SOLID MASONRY UP TO 9"0" HIGH 16"x16" PIERS: HOLLOW MASONRY UP TO 64" HIGH, SOLID MASONRY UP TO 12'0" HIGH

BLOCK PIERS SHOULD BE PLACED DIRECTLY ON CONCRETE FOOTINGS PER PLAN. THEY SHOULD BE PLUMBED AND SQUARE WITHIN 1/4"

- SILL PLATES TO BE A MINIMUM OF 2x4 NOMINAL LUMBER.

FRAMING NOTES

DESIGN LOADS:

FLOORS: 40 psf LIVE LOAD + 10 psf DEAD LOAD = 50 psf ROOF: 18 psf LIVE LOAD + 17psf DEAD LOAD = 35 psf

DESIGN DEFLECTION LIMITS (BASED ON LIVE LOAD, EXCEPT MASONRY): RAFTERS GREATER THAN 3:12 L/180

MASONRY VENEER L/600 NOMINAL LUMBER FLOORS: L/360

MANUFACTURED WOOD FLOORS: DESIGNED TO MINIMUM PRO RATING OF 35 (OR EQUIVALENT). NO MORE THAN 8 POINT DIFFERENCE BETWEEN ADJACENT SPANS.

L/480 FOR SPANS UP TO 16'-0" AND NO GREATER THAN 1/2" DEFLECTION

WIND SPEED: 120 MPH

CEILINGS

GARAGE FLOOR: 50 psf LIVE LOAD

L/240

L/600 FOR SPANS OVER 16'-0" IF SIMPLE SPAN AND NO GREATER THAN 1/2" DEFLECTION L/840 FOR SPANS OVER 16'-0" IF CONTINUOUS SPAN. AND NO GREATER THAN 1/2" DEFLECTION

SEISMIC: "A" & "B"

19.2" o.c. MAXIMUM SPACING JOIST SPACING:

DOUBLE EVERY OTHER FLOOR JOIST UNDER KITCHEN ISLANDS

INSTALL UNCOUPLING MEMBRANE IN TILE FLOOR AREAS IF 19.2" O.C. FLOOR JOIST SPACING

GLUE AND MECHANICALLY FASTEN [SCREWS] WOOD FLOOR IF 19.2" o.c. FLOOR JOIST SPACING

MANUFACTURED WOOD PRODUCTS (INCLUDING, BUT NOT LIMITED TO, STRUCTURAL WOOD BEAMS AND I-JOISTS) SHALL BE FABRICATED. HANDLED, AND INSTALLED IN ACCORDANCE WITH THE MANUFACTURER'S INSTRUCTIONS.

-JOISTS ARE NOT TO BE PLACED DIRECTLY OVER INTERIOR PARALLEL WALLS. (TO PREVENT UNEVEN FLOOR DEFLECTION FROM OCCURRING)

ALL WOOD BEAMS/HEADERS: 2x6's TO BE SPF STUD GRADE OR BETTER/ 2x8 OR LARGER TO BE SYP #2 [PER NDS 2012] OR BETTER, U.O.N.

ALL HEADERS SHALL BE SUPPORTED BY (1) 2x JACK STUD AND (1) 2x KING STUD MINIMUM. THE NUMBER OF STUDS SPECIFIED AT A SUPPORT INDICATES THE NUMBER OF JACKS REQUIRED, U.N.O. AT FLUSH OR DROPPED BEAMS, THE NUMBER OF STUDS SPECIFIED INDICATES THE TOTAL NUMBER OF STUDS REQUIRED TO SUPPORT THE BEAM

EXTERIOR WALLS TO BE 2x4 SPF STUD GRADE AT 16" O.C. UNLESS OTHERWISE NOTED (10'4-1/2" MAXIMUM WALL HEIGHT)

ALL INTERIOR BEARING WALLS AND WALLS AT BASEMENT & FIRST FLOOR STAIRWELLS, KITCHEN, BATH, & GARAGE TO BE 2x4 SPF STUD GRADE @ 16" o.c.; ALL OTHER NON-BEARING INTERIOR WALLS TO BE 2x4 SPF STUD GRADE @ 24" o.c. U.O.N.

ALL WALLS TO BE 3 1/2" UNLESS OTHERWISE NOTED.

PROVIDE SOLID BEARING TO FOUNDATION OR BEAM BELOW FOR ALL BEAMS, HEADERS & GIRDER TRUSSES. PROVIDE BLOCKING BETWEEN JOISTS AS REQUIRED.

SEE SELECTION SHEET FOR SIZE AND STYLE OF FIREPLACE. SEE FIREPLACE ELEVATION DETAIL FOR ADDITIONAL FRAMING REQUIREMENTS, IF ANY. CHECK SELECTION SHEETS FOR FLOOR COVERING AT TOP AND BOTTOM OF STAIR RISERS AND ADJUST RISERS AS REQ'D.

PROVIDE BLOCKING AT ALL HANDRAIL TERMINATION AND BRACKET LOCATIONS.

20-MINUTE FIRE RATED DOOR BETWEEN GARAGE AND LIVING AREA.

EXTERIOR WALL TO BE 2x4 SPF STUD G AT 16" o.c., UNLESS OTHERWISE NOTED (10'-0" MAXIMUM UNBRACED WALL HEIGHT).

ALL EXTERIOR WALLS AND INTERIOR BEARING WALLS, FRAMED HIGHER THAN THE STANDARD PLATE HEIGHT, SHALL BE FRAMED WITH CONTINUOUS FULL HEIGHT STUDS TO THE HIGHEST CEILING (I.E. NO INTERMEDIATE BREAKS) TO PREVENT LATERAL HINGE CONDITIONS.

IN THE GARAGE, PROVIDE 1/2" GYP. BOARD AT ALL WALLS COMMON TO LIVING SPACE AND ALL STRUCTURAL MEMBERS SUPPORTING FLOOR/CEILING ASSEMBLY. GARAGE CEILING TO BE 1/2" SAG RESISTANT GYP. BOARD WHEN THERE ARE NO HABITABLE SPACES ABOVE, OR 5/8"

TYPE X GYP. BOARD WHEN HABITABLE SPACES ARE ABOVE. ALL EMERGENCY ESCAPE & RESCUE OPENINGS TO BE A MAXIMUM OF 44" OFF OF FINISHED FLOOR AND HAVE MINIMUM OPENING DIMENSIONS OF 24" IN HEIGHT, 20" IN WIDTH, & HAVE A MINIMUM OPENING AREA OF 5.7 S.F.

ALL DOORS TO BE 6'-8" TALL UNLESS OTHERWISE NOTED.

ALL GLASS IN INTERIOR AND EXTERIOR DOORS TO BE TEMPERED (INCLUDING SIDELITES AND TRANSOMS)

ALL LUMBER CONTACTING CONCRETE TO BE PRESSURE TREATED.

ALL FASTENERS, HANGERS, AND OTHER CONNECTORS TO BE USED WITH PRESSURE TREATED WOOD ARE TO HAVE ZMAX COATING (OR EQUIVALENT) HOT-DIPPED GALVANIZED OR STAINLESS STEEL.

AT STAIR HANDRAIL, ON ONE SIDE ONLY, SHALL BE CONTINUOUS FOR THE ENTIRE LENGTH OF THE STAIRWAY, AND ENDS SHALL BE RETURNED TO A WALL OR POST. THE HANDRAIL MAY BE INTERRUPTED AT A NEWEL POST AT A TURN.

ALL HANDRAIL GRIP PORTIONS SHALL NOT EXCEED 2-1/4" IN CROSS SECTIONAL DIMENSION.

HANDRAILS SHALL BE INSTALLED ON ALL STAIRS WITH 2 OR MORE RISERS, HANDRAIL HEIGHTS SHALL BE A MINIMUM OF 34" AND A MAXIMUM OF 38".

ALL STAIRS TO BE CONSTRUCTED SO AS NOT TO ALLOW A 4" SPHERE TO PASS THROUGH THE RISER.

GUARDRAILS MUST BE A MINIMUM OF 36" HIGH. GUARDRAILS AT THE OPEN SIDES OF STAIRS MUST BE A MINIMUM OF 34" HIGH MEASURED VERTICALLY

FROM THE NOSING AT THE TREADS. THE HORIZONTAL SPACING OF THE VERTICAL BALUSTERS SHALL BE 4" O.C.

- GUARDRAIL DESIGN TO RESIST A MINIMUM OF 200 LBS LATERAL FORCE

BASEMENTS:

- SLOPE CONCRETE SLAB 4" MINIMUM TOWARDS GARAGE DOOR

- EXTERIOR FLATWORK/GARAGES SHALL HAVE A MINIMUM CONCRETE SRENGTH OF 4 500 PSI

- FOOTINGS TO A MINIMUM CONCRETE STRENGTH OF 2500 PSI, UNLESS OTHERWISE NOTED- ALL FOUNDATION WALLS TO BE CAST IN PLACE CONCRETE 3000 PSI MIN. UNLESS OTHERWISE NOTED.

- BASEMENT WINDOW LOCATIONS MAY VARY FROM DRAWING DUE TO LOT CONDITIONS.

- BACKFILL ADJACENT TO FOUNDATION WALLS SHALL NOT BE PLACED UNTIL THE WALL HAS SUFFICIENT STRENGTH AND HAS BEEN ANCHORED TO THE FLOOR OR HAS BEEN SUFFICIENTLY BRACED TO PREVENT DAMAGE BY THE BACKFILL.

- ASSUMED ALLOWABLE SOIL BEARING PRESSURE: 2 000 p.s.f.

- WATERPROOF FOUNDATION WITH BITUMINOUS SPRAY.

- VERTICAL CONTROL JOINTS IN BASEMENT FOUNDATION WALLS - STANDARD LOCATION GUIDELINES:

1) PLACE A CONTROL JOINT IN ALL UNBRACED WALLS OVER 30' IN LENGTH. (NOTE: "T" WALLS AND CORNERS COUNT AS A BRACE)

2) WINDOWS THAT ARE LARGER THAN THE STANDARD BASEMENT WINDOW REQUIRE A CONTROL JOINT.

3) CONTROL JOINTS ARE NOT REQUIRED AT EVERY WINDOW THAT IS STANDARD

4) IF THERE IS A STANDARD WINDOW LOCATED IN A WALL SEGMENT THAT REQUIRES A CONTROL JOINT, THEN THE CONTROL JOINT SHOULD BE PLACED ON THE SIDE OF THE WINDOW THAT IS ADJACENT TO THE LONG SIDE OF THE WALL. IF THERE IS MORE THAN ONE WINDOW IN A WALL THEN ONLY ONE WINDOW SHOULD HAVE A CONTROL JOINT.

5) DOORS DO NOT GET CONTROL JOINTS.

6) CONTROL JOINTS SHOULD NOT BE LOCATED WITHIN 3' OF A BEAM POCKET.

7) CONTROL JOINTS ARE REQUIRED AT THE FIRST AND LAST STEP DOWN AT STEPPED BASEMENT FOUNDATION WALLS.

- INTERIOR FLATWORK SHALL HAVE A MINIMUM CONCRETE STRENGTH OF 3.000

- ALL VERTICAL STEEL AND ALL STEEL IN STRUCTURAL SLABS TO BE GRADE 60. ALL HORIZONTAL STEEL IN FOUNDATION WALLS AND FOOTERS TO BE GRADE 40 STEEL. **SLAB ON GRADE:**

- ALL CONCRETE SLABS ON GRADE SHALL BE THE THICKNESS AS INDICATED ON THE DETAILS OVER MINIMUM 6 MIL. POLYETHYLENE (VISQUEEN) VAPOR BARRIER, SLABS SHALL BE REINFORCED WITH 6x6 W1 4 WWE LAPPED 8" AT EDGES AND ENDS IN

CONFORMANCE WITH ASTM-A 185, OR FIRERMESS REINFORCEMENT SHALL BE LISED WITH A MINIMUM FIBER LENGTH OF $\frac{1}{2}$ TO 2 $\frac{1}{4}$ COMPLYING WITH ASTM C 1116. THE DOSAGE AMOUNT SHALL BE 0.75 TO 3.0 POUNDS PER CUBIC YARD IN ACCORDANCE 2/OITAG//AMMOOSS 2'SSRIIT ASII/AM HTIW

- SLABS ON GRADE SHALL BEAR ON STRUCTURAL FILL WHICH SHALL BE CLEAN SAND FREE OF DEBRIS AND OTHER DELETERIOUS MATERIAL, STRUCTURAL FILL SHALL BE COMPACTED TO A DENSITY OF AT LEAST 95% OF THE MODIFIED PROCTOR MAXIMUMN DRY DENSITY (ASTM D1557). TERMITE PROTECTION SHALL BE PROVIDED IN ACCORDANCE WITH APPLICABLE CODE REQUIREMENTS. IF SOIL TREATMENT IS USED. THE TREATMENT SHALL BE DONE AFTER ALL EXCAVATION, BACKFILLING, AND COMPACTION IS COMPLETED.

- FOOTINGS MAY BEAR UPON UNDISTURBED SOIL OR UPON STRUCTURAL FILL, STRUCTURAL FILL SHALL BE COMPACTED TO A DENSITY OF AT LEAST 95% OF THE MODIFIED PROCTOR MAXIMUMN DRY DENSITY (ASTM D1557) FOR A DEPTH OF AT LEAST TWO FEET (2'-0") BELOW THE BOTTOM OF THE FOOTING.

- THE FOLLOWING MINIMUM CONCRETE COVER SHALL BE PROVIDED FOR REINFORCEMENT:

3" CONCRETE CAST AGAINST AND PERMANENTLY EXPOSED TO EARTH

2" CONCRETE EXPOSED TO EARTH AND WEATHER 1" CONCRETE NOT EXPOSED TO EARTH OR WEATHER

- SLOPÉ CONCRETE SLAB 4" MINIMUM TOWARDS GARAGE DOOR

- EXTERIOR FLATWORK/GARAGES SHALL HAVE A MINIMUM CONCRETE SRENGTH OF 4,500 PSI

- ASSUMED ALLOWABLE SOIL BEARING PRESSURE: 2,000 p.s.f.

- INTERIOR FLATWORK SHALL HAVE A MINIMUM CONCRETE STRENGTH OF 3.000 PSI.

- ALL STEEL IN STRUCTURAL SLABS TO BE GRADE 60. ALL HORIZONTAL STEEL IN FOUNDATION WALLS AND FOOTERS TO BE GRADE 40 STEEL

MECHANICAL/ELECTRICAL NOTES

- ANY GAS APPLIANCES MUST BE INSTALLED PER MANUFACTURER'S SPECIFICATIONS.

- HOLD THE CENTERLINE OF ALL EXTERIOR LIGHT FIXTURES AT 5'-8" OFF BOTTOM OF DOOR OPENING.

- ALL KITCHEN CABINET DIMENSIONS ARE CABINET TO CABINET.

- CABINET STYLES MAY VARY FROM INTERIOR ELEVATIONS DEPENDING ON STYLE, MANUFACTURER, ETC. FOR CABINET DETAILS SEE SHOP DRAWINGS

- CABINET SIZES MAY VARY WITH FULL-OVERLAY CABINETS. - GROUND FAULT INTERRUPTER (GFCI) OUTLETS TO BE INSTALLED PER NEC 2017, SECT. 210.8

(2x4)

- PROVIDE HOSE BIBS PER DIVISION SPEC. SHEET. EXACT LOCATION TO BE FIELD DETERMINED UNLESS OTHERWISE NOTED ON THE PLANS.

- MIN. 50 C.F.M. FOR ALL EXHAUST FANS IN BATHROOMS

INSULATION DETAILS

EXTERIOR STUD WALL CAVITY: R-19

R-19

FLOOR JOIST CAVITY AT CANTILEVER: (OVER HORIZONTAL SPACE) OVER GARAGE: (SLOPED AND VERTICAL SPACE) R-38 BATT

FLOOR JOIST CAVITY AT STANDARD PERIMETER:

R-19 R-38 BLOWN

R-15

ELEVATION NOTES

- WINDOW STYLE AND MULLIONS MAY VARY FROM ELEVATION DEPENDING UPON MANUFACTURER, STYLE, PATTERN, TYPE, ETC.

- USE SECONDARY HEAT BARRIER ON ALL DIRECT VENT FIREPLACES 7' OR LESS ABOVE A WALKWAY

- Grade away from foundation walls shall fall a minimum of 6" within the first 10'.

- PROVIDE TYVEK OR EQUIVALENT HOUSE WRAP BEHIND BRICK AND STONE VENEER OVER WOOD SHEATHING.

PROVIDE BRICK WEEP HOLES AT 24" O.C. WITH BRICK VENEER AND MORTER NET BEHIND AND THROUGH WEEP HOLES. PROVIDE FLASHING AND WEEP HOLES ABOVE ALL BRICK ANGLE IRONS, BELOW ALL BRICK SILLS AND ABOVE SILL PLATE SEALERS.

- EXTERIOR STEPS TO HAVE A MAXIMUM 8" RISER. WHEN VERTICAL RISE EXCEEDS 30" OR FOUR OR MORE CONTINUOUS RISERS. A

HANDRAIL IS REQUIRED

ROOF PLAN NOTES

- ALL OVERHANGS TO HAVE (2) SOFFIT VENTS PER EACH 8' SOFFIT SECTION.

- PROVIDE BAFFLES AT EXTERIOR TRUSS BEARING FOR VENTILATION.

PROVIDE 15# FELT PAPER LINDER SHINGLES



The Drees Company 12/22/2023 1:11:35 PM

VOA K

RESIDENCE FOR:

MODEL

TOBACCO ROAD

Job Number TBRD-0001-00 House Name:

Born on Date:

Space for Architect Seal

Coord Name 11/16/23 **GREG PIEPER**

the PARKETTE

07/11/23 CDs Drawn By

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Elevation "D"

Coord Phone

Series

Plan No


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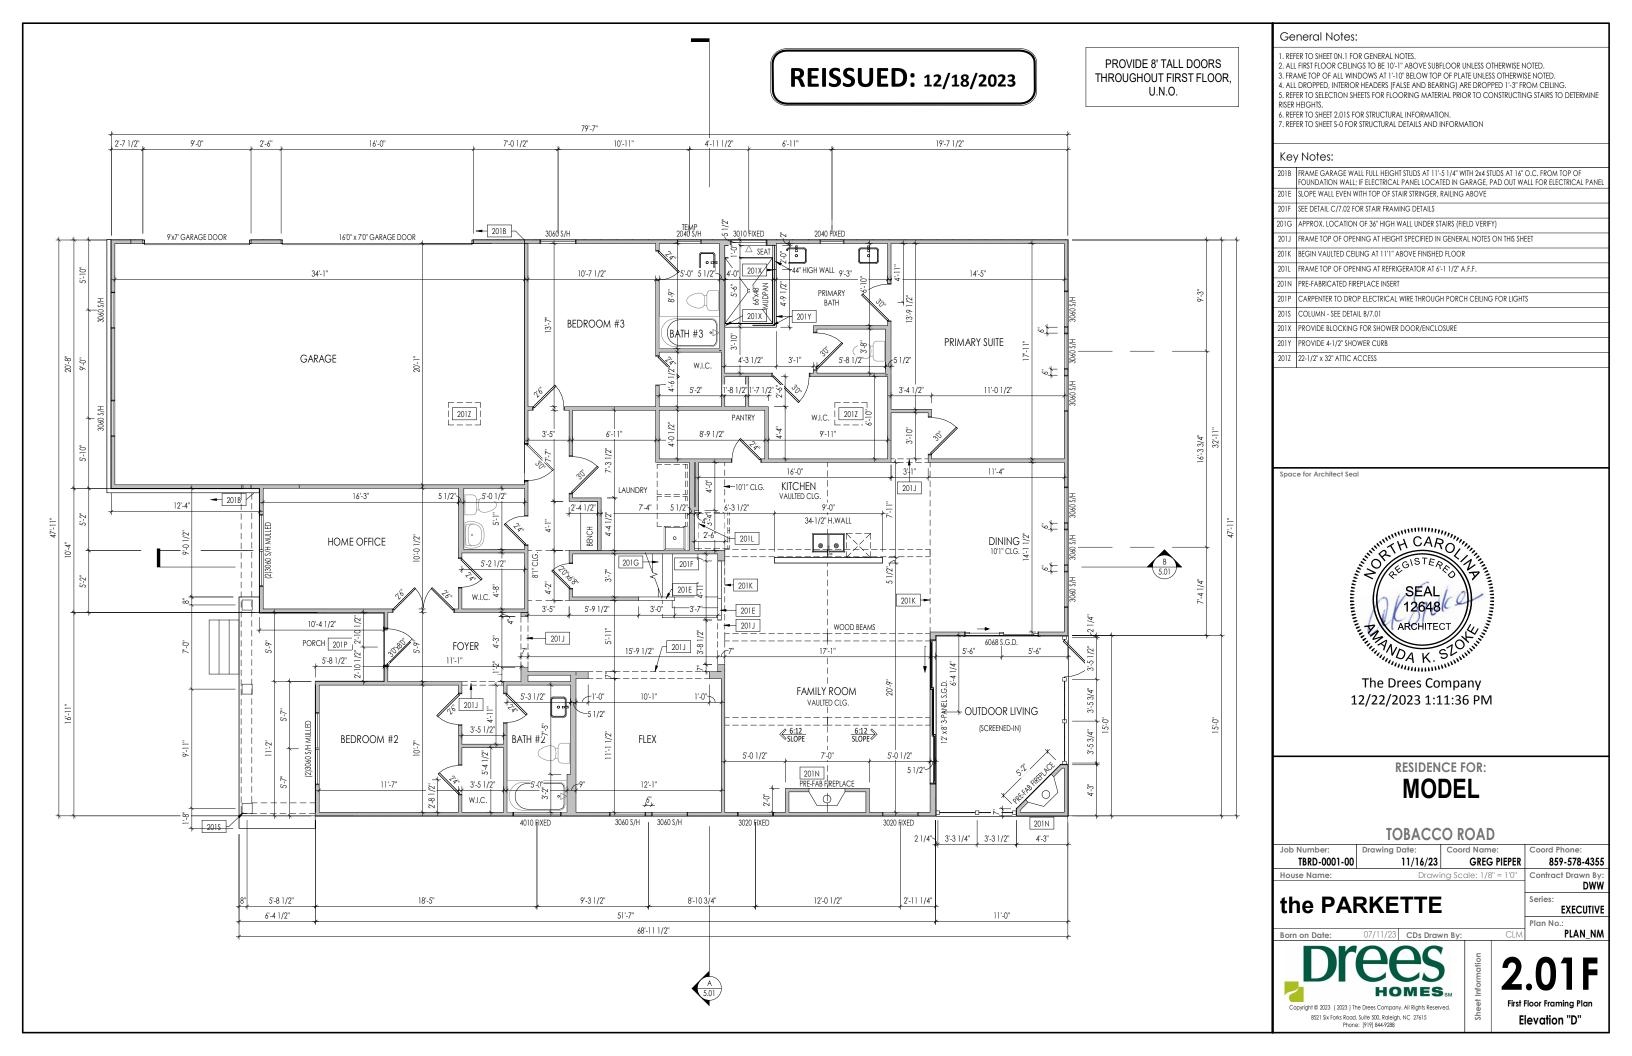
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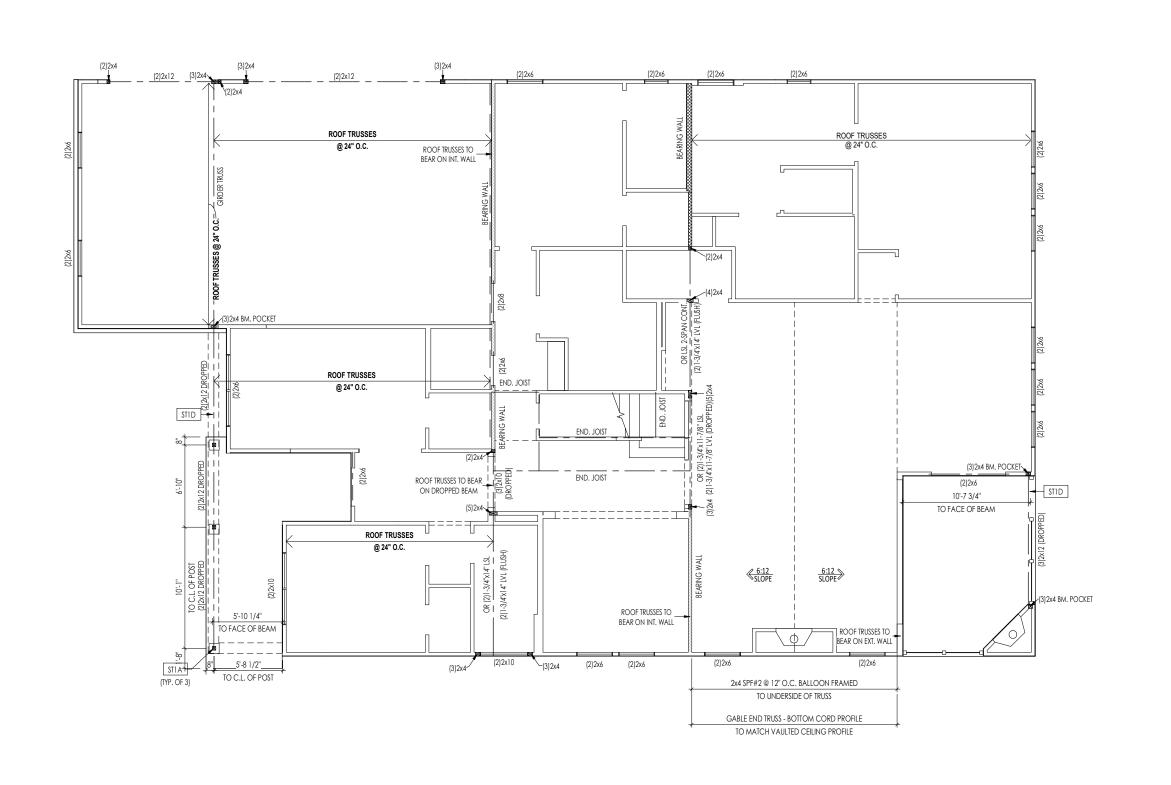
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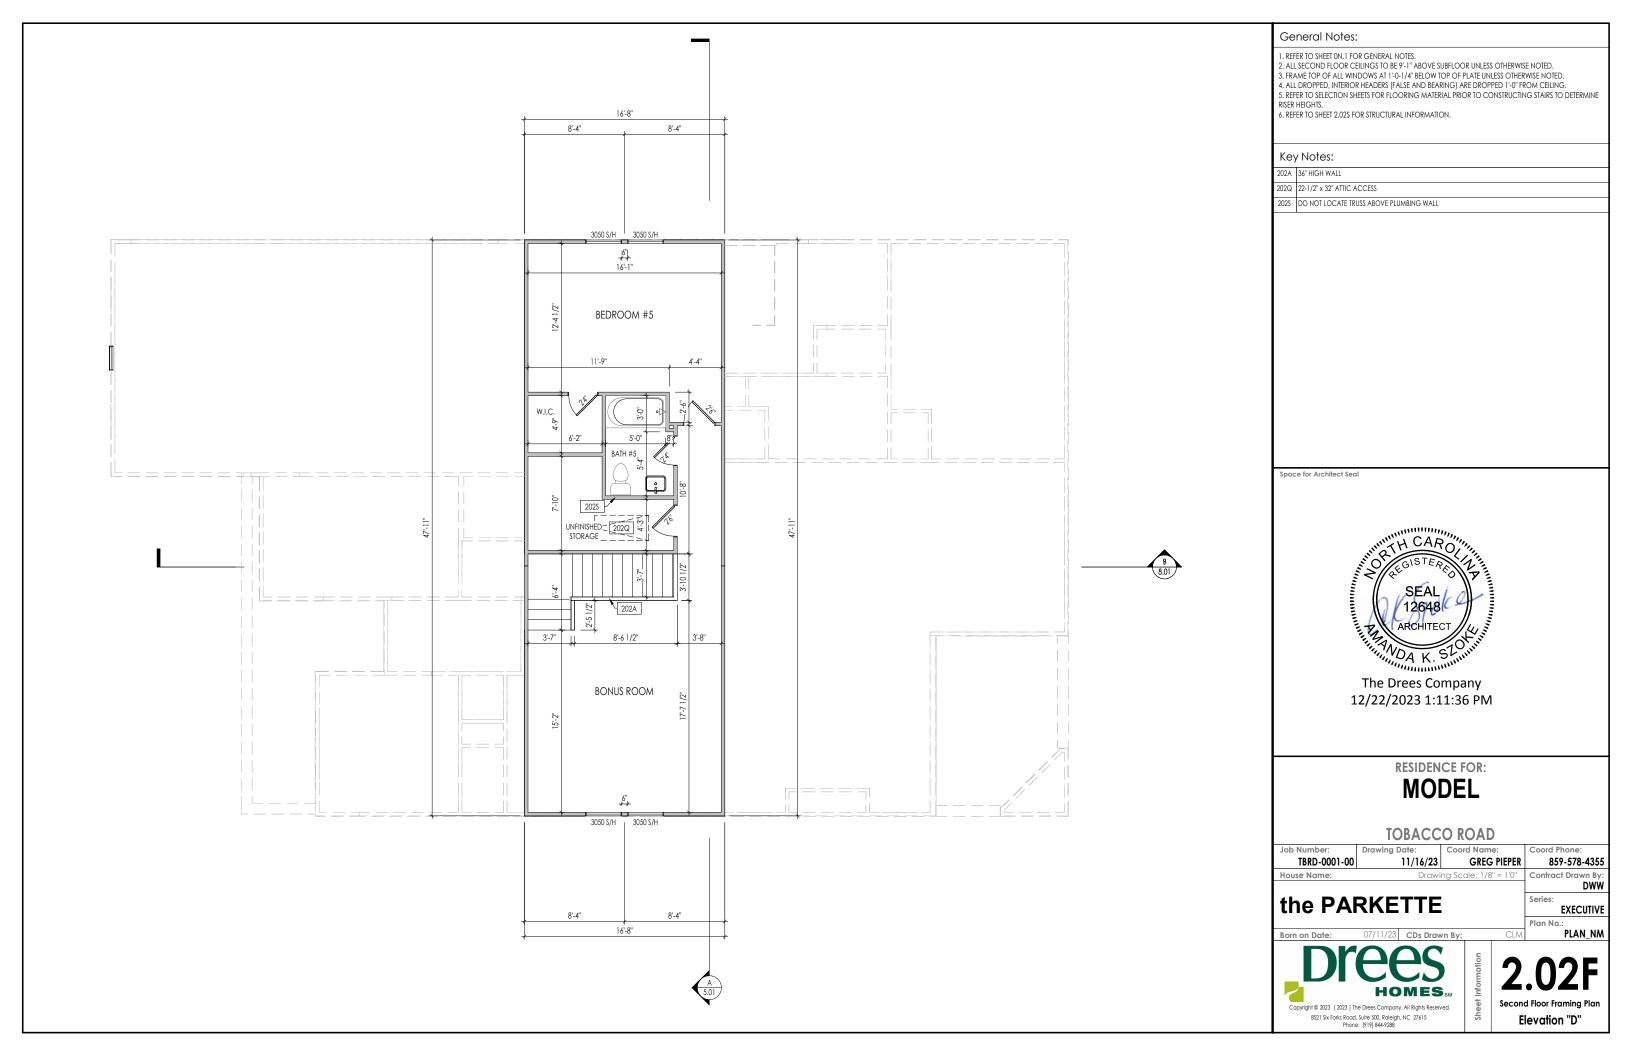
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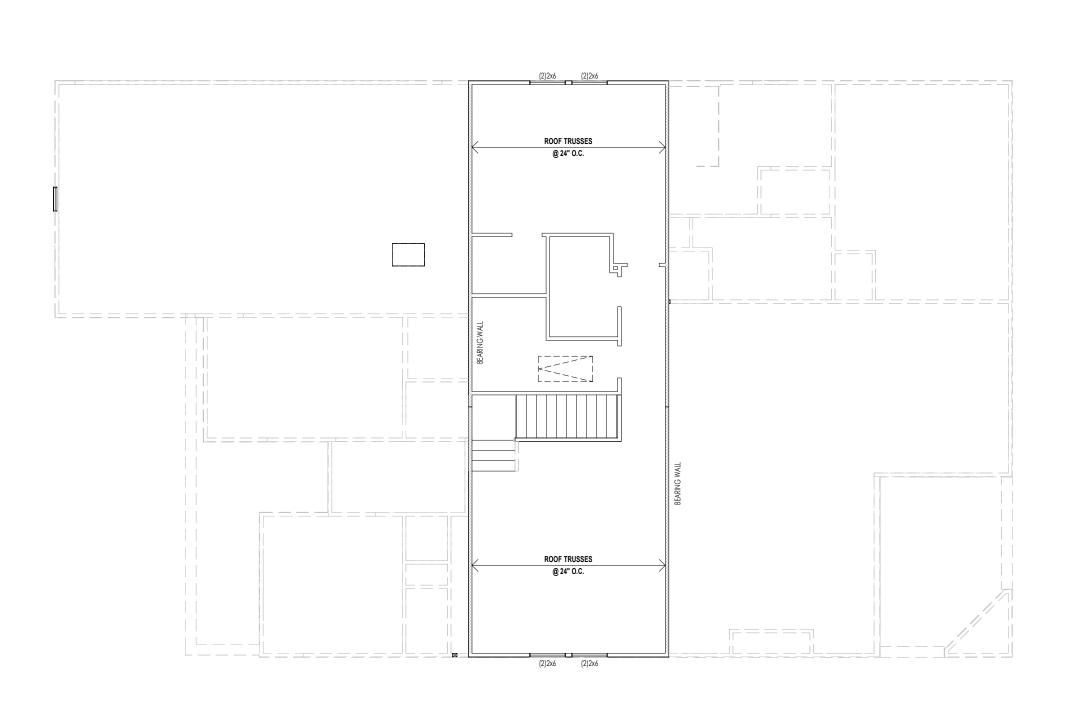







General Notes: 1. REFER TO SHEET ON.1 FOR GENERAL NOTES. 2. REFER TO SHEET S-0 FOR STRUCTURAL DETAILS AND INFORMATION Key Notes: STIA 4x4 P.T. POST W/ SIMPSON BCS2-2/4 CAP & ABW44Z BASE STID FRAME TOP OF BEAM AT 10'-1" ABOVE INTERIOR FIRST FLOOR SUBFLOOR/SLAB Space for Architect Seal The Drees Company 12/22/2023 1:11:36 PM RESIDENCE FOR: **MODEL TOBACCO ROAD** Job Number: **GREG PIEPER** TBRD-0001-00 11/16/23 859-578-4355 DWW the PARKETTE **EXECUTIVE** PLAN NM **HOMES**_{SM} Copyright © 2023 (2023) The Drees Company. All Rights Reserved. 8521 Six Forks Road, Suite 500, Raleigh, NC 27615 Phone: [919] 844-9288 Elevation "D"



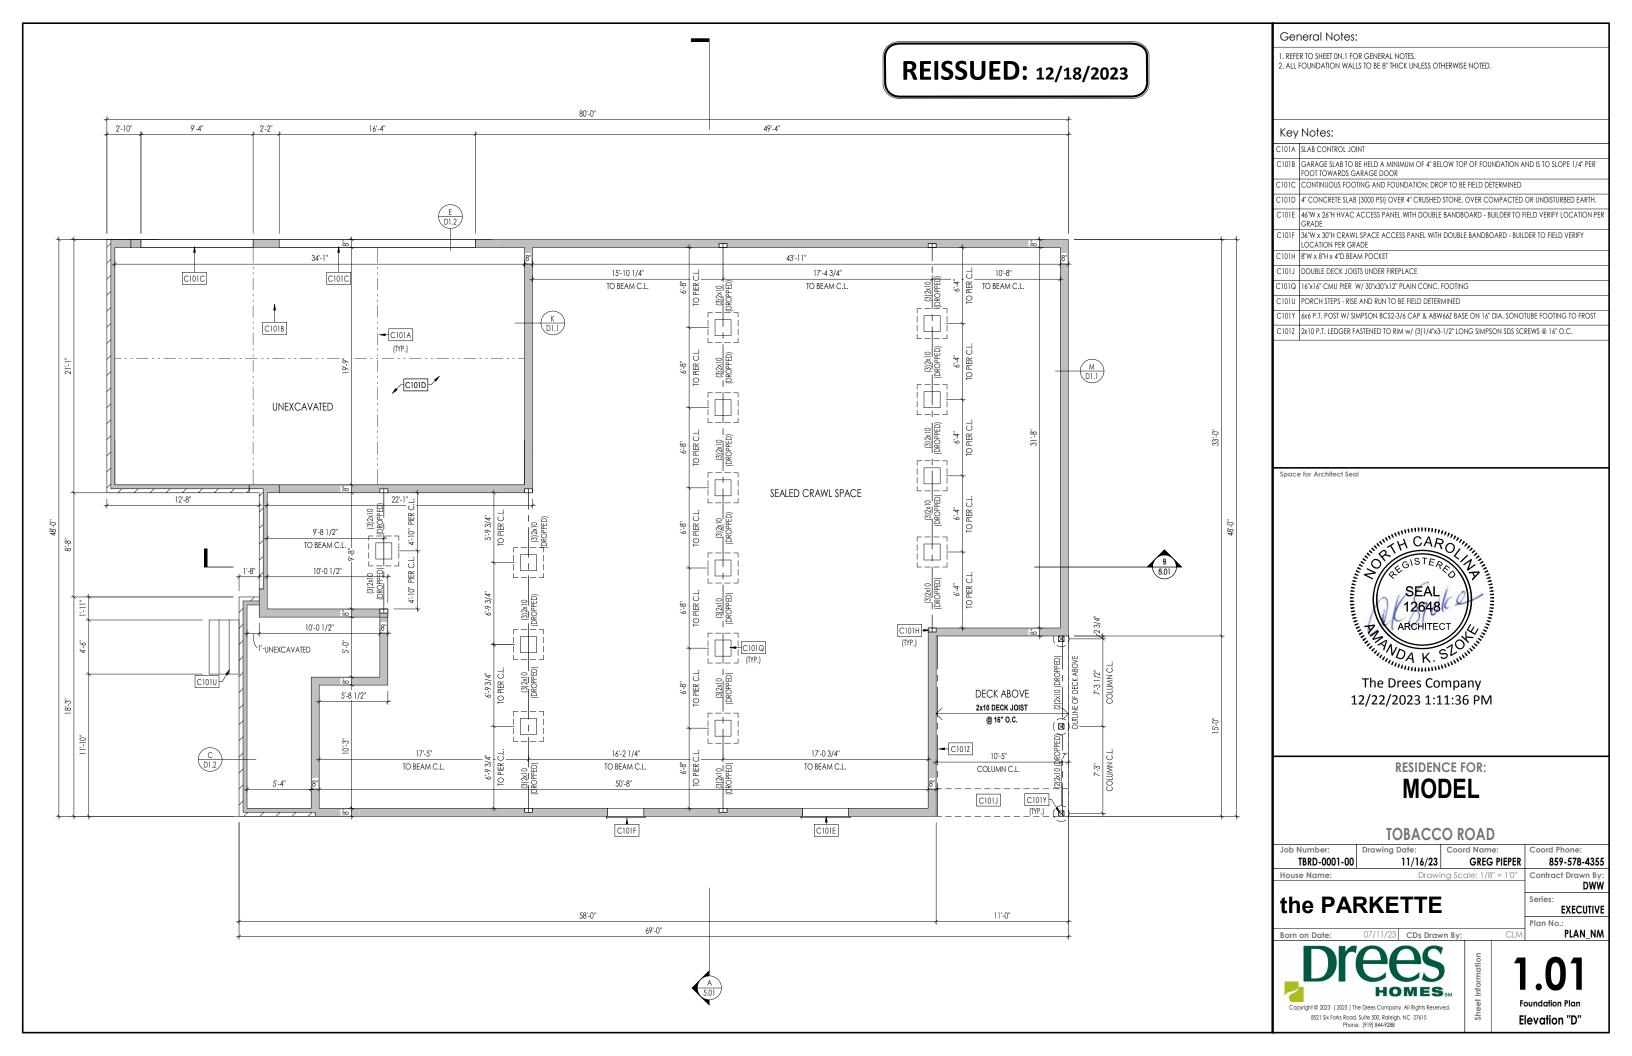

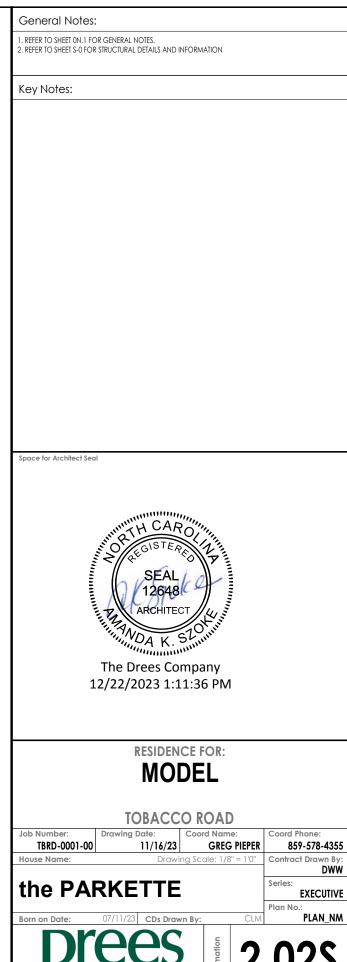



2.02 Second Floor Structural Elevation "D"

9.				
1'-0" 204A				
GIRDER TRUSS				
	6:12		6:12	
2·2 1/4" 4·8"				
	2048	 - 	EXTENT OF VAULTED CEILING	¥
1'-0" 5'-10 1/4"		[]	POT VENT (TYP.)	10'-7 3/4" 1'-4 1/4" TO FACE OF BEAM
11-0" 5-10 1/4" TO FACE OF BEAM				
# = 1.73.74 				

HEEL CUT STANDARDS							
	OVERHANG						
1'-0" 2'-0"							
	4:12	3-3/4"	7-3/4"				
	5:12	4-3/4"	9-3/4"				
ROOF PITCH	6:12	5-3/4"	11-3/4"				
	7:12	6-3/4"	13-3/4"				
	8:12	7-3/4"	N/A				
9	9:12	8-3/4"	N/A				
R	10:12	9-3/4"	N/A				
	12:12	11-3/4"	N/A				
	14:12	13-3/4"	N/A				

DARDS	Ge	neral Notes:
ANG		ER TO SHEET ON. 1 FOR GENERAL NOTES.
2'-0"	2. KEF	er to sheet 5-0 for structural details and information
7-3/4"	Va	/ Notes:
9-3/4"	VG)	/ NOIEs.
44.0/411	204A	VALLEY TRUSS OVER-FRAMING @ 24" O.C.
11-3/4"	204B	NO ROOF DECKING UNDER OVER-FRAMING IN THIS AREA TO ALLOW FOR PROPER ATTIC VENTILATION
13-3/4"		
N/A		

ROOF VENTILATION					
CITY/SERIES:	RALEIGH				
	MAIN HOUSE				
TOTAL ATTIC AREA:	3,757				
REQUIRED NET FREE VENTILATION (ATTIC AREA/300):	12.52				
ACTUAL NET FREE VENTILATION (UPPER + LOWER):	12.86				
DOWNSPOUT CALCULATION					
	MAIN HOUSE				
TOTAL DRAINABLE ROOF AREA:	4884.1				
MINIMUM # OF DOWNSPOUTS:	9				
Space for Architect Seal					



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MODEL

TOBACCO ROAD

Coord Name: Job Number: TBRD-0001-00 11/16/23 GREG PIEPER 859-578-4355


the PARKETTE

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PLAN_NM

EXECUTIVE

Elevation "D"

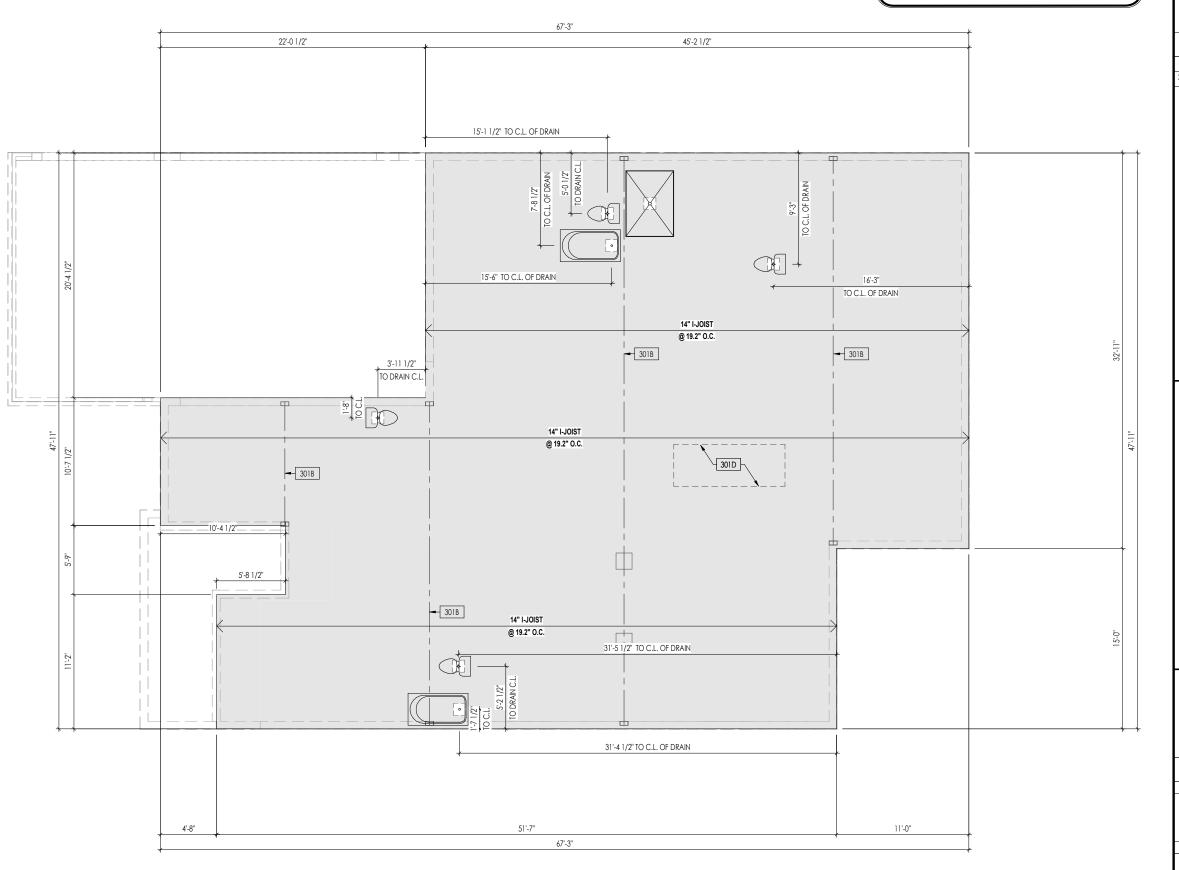

General Notes:

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- (TO PREVENT UNEVEN FLOOR DEFLECTION FROM OCCURRING)
- 4. ADD'L JOISTS MAY BE LOCATED UP TO 2" AWAY FROM THE PARTITION WALL ABOVE IN CASES
- WHERE MECHANICAL PENETRATIONS

 5. REFER TO SHEET S-0 FOR STRUCTURAL DETAILS AND INFORMATION

Key Notes:

301B BEAM BELOW - SEE FOUNDATION PLAN FOR MORE INFO

301D OUTLINE OF KITCHEN ISLAND ABOVE - DOUBLE EVERY OTHER JOIST IN THIS AREA (MIN. 2 INSTANCES)

Space for Architect Seal



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RESIDENCE FOR:

MODEL

TOBACCO ROAD

Coord Name: Job Number: **GREG PIEPER** TBRD-0001-00 11/16/23 859-578-4355 House Name:

the PARKETTE


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- WHERE MECHANICAL PENETRATIONS
- 5. REFER TO SHEET S-0 FOR STRUCTURAL DETAILS AND INFORMATION

Key Notes:

302A BEARING WALL BELOW

302B BEAM BELOW - SEE SHEET 2.01S FOR MORE INFO

302C FLUSH BEAM - SEE SHEET 2.01S FOR MORE INFO

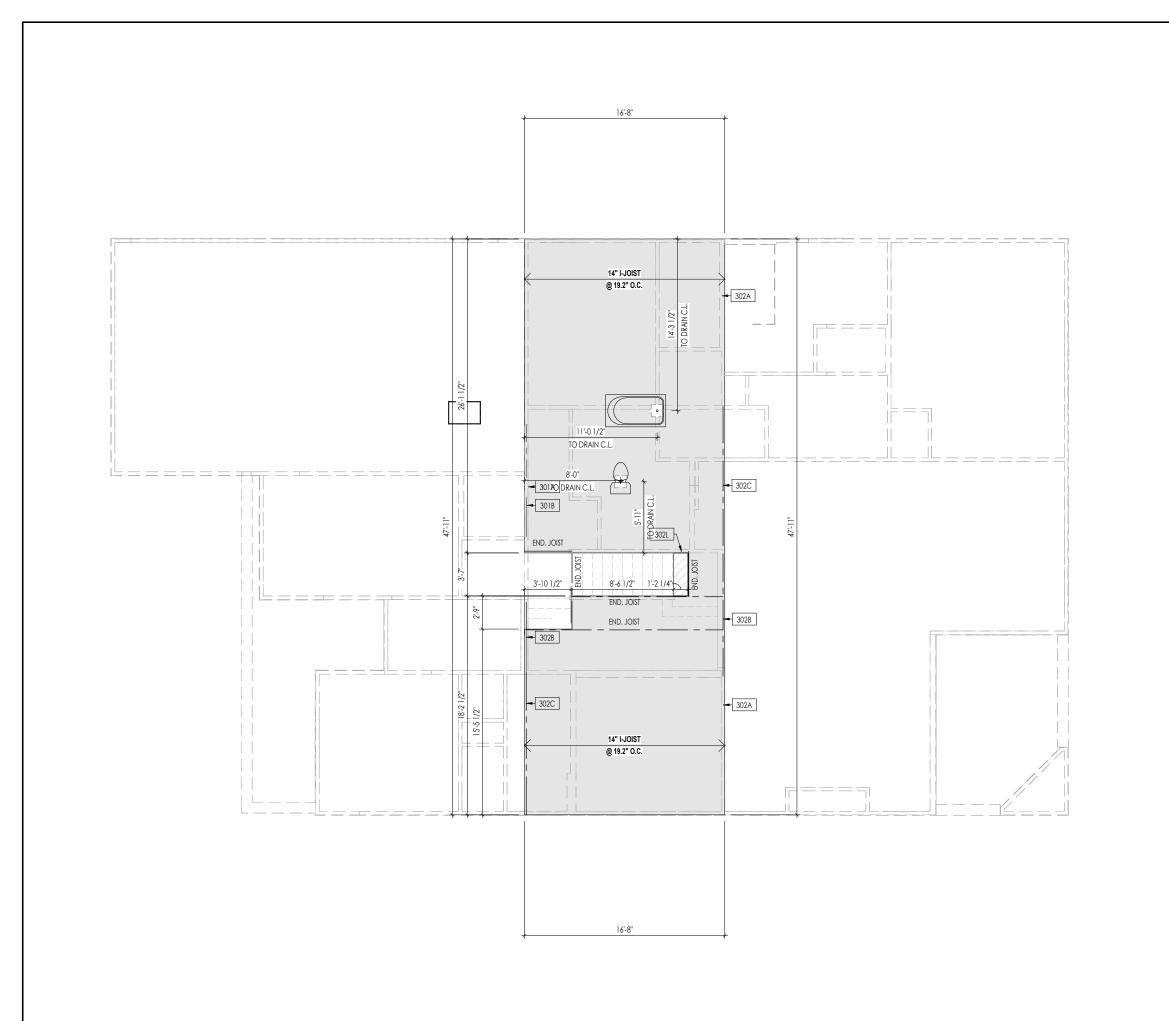302L 2x12 FLAT FRAME (TOP FLUSH) FOR HEADROOM OVER STAIRS - FASTEN TO LVL EA, END W/ SIMPSON A21 CLIPS (4 TOTAL) - SEE STAIR DETAIL

Space for Architect Seal



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RESIDENCE FOR:

MODEL

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Coord Name: Job Number: TBRD-0001-00 11/16/23

House Name:

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859-578-4355 DWW

the PARKETTE


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Elevation "D"

PROVIDE 8' TALL DOORS THROUGHOUT FIRST FLOOR, U.N.O.



General Notes:

. REFER TO SHEET ON.1 FOR GENERAL NOTES.

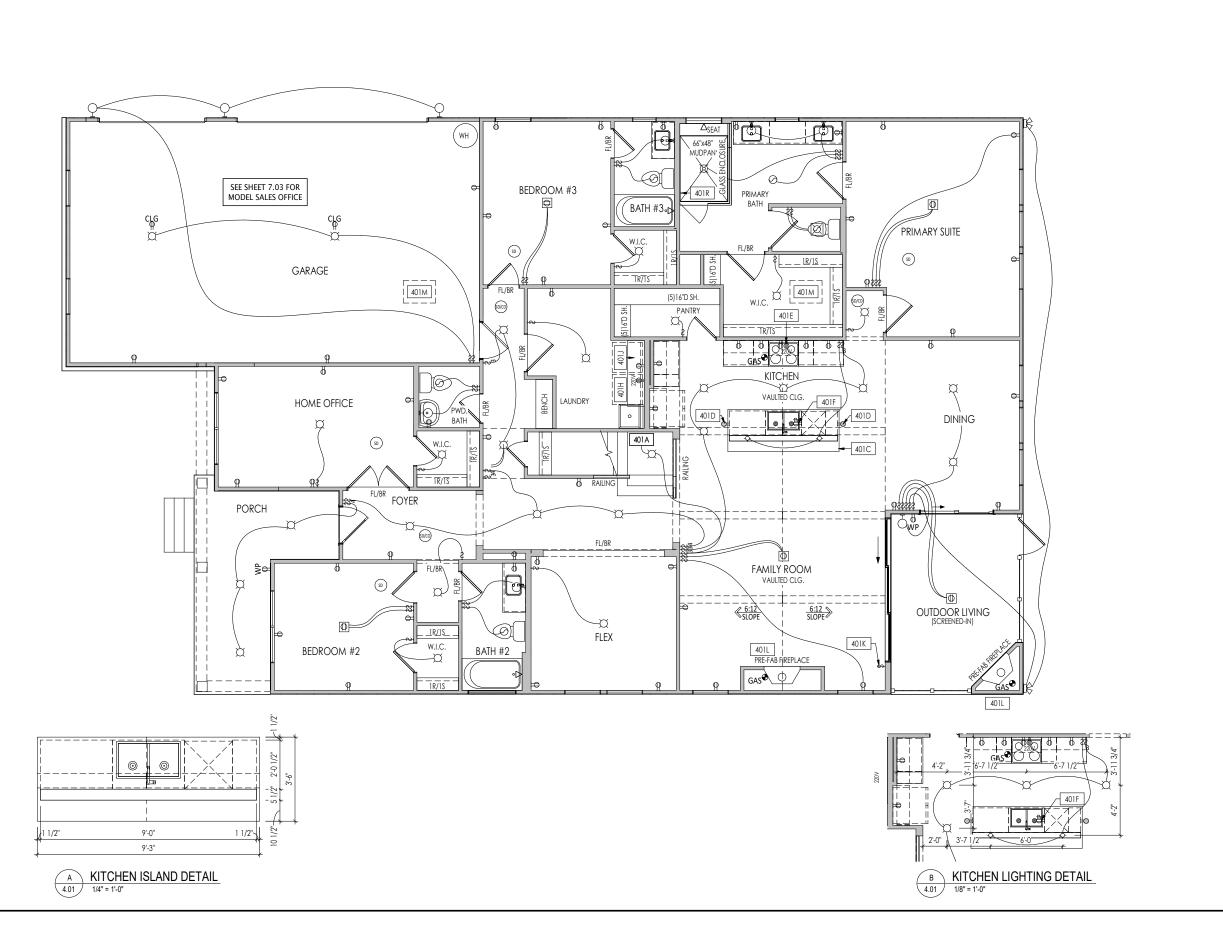Key Notes:

- 401A TO SWITCH OR LIGHT ABOVE
- 401C SEE DETAIL A/4.01 FOR KITCHEN ISLAND COUNTERTOP DIMENSIONS
- 401D HOLD OUTLET HIGH ON ISLAND
- DUTLET FOR RANGE HOOD/MICROWAVE HELD HIGH VENT TO EXTERIOR
- OUTLET FOR DISHWASHER LOCATED IN SINK CABINET
- LOCATE WASHER TO LEFT OF DRYER
- JPPER WALL CABINETS OR 16" DEEP x 5'-6" LONG SHELF HELD AT 5'-7" A.F.F. REFER TO SELECTIONS

CLG. MOUNTED LIGHT FIXT.

SURFACE MOUNT DISC LIGHT OR RECESSED CEILING LIGHT, PER SPECS.

H WALL MOUNTED LIGHT FIXT.

- DOUBLE SPOTLIGHT FIXT.

DIRECTIONAL CAN LIGHT

- WITCHES FOR BLOWER UNIT WITH DIRECT VENT FIREPLACE ONLY
- PRE-FABRICATED FIREPLACE INSERT
- 401M 22-1/2" x 32" ATTIC ACCESS PANEL IN CEILING
- 401R LOCATE SHOWER CONTROLS HERE

MECHANICAL LEGEND

- DATA JACK
- ⇒ WALL OUTLET
- ₩EATHERPROOF GFCI OUTLET Ş ⇒ 220 VOLT OUTLET
- 8⊕ GFCI OUTLET
- FLOOR OUTLET (TV) CABLE TELEVISION JACK (PIN LIGHT
- ← SINGLE POLE SWITCH

Space for Architect Seal

- BLOCK, MOUNT, & SWITCH FOR FUTURE FAN/LIGHT COMBINATION (CENTER, UNLESS OTHERWISE NOTED)
- ₩ WALL SCONCE @ 5'-6" A.F.F. FLUORESCENT LIGHT
- UNDER CABINET LIGHTING

- EXHAUST FAN AND LIGHT COMBINATION

STAIR LIGHT

✓ SHOWER HEAD

GAS GAS HOOK UP

SD SMOKE DETECTOR

SMOKE DETECTOR/ CO DETECTOR COMBINATION

+ HOSE BIB

CLG. MTD. EXHAUST FAN



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MODEL

TOBACCO ROAD

11/16/23 TBRD-0001-00 House Name:

the PARKETTE

GREG PIEPER 859-578-4355


DWW **EXECUTIVE**


PLAN NM

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Elevation "D"



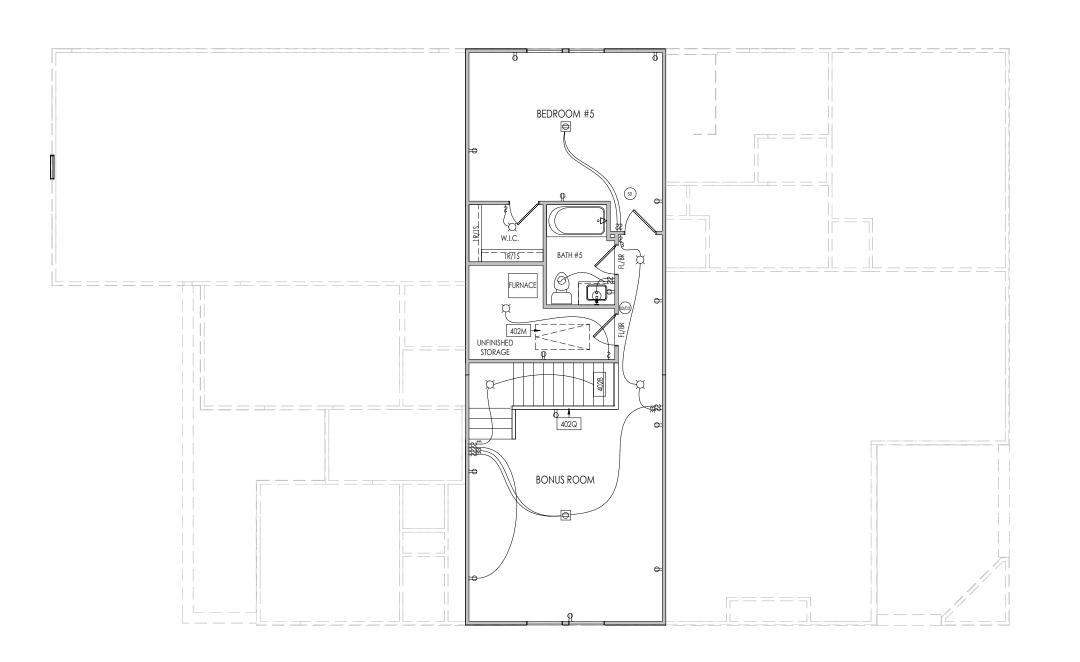

RESIDENCE FOR:

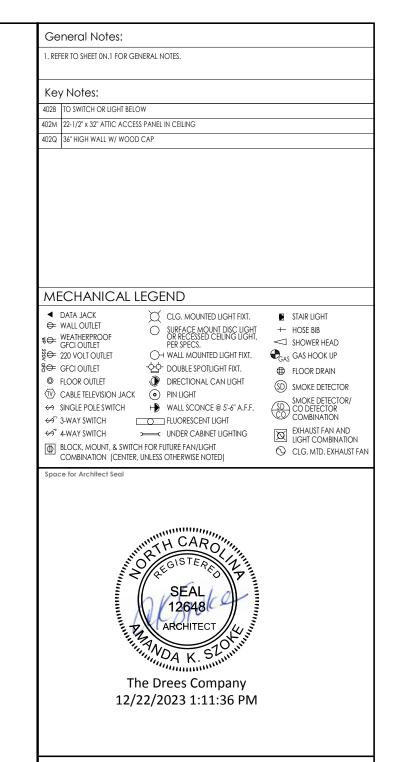MODEL

TOBACCO ROAD

 Job Number:
 Drawing Date:
 Coord Name:
 Coord Phone:

 TBRD-0001-00
 11/16/23
 GREG PIEPER
 859-578-4355

 House Name:
 Drawing Scale: 1/8" = 1'0"
 Contract Drawn By:

the PARKETTE

Series: EXECUTIVE


DWW

| Plan No.: | 07/11/23 | CDs Drawn By: CLM | PLAN NM


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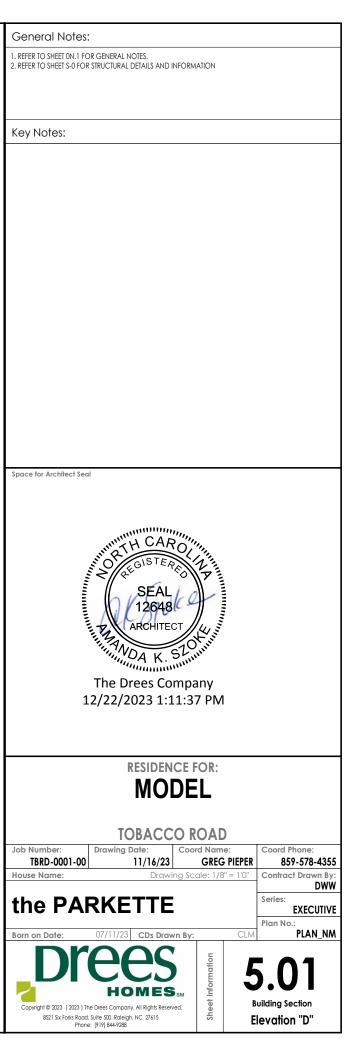
4.02

econd Floor Mechanical Plo Elevation "D"

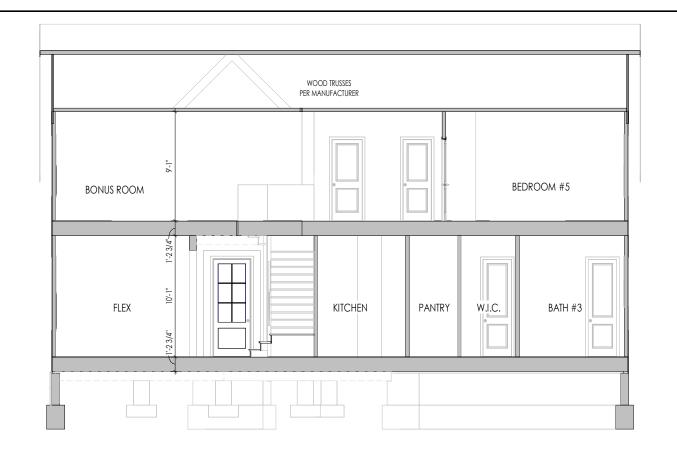

BUILDING SECTION THRU FAMILY ROOM



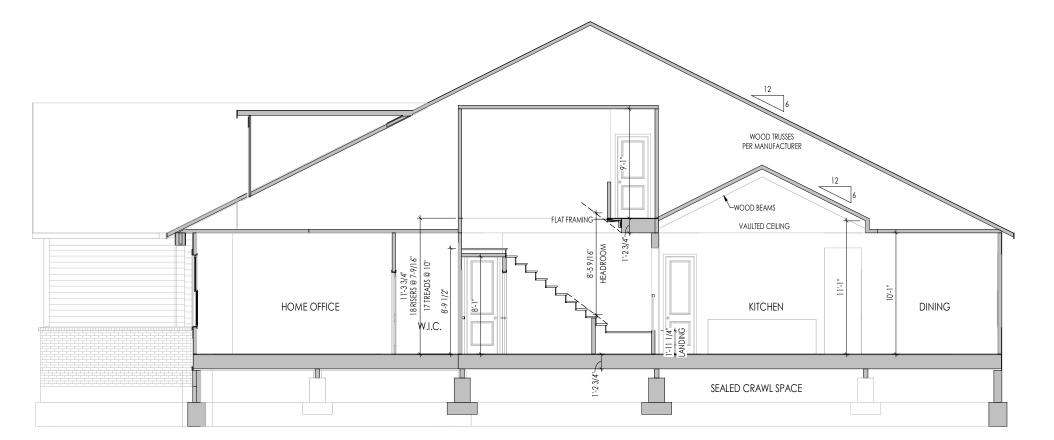

TYPICAL TRIM:

6" FASCIA (ALL SIDES)

8" FRIEZE (FRONT ONLY, UNLESS OTHERWISE NOTED)

General Notes:

- . REFER TO SHEET ON.1 FOR GENERAL NOTES.

Key Notes:

2. ROOFING MATERIAL PER SELECTIONS.
3. CONTACT M&K ENGINEERING FOR HEADER SIZE/BRICK SUPPORT IF GRADE DROPS AND THE AMOUNT OF BRICK OVER GARAGE DOOR SHOWN ON CURRENT ELEVATION IS NO LONGER ACCURATE

4. REFER TO SHEET S-0 FOR STRUCTURAL DETAILS AND INFORMATION



ELEVATION "D"



RESIDENCE FOR:

MODEL

TOBACCO ROAD


Job Number: TBRD-0001-00 **GREG PIEPER** 859-578-4355 11/16/23 House Name: DWW


the PARKETTE





Elevation "D"

EXECUTIVE PLAN NM

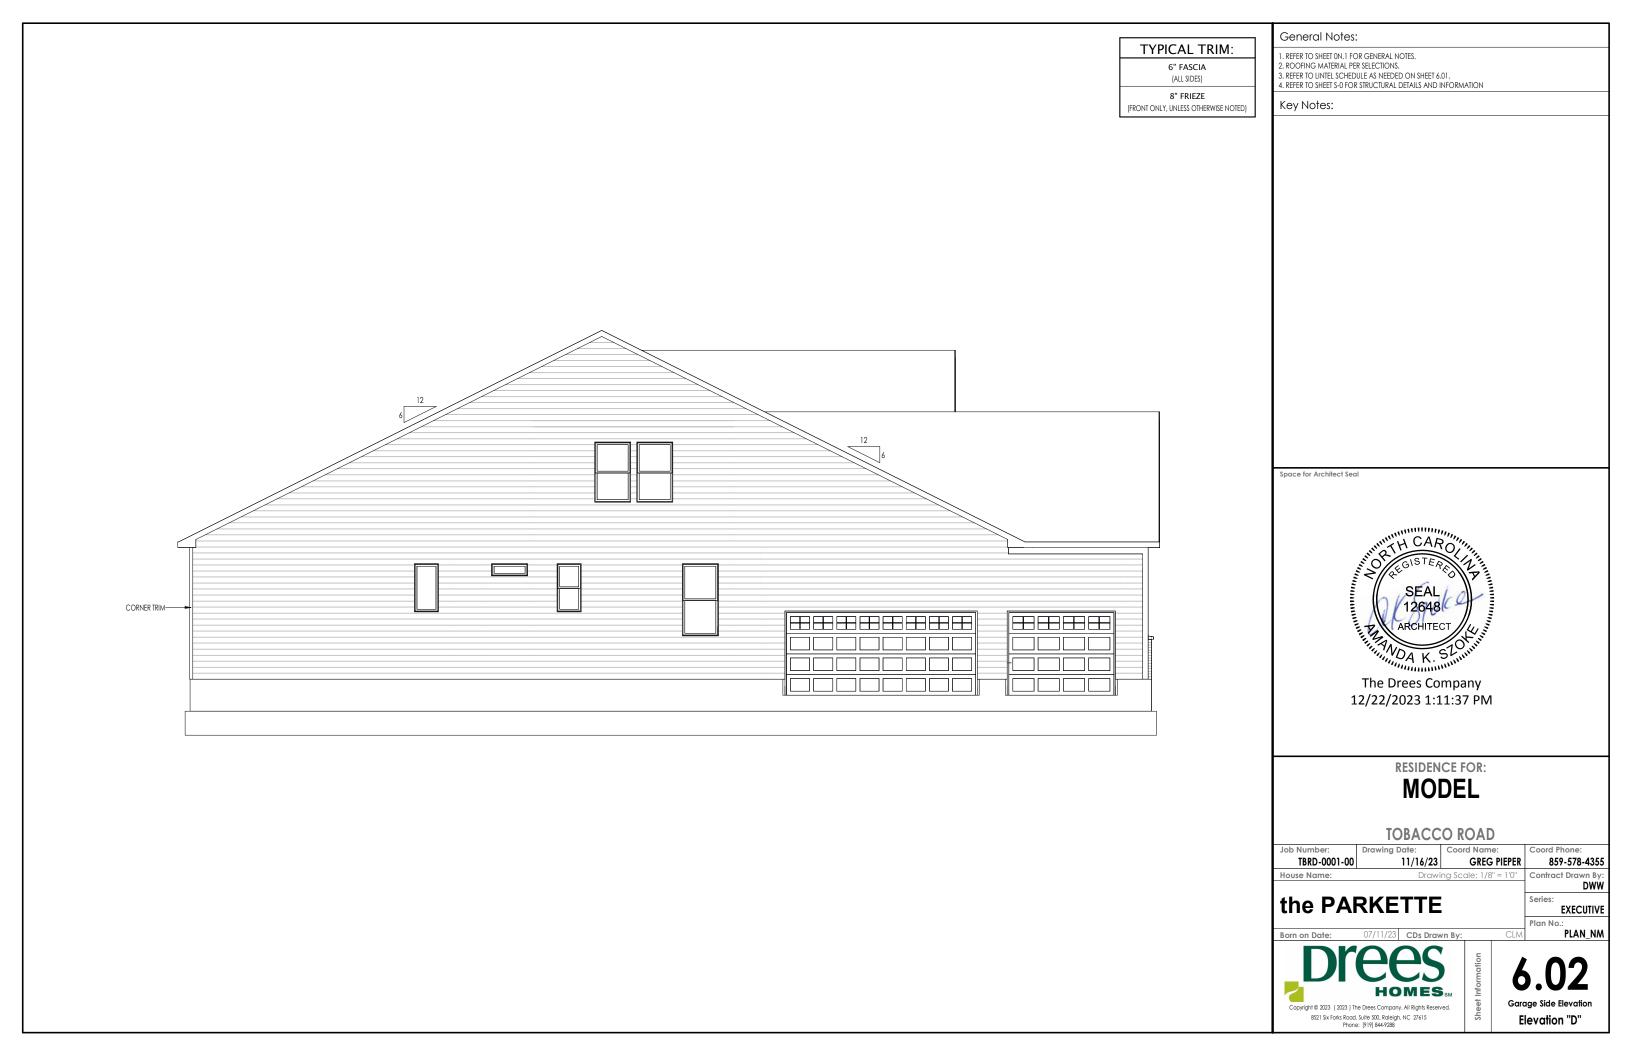

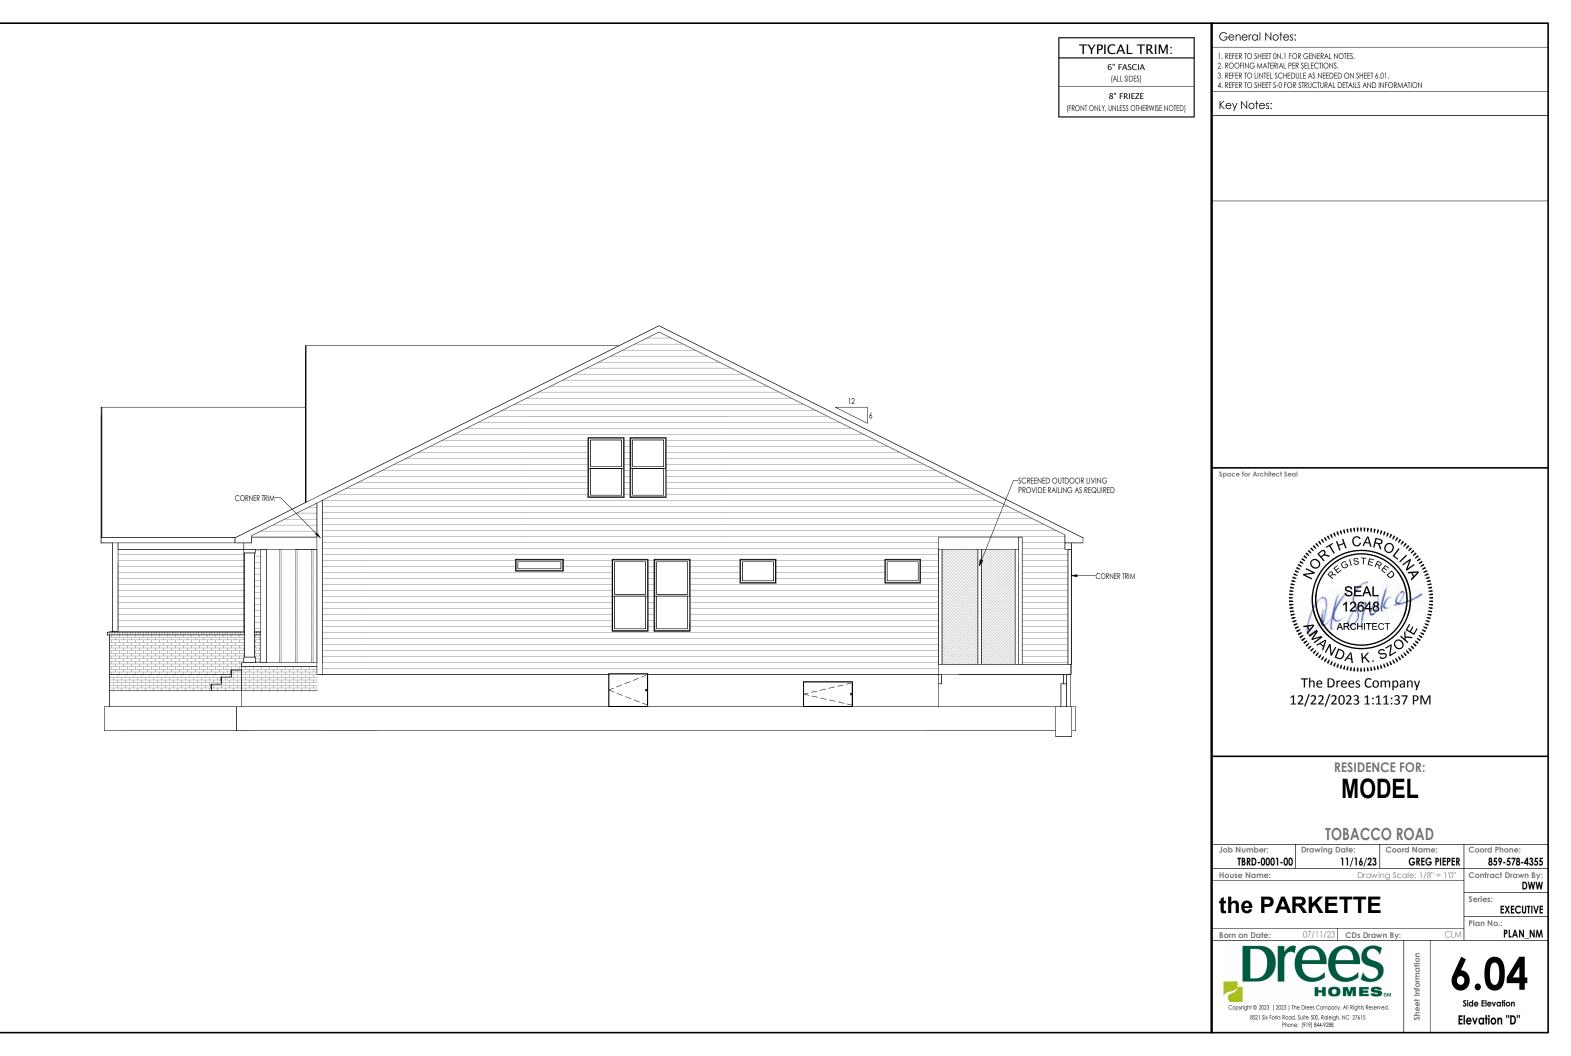


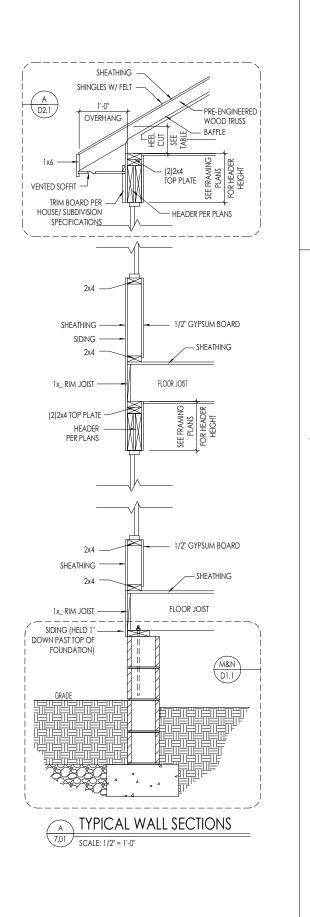

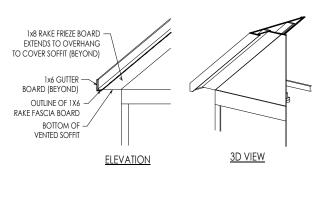


RAFTER TAIL DETAIL

SCALE: 1/4" = 1'-0"

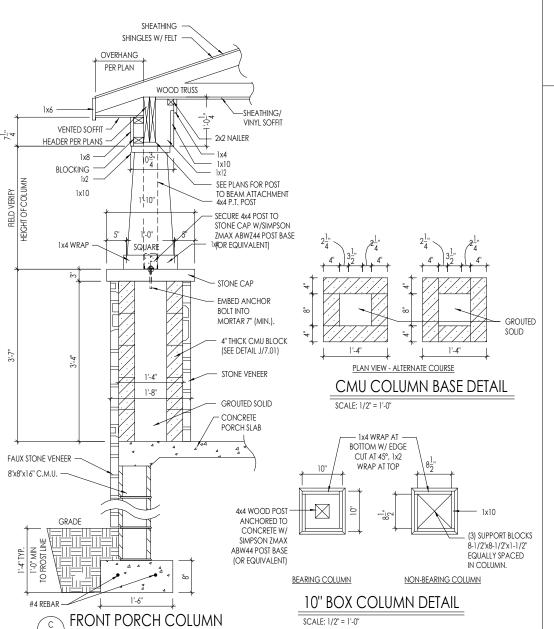

7.01


SCALE: 1/2" = 1'-0"

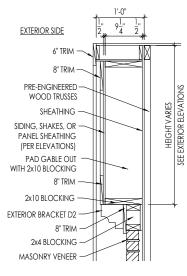

PAD-OUT ABOVE MASONRY

D GABLE PAD-OUT DETAIL

7.01 SCALE: 1/2" = 1'-0"

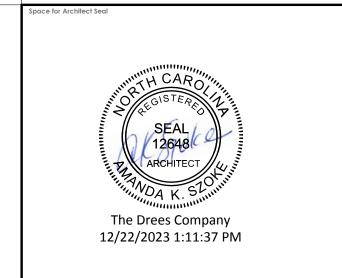

RESIDENCE FOR:

MODEL

TOBACCO ROAD

GREG PIEPER 859-578-4355
a Scale: 1/8" = 1'0" Contract Drawn By:

the PARKETTE

DWW
Series:
EXECUTIVE


PLAN NM


Plan No. ate: 07/11/23 CDs Drawn By: CLM




7.01

House Specific Details
Elevation "D"

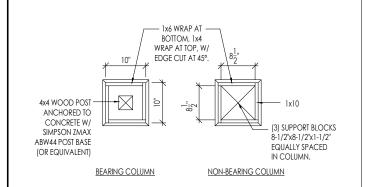

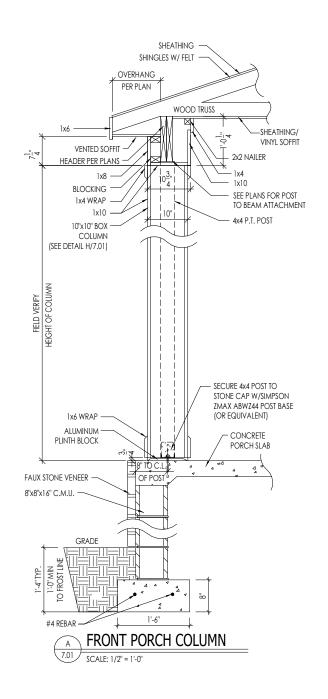

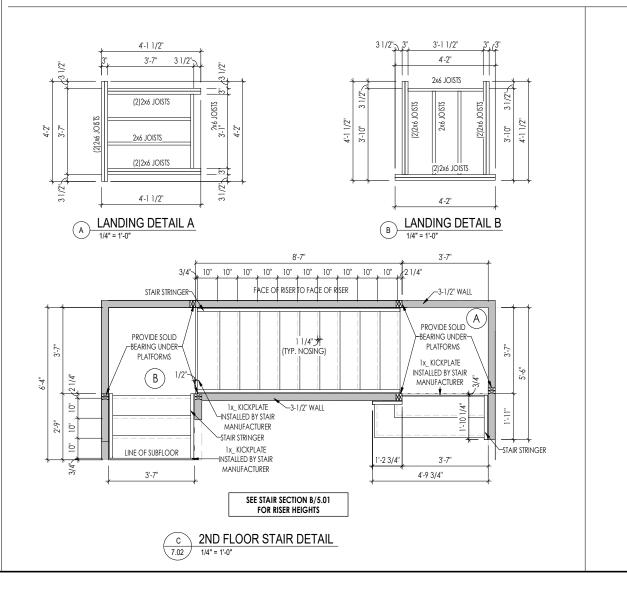

Space for Architect Seal The Drees Company 12/22/2023 1:11:37 PM RESIDENCE FOR: **MODEL TOBACCO ROAD** Coord Name Job Number: TBRD-0001-00 **GREG PIEPER** 859-578-4355 11/16/23 House Name: DWW the PARKETTE **EXECUTIVE** Plan No. PLAN_NM **HOMES**_{SM}

Elevation "D"

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HEIGHT OF TOP BOARD CUT TO FIT AS NEEDED

(3) ROWS* 3/4" THICK x 11-1/4"

* NOTE FOR DROPPED GARAGE: INCREASE NUMBER OF <u>UPPER</u> ROWS TO CEILING

LEAVE 3/4" GAP BETWEEN

(3) ROWS $\frac{3}{4}$ " THICK x 23- $\frac{1}{4}$ "

WALL SCONCE CENTERED IN

(3) ROWS $\frac{3}{4}$ " THICK x 11- $\frac{1}{4}$ "

MDF PANEL BOARDS APPLIED TO

DRYWALL ON 2x4 STUDS (DRYWALL PAINTED TO MATCH TRIM)

MIDDLE 23- $\frac{1}{4}$ " MDF PANEL BOARD


MDF PANEL BOARD

(SEE ELEVATION 'D')


MDF PANEL BOARD

BOARDS (TYP.)

MDF PANEL BOARD

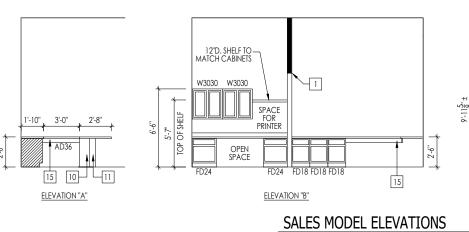

SCALE: 1/8"=1'-0"

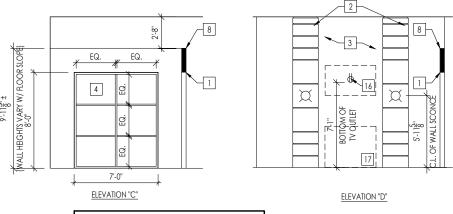

DISTANCE PER-

ADA REQ'TS

STORAGE

LENGTH PER

ADA REQ'TS

INTERIOR SELECTIONS FOR CABINETRY, COUNTERTOPS, FLOORING PAINT WALLCOVERINGS & FURNITURE PER

STANDARD MODEL SELECTIONS. SEE MARKETING.

INTERIOR SELECTIONS FOR CABINETRY, COUNTERTOPS, FLOORING, PAINT, WALLCOVERINGS, & FURNITURE PER STANDARD MODEL SELECTIONS, SEE MARKETING.

SCALE: 1/8"=1'-0"

12648

ARCHITECT

DREES LOGO SIGNAGE ON WALL WITH BACK LIGHTING - OUTLET TO BE CENTERED IN THE MIDDLE OF THE WALL WITH THE BOTTOM OF THE OUTLET 5'-6" A.F.F. 6 OUTLET/ PHONE BELOW COUNTER.

General Notes:

Key Notes:

REFER TO SHEET ON.1 FOR GENERAL NOTES.

7 GROMMETS IN COUNTER FOR PHONE/ELECTRIC BELOW

8 FRAME TOP OF WALLS AT OFFICE AND STORAGE 2'-8" DOWN FROM GARAGE CEILING

1 FRAME TOP OF OPENING EVEN W/ TOP OF FIXED PANEL GLASS WINDOW AT OFFICE - NO CASING

2 WRAPPED PILASTERS FRAMED TO CEILING AND PAINTED TO MATCH TRIM - SEE DETAIL THIS SHEET

3 WALL BETWEEN PILASTERS TO BE PAINTED ACCENT COLOR - RE: STANDARD MODEL SELECTIONS FRAME ROUGH OPENING FOR 7'-0" WIDE x 8'-0" TALL FIXED PANEL GLASS WITH 6-LITES AND BLACK METAL MULLIONS, BOTTOM FLUSH TO FLOOR

9 PLAS. LAMINATE SUPPORT PANEL 12"W, X 30" H, X 3/4" TH. PLASTIC LAM. ALL (4) SIDES.

10 L-SHAPED PLAS. LAM. MODESTY PANEL, INTERIOR DIMENSIONS: 3'-0" WIDE x 1'-8" DEEP.

[1] 6X6 PLAS. LAM. SUPPORT COLUMN FOR COUNTERTOP

12 3 BASE FILE CABINETS. SEE ELEVATION 'B'

13 BROCHURE HOLDERS.

14 OUTLET/ DATA JACK HELD HIGH

15 VALANCE/ FILLER AS REQ'D.

16 FLAT SCREEN TV ON WALL - PROVIDE CAT 5 AND OUTLET HELD HIGH (7'-1" A.F.F.)

17 HOLD OUTLET AND CAT 5 LOW FOR INTERACTIVE DISPLAY KIOSK

18 LIGHT AND OUTLET IN CEILING FOR FUTURE GARAGE DOOR OPENER.

19 COVER EXPOSED FOUNDATION WALL LEDGE W/ 1x_ RIPPED WOOD CAP


20

21 FRAME WALLS AT STORAGE ROOM AND BATHROOM TO CEILING

22 19" x 17" WALL HUNG SINK

23 CLEAR SPACE PER CODE

24 BLOCKING IN WALL FOR GRAB BARS - SEE BATH ELEVATIONS THIS SHEET

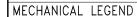

■ PHONE JACK ⇒ WALL OUTLET

P 220 VOLT OUTLET

8 ← GFCI OUTLET FLOOR OUTLET

Outlier

Ou

← SINGLE POLE SWITCH

₩ WALL SCONCE @ 5'-6" A.F.F. FLUORESCENT LIGHT UNDER CABINET LIGHTING

BLOCK, MOUNT, & SWITCH FOR FUTURE FAN/LIGHT COMBINATION (CENTER, UNLESS OTHERWISE NOTED)

CLG. MOUNTED LIGHT FIXT.

DIRECTIONAL CAN LIGHT

PIN LIGHT

SHOWER HEAD GAS GAS HOOK UP → WALL MOUNTED LIGHT FIXT. - DOUBLE SPOTLIGHT FIXT.

(SD) SMOKE DETECTOR

(CO) CO DETECTOR SMOKE DETECTOR/ CO DETECTOR COMBINATION

■ STAIR LIGHT

+ HOSE BIB

EXHAUST FAN AND LIGHT COMBINATION

Coord Phone:

859-578-4355

DWW

Contract Drawn By

O CLG. MTD. EXHAUST FA

MODEL HOME ADDRESS T.B.D. TOBACCO ROAD

RESIDENCE FOR:


Drawing Date: Job Number: TBRD-0001-00 11/16/23 House Name

the PARKETTE

EXECUTIVE Plan No.: Drawing Scale: 1/8" = 1'0"

HOMES

GREG P.

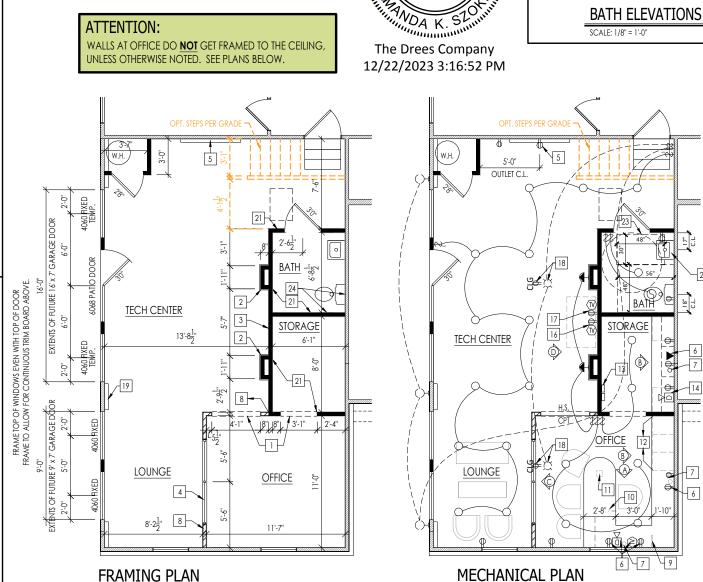

WRAPPED PILASTER DETAIL SCALE: 1/4" = 1'-0" FRAME TOP OF WINDOWS EVEN WITH TOP OF DOOR FRAME TO ALLOW FOR CONTINUOUS TRIM BOARD ABOVE. 4060 FIXED TEMP. 4060 FIXED TRIM TO MATCH FRONT ELEVATION (SHEET 6.01) EXTENTS OF FUTURE 9' x 7' GARAGE DOOR EXTENTS OF FUTURE 16' x 7' GARAGE DOOR **GARAGE SIDE ELEVATION**


<u>|</u>


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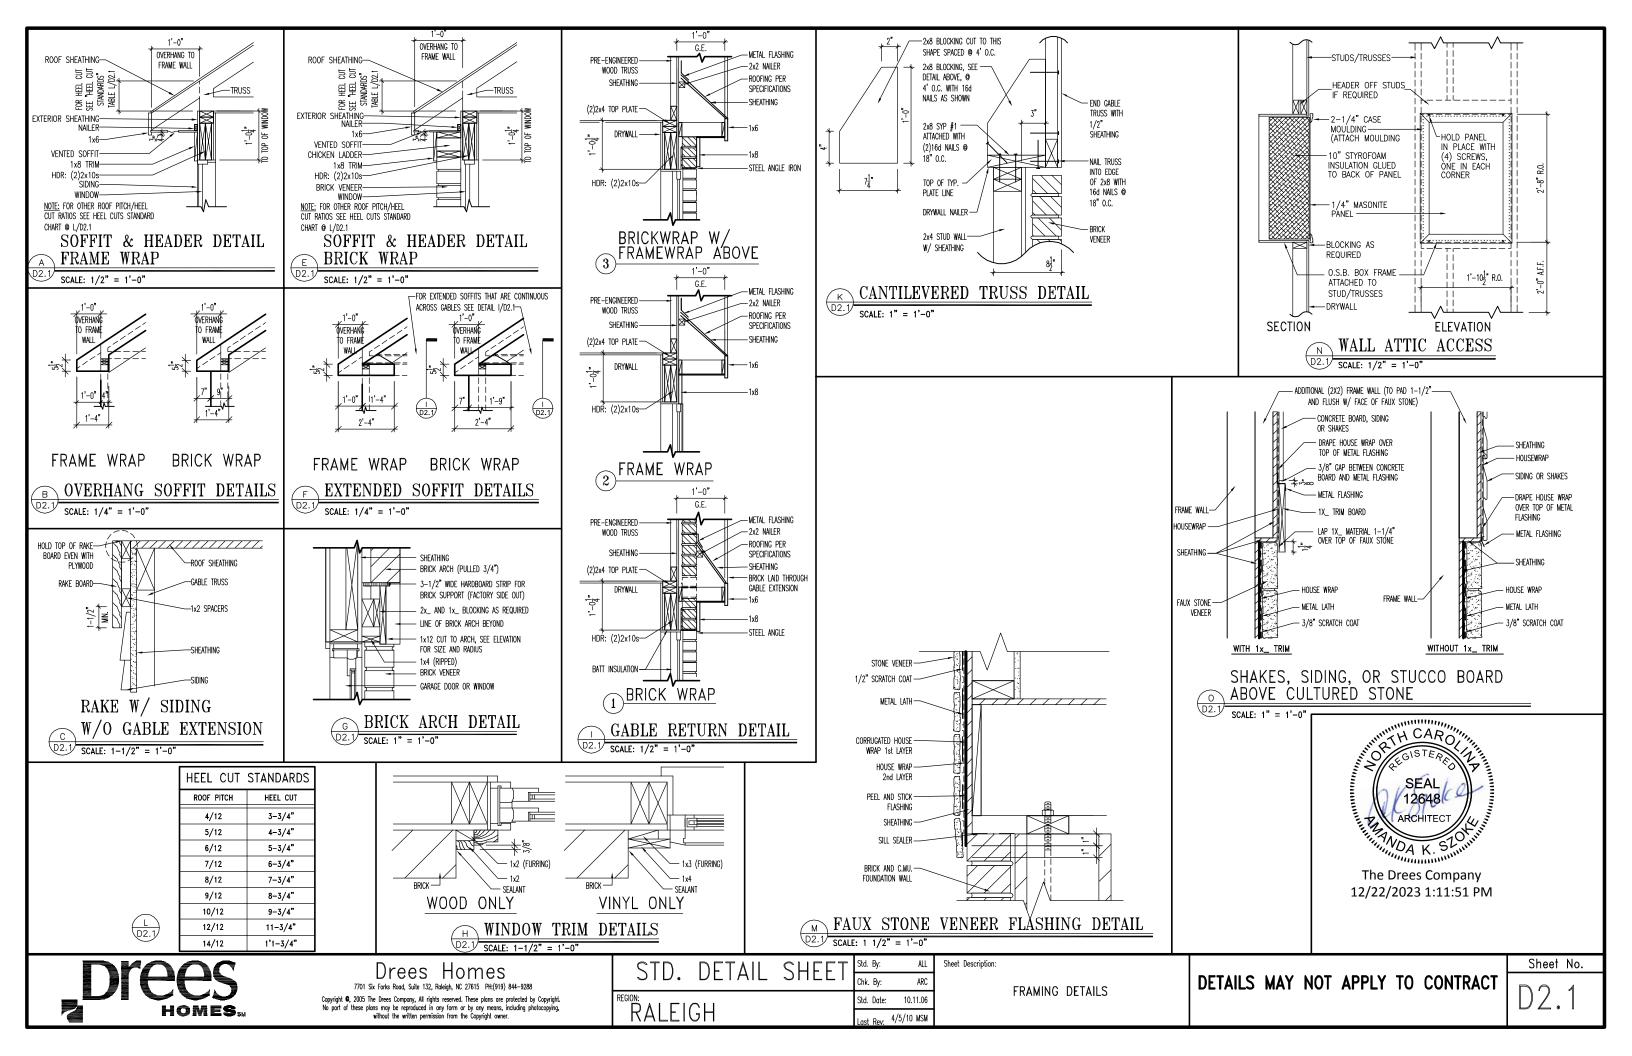
GARAGE SLAB

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8521 SIX FORKS ROAD, SUITE 500, RALEIGH, NC 27615 PHONE: [919] 844-9288 Elevation "D"






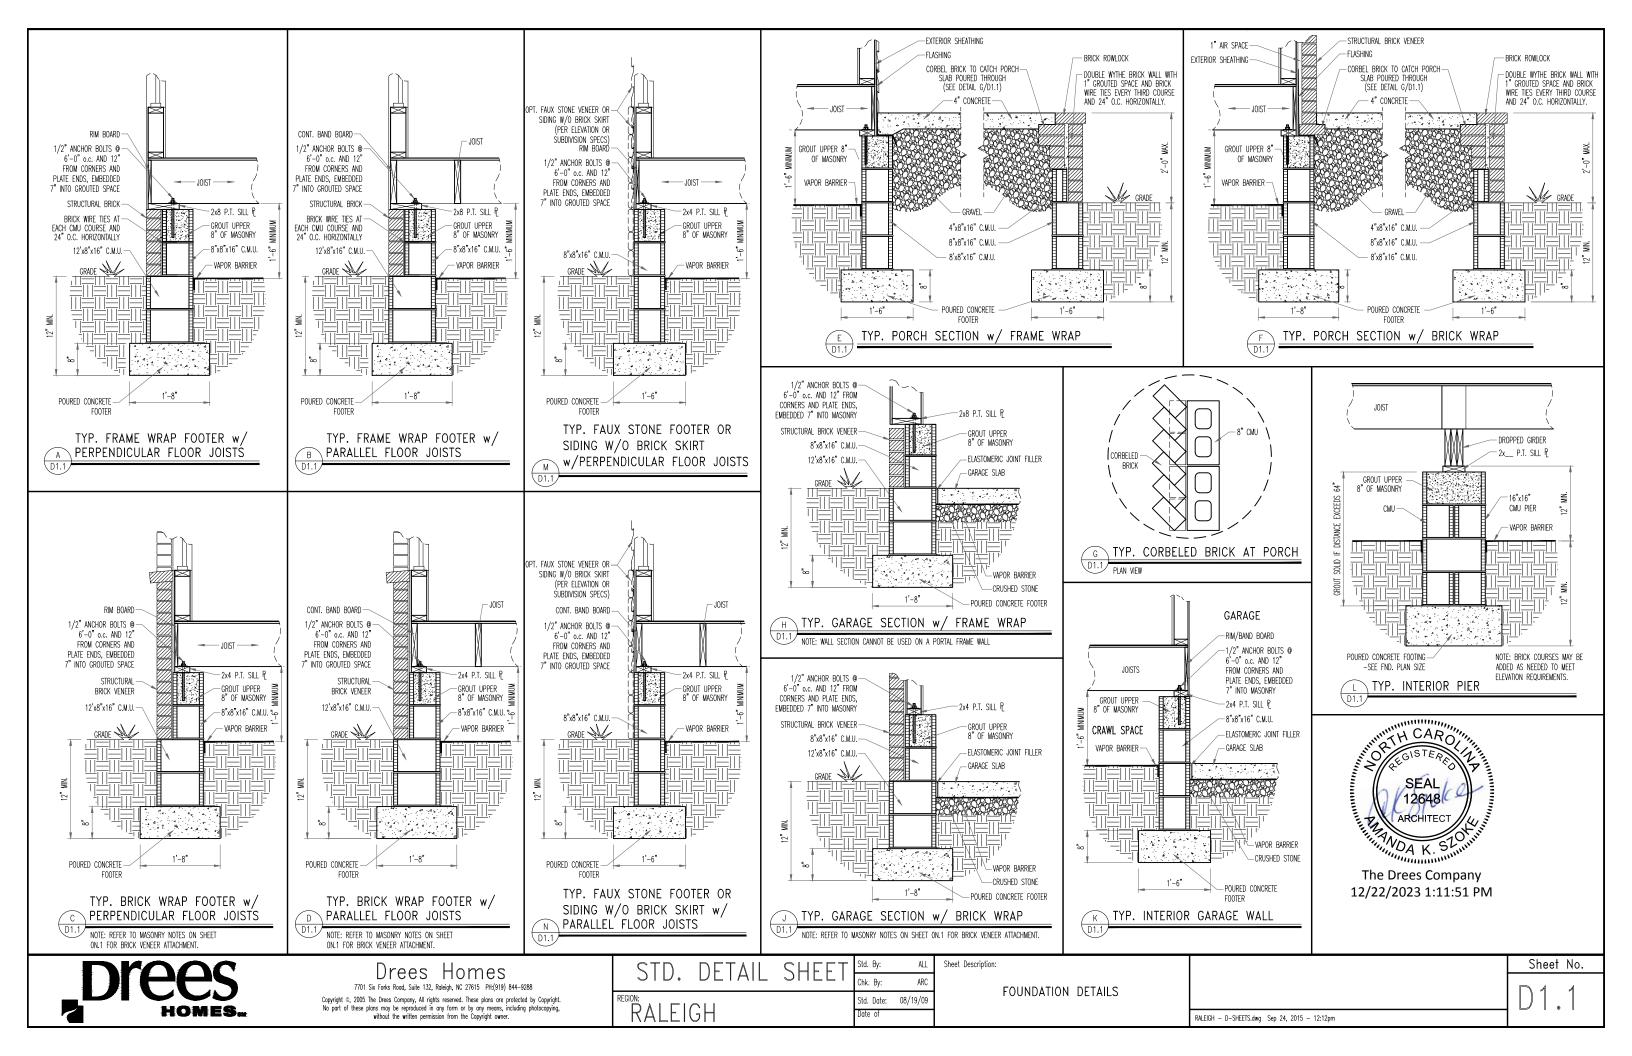

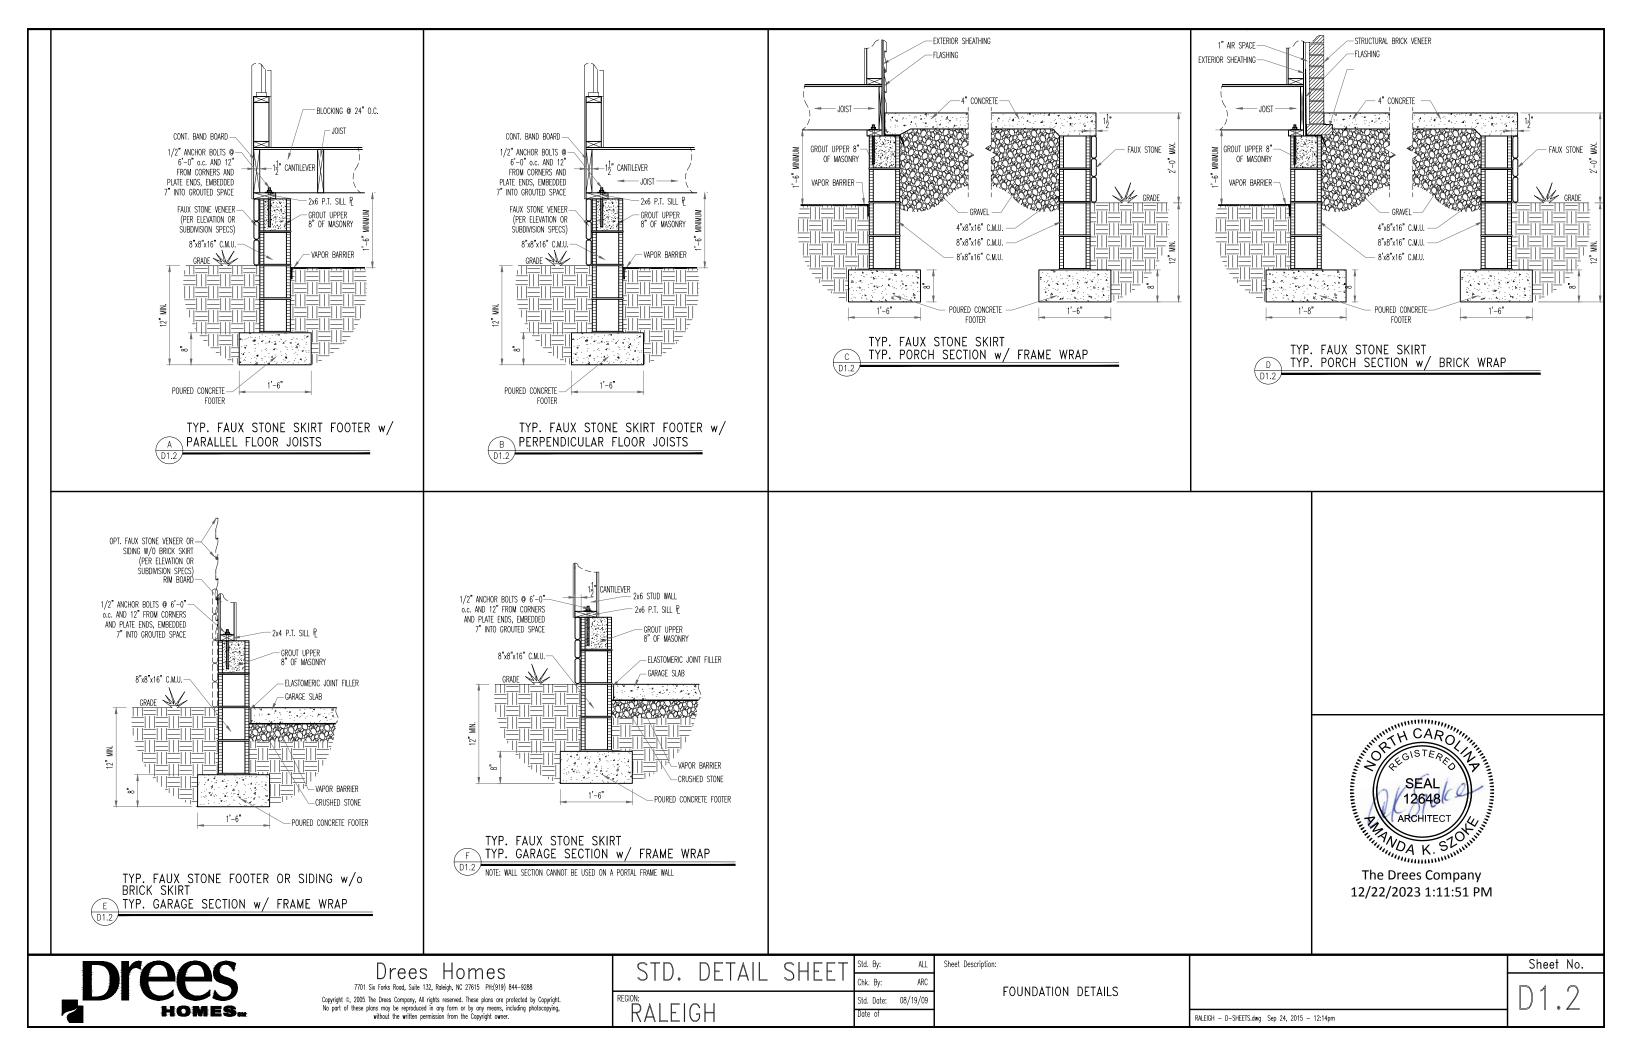



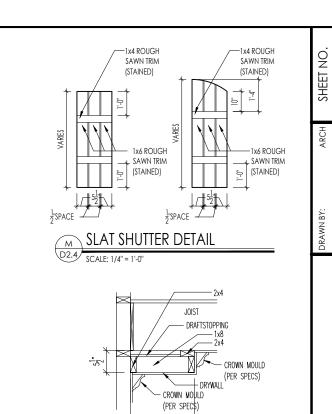


SINGLE TRAY CEILING DETAIL

D2.4 SCALE: 1/2" = 1"-0"


1'-4"



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STANDARD FRAMING DETAILS
RALEIGH DIVISION
SCALE: AS NOTED
SCALE: AS NOTED

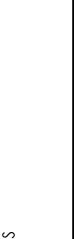



STANDARD FRAMING DETAILS
RALEIGH DIVISION
SCALE: AS NOTED

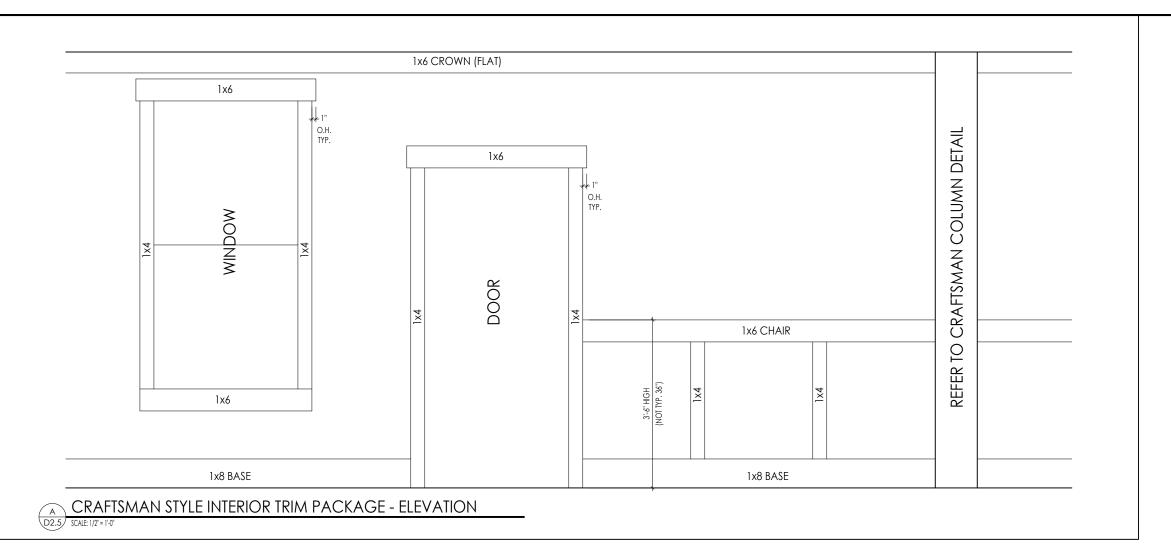D2.5



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Note: Ceiling treatment details will tray down into space on enclosed rooms located on the 1st floor. On enclosed rooms on the 2nd floor, the ceiling treatment will tray up into the roof truss system. On 2-story spaces, the ceiling treatment will tray down into the space and require an appropriate sized header to capture the ceiling detail return.

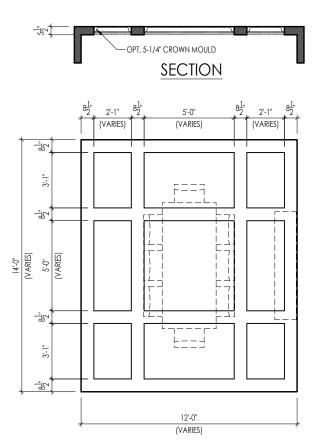-8x8 BOX BEAM **SECTION** 7'-4" 12'-0" (VARIES) TYPICAL PLAN

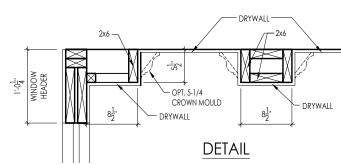
2-story spaces, the ceiling treatment will tray down into the space and require an appropriate sized header to capture the ceiling detail return.

Note: Ceiling treatment details will tray down into space on enclosed rooms located on the 1st floor. On enclosed rooms on the 2nd floor, the ceiling treatment will tray up into the roof truss system. On

-5-1/4" CROWN MOULD 5/8"x3/4" BASE MOULD

TYPICAL PLAN


SECTION

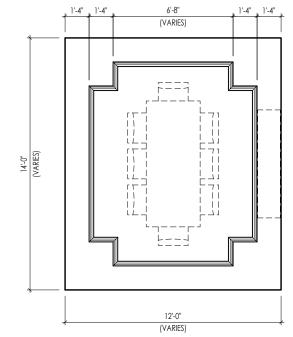


TYPICAL PLAN



Note: Ceiling treatment details will tray down into space on enclosed rooms located on the 1st floor. On enclosed rooms on the 2nd floor, the ceiling treatment will tray up into the roof truss system. On 2-story spaces, the ceiling treatment will tray down into the space and require an appropriate sized header to capture the ceiling detail return.

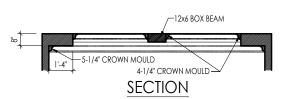


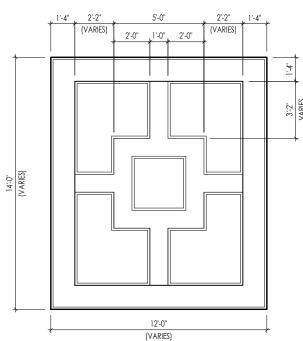

TYPICAL PLAN



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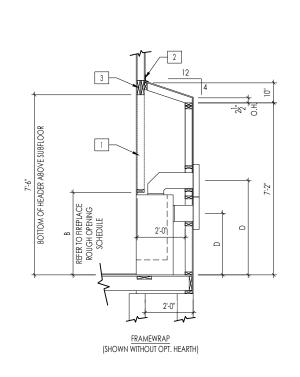


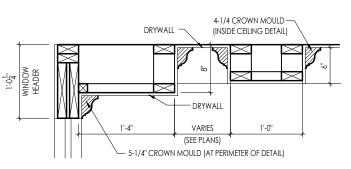
DETAIL

Note: Ceiling treatment details will tray down into space on enclosed rooms located on the 1st floor. On enclosed rooms on the 2nd floor, the ceiling treatment will tray up into the roof truss system. On 2-story spaces, the ceiling treatment will tray down into the space and require an appropriate sized header to capture the ceiling detail return.

CEILING TREATMENTS


SCALE: AS NOTED



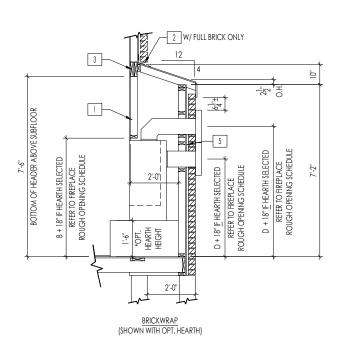


FIREPLACE DOGHOUSE SECTIONS

SCALE: 1/4" = 1'-0"

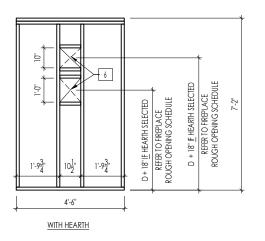


DIRECT VENT REAR WALL FRAMING

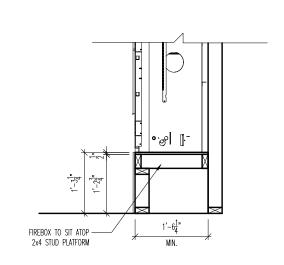

RAVE FIREPLACE PLATFORM DETAIL

SCALE: 1/2" = 1'-0"

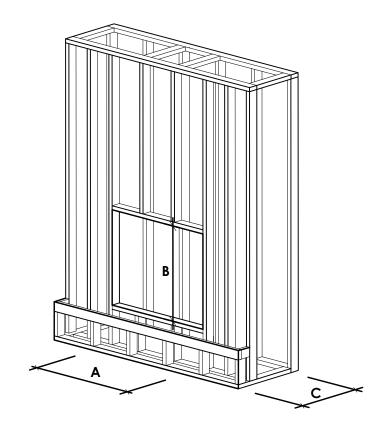

NOTE:
PROVIDE OSB SHEATHING WHEN
STONE VENEER SELECTED

FIREPLACE ROUGH OPENING SCHEDULE						
	MODEL	А	В	С	D	
FIREPLACE MANUFACTURER		(FIREBOX REQUIRED WIDTH)	(FIREBOX REQUIRED HEIGHT) *ADD 18" W/ OPT. HEARTH	(FIREBOX REQUIRED DEPTH - INTERIOR REAR WALL TO FRONT EXTERIOR WALL)	(VENT CENTERLINE HEIGHT *ADD 18" W/ OPT. HEARTH	
	SLIMLINE SL-7	42"	38-1/4"	16-1/4"	TOP 40" SIDE 26-7/8"	
HEAT & GLO	COSMO 42	49"	32-3/4"	17-3/4"	TOP ONLY 47-1/16"	
	NOVUS 33	39"	34-7/8"	19-5/8"	TOP 40" SIDE 23-1/2"	
	COURTYARD 36	43-3/8"	44-1/8"	18-3/8"	SEE MANUFACTURER'S SPEC	
HEARTH & HOME	COURTYARD 42	48-1/2"	34-1/4"	20-1/4"	SEE MANUFACTURER'S SPEC	
	LANAI *(NOT IN CINCY/NKY)	57-3/4"	39-1/2"	17-5/8"	SEE MANUFACTURER'S SPEC	
	RAVE	49"	32-3/4" *RAISED 15-1/4"*	18-1/4"	TOP ONLY 46-1/2"	
			all dimensions	are in inches		



. REFER TO SHEET ON.1 FOR GENERAL NOTES. 2. VERIFY FIREPLACE MODEL AND HEARTH SELECTION WITH CUSTOMER'S SELECTIONS.

Key Notes

1 FUTURE FRAMING FOR F.P. OPENING AFTER INSULATION HAS BEEN INSTALLED IN EXT. WALL

2 FLASHING

3 HEADER PER PLAN

4

5 1" AIRSPACE

6 BOX OUT FOR FLUE (REFER TO SELECTIONS FOR FIREPLACE AND OPENING HEIGHT)



12/22/2023 1:11:52 PM



The Drees Company
211 Grandview Drive Fort Mitchell, Kentucky 41017 PH:(859) 578-4200

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Std. Drawn By:	MRPH	Sheef Description: SCALE: VARIES	
		FIREPLACE DETAIL	
Std. Date:	02.29.20		
Date of Last Rev:	7.10.2023	g\architecture\cincinnati\cinti standard drawings\fireplace\fireplace detail sheets.dwg	

Sheet No.

F-1

RALEIGH WINDOW SCHEDULE

* MEETS EMERGENCY ESCAPE & RESCUE OPENING REQUIREMENTS

Drees General	Window Type	MI Windows and Doors Capitol Series			Drees General				
Callout	Willdow Type	Call No. Rough Opening	Call No.	Rough Opening	Callout	Call No.	Rough Opening	Call No.	Rough Opening
1660	SINGLE/DOUBLE HUNG	CW3500 1/8 x 6/0 20" x 60-1/4"							
1670 1860	SINGLE/DOUBLE HUNG SINGLE/DOUBLE HUNG	CW3500 1/8 x 7/0 20" x 84" CW3500 1/8 x 6/0 20" x 60-1/4"							
2030	SINGLE/DOUBLE HUNG	L CW3500 2/0 x 3/0 L 24" x 36"		 					
2040	SINGLE/DOUBLE HUNG	CW3500 2/0 x 4/0 24" x 48"							
2050	SINGLE/DOUBLE HUNG SINGLE/DOUBLE HUNG	CW3500 2/0 x 5/0 24" x 60-1/4" CW3500 2/0 x 6/0 24" x 72"							
2060 2070	SINGLE/DOUBLE HUNG	CW3500 2/0 x 6/0 24 x 72							
2430	SINGLE/DOUBLE HUNG SINGLE/DOUBLE HUNG	CW3500 2/0 x 7/0 24" x 84" CW3500 2/4 x 3/0 28" x 36"							
2440	SINGLE/DOUBLE HUNG	CW3500 2/4 x 4/0 28" x 48"							
2450 2460	SINGLE/DOUBLE HUNG SINGLE/DOUBLE HUNG	CW3500 2/4 x 5/0 28" x 60-1/4" CW3500 2/4 x 6/0 28" x 72"							
2830	SINGLE/DOUBLE HUNG	CW3500 2/8 x 3/0 32" x 36"							
2840	SINGLE/DOUBLE HUNG	CW3500 2/8 x 4/0 32" x 48" CW3500 2/8 x 5/0 32" x 60-1/4"							
2850 2860	SINGLE/DOUBLE HUNG	CW3500 2/8 x 5/0 32" x 60-1/4" CW3500 2/8 x 6/0 32" x 72"							
3030	SINGLE/DOUBLE HUNG SINGLE/DOUBLE HUNG	CW3500 2/8 x 6/0 32 x 72 CW3500 3/0 x 3/0 36-1/4" x 36"		+					
3040	SINGLE/DOUBLE HUNG	CW3500 3/0 x 4/0 36-1/4" x 48"							
3050	SINGLE/DOUBLE HUNG	CW3500 3/0 x 5/0 36-1/4" x 60-1/4"							
3060 3070	SINGLE/DOUBLE HUNG SINGLE/DOUBLE HUNG	CW3500 3/0 x 6/0 36-1/4" x 72" CW3500 3/0 x 7/0 36-1/4" x 84"		-					
3470	SINGLE/DOUBLE HUNG	CW3500 3/0 x 7/0 30-1/4 x 84"		 					
1050 FIXED		910T 5/0 x 1/0 59-5/8" x 11-1/2"							
1640 FIXED		910T 4/0 x 1/8 47-1/4" x 19-1/2"							
2020 FIXED 2030 FIXED		CW3500 2/0 x 2/0 24" x 24" CW3500SL 2/0 x 3/0 24" x 36"							
2040 FIXED		CW3500SL 2/0 x 3/0 24 x 30 CW3500SL 2/0 x 4/0 24" x 48"							
2050 FIXED		CW3500SL 2/0 x 5/0 24" x 60-1/4"							
2816 FIXED		910TSL 2/6 x 1/8 29-1/4" x 19-1/2" CW3500 3/0 x 6/0 36" x 72"							
2860 FIXED 3016 FIXED		910TSL 3/0 x 1/8 35-1/4" x 19-1/2"		+					
3020 FIXED		910TSL 3/0 x 2/0 35-1/4" x 23-1/2"							
3030 FIXED		CW3500P 3/0 x 3/0 36-1/4" x 36"							
3040 FIXED 3050 FIXED		CW3500P 3/0 x 4/0 36-1/4" x 48" CW3500P 3/0 x 5/0 36-1/4" x 60-1/4"		-					
3060 FIXED		CW3500P 3/0 x 5/0 36-1/4 x 60-1/4 CW3500P 3/0 x 6/0 36-1/4" x 72"							
3070 FIXED		CW3500P 3/0 x 7/0 36-1/4" x 84"							
4010 FIXED		910T 4/0 x 1/0 47-1/4" x 11-1/2"							
4020 FIXED 4030 FIXED		910T 4/0 x 2/0 47-1/4" x 23-1/2" CW3500P 4/0 x 3/0 48" x 36"							
4040 FIXED		CW3500F 4/0 x 4/0 48" x 48"							
4044 FIXED		CW3500P 4/0 x 4/4 48" x 52"							
4050 FIXED		CW3500P 4/0 x 5/0 48" x 60-1/4"							
4060 FIXED 4070 FIXED		CW3500P 4/0 x 6/0 48" x 72" CW3500P 4/0 x 7/0 48" x 84"		+					
5030 FIXED		CW3500P 5/0 x 3/0 60" x 36"							
5040 FIXED		CW3500P 5/0 x 4/0 60" x 48"							
5060 FIXED 5070 FIXED		CW3500P 5/0 x 6/0 60" x 72" CW3500P 5/0 x 7/0 60" x 84"							
6020 FIXED		910T 6/0 x 2/0 71-5/8" x 23-1/2"		 					
6050 FIXED		CW3500P 6/0 x 5/0 72" x 60-1/4"							
6060 FIXED		CW3500P 6/0 x 6/0 72" x 72"							
3'-0" HALF ROUND 4'-0" HALF ROUND		CW3500 3/0 HC 36-1/4" CW3500 3/0 HC 48"		+					
5'-0" HALF ROUND		CW3500 3/0 HC 60"							
2020 OCTAGON		CW3500 2/0 OCT 24"							
2'-4" QUARTER ROUND 3'-0" QUARTER ROUND		CW3500 2/4 QC 28" CW3500 3/0 QC 36-1/4"							
3-U QUAKTEK KU	עוויט	CW3300 3/0 QC 30-1/4							



Drees Homes

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Sheet Description:

WINDOW SCHEDULE

Sheet No.

MOULDED MILLWORK SCHEDULE

LAST REVISED 11/22/1

Droos Coporal Callout	Number	Fypon
Drees General Callout	Nuwood	* *
ARCHED HEADER D1	H8xxEFR	N/A
ARCHED HEADER D1K	H8xxEFKR	N/A
ARCHED HEADER D2	H8xxEFTR	N/A
ARCHED HEADER D2K	H8xxEFTKR	N/A
ARCHED HEADER D3	AH10xx	WCHSEGxxX10
ARCHED HEADER D3K	N/A	WCHSEGxxX10K
ARCHED HEADER D4	AR5xx	ARxxX6M
ARCHED HEADER D4K	AR5xxK	ARXXX6MK
ARCHED HEADER D5	AR10xxEC	ARXXX6METAR6C
ARCHED HEADER D5K	AR10xxECK	ARXXX6METAR6CK
ARCHED HEADER D6	AR10xxC	ARXX10MC
ARCHED HEADER D6K	AR10xxCK	ARXXX10MCK
ARCHED HEADER D7K	H7xxEF-4K	N/A
ARCHED HEADER D8	AR14xxC	ARXXX14MC
ARCHED HEADER D8K	AR14xxCK	ARXXX14MCK
ARCHED HEADER D9	H9xxE	WCHARSxx13
CROSSHEAD A1	H9xx	WCHxxX9N
CROSSHEAD A1K	H9xxK	WCHxxX9NK
CROSSHEAD B1	H14xxBT	WCHxxX14BT
CROSSHEAD B1K	H14xxBTK	WCHXXX14BTK
CROSSHEAD B2	H12xx	WCHxxX12
CROSSHEAD B2K	H12xxK	WCHxxX12K
CROSSHEAD C1	H18xxBT	WCHxxX14BT
CROSSHEAD C1K CROSSHEAD C2	H18xxBTK	WCHxxX14BTK LDCHxxX18
	H18xxBT-PA	LDCHXXX18 LDCHXXX18K
CROSSHEAD C2K	H18xxBTK-PA	
CROSSHEAD Z-E1-HDR	Z-E1-HDR Z-E2-HDR	Z-E1-HDR Z-E2-HDR
CROSSHEAD Z-E2-HDR CROSSHEAD Z-E3-HDR	Z-E2-HDR Z-E3-HDR	Z-EZ-HDR Z-E3-HDR
CROSSHEAD Z-E3-ARCHHDR	Z-E3-HDR Z-E3-ARCHHDR	Z-E3-HDR Z-E3-ARCHHDR
CROSSHEAD Z-E3-ARCHHDR	Z-E3-ARCHHDR Z-E3-CLHDR	Z-E3-ARCHHDR Z-E3-CLHDR
CROSSHEAD Z-E5-CLHDR	Z-E5-CLHDR Z-E5-HDR	Z-E5-CLHDR Z-E5-HDR
WINDOW HEADER A1	-	WCHxxX6
WINDOW HEADER AT WINDOW HEADER ATK	H6xx	WCHXXX6 WCHXXX6K
WINDOW HEADER ATK WINDOW HEADER B1	H6xxK	
WINDOW HEADER B1K	H9xx-2 H9xx-2K	WCHxxX9N WCHxxX9NK
WINDOW HEADER BT	H9xxBT	WCHXXX7NN WCHXXX10NBT
WINDOW HEADER B2K	H9xxBTK	WCHXXX10NBTK
WINDOW HEADER C1	H9xx	CCAxxX10
WINDOW HEADER CTK	H9xxK	CCAXXX10 CCAXXX10K
WINDOW HEADER C2	H9xxT	WCHxxX9T
WINDOW HEADER C2K	H9xxTK	WCHXXX7T WCHXXX9TK
WINDOW HEADER C3	H12xxBT	WCHXXX10BT
WINDOW HEADER C3K	H12xxBTK	WCHXXX10BTK
WINDOW HEADER C3R	H14xxBT	WCHXXX10BIK WCHXXX14BT
WINDOW HEADER D1	H7xxF-4	N/A
WINDOW HEADER D1K	H7xxF-4K	N/A
WINDOW HEADER D2K	H9xxK-1	N/A
WINDOW HEADER Z-W1	Z-W1	Z-W1
WINDOW HEADER Z-W3	Z-W3	Z-W3
WINDOW HEADER Z-W3K	7-W3K	Z-W3K
WINDOW HEADER Z-W3D	Z-W3D	Z-W3D
WINDOW HEADER Z-W4	Z-W4	Z-W4
WINDOW HEADER Z-W4K	Z-W4K	Z-W4K

PILASTERS							
Drees General Callout	Nuwood	Fypon					
FLUTED PILASTER A1	PL7xxF	PIL7Xxx					
FLUTED PILASTER B1	PL9xxF	PIL9Xxx					
FLUTED PILASTER C1	PL11xxFM	PIL11Xxx					
PANEL PILASTER A2	PL7xxP	PIL7XxxDP					
PANEL PILASTER B2	PL9xxP	PIL9XxxDP					
PANEL PILASTER C2	PL11xxPM	PIL11XxxDP					
PILASTER D1	M311-9	PIL10XxxA					
PILASTER D2	M323-9	N/A					
PILASTER Z-E1-PIL	Z-E1-P I L	Z-E1-P I L					
PILASTER Z-E2-PIL	Z-E2-PIL	Z-E2-PIL					
PILASTER Z-E3-PIL	Z-E3-PIL	Z-E3-PIL					
PILASTER Z-PIL-EXT	Z-PIL-EXT	Z-PIL-EXT					
PLAIN PILASTER A3	PL7xxS	PIL7XxxP					
PLAIN PILASTER B3	PL9xxS	PIL9XxxP					
PLAIN PILASTER C3	PL11xxS	PIL11XxxP					
PLINTH D1	PF10	ADD "P" TO END OF PILASTER					
PLINTH D2	P14.5	N/A					
LOUVERS							

Drees General Callout	Nuwood	Fypon	Mid-America
CATHEDRAL LOUVER D1	CLV1224	CLV12X24	
CATHEDRAL LOUVER D1T	CLV1224TRIM4	CLV12X24X4F	
CATHEDRAL LOUVER D2	CLV1432	CLV14X32	
CATHEDRAL LOUVER D2T	CLV1432TRIM4	CLV14X32X4F	00 44 1422
CATHEDRAL LOUVER D3	CLV2232	CLV22X32	
CATHEDRAL LOUVER D3T	CLV2232TRIM4	CLV22X32X4F	
HALF CIRCLE LOUVER D1	HRLV32	HRLV32X16	
HALF CIRCLE LOUVER D1T	HRLV32TRIM4	HRLV32X4F	
HALF CIRCLE LOUVER D2	HRLV36	HRLV36X18	

HALF CIRCLE LOUVER DT	HRLV32	HRLV32X16	
HALF CIRCLE LOUVER D1T	HRLV32TRIM4	HRLV32X4F	
HALF CIRCLE LOUVER D2	HRLV36	HRLV36X18	
HALF CIRCLE LOUVER D2T	HRLV36TRIM4	HRLV36X4F	00 43 2234
OCTAGONAL LOUVER D1	OLV24	OLV24	
OCTAGONAL LOUVER D12	OLV24TRIM4	OLV24X4F	
OVAL LOUVER D1	OLV2537	OLV37X25	
OVAL LOUVER D1T	OLV2537TRIM4	OLV37X25X4F	
RECTANGUAR LOUVER D1	LV1224V	LV12X24	00 45 1218
RECTANGUAR LOUVER D1T	LV1224VTRIM4	LV12X24-4F	00 45 1218
RECTANGUAR LOUVER D2	LV1636V	LV16X36	
RECTANGUAR LOUVER D2T	LV1636VTRIM4	LV16X36-4F	
RECTANGUAR LOUVER D3	LV2436V	LV24X36	
RECTANGUAR LOUVER D3T	LV2436VTRIM4	LV24X36-4F	
RECTANGUAR LOUVER D4	LV2424V	LV24X24	
RECTANGUAR LOUVER D4T	LV2424VTRIM4	LV24X24-4F	
ROUND LOUVER D1	RLV18	RLV18	
ROUND LOUVER DIT	RLV18TRIM4	RLV18X4F	
ROUND LOUVER D2	RLV22	RLV22	
ROUND LOUVER D2T	RLV22TRIM4	RLV22X4F	
TRIANGULAR LOUVER D1		TRLVxxX36	00 47 0x0x
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BRACKETS

Drees General Callout	Nuwood	Fypon
EXTERIOR BRACKET D1	BR437	N/A
EXTERIOR BRACKET D2	DB102	DTLB6X4X6
EXTERIOR BRACKET D3	BR304 (7" WIDE)	BKT24X24X7
EXTERIOR BRACKET D4	BR455	N/A
EXTERIOR BRACKET D5	BR300-1	BKT12X12X6
EXTERIOR BRACKET D6	BR300	BKT12X12
EXTERIOR BRACKET D7	BR409	BKT16X18X3
EXTERIOR BRACKET D8	BR413	DTLB5X5X3
EXTERIOR BRACKET D9	TBD	BKT11X20
EXTERIOR BRACKET D10	TBD	BKT12X24X3
EXTERIOR BRACKET D11	BR435	BKT25X27
EXTERIOR BRACKET D12	BR404	BKT16X30X4
EXTERIOR BRACKET D13	BR23.13x10.13x5.5	N/A
GABLE BRACKET D1	TBD	DTLB6X4X6R(OR L)PITCH
GABLE BRACKET D2	BR423-x:12	BKT5X20
GABLE BRACKET D3	BR424-x:12	BKT5X20 (CUT 2" PROJECTION)

MOULDINGS			
Drees General Callout	Nuwood	Fypon	
BAND MOULD D1	M210-16	MLD612-12	
BAND MOULD D2	M301-16	MLD220-16	
BARGE MOULD D1	WM210	WM210	
CASE MOULD D1	M320-16	MLD226-16	
CASE MOULD D2	N/A	MLD244-12	
CROWN MOULD D1	M404-16	MLD572-16	
DENTIL MOULD D1	M105-16	MLD310-16	
DENTIL MOULD D2	M108-8	MLD353-8	
HALF ROUND MOULD D1	N/A	MLD605-12	
PANEL MOULD D1	M310-8 OR 16	MLD612-12	

PEDIMENTS / COMBO HEADERS

Drees General Callout	Nuwood	Fypon
BROW COMBO D1	BCxx	CSAPxx
PEAK PEDIMENT D1	Pxx-4 (6:12)	PCPxx
PEAK PEDIMENT Z-E1-PED	Z-E1-PED	Z-E1-PED
PEAKED COMBO D1	PCxx-4	CPCPxx
RAMS HEAD PEDIMENT D1	Rxx	RHPxx00
ROUND PEDIMENT D1	Bxx-4	PSPxx
SUNRISE COMBO D1	SCxx-4	CSPxx
VICTORIAN PEDIMENT D1	VPxx	DVPxx w/ SWDHxxXxx

WINDOW DECORATION

Drees General Callout	Nuwood	Fypon
HALF CIRCLE SUNBURST D1	SPxxxx	SWDHxxXxx
PALLADIAN WINDOW D1	H9AR10-xx xx" FL/FR	ARxxX10MFLxxx
PALLADIAN WINDOW D1K	H9AR10-xxK xx" FL/FR	ARxxX10MFLxxx with K10TM
PALLADIAN WINDOW D2	H9AR10SPxxxx	ARxxX10MFLxxx with
		SWDHxxXxx
PALLADIAN WINDOW D2K	H9AR10SPxxxxK	ARxxX10MFLxxx with
		SWDHxxXxx and K10TM
PEAKED CAP HEADER D1	N/A	CHPCxxX15
PLAIN SEGMENT D1	SPxxxxP	PSPxx
SEGMENT SUNBURST D1	SPxxxx	SWDHxxXxx

ACCESSORIES

Drees General Callout	Nuwood	Fypon
GABLE D1	PGDx12	GPA (width X height)
KEYSTONE D1	KY14F-3	KY14
KEYSTONE D2	KYHM9F	К9М
WREATH D1	N/A	WAB34



Sheet Description:

MOULDED MILLWORK SCHEDULE

Sheet No.