REVISION LOG

REVISION:001

ADJUST OPTION SQUARE FOOTAGES TO ACCURATELY SHOW THE DIFFERENCES FROM THE BASE PLAN SQUARE FOOTAGE TOTALS.

REVISION:002

RELOCATE FRONT DOOR TO ALIGN W/ GARAGE WALL. ADJUST FOUNDATION AND OPTIONS

accordingly.

2. Add wall & door at foyer for optional smart door delivery center.

3. Note door into main house w/ optional smart door delivery center to be 3068 3/4

CHANGE DOOR WIDTH FROM 2/6 TO 2/4 @ BATH #3, BED #3 CLOSET, BATH #2, BED #2

CLOSET AND OPT. BED #5.

6. FUP PANTRY SHELVES, DELETE DOOR ACCESSED FROM DROP ZONE & ADD 2/4 DOOR

ACCESSED FROM MESSY KITCHEN.
DIMENSION TO CENTER OF TRIPLE WINDOWS ONLY.

MAKE ALL STUD POCKETS 4 1/2".

ADD NOTE AT FIREPLACE FOR A "42"X39" R.O." FOR FIREBOX

9. AUD NOTE AT PREPURCE FOR A 42 X39 K.V. FOR PRESENT.

10. RELOCATE WALL UNDER STAIR & NOTE © 36" WALL HT (V.I.F.).

11. ADD GOURMET KITCHEN, ALTERNATE KITCHEN AND ALTERNATE GOURMET KITCHEN OPTIONS.

12. DELETE 2ND WINDOW NEAREST TO CONNER ® POCKET OFFICE OPTION.

13. DELETE OPTIONAL PARTRY DOOR LOCATION.

14. CHANGE SIDELOAD GARAGE FRONT WINDOWS FROM 5/0 HT TO 6/0 HT.

15. ADD 8" DEEP CHASE BEHIND 2ND FL LINEN CLOSET @ HALL.

16. RELOCATE WATER HEATER AT SIDELOAD GARAGE UNDER NEW LINEN CLOSET CHASE.

17. DECREASE DEPTH OF CHASE BEHIND OWNERS BATH WATER CLOSET TO 10" TO INCREASE WATER CLOSET DEPTH TO 6"-1".

18. MOVE OWNERS VANITY WALL UP TO ALLOW ROOM IN LAUNDRY FOR CHASE @ LINEN, OPT 30"
CAB W/ OPT L.T. AND WASHER/DRYER.

19. ADD PULL DOWN STAIR IN LAUNDRY. NOTE "25 1/2" X 54 1/2" R.O."

20. ADD 18"X24" CHASE IN OWNERS WIC CLOSET @ SHOWER WALL.

21. MAKE BATH#2 VANITY 60".

22. MAKE WC @ BED#2 5"-4" DEEP, ADDING 3" TO BATH #2.

23. MOVE BATH#2 TOILET, TUB AND WINDOW 3" TOWARD FRONT OF HOUSE.

24. MAKE WINDOW IN BED #2 CLOSET TEMPERED.

REVISION:003

DATF: 2/4/2022

DIMENSION TRIPLE STUD POCKETS
RELOCATE ISLAND PER REDLINES.
REMOVE WINDON IN MESSY KITCHEN
FULL HEIGHT WALL AT END OF CABINETS ON GARAGE ADJACENT WALL.
REMOVE UNDER-COLUNIER SIDE WALLS IN ISLAND.
SHOW AND CALL OUT DROP ZONE BENCH AS 18" DEEP.

VERIFY CASED OPENINGS ARE 3/0X6/8 ON 1ST FLOOR.
ELIMINATE ALT KITCHEN
MATCH BASE PLAN LOCATION FOR WATER HEATER IN SIDE LOAD GARAGE.

3/4 LITE ENTRY DOOR.

11. Create shower option with 18" seat.
12. Resze standard shower to 60x36. Extend full height wall at standard shower.
13. Add 2x6 wall just inside exterior wall for opt. Super shower w/ opt. 2nd floor.

13. AUU ZAG WALL JUST INSUE EXTENDIN MALL FOR OPT. SUPEN STUMEN MY OPT. ZMD FLOUR.

14. ALL LIBEN CALLED OUT AS (4) SHELVES.

15. POCKET DOORS CHANGE TO STANDARD 2/4 IN OWNER'S WC TO LAUNDRY.

16. EXTEND REAR PORCH 6" SO BEAM BEARS ON CAFE WALL.

17. CHANGE COLUMNS TIO 6X6 P.T. WITH IX WRAP FOR TRADITIONAL ELEVATION.

18. CHANGE REAR PORCH COLUMNS TIO 6X6 P.T. POST, NO WRAP.

19. CHANGE ENTRY DOOR TO 3/4 LITE

20. EXTEND PORCH SLAB 4" AT FRONT AND EXTEND AROUND CORNER 20" TO SUPPORT STONE VENEER.

21. REMOVED HALF WALLS AT KITCHEN ISLAND AND UPDATED PER CABINET PROVIDER
22. CHANGED THE BASE OWNER'S BATH WINDOW TO 4010
24. CHANGED THE OWNER'S BATH OPTION SHOWER W/18" SEAT WINDOW TO 4010

24. CHANGED THE OWNER'S BATH OPTION SUPER SHOWER MINDOWS TO (2)3010
25. CHANGED THE OPTION 2ND FLOOR OWNER'S BATH WINDOW TO 4010
26. CHANGED THE OPTION 2ND FLOOR OWNER'S BATH OPTION SUPER SHOWER WINDOWS TO (2)3010

20. CHANGED 2ND FLOOR WINDOW OVER PORCH TO BE 2040 ALL ELEVATIONS
28. UPDATED THE WINDOW HEADER AT THE STAIR LANDING TO BE 8'-10" ABOVE LANDING
29. RE-CENTERED GEORGIAN PORCH TO BE CENTERED ON THE WINDOW ABOVE
30. ADDED AN EXTENDED PORCH OPTION TO THE TRADITIONAL ELEVATION ONLY

REVISION:004

CHANGED 2ND FLOOR WINDOW OVER PORCH TO BE 2040 ALL ELEVATIONS

UPDATED THE WINDOW HEADER AT THE STAIR LANDING TO BE 8"-10" ABOVE LANDING CHANGED SIZE OF GEORGIAN PORCH TO BE CENTERED ON THE WINDOW ABOVE CHANGED STYLE OF GEORGIAN COLUMNS FROM ROUND TO SQUARE ADDED AN EXTENDED PORCH OPTION TO THE TRADITIONAL ELEVATION ONLY ADDED ELECTRICAL PLAN SHEETS

REVISION:005

ADD "STEM WALL" TO CRAWL ELEVATION TITLES AND ADD NOTE "SEE FOUNDATION

PAGES FOR FOUNDATION TYPE". UPDATE SHEET TITLES

REVISION:007

DATE: 11/28/2023

ADD 6" TO THE SIDE OF THE PATIO/DECK/COVERED PORCH TO THE BEAM FOR THE ROOF OF THE COVERED PORCH HAS A BEARING POINT.

11-14-23 - Initial Redlines 11-17-23- Added 3rd Car **Garage Sheets**

SF 12-18-23 - Added Bathroom 3 Shower

Lot 163 DC - Duncan's Creek Rd., Lillington, NC 27546

Trademark Plus

NC.



8'-0" Tall Garage doors for 2 car side load and third car garage

PLAN 4 The Selma RH **'ENGLISH COUNTRY'**

Sheet No.	Sheet Description
0.0	Cover Sheet
1.1	Foundation (Slab)
1.1.1	Foundation Options (Slab) Foundation (Crawl)
1.2.1	Foundation Options (Crawl)
1.3	Foundation (Stem Wall Slab)
1.3.1	Foundation Options (Stem Wall Slab)
2.1	First Floor Plan
2.1.1	First Floor Plan Options
2.2	Second Floor Plan
2.2.1	Second Floor Plan Options
2.4	Covered Porch Plans & Elevations (Slab)
2.4.1	Covered Porch Plans & Elevations (Crawl/Stem Wall)
2.5	Side Load Garage Elevations (Slab)
2.5.1	Side Load Garage Elevations (Crawl/ Stem Wall)
3.1	Front & Rear Elevations (Slab)
3.1.1	Front & Rear Elevations (Crawl/Stem Wall)
3.2	Side Elevations (Slab)
3.2.1	Side Elevations (Crawl/Stem Wall)
3.3	Roof Plan
5.1	First Floor Electrical
5.1.1	First Floor Options Electrical
5.2	Second Floor Electrical
5.2.1	Second Floor Options Electrical

SQUARE	FOOTA	4GE
	'ENGLISH COUN	try' elevat i on
	UNHEATED	HEATED
FIRST FLOOR	0	1194
SECOND FLOOR	0	1452
FRONT PORCH (CRAWL)	149	0
FRONT PORCH (SLAB)	158	0
REAR PATIO/DECK	210	0
2 CAR GARAGE	415	0
SUBTOTALS	790-	2646
TOTAL UNDER ROOF	35	76
OI	PTIONS	
	UNHEATED S.F.	HEATED S.F.
OPT. POCKET OFFICE	0	+64
FIREPLACE BUMPOUT	0	+34
COVERED PATIO/DECK	210	0
3rd Car Garage Option	+323	+40

DESIGN CRITERIA:

THIS PLAN IS TO BE BUILT IN CONFORMANCE WITH THE 2018 NORTH CAROLINA STATE BUILDING CODE: RESIDENTIAL CODE

DIMENSIONS SHALL GOVERN OVER SCALE, AND CODE SHALL GOVERN OVER DIMENSIONS.


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1 Cover Sheet 'English Country' THE SELMA 4 **PLAN**


> DRAWN BY: South Designs ISSUE DATE: 7/1/2021


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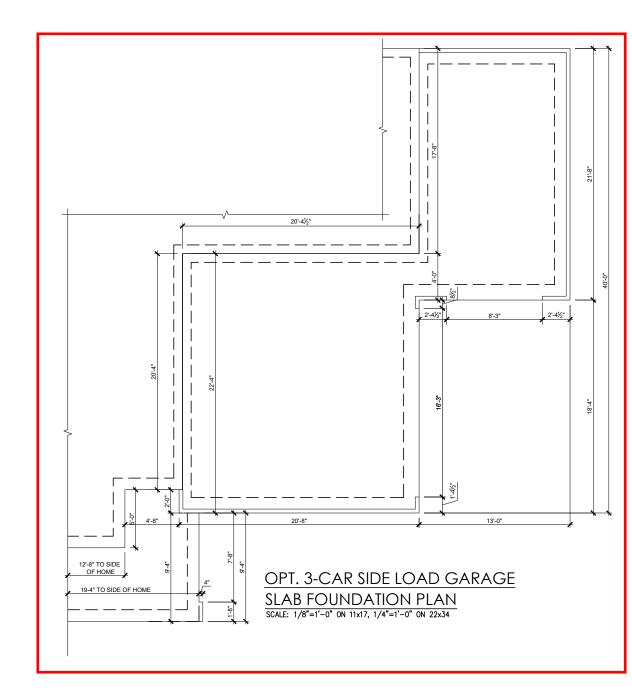


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PLAN 4 - THE SELMA - LH

Slab Foundation Options 'English Country' DRAWN BY: South Designs

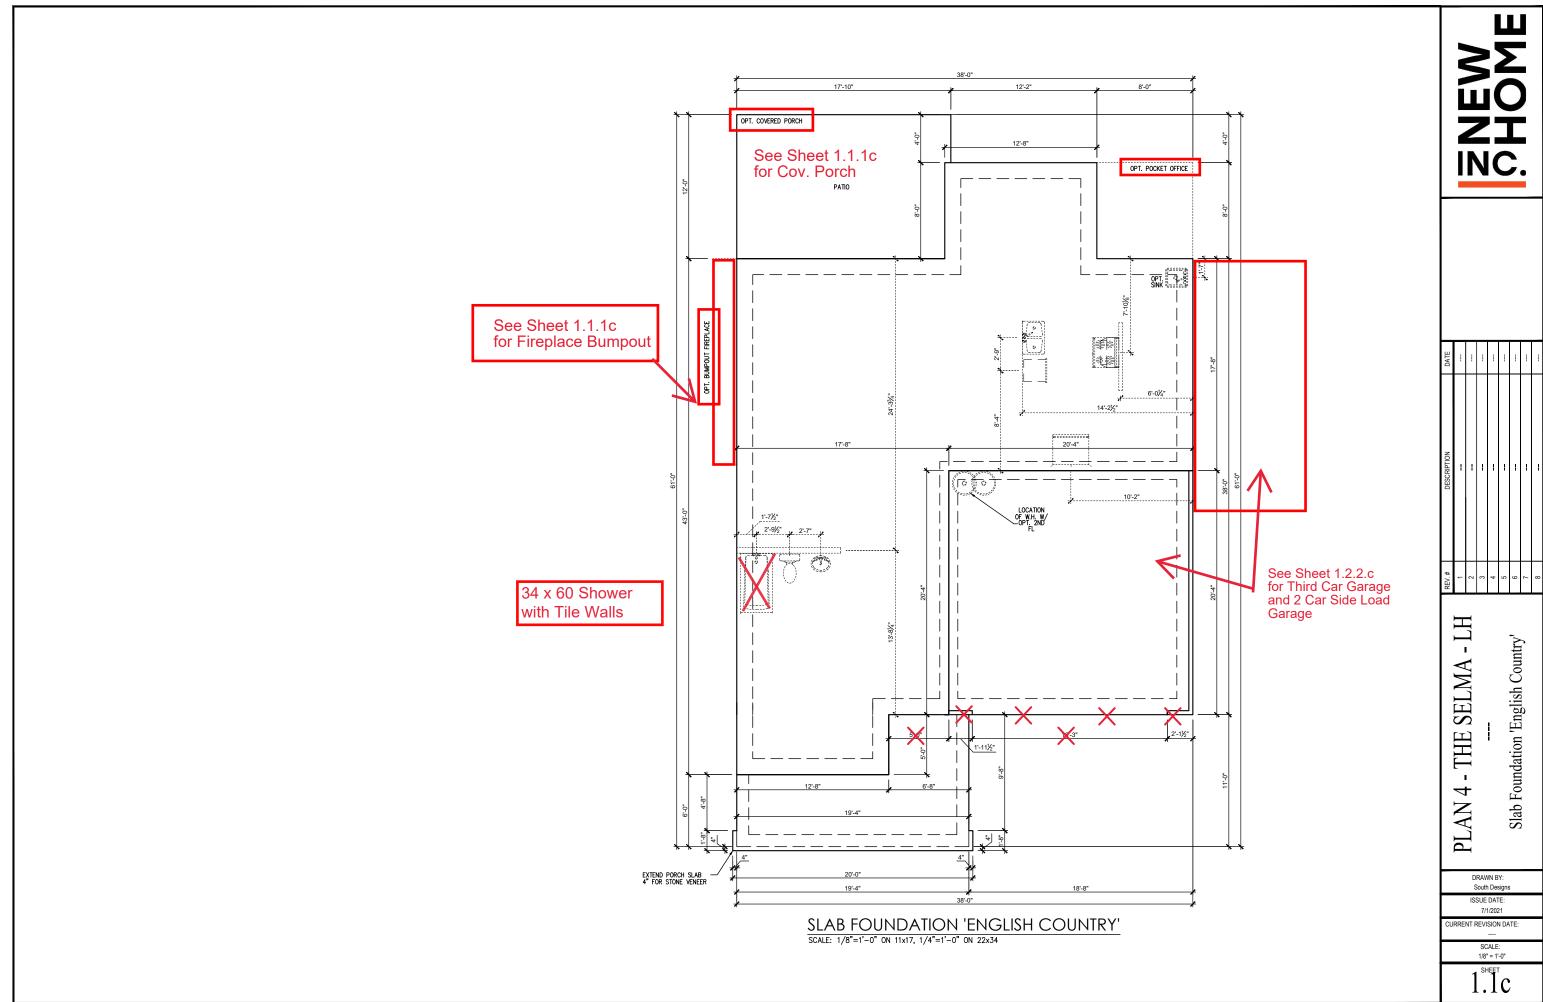ISSUE DATE: 7/1/2021 CURRENT REVISION DATE:

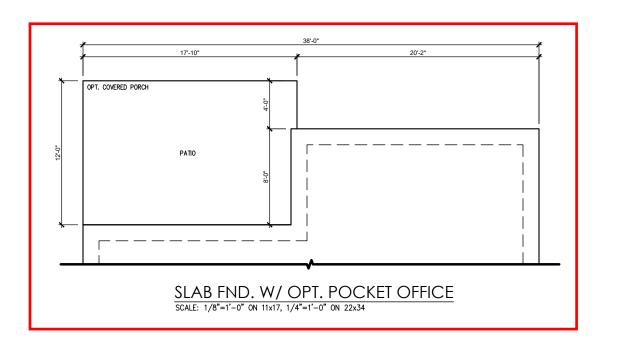

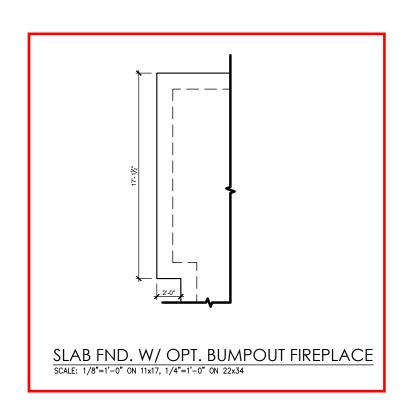

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THE SELMA - RH

DRAWN BY: South Designs

ISSUE DATE: 7/1/2021


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SCALE: 1/8" = 1'-0"

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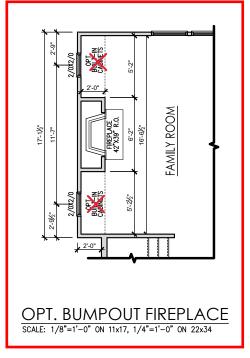
General Floor Plan Notes shall apply unless noted otherwise on plan.


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- Soffits, Coffered Ceilings, Trey Ceilings and other significant ceiling plan elements are shown on the floor plans and are denoted as single dashed lines. Unless specifically call out as included, Kitchens do not include soffits over wall cabinetry.
- Door & Window Frames, where occurring near corners, shall be a minimum of 4 1/2" from corner. Except for walk-in closets with doors near a corner, doors at closets shall be centered on closet.
- Windows: Shall have at least (1) window in each sleeping room, that meets egress. Shall be provided with tempered glass at hazardous glazing areas. False windows shall be installed with obscure glazina.
- Closets for clothing or coat storage shall be equipped with 1 rod/shelf. Closets for linen shall have 4 open equal shelves. Closets for pantries shall have 4 equal wood shelves, painted.
- Stair treads shall be a min of 9" deep, risers shall be a maximum of 8 1/4", unless noted otherwise, per the current North Carolina Residential Code
- 10. Handrails and Guards at stairs shall be 34" above the finished surface of the ramp surface of the stair. Handrails at landings and overlooks of multilevel spaces shall be 36" above finished floor. Guards (pickets or balusters) shall be spaced with no more than 4" between guards.
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- 12.Garage Door to Living Space shall be 2'-8" x 6'-8" minimum size and shall be 20 minute fire rated and weather sealed
- 13. Garage Walls, as a minimum, shall be separated from living space by installing 1/2" gypsum board on the garage side of the wall. With habitable space above, the inside of all garage walls require 1/2" GWB supporting 5/8" type X GWB on ceiling.





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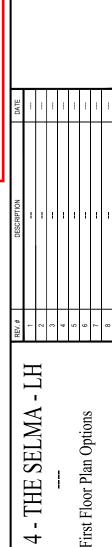
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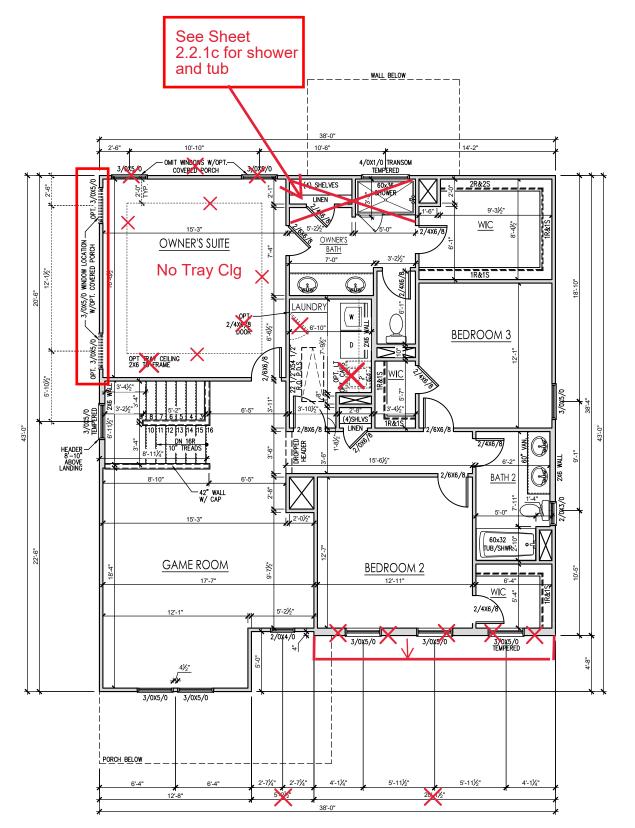
THE SELMA 4 **PLAN**

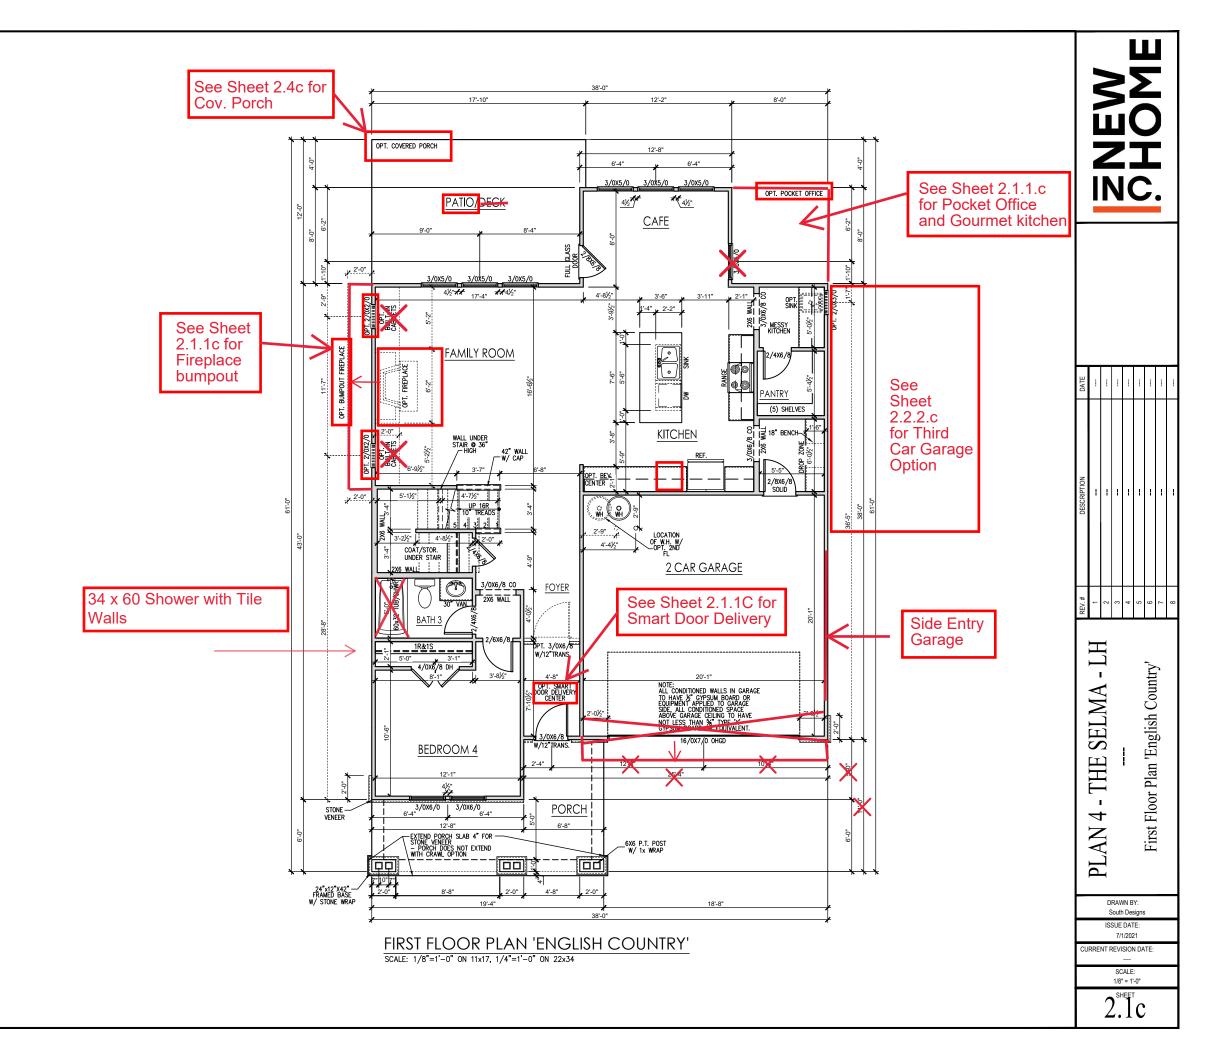DRAWN BY: South Designs ISSUE DATE: 7/1/2021

URRENT REVISION DATE: 1/8" = 1'-0"

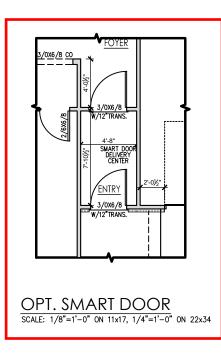General Floor Plan Notes shall apply unless noted otherwise on plan.
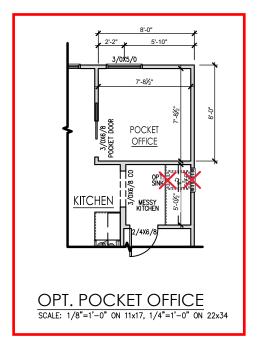
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SECOND FLOOR PLAN 'ENGLISH COUNTRY'

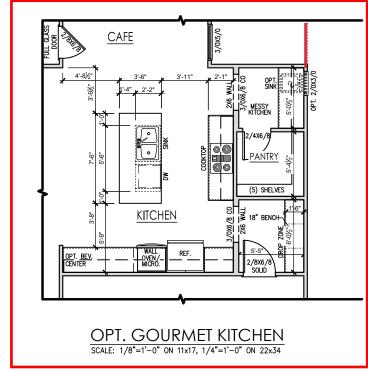SCALE: 1/8"=1'-0" ON 11x17, 1/4"=1'-0" ON 22x34

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---Second Floor Plan 'English Country'

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SELMA

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PLAN

DRAWN BY: South Designs ISSUE DATE:


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> SCALE: 1/8" = 1'-0"

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PLAN 4 - THE SELMA --- Second Floor Plan Options


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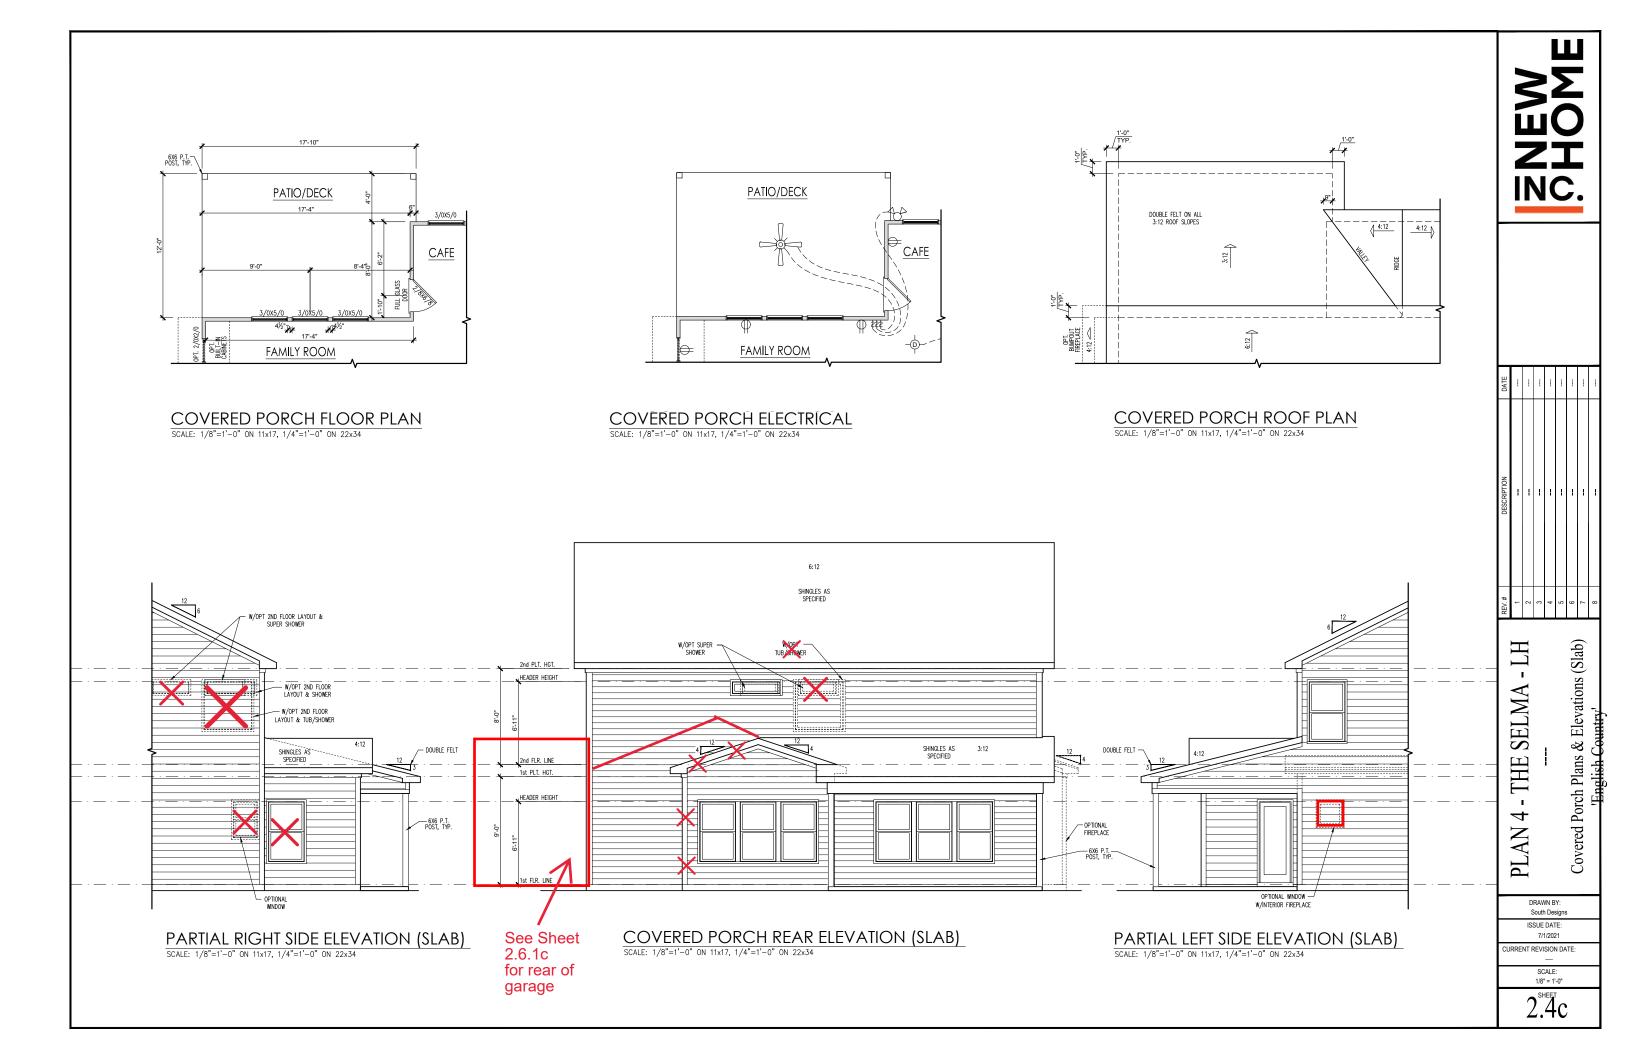
DRAWN BY: South Designs ISSUE DATE: 7/1/2021

CURRENT REVISION DATE:

1/8" = 1'-0"
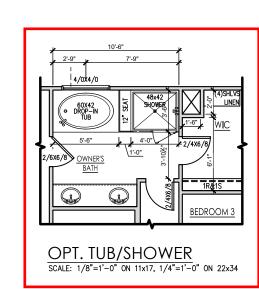
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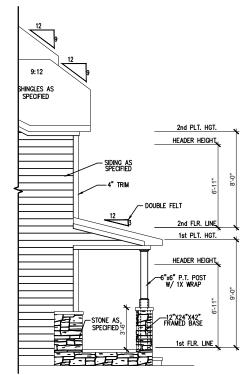
General Elevation Notes

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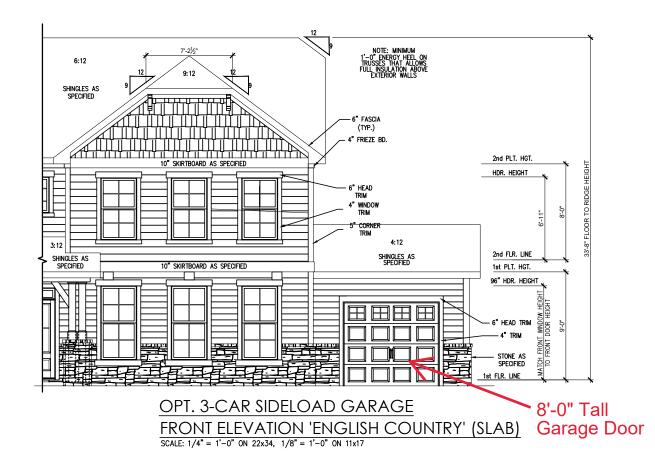
- Roof shall be finished with architectural c shingles with slopes as noted on plan.
- Ridge Vent shall be provided and installed on all ridges greater than 6' in length per manufacturer's specifications.
- Soffit Vent shall be continuous soffit vent
- House Wrap, "tyvek" or approved equal shall be installed over entire exterior wall per manufacturer's specifications and recommendations.
- Flashing shall be provided above all door and window openings, above finish wall material changes and at wall surfaces where lower roof areas abut vertical wall surfaces.
- Porch Railings shall be provided at all porch walking surfaces greater than 30" above adjacent finished grade. It shall be 35" high with guards spaced no more than 4" apart. Consult community specifications for material.
- Finish Wall Material shall be as noted on elevation
- Brick Veneer, if included on elevation shall be fied to wall surface with galvanized corrugated metal fies at a rate of 24° oc horizontally and 16° oc vertically so that no more than 2.674 of brick is supported by (1) fie. Space between face of wall and back face of brick shall be limited to a maximum of 1°. Ratshing shall be provided behind brick above all wall openings and at base of brick wall. Flashing shall be a minimum of 6 mil poly or other corrosion resistant material and shall be installed so that flaps under the house wap material a minimum of 2°. Weepholes shall be provided at a rate of 48° oc and shall not be less than 3/16° in diameter and shall be located immediately above flashing.
- Brick Veneer Support Lintels shall be provided if brick veneer is included on elevation. Lintels shall be provided as listed in the following schedule and shall have a minimum bearing length of 6". Masomy Lintels shall be provided so that deflection is limited to 1/600.

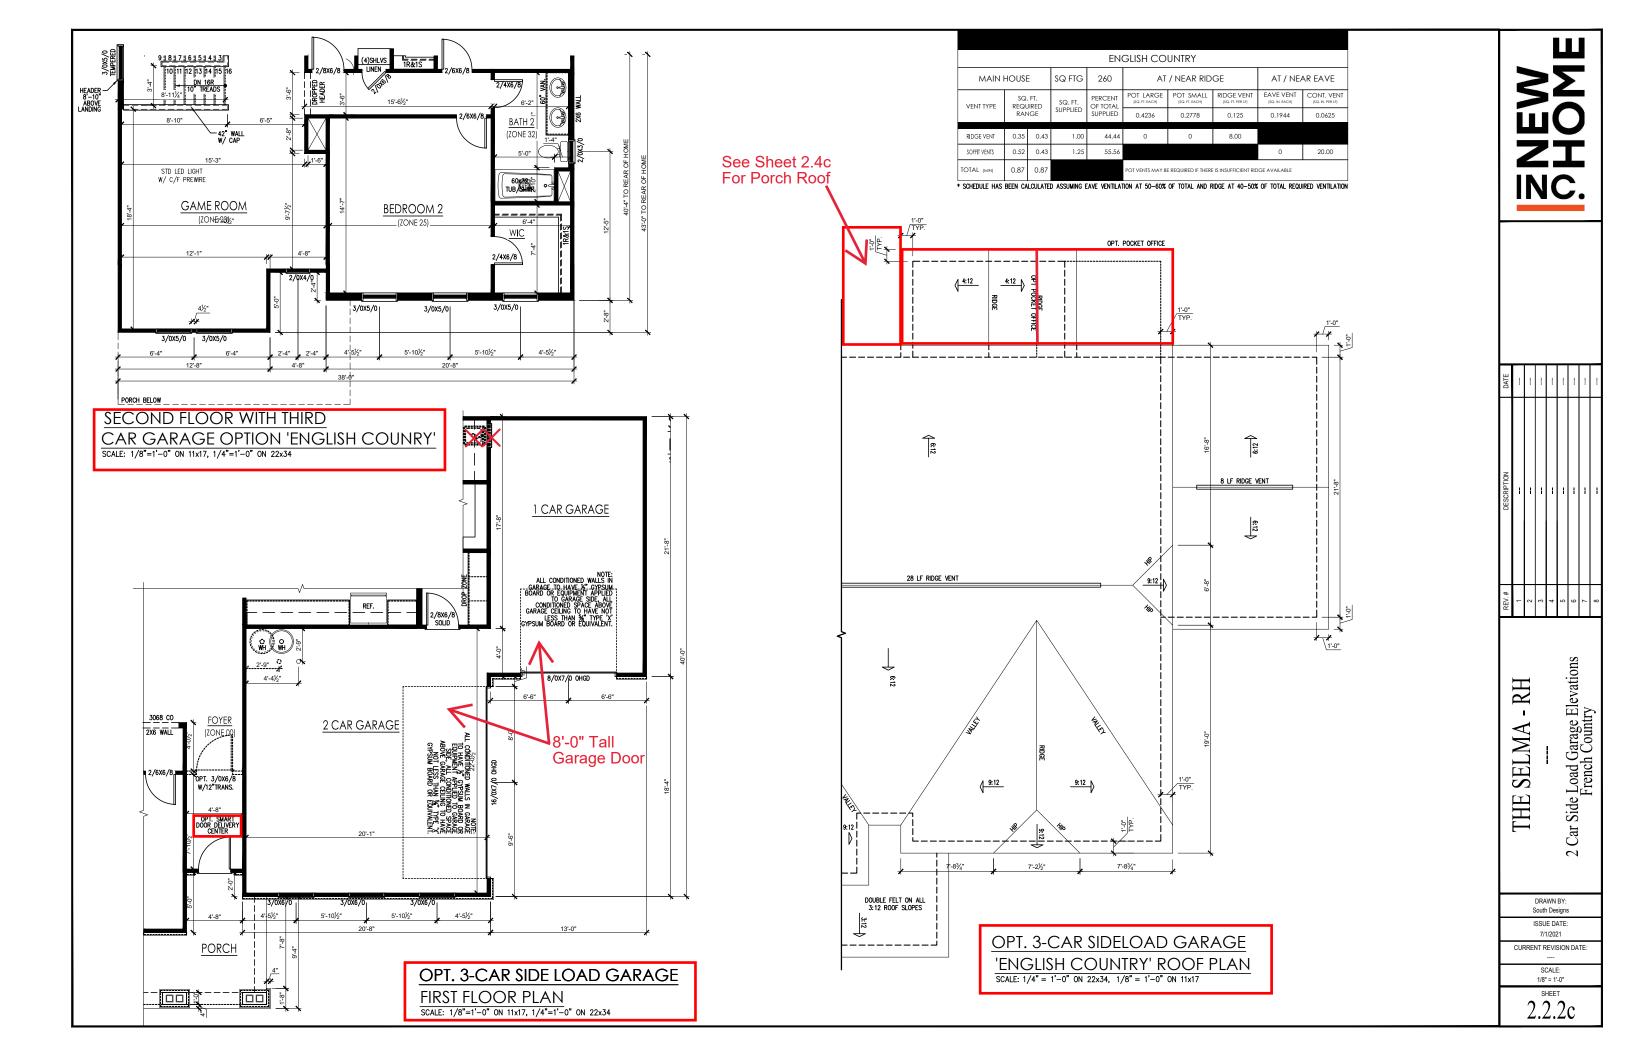Opening Size	Angl


up to	4'-0"		3-1/2" x 3-1/2" x 5/16
4'-1"	to	5'-6"	4" x 3-1/2" x 5/16" LLV
5'-7"	to	6'-6"	5" x 3-1/2" x 5/16" LLV
6'-7"	to	8'-4"	6" x 3-1/2" x 5/16" LLV
8'-5"	to	16'-4"	7" x 4" x 3/8" LLV



OPT. 3-CAR SIDELOAD GARAGE LEFT SIDE ELEVATION 'ENGLISH COUNTRY' SCALE: 1/4" = 1'-0" ON 22x34, 1/8" = 1'-0" ON 11x17





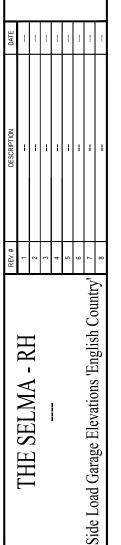

- RH SELMA THE

South Designs

ISSUE DATE: 7/1/2021 CURRENT REVISION DATE:

> SCALE: 1/8" = 1'-0"

SHEET 2.6c


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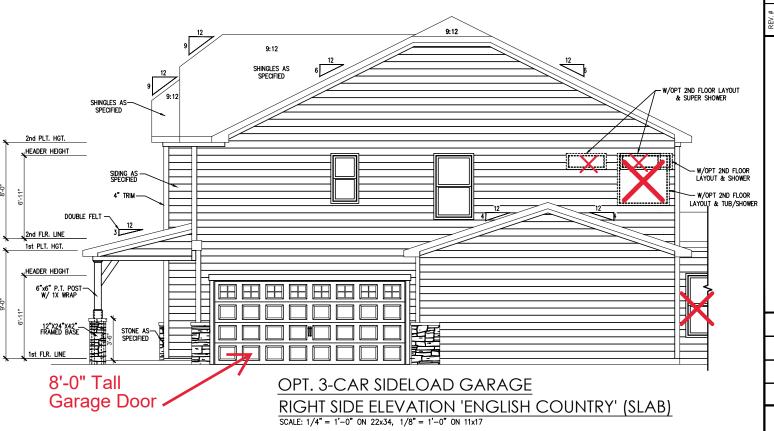
- Roof shall be finished with architectural composition shingles with slopes as noted on plan.
- Ridge Vent shall be provided and installed on all ridges greater than 6' in length per manufacturer's specifications.
- 3. Soffit Vent shall be continuous soffit vent
- House Wrap, "tyvek" or approved equal shall be installed over entire exterior wall per manufacturer's specifications and recommendations.
- Flashing shall be provided above all door and window openings, above finish wall material changes and at wall surfaces where lower roof areas abut vertical wall surfaces.
- Porch Railings shall be provided at all porch walking surfaces greater than 30" above adjacent finished grade. It shall be 36" high with guards spaced no more than 4" apart. Consult community specifications for material.
- Finish Wall Material shall be as noted on elevation drawings.
- 8. Brick Veneer, if included on elevation shall be tied to wall surface with galvanized corrugated metal ties at a rate of 24" oc horizontally and 16" oc vertically so that no more than 2.67st of brick is supported by (1) tie. Space between face of wall and back face of brick shall be limited to a maximum of 1". Rashing shall be provided behind brick above all wall openings and at base of brick wall. Flashing shall be a minimum of 6-mil poly or other corrosion resistant material and shall be installed so that it lops under the house wrap material a minimum of 2". Weepholes shall be provided at a rate of 48" oc and shall not be less than 3,716" in diameter and shall be located immediately above flashing.
- Brick Veneer Support Lintels shall be provided if brick veneer is included on elevation. Lintels shall be provided as listed in the following schedule and shall have a minimum bearing length of 6". Masonry Lintels shall be provided so that deflection is limited to L/600.

Masonry Openina Lintel Schedule

nina Size	Angle

up to 4'-0"		3-1/2" x 3-1/2" x 5/16"
4'-1" to	5'-6"	4" x 3-1/2" x 5/16" LLV
5'-7" to	6'-6"	5" x 3-1/2" x 5/16" LLV
6'-7" to	8'-4"	6" x 3-1/2" x 5/16" LLV
8'-5" to	16'-4"	7" x 4" x 3/8" LLV



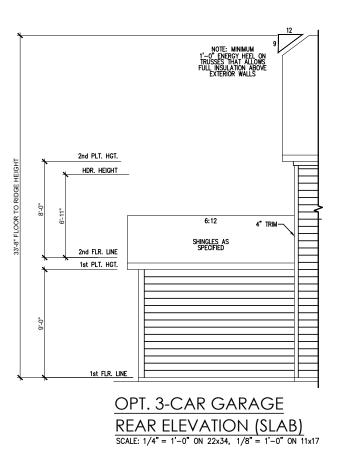





THE SELMA - RH
--Side Load Garage Elevations 'English Country'

DRAWN BY: South Designs ISSUE DATE:

7/1/2021

CURRENT REVISION DATE:

SCALE: 1/8" = 1'-0" SHEET

2.6.1c

General Elevation Notes

General Elevation Notes shall apply unless noted otherwise on plan.


- Roof shall be finished with architectural composition shingles with slopes as noted on plan.
- Ridge Vent shall be provided and installed on all ridges greater than 6' in length per manufacturer's specifications.
- 3. Soffit Vent shall be continuous soffit vent
- House Wrap, "tyvek" or approved equal shall be installed over entire exterior wall per manufacturer's specifications and recommendations.
- Flashing shall be provided above all door and window openings, above finish wall material changes and at wall surfaces where lower roof areas abut vertical wall surfaces.
- Porch Roilings shall be provided at all porch walking surfaces greater than 30" above adjacent finished grade. It shall be 36" high with guards spaced no more than 4" apart. Consult community specifications for material.
- Finish Wall Material shall be as noted on elevation drawings.
- 8. Brick Veneer, if included on elevation shall be tied to wall surface with galvanized corrugated metal ties at a rate of 24" oc horizontally and 16" oc vertically so that no more than 2.67st of brick is supported by (1) tie. Space between face of wall and back face of brick shall be limited to a maximum of 1". Flashing shall be provided behind brick above all wall openings and at base of brick wall. Flashing shall be a minimum of 6-mil poly or other corrosion resistant material and shall be installed so that it laps under the house wrap material a minimum of 2".

 Weepholes shall be provided at a rate of 48" oc and shall not be less than 3/16" in diameter and shall be located immediately above flashing.
- Brick Veneer Support Lintels shall be provided if brick veneer is included on elevation. Lintels shall be provided as listed in the following schedule and shall have a minimum bearing length of 6". Masonry Lintels shall be provided so that deflection is limited to L/600.

Masonry Opening Lintel Schedule

Opening Size Angle

up to 4'-	0"	3-1/2" x 3-1/2" x 5/16
4'-1" to	5'-6"	4" x 3-1/2" x 5/16" LL\
5'-7" to	6'-6"	5" x 3-1/2" x 5/16" LL\
6'-7" to	8'-4"	6" x 3-1/2" x 5/16" LL\
8'-5" to	16'-4"	7" x 4" x 3/8" LLV

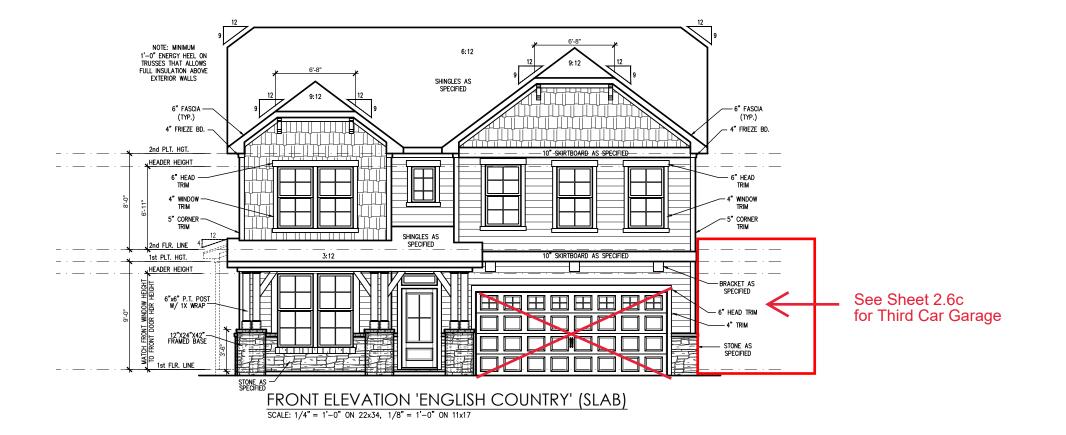

NEW SHOWE

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PLAN 4 - THE SELMA - LH
--Front & Rear Elevations (Slab) 'English
Country'

DRAWN BY: South Designs

ISSUE DATE: 7/1/2021

URRENT REVISION DATE:
---SCALE:
1/8" = 1'-0"

3.1c


General Elevation Notes

General Elevation Notes shall apply unless noted otherwise on plan.

- Roof shall be finished with architectural composition shingles with slopes as noted on plan.
- Ridge Vent shall be provided and installed on all ridges greater than 6' in length per manufacturer's specifications.
- 3. Soffit Vent shall be continuous soffit vent
- House Wrap, "tyvek" or approved equal shall be installed over entire exterior wall per manufacturer's specifications and recommendations.
- Flashing shall be provided above all door and window openings, above finish wall material changes and at wall surfaces where lower roof areas abut vertical wall surfaces.
- Porch Raillings shall be provided at all porch walking surfaces greater than 30" above adjacent finished grade. It shall be 36" high with guards spaced no more than 4" apart. Consult community specifications for material.
- Finish Wall Material shall be as noted on elevation drawings.
- 8. Brick Veneer, if included on elevation shall be fied to wall surface with galvanized corrugated metal fies at a rate of 24" oc horizontally and 16" oc vertically so that no more than 2.675 of brick is supported by (1) fie. Space between face of wall and back face of brick shall be limited to a maximum of 1". Flashing shall be provided behind brick above all wall openings and at base of brick wall. Flashing shall be a minimum of 6-mil poly or other corrosion resistant material and shall be installed so that if laps under the house wrap material a minimum of 2". Weepholes shall be provided at a rate of 48" oc and shall not be less than 3/16" in diameter and shall be located immediately above flashing.
- Brick Veneer Support Lintels shall be provided if brick veneer is included on elevation. Lintels shall be provided as listed in the following schedule and shall have a minimum bearing length of 6". Masonry Lintels shall be provided so that deflection is limited to 1/600.

Masonry Opening Lintel Schedule

Opening S	ize	Angle
up to 4'-0"		3-1/2" x 3-1/2" x 5/16"
4'-1" to	5'-6"	4" x 3-1/2" x 5/16" LLV
5'-7" to	6'-6"	5" x 3-1/2" x 5/16" LLV
6'-7" to	8'-4"	6" x 3-1/2" x 5/16" LLV
8'-5" to	16'-4"	7" x 4" x 3/8" LLV

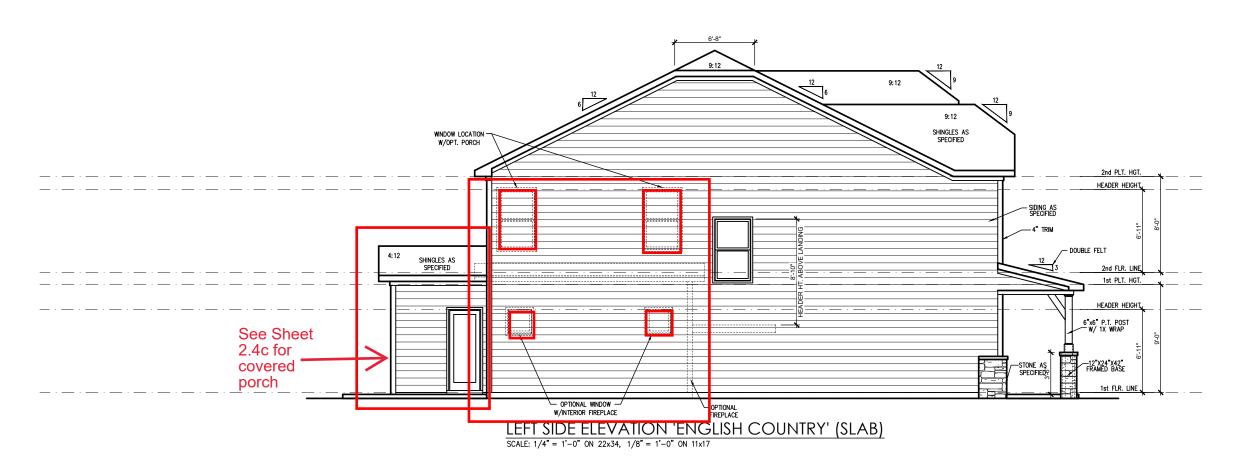



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PLAN 4 - THE SELMA - LH


--Side Elevations (Slab) 'English Country'

South Designs
ISSUE DATE:
7/1/2021

JRRENT REVISION DATE:

RENT REVISION DATE:
---SCALE:
1/8" = 1'-0"

3.2c

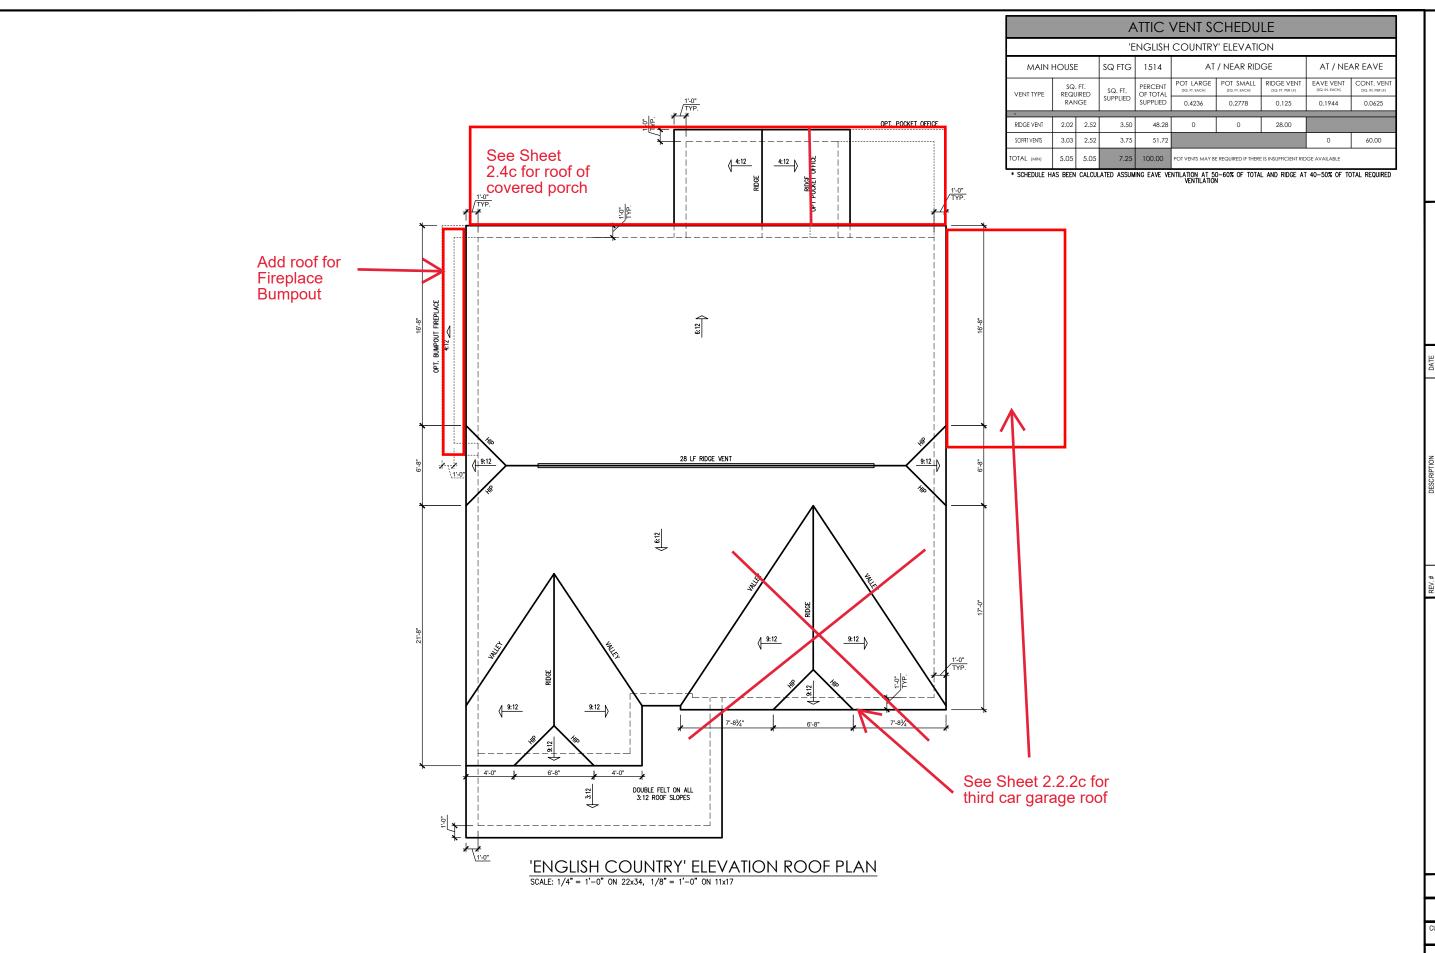

HOME MOHC.

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PLAN 4 - THE SELMA - LH
--Roof Plan 'English Country'

DRAWN BY: South Designs ISSUE DATE: 7/1/2021

SCALE: 1/8" = 1'-0"

3.3c

ELECTRICAL KEY DUPLEX OUTLET SPLIT SWITCHED OUTLET FLOOR OUTLET QUADPLEX OUTLET ⊕^{GF1} GROUND FAULT OUTLET $\bigoplus^{\text{GFIWP}} \text{WEATHER PROOF OUTLET}$ **220V** 220V OUTLET (5) EXAUST FAN EXHAUST FAN / LIGHT **\P** EXHAUST FAN / HEAT LIGHT $^{ m R}$ RECESSED CAN LIGHT EYEBALL LIGHT $^{\circ}$ VAPOR PROTECTED LIGHT CEILING LIGHT LED DISC -⊕-HANGING CEILING LIGHT -ф-HANGING PENDANT LIGHT Ю WALL LIGHT VANITY LIGHT WALL SCONCE LIGHT \$ SINGLE SWITCH **\$**3 3-WAY SWITCH DIMMER SWITCH ΤV CABLE T.V. JACK · BUTTON ∇ PHONE JACK \bigcirc DIRECT WIRE DATA OUTLET SMART PANEL NETWORK PANEL W/ OUTLET (SD) SMOKE DETECTOR CARBON MONOXIDE CMD ELECTRICAL PANEL \Box DISCONNECT SWITCH ELECTRIC METER → 2' LED LIGHT 2 BULB FLUORESCENT QQQQ VANITY LIGHTS FLOOD LIGHT 0 0 0 CEILING FAN CEILING FAN W/ LIGHT

General Power and Lighting:


General Power and Lighting Notes shall apply unless noted otherwise on plans.


All work shall be installed per the current NC Residential Building Code, and the National Electric Code. Alarm devices shall meet NFPA 72.

- Smoke Alarms Shall be provided as a minimum of (1)
 per floor, including basements (if applicable), (1) in each
 sleep room, and (1) outside each sleeping area, within
 the immediate vicinity of sleeping rooms. When more
 than one alarm is required, the alarm devices shall be
 interconnected in such a manner that the activation of
 one alarm will activate all of the alarms. Smoke alarms
 shall be hard wired to permanent power and shall have
 batter back-ups.
- Switches For lighting, fans, etc. shall be installed at
 heights illustrated on this page and shall be located a
 minimum of 4 1/2" from door openings to allow for the
 proper installation of door casings. Switches, thermostats,
 security pads, and other similar devices shall be grouped
 together and installed thoughtfully for convenience of use
 and to avoid placement within centers of wall areas.

Note:

This plan is a diagram showing approximate locations of convenience outlets based on requirements found in the NC Residential Code and N.E.C. Actual positions may vary from what is shown on plan.

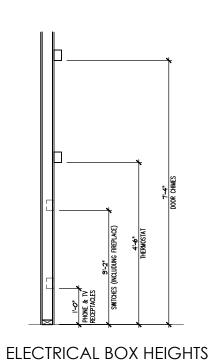

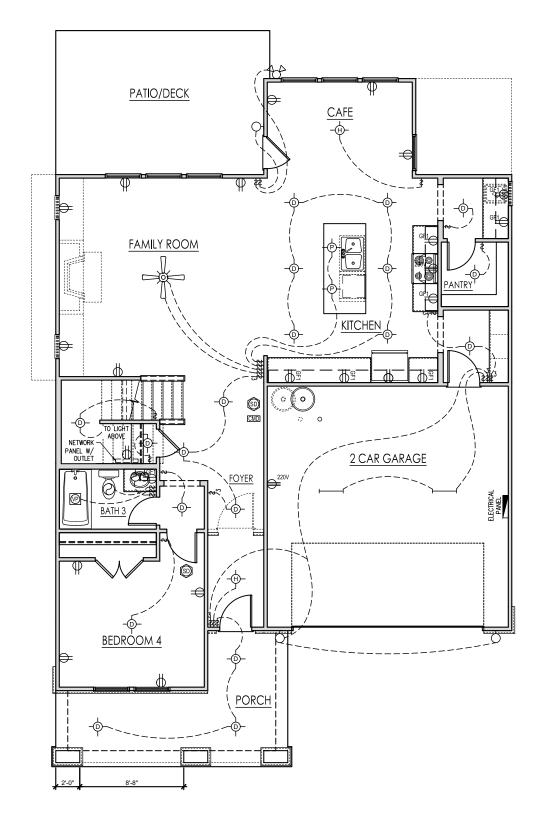

FIRST FLOOR ELECTRICAL PLAN 'ENGLISH COUNTRY'
SCALE: 1/8"=1'-0" ON 11x17, 1/4"=1'-0" ON 22x34

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PLAN 4 - THE SELMA - LH
--First Floor Electrical 'English Country'

DRAWN BY: South Designs ISSUE DATE:

7/1/2021 JRRENT REVISION DATE

SCALE: 1/8" = 1'-0"

5.1c

ELECTRICAL KEY DUPLEX OUTLET SPLIT SWITCHED OUTLET FLOOR OUTLET QUADPLEX OUTLET ⊕^{GF1} GROUND FAULT OUTLET GFIWP WEATHER PROOF OUTLET 220V OUTLET (5) EXAUST FAN EXHAUST FAN / LIGHT � EXHAUST FAN / HEAT LIGHT $^{ m R}$ RECESSED CAN LIGHT EYEBALL LIGHT **(P)** VAPOR PROTECTED LIGHT CEILING LIGHT LED DISC -⊕-HANGING CEILING LIGHT HANGING PENDANT LIGHT Ю WALL LIGHT VANITY LIGHT WALL SCONCE LIGHT \$ SINGLE SWITCH \$ 3-WAY SWITCH 4-WAY SWITCH DIMMER SWITCH ΤV CABLE T.V. JACK · BUTTON ∇ PHONE JACK \bigcirc DIRECT WIRE DATA OUTLET SMART PANEL NETWORK PANEL W/ OUTLET (SD) SMOKE DETECTOR CARBON MONOXIDE CMD ELECTRICAL PANEL \Box DISCONNECT SWITCH ELECTRIC METER → 2' LED LIGHT 2 BULB FLUORESCENT QQQQ VANITY LIGHTS FLOOD LIGHT 0 0 0 CEILING FAN CEILING FAN W/ LIGHT **ELECTRICAL BOX HEIGHTS**


General Power and Lighting:


General Power and Lighting Notes shall apply unless noted otherwise on plans.


All work shall be installed per the current NC Residential Building Code, and the National Electric Code. Alarm devices shall meet NFPA 72.

- Smoke Alarms Shall be provided as a minimum of (1) per floor, including basements (if applicable), (1) in each sleep room, and (1) outside each sleeping area, within the immediate vicinity of sleeping rooms. When more than one alarm is required, the alarm devices shall be interconnected in such a manner that the activation of one alarm will activate all of the alarms. Smoke alarms shall be hard wired to permanent power and shall have
- Switches For lighting, fans, etc. shall be installed at heights illustrated on this page and shall be located a minimum of 4 1/2" from door openings to allow for the proper installation of door casings. Switches, thermostats, security pads, and other similar devices shall be grouped together and installed thoughfully for convenience of use and to avoid placement within centers of wall areas.

This plan is a diagram showing approximate locations of convenience outlets based on requirements found in the NC Residential Code and N.E.C. Actual positions may vary from what is shown on plan.

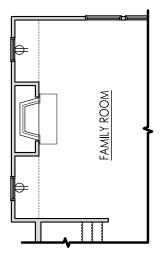


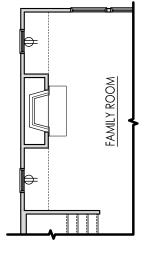

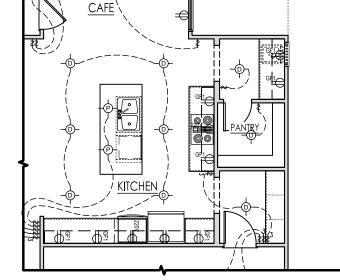







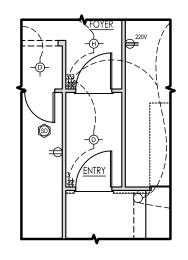


OPT. SMART DOOR SCALE: 1/8"=1'-0" ON 11x17, 1/4"=1'-0" ON 22x34

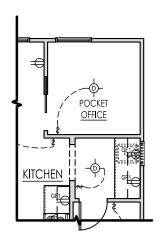

OPT. POCKET OFFICE SCALE: 1/8"=1'-0" ON 11x17, 1/4"=1'-0" ON 22x34

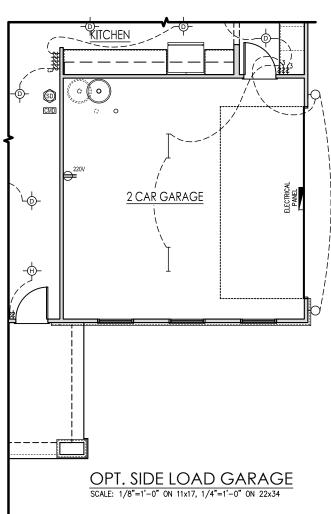

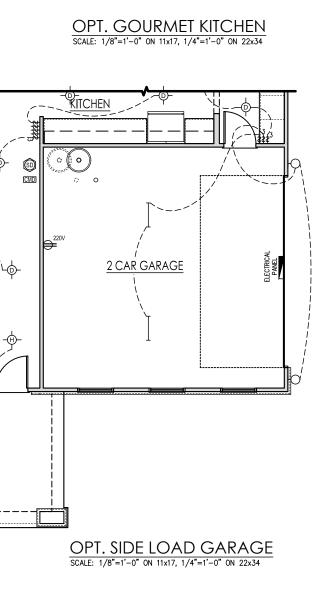





ISSUE DATE: 7/1/2021 IRRENT REVISION DATE

1/8" = 1'-0"

ELECTRICAL KEY DUPLEX OUTLET SPLIT SWITCHED OUTLET FLOOR OUTLET QUADPLEX OUTLET ⊕^{GF1} GROUND FAULT OUTLET $\bigoplus^{\text{GFIWP}} \text{WEATHER PROOF OUTLET}$ **220V** 220V OUTLET (5) EXAUST FAN EXHAUST FAN / LIGHT **\P** EXHAUST FAN / HEAT LIGHT $^{ m R}$ RECESSED CAN LIGHT EYEBALL LIGHT $^{\circ}$ VAPOR PROTECTED LIGHT CEILING LIGHT LED DISC -⊕-HANGING CEILING LIGHT -ф-HANGING PENDANT LIGHT Ю WALL LIGHT VANITY LIGHT WALL SCONCE LIGHT \$ SINGLE SWITCH **\$**3 3-WAY SWITCH DIMMER SWITCH ΤV CABLE T.V. JACK · BUTTON ∇ PHONE JACK \bigcirc DIRECT WIRE DATA OUTLET SMART PANEL NETWORK PANEL W/ OUTLET (SD) SMOKE DETECTOR CARBON MONOXIDE CMD ELECTRICAL PANEL \Box DISCONNECT SWITCH ELECTRIC METER → 2' LED LIGHT 2 BULB FLUORESCENT QQQQ VANITY LIGHTS FLOOD LIGHT 0 0 0 CEILING FAN CEILING FAN W/ LIGHT


General Power and Lighting:


General Power and Lighting Notes shall apply unless noted otherwise on plans.

All work shall be installed per the current NC Residential Building Code, and the National Electric Code. Alarm devices shall meet NFPA 72.

- Smoke Alarms Shall be provided as a minimum of (1) per floor, including basements (if applicable), (1) in each sleep room, and (1) outside each sleeping area, within the immediate vicinity of sleeping rooms. When more than one alarm is required, the alarm devices shall be interconnected in such a manner that the activation of one alarm will activate all of the alarms. Smoke alarms shall be hard wired to permanent power and shall have
- Switches For lighting, fans, etc. shall be installed at heights illustrated on this page and shall be located a minimum of 4 1/2" from door openings to allow for the proper installation of door casings. Switches, thermostats, security pads, and other similar devices shall be grouped together and installed thoughfully for convenience of use and to avoid placement within centers of wall areas.

This plan is a diagram showing approximate locations of convenience outlets based on requirements found in the NC Residential Code and N.E.C. Actual positions may vary from what is shown on plan.

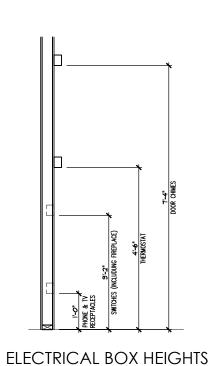

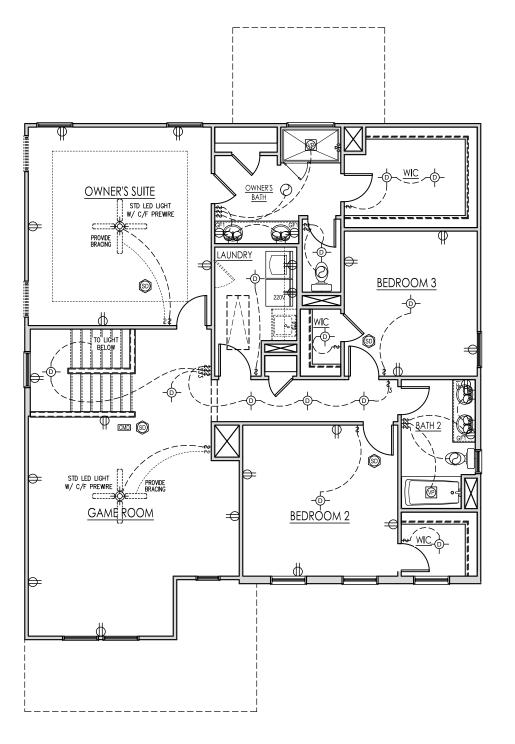

SECOND FLOOR ELECTRICAL PLAN 'ENGLISH COUNTRY' SCALE: 1/8"=1'-0" ON 11x17, 1/4"=1'-0" ON 22x34

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-LH Second Floor Electrical 'English Country' SELMA THE 4 **PLAN**

> DRAWN BY: South Designs ISSUE DATE:

7/1/2021 JRRENT REVISION DATE

1/8" = 1'-0"

5.2c

ELECTRICAL KEY DUPLEX OUTLET SPLIT SWITCHED OUTLET FLOOR OUTLET QUADPLEX OUTLET ⊕^{GF1} GROUND FAULT OUTLET GFIWP WEATHER PROOF OUTLET 220V OUTLET (5) EXAUST FAN EXHAUST FAN / LIGHT � EXHAUST FAN / HEAT LIGHT $^{ m R}$ RECESSED CAN LIGHT EYEBALL LIGHT **(P)** VAPOR PROTECTED LIGHT CEILING LIGHT LED DISC HANGING CEILING LIGHT -ф-HANGING PENDANT LIGHT Ю WALL LIGHT VANITY LIGHT WALL SCONCE LIGHT \$ SINGLE SWITCH \$ 3-WAY SWITCH DIMMER SWITCH ΤV CABLE T.V. JACK · BUTTON ∇ PHONE JACK \bigcirc DIRECT WIRE DATA OUTLET SWART PANEL NETWORK PANEL W/ OUTLET (SD) SMOKE DETECTOR CARBON MONOXIDE CMD ELECTRICAL PANEL \Box DISCONNECT SWITCH ELECTRIC METER → 2' LED LIGHT 2 BULB FLUORESCENT QQQQ VANITY LIGHTS FLOOD LIGHT 0 0 0 CEILING FAN CEILING FAN W/ LIGHT **ELECTRICAL BOX HEIGHTS**


General Power and Lighting:

General Power and Lighting Notes shall apply unless noted otherwise on plans.

All work shall be installed per the current NC Residential Building Code, and the National Electric Code. Alarm devices shall meet NFPA 72.

- Smoke Alarms Shall be provided as a minimum of (1) per floor, including basements (if applicable), (1) in each sleep room, and (1) outside each sleeping area, within the immediate vicinity of sleeping rooms. When more than one alarm is required, the alarm devices shall be interconnected in such a manner that the activation of one alarm will activate all of the alarms. Smoke alarms shall be hard wired to permanent power and shall have
- Switches For lighting, fans, etc. shall be installed at heights illustrated on this page and shall be located a minimum of 4 1/2" from door openings to allow for the proper installation of door casings. Switches, thermostats, security pads, and other similar devices shall be grouped together and installed thoughfully for convenience of use and to avoid placement within centers of wall areas.


This plan is a diagram showing approximate locations of convenience outlets based on requirements found in the NC Residential Code and N.E.C. Actual positions may vary from what is shown on plan.

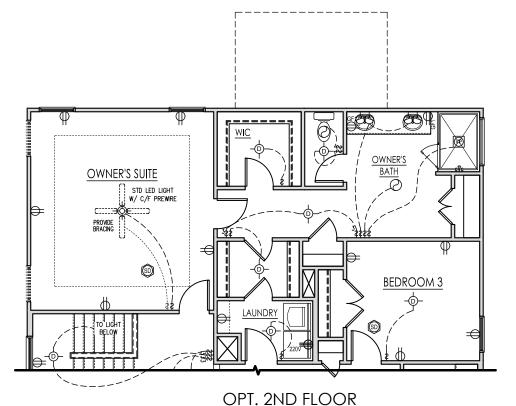


SCALE: 1/8"=1'-0" ON 11x17, 1/4"=1'-0" ON 22x34

OPT. SHOWER \$\psi_18" SEAT


SCALE: 1/8"=1'-0" ON 11x17, 1/4"=1'-0" ON 22x34

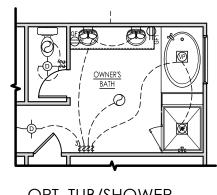



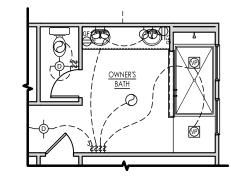

OPT. SUPER SHOWER W/ OPT. 2ND FLOOR SCALE: 1/8"=1'-0" ON 11x17, 1/4"=1'-0" ON 22x34

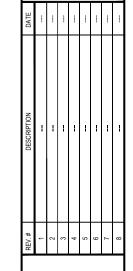

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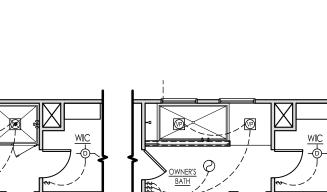
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SELMA


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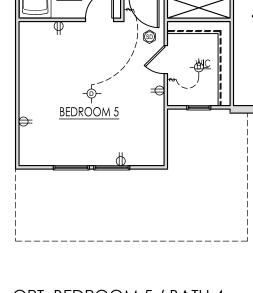
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OPT. SUPER SHOWER SCALE: 1/8"=1'-0" ON 11x17, 1/4"=1'-0" ON 22x34



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BATH 4

OPT. BEDROOM 5 / BATH 4 SCALE: 1/8"=1'-0" ON 11x17, 1/4"=1'-0" ON 22x34

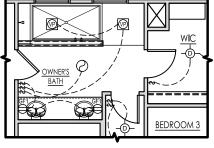


DRAWN BY: South Designs ISSUE DATE: 7/1/2021


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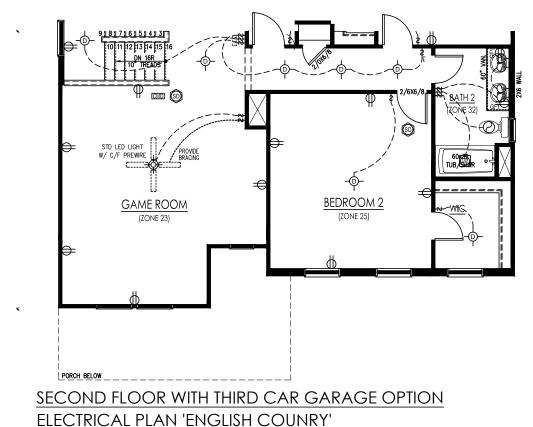
Options Electrical 'English Country'

JRRENT REVISION DATE

1/8" = 1'-0"




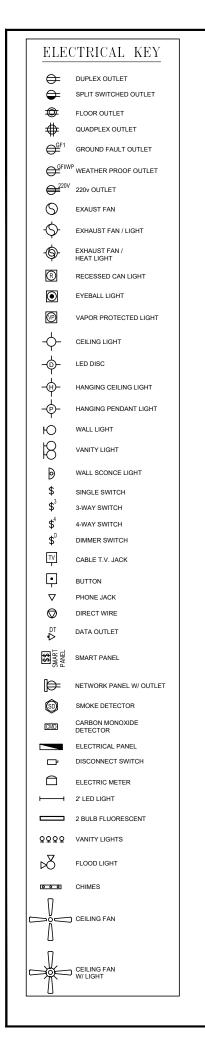

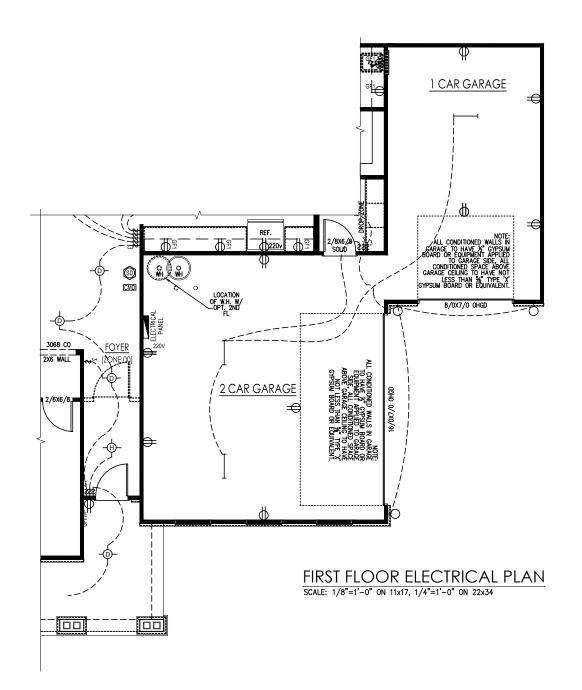

SCALE: 1/8"=1'-0" ON 11x17, 1/4"=1'-0" ON 22x34



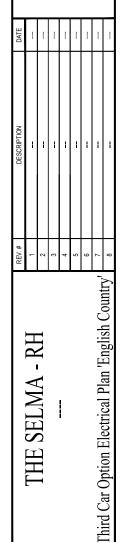

- RH

SELMA


THE

South Designs

ISSUE DATE: 7/1/2021

CURRENT REVISION DATE: SCALE: 1/8" = 1'-0"

SHEET

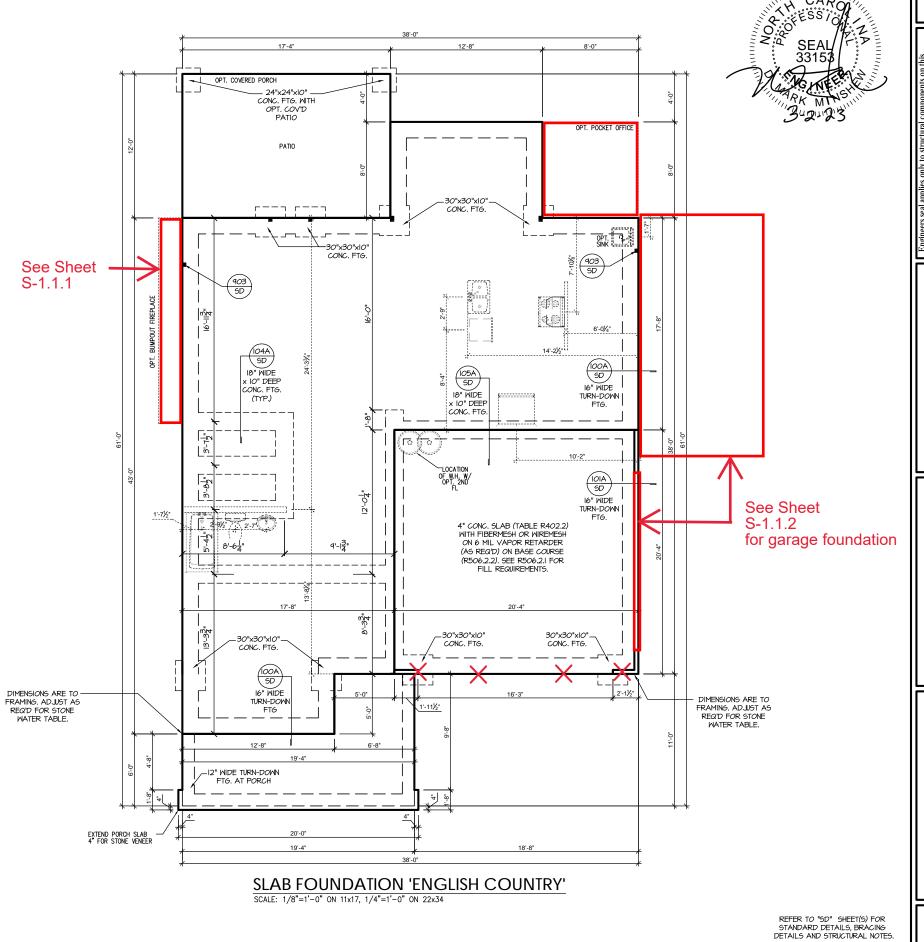

PROJECT # 21-2817-RH

Engineers seal applies only to structural components on this document.

Journal Seal does not include construction means, methods, techniques, sequences, procedures or safety precautions.

Any deviations or discrepancies on plans are to be brought to the immediate attention of Southern Engineers. Failure to do so will void Southem Engineers's lability.

Seal is vald for projects permitted one year from date of seal.

Use of these plans constitutes approval of terms & conditions as defined in the customer agreement.

P.A. 27609


Southern Engineers, P. 3716 Benson Drive, Raleigh, NC 276 Phone: (919) 878-1617 License: C-4772 www.southernengineers.com


SOUTH DESIGNS


RH Selma NEW HOME, INC.

The 8 Plan

S-1.1

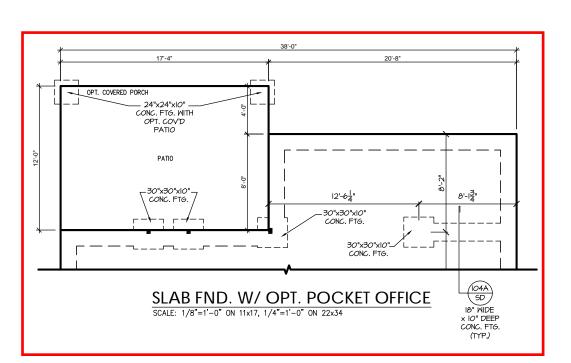

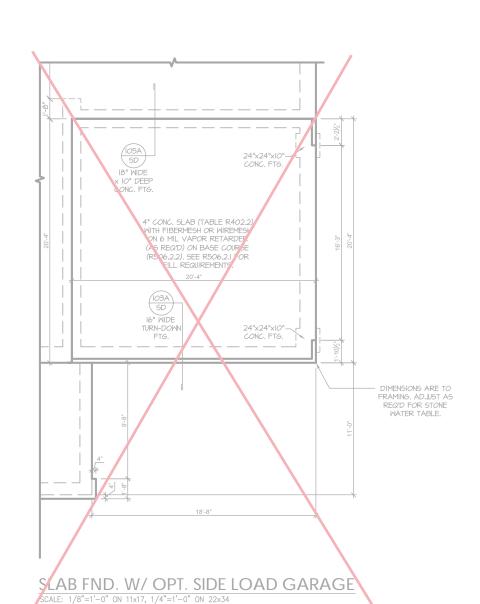

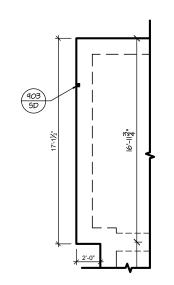

SLAB FND. W/ OPT. BUMPOUT FIREPLACE SCALE: 1/8"=1'-0" ON 11x17, 1/4"=1'-0" ON 22x34


PROJECT # 21-2817-RH

Southern Engineers, P.A. 3716 Benson Drive, Raleigh, NC 27609 Phone: (919) 878-1617 License: C-4772 www.southernengineers.com

SOUTH DESIGNS

RH The Selma NEW HOME, INC. Plan 04

S-1.1

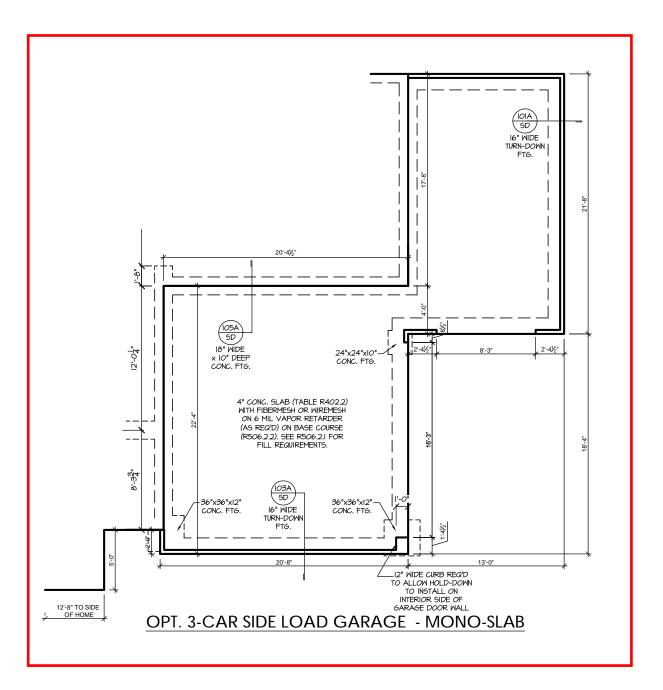

PROJECT # 21-2817-RH

Southern Engineers, P.A. 3716 Benson Drive, Raleigh, NC 27609 Phone: (919) 878-1617 License: C-4772 www.southernengineers.com

SOUTH DESIGNS

RH The Selma -NEW HOME, INC. Plan 04

REFER TO "SD" SHEET(S) FOR STANDARD DETAILS, BRACING DETAILS AND STRUCTURAL NOTES.

TRUSS SYSTEM REQUIREMENTS NC (2018 NCRC): Wind: 115-120 mph

- TRUSS SYSTEM LAYOUTS (PLACEMENT PLANS) SHALL BE DESIGNED IN ACCORDANCE WITH SEALED STRUCTURAL PLANS, ANY NEED TO CHANGE TRUSSES SHALL BE
- TRUSS SCHEMATICS (PROFILES) SHALL BE PREPARED AND SEALED BY TRUSS MANUFACTURER
- ALL TRUSSES SHALL BE DESIGNED FOR BEARING ON SPF #2 OR #3 PLATES OR LEDGERS (UNO).
- ALL REQUIRED ANCHORS FOR TRUSSES DUE TO UPLIFT OR BEARING SHALL MEET THE REQUIREMENTS AS SPECIFIED ON THE TRUSS SCHEMATICS.

HEADER/BEAM & COLUMN NOTES

- ALL EXTERIOR AND LOAD BEARING HEADERS SHALL SUPPORT STUD, UNI ESS NOTED OTHERWISE.
- 2. THE NUMBER SHOWN AT BEAM AND HEADER SUPPORTS INDICATES THE NUMBER OF SUPPORT STUDS REQUIRED IN STUD POCKET OR COLUMN. THE NUMBER OF KING STUDS AT EACH END OF HEADERS IN EXTERIOR WALLS SHALL BE ACCORDING TO ITEM "d" IN TABLE R602.3(5) OR AS BELOW PER NCDOI COMMENTARY "KING STUDS
- AT WALL OPENINGS" REVISED 1-9-2020: UP TO 3' SPAN: (I) KING STUD
- OVER 3' UP TO 6' SPAN: (2) KING STUDS
- OVER 6' UP TO 9' SPAN: (3) KING STUDS
- OVER 9' UP TO 12' SPAN: (4) KING STUDS
- OVER 12' UP TO 15' SPAN: (5) KING STUDS

FRAMING NOTES

NC (2018 NCRC): Wind: 115-120 mph

- BRACING METHOD AND TYPE: CONTINUOUSLY SHEATHED WSP: CS-MSP, NOTE THAT THE WALL BRACING AMOUNT PROVIDED ON THE PLANS (DETAILS AND SPECIFICATIONS) IS GREATER THAN THE AMOUNT OF WALL BRACING REQUIRED BY SECTION R602.10 OF THE CODE. SEE NOTES BELOW FOR DETAILS AND SPECIFICATIONS FOR WALL BRACING AND WALL FRAMING.
- 2. EXTERIOR WALL SHEATHING: WALLS SHALL BE BRACED BY SHEATHING WALLS ON ALL STORIES WITH WOOD STRUCTURAL PANEL SHEATHING (WGP) (EXPOSURE B: 17/16", EXPOSURE C: 15/32").
 SHEATHING SHALL BE ATTACHED WITH 8d NAILS AT A 6"/12" NAILING PATTERN (6" OC AT PANEL EDGES AND 12" OC AT INTERMEDIATE SUPPORTS). INSTALL BLOCKING AT ALL PANEL EDGES.
- 3. WSP SHEATHING SHALL EXTEND TO THE UPPERMOST DOUBLE BEARING PLATE. BLOCK AT ROOF PER SECTION R602.10.4.5 AND ATTACH BRACED WALLS PER CODE. WSP SHEATHING BETWEEN FLOORS SHALL BE SPLICED ALONG CONTINUOUS BAND OR THE WSP SHEATHING MAY BE SPLICED ACROSS STUDS (CONTINUOUS ACROSS FLOOR SYSTEM) WITH BLOCKING AT PANEL EDGES. (MINIMUM 12" BEYOND FLOOR BREAK) OR OTHER APPROVED METHOD.
- 4. "HD" = HOLDOWN: HOLD-DOWN DEVICE (NOTED AS "HD" ON PLANS) SHALL BE AN 800 POUND CAPACITY ASSEMBLY AS NOTED ON PLANS SEE DETAILS FOR HD ASSEMBLY
- **GROUND/FIRST FLOOR: USE "HD HOLD-DOWN DETAIL" ON SD SHEET (OR EQUIV.)
- **UPPER FLOORS: ATTACH BASE OF KING STUD WITH A SIMPSON CS22 STRAP DOWN ACROSS THE BAND AND DOWN TO A STUD BELOW OR HEADER BELOW. EXTEND STRAP 7" MIN ALONG EACH STUD (OR HEADER) AND ATTACH EACH END W/ (7) 8d NAILS.
- 5. INTERIOR BRACED WALL: (NOTED AS "IBW" ON PLANS) ATTACH I/2" GYPSUM BOARD (GB) ON EACH SIDE OF WALL WITH A MIN. OF 5d COOLER NAILS OR #6 SCREWS @ 7" O.C. ALONG THE EDGES AND AT INTERMEDIATE SUPPORTS.
- 6. INTERIOR BRACED WALL-WOOD STRUCTURAL PANEL: (NOTED AS "IBM-WSP" ON PLANS). ATTACH ONE SIDE WITH 1/6" WSP SHEATHING WITH 8d NAILS AT A 6"/12" NAILING PATTERN (6" OC AT PANEL EDGES AND 12" OC AT INTERMEDIATE SUPPORTS). INSTALL BLOCKING AT ALL PANEL EDGES, ATTACH 6B OVER WEP AS REQUIRED. ATTACH OPPOSITE SIDE WITH 1/2" 6B WITH A MIN. OF 5d COOLER NAILS OR #6 SCREWS @ 1" OC ALONG THE EDGES AND AT

MOOD I-JOISTS

(SHALL BE ONE OF THE FOLLOWING):

- LPI 20 PLUS BY LP


HEAVY I- JOISTS

(SHALL BE ONE OF THE FOLLOWING OR EQUAL):

- TJI 360 BY TRUS JOIST
- BCI 60s 2.0 BY BC
- ALL WOOD I-JOISTS SHALL BE INSTALLED ACCORDING TO MANUFACTURER'S SPECIFICATIONS.
- INSTALL SQUASH BLOCKS, WEB STIFFENERS, ETC. AS REQUIRED BY AND ACCORDING TO THE I-JOIST MANUFACTURER'S SPECIFICATIONS AND
- HANGERS FOR I-JOISTS ARE THE RESPONSIBILITY OF THE I-JOIST SUPPLIER.
- FLOOR TRUSSES BY THE MANUFACTURER MAY BE SUBSTITUTED FOR I-JOISTS.

- PORCH POST NOTES:

 4"x4" (6"x6") TRT'D POST (OR EQUAL).
- ATTACH TRUSSES (RAFTERS) AT PORCH WITH HURRICANE CONNECTORS.
- POST CAP: SIMPSON AC4-MAX (AC6-MAX)
 POST CAP AT CORNER: (2) SIMPSON LCE4 (MITER HEADER
- AT CORNER). HIGH WIND; ADD (1) SIMPSON H6. 3. POST BASE: SIMPSON ABU44 (ABU66).
- MONO: %" ANCHOR (EMBED 1")
- CMU: %" ANCHOR (EXTEND TO FOOTING HIGH WIND ONLY)
- 4. <u>POST BASE:</u> WOOD FOUNDATION: (2) SIMPSON CSI6 STRAPS AT POSTS, EXTEND 12" ONTO EACH POST (UPPER AND
- NOTE: EQUIVALENT POST CAP AND BASE ACCEPTABLE.

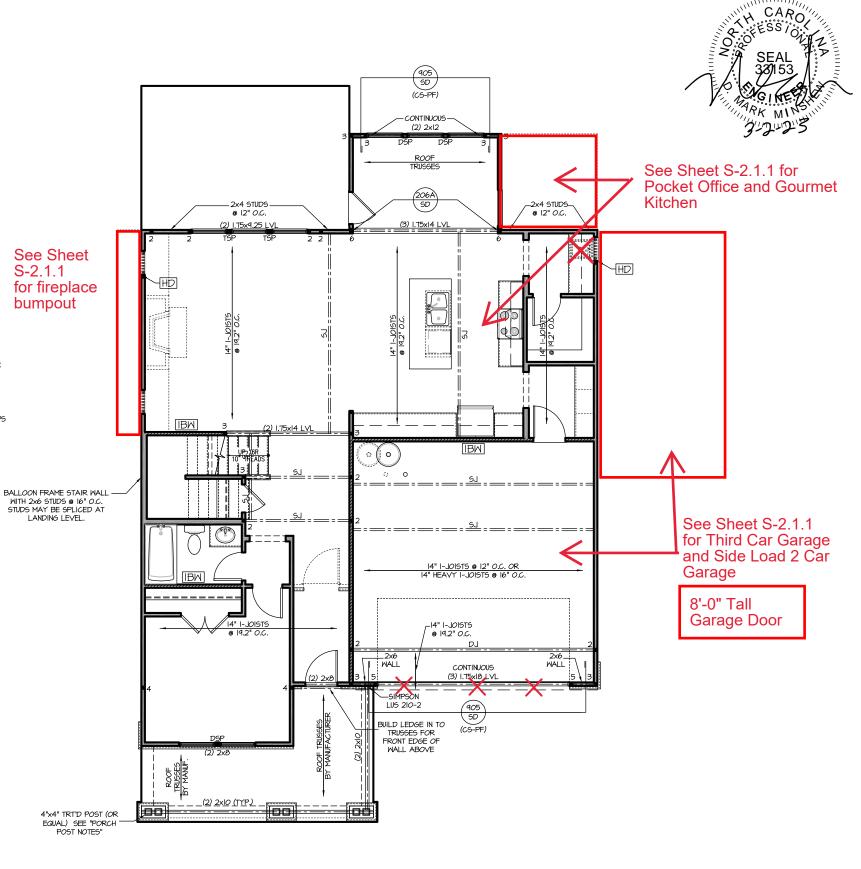

FIRST FLOOR PLAN 'ENGLISH COUNTRY'

SCALE: 1/8"=1'-0" ON 11x17, 1/4"=1'-0" ON 22x34

PROJECT # 21-2817-RH

e to be brought to the Failure to do so will


P.A. 27609 Engineers, Drive, Raleigh, NC e: (919) 878-1617 Southern Engi 3716 Benson Drive, Ra Phone: (919) 8


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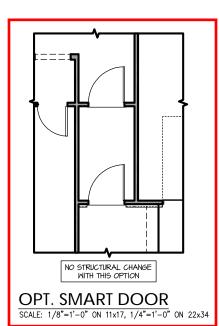
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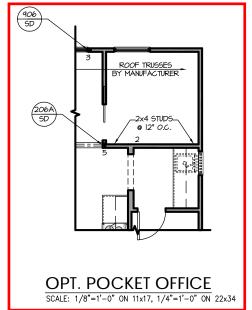
Plan


REFER TO "SD" SHEET(S) FOR STANDARD DETAILS BRACING DETAILS AND STRUCTURAL NOTES.






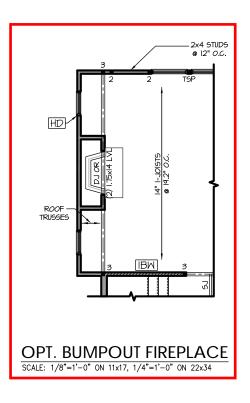

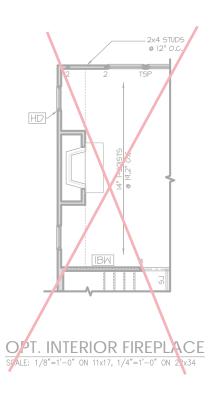

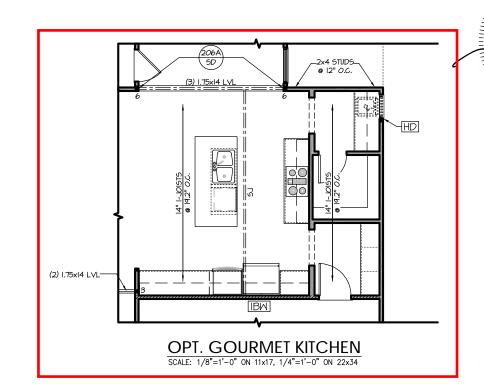

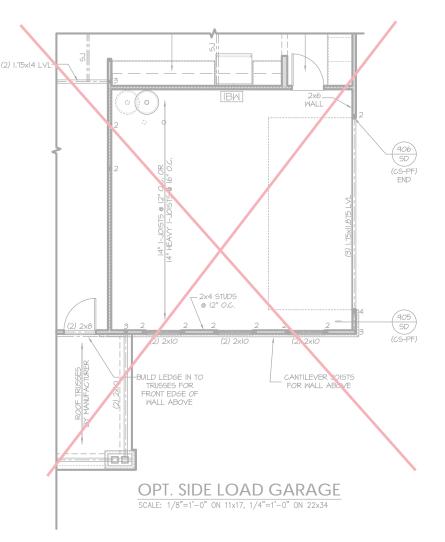

PROJECT # 21-2817-RH

S. Failure to do so will struct to do so will remain from date of seal.

Seal does not include construction means, methods, techniq sequences, procedures or safety precautions.

Any deviations or discrepancies on plans are to be brought immediate attention of Southern Engineers. Failure to do so void Southern Engineers liability.

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SOUTH DESIGNS

Plan 04 - The Selma - RH
NEW HOME, INC.

REFER TO "5D" SHEET(S) FOR STANDARD DETAILS, BRACING DETAILS AND STRUCTURAL NOTES.

(SHALL BE ONE OF THE FOLLOWING):

TJI 210 BY TRUS JOIST

- LPI 20 PLUS BY LP
- BCI 5000s I.8 BY BC

HEAVY 1- JOISTS (SHALL BE ONE OF THE FOLLOWING OR EQUAL):

- TJI 360 BY TRUS JOIST
- BCI 60s 2.0 BY BC
- ALL WOOD I-JOISTS SHALL BE INSTALLED ACCORDING TO MANUFACTURER'S SPECIFICATIONS.
- INSTALL SQUASH BLOCKS, WEB STIFFENERS, ETC. AS REQUIRED BY AND ACCORDING TO THE I-JOIST MANUFACTURER'S SPECIFICATIONS AND INSTRUCTIONS.
- HANGERS FOR I-JOISTS ARE THE RESPONSIBILITY OF THE
- FLOOR TRUSSES BY THE MANUFACTURER MAY BE SUBSTITUTED FOR I-JOISTS.

PORCH POST NOTES:

- 4"x4" (6"x6") TRT'D POST (OR EQUAL). ATTACH TRUSSES (RAFTERS) AT PORCH WITH HURRICANE CONNECTORS.
- POST CAP: SIMPSON AC4-MAX (AC6-MAX)
- POST CAP AT CORNER: (2) SIMPSON LCE4 (MITER HEADER AT CORNER). HIGH WIND; ADD (1) SIMPSON H6.
- 3. POST BASE: SIMPSON ABU44 (ABU66).
- MONO: %" ANCHOR (EMBED 7")
 CMU: %" ANCHOR (EXTEND TO FOOTING HIGH WIND
- 4. POST BASE: WOOD FOUNDATION: (2) SIMPSON CSI6 STRAPS AT POSTS. EXTEND 12" ONTO EACH POST (UPPER AND LOWER) OR TO GIRDER.

4"x4" TRT'D POST (OR-EQUAL) SEE "PORCH

NOTE: EQUIVALENT POST CAP AND BASE ACCEPTABLE.

TRUSS SYSTEM REQUIREMENTS

NC (2018 NCRC): Wind: 115-120 mph

- TRUSS SYSTEM LAYOUTS (PLACEMENT PLANS) SHALL BE DESIGNED IN ACCORDANCE WITH SEALED STRUCTURAL PLANS. ANY NEED TO CHANGE TRUSSES SHALL BE COORDINATED WITH SOUTHERN ENGINEERS
- TRUSS SCHEMATICS (PROFILES) SHALL BE PREPARED AND SEALED BY TRUSS MANUFACTURER.
- ALL TRUSSES SHALL BE DESIGNED FOR BEARING ON SPF #2 OR #3 PLATES OR LEDGERS (UNO).
- ALL REQUIRED ANCHORS FOR TRUSSES DUE TO UPLIFT OR BEARING SHALL MEET THE REQUIREMENTS AS SPECIFIED ON THE TRUSS SCHEMATICS.

2x4 STUDS-

@ 12" O.C.



HEADER/BEAM & COLUMN NOTES

- ALL EXTERIOR AND LOAD BEARING HEADERS SHALL BE MIN. (2)2x6 (4" WALL) OR (3)2x6 (6" WALL) MITH (1) SUPPORT STUD, UNLESS NOTED OTHERWISE.
- 2. THE NUMBER SHOWN AT BEAM AND HEADER SUPPORTS INDICATES THE NUMBER OF SUPPORT STUDS REQUIRED IN STUD POCKET OR COLUMN. THE NUMBER OF KING STUDS AT EACH END OF HEADERS IN EXTERIOR WALLS SHALL BE ACCORDING TO ITEM "d" IN TABLE R602.3(5) OR AS BELOW PER NCDO! COMMENTARY "KING STUDS AT WALL OPENINGS" REVISED 1-9-2020:
- UP TO 3' SPAN: (I) KING STUD
- OVER 3' UP TO 6' SPAN: (2) KING STUDS
- OVER 6' UP TO 9' SPAN: (3) KING STUDS OVER 9' UP TO 12' SPAN: (4) KING STUDS
- OVER 12' UP TO 15' SPAN: (5) KING STUDS

FRAMING NOTES


NC (2018 NCRC): Wind: 115-120 mph

- BRACING METHOD AND TYPE: CONTINUOUSLY SHEATHED WSP: CS-WSP. NOTE THAT THE WALL BRACING AMOUNT PROVIDED ON THE PLANS (DETAILS AND SPECIFICATIONS) IS GREATER THAN THE AMOUNT OF WALL BRACING REQUIRED BY SECTION REO2LO OF THE CODE. SEE NOTES BELOW FOR DETAILS AND SPECIFICATIONS FOR WALL BRACING AND WALL FRAMING.
- 2. EXTERIOR WALL SHEATHING: WALLS SHALL BE BRACED BY SHEATHING WALLS ON ALL STORIES WITH WOOD STRUCTURAL PANEL SHEATHING (MSP) (EXPOSURE B: 7/16", EXPOSURE C: 15/32"). SHEATHING SHALL BE ATTACHED WITH 8d NAILS AT A 6"/12" NAILING PATTERN (6" OC AT PANEL EDGES AND 12" OC AT INTERMEDIATE SUPPORTS). INSTALL BLOCKING AT ALL PANEL EDGES.
- 3 WSP SHEATHING SHALL EXTEND TO THE UPPERMOST DOUBLE BEARING PLATE. BLOCK AT ROOF PER SECTION R602.10.4.5 AND ATTACH BRACED WALLS PER CODE. WSP SHEATHING BETWEEN FLOORS SHALL BE SPLICED ALONG CONTINUOUS BAND OR THE WSP SHEATHING MAY BE SPLICED ACROSS STUDS (CONTINUOUS ACROSS FLOOR SYSTEM) WITH BLOCKING AT PANEL EDGES. (MINIMUM 12" BEYOND FLOOR BREAK) OR OTHER APPROVED METHOD
- 4. "HD" = HOLDOWN: HOLD-DOWN DEVICE (NOTED AS "HD" ON PLANS) SHALL BE AN 800 POUND CAPACITY ASSEMBLY AS NOTED ON PLANS, SEE DETAILS FOR HD ASSEMBLY.
- **GROUND/FIRST FLOOR: USE "HD HOLD-DOWN DETAIL" ON SD SHEET (OR EQUIV.)
- SHIEL (OK EQUIV.)

 **UPPER FLOORS; ATTACH BASE OF KING STUD MITH A

 SIMPSON C522 STRAP DOWN ACROSS THE BAND AND DOWN TO A STUD BELOW OR HEADER BELOW. EXTEND STRAP 7" MIN. ALONG EACH STUD (OR HEADER) AND ATTACH EACH END W (7)
- 5. INTERIOR BRACED WALL: (NOTED AS "IBW" ON PLANS) ATTACH 1/2" GYPSUM BOARD (GB) ON EACH SIDE OF WALL WITH A MIN. OF 5d COOLER NAILS OR #6 SCREWS @ 7" O.C. ALONG THE EDGES AND AT INTERMEDIATE SUPPORTS
- INTERIOR BRACED WALL-WOOD STRUCTURAL PANEL: (NOTED AS "IBW-WSP" ON PLANS). ATTACH ONE SIDE WITH 1/6" WSP SHEATHING WITH 8d NAILS AT A 6"/12" NAILING PATTERN (6" OC AT PANEL EDGES AND 12" OC AT INTERMEDIATE SUPPORTS). INSTALL BLOCKING AT ALL PANEL EDGES. ATTACH GB OVER WSP AS REQUIRED. ATTACH OPPOSITE SIDE WITH I/2" GB WITH A MIN, OF 5d COOLER NAILS OR #6 SCREWS @ 7" OC ALONG

HD (2) 1.75x14 LVL 905 SD ΙΒΜ **(**0 → -I-JOIST TRANSITION BY SUPPLIER IF 16" JOISTS ARE USED. (CS-PF) ____<u>5J</u>_____ WALL (3) 2xl2 _=___5 902 SD 16" I-JOISTS @ 12" 0.C. OR UBLE 14" HEAVY I-JOISTS @ 16 8'-0" Tall Garage Door 14" I-JOISTS 9 19.2" O.C. 5.25"x5.25" PSL, LVL, OR-GLULAM COLUMN. INSTALL HTT4 HOLD-DOWN ON INTERIOR SIDE OF WALL LVL. OR GLULAM COLUMN 2x4 STUDS-@ 12" O.C. SD / SD (APA-PF) (APA-PF) (2) 2x10 (2) 2xIO (2) 2x10 CRAWL AND MONO-SLAB STEMWALL CANTILEVER FOR SLAB FND BUILD LEDGE IN TO WALL ABOVE TRUSSES FOR WALL ABOVE **OPT. 3-CAR SIDE LOAD GARAGE** ___(2) 2xIO (TYP.)____

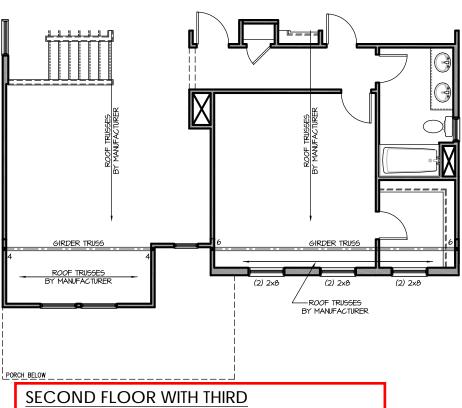

CAR GARAGE OPTION 'ENGLISH COUNTRY'

SCALE: 1/8"=1'-0" ON 11x17, 1/4"=1'-0" ON 22x34

REFER TO "SD" SHEET(S) FOR STANDARD DETAILS BRACING DETAILS AND STRUCTURAL NOTES. PROJECT # 21-2817-RH

> to be brought to t one year from date of seal. oval of terms & conditions

P.A. 27609

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SOUTH DESIGNS

至 Selma HOME,

Plan

TRUSS SYSTEM REQUIREMENTS

NC (2018 NCRC): Wind: 115-120 mph

- TRUSS SYSTEM LAYOUTS (PLACEMENT PLANS) SHALL BE DESIGNED IN ACCORDANCE WITH SEALED STRUCTURAL PLANS. ANY NEED TO CHANGE TRUSSES SHALL BE COORDINATED WITH SOUTHERN ENGINEERS.
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HEADER/BEAM & COLUMN NOTES


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 SHEATHING SHALL BE ATTACHED WITH 8d NAILS AT A 6"/12" NAILING PATTERN (6" OC AT PANEL EDGES AND 12" OC AT INTERMEDIATE SUPPORTS). INSTALL BLOCKING AT ALL PANEL EDGES.
- 3. WSP SHEATHING SHALL EXTEND TO THE UPPERMOST DOUBLE BEARING PLATE, BLOCK AT ROOF PER SECTION R602,10,45 AND ATTACH BRACED WALLS PER CODE, WSP SHEATHING BETWEEN FLOORS SHALL BE SPLICED ALONG CONTINUOUS BAND OR THE WSP SHEATHING MAY BE SPLICED ACROSS STUDS (CONTINUOUS ACROSS FLOOR SYSTEM) WITH BLOCKING AT PANEL EDGES. (MINIMUM 12" BEYOND FLOOR BREAK) OR OTHER APPROVED METHOD.
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- **GROUND/FIRST FLOOR: USE "HD HOLD-DOWN DETAIL" ON SD SHEET (OR EQUIV.)
- STEEL (OR EGOIV)

 "UPPER ILOORS, ATTACH BASE OF KING STUD WITH A SIMPSON C522 STRAP DOWN ACROSS THE BAND AND DOWN TO A STUD BELOW OR HEADER BELOW. EXTEND STRAP T" MIN ALONG EACH STUD (OR HEADER) AND ATTACH EACH END W (1) 8d NAILS.
- 5. INTERIOR BRACED WALL: (NOTED AS "IBW" ON PLANS) ATTACH I/2" GYPSUM BOARD (GB) ON EACH SIDE OF WALL WITH A MIN. OF 5d COOLER NAILS OR #6 SCREWS @ 7" O.C. ALONG THE EDGES AND AT INTERMEDIATE SUPPORTS.
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SECOND FLOOR PLAN 'ENGLISH COUNTRY' SCALE: 1/8"=1'-0" ON 11x17, 1/4"=1'-0" ON 22x34

PROJECT # 21-2817-RH

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3716 Benson Dri
Phone: (


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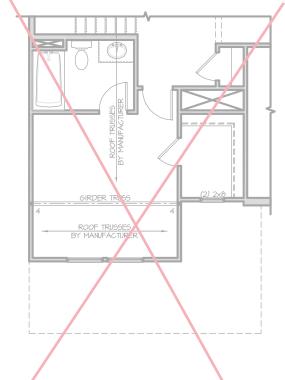
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Plan

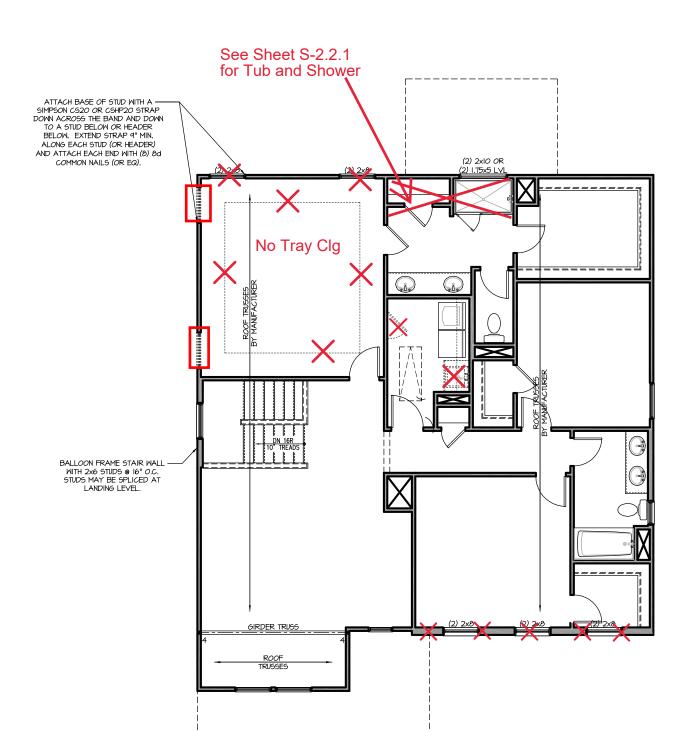DETAILS AND STRUCTURAL NOTES.

REFER TO "SD" SHEET(S) FOR STANDARD DETAILS BRACING




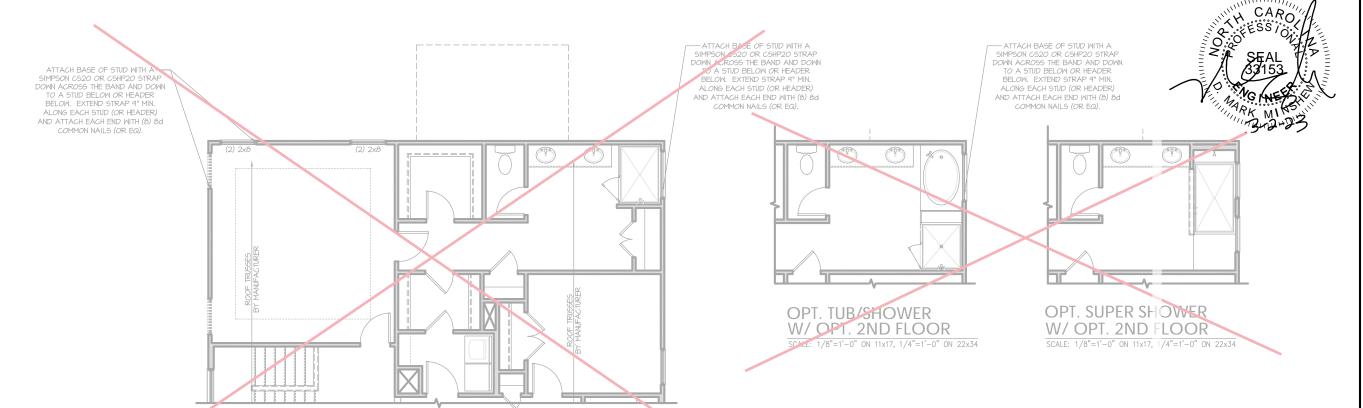

OPT. 2ND FLOOR

SCALE: 1/8"=1'-0" ON 11x17, 1/4"=1'-0" ON 22x34



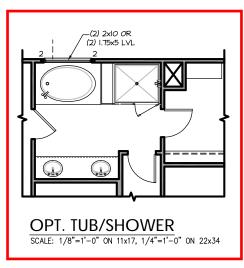



OPT. BEDROOM 5 / BATH 4 SCALE: 1/8"=1'-0" ON 11x17, 1/4"=1'-0" ON 22x34

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PROJECT # 21-2817-RH

Engineers seal appues our, occasional document.

document.

Seal does not include construction means, methods, techniques, sequences, procedures or safety precautions.

Any deviations or discrepancies on plans are to be brought to the immediate attention of Southern Engineers. Failure to do so will void Southern Engineers. Failure to seal.

Seal is valid for projects permitted one year from date of seal.

Use of these plans constitutes approval of terms & conditions as defined in the customer agreement.

Southern Engineers, P.A. 3716 Benson Drive, Raleigh, NC 27609 Phone: (919) 878-1617 License: C-4772 www.southernengineers.com

SOUTH DESIGNS

RH Selma NEW HOME, The 8 Plan

S-2.2.

TRUSS SYSTEM REQUIREMENTS

NC (2018 NCRC): Wind: 115-120 mph


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- ALL TRUSSES SHALL BE DESIGNED FOR BEARING ON SPF #2 OR #3 PLATES OR LEDGERS (UNO).
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	ATTIC VENT SCHEDULE												
'ENGLISH COUNTRY' ELEVATION													
MAIN HOUSE SQ FTG 1514 AT / NEAR RIDGE					AT / NE	AR EAVE							
VENT TYPE	SQ. REQL		SQ. FT.	SQ. FT. PERCENT OF TOTAL	POT LARGE (SQ. FT. EACH)	POT SMALL (SQ. FT. EACH)	RIDGE VENT (SQ. FT. PER LF)	EAVE VENT (SQ. IN. EACH)	CONT. VENT (SQ. IN. PER LF)				
	RANGE		SUPPLIED	SUPPLIED	0.4236	0.2778	0.125	0.1944	0.0625				
RIDGE VENT	2.02	2.52	3.50	48.28	0	0	28.00						
SOFFIT VENTS	3.03	2.52	3.75	51.72	0 60.00								
TOTAL (MIN)	5.05	5.05	7.25	100.00	POT VENTS MAY BE REQUIRED IF THERE IS INSUFFICIENT RIDGE AVAILABLE								

^{*} SCHEDULE HAS BEEN CALCULATED ASSUMING EAVE VENTILATION AT 50-60% OF TOTAL AND RIDGE AT 40-50% OF TOTAL REQUIRED VENTILATION



'ENGLISH COUNTRY' ELEVATION ROOF PLAN SCALE: 1/4" = 1'-0" ON 22x34, 1/8" = 1'-0" ON 11x17

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PROJECT # 21-2817-RH
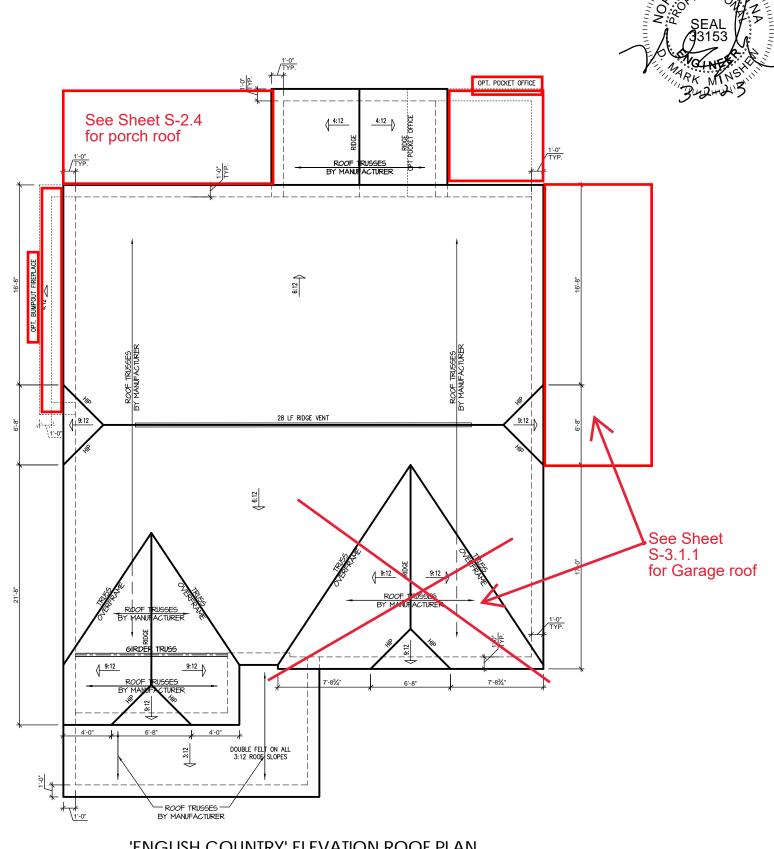
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SOUTH DESIGNS

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Plan


	ATTIC VENT SCHEDULE																				
ENGLISH COUNTRY																					
MAIN	HOUSE		SQ FTG	FTG 260 AT / NEAR RIDGE AT / NE			AT / NE	AR EAVE													
		. FT. JIRED	SQ. FT.													PERCENT OF TOTAL	POT LARGE (SQ. FT. EACH)	POT SMALL (SQ. FT. EACH)	RIDGE VENT (SQ. FT. PER LF)	EAVE VENT (SQ. IN. EACH)	CONT. VENT (SQ. IN. PER LF)
	RAN	IGE	SUPPLIED	SUPPLIED	0.4236	0.2778	0.125	0.1944	0.0625												
RIDGE VENT	0.35	0.43	1.00	44.44	0	0	8.00														
SOFFIT VENTS	0.52	0.43	1.25	55.56	0 20.00																
TOTAL (MIN)	0.87	0.87	2.25	100.00	POT VENTS MAY BE REQUIRED IF THERE IS INSUFFICIENT RIDGE AVAILABLE																

^{*} SCHEDULE HAS BEEN CALCULATED ASSUMING EAVE VENTILATION AT 50-60% OF TOTAL AND RIDGE AT 40-50% OF TOTAL REQUIRED VENTILATION

TRUSS SYSTEM REQUIREMENTS

NC (2018 NCRC): Wind: 115-120 mph

- TRUSS SYSTEM LAYOUTS (PLACEMENT PLANS)
 SHALL BE DESIGNED IN ACCORDANCE WITH SEALED
 STRUCTURAL PLANS. ANY NEED TO CHANGE
- TRUSS SCHEMATICS (PROFILES) SHALL BE
 PREPARED AND SEALED BY TRUSS MANUFACTURER.
- 3. ALL TRUSSES SHALL BE DESIGNED FOR BEARING ON SPF #2 OR #3 PLATES OR LEDGERS (UNO).
- ALL REQUIRED ANCHORS FOR TRUSSES DUE TO UPLIFT OR BEARING SHALL MEET THE REQUIREMENTS AS SPECIFIED ON THE TRUSS

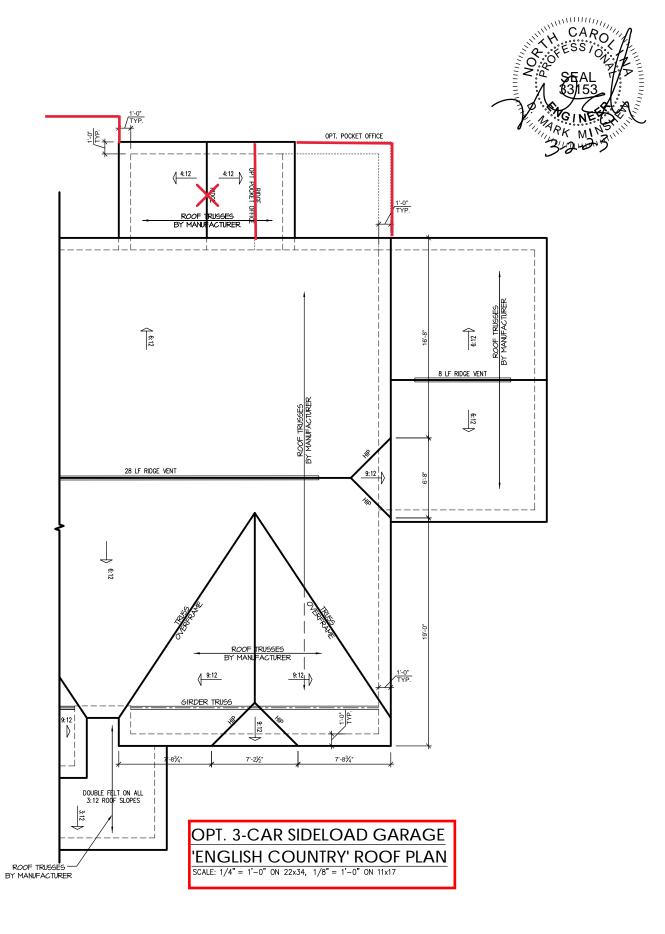

PROJECT # 21-2817-RH

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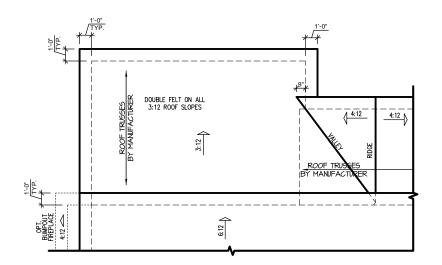
SOUTH DESIGNS

RH Selma NEW HOME, Plan

STANDARD DETAILS, BRACING DETAILS AND STRUCTURAL NOTES.

REFER TO "SD" SHEET(S) FOR

COVERED PORCH FLOOR PLAN SCALE: 1/8"=1'-0" ON 11x17, 1/4"=1'-0" ON 22x34



COVERED PORCH ROOF PLAN SCALE: 1/8"=1'-0" ON 11x17, 1/4"=1'-0" ON 22x34

6:12 SHINGLES AS SPECIFIED -W/OPT 2ND FLOOR LAYOUT & SUPER SHOWER 2nd PLT. HGT. HEADER HEIGHT _W/OPT 2ND FLOOR LAYOUT & TUB/SHOWER -DOUBLE FELT SHINGLES AS SPECIFIED DOUBLE FELT-2nd FLR. LINE 1st PLT. HGT. HEADER HEIGHT OPTIONAL WINDOW—/ W/INTERIOR FIREPLACE

PARTIAL RIGHT SIDE ELEVATION (SLAB) SCALE: 1/8"=1'-0" ON 11x17, 1/4"=1'-0" ON 22x34

COVERED PORCH REAR ELEVATION (SLAB) SCALE: 1/8"=1'-0" ON 11x17, 1/4"=1'-0" ON 22x34

PARTIAL LEFT SIDE ELEVATION (SLAB) SCALE: 1/8"=1'-0" ON 11x17, 1/4"=1'-0" ON 22x34


REFER TO "SD" SHEET(S) FOR STANDARD DETAILS, BRACING DETAILS AND STRUCTURAL NOTES.


PROJECT # 21-2817-RH


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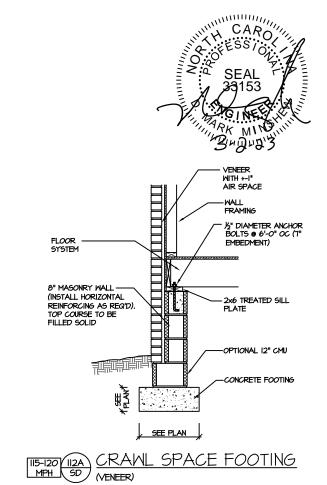
SOUTH DESIGNS


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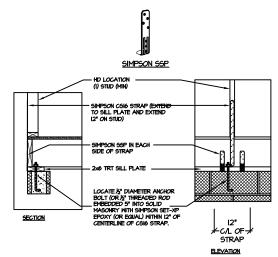




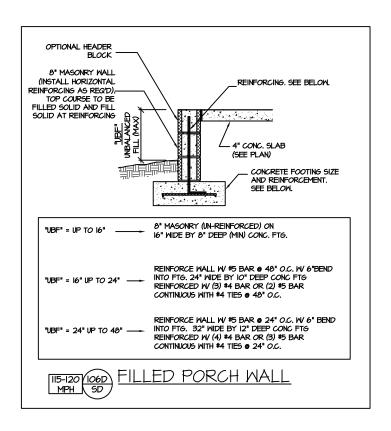

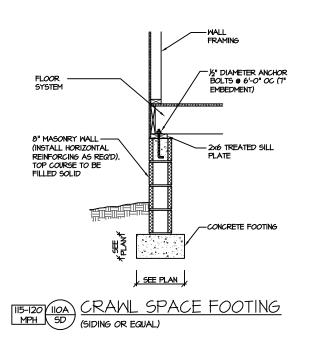
GARAGE WALI FOOTING (VENEER)

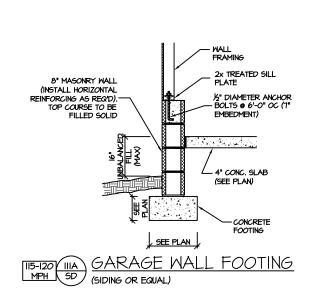(FOR UNBALANCED FILL EXCEEDING 16" O.C. SEE DETAIL "IO6D/SD")

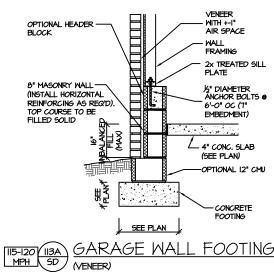

BRACED WALL END CONDITION " HD" HOLD-DOWN DETAIL

NOTE: SIMPSON DTT-IZ IS ACCEPTABLE ALTERNATE NOTE: ALTERNATE HD HOLD-DOWN DEVICES OR SYSTEMS MAY BE USED TO MEET THE CODE REQUIRED 800 LB CAPACITY IN LIEU OF THE ABOVE DETAIL.

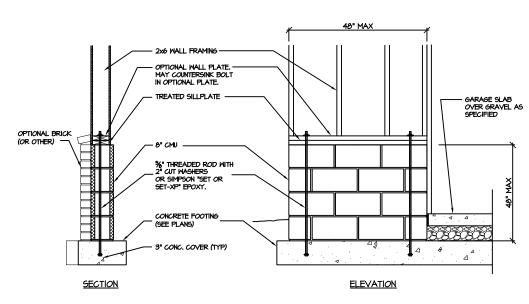

GARAGE 'WING WALL' REINFORCING PER IRC FIGURE R602.IO.4.3

CRAWL SPACE FOUNDATION

PROJECT # 21-2817


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MITH +-I" AIR SPACE - WALL FRAMING - TREATED SILL PLATE - ½" DIAMETER ANCHOR BOLTS @ 6'-O" OC (7" EMBEDMENT) OR SIMPSON MASA MUDSILL ANCHORS @ 6'-O" OC (ADJUST LOCATION AT DOOR OPENINGS.) LOCATE 12" FROM PLATE 4" CONC. SLAB (SEE PLAN)




MONOLITHIC SLAB @ GARAGE


MONOLITHIC SLAB FOOTING (MPH SD) MONOLITHIC SLAB FOOTING

VENEER

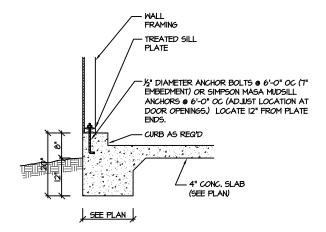
MPH SD (SIDING OR FOLK)

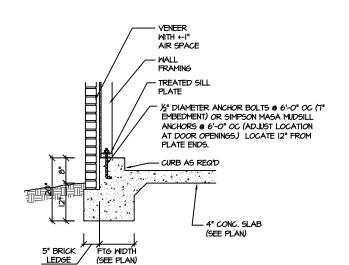


MONOLITHIC SLAB @ GARAGE (VENEER)

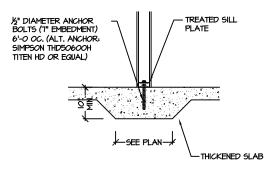



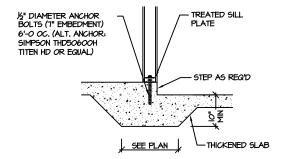

THICKENED SLAB @ GARAGE (INTERIOR GARAGE WALL)

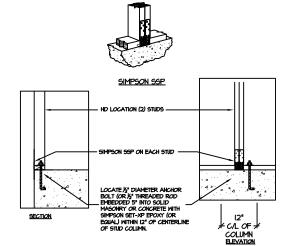

II5-I20 IOIA MPH SD

(SIDING OR EQUAL)

BRACED WALL END CONDITION "HD" HOLD-DOWN DETAIL

NOTE: SIMPSON DTT-IZ IS ACCEPTABLE ALTERNATE NOTE: ALTERNATE HD HOLD-DOWN DEVICES OR SYSTEMS MAY BE USED TO MEET THE CODE REQUIRED 800 LB CAPACITY IN

LIEU OF THE ABOVE DETAIL.

SLAB FOUNDATION

PROJECT # 21-2817


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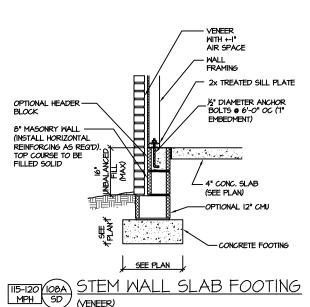
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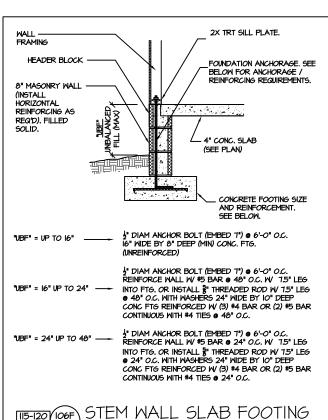





(FOR UNBALANCED FILL EXCEEDING 16" O.C.

(VENEER)


SEE DETAIL "IO6E/SD")

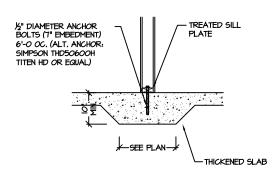


(SIDING OR EQUAL)

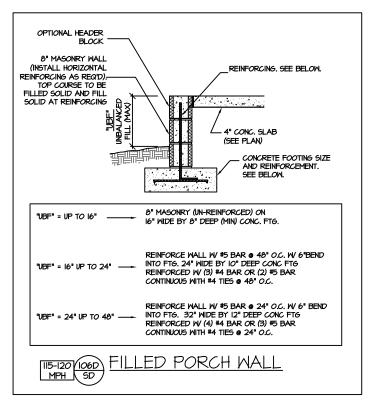




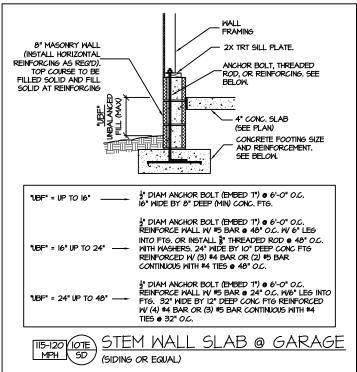

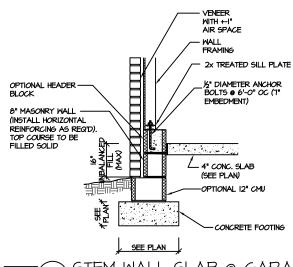


STEM WALL SLAB @ GARAGE 115-120 109A MPH SD (VENEER) (FOR UNBALANCED FILL EXCEEDING 16" O.C.

SEE DETAIL "IO6E/SD")

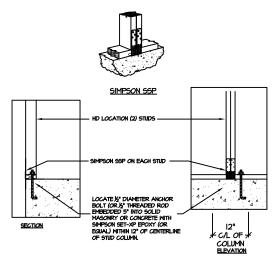

BRACED WALL END CONDITION "HD" HOLD-DOWN DETAIL

NOTE: SIMPSON DTT-IZ IS ACCEPTABLE ALTERNATE NOTE: ALTERNATE HD HOLD-DOWN DEVICES OR SYSTEMS MAY BE USED TO MEET THE CODE REQUIRED 800 LB CAPACITY IN LIEU OF THE ABOVE DETAIL.

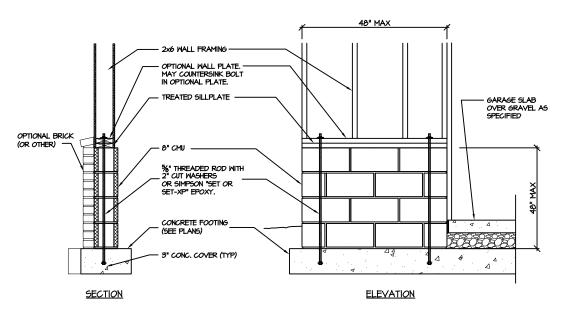

GARAGE 'WING WALL' REINFORCING PER IRC FIGURE R602.IO.4.3

STEMMALL SLAB FOUNDATION

PROJECT # 21-2817


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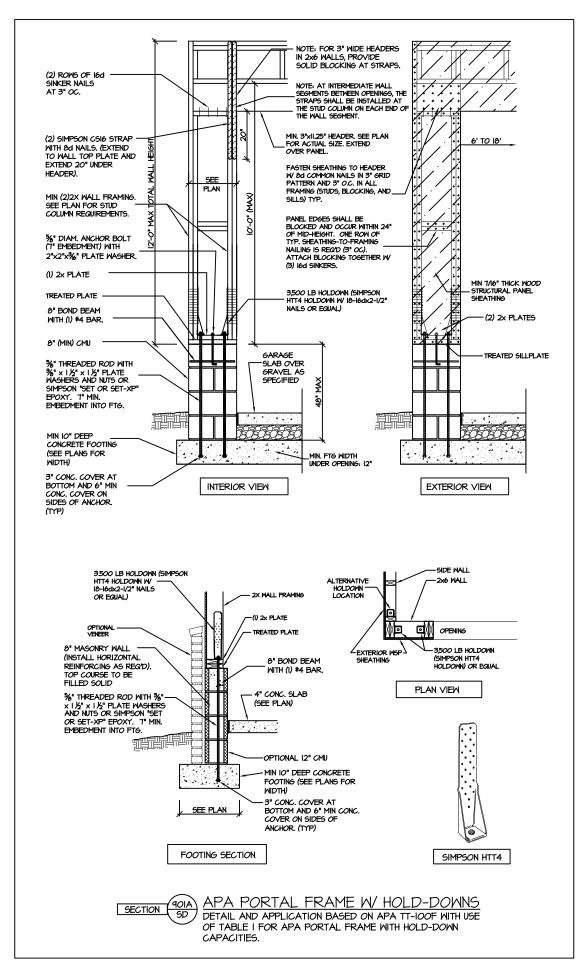
Southern Engineers, F 3716 Benson Drive, Raleigh, NC 2. Phone: (919) 878-1617

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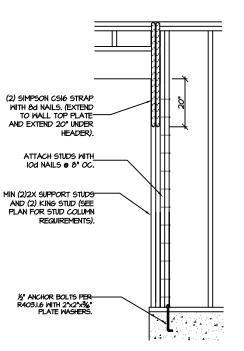
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CS-PF - OVER WOOD FLOOR

MSP OVERLAP OPTION

CS-PF: CONTINUOUS PORTAL FRAME CONSTRUCTION DETAIL AND APPLICATION BASED ON NORC FIGURE R602.IO.I - PORTAL FRAME CONSTRUCTION

FRAMING ANCHOR OPTION

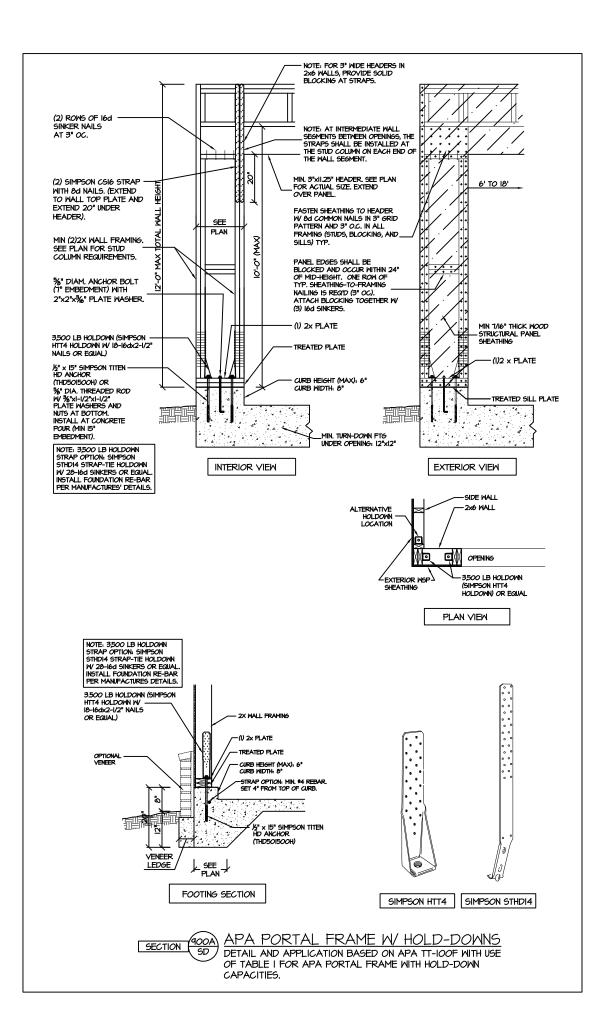

<u> CS-PF: END CONDITION DETAIL</u> (FOR USE WITH SINGLE CS-PF CONDITION) DETAIL AND APPLICATION BASED ON NORC FIGURE R602.IO.I - PORTAL FRAME CONSTRUCTION



STRUCTURAL NOTES

NC (2018 NCRC): Wind: 115-120 mph

- I. ENGINEER'S SEAL APPLIES ONLY TO STRUCTURAL COMPONENTS INCLUDING ROOF RAFTERS, HIPS, VALLEYS, RIDGES, FLOORS, WALLS, BEAMS AND HEADERS, COLUMNS, CANTILEVERS, OFFSET LOAD BEARING WALLS, PIER & GIRDER SYSTEM, FOOTING, AND PILING SYSTEM. ENGINEER'S SEAL DOES NOT CERTIFY DIMENSIONAL ACCURACY OR ARCHITECTURAL LAYOUT INCLIDING ROOF SYSTEM. ALL REQUIREMENTS FOR PROFESSIONAL CERTIFICATION SHALL BE PROVIDED BY THE APPROPRIATE PROFESSIONAL. SOUTHERN ENGINEERS, P.A. CERTIFIES ONLY THE STRUCTURAL COMPONENTS AS SPECIFICALLY STATED
- ALL CONSTRUCTION SHALL CONFORM TO THE LATEST REQUIREMENTS OF THE 2018 NC RESIDENTIAL CODE, PLUS ALL LOCAL CODES AND REGULATIONS, THE STRUCTURAL ENGINEER IS NOT RESPONSIBLE FOR, AND WILL NOT HAVE CONTROL OF, CONSTRUCTION MEANS, METHODS, TECHNIQUES, SEQUENCES OR PROCEDURES, OR FOR SAFETY PRECAUTIONS AND PROGRAMS IN CONNECTION WITH THE CONSTRUCTION WORK, NOR WILL THE ENGINEER BE RESPONSIBLE FOR THE CONTRACTOR'S FAILURE TO CARRY OUT THE CONSTRUCTION WORK IN ACCORDANCE WITH THE CONTRACT DOCUMENTS, "CONSTRUCTION REVIEW" SERVICES ARE NOT PART OF OUR CONTRACT ALL MEMBERS SHALL BE FRAMED ANCHORED, TIED AND BRACED IN ACCORDANCE WITH 600D CONSTRUCTION PRACTICE AND THE BUILDING CODE.
- 3. DESIGN LOADS (LISTED AS: LIVE LOAD, DEAD LOAD, DEFLECTION)
- ROOMS OTHER THAN SLEEPING ROOMS: (40 PSF, IO PSF, L/360) SLEEPING ROOMS: (30 PSF, IO PSF, L/360)
- ATTIC WITH PERMANENT STAIR: (40 PSF, IO PSF, L/360)
- ATTIC WITHOUT PERMANENT STAIR: (20 PSF, I/0 PSF, L/360) ATTIC WITHOUT STORAGE: (10 PSF, I/0 PSF, L/240)

- STAIRS: (40 PSF, IO PSF, L/360)
 DECKS AND EXTERIOR BALCONIES: (40 PSF, IO PSF, L/360)
- PASSENGER VEHICLE GARAGES: (50 PSF, 10 PSF, L/360)
- SNOW: (20 PSF)
- 4. WALLS SHALL BE BRACED BY SHEATHING WALLS ON ALL STORIES WITH WOOD STRUCTURAL PANELS. SEE FRAMING NOTES FOR THICKNESS AND NAILING REQUIREMENTS.
- 5. SEE APPENDIX M (DCA6) FOR EXTERIOR DECK REQUIREMENTS INCLUDING ATTACHMENTS FOR
- 6. CONCRETE SHALL HAVE A MINIMUM 26 DAY STRENGTH OF 3000 PSI AND A MAXIMUM SLUMP OF 5 INCHES UNLESS NOTED OTHERWISE (UNO). AIR ENTRAINED PER TABLE 402.2. ALL CONCRETE SHALL BE PROPORTIONED, MIXED, HANDLED, SAMPLED, TESTED, AND PLACED IN ACCORDANCE WITH ACI STANDARDS, ALL SAMPLES FOR PUMPING SHALL BE TAKEN FROM THE EXIT END OF THE PUMP. CONTROL JOINTS IN SLABS SHALL BE SPACED ON A GRID OF +30 TIMES THE DEPTH (D). CONTROL JOINTS SHALL BE SANCUT TO A DEPTH OF I/D. (I.E. 4" CONCRETE SLABS SHALL HAVE 1/4" DEEP CONTROL JOINTS SAWCUT IN SLAB ON A +-10'-0" x +-10'-0" GRID)
- ALLOWABLE SOIL BEARING PRESSURE ASSUMED TO BE 2000 PSF. THE CONTRACTOR MUST CONTACT A GEOTECHNICAL ENGINEER AND THE STRUCTURAL ENGINEER IF UNSATISFACTORY SUBSURFACE CONDITIONS ARE ENCOUNTERED. THE SURFACE AREA ADJACENT TO THE FOUNDATION WALL SHALL BE PROVIDED WITH ADEQUATE DRAINAGE, AND SHALL BE GRADED SO AS TO DRAIN SURFACE WATER AWAY FROM FOUNDATION WALLS.
- 8. ALL FRAMING LUMBER SHALL BE SPF #2 (Fb = 875 PSI) UNLESS NOTED OTHERWISE (UNO). ALL TREATED LUMBER SHALL BE SYP # 2. PLATE MATERIAL MAY BE SPF # 3 OR SYP #3 (Fc(perp) =
- q. L.V.L. SHALL BE LAMINATED VENEER LIMBER: Fb=2600 PSI, Fv=285 PSI, E=1.9xIO PSI.
 q.I. P.S.L. SHALL BE PARALLEL STRAND LIMBER: Fb=2400 PSI, Fv=240 PSI, E=2.0xIO PSI.
 q.2. L.S.L. SHALL BE LAMINATED STRAND LIMBER: Fb=2250 PSI, Fv=400 PSI, E=1.55xIO PSI. INSTALL ALL CONNECTIONS PER MANUFACTURERS INSTRUCTIONS.
- IO. ALL ROOF TRUSS AND I-JOIST LAYOUTS SHALL BE PREPARED IN ACCORDANCE WITH THE SEALED STRUCTURAL DRAWINGS. TRUSSES AND I-JOISTS SHALL BE INSTALLED ACCORDING TO THE MANUFACTURE'S SPECIFICATIONS. ANY CHANGE IN TRUSS OR I-JOIST LAYOUT SHALL BE COORDINATED WITH SOUTHERN ENGINEERS
- II. ALL STRUCTURAL STEEL SHALL BE ASTM A-36. STEEL BEAMS SHALL BE SUPPORTED AT EACH END WITH A MINIMUM BEARING LENGTH OF 3 1/2" INCHES AND FULL FLANGE MIDTH, PROVIDE SOLID BEARING FROM BEAM SUPPORT TO FOUNDATION. BEAMS SHALL BE ATTACHED TO EACH SUPPORT MITH TIMO LAG SCRENG (1/2" DIAMETER x 4" LONG). LATERAL SUPPORT 15 CONSIDERED ADEQUATE PROVIDING THE JOIST ARE TOE NAILED TO THE SOLE PLATE, AND SOLE PLATE IS NAILED OR BOLTED TO THE BEAM FLANGE @ 48" O.C. ALL STEEL TIBING SHALL BE ASTM A500.
- 12. REBAR SHALL BE DEFORMED STEEL, ASTM615, GRADE 60. LAP ALL REBAR SPLICES 30 BAR
- 13. FLITCH BEAMS SHALL BE BOLTED TOGETHER USING (2) ROWS OF 1/2" DIAMETER BOLTS (ASTM A325) MITH WASHERS PLACED INDER THE THREADED END OF BOLT. BOLTS SHALL BE SPACED AT 24" O.C. (MAX), AND STAGGERED AT THE TOP AND BOTTOM OF BEAM (2" EDGE DISTANCE),
- I4. BRICK LINTELS (WHEN REQUIRED) SHALL BE 3 I/2'x3 I/2'x1/4" STEEL ANGLE FOR UP TO 6'-0" SPAN AND 6'x4'x5/16" STEEL ANGLE WITH 6" LEG VERTICAL FOR SPANS UP TO 9'-0". SEE PLANS FOR SPANS OVER 9'-0". SEE ALSO SECTION RT03.8.3 LINTELS.

PROJECT # 21-2817

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