


PLANS DESIGNED TO THE 2018 NORTH CAROLINA STATE RESIDENTIAL BUILDING CODE

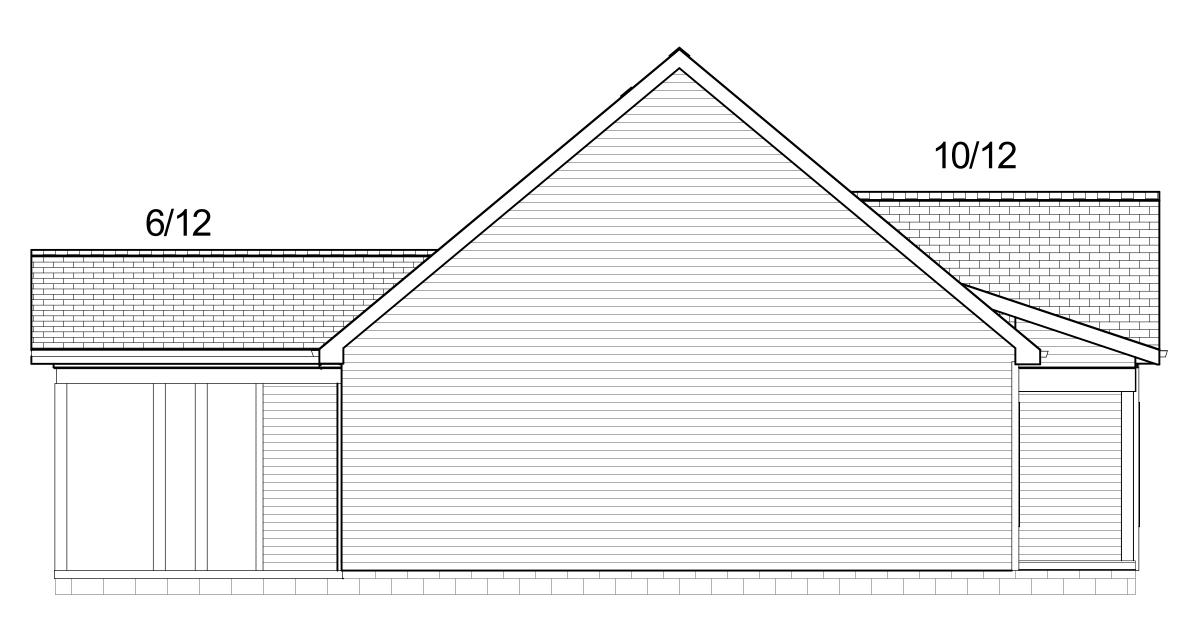

RIGHT ELEVATION



LEFT ELEVATION

PURCHASER MUST VERIFY ALL DIMENSIONS AND CONDITIONS BEFORE CONSTRUCTION BEGINS. TONY R. WIMBERLY ASSUMES NO LIABILITY OR RESPONSIBILITY FOR ANY STRUCTURAL OR DIMENSIONAL ERRORS OR OMISSIONS. THE CONTRACTOR AND/OR OWNER SHALL BE RESPONSIBLE FOR THE VERIFICATION AND CHECKING OF ALL NOTES, DETAILS, ELEVATIONS, SECTIONS, AND FLOOR PLANS. CODES AND CONDITIONS MAY VARY WITH LOCATION. A LOCAL DESIGNER, ARCHITECT, OR ENGINEER SHOULD BE CONSULTED BEFORE CONSTRUCTION. THESE ARE INSTRUMENTS OF SERVICE AND AS SUCH SHALL REMAIN PROPERTY OF TONY R. WIMBERLY.

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ELEVATIONS

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RYAN BEACHAM RESIDENCE

> ony R. Wimberly (919) 669-7066 mberly@gmail.com

DATE:


12/26/2023

SCALE:

1/4" = 1'


SHEET:

2

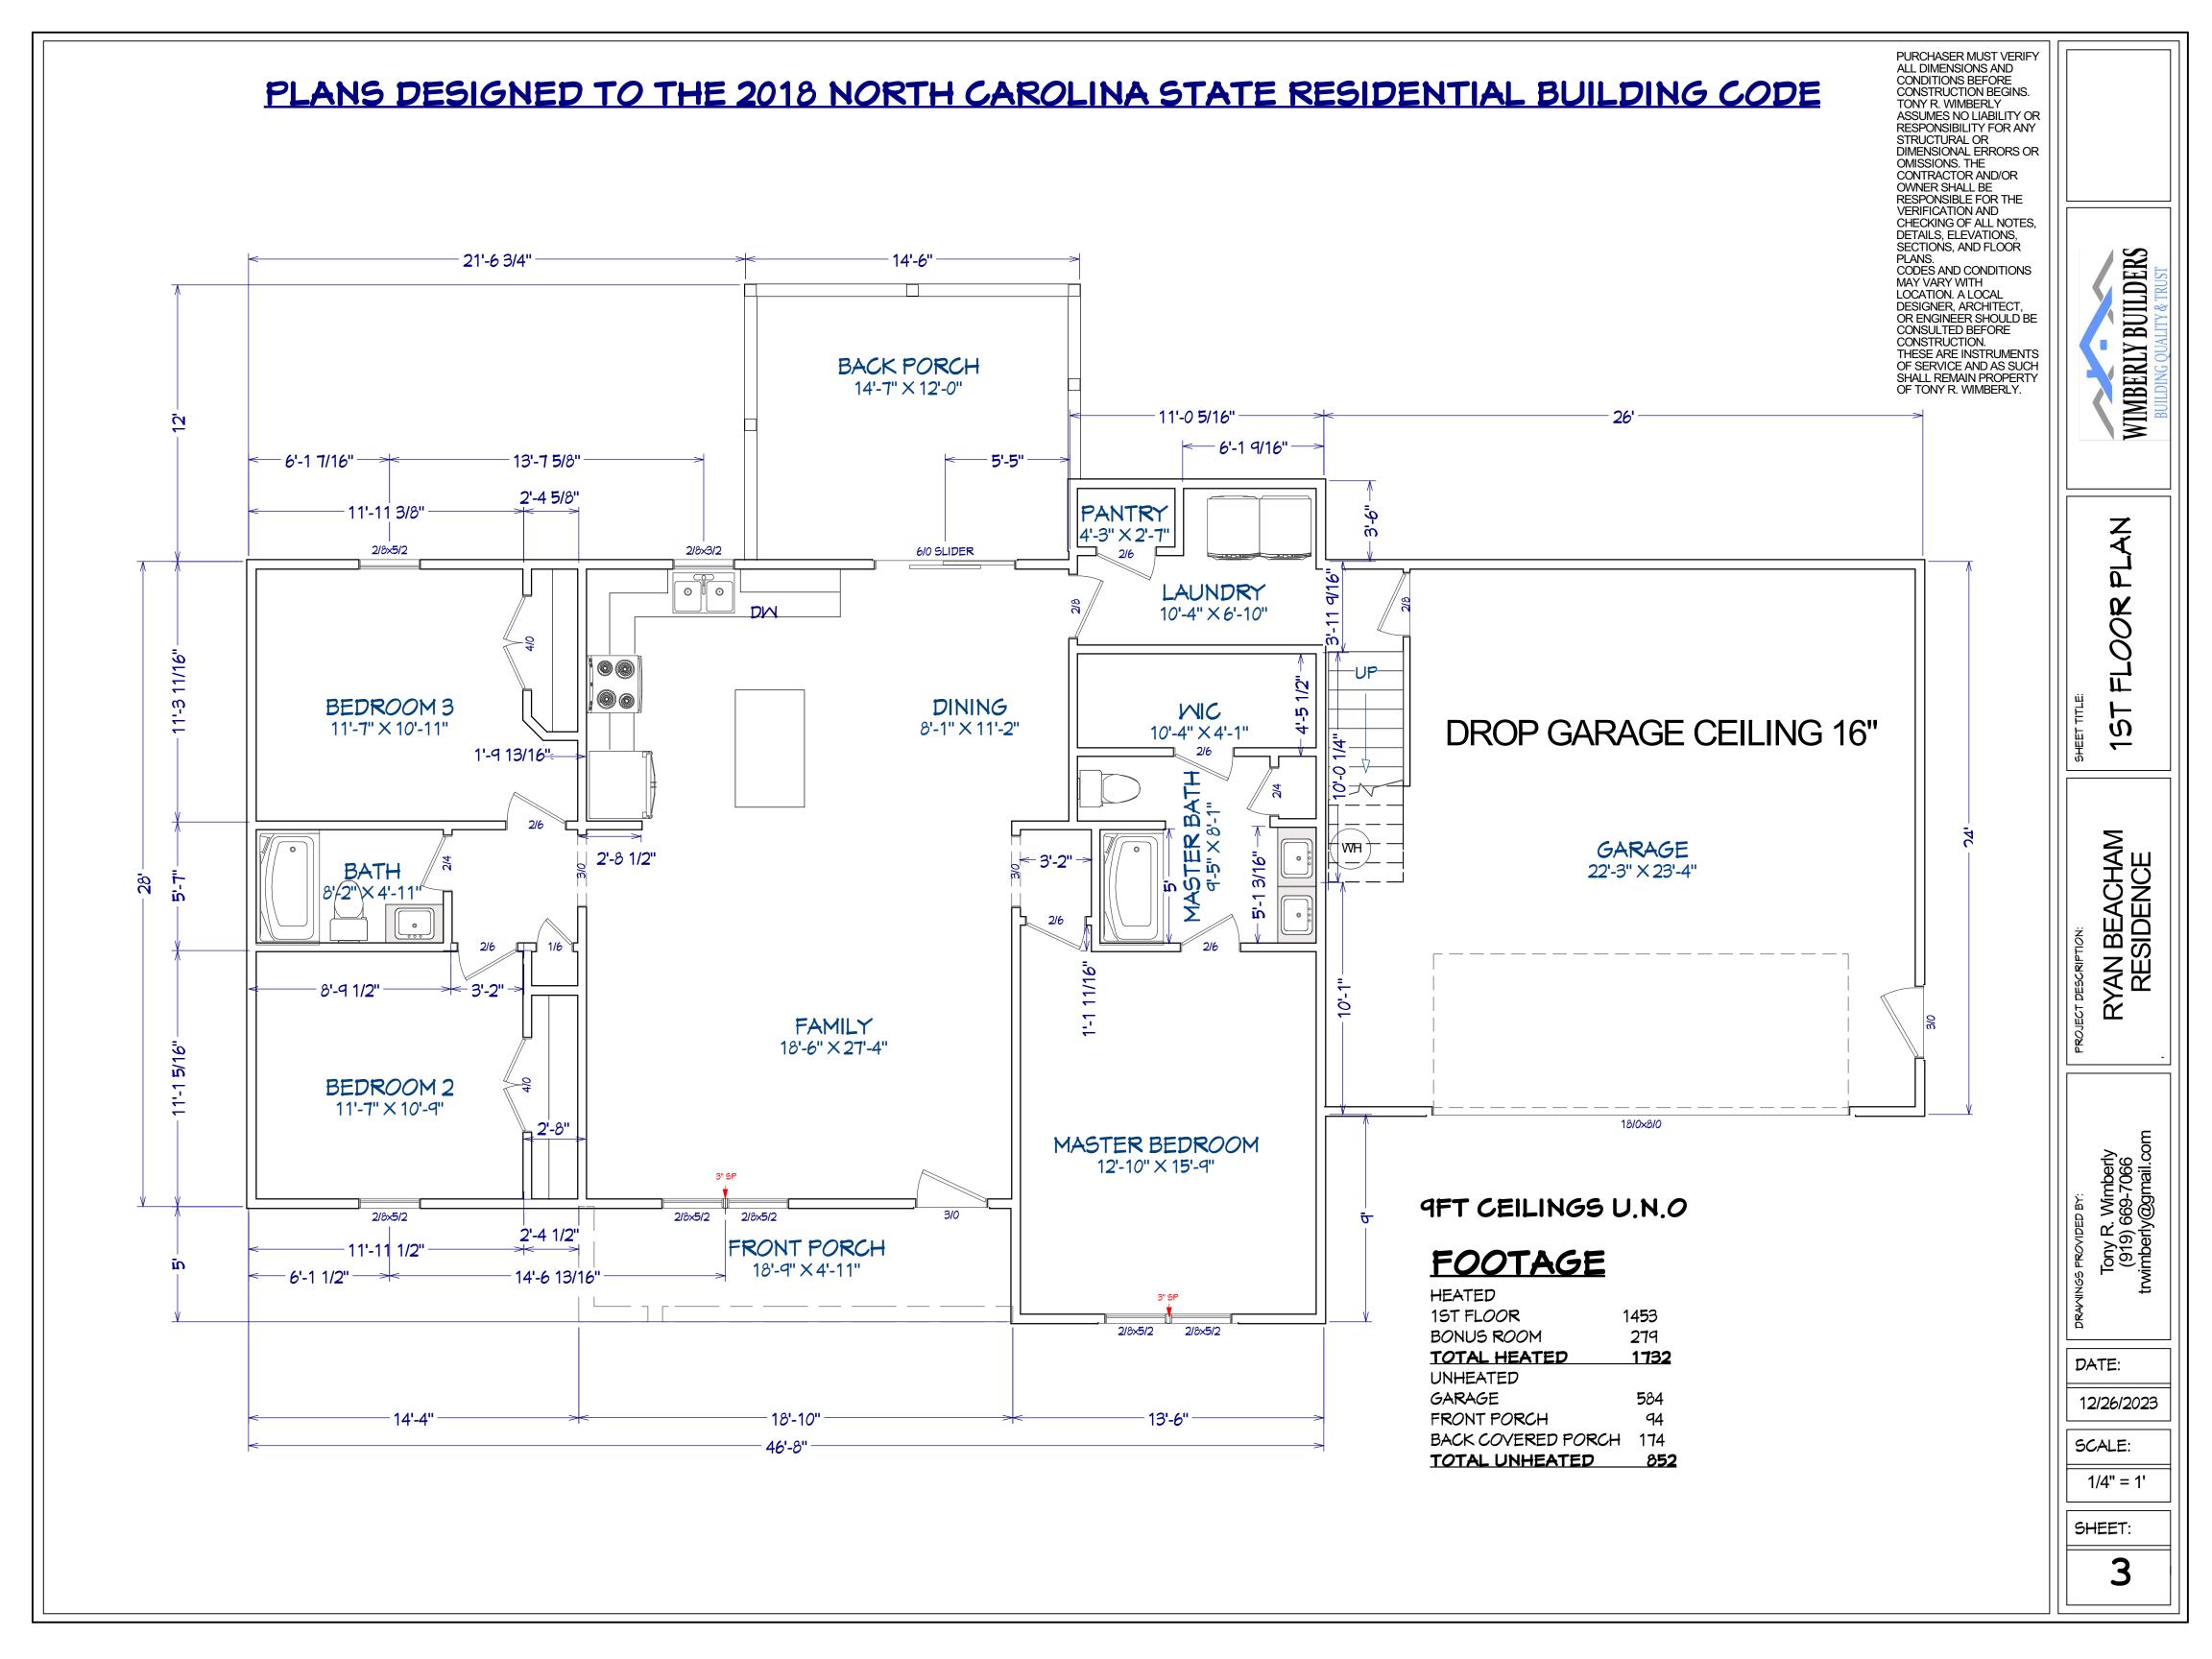

PLANS DESIGNED TO THE 2018 NORTH CAROLINA STATE RESIDENTIAL BUILDING CODE

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WIMBERLY BUILDERS

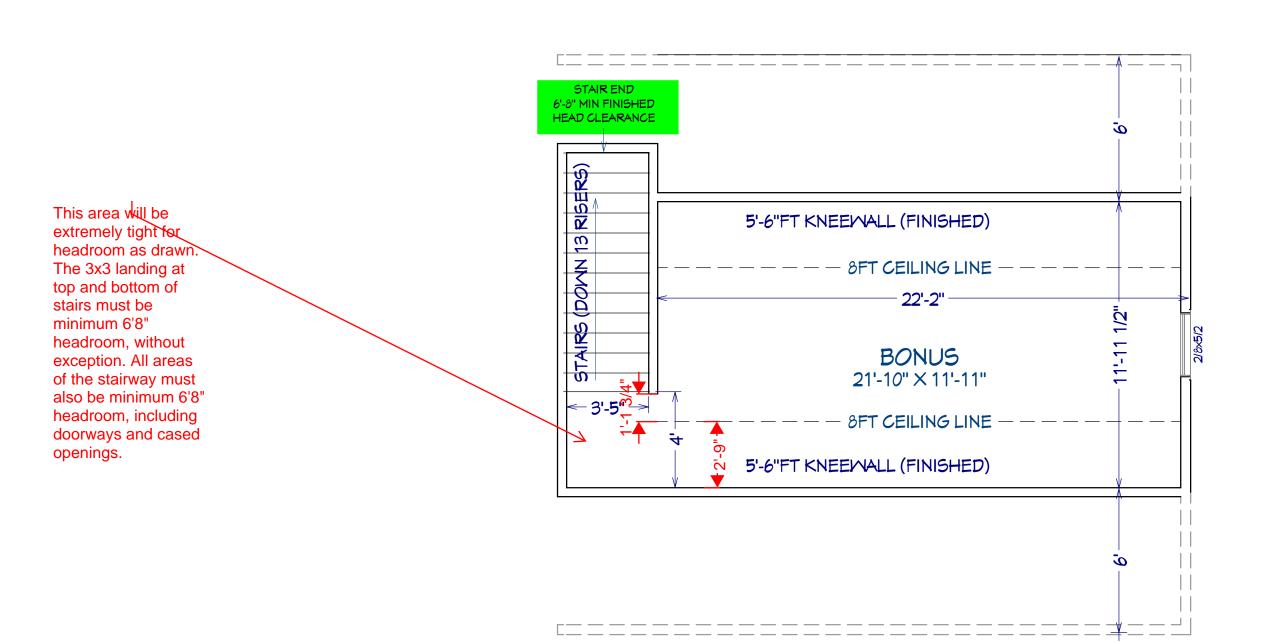2ND FLOOR PLAN


RYAN BEACHAM RESIDENCE


DATE:

12/26/2023 SCALE:

1/4" = 1'

SHEET:

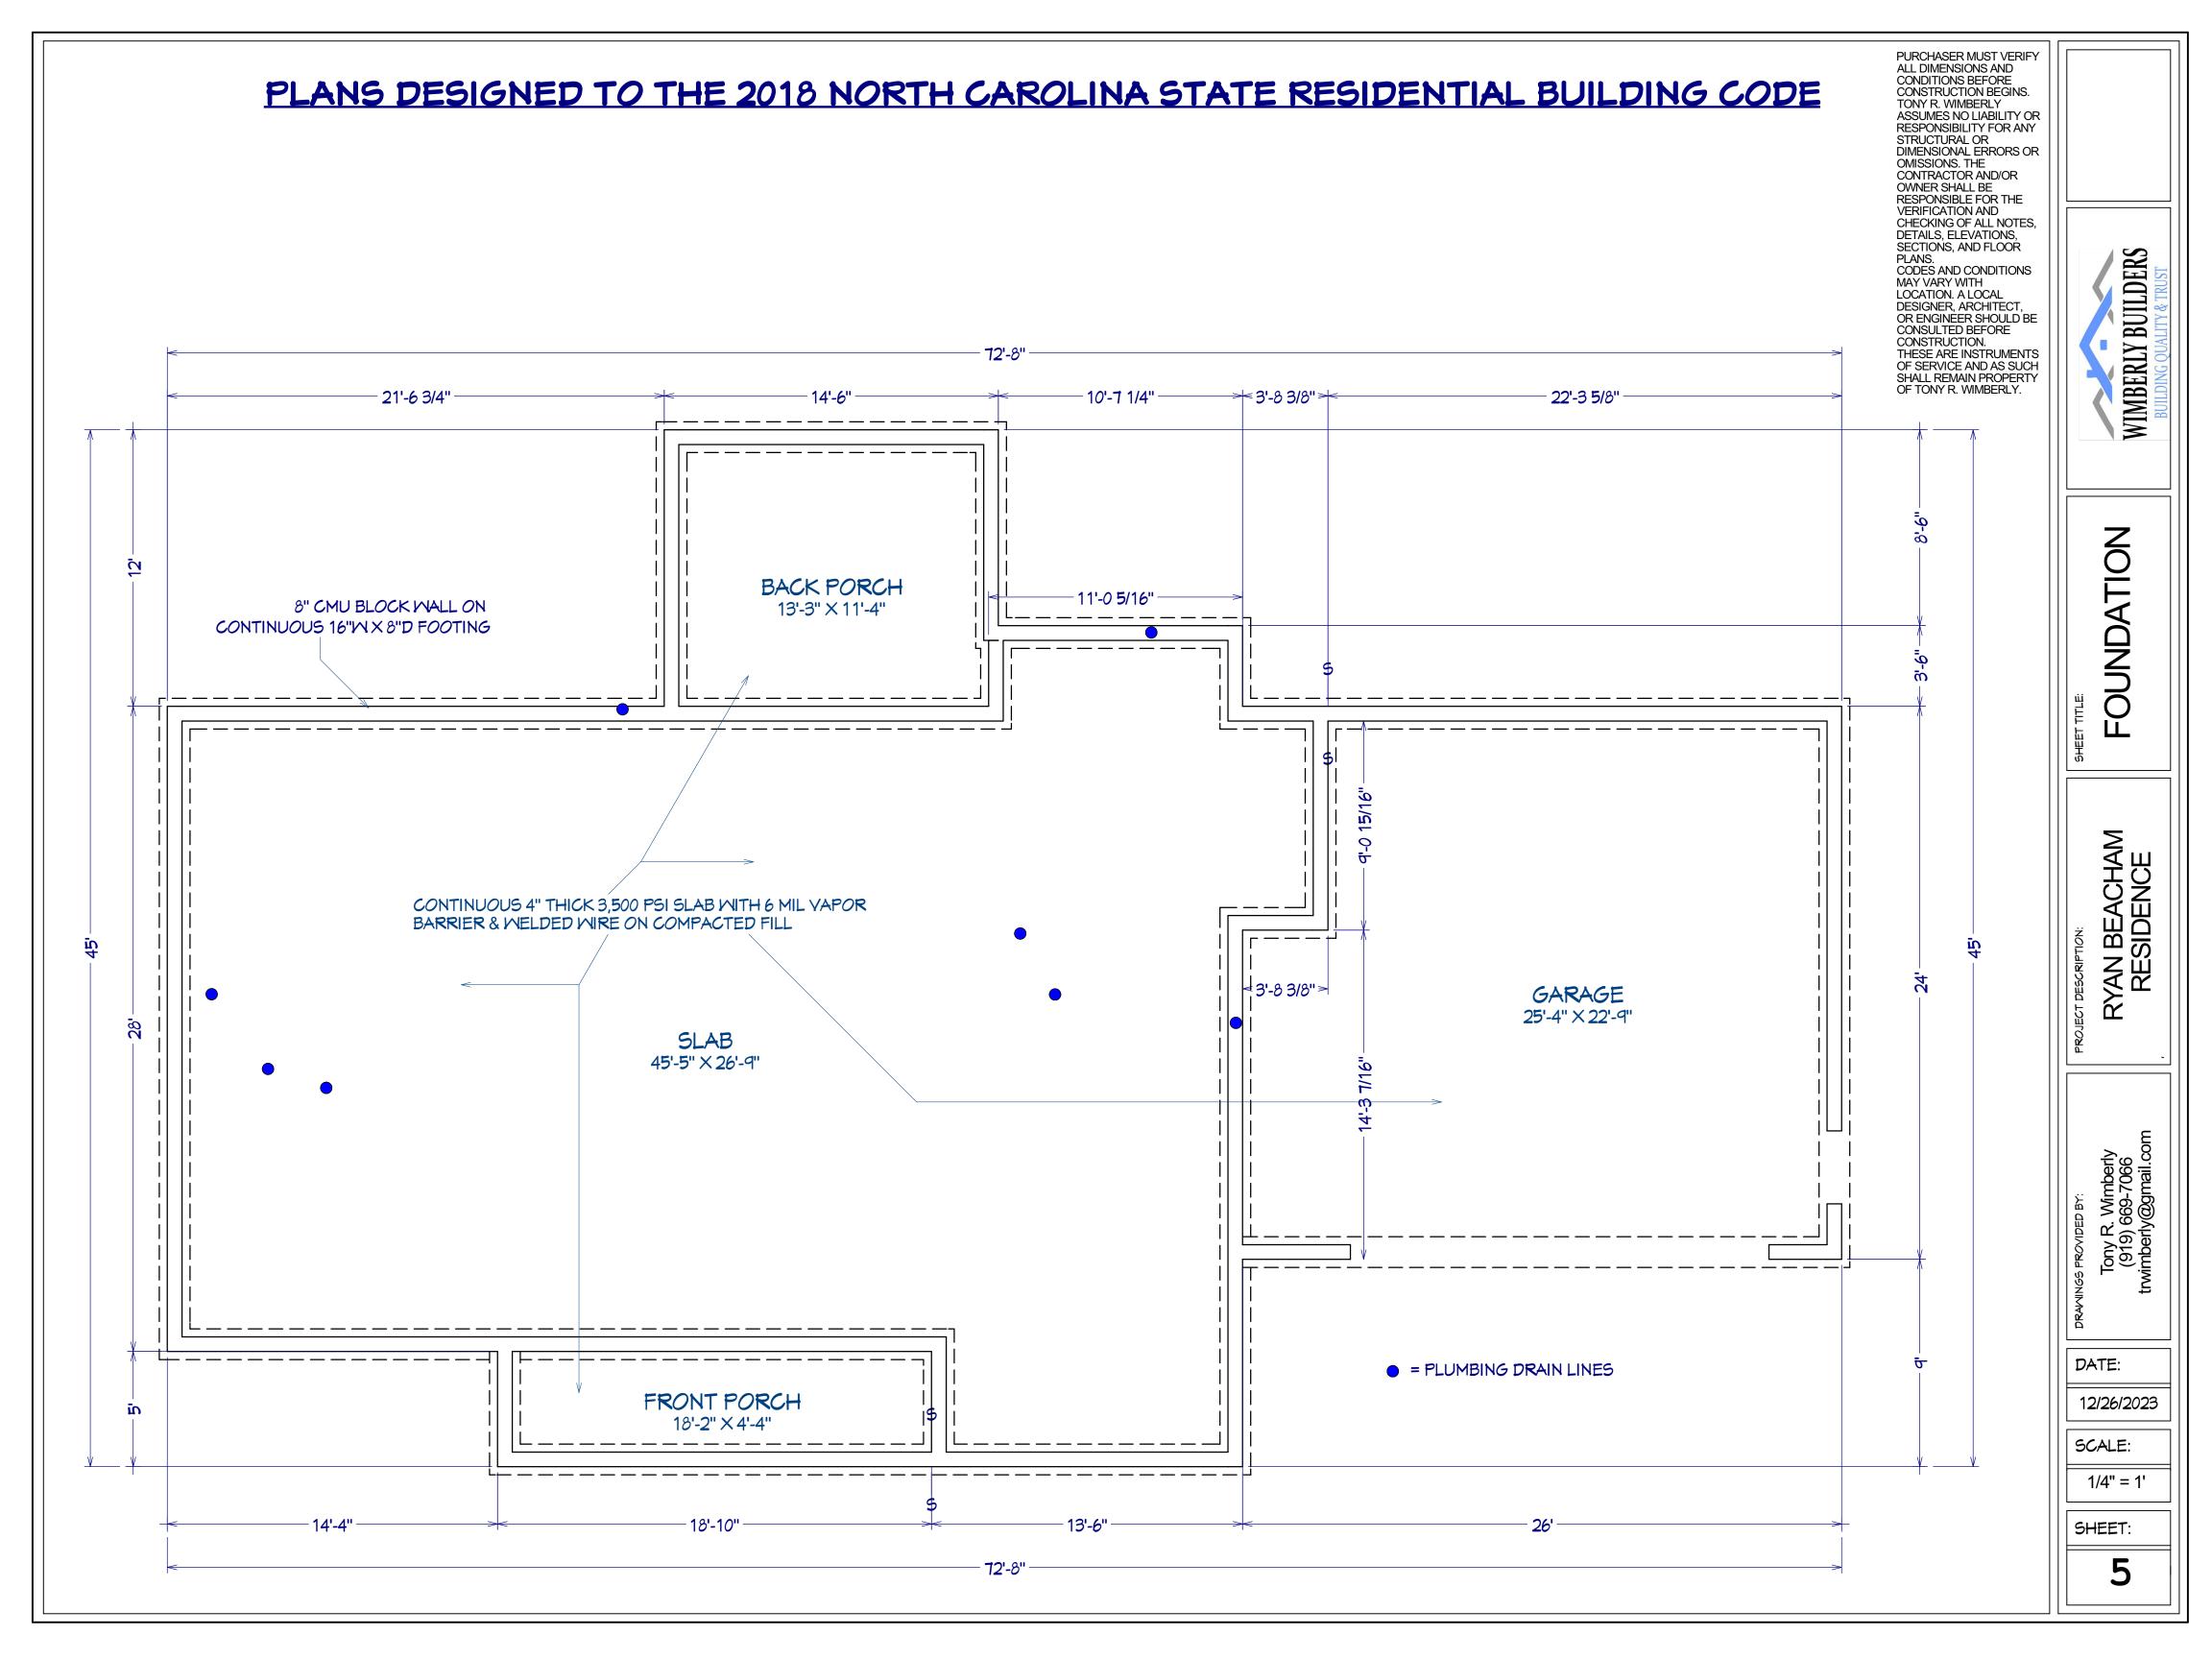

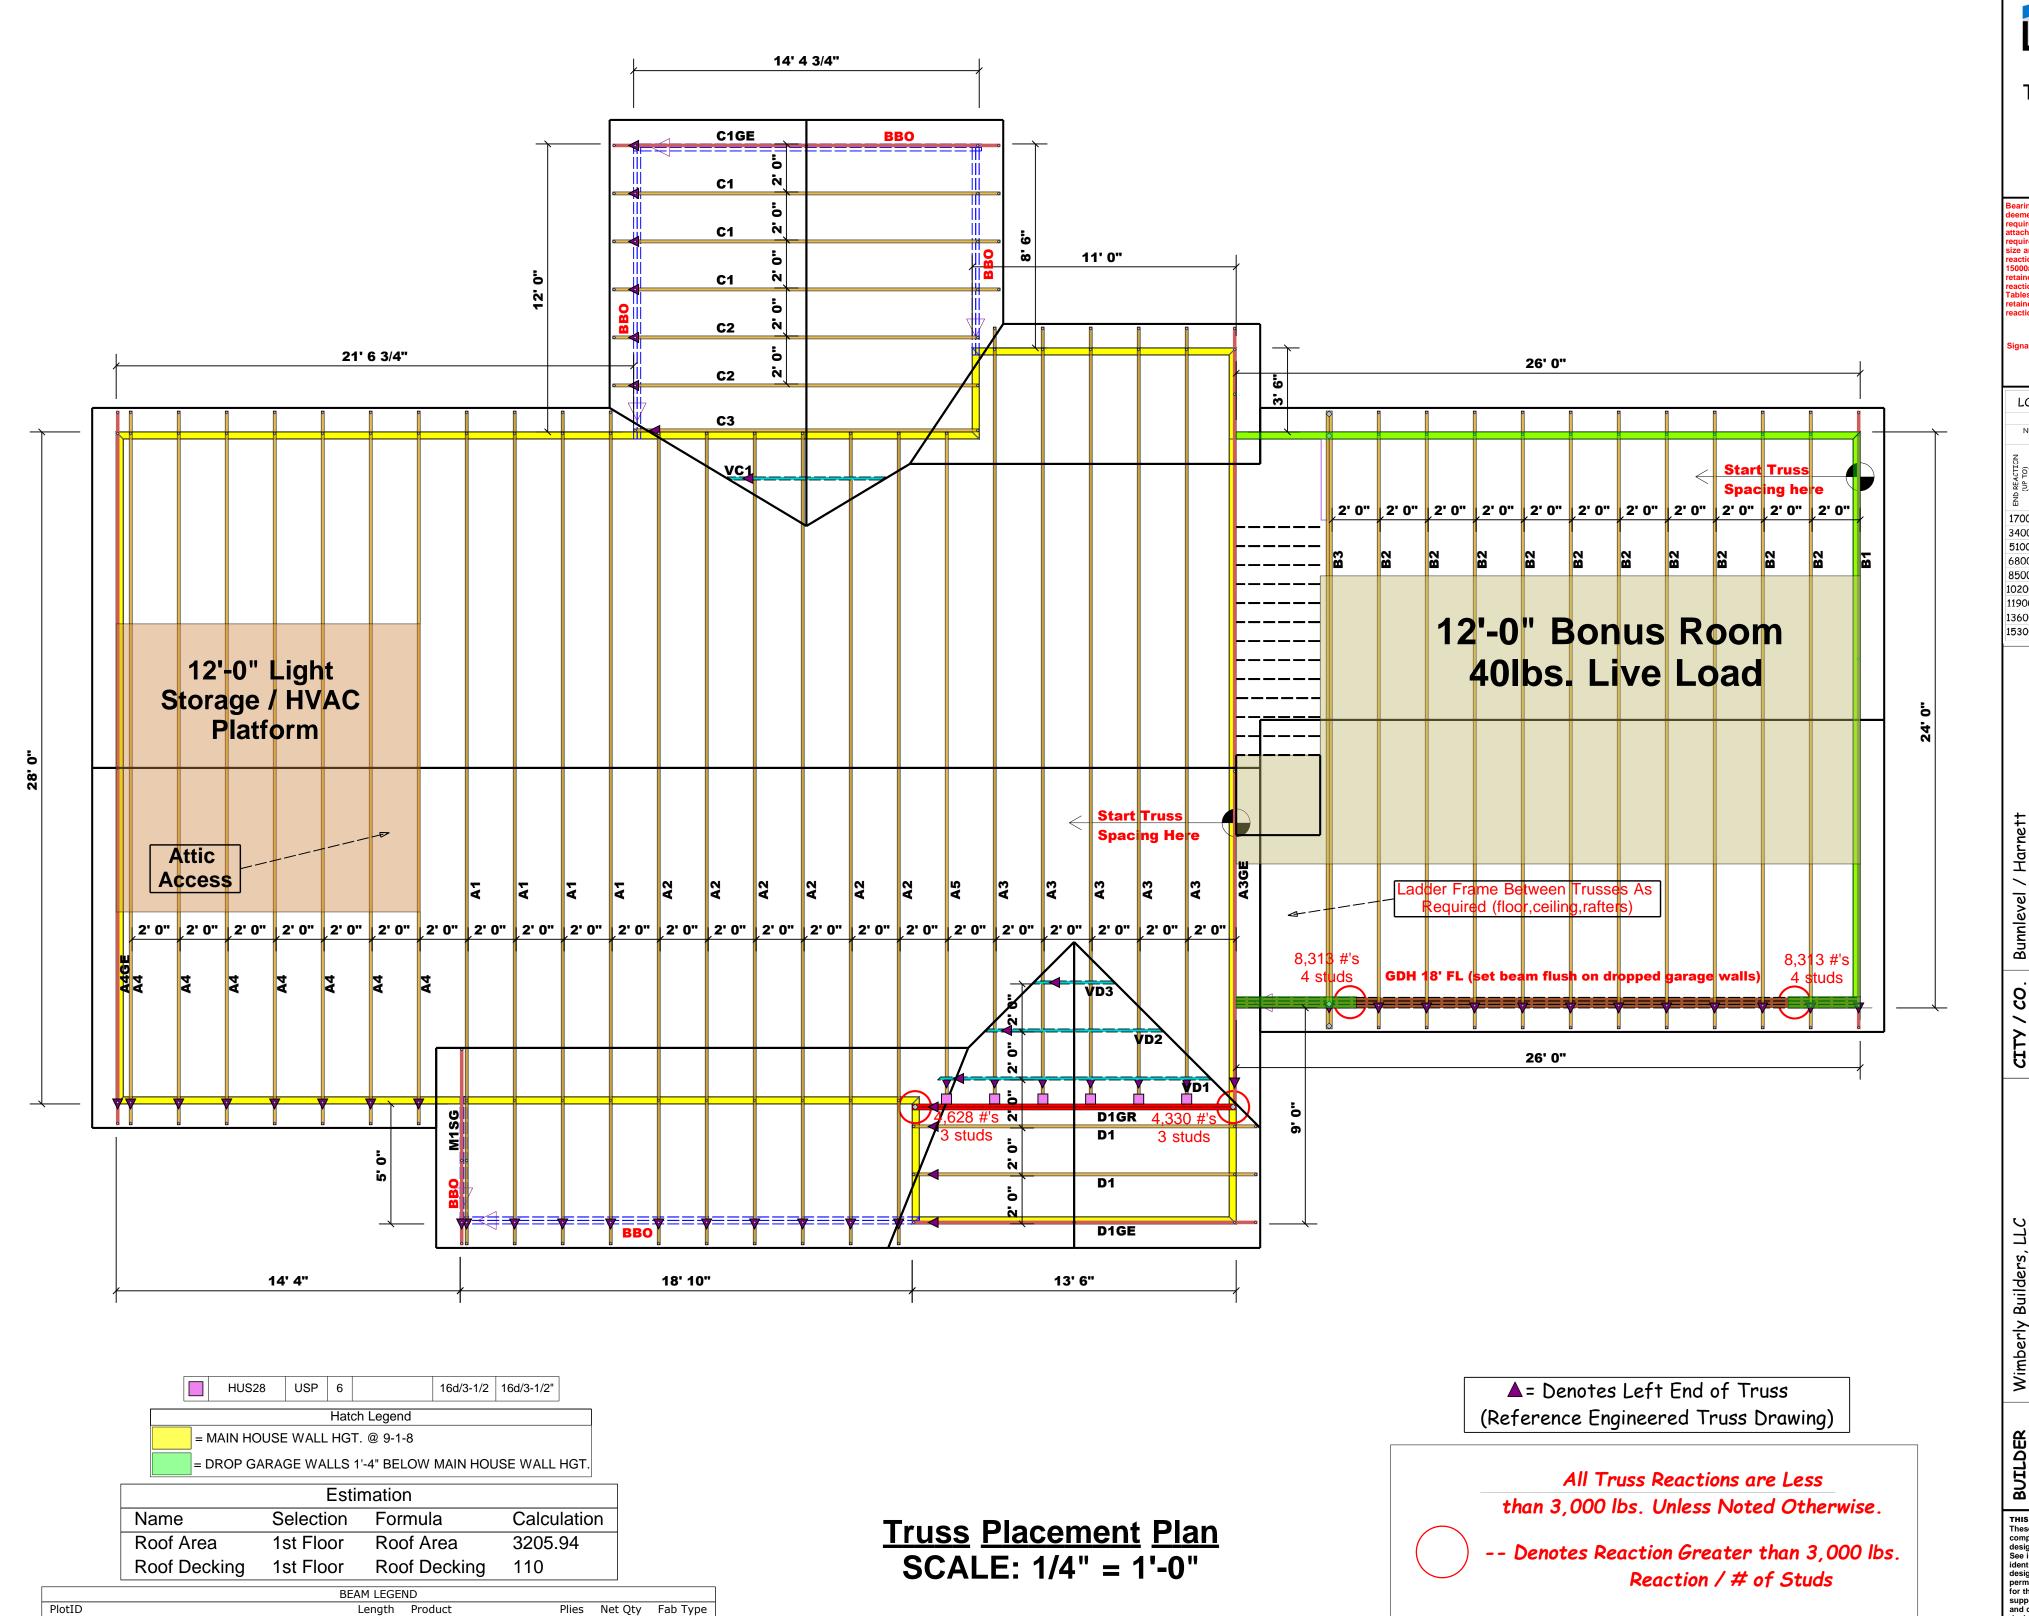

GDH 18' FL (set beam flush on dropped garage walls) 26' 0" 1-3/4"x 18" LVL Kerto-S 3

COMTECH **ROOF & FLOOR**

TRUSSES & BEAMS

Reilly Road Industrial Park Fayetteville, N.C. 28309 Phone: (910) 864-8787 Fax: (910) 864-4444

Lenny Norris

Lenny Norris

LOAD CHART FOR JACK STUDS (BASED ON TABLES R502.5(1) & (b))

Bunnlevel / Harnett Lenny Norris Nut Grass DRAWN BY CITY / CO. Wimberly Builders, LLC

JOB NAME QUOTE SEAL THIS IS A TRUSS PLACEMENT DIAGRAM ONLY. These trusses are designed as individual building components to be incorporated into the building design at the specification of the building design at the specification of the building designer. See individual design sheets for each truss design identified on the placement drawing. The building designer is responsible for temporary and permanent bracing of the roof and floor system and for the overall structure. The design of the truss support structure including headers, beams, walls, and columns is the responsibility of the building designer. For general guidance regarding bracing, consult BCSI-B1 and BCSI-B3 provided with the truss delivery package or online @ sbcindustry.con THIS IS A TRUSS PLACEMENT DIAGRAM ONLY.

DATE

Quote#