ABBREVIATION

ACC. ACCESS
BWL. BRACED WALL LINE
BWP. BRACED WALL PANEL
C.O. CASED OPENING
C.J. CELING JOIST
COLOS. CLOSET
COL. COMP.
COMP. COMPOSITION

CONC. CONCRETE
CONT. CONTINUOUS
C.M.A. CARBON MONOXIDE ALARM
C.M.U. CONCRETE MASONRY UNIT

D.H. DOUBLE HUNG
DIA. DIAMETER
D.J. DOUBLE JOIST
DN. DOWN
EXH. EXHAUST
EXT. EXTERIOR
FL.J. FLOOR JOIST
FTG. FOOTING
G.F.I. GROUND FAULT

G.F.I. GROUND FAULT INTERRUPTER
H.B. HOSE BIB
LVL LAMINATED VENEER LUMBER
M.O. MASONRY OPENING

M.O. MASONRY OPENING
MAS. MASONRY
MAX. MAXIMUM

M.C. MEDICINE CABINET
MTL. METAL
MIN. MINIMUM
O.C. ON CENTER

OSB ORIENTED STRAND BOARD
PERF. PERFORATED

SHWR SHOWER
S.Y.P. SOUTHERN YELLOW PINE

S.P.F. SPRUCE/PINE/FIR SUSP. SUSPENDED 7YP TYPICAL

7YP. TYPICAL U.O.N. UNLESS OTHERWISE NOTED

WASH. WASHER
W.H. WATER HEATER
W.P. WEATHER PROOF
W.W.M. WELDED WIRE MESH
WDW. HT. WINDOW HEIGHT

TAGS

XX DOOR TAG

XX) WINDOW TAG

GENERAL NOTES AND SPECIFICATION

EXCAVATION

EXCAVATE TO UNDISTURBED SOIL BOTTOM OF FOOTING SHALL EXTEND BELOW LOCAL FROST LINE AND TO A MINIMUM DEPTH OF 12" BELOW ADJACENT GRADE, (PRESUMED 2000 PSF SOIL BEARING CAPACITY). ERADE, SOUR SOILS SHALL BE REMOVED TO A DEPTH AND WIDTH SUFFICIENT TO ASSUME A STABLE MOISTURE CONTENT IS ACCH ACTIVE ZONE.

FOUNDATION

PROVIDE 1/2" DIA. STEEL ANCHOR BOLTS 6'-0" O.C., 1'-0" MAX. FROM CORNERS AND 1-0" MAX. FROM ENDS OF EACH PLATE SECTION, WITH 7" MIN. EMBEDMENT. SLOPE GRADE AWAY FROM FOUNDATION WALLS 6" MINIMUM WITHIN THE FIRST 10 FEET. PROVIDE PRESSURE TREATED LUMBER FOR SILLS, PLATES, BANDS AND ANY LUMBER IN CONTACT WITH MASONRY.

CRAWL SPACE

ALL GIRDER JOINTS AND ENDS OF GIRDERS SHALL REST ON SOLID BEARINGS, FILL CORES OF HOLLOW MASONRY TO FOOTING WITH CONCRETE, FILL TOP COURSE CORES OF EXTERIOR FOUNDATION WALL WITH CONCRETE, FOOTINGS SHALL EXTEND 6" AND SHALL BE 12" THICK UNDER GIRDER PIERS.

FRAMING

ALL FLOOR JOISTS, CEILING JOISTS, RAFTERS, GIRDERS, HEADERS, SILLS AND BEAMS SHALL BE NO. 2 SPRUCE/PINE/FIR (S.P.F.)

UNLESS OTHERWISE INDICATED

ALL LOAD BEARING WALLS SHALL BE STUD GRADE SPRUCE/PINE/FIR (S.P.F.) UNLESS OTHERWISE INDICATED.

GITEET EIGT	
Sheet Number	Sheet Name
A100	COVER SHEET
A101	LEVEL 1 FLOOR PLAN
A103	ROOF PLAN
A200	FOUNDATION PLAN

A103 ROOF PLAN
A200 FOUNDATION PLAN
A203 ROOF FRAMING PLAN
A401 FRONT ELEVATION
A402 REAR ELEVATION
A403 RIGHT ELEVATION
A404 LEFT ELEVATION


SHEETLIST

HEATE	D/UNHEATE	SQFT		
Name Area Comments				
LEVEL 1	2014 SF	HEATED		

HEATED/UNHEATED SQFT				
Name Area Comments				
BACK PORCH 360 SF UNHEATED				
FRONT PORCH 271 SF UNHEATED				

DOOR SCHEDULE			
DOOR TAG	DOOR SIZE	QUANTITY	
10	2880	2	
22	2468	6	
23	2668	5	
24	2-1668	1	
26	2868	1	
35	3080	3	
36	POCKET DOOR 2468	3	
37	2868	3	
38	4080	2	
81	2-2068	2	


WINDOW SCHEDULE			
WINDOW TAG	WINDOW SIZE	QUANTITY	
25	1040	2	
28	2462	4	
29	2446	5	
30	30310	3	
31	2462 TWIN	4	

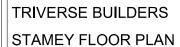

No.	Description	Date

COVER SHEET			
Project number	001		
Date	Issue Date	A100	
Drawn by	DF	71100	
Checked by	BS	Scale	




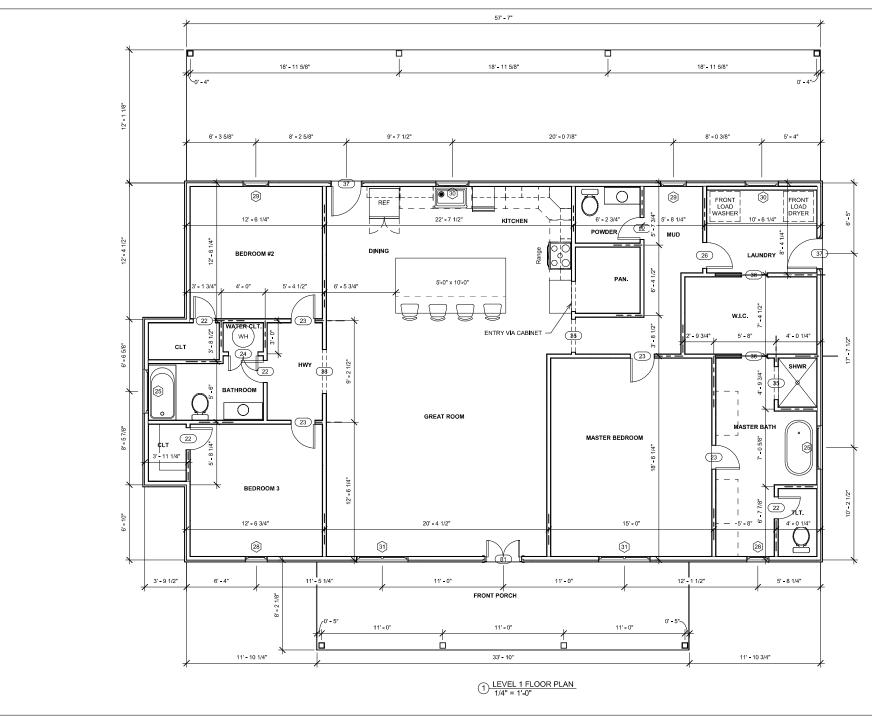

Triverse
Builders
Fuquay-Varina, NC

No.	Description	Date

LEVEL 1 FLOOR PLAN				
Project number	001			
Date	Issue Date	A101		
Drawn by	DF	, , , , ,		
Checked by	BS	Scale 1/4" = 1'-0"		

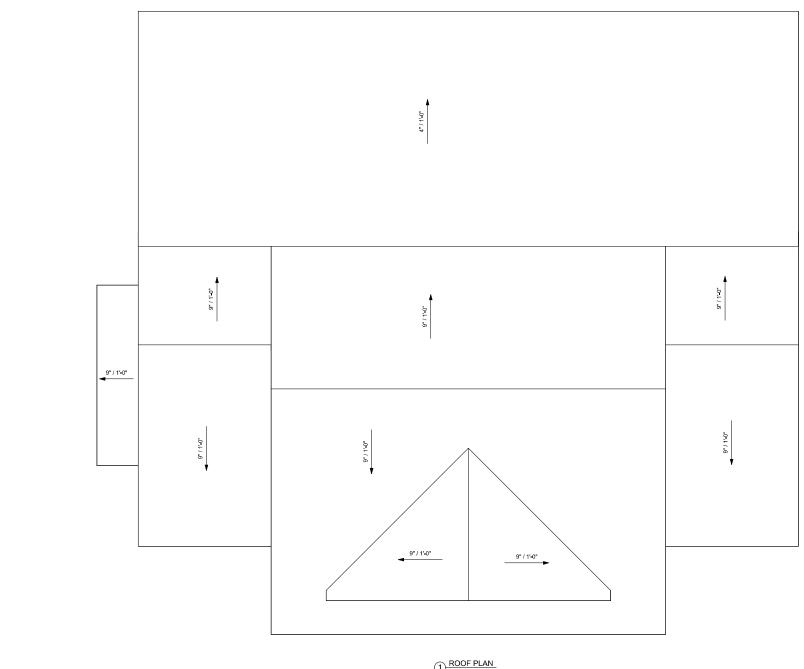

1) ROOF PLAN 1/4" = 1'-0"



7	No.	Description	Date	ΙГ
				╽┝
				H
				ا ا
				H
┛				

ROOF PLAN			
oject number	001		
ate	Issue Date	A103	
rawn by	DF	, (100	
necked by	BS	Scale 1/4" = 1'-0"	

STRUCTURAL EVALUATION BY: HOWERTON SERVICES, PLLC 3513 CATHEDRAL BELL ROAD RALEIGH, NC 27614 LICENSE P-1716


- * EMENIERS SEAL APPLIES ONLY TO STRUCTURAL COMPONENTS ON THIS DOCUMENT. SEAL DISE NOT INCLUDE CONSTRUCTIONS REPERBY.
 MARKA METHOR, THEORIGES, SYLENDER, PROCEDURS OR SAFETY PRESCULTIONS.
 *ANY TREVATIONS OR DECERNACES OF PLANS ARE TO BE BROGGET ID DIAMONIANT STRUCTION OF THE BROANER FAILURE TO DO SO WILL VOID ENGINEERS LABRILITY.



Triverse Builders Fuquay-Varina, NC

No.	Description	Date

FOUNDATION PLAN			
Project number	001		
Date	Issue Date	A200	
Drawn by	Author	,	
Checked by	Checker	Scale 1/4" = 1'-0"	

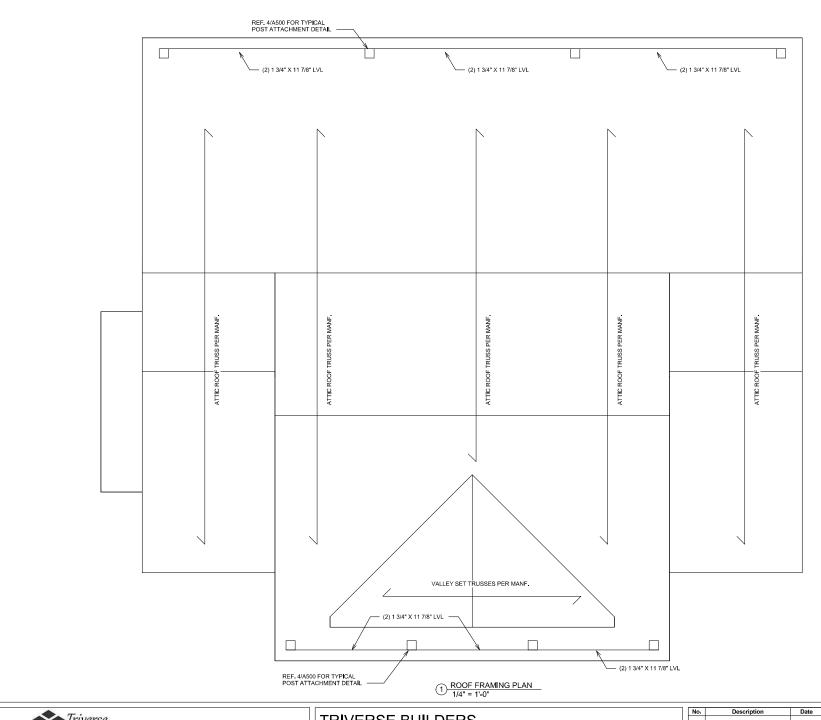




01 12 2024 ES

Triverse
Builders
Fuguay-Varina, NC

No.	Description	Date	
			П
			H
			H
			H
			H
			ΙL

ROOF FRAMING PLAN			
Project number	001		
Date	Issue Date	A203	
Drawn by	DF	,	
hacked by	BS	Scale 1//" = 1'-0"	

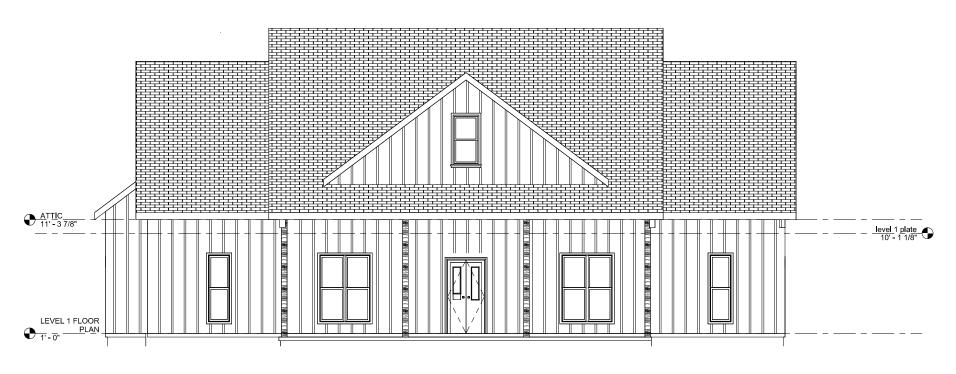


1 South 1/4" = 1'-0"



	No.	Description	Date	
				ı
				l
_	_			1


FRONT ELEVATION			
Project number	001		
Date	Issue Date	A401	
Drawn by	DF	,	
Checked by	BS	Scale 1/4" = 1'-0"	

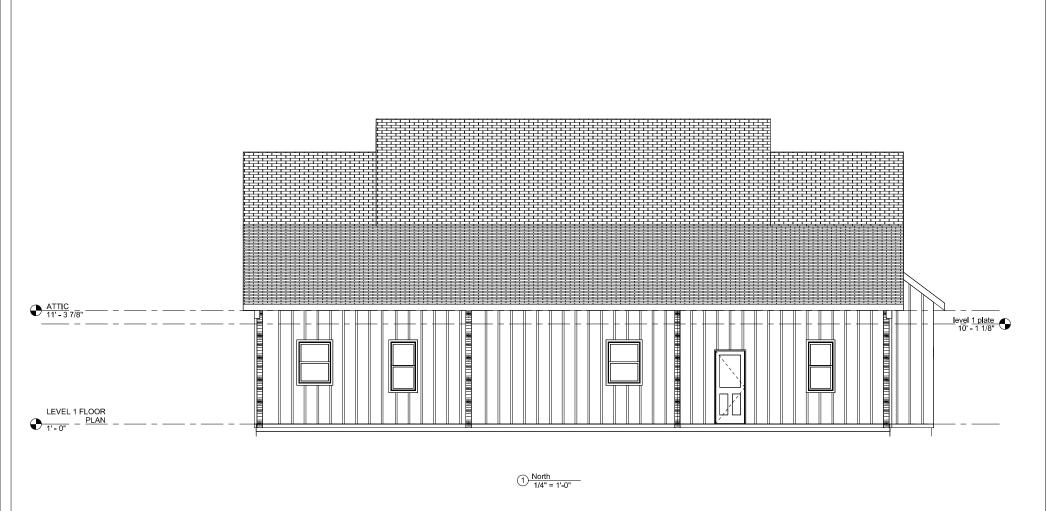

Triverse
Builders
Fuquay-Varina, NC

No.	Description	Date

REAR ELEVATION			
Project number	001		
Date	Issue Date	A402	
Drawn by	DF	,	
Checked by	BS	Scale 1/4" = 1'-0"	

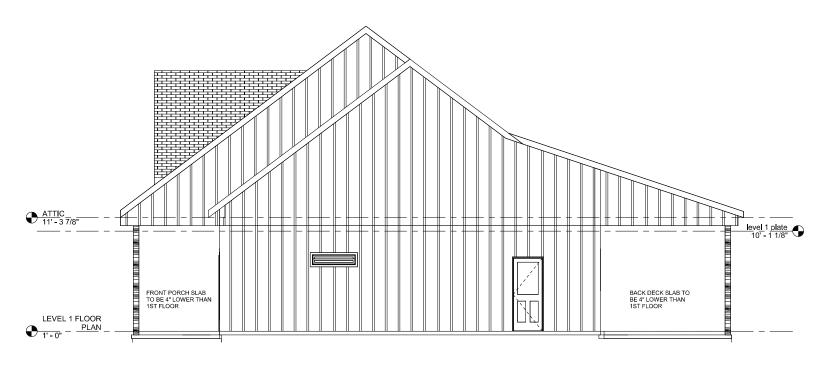


1) East 1/4" = 1'-0"



	No.	Description	Date
_	-		


RIGHT ELEVATION				
Project number	001			
Date	Issue Date	A403		
Drawn by	DF	,		
Checked by	BS	Scale 1/4" = 1'-0"		

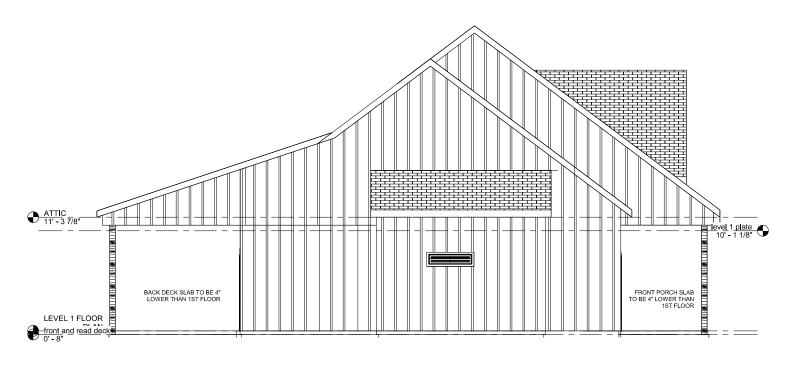


1/4" = 1'-0"




LEFT ELEVATION			
Project number	001		
Date	Issue Date	A404	
Drawn by	DF	, , , , ,	
Checked by	BS	Scale 1/4" = 1'-0"	

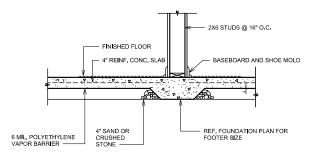


1) TYPICAL LOAD BEARING WALL DETAIL NTS

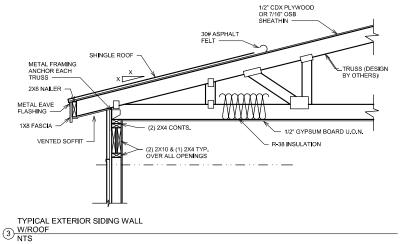

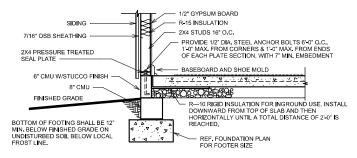

2 TYPICAL EXTERIOR SIDING WALL

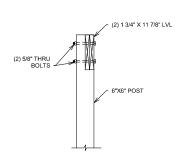

4 TYPICAL POST ATTACHMENT DETAIL NTS



01 12 2024 EST

- 1. BRACED WAILS ARE REQUIRED PER SECTION R602.10.1 2018 NCBC RESIDENTIAL CODE
- 2. THE EXTERIOR WALL STRUCTURE SHALL BE CONTINUOUSLY SHEATHED, FULL HEIGHT WITH MIN. THICKNESS 7/16" OSB. THESE WALLS SHALL BE CONSTRUCTED IN CONFORMANCE TO TYPE CS-WSP DETAILS. REFER TO PLAN FOR LOCATION OF REQUIRED BRACING LABLED "CS BRACING" AND LENGTH OF WALL BRACING LABELED IN LINEAR FEET.
- INTERIOR VALLS WHERE NOTED SHALL BE BRACED PER INDICATED METHOD IN REFERENCE TO NOBC-RESIDENTIAL CODE, TABLE R602.10.2.

LIB METHOD:
INSTALL 134 WOOD OR CONTINUOUS METAL STRAPPING AT 45 DEGREES TO 60
DEGREES FROM TOP PLATE TO BOTTOM PLATE ACROSS STUDS WITH MAXMUM STUD SPACING OF 16" ON CENTER. CONNECT AS INDICATED IN CODE SECTION.

MININUM & GYPSUM BOARD TURNED VERTICALLY AND CONTINUOU FROM TOP PLATE TO BOTTOM PLATE, SCREW CONNECTION TO FRAMING USING SPACING CRITERIA AS INDICATED IN CODE TABLES

- SPECIAL BRACING DETAILS ARE ILLUSTRATED IN THE CODE AND ALLOWED WHERE VALLS DO NOT MEET THE MINIMUM REQUIREMENTS FOR SUPPORT.
- SEE TABLE R602.7.5 FOR CORRECT NUMBER OF KING STUDS PER HEADER.

GENERAL FRAMING NOTES:

- 1. THIS PLAN DESIGNED IN ACCORDANCE WITH NC RESIDENTIAL CODE. 2018
- GLAZING AREAS SHOWN ON THESE DESIGN DRAWINGS DO NOT EXCEED 15%
 OF THE GROSS AREA OF THE EXTERIOR WALLS. THIS STRUCTURE MEETS THE REQUIREMENTS OF NI101.2.1, RESIDENTIAL BUILDING, TYPE A-1.
- WALL CLADDING IS DESIGNED FOR A 24.1 #SF OR GREATER POSITIVE/NEGATIVE PRESSURE.
- 4. ALL WALLS, FLOORS AND CEILINGS SHALL BE INSUIATED IN ACCORDANCE WITH

ESIGN CRITERIA:	DEAD	LIVE
PRIMARY FLOOR	10 PSF	40 PSF
SECONDARY FLOOR	10 PSF	40 PSF
SLEEPING AREAS	10 PSF	30 PSF
ATTIC	10 PSF	20 PSF
ROOF	10 PSF	20 PSF
DEEL COTION LINETO		

L/360(LIVE LOAD ONLY) FLOOR

ROOF

- ALL HEADERS IN LOAD BEARING WALLS SHALL BE DOUBLE 2X10 U.O.N.
- ALL WALLS ARE 2X4 @ 16" O.C. U.O.N.
- PROVIDE DOUBLE FLOOR JOISTS UNDER WALLS ABOVE.
- PROVIDE FOUNDATION VENT WITHIN 36" OF EACH CORNER.
- 10. ALL JOISTS TO BE SPF.



No.	Description	Date

DETAILS			
Project number	001		
Date	Issue Date	□ A500	
Drawn by	DF	7 , 1000	
Checked by	BS	Scale As indicated	