REVISION LOG

REVISION:001

DATE: 07/22/2022

ADD STEM WALL SLAB FOUNDATION SHEETS
ADD "STEM WALL" TO CRAWL ELEVATION TITLES AND NOTE "SEE FOUNDATION PAGES FOR FOUNDATION TYPE". UPDATE SHEET TITLES.

REVISION:002 DATE: 10/20/2023

STANDARD SHOWER REVISED TO BE 60X36.

- STANDARD SHOWER REVISED TO BE 60X36.
 CHANGED SHOWER SIZE FOR THE OWNER'S SHOWER/TUB OPTION TO 42"X42" AND
 MADE THE TUB DECK LARGER, CHANGED WINDOW OVER TUB TO 4/0X1/0
 RELABELED FIREPLACES AS OPT. DENOTED FIREPLACE. IN THE FAMILY ROOM AS AN
 INTERIOR FIREPLACE. NOTED THE WINDOWS FOR THIS OPTION TO BE 2/8X5/0.
 CHANGE FRONT DOOR FOR THE SMART DOOR DELIVERY OPTION TO AN INSWING DOOR.
 MODIFIED HALF WALL AT THE STAIRS TO BE A FULL WALL FOR THE DOUBLE POCKET
 OFFICE OPTION. THIS IS TO CARRY THE BEAM OVER THE STAIRS.
 SMART DOOR DELIVERY EXTENDED 2"—0" TOWARD THE FRONT IN THE POCKET OFFICE
 OPTIONS FOILDMATIONS WERE CHANGED TO MATCH.

OPTIONS. FOUNDATIONS WERE CHANGED TO MATCH.

REVISION:003 DATE: 01/21/2024

 CLARIFY NOTES TO INDICATE THAT THE OWNER'S BEDROOM 3/0X5/0 SIDE WINDOWS
ARE OPTIONAL TO PURCHASE BUT ALSO STANDARD IF THE COVERED PORCH OPTION IS
SELECTED ON THE REAR OF THE HOUSE. THE 2/0X2/0 SIDE WINDOWS ARE OPTIONAL
TO PURCHASE. THE REAR 3/0X5/0 WINDOW NEAR THE THE CORNER BECOMES AN OPTIONAL PURCHASE WHEN COVERED PORCH IS SELECTED.

Redlines Complete - 3 March- 24- DP

First Floor Options:

- 1. Oak treads
- 2. 3 Car Garage
- 3. Dbl Pocket office
- 4. Side Fireplace
- 5. Cafe Windows (3) 2'x2' Fixed
- 6.Cafe Vaulted Ceiling
- 7.Gourmet Kitchen
- 8. Pocket Door at Messy Kitchen
- 9. Sink at Messy Kitchen
- 10. Window at Messy Kitchen
- 11.Extended Covered Deck
- 12. Shower at First Floor Bath

Second Floor Options:

- 1.Extended Game room
- 2. Window at Owner's Bth
- 3. Laundry Sink

SQUARE	F	00	T	۹(ЭE	
	<u>'</u> (GEORG	ΑN	' ELE	VATIC	N
	T	JNHEATED			HEATE)
FIRST FLOOR		0			1342	
SECOND FLOOR		0			1508	
FRONT PORCH		144			0	
BALCONY		117			0	
REAR PATIO/DECK	\vdash	100			Û	
2 CAR GARAGE		469			0	
				_		_
SUBTOTALS		710			2850	
TOTAL UNDER ROOF			-37	60		
0	PTIC	SNC				
	UNH	HEATED	S.F.	HE	ATED	S.F.
POCKET OFFICE		0			+51	
EXTENDED FRONT PORCH W/ POCKET OFFICE		+27			0	
EXTENDED GAME ROOM W/ FF POCKET OFFICE		0			+74	
		- 12			140	
SMART DOOR	-		$\overline{}$	_		
SITTING ROOM		0			+152	
SITTING ROOM OPT. 3RD CAR GARAGE	_	+260			1152	•
SITTING ROOM	_				1152 0 0	•

Lot 18 WS - 23 Avents Creek Way, Fuquay- Varina, NC 27526

NC.



THE APEX - LH 'GEORGIAN'

neet No.	Sheet Description
0.0	Cover Sheet
1.1.1	Foundation (Slab) Foundation Options (Slab)
1.1.2	Foundation Options (Slab)
1.1.2	Foundation (Crawl)
1.2.1	Foundation Options (Crawl)
1.2.2	Foundation Options (Crawl)
1.3	Foundation (Stem Wall Slab)
1.3.1	Foundation Options (Stem Wall Slab)
1.3.2	Foundation Options (Stem Wall Slab)
2.1	First Floor Plan
2.1.1	First Floor Plan Options
2.2	Second Floor Plan
2.2.1	Second Floor Plan Options
2.4	Covered Porch Plans & Elevations (Slab)
2.4.1	Covered Porch Plans & Elevations (Crawl/Stem Wall)
2.5	Extended Cafe Elevations & Roof Plan (Slab)
2.5.1	Extended Cafe Elevations & Roof Plan (Crawl)
2.6	2-Car Sideload Garage Plans
2.6.1	2-Car Sideload Garage Elevations
2.7	3-Car Garage Plans
2.7.1	3-Car Garage Elevations
3.1	Front & Rear Elevations (Slab)
3.1.1	Front & Rear Elevations (Crawl/Stem Wall)
3.2	Side Elevations (Slab)
3.2.1	Side Elevations (Crawl/Stem Wall)
3.3	Roof Plan
5.1	First Floor Electrical
5.1.1	First Floor Options Electrical
5.2	Second Floor Electrical
5.2.1	Second Floor Options Electrical

DESIGN CRITERIA:

THIS PLAN IS TO BE BUILT IN CONFORMANCE WITH THE 2018 NORTH CAROLINA STATE BUILDING CODE: RESIDENTIAL CODE

DIMENSIONS SHALL GOVERN OVER SCALE, AND CODE SHALL GOVERN OVER DIMENSIONS




									ı
DATE			-						
DESCRIPTION	:		1	1	1	1	1		
REV.#	1	2	က	4	2	9	7	8	

Cover Sheet 'Georgian' APEX THE,


DRAWN BY: South Designs ISSUE DATE: CURRENT REVISION DATE


1/8" = 1'-0"

0.0b

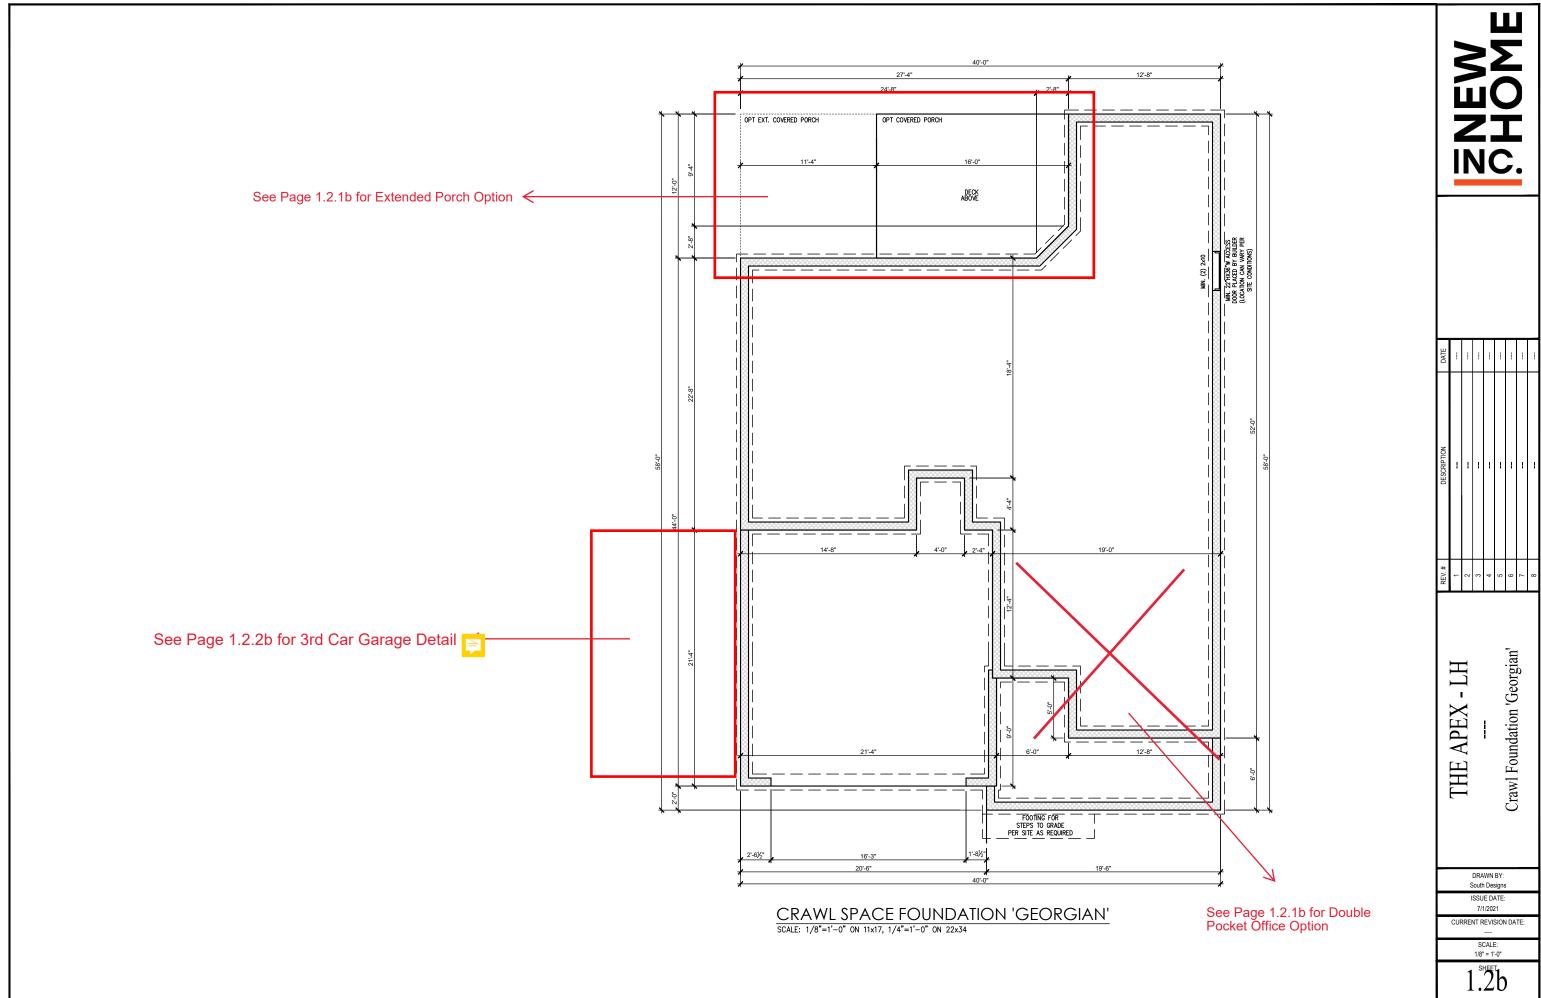

REV.#	DESCRIPTION	DATE
1		-
2		
3		1
4		-
2		-
9		
7		
8		-
	2 3 3 7 7 7 8 8	

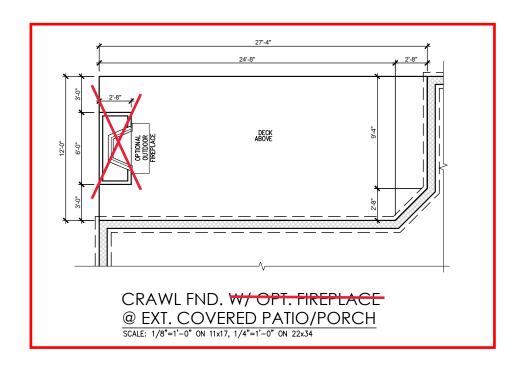

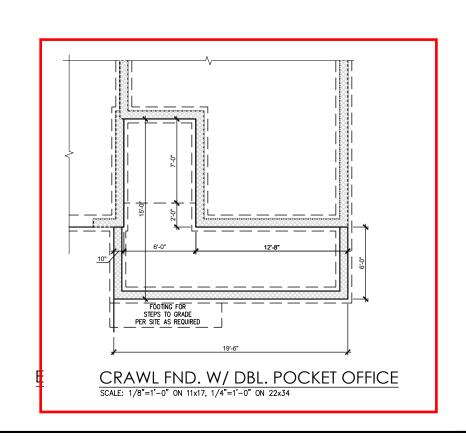



DATE								
DESCRIPTION			-	-	-	-	-	
REV. #	1	2	3	4	2	9	7	8


THE APEX - LH
--Crawl Foundation Options 'Georgian'

DRAWN BY: South Designs ISSUE DATE:

ISSUE DATE:
7/1/2021

CURRENT REVISION DATE:

SCALE: 1/8" = 1'-0"

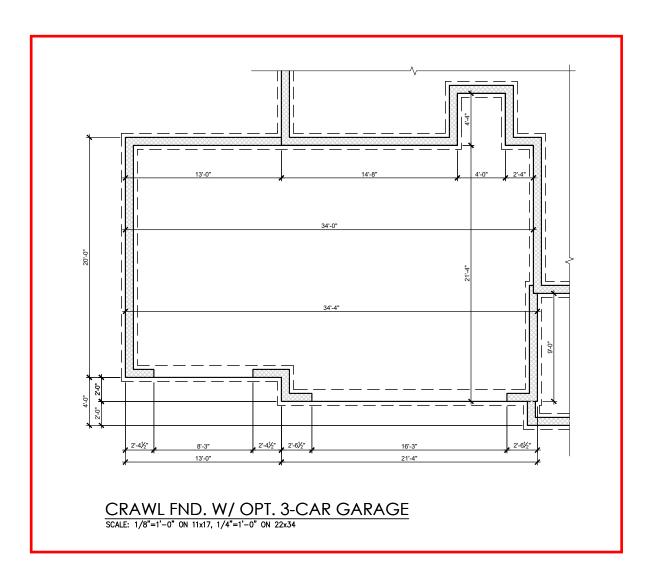


DATE			-			-			
DESCRIPTION		-	ł	1	1	1	-		
REV. #	1	2	3	4	2	9	7	8	

Crawl Foundation Options 'Georgian' THE APEX - LH

DRAWN BY: South Designs


ISSUE DATE: 7/1/2021

General Floor Plan Notes shall apply

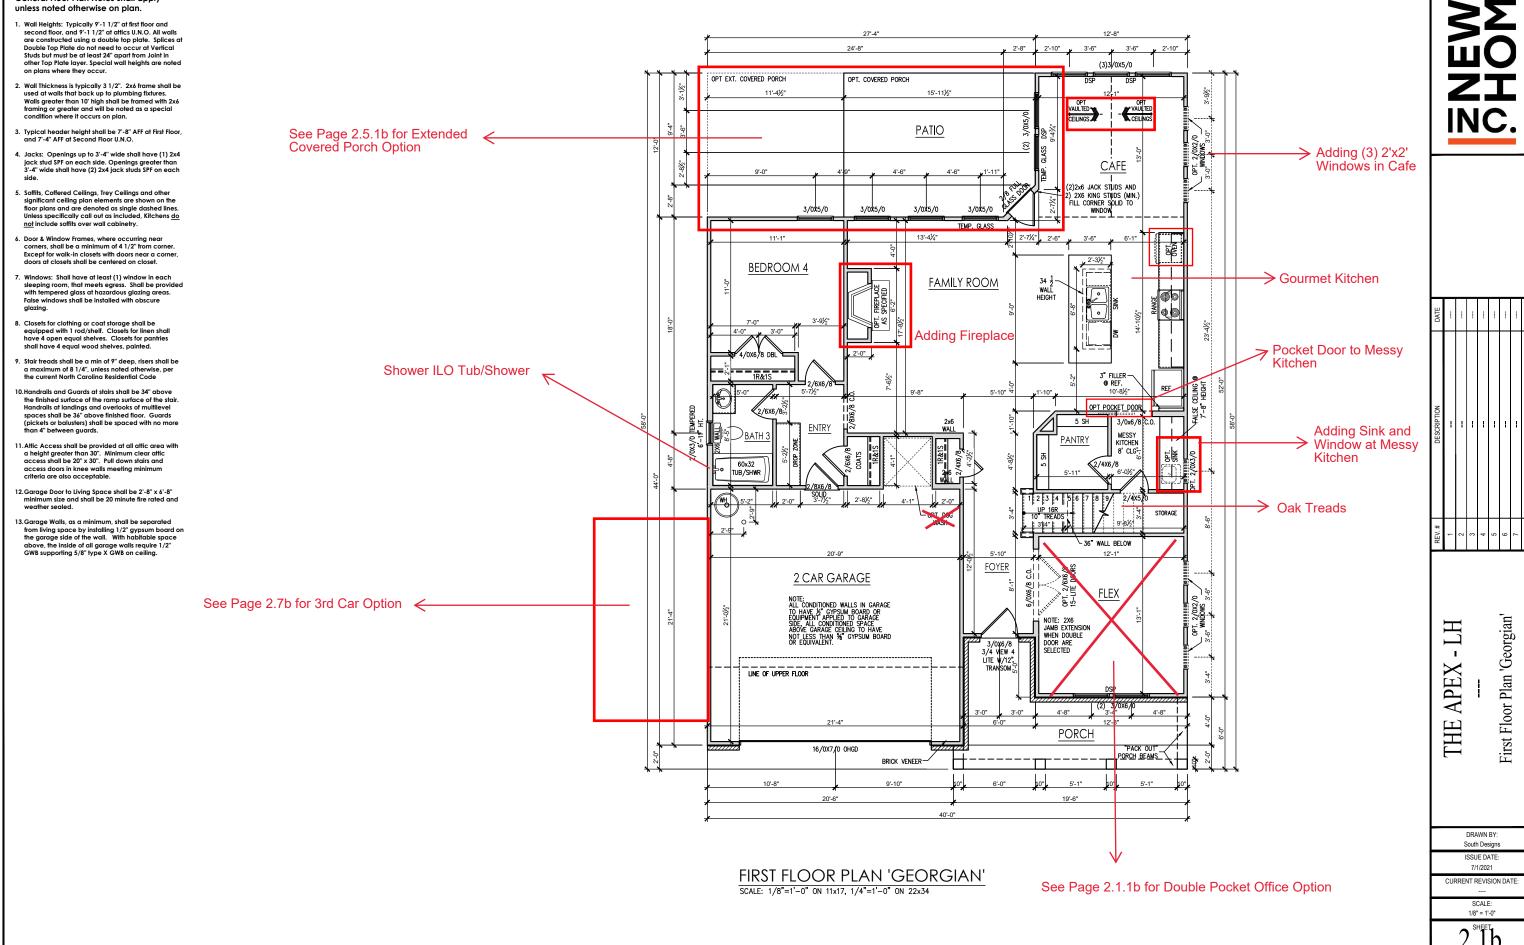

General Floor Plan Notes shall apply unless noted otherwise on plan.

- Wall Heights: Typically 9"-1 1/2" at first floor and second floor, and 9"-1 1/2" at affics U.N.O. All walls are constructed using a double fop plate. Splices at Double Top Plate do not need to occur at Vertical Studs but must be at least 24" apart from Joint in other Top Plate layer. Special wall heights are noted on plans where they occur.
- Wall Thickness is typically 3 1/2". 2x6 frame shall be used at walls that back up to plumbing fixtures. Walls greater than 10' high shall be framed with 2x6 framing or greater and will be noted as a special condition where it occurs on plan.
- Typical header height shall be 7'-8" AFF at First Floor, and 7'-4" AFF at Second Floor U.N.O.
- Jacks: Openings up to 3'-4" wide shall have (1) 2x4 jack stud SPF on each side. Openings greater than 3'-4" wide shall have (2) 2x4 jack studs SPF on each
- Soffits, Coffered Ceilings, Trey Ceilings and other significant ceiling plan elements are shown on the floor plans and are denoted as single dashed lines. Unless specifically call out as included, Kitchens do not include soffits over wall cabinetry.
- Door & Window Frames, where occurring near corners, shall be a minimum of 4 1/2" from corner. Except for walk-in closets with doors near a corner, doors at closets shall be centered on closet.
- 7. Windows: Shall have at least (1) window in each sleeping room, that meets egress. Shall be provided with tempered glass at hazardous glazing areas. False windows shall be installed with obscure glazing.
- Closets for clothing or coat storage shall be equipped with 1 rod/shelf. Closets for linen shall have 4 open equal shelves. Closets for pantries shall have 4 equal wood shelves. painted.
- Stair treads shall be a min of 9" deep, risers shall be a maximum of 8 1/4", unless noted otherwise, per the current North Carolina Residential Code
- 10. Handrails and Guards at stairs shall be 34" above the finished surface of the ramp surface of the stair. Handrails at landings and overlooks of multilevel spaces shall be 36" above finished floor. Guards (pickets or balusters) shall be spaced with no more than 4" between quards.
- 11. Attic Access shall be provided at all attic area with a height greater than 30". Minimum clear attic access shall be 20" x 30". Pull down stairs and access doors in knee walls meeting minimum criteria are also acceptable.
- 12. Garage Door to Living Space shall be 2'-8" x 6'-8" minimum size and shall be 20 minute fire rated and weather sealed.
- 13. Garage Walls, as a minimum, shall be separated from living space by installing 1/2" gypsum board on the garage side of the wall. With habitable space above, the inside of all garage walls require 1/2" GWB supporting 5/8" type X GWB on ceiling.

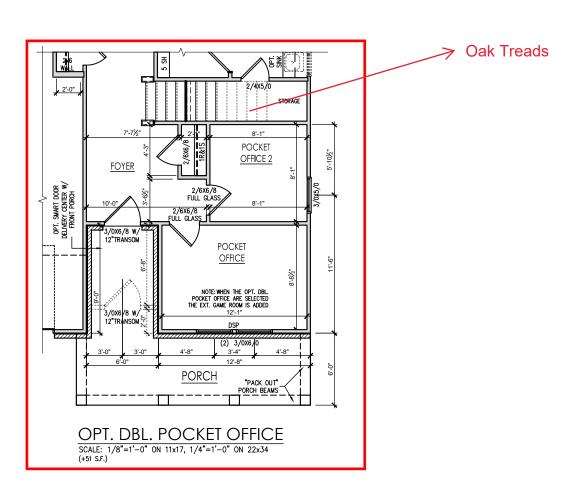

BWEW CHOME

DATE									
DESCRIPTION		-	ł	1	1	1	-		
REV. #	1	2	3	4	2	9	7	8	

THE APEX - LH
--First Floor Plan Options

DRAWN BY: South Designs

ISSUE DATE: 7/1/2021 CURRENT REVISION DATE:

SCALE: 1/8" = 1'-0"


2 1 1 1 h

General Floor Plan Notes shall apply unless noted otherwise on plan.

- Wall Heights: Typically 9"-1 1/2" at first floor and second floor, and 9"-1 1/2" at attics U.N.O. All walls are constructed using a double top plate. Splices at Double Top Plate do not need to occur at Vertical Studs but must be at least 24" apart from Joint in other Top Plate layer. Special wall heights are noted on plans where they occur.
- Wall Thickness is typically 3 1/2". 2x6 frame shall be used at walls that back up to plumbing fixtures.
 Walls greater than 10' high shall be framed with 2x6 framing or greater and will be noted as a special condition where it occurs on plan.
- Typical header height shall be 7'-8" AFF at First Floor, and 7'-4" AFF at Second Floor U.N.O.
- 4. Jacks: Openings up to 3'-4" wide shall have (1) 2x4 jack stud SPF on each side. Openings greater than 3'-4" wide shall have (2) 2x4 jack studs SPF on each
- Soffits, Coffered Cellings, Trey Ceilings and other significant ceiling plan elements are shown on the floor plans and are denoted as single dashed lines. Unless specifically call out as included, Kitchens do not include soffits over wall cabinetry.
- Door & Window Frames, where occurring near corners, shall be a minimum of 4 1/2" from corner. Except for walk-in closets with doors near a corner, doors at closets shall be centered on closet.
- Windows: Shall have at least (1) window in each sleeping room, that meets egress. Shall be provided with tempered glass at hazardous glazing areas. False windows shall be installed with obscure glazing.
- Closets for clothing or coat storage shall be equipped with 1 rod/shelf. Closets for linen shall have 4 open equal shelves. Closets for pantries shall have 4 equal wood shelves, painted.
- Stair treads shall be a min of 9" deep, risers shall be a maximum of 8 1/4", unless noted otherwise, per the current North Carolina Residential Code

Wood Shelves at Owners Double Linen ←

- 10. Handrails and Guards at stairs shall be 34" above the finished surface of the ramp surface of the stair. Handrails at landings and overlooks of multilevel spaces shall be 36" above finished floor. Guards (pickets or balusters) shall be spaced with no more than 4" between quards.
- 11. Attic Access shall be provided at all attic area with a height greater than 30". Minimum clear attic access shall be 20" x 30". Pull down stairs and access doors in knee walls meeting minimum criteria are also acceptable.
- 12.Garage Door to Living Space shall be 2'-8" x 6'-8" minimum size and shall be 20 minute fire rated and weather sealed.
- 13. Garage Walls, as a minimum, shall be separated from living space by installing 1/2" gypsum board on the garage side of the wall. With habitable space above, the Inside of all garage walls require 1/2" GWB supporting 5/8" type X GWB on ceiling.

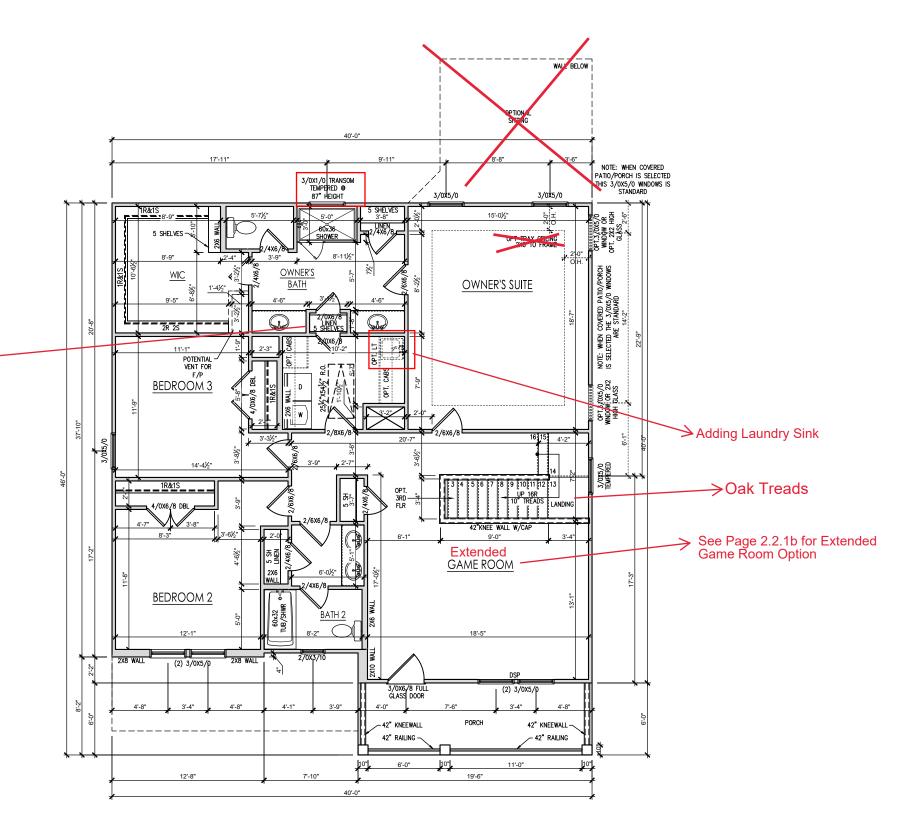

Second Floor Plan 'Georgian'

HT

APEX

THE

DRAWN BY: South Designs ISSUE DATE: 7/1/2021


CURRENT REVISION DATE

1/8" = 1'-0"

SECOND FLOOR PLAN 'GEORGIAN'
SCALE: 1/8"=1"-0" ON 11x17, 1/4"=1"-0" ON 22x34

General Floor Plan Notes shall apply unless noted otherwise on plan.

- Wall Heights: Typically 9'-1 1/2" at first floor and second floor, and 9'-1 1/2" at attics U.N.O. All walls are constructed using a double top plate. Splices at Double Top Plate do not need to occur at Vertical Studs but must be at least 24" apart from Joint in other Top Plate layer. Special wall heights are noted on plans where they occur.
- Wall Thickness is typically 3 1/2". 2x6 frame shall be used at walls that back up to plumbing fixtures. Walls greater than 10' high shall be framed with 2x6 framing or greater and will be noted as a special condition where it occurs on plan.
- Typical header height shall be 7'-8" AFF at First Floor, and 7'-4" AFF at Second Floor U.N.O.
- Jacks: Openings up to 3'-4" wide shall have (1) 2x4 jack stud SPF on each side. Openings greater than 3'-4" wide shall have (2) 2x4 jack studs SPF on each
- 5. Soffits, Coffered Cellings, Trey Cellings and other significant celling plan elements are shown on the floor plans and are denoted as single dashed lines. Unless specifically call out as included, Kitchens do not include soffits over wall cabinetry.
- Door & Window Frames, where occurring near corners, shall be a minimum of 4 1/2" from corner. Except for walk-in closets with doors near a corner, doors at closets shall be centered on closet.
- 7. Windows: Shall have at least (1) window in each sleeping room, that meets egress. Shall be provided with tempered glass at hazardous glazing areas. False windows shall be installed with obscure glazing.
- Closets for clothing or coat storage shall be equipped with 1 rod/shelf. Closets for linen shall have 4 open equal shelves. Closets for pantries shall have 4 equal wood shelves, painted.
- Stair treads shall be a min of 9" deep, risers shall be a maximum of 8 1/4", unless noted otherwise, per the current North Carolina Residential Code
- 10. Handrails and Guards at stairs shall be 34" above the finished surface of the ramp surface of the stair. Handrails at landings and overlooks of multilevel spaces shall be 36" above finished floor. Guards (pickets or balusters) shall be spaced with no more than 4" between guards.
- 11. Attic Access shall be provided at all attic area with a height greater than 30". Minimum clear attic access shall be 20" x 30". Pull down stairs and access doors in knee walls meeting minimum criteria are also acceptable.
- 12.Garage Door to Living Space shall be 2'-8" x 6'-8" minimum size and shall be 20 minute fire rated and weather sealed.
- 13. Garage Walls, as a minimum, shall be separated from living space by installing 1/2" gypsum board on the garage side of the wall. With habitable space above, the inside of all garage walls require 1/2" GWB supporting 5/8" type X GWB on celling.

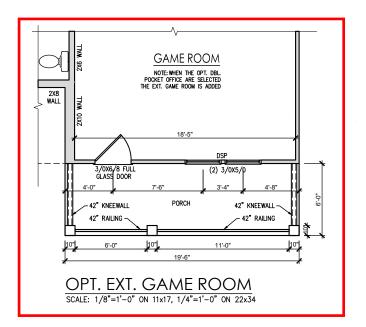



DATE			-						
DESCRIPTION			1	1	1	1	1		
REV.#	1	2	က	4	2	9	7	8	


THE APEX - LH --- Second Floor Plan Options


DRAWN BY: South Designs


ISSUE DATE: 7/1/2021

CURRENT REVISION DATE:
---SCALE:
1/8" = 1'-0"

2.2.1h

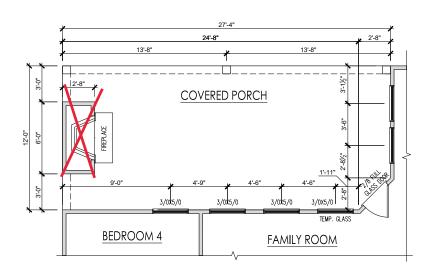

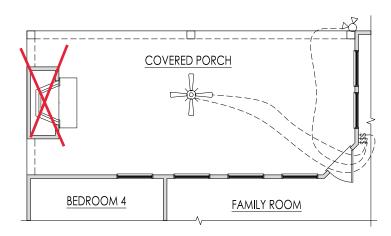

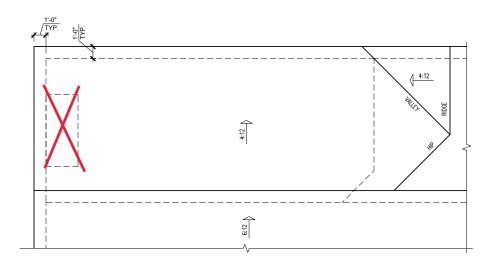


OPT. EXT. COVERED PORCH **W/ FIREPLACE** FLOOR PLAN SCALE: 1/8"=1'-0" ON 11x17, 1/4"=1'-0" ON 22x34

OPT. EXT. COVERED PORCH W/ FIREPLACE ELECTRICAL SCALE: 1/8"=1'-0" ON 11x17, 1/4"=1'-0" ON 22x34


OPT. EXT. COVERED PORCH W/ FIREPLACE ROOF PLAN SCALE: 1/8"=1'-0" ON 11x17, 1/4"=1'-0" ON 22x34

See Page 3.2.1b for Elevations w/ Sitting Room Option

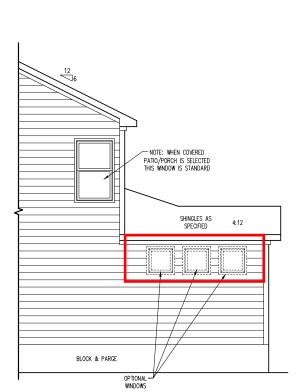

PARTIAL RIGHT SIDE ELEVATION (CRAWL\ STEM WALL) SCALE: 1/8"=1'-0" ON 11x17, 1/4"=1'-0" ON 22x34


SEE FOUNDATION PAGES FOR FOUNDATION TYPE

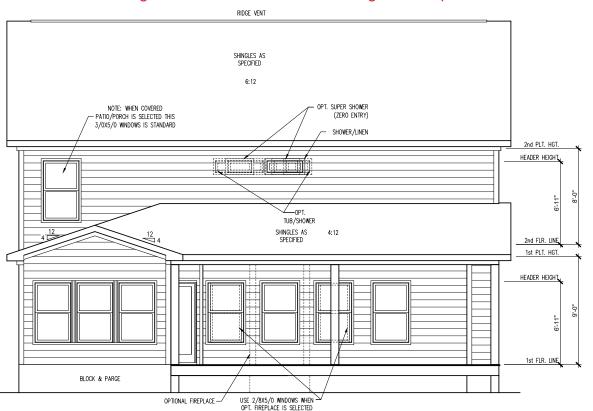

EXTENDED COVERED PORCH REAR ELEVATION (CRAWL\ STEM WALL)

SEE FOUNDATION PAGES FOR FOUNDATION TYPE

SCALE: 1/8"=1'-0" ON 11x17, 1/4"=1'-0" ON 22x34

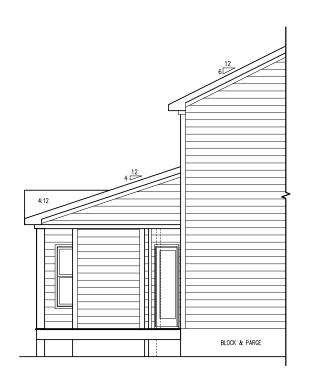

PARTIAL LEFT SIDE ELEVATION (CRAWL\ STEM WALL) SCALE: 1/8"=1'-0" ON 11x17, 1/4"=1'-0" ON 22x34

SEE FOUNDATION PAGES FOR FOUNDATION TYPE

DATE	ŀ	-		-	-	-	-	1
DESCRIPTION			-	1	1	I	Ŧ	:
REV. #	1	7	3	4	9	9	7	8

Ext. Covered Porch Plans & Elev (Crawl or Stem Wall) 'Georgian'

- LH

THE APEX

DRAWN BY: South Designs ISSUE DATE: 7/1/2021


CURRENT REVISION DATE:

SCALE: 1/8" = 1'-0"

2.5.1b

			A	TTIC '	VENT S	CHEDU	LE				
				'GEO	rgian' el	EVATION					
MAIN	MAIN HOUSE SQ FTG 260 AT / NEAR RIDGE AT / NEAR EAVE										
VENT TYPE	SQ. REQL		SQ. FT.	PERCENT OF TOTAL	POT LARGE (SQ. FT. EACH)	POT SMALL (SQ. FT. EACH)	RIDGE VENT (SQ. FT. PER LF)	EAVE VENT (SQ. IN. EACH)	CONT. VENT (SQ. IN. PER LF)		
VENTITIE	RAN		SUPPLIED	SUPPLIED	0.4236	0.2778	0.125	0.1944	0.0625		
•											
RIDGE VENT	0.35	0.43	1.00	44.44	0	0	8.00				
SOFFIT VENTS	0.52	0.43	1.25	55.56	5.56 0 20.00						
TOTAL (MIN)	0.87	0.87	2.25	100.00	POT VENTS MAY BE REQUIRED IF THERE IS INSUFFICIENT RIDGE AVAILABLE						


^{*} SCHEDULE HAS BEEN CALCULATED ASSUMING EAVE VENTILATION AT 50-60% OF TOTAL AND RIDGE AT 40-50% OF TOTAL REQUIRED VENTILATION

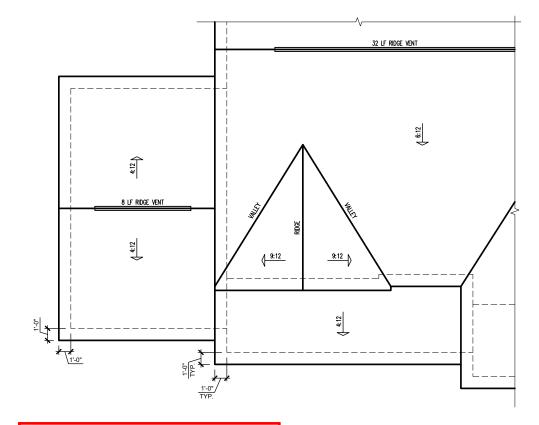

OPT. 3-CAR GARAGE

'GEORGIAN' ROOF PLAN

SCALE: 1/4" = 1'-0" ON 22x34, 1/8" = 1'-0" ON 11x17

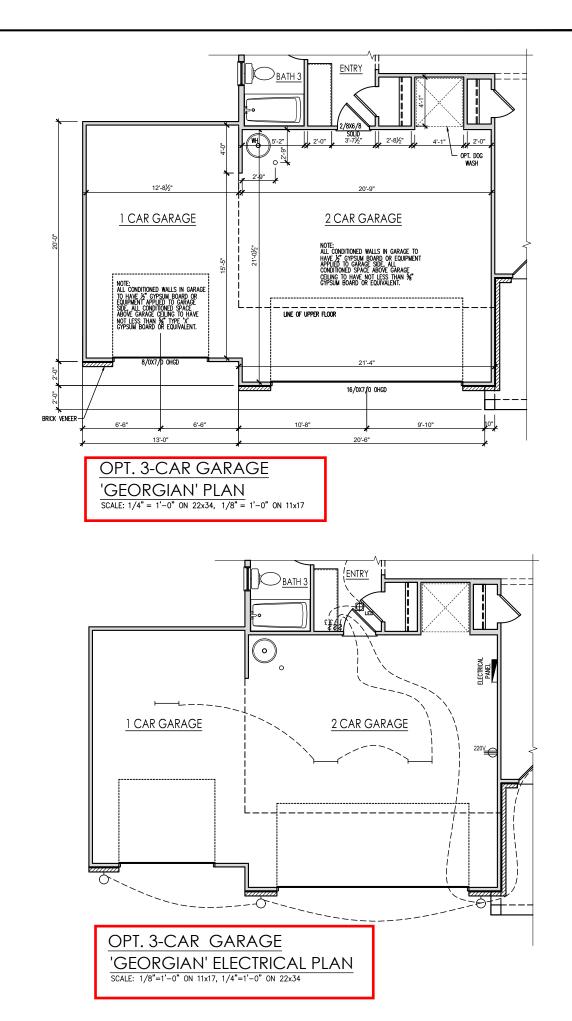



DATE	-	:	-					
DESCRIPTION	1	1	I	1	1	1	1	
REV. #	1	2	3	4	2	9	7	8


THE APEX - LH
--3-Car Garage Plans 'Georgian'

DRAWN BY: South Designs

ISSUE DATE: 7/1/2021

CURRENT REVISION DATE:
---SCALE:
1/8" = 1'-0"

2.7b

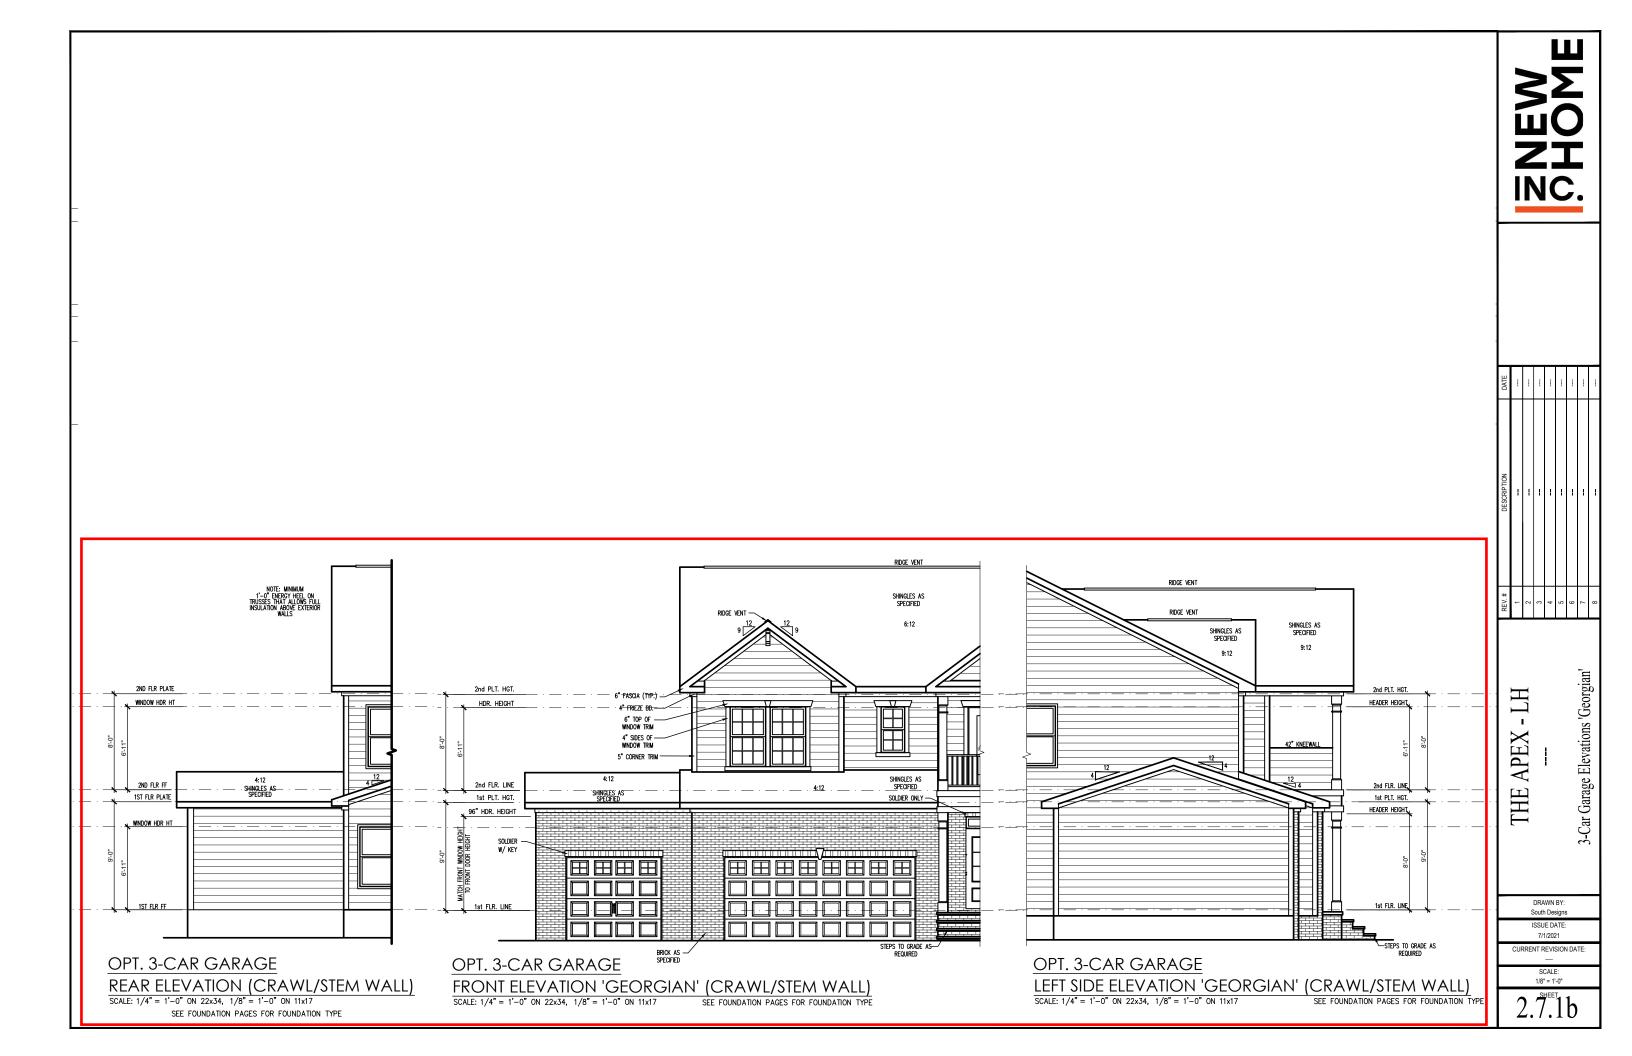

General Elevation Notes

General Elevation Notes shall apply unless noted otherwise on plan.

- Roof shall be finished with architectural composition shingles with slopes as noted on plan.
- Ridge Vent shall be provided and installed on all ridges greater than 6' in length per manufacturer's specifications.
- 3. Soffit Vent shall be continuous soffit vent
- House Wrap, "tyvek" or approved equal shall be installed over entire exterior wall per manufacturer's specifications and recommendations.
- Flashing shall be provided above all door and window openings, above finish wall material changes and at wall surfaces where lower roof areas abut vertical wall surfaces.
- Porch Railings shall be provided at all porch walking surfaces greater than 30" above adjacent finished grade. It shall be 36" high with guards spaced no more than 4" apart. Consult community specifications for material.
- Finish Wall Material shall be as noted on elevation drawings.
- 8. Brick Veneer, if included on elevation shall be tied to wall surface with galvanized corrugated metal ties at a rate of 24" oc horizontally and 16" oc vertically so that no more than 2.67sf of brick is supported by (1) tie. Space between face of wall and back face of brick shall be limited to a maximum of 1". Flashing shall be provided behind brick above all wall openings and at base of brick wall. Flashing shall be a minimum of 6-mil poly or other corrosion resistant material and shall be installed so that if laps under the house wrap material a minimum of 2". Weepholes shall be provided at a rate of 48" oc and shall not be less than 3/16" in diameter and shall be located immediately above flashing.
- Brick Veneer Support Lintels shall be provided if brick veneer is included on elevation. Lintels shall be provided as listed in the following schedule and shall have a minimum bearing length of 6°. Masonry Lintels shall be provided so that deflection is limited to L/600.


Masonry Opening Lintel Schedule

Opening Size Angle

up to 4'-0" 3-1/2" x 3-1/2" x 5/16" 4'-1" to 5'-6" 4" x 3-1/2" x 5/16" LLV 5'-7" to 6'-6" 5" x 3-1/2" x 5/16" LLV 6'-7" to 8'-4" 6" x 3-1/2" x 5/16" LLV 8'-5" to 16'-4" 7" x 4" x 3/8" LLV


RIDGE VENT NOTE: MINIMUM 1'-0" ENERGY HEEL ON TRUSSES THAT ALLOWS FULL INSULATION ABOVE EXTERIOR WALLS RIDGE VENT-SHINGLES AS SPECIFIED 6:12 18x24 LOUVER VENTILATION 2nd PLT. HGT. - 6" FASCIA (TYP.) -HEADER HEIGHT -4" FRIEZE BD.- \blacksquare 6" TOP OF -WINDOW TRIM Ħ - 6X6 COLUMN WRAP W/1" TRIM TO BE 8X8 COLUMN 4" SIDES OF — WINDOW TRIM 5" CORNER TRIM See Page 2.7.1b for 3rd Car Detail SHINGLES AS SPECIFIED 2nd FLR. LINE SOLDIER ONLY 1st PLT. HGT. 96"HEADER HEIGHT W/ KEY W/ KEY 6X6 COLUMN WRAP W/1" TRIM TO BE 8X8 COLUMN BRICK AS SPECIFIED BRICK AS— SPECIFIED FRONT ELEVATION 'GEORGIAN' (CRAWL/STEM WALL' SEE FOUNDATION PAGES FOR FOUNDATION TYPE SCALE: 1/4" = 1'-0" ON 22x34, 1/8" = 1'-0" ON 11x17

SCALE: 1/4" = 1'-0" ON 22x34, 1/8" = 1'-0" ON 11x17

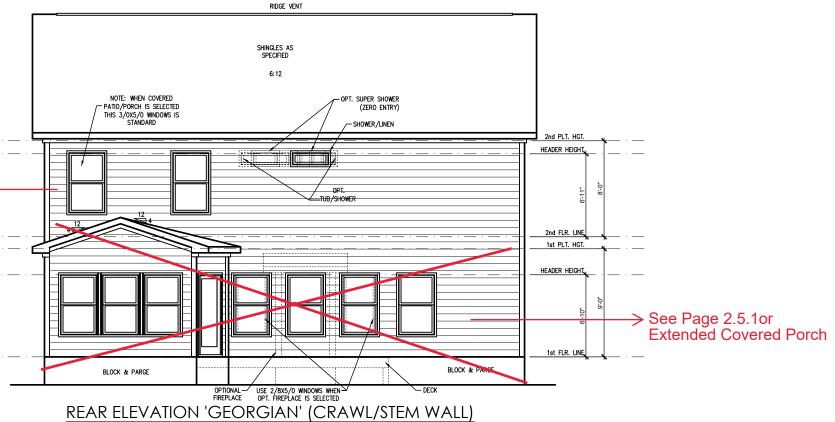

SEE FOUNDATION PAGES FOR FOUNDATION TYPE



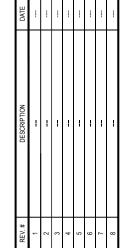

Front & Rear Elev (Crawl or Stem Wall)
'Georgian'

- LH

APEX

THE,

DRAWN BY: South Designs ISSUE DATE: 7/1/2021


7/1/2021

CURRENT REVISION DATE:
---SCALE:

1/8" = 1'-0"

3.1.1b

General Elevation Notes General Elevation Notes shall apply unless noted otherwise on plan. Roof shall be finished with architectural composition shingles with slopes as noted on plan RIDGE VENT Ridge Vent shall be provided and installed on all ridges greater than 6' in length per manufacturer's specifications. RIDGE VENT 3. Soffit Vent shall be continuous soffit vent SHINGLES AS SPECIFIED House Wrap, "tyvek" or approved equal shall be installed over entire exterior wall per manufacturer's specifications and recommendations. 9:12 Flashing shall be provided above all door and window openings, above finish wall material changes and at wall surfaces where lower roof areas abut vertical wall surfaces. 2nd PLT. HGT. Porch Railings shall be provided at all porch walking ____ surfaces greater than 30" above adjacent finished HEADER HEIGHT, LINE FOR COVERED PATIO/PORC - 6X6 COLUMN WRAP W/1" TRIM TO BE 8X8 COLUMN Finish Wall Material shall be as noted on elevation VENT Brick Veneer, if included on elevation shall be tied to wall surface with galvanized corrugated metal ties at a rate of 24" oc horizontally and 16" oc vertically so 2nd FLR. LINE a rate of 24" oc horizontally and 16" oc vertically so—that no more than 2.67st of brick is supported by (1) the. Space between face of wall and back face of brick shall be limited to a maximum of 1". Flashing shall be provided behind brick above all wall openings and at base of brick wall. Flashing shall be—a minimum of 6-mil poly or other corrosion resistant material and shall be installed so that it laps under the house wrap material a minimum of 2". Weepholes shall be provided at a rate of 48" oc and shall no be less than 3/16" in diameter and shall be located immediately above flashing. 1st PLT. HGT. HEADER HEIGHT, 6X6 COLUMN WRAP W/1" TRIM TO BE 8X8 COLUMN Brick Veneer Support Lintels shall be provided if brick veneer is included on elevation. Lintels shall be provided as listed in the following schedule and shall 1st FLR. LIN have a minimum bearing length of 6". Masonry Lintels shall be provided so that deflection is limited to L/600. BLOCK & PARGE STEPS TO GRADE AS REQUIRED Opening Size LEFT SIDE ELEVATION 'GEORGIAN' (CRAWL/STEM WALL) up to 4'-0" 4'-1" to 5'-6" 5'-7" to 6'-6" 6'-7" to 8'-4" 8'-5" to 16'-4" 3-1/2" x 3-1/2" x 5/16" SEE FOUNDATION PAGES FOR FOUNDATION TYPE SCALE: 1/4" = 1'-0" ON 22x34, 1/8" = 1'-0" ON 11x17 RIDGE VENT RIDGE VENT SHINGLES AS SPECIFIED Side Elevations (Crawl or Stem Wall) 'Georgian' 9:12 9:12 NOTE: WHEN COVERED-2nd PLT. HGT. PATIO/PORCH IS SELECTED THESE 2 HEADER HEIGHT THE APEX LINE FOR COVERED PATIO/PORCH 42" KNEEWALL SHINGLES AS SPECIFIED -2nd FLR. LINE 1st PLT. HGT. HEADER HEIGHT DRAWN BY: South Designs ISSUE DATE: 7/1/2021 CURRENT REVISION DATE: STEPS TO GRADE AS REQUIRED BLOCK & PARGE STEPS TO GRADE -AS REQUIRED OPTIONAL WINDOWS OPTIONAL —W 1/8" = 1'-0" OPT. PKT. OFFICE RIGHT SIDE ELEVATION 'GEORGIAN' (CRAWL/STEM WALL) SCALE: 1/4" = 1'-0" ON 22x34, 1/8" = 1'-0" ON 11x17SEE FOUNDATION PAGES FOR FOUNDATION TYPE

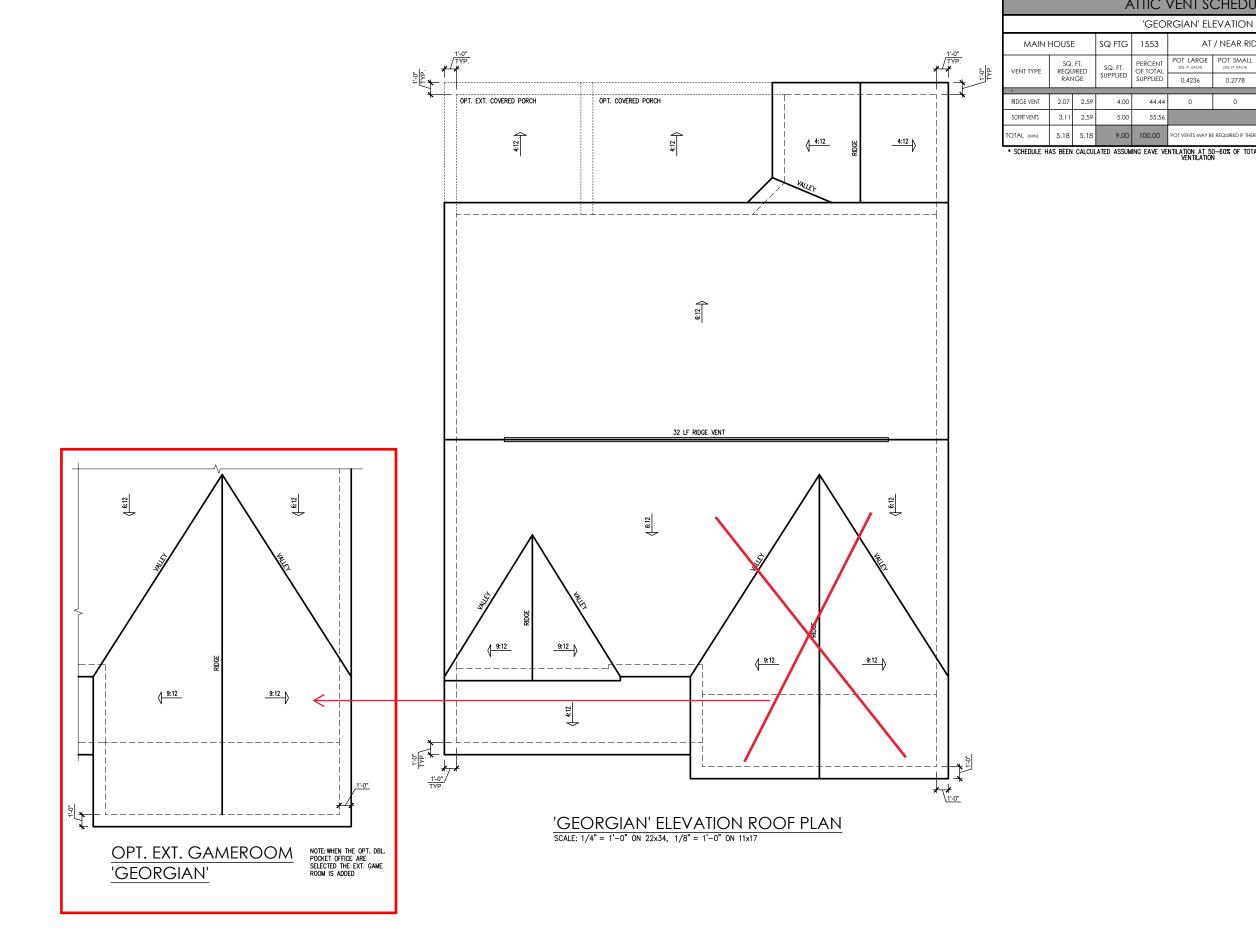

				A	TTIC '	VENT S	CHEDU	LE			
					'GEO	rgian' el	EVATION				
	MAIN I	HOUSE		SQ FTG	1553	AT	/ NEAR RID	GE	AT / NE/	AR EAVE	
:	SQ. FT. VENT TYPE REQUIRED			SQ. FT. PERCENT OF TOTAL		POT LARGE (SQ. FT. EACH)	POT SMALL (SQ. FT. EACH)	RIDGE VENT (SQ. FT. PER LF)	EAVE VENT (SQ. IN. EACH)	CONT. VENT (SQ. IN. PER LF)	
:		RAN		SUPPLIED	SUPPLIED	0.4236	0.2778	0.125	0.1944 0.0625		
	RIDGE VENT	2.07	2.59	4.00	44.44	0	0	32.00			
	KIDGE VEINI	2.07	2.57	4.00	44.44	0	U	32.00			
	SOFFIT VENTS	3.11	2.59	5.00	55.56	0				80.00	
	TOTAL (MIN)	5.18	5.18	9.00	100.00	POT VENTS MAY BE	POT VENTS MAY BE REQUIRED IF THERE IS INSUFFICIENT RIDGE AVAILABLE				

* SCHEDULE HAS BEEN CALCULATED ASSUMING EAVE VENTILATION AT 50-60% OF TOTAL AND RIDGE AT 40-50% OF TOTAL REQUIRED VENTILATION

DATE			-	-	-				
DESCRIPTION		-	ł	1	1	1	-		
REV. #	1	2	3	4	2	9	7	8	

THE APEX - LH Roof Plan 'Georgian'

> DRAWN BY: South Designs ISSUE DATE:

CURRENT REVISION DATE

SCALE: 1/8" = 1'-0"

3.3b

TRUSS SYSTEM REQUIREMENTS NC (2018 NCRC): Wind: 115-120 mph

- TRUSS SYSTEM LAYOUTS (PLACEMENT PLANS) SHALL BE DESIGNED IN ACCORDANCE WITH SEALED STRUCTURAL PLANS, ANY NEED TO CHANGE TRUSSES SHALL BE COORDINATED WITH SOUTHERN ENGINEERS.
- TRUSS SCHEMATICS (PROFILES) SHALL BE PREPARED AND SEALED BY TRUSS MANUFACTURER.
- ALL TRUSSES SHALL BE DESIGNED FOR BEARING ON SPF #2 OR #3 PLATES OR LEDGERS (UNO).
- ALL REQUIRED ANCHORS FOR TRUSSES DUE TO UPLIFT OR BEARING SHALL MEET THE REQUIREMENTS AS SPECIFIED ON THE TRUSS SCHEMATICS.

MOOD I-JOISTS

(SHALL BE ONE OF THE FOLLOWING OR EQUAL):

TJI 210 BY TRUS JOIST

LPI 20 PLUS BY LP

- BCI 5000s I.8 BY BC

HEAVY WOOD I-JOISTS

(SHALL BE ONE OF THE FOLLOWING OR EQUAL):

- T.II 360 BY TRUS JOIST
- LPI 42 PLUS BY LP
- BCI 60s 2.0 BY BC
- ALL WOOD I-JOISTS SHALL BE INSTALLED ACCORDING TO MANUFACTURER'S SPECIFICATIONS.
- INSTALL SQUASH BLOCKS, WEB STIFFENERS, ETC. AS REQUIRED BY AND ACCORDING TO THE I-JOIST MANUFACTURER'S SPECIFICATIONS AND INSTRUCTIONS.
- HANGERS FOR I-JOISTS ARE THE RESPONSIBILITY OF THE I-JOIST SUPPLIER.
- FLOOR TRUSSES BY MANUFACTURER MAY BE SUBSTITUTED FOR ANY I-JOISTS.

FOUNDATION STRUCTURAL NOTES NC (2018 NCRC): Wind: 115-120 mph - CRAWL

(]. (3)2xIO SYP#2 OR SPF#2 GIRDER, TYPICAL UNO.

- CONCRETE BLOCK PIER SIZE SHALL BE
- 2 SIZE HOLLOW UP TO 32" UP TO 48" <u>SOLID</u> UP TO 5'-0" UP TO 9'-0" 8x16
- 12x16 UP TO 64" UP TO 12'-0" 24x24 UP TO 96"
- WITH 30" x 30" x 10" CONCRETE FOOTING, UNO
- ③ •• WALL FOOTING AS FOLLOWS


8" - UP TO 2 STORY IO" - 3 STORY

16" - UP TO 2 STORY SIDING:

20" - 3 STORY BRICK: 16" - I STORY

20" - 2 STORY

- FOR FOUNDATION WALL HEIGHT AND BACKFILL REQUIREMENTS, REFER TO CODE TABLE R404.I.I (I THRU 4) NOTE: ASSUMED SOIL BEARING CAPACITY = 2000 PSF. CONTRACTOR MUST VERIFY SITE CONDITIONS AND CONTACT SOILS ENGINEER IF MARGINAL OR UNSTABLE SOILS ARE ENCOUNTERED.
- 4> (4) 2xIO SPF #2 OR SYP #2 GIRDER
- (5,) (2) 1.75x9.25 LVL OR LSL GIRDER
- 6 (3) 1.75x9.25 LVL OR LSL GIRDER
- "" DESIGNATES A SIGNIFICANT POINT LOAD TO HAVE SOLID BLOCKING TO PIER. SOLID BLOCK ALL BEAM BEARING POINTS NOTED TO HAVE THREE OR MORE STUDS TO FND, TYPICAL.
- ABBREVIATIONS:
- "SJ" = SINGLE JOIST
- "DJ" = DOUBLE JOIST
- ADJUST SUBFLOOR THICKNESS OR JOIST SPACING AS REQ'D FOR FLOOR FINISH MATERIALS.

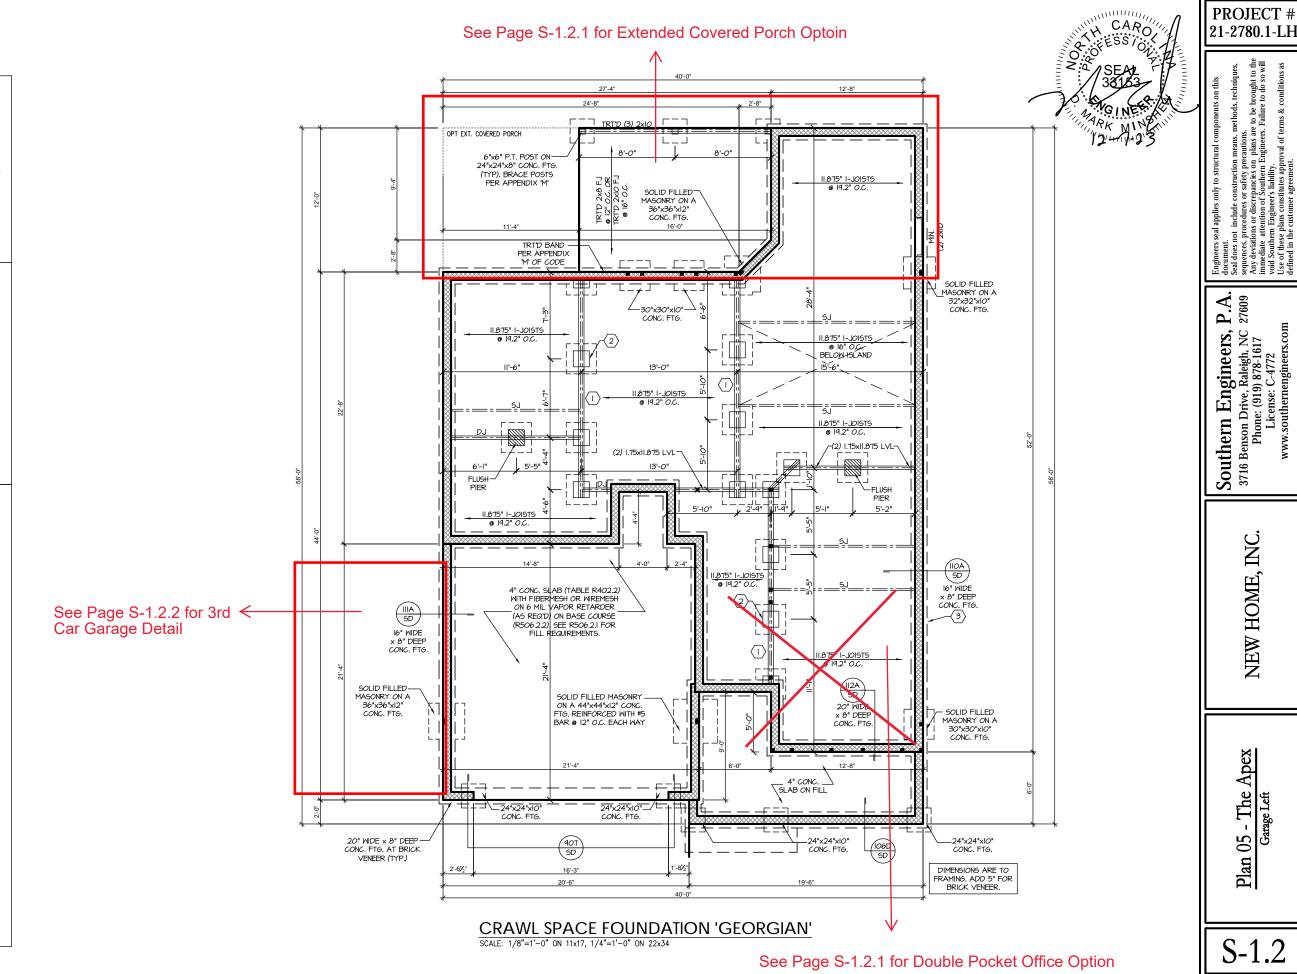

HOME,


NEW

Apex

- The

05

Plan

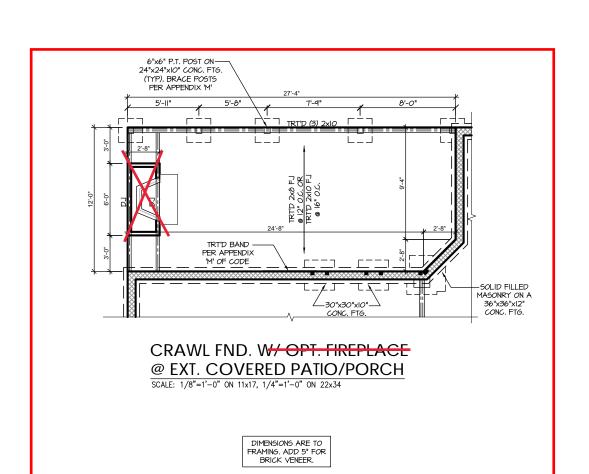

CARO CARO SEAL 38153

Figure 1 by the standard of the standard component for the standard sequences, procedures or safety precautions.

Any deviations or discrepancies on plans are to be immediate attention of Southern Engineers. Failure void Southern Engineers is lability. Its of those plans constitutes annival of forms &

PROJECT # 21-2780.1-LH

Southern Engineers, P.A. 3716 Benson Drive, Raleigh, NC 27609 Phone: (919) 878-1617 License: C-4772 www.southernengineers.com

NEW HOME, INC.

Plan 05 - The Apex Garage Left


S-1.2.1

SOLID FILLED MASONRY
ON A 44*X44X12" CONC.
FIG. REINFORCED WITH #5
BAR © 12' O.C. EACH WAY

24*X24*X10"
CONC. FIG.

CRAWL FND. W/ DBL. POCKET OFFICE

SCALE: 1/8"=1'-0" ON 11x17, 1/4"=1'-0" ON 22x34

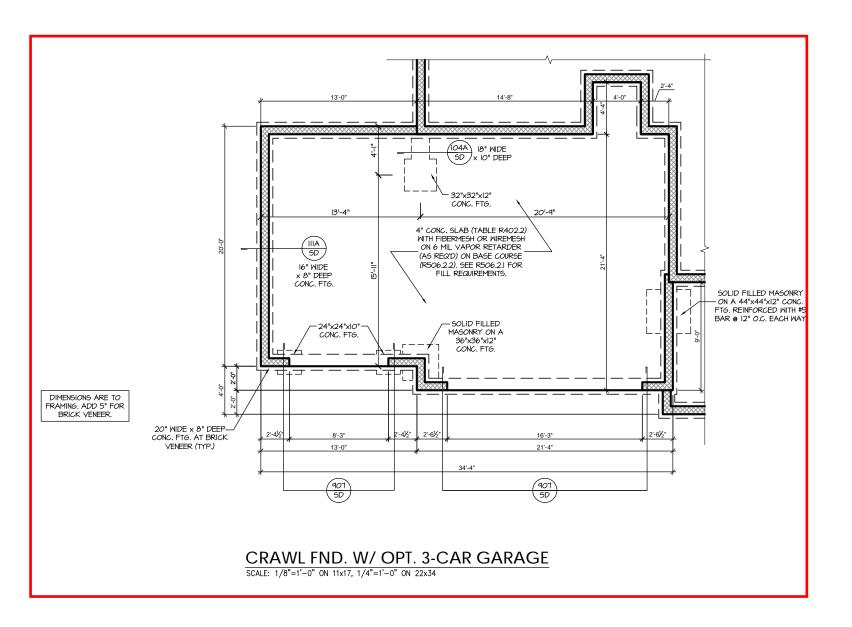

PROJECT # 21-2780.1-LH

occurrent.

Seal does not include construction means, methods, techni sequences, procedures or safety precautions.

Any deviations or discrepancies on plans are to be brought immediate attention of Southern Engineers. Failure to do void Southern Engineers liability. Use of these plans constitutes approval of terms & condition.

Southern Engineers, P.A. 3716 Benson Drive, Raleigh, NC 27609 Phone: (919) 878-1617 License: C-4772 www.southernengineers.com

NEW HOME, INC.

Plan 05 - The Apex Garage Left

S-1.2.2

HEADER/BEAM & COLUMN NOTES

- ALL EXTERIOR AND LOAD BEARING HEADERS SHALL BE MIN. (2)2x6 (4" WALL) OR (3)2x6 (6" WALL) WITH (1) SUPPORT STUD, UNLESS NOTED OTHERWISE.
- 2. THE NUMBER SHOWN AT BEAM AND HEADER SUPPORTS INDICATES THE NUMBER OF SUPPORT STUDS REQUIRED IN STUD POCKET OR COLUMN. THE NUMBER OF KING STUDS AT EACH END OF HEADERS IN EXTERIOR WALLS SHALL BE ACCORDING TO ITEM "d" IN TABLE R602.3(5) OR AS BELOW PER NCDOI COMMENTARY "KING STUDS AT WALL OPENINGS" REVISED 1-9-2020:
 UP TO 3' SPAN: (I) KING STUD
- OVER 3' UP TO 6' SPAN: (2) KING STUDS
- OVER 6' UP TO 9' SPAN. (3) KING STUDS
- OVER 9' UP TO 12' SPAN: (4) KING STUDS OVER 12' UP TO 15' SPAN: (5) KING STUDS

TRUSS SYSTEM REQUIREMENTS

NC (2018 NCRC): Wind: 115-120 mph

- TRUSS SYSTEM LAYOUTS (PLACEMENT PLANS) SHALL BE DESIGNED IN ACCORDANCE WITH SEALED STRUCTURAL PLANS. ANY NEED TO CHANGE TRUSSES SHALL BE COORDINATED WITH SOUTHERN ENGINEERS.
- TRUSS SCHEMATICS (PROFILES) SHALL BE PREPARED AND SEALED BY TRUSS MANUFACTURER
- ALL TRUSSES SHALL BE DESIGNED FOR BEARING ON SPF #2 OR #3 PLATES OR LEDGERS (UNO).
- ALL REQUIRED ANCHORS FOR TRUSSES DUE TO UPLIFT OR BEARING SHALL MEET THE REQUIREMENTS AS SPECIFIED ON THE TRUSS SCHEMATICS.

PORCH POST NOTES:

- 4X4 (6x6) TRT'D POST (OR EQUAL)
- ATTACH TRUSSES (RAFTERS) AT PORCH WITH HURRICANE CONNECTORS.

 POST CAP: SIMPSON AC4-MAX (AC6-MAX)
- POST CAP AT CORNER: (2) SIMPSON LCE4
 (MITER HEADER AT CORNER). HIGH WIND; ADD (1)
- 3. POST BASE: SIMPSON ABU44 (ABU66).
- MONO: 5%" ANCHOR (EMBED 1")

 CMJ: 5%" ANCHOR (EXTEND TO FOOTING
 HIGH WIND ONLY)
- 4. POST BASE: WOOD FOUNDATION: (2) SIMPSON CSI6 STRAPS AT POSTS. EXTEND 12" ONTO EACH POST (UPPER AND LOWER) OR TO GIRDER.
- NOTE: THE ABOVE CONNECTORS ARE SUGGESTIONS. EQUIVALENT CONNECTORS THAT MEET THE REQUIREMENTS OF THE NC RESIDENTIAL BUILDING CODE, LOCAL CODES, AND/OR ARE APPROVED BY THE BUILDING INSPECTOR MAY BE SUBSTITUTED.

MOOD I-JOISTS

(SHALL BE ONE OF THE FOLLOWING OR EQUAL):

- TJI 210 BY TRUS JOIST
- LPI 20 PLUS BY LP
 BCI 5000s I.8 BY BC

HEAVY WOOD I-JOISTS

- (SHALL BE ONE OF THE FOLLOWING OR EQUAL):

 TJI 360 BY TRUS JOIST


 LPI 42 PLUS BY LP
- BCI 60s 2.0 BY BC
- ALL WOOD IS DISTS SHALL BE INSTALLED
- INSTALL SQUASH BLOCKS, MEB STIFFENERS, ETC. AS REQUIRED BY AND ACCORDING TO THE I-JOIST MANUFACTURER'S SPECIFICATIONS AND INSTRUCTIONS.
- HANGERS FOR I-JOISTS ARE THE RESPONSIBILITY OF THE I-, WIST SUPPLIER
- FLOOR TRUSSES BY MANUFACTURER MAY BE SUBSTITUTED FOR ANY I-JOISTS.

FRAMING NOTES

NC (2018 NCRC): Wind: 115-120 mph

- BRACING METHOD AND TYPE: CONTINUOUSLY SHEATHED WSP: CS-WSP NOTE THAT THE WALL BRACING AMOUNT PROVIDED ON THE PLANS (DETAILS AND SPECIFICATIONS) IS GREATER THAN THE AMOUNT OF WALL BRACING REQUIRED BY SECTION R602.10 OF THE CODE. SEE NOTES BELOW FOR DETAILS AND SPECIFICATIONS FOR WALL BRACING AND WALL FRAMING.
- 2. EXTERIOR WALL SHEATHING: WALLS SHALL BE BRACED BY SHEATHING WALLS ON ALL STORIES WITH WOOD STRUCTURAL PANEL SHEATHING (WSP) (EXPOSURE B: 7/16". EXPOSURE C: 15/32"). SHEATHING SHALL BE ATTACHED WITH 8d NAILS AT A 6"/12" NAILING PATTERN (6" OC AT PANEL EDGES AND 12" OC AT INTERMEDIATE SUPPORTS). INSTALL BLOCKING AT ALL PANEL EDGES.
- 3. WSP SHEATHING SHALL EXTEND TO THE UPPERMOST DOUBLE BEARING PLATE. BLOCK AT ROOF PER SECTION R602.10.4.5 AND ATTACH BRACED WALLS PER CODE. WSP SHEATHING BETWEEN FLOORS SHALL BE SPLICED ALONG CONTINUOUS BAND OR THE WSP SHEATHING MAY BE SPLICED ACROSS STUDS (CONTINUOUS ACROSS FLOOR SYSTEM) WITH BLOCKING AT PANEL EDGES. (MINIMUM 12" BEYOND FLOOR BREAK) OR OTHER APPROVED METHOD.
- . "HD" = HOLDONN: HOLD-DOWN DEVICE (NOTED AS "HD" ON PLANS)
 SHALL BE AN 800 POUND CAPACITY ASSEMBLY AS NOTED ON PLANS. SEE DETAILS FOR HD ASSEMBLY.

 **GROUND/FIRST FLOOR: USE "HD HOLD-DOWN DETAIL" ON SD SHEET
- **UPPER FLOORS: ATTACH BASE OF KING STUD WITH A SIMPSON C520 OR C5HP20 STRAP DOWN ACROSS THE BAND AND DOWN TO A STUD BELOW OR HEADER BELOW. EXTEND STRAP T" MIN ALONG EACH STUD (OR HEADER) AND ATTACH EACH END W (7) 8d NAILS.
- 5. INTERIOR BRACED WALL: (NOTED AS "IBW" ON PLANS) ATTACH I/2" GYPSUM BOARD (6B) ON EACH SIDE OF WALL WITH A MIN. OF 5d COOLER NAILS OR #6 SCREWS @ 7* O.C. ALONG THE EDGES AND AT INTERMEDIATE SUPPORTS. SEE SECTION R602.IO.4.4 OF THE CODE.
- INTERIOR BRACED WALL-WOOD STRUCTURAL PANEL: (NOTED AS "IBM-MSP" ON PLANS), ATTACH ONE SIDE WITH 1%" MSP SHEATHING WITH 8d NAILS AT A 6"/12" NAILING PATTERN (6" OC AT PANEL EDGES AND 12" OC AT INTERMEDIATE SUPPORTS), INSTALL BLOCKING AT ALL PANEL EDGES. ATTACH GB OVER MSP AS REQUIRED. ATTACH
 OPPOSITE SIDE WITH I/2" GB WITH A MIN. OF 5d COOLER NAILS OR #6 SCREWS @ 7" OC ALONG THE EDGES AND AT INTERMEDIATE SUPPORTS. SEE SECTION R602.10.4.4 OF THE CODE.

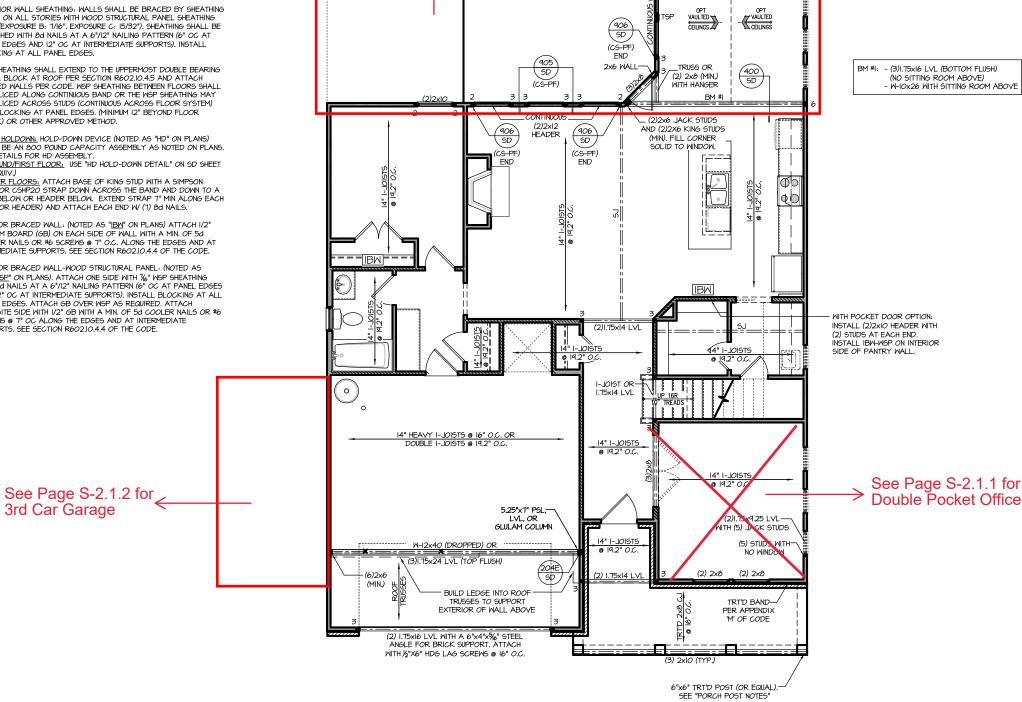

1'-6" (MIN.) EDGE OF

ROUGHED OPENING TO

EXTERIOR OF CORNER

(SAME ON OPPOSITE SIDE)

905 SD

(CS-PF)

905

(CS-PF)

CONTINUOUS (2)2x1:

ROOF TRUSSES

BY MANUFACTURER
FLOOR TRUSSES WITH SITTING

ROOM ABOVE

FIRST FLOOR PLAN 'GEORGIAN' SCALE: 1/8"=1'-0" ON 11x17, 1/4"=1'-0" ON 22x34

Extended Covered Porch

OPT. COVERED PORCH

OPT EXT. COVERED PORCH

PROJECT # 21-2780.1-LH

CARO

brought e to do s

P.A. 27609

Engineers, Drive, Raleigh, NC e: (919) 878-1617 Southern Engi 3716 Benson Drive, Ra Phone: (919) 8

> HOME, NEW

Apex The 05 Plan

Southern Engineers, P.A. 3716 Benson Drive, Raleigh, NC 27609 Phone: (919) 878-1617 License: C-4772 www.southernengineers.com

PROJECT # 21-2780.1-LH

NEW HOME, INC.

Plan 05 - The Apex Garage Left

HEADER/BEAM & COLUMN NOTES

- ALL EXTERIOR AND LOAD BEARING HEADERS SHALL BE MIN. (2)2x6 (4" WALL) OR (3)2x6 (6" WALL) WITH (1) SUPPORT STUD, UNLESS NOTED OTHERWISE.
- 2. THE NUMBER SHOWN AT BEAM AND HEADER SUPPORTS INDICATES THE NUMBER OF SUPPORT STUDS REQUIRED IN STUD POCKET OR COLUMN. THE NUMBER OF KING STUDS AT EACH END OF HEADERS IN EXTERIOR WALLS SHALL BE ACCORDING TO ITEM "d" IN TABLE R602.3(5) OR AS BELOW PER NCDOI COMMENTARY "KING STUDS AT WALL OPENINGS" REVISED 1-9-2020:
 UP TO 3' SPAN: (I) KING STUD
- OVER 3' UP TO 6' SPAN: (2) KING STUDS
- OVER 6' UP TO 9' SPAN. (3) KING STUDS
- OVER 9' UP TO 12' SPAN: (4) KING STUDS OVER 12' UP TO 15' SPAN: (5) KING STUDS

TRUSS SYSTEM REQUIREMENTS NC (2018 NCRC): Wind: 115-120 mph

- TRUSS SYSTEM LAYOUTS (PLACEMENT PLANS) SHALL BE DESIGNED IN ACCORDANCE WITH SEALED STRUCTURAL PLANS. ANY NEED TO CHANGE TRUSSES SHALL BE COORDINATED WITH SOUTHERN ENGINEERS.
- TRUSS SCHEMATICS (PROFILES) SHALL BE PREPARED AND SEALED BY TRUSS MANUFACTURER.
- ALL TRUSSES SHALL BE DESIGNED FOR BEARING ON SPF #2 OR #3 PLATES OR LEDGERS (UNO).
- ALL REQUIRED ANCHORS FOR TRUSSES DUE TO UPLIFT OR BEARING SHALL MEET THE REQUIREMENTS AS SPECIFIED ON THE TRUSS SCHEMATICS.

PORCH POST NOTES:

- 4X4 (6x6) TRT'D POST (OR EQUAL)
- ATTACH TRUSSES (RAFTERS) AT PORCH WITH HURRICANE CONNECTORS.

 POST CAP: SIMPSON AC4-MAX (AC6-MAX)
- POST CAP AT CORNER: (2) SIMPSON LCE4 (MITER HEADER AT CORNER). HIGH WIND; ADD (1)
- 3. POST BASE: SIMPSON ABU44 (ABU66).
- MONO: 5% ANCHOR (EMBED 1")


 CMJ: 5% ANCHOR (EXTEND TO FOOTING HIGH WIND ONLY)
- 4. POST BASE: WOOD FOUNDATION: (2) SIMPSON CSI6 STRAPS AT POSTS. EXTEND 12" ONTO EACH POST (UPPER AND LOWER) OR TO GIRDER.
- NOTE: THE ABOVE CONNECTORS ARE SUGGESTIONS. EQUIVALENT CONNECTORS THAT MEET THE REQUIREMENTS OF THE NC RESIDENTIAL BUILDING CODE, LOCAL CODES, AND/OR ARE APPROVED BY THE BUILDING INSPECTOR MAY BE SUBSTITUTED.

FRAMING NOTES

NC (2018 NCRC): Wind: 115-120 mph

- BRACING METHOD AND TYPE: CONTINUOUSLY SHEATHED WSP: CS-WSP NOTE THAT THE WALL BRACING AMOUNT PROVIDED ON THE PLANS (DETAILS AND SPECIFICATIONS) IS GREATER THAN THE AMOUNT OF WALL BRACING REQUIRED BY SECTION R602.10 OF THE CODE. SEE NOTES BELOW FOR DETAILS AND SPECIFICATIONS FOR WALL BRACING AND WALL FRAMING.
- 2. EXTERIOR WALL SHEATHING: WALLS SHALL BE BRACED BY SHEATHING WALLS ON ALL STORIES WITH WOOD STRUCTURAL PANEL SHEATHING (WSP) (EXPOSURE B: 7/16". EXPOSURE C: 15/32"). SHEATHING SHALL BE ATTACHED WITH 8d NAILS AT A 6"/12" NAILING PATTERN (6" OC AT PANEL EDGES AND 12" OC AT INTERMEDIATE SUPPORTS). INSTALL BLOCKING AT ALL PANEL EDGES.
- 3. WSP SHEATHING SHALL EXTEND TO THE UPPERMOST DOUBLE BEARING PLATE. BLOCK AT ROOF PER SECTION R602.10.4.5 AND ATTACH BRACED WALLS PER CODE. WSP SHEATHING BETWEEN FLOORS SHALL BE SPLICED ALONG CONTINUOUS BAND OR THE WSP SHEATHING MAY BE SPLICED ACROSS STUDS (CONTINUOUS ACROSS FLOOR SYSTEM) WITH BLOCKING AT PANEL EDGES. (MINIMUM 12" BEYOND FLOOR BREAK) OR OTHER APPROVED METHOD.
- 4. "HD" = HOLDOMN: HOLD-DOWN DEVICE (NOTED AS "HD" ON PLANS)
 SHALL BE AN 800 POUND CAPACITY ASSEMBLY AS NOTED ON PLANS.
- SEE DETAILS FOR HD ASSEMBLY.

 **GROUND/FIRST FLOOR: USE "HD HOLD-DOWN DETAIL" ON SD SHEET
- **UPPER FLOORS: ATTACH BASE OF KING STUD WITH A SIMPSON C520 OR C5HP20 STRAP DOWN ACROSS THE BAND AND DOWN TO A STUD BELOW OR HEADER BELOW. EXTEND STRAP T" MIN ALONG EACH STUD (OR HEADER) AND ATTACH EACH END W (7) 8d NAILS.
- 5. INTERIOR BRACED WALL: (NOTED AS "IBW" ON PLANS) ATTACH I/2" GYPSIM BOARD (GB) ON EACH SIDE OF WALL WITH A MIN. OF 5d COOLER NAILS OR #6 SCREWS @ 7" O.C. ALONG THE EDGES AND AT INTERMEDIATE SUPPORTS. SEE SECTION R602.10.4.4 OF THE CODE.
- INTERIOR BRACED WALL-WOOD STRUCTURAL PANEL: (NOTED AS "IBW-MSP" ON PLANS). ATTACH ONE SIDE WITH %" MSP SHEATHING WITH δd NAILS AT A 6"/12" NAILING PATTERN (6" OC AT PANEL EDGES AND 12" OC AT INTERMEDIATE SUPPORTS). INSTALL BLOCKING AT ALL PANEL EDGES. ATTACH GB OVER MSP AS REQUIRED. ATTACH
 OPPOSITE SIDE WITH I/2" GB WITH A MIN. OF 5d COOLER NAILS OR #6 SCREWS @ 7" OC ALONG THE EDGES AND AT INTERMEDIATE SUPPORTS. SEE SECTION R602.10.4.4 OF THE CODE.

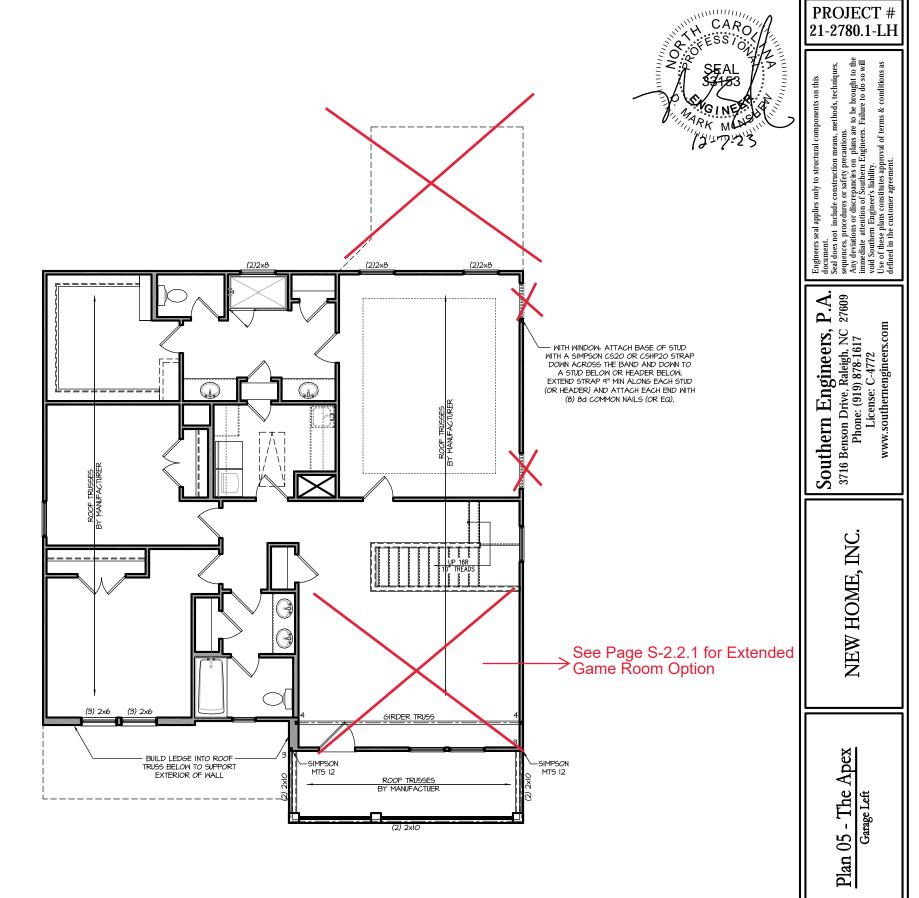

SECOND FLOOR PLAN 'GEORGIAN'

SCALE: 1/8"=1'-0" ON 11x17, 1/4"=1'-0" ON 22x34


ROOF TRUSSES BY MANUFACTURER GIRDER TRUSS —SIMPSON MTS 12 SIMPSON MTS 12 ROOF TRUSSES BY MANUFACTUER (2) 2xIO (APPLIES ONLY WITH "OPT. DOUBLE POCKET OFFICE" BELOW) OPT. EXT. GAME ROOM
SCALE: 1/8"=1'-0" ON 11x17, 1/4"=1'-0" ON 22x34

Southern Engineers, P.A. 3716 Benson Drive, Raleigh, NC 27609 Phone: (919) 878-1617 License: C-4772 www.southernengineers.com

PROJECT # 21-2780.1-LH

NEW HOME, INC.

Plan 05 - The Apex Garage Left

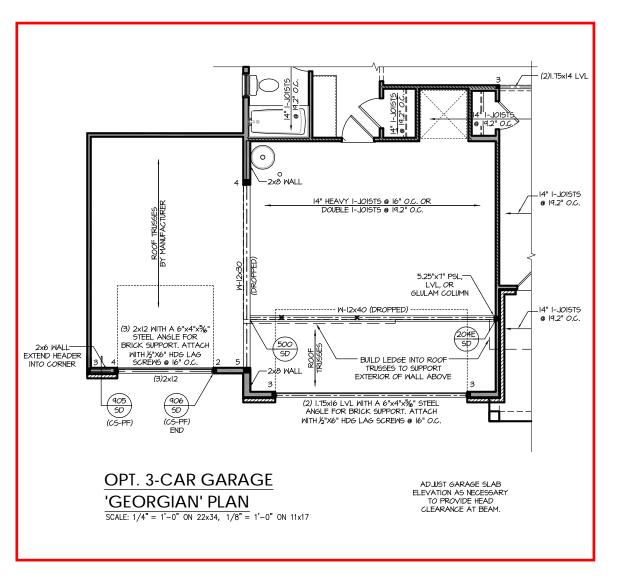

PROJECT # 21-2780.1-LH


document.
Seal does not include construction means, methods, technis sequences, procedures or safety precautions.
Any deviations or discrepancies on plans are to be brought immediate attention of Southern Engineers. Failure to do s void Southern Engineer's liability.
Use of these plans constitutes approval of terms & conditio


Southern Engineers, P.A. 3716 Benson Drive, Raleigh, NC 27609 Phone: (919) 878-1617 License: C-4772 www.southernengineers.com


NEW HOME, INC.

Plan 05 - The Apex Garage Left

S-2.1.2

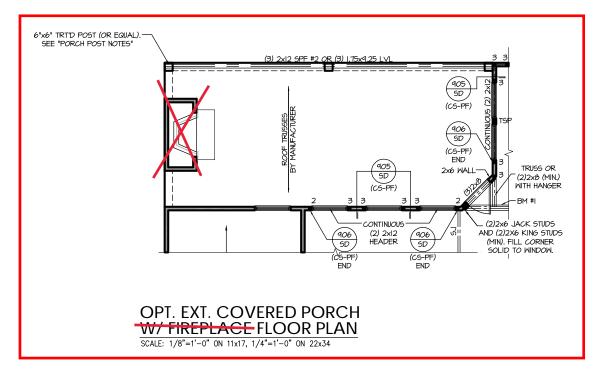

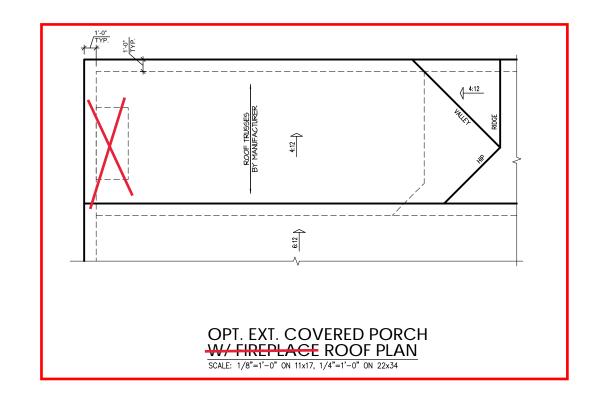

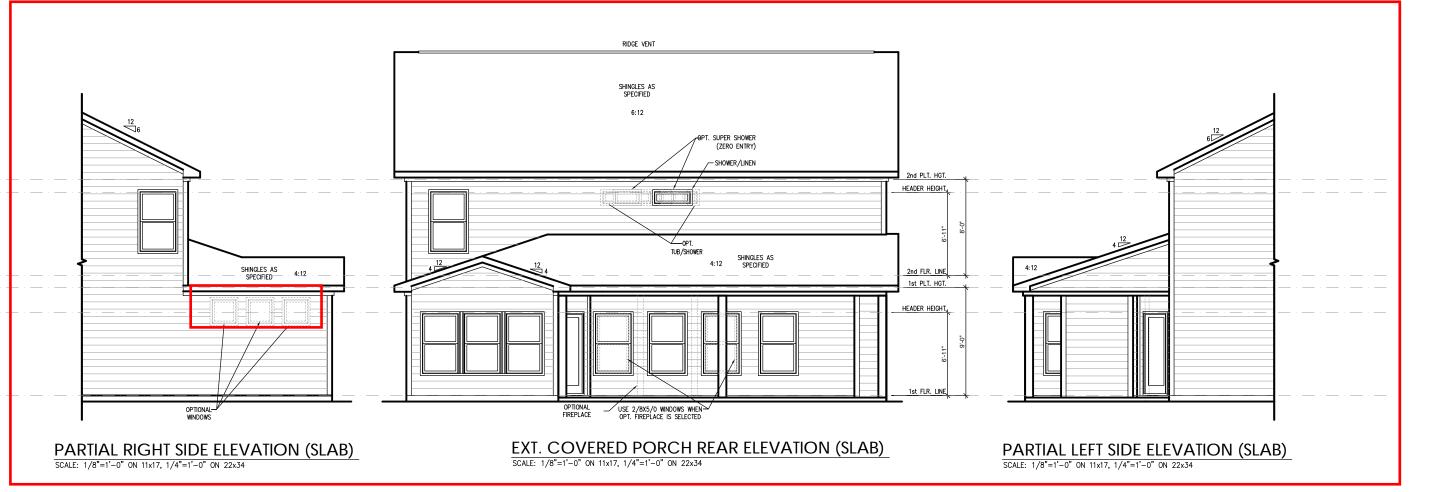


PROJECT # 21-2780.1-LH

P.A. 27609 Southern Engineers, P


INC.

NEW HOME,

i - The Apex arage Left Plan 05 -

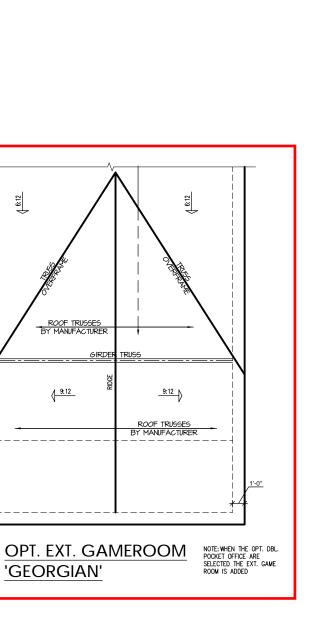

9:12

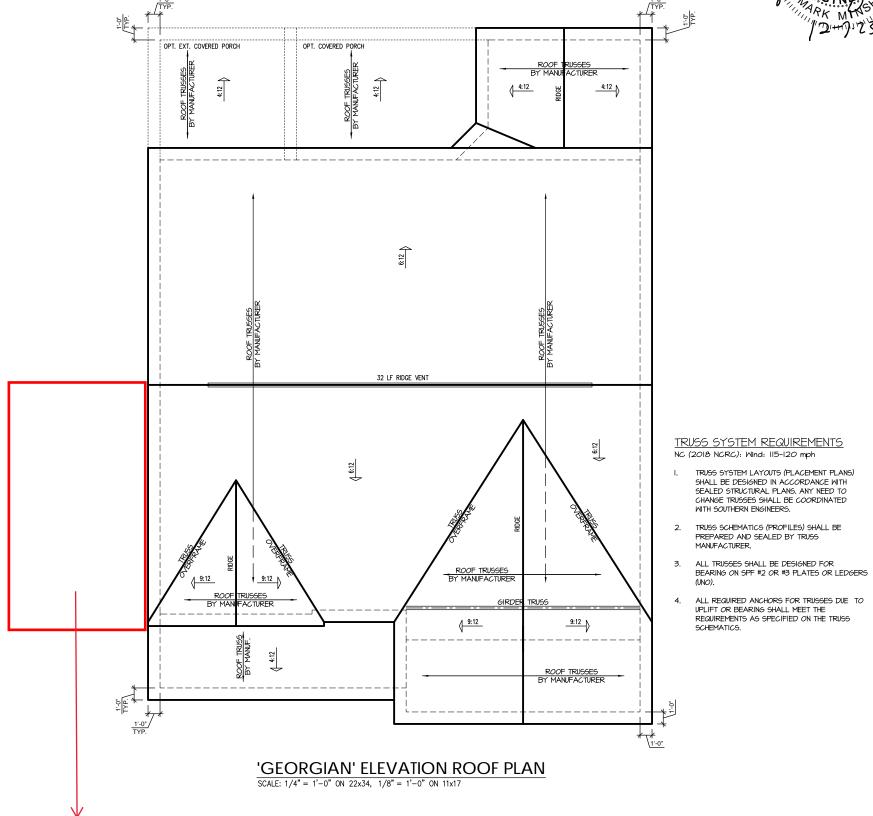


See Page S-3.1.1 for 3rd Car Garage Detail

PROJECT # 21-2780.1-LH

P.A. 27609 Southern Engineers, P 3716 Benson Drive, Raleigh, NC 27 Phone: (919) 878-1617 License: C-4772

NEW HOME, INC.

Plan 05 - The Apex Garage Left

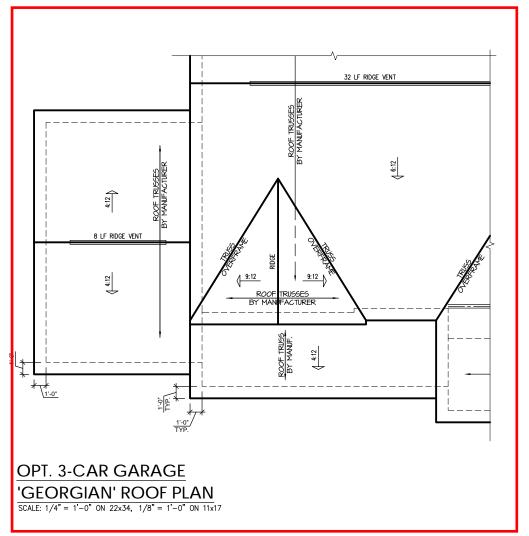

Southern Engineers, P.A. 3716 Benson Drive, Raleigh, NC 27609 Phone: (919) 878-1617 License: C-4772 www.southernengineers.com


PROJECT # 21-2780.1-LH


ME, INC. 37161

NEW HOME, INC.


Plan 05 - The Apex Garage Left

S-3.2

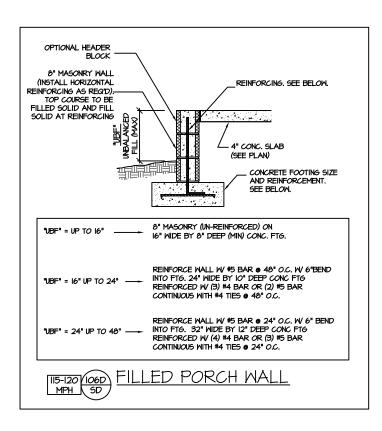


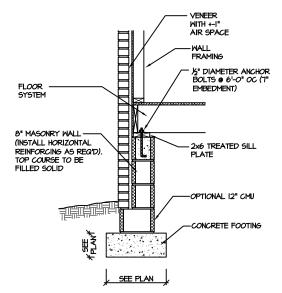



MPH SD (VENEER)

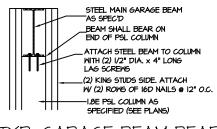



SPACE FOOTING

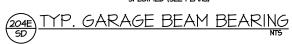


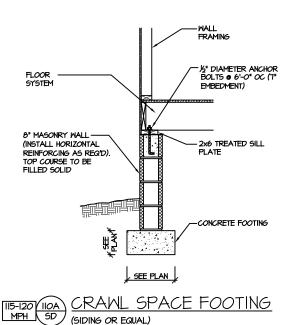


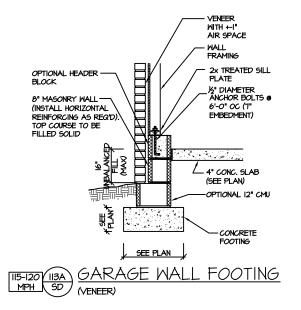


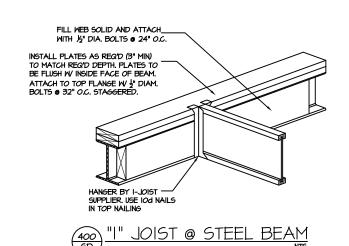

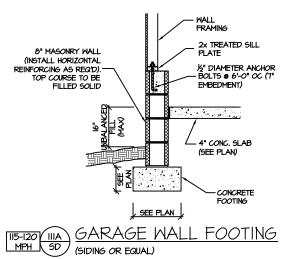

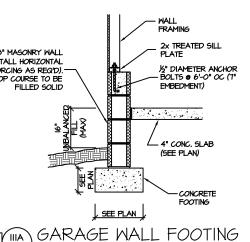

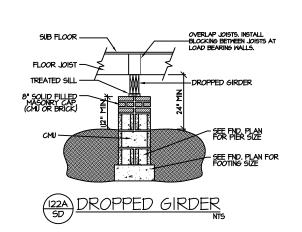

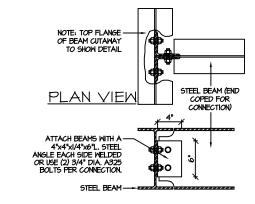

BEAM CONNECTION DETAIL

STRUCTURAL DETAILS: CRAWL SPACE FOUNDATION PROJECT # 21-2780.1

CARO

P.A. 27609 Southern Engineers, P 3716 Benson Drive, Raleigh, NC 2' Phone: (919) 878-1617 License: C-4772

NEW HOME,

05 Plan Apex The

SD

CARO

ENGINEER'S SEAL APPLIES ONLY TO STRUCTURAL COMPONENTS INCLUDING ROOF RAFTERS, HIPS, VALLEYS, RIDGES, FLOORS, WALLS, BEAMS AND HEADERS, COLUMNS, CANTILEVERS, OFFSET LOAD BEARING WALLS, PIER & GIRDER SYSTEM, FOOTING, AND PILING SYSTEM. ENGINEER'S

SEAL DOES NOT CERTIFY DIMENSIONAL ACCURACY OR ARCHITECTURAL LAYOUT INCLUDING ROOF SYSTEM, ALL REQUIREMENTS FOR PROFESSIONAL CERTIFICATION SHALL BE PROVIDED BY

THE APPROPRIATE PROFESSIONAL. SOUTHERN ENGINEERS, P.A. CERTIFIES ONLY THE STRUCTURAL

NOT RESPONSIBLE FOR, AND WILL NOT HAVE CONTROL OF, CONSTRUCTION MEANS, METHODS, TECHNIQUES, SEQUENCES OR PROCEDURES, OR FOR SAFETY PRECAUTIONS AND PROGRAMS IN CONNECTION WITH THE CONSTRUCTION WORK, NOR WILL THE ENGINEER BE RESPONSIBLE FOR THE CONTRACTOR'S FAILURE TO CARRY OUT THE CONSTRUCTION NORK IN ACCORDANCE WITH THE CONTRACT DOCUMENTS, "CONSTRUCTION REVIEW" SERVICES ARE NOT PART OF OUR CONTRACT. ALL MEMBERS SHALL BE FRAMED ANCHORED, TIED AND BRACED IN ACCORDANCE WITH GOOD

2. ALL CONSTRUCTION SHALL CONFORM TO THE LATEST REQUIREMENTS OF THE 2018 NC RESIDENTIAL CODE, PLUS ALL LOCAL CODES AND REGULATIONS. THE STRUCTURAL ENGINEER IS

4. WALLS SHALL BE BRACED BY SHEATHING WALLS ON ALL STORIES WITH MOOD STRUCTURAL PANELS. SEE FRAMING NOTES FOR THICKNESS AND NAILING REQUIREMENTS.

SEE APPENDIX M (DCA6) FOR EXTERIOR DECK REQUIREMENTS INCLUDING ATTACHMENTS FOR LATERAL LOADS.

HAVE 1/4" DEEP CONTROL JOINTS SANCUT IN SLAB ON A +-10'-0" x +-10'-0" GRID).

7. ALLOWABLE SOIL BEARING PRESSURE ASSUMED TO BE 2000 PSF. THE CONTRACTOR MUST CONTACT A GEOTECHNICAL ENGINEER AND THE STRUCTURAL ENGINEER IF UNSATISFACTORY SUBSURFACE CONDITIONS ARE ENCOUNTERED. THE SURFACE AREA ADJACENT TO THE

ALL FRAMING LUMBER SHALL BE SPF #2 (Fb = 875 PSI) UNLESS NOTED OTHERWISE (UNO). ALL TREATED LUMBER SHALL BE SYP # 2. PLATE MATERIAL MAY BE SPF # 3 OR SYP #3 (Fc(perp)

4. L.V.L. SHALL BE LAMINATED VENEER LUMBER: Fb=2600 PSI, Fv=265 PSI, E=1.4xI0 PSI.
4.I. P.S.L. SHALL BE PARALLEL STRAND LUMBER: Fb=2400 PSI, Fv=240 PSI, E=2.0xI0 PSI.
4.2. L.S.L. SHALL BE LAMINATED STRAND LUMBER: Fb=2250 PSI, Fv=400 PSI, E=1.55xI0 PSI.

IO. ALL ROOF TRUSS AND I-JOIST LAYOUTS SHALL BE PREPARED IN ACCORDANCE WITH THE SEALED STRUCTURAL DRAWINGS. TRUSSES AND I-JOISTS SHALL BE INSTALLED ACCORDING TO THE MANUFACTURE'S SPECIFICATIONS. ANY CHANGE IN TRUSS OR I-JOIST LAYOUT SHALL BE

II. ALL STRUCTURAL STEEL SHALL BE ASTM A-36. STEEL BEAMS SHALL BE SUPPORTED AT EACH END WITH A MINIMUM BEARING LENGTH OF 3 1/2" INCHES AND FULL FLANGE WIDTH, PROVIDE SOLID BEARING FROM BEAM SUPPORT TO FOUNDATION. BEAMS SHALL BE ATTACHED TO EACH

12. REBAR SHALL BE DEFORMED STEEL, ASTM615, GRADE 60. LAP ALL REBAR SPLICES 30 BAR

FLITCH BEAMS SHALL BE BOLTED TOGETHER USING (2) ROWS OF I/2" DIAMETER BOLTS (ASTM A325) WITH WASHERS PLACED UNDER THE THREADED END OF BOLT. BOLTS SHALL BE SPACED

AT 24" O.C. (MAX), AND STAGGERED AT THE TOP AND BOTTOM OF BEAM (2" EDGE DISTANCE), WITH 2 BOLTS LOCATED AT 6" FROM EACH END.

14. BRICK LINTELS (MHEN REQUIRED) SHALL BE 3 1/2*x3 1/2*x1/4" STEEL ANGLE FOR UP TO 6'-0" SPAN AND 6'x4'x5/16" STEEL ANGLE WITH 6" LEG VERTICAL FOR SPANS UP TO 9'-0". SEE PLANS

I5. METAL CONNECTORS REFERENCED ON PLANS CORRESPOND TO SIMPSON STRONG-TIE BRAND. CONNECTORS OF EQUAL OR BETTER CAPACITY ARE ACCEPTABLE. CORROSION RESISTANCE PER CODE AND AS RECOMMENDED BY MANUFACTURER.

SUPPORT WITH TWO LAG SCRENS (1/2" DIAMETER x 4" LONG). LATERAL SUPPORT IS CONSIDERED ADEQUATE PROVIDING THE JOIST ARE TOE NAILED TO THE SOLE PLATE, AND SOLE PLATE IS

NAILED OR BOLTED TO THE BEAM FLANGE • 48" O.C. ALL STEEL TUBING SHALL BE ASTM A500.

INSTALL ALL CONNECTIONS PER MANUFACTURERS INSTRUCTIONS.

6. CONCRETE SHALL HAVE A MINIMUM 28 DAY STRENGTH OF 3000 PSI AND A MAXIMUM SLUMP OF 5 INCHES UNLESS NOTED OTHERNISE (UNO). AIR ENTRAINED PER TABLE 402.2. ALL CONCRETE SHALL BE PROPORTIONED, MIXED, HANDLED, SAMPLED, TESTED, AND PLACED IN ACCORDANCE WITH ACI STANDARDS. ALL SAMPLES FOR PUMPING SHALL BE TAKEN FROM THE EXIT END OF

THE PIMP, CONTROL JOINTS IN SLABS SHALL BE SPACED ON A GRID OF \leftrightarrow 30 TIMES THE DEPTH (D). CONTROL JOINTS SHALL BE SANCUT TO A DEPTH OF I/D. (I.E. 4" CONCRETE SLABS SHALL

FOUNDATION WALL SHALL BE PROVIDED WITH ADEQUATE DRAINAGE, AND SHALL BE GRADED SO

CONSTRUCTION PRACTICE AND THE BUILDING CODE.

SLEEPING ROOMS: (30 PSF, I/O PSF, L/360) ATTIC WITH PERMANENT STAIR: (40 PSF, I/O PSF, L/360)

ATTIC WITHOUT STORAGE: (IO PSF, IO PSF, L/240)

STAIRS: (40 PSF, IO PSF, L/360)

ATTIC WITHOUT PERMANENT STAIR: (20 PSF, IO PSF, L/360)

DECKS AND EXTERIOR BALCONIES: (40 PSF, IO PSF, L/360) PASSENGER VEHICLE GARAGES: (50 PSF, IO PSF, L/360)


DESIGN LOADS (LISTED AS: LIVE LOAD, DEAD LOAD, DEFLECTION)
ROOMS OTHER THAN SLEEPING ROOMS: (40 PSF, IO PSF, L/360)

STRUCTURAL NOTES NC (2018 NCRC): Wind: 115-120 mph



PTIONAL WALL PLATE MAY COUNTERSINK BOLT IN OPTIONAL PLATE. TREATED SILLPLATE GARAGE SLAE OVER GRAVEL AS SPECIFIED (OR OTHER) THREADED ROD WITH OR SIMPSON "SET OR CONCRETE FOOTING 3" CONC. COVER (TYP) SECTION **ELEVATION**



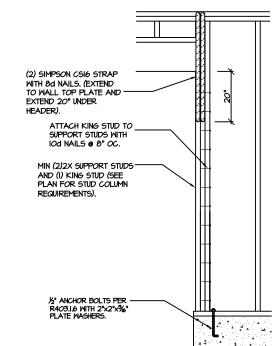

CS-PF: END CONDITION DETAIL (FOR USE WITH SINGLE CS-PF CONDITION) R602.IO.I - PORTAL FRAME CONSTRUCTION

NOTE: AT INTERMEDIATE WALL (2) SIMPSON CSI6 STRAP SEGMENTS BETWEEN OPENINGS. THE WITH 8d NAILS, (EXTEND STRAPS SHALL BE INSTALLED AT

2' TO 18'

MIN 1/6" THICK WOOD STRUCTURAL PANEL

TREATED SILLPLATE

SHEATHING


EXTERIOR VIEW

-8d NAILS @ 3" OC TOP

-EXTEND SHEATHING TO

SILL PLATE (DO NOT SPLICE)

MSP OVERLAP OPTION

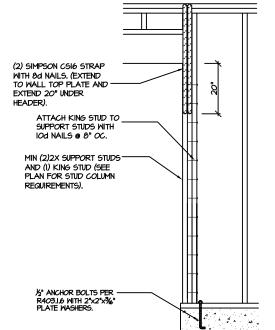

DETAIL AND APPLICATION BASED ON NORC FIGURE

CS-PF - OVER WOOD FLOOR

FRAMING ANCHOR OPTION

INTERIOR VIEW

EXTEND 20" UNDER

(2) ROWS OF 16d

MIN (2)2X WALL FRAMING.

COLUMN REQUIREMENTS.

SEE PLAN FOR STUD

TREATED SILLPLATE

15" ANCHOR BOLTS PE

R403.1.6 WITH 2"x2"x36" PLATE WASHERS.

NOTE: FOR CMU APPLICATIONS AT GARAGE DOORS, ANCHOR BOLTS SHAL BE %" DIAMETER AND SHALL EXTEND TO FOOTING (PER NORC FIGURE

R602.IO.4.3 (SEE GARAGE "WING WALL" DETAIL ON STRUCTURAL PLANS)

NAILS @ 3" OC

HEADER).

CS-PF: CONTINUOUS PORTAL FRAME CONSTRUCTION DETAIL AND APPLICATION BASED ON NORC FIGURE R602.IO.I - PORTAL FRAME CONSTRUCTION

SIMPSON LTP4 FRAMING

MIN, 3"XII.25" HEADER, SEE PLAN FOR ACTUAL SIZE, EXTEND - OVER PANEL.

FASTEN SHEATHING TO HEADER W 8d COMMON NAILS IN 3" GRID

FRAMING (STUDS, BLOCKING, AND

PANEL EDGES SHALL BE BLOCKED AND OCCUR WITHIN 24" OF MID-HEIGHT. ONE ROW OF TYP. SHEATHING-TO-FRAMING

NAILING IS REQ'D (3" OC). ATTACH BLOCKING TOGETHER W

FOOTING / FOUNDATION (SEE

PATTERN AND 3" OC. IN ALL

SILLS) TYP.

(3) I6d SINKERS.

STRUCTURAL DETAILS: CRAWL SPACE FOUNDATION