#### **REVISION LOG**

REVISION:001

ADJUST OPTION SQUARE FOOTAGES TO ACCURATELY SHOW THE DIFFERENCES FROM THE BASE PLAN SQUARE FOOTAGE TOTALS.

REVISION:002

1. ADJUST OPTION SQUARE FOOTAGES TO ACCURATELY SHOW THE DIFFERENCES FROM THE BASE PLAN SQUARE FOOTAGE TOTALS.
2. EXTENDED TERM AT GARAGE DOOR DOWN TO BASE AND CUT STONE BACK
3. ADJUSTED KITCHEN ISLAND
4. RESIZED THE FIREPLACE OPTION
5. RELOCATED THE WINDOW IN THE MESSY KITCHEN TO BEHIND THE OPT. SINK
6. CHANGED MESSY KITCHEN WINDOW TO OPTIONAL
7. ADDED CHASE TO OWNER'S WIC
8. ADDED DIMS TO 0. BATH VANITY FOR CLARIFICATION
9. REMOVED OPT. DOOR TO LOFT
10. ADDED CHASE TO LOFT WINDOW TO THE CONTROL OF THE CONTROL

REVISION:003 DATE: 3/30/2022

EXTEND PORCH SLAB 4" AROUND THE PERIMETER AT THE 'CRAFTSMAN' ELEVATION

ADDED A COLUMN DETAIL FOR CLARITY ON THE "CRAFTSMAM" ELEVATION
ADDED A SEPARATE OPTION FOR THE POCKET OFFICE WITH THE SMART DELIVERY DOOR
ADDED ELECTRICAL PLAN SHEETS

REVISION:004 DATE: 6/20/2022

1. ADD SIDE LOAD GARAGE.

REVISION:005

DATE: 7/22/2022 ADD STEM WALL SLAB FOUNDATION SHEETS CORRECT OPTIONAL SMART DELIVERY DOOR LOCATION ON FOUNDATION PLANS TO MATCH FLOOR PLAN.

REVISION:006 DATE: 10/29/23

CHANGED 40A42 STOWER 10 42A42.
ADDED SIDE LOAD GARAGE FOUNDATION FOR EXTENDED CAFE OPTION.
UPDATED SQUARE FOOTAGE CHART TO ADD EXTENDED PATIO TO THE EXTENDED CAFE

4. MOVED WATER HEATER TO INNER CORNER FOR ALL SIDE LOAD OPTIONS.

# Redlines completed 23-Feb-24

Lot 5 - Woodbridge South

146 Yates Mill Drive Lillington, NC 27526

# NC.



#### **DESIGN CRITERIA:**

THIS PLAN IS TO BE BUILT IN CONFORMANCE WITH THE 2018 NORTH CAROLINA STATE BUILDING CODE: RESIDENTIAL CODE

DIMENSIONS SHALL GOVERN OVER SCALE, AND CODE SHALL GOVERN OVER DIMENSIONS.

# PLAN 2 The Holly - RH 'GEORGIAN' ELEVATION

| Sheet No. | Sheet Description   |
|-----------|---|
| 0.0       | Cover Sheet   |
| 0.0       | Foundation (Slab)   |
| 1.1.1     | Foundation Options (Slab)   |
| 1.1.2     | Foundation Options (Slab)   |
| 1.2       | Foundation (Crawl)  |
| 1.2.1     | Foundation Options (Crawl)  |
| 1.2.2     | Foundation Options (Crawl)  |
| 1.3       | Foundation (Stem Wall Slab)   |
| 1.3.1     | Foundation Options (Stem Wall Slab)                                 |
| 1.3.2     | Foundation Options (Stem Wall Slab)                                 |
| 2.1       | First Floor Plan  |
| 2.1.1     | First Floor Plan Options  |
| 2.2       | Second Floor Plan   |
| 2.2.1     | Second Floor Plan Options   |
| 2.4       | Covered Porch Plans & Elevations (Slab)                             |
| 2.4.1     | Covered Porch Plans & Elevations (Crawl/Stem Wall)                  |
| 2.5       | Covered Porch w/ Extended Cafe Plans & Elevations (Slab)            |
| 2.5.1     | Covered Porch w/ Extended Cafe Plans & Elevations (Crawl/ Stem Wall |
| 2.6       | Extended Cafe Plans & Elevations (Slab)                             |
| 2.6.1     | Extended Cafe Plans & Elevations (Crawl/ Stem Wall)                 |
| 2.7       | 2-Car Sideload Garage Plans   |
| 2.7.1     | 2-Car Sideload Garage Elevations                                    |
| 3.1       | Front & Rear Elevations (Slab)                                      |
| 3.1.1     | Front & Rear Elevations (Crawl/ Stem Wall)                          |
| 3.2       | Side Elevations (Slab)  |
| 3.2.1     | Side Elevations (Crawl/ Stem Wall)                                  |
| 3.3       | Roof Plan   |
| 5.1       | First Floor Electrical  |
| 5.1.1     | First Floor Options Electrical                                      |
| 5.2       | Second Floor Electrical   |
| 5.2.1     | Second Floor Options Electrical                                     |

|                     | GEOR          | GIAN       |
|---------------------|---------------|------------|
|                     | UNHEATED      | HEATED     |
| FIRST FLOOR         | 0             | 872        |
| SECOND FLOOR        | 0             | 1336       |
| FRONT PORCH         | 123           | 0          |
| 2 CAR GARAGE        | 437           | 0          |
| PATIO               | 140           | 0          |
|                     |               |            |
| SUBTOTALS           | 720           | 2208       |
| TOTAL UNDER ROOF    | 29:           | 28         |
| 0                   | PTIONS        |            |
|                     | UNHEATED S.F. | HEATED S.F |
| COVERED PATIO       | 160           | 0          |
| EXTENDED CAFE w/    | +148          | +152       |
| REAR POCKET OFFICE  | 0             | +60        |
| PRONT POCKET OFFICE | 0             | +37        |
| I KOM I OCKEI OMICE |               |            |
| EDONT PORCH W/      | 126           | 0          |



| 7                 |             |   |   |   |   |   |   |   |   |  |
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| * - 2 8 4 5 6 F 8 | DESCRIPTION |   |   | ł | 1 | 1 | 1 | 1 |   |  |
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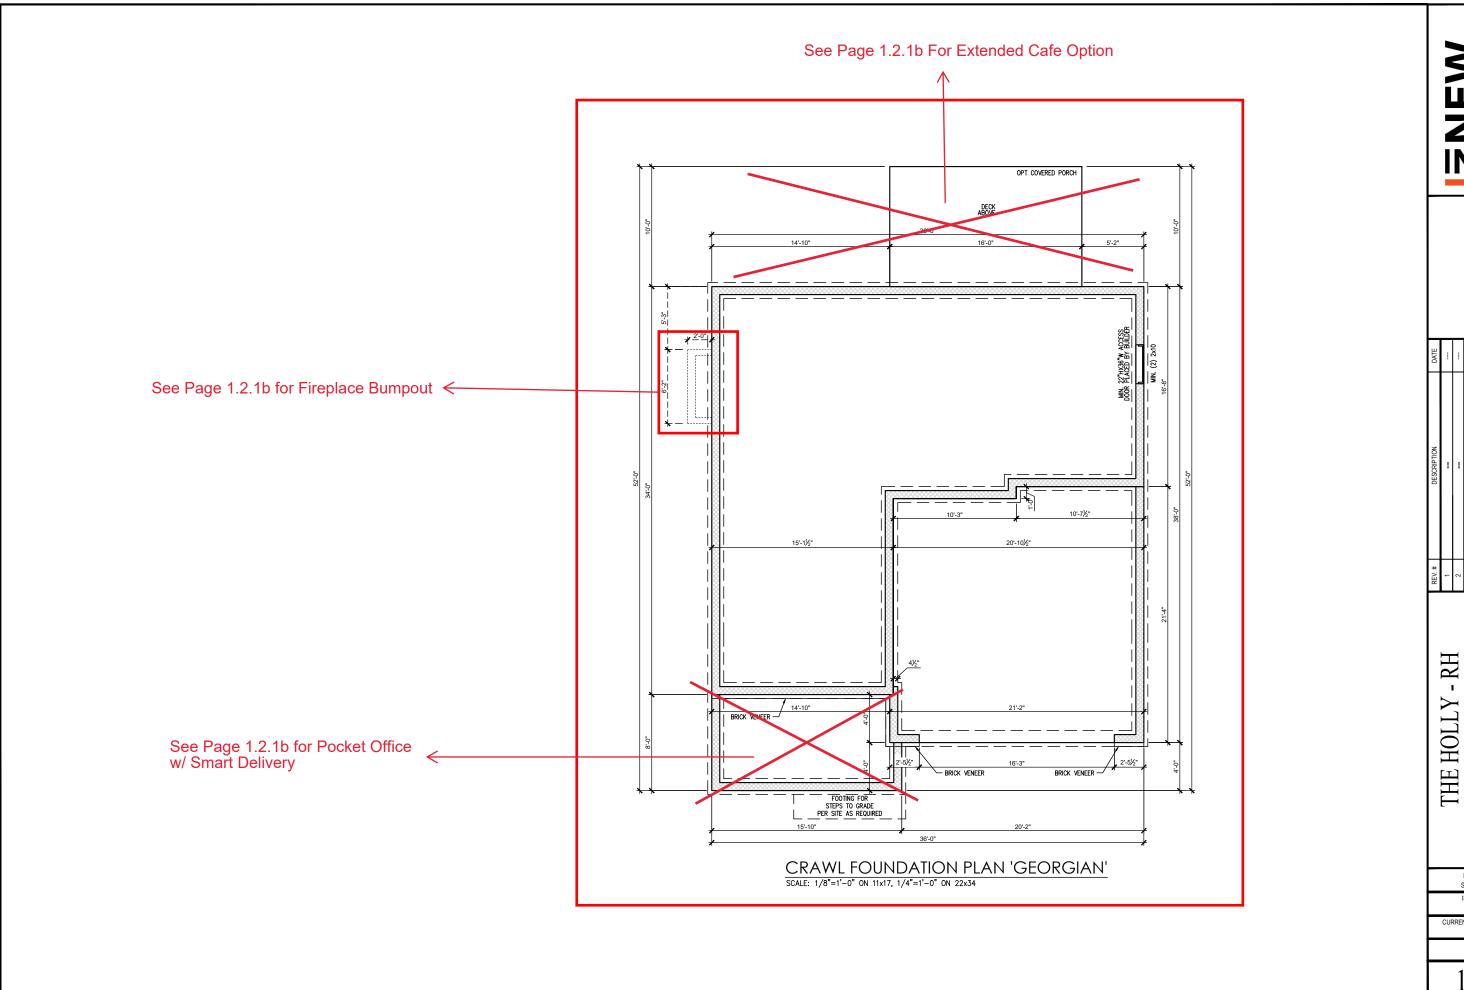
Cover Sheet 'Georgian'

-RH

THE HOLLY

DRAWN BY: South Designs ISSUE DATE: CURRENT REVISION DATE

1/8" = 1'-0"



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| DATE        |   |   | - | - | - |   |   | i |  |
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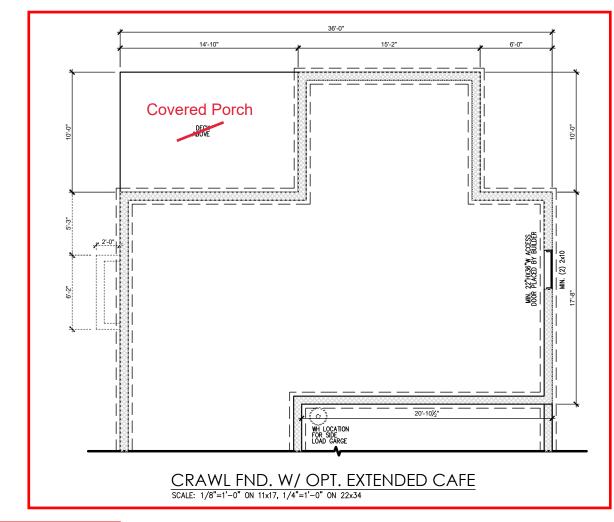
Foundation Crawl 'Georgian'


DRAWN BY: South Designs


ISSUE DATE: 7/1/2021

CURRENT REVISION DATE:
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THE HOLLY - RH
--Foundation Crawl Options 'Georgian'

DRAWN BY: South Designs

ISSUE DATE: 7/1/2021

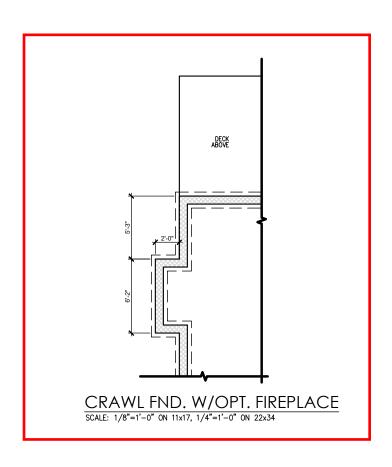
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1/8" = 1'-0"
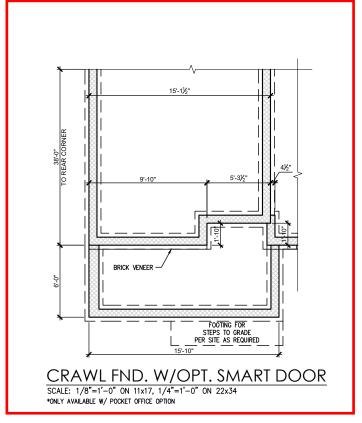
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#### **General Floor Plan Notes**

General Floor Plan Notes shall apply unless noted otherwise on plan.

- Wall Heights: Typically 9'-1 1/2" at first floor and 8'-1 you'n reignis. Typicully 7-11/2 an iss noot and 5-11/2" at second floor and affics U.N.O. All walls are constructed using a double top plate. Splices at Double Top Plate do not need to occur at Vertical Studs but must be at least 24" apart from Joint in other Top Plate layer. Special wall heights are noted on plans where they occur.
- Wall Thickness is typically 3 1/2". 2x6 frame shall be used at walls that back up to plumbing fixtures.
   Walls greater than 10' high shall be framed with 2x6 framing or greater and will be noted as a special condition where it occurs on plan.
- Typical header height shall be 6'-11" AFF at First Floor, and 6'-11" AFF at Second Floor U.N.O. on elevation drawings. Windows at front elevation may be higher at the first floor.
- 4. Jacks: Openings up to 3'-4" wide shall have (1) 2x4 jack stud SPF on each side. Openings greater than 3'-4" wide shall have (2) 2x4 jack studs SPF on each
- Soffits, Coffered Ceilings, Trey Ceilings and other significant ceiling plan elements are shown on the floor plans and are denoted as single dashed lines. Unless specifically call out as included, Kitchens do not include soffits over wall cabinetry.
- Door & Window Frames, where occurring near corners, shall be a minimum of 4 1/2" from corner. Except for walk-in closets with doors near a corner, doors at closets shall be centered on closet.
- . Windows: Shall have at least (1) window in each sleeping room, that meets egress. Shall be provided with tempered glass at hazardous glazing areas. False windows shall be installed with obscure
- Closets for clothing or coat storage shall be equipped with 1 rod/shelf. Closets for linen shall have 4 open equal shelves. Closets for pantries shall have 4 equal wood shelves, painted.
- Stair treads shall be a min of 9" deep, risers shall be a maximum of 8 1/4", unless noted otherwise, per the current North Carolina Residential Code
- the finished surface of the ramp surface of the stair. Handrails at landings and overlooks of multilevel spaces shall be 36" above finished floor. Guards (pickets or balusters) shall be spaced with no more than 4" between guards.
- Affic Access shall be provided at all affic area with a height greater than 30". Minimum clear affic access shall be 20" x 30". Pull down stairs and access doors in knee walls meeting minimum criteria are also acceptable.
- 12.Garage Door to Living Space shall be 2'-8" x 6'-8" minimum size and shall be 20 minute fire rated and
- 13. Garage Walls, as a minimum, shall be separated from living space by installing 1/2" gypsum board on the garage side of the wall. With habitable space above, the inside of all garage walls require 1/2" GWB supporting 5/8" type X GWB on ceiling.



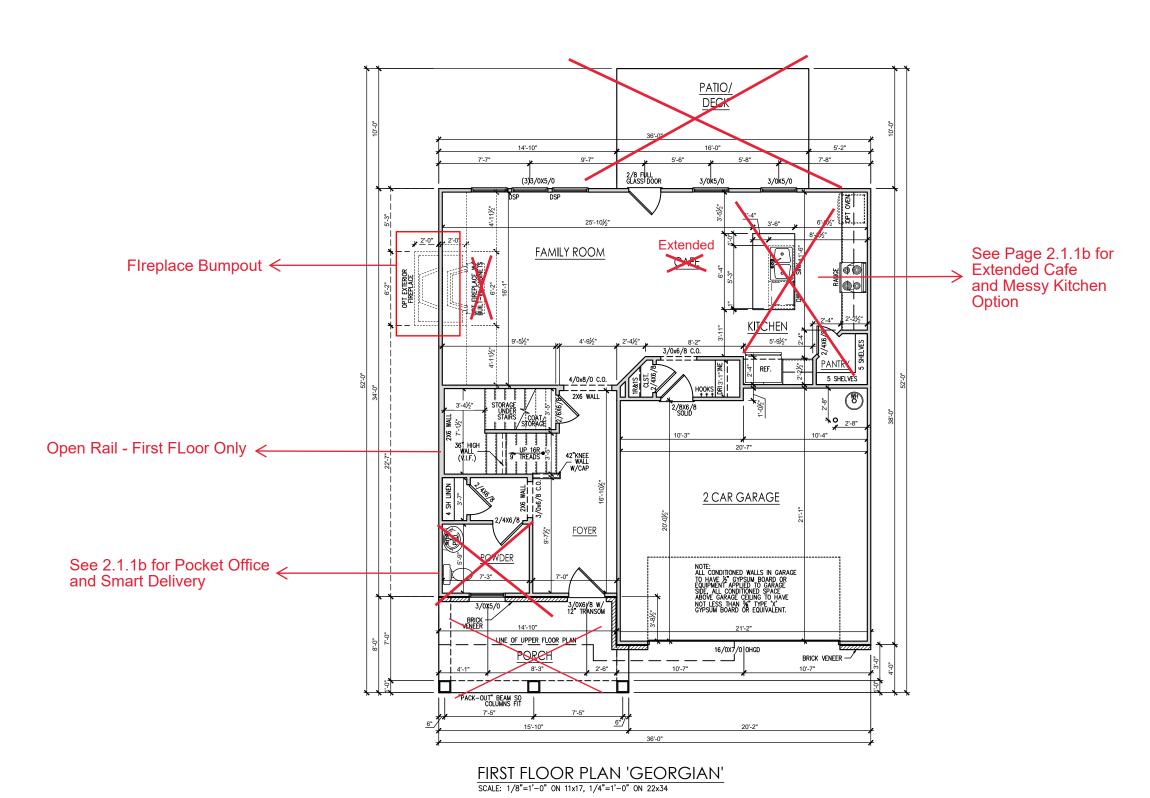

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|             |   |   |   |   |   |   |   |   |

First Floor Plan 'Georgian' THE HOLLY

-RH

DRAWN BY: South Designs

ISSUE DATE: 7/1/2021

CURRENT REVISION DATE: 1/8" = 1'-0"

#### Vaulted Ceiling at **General Floor Plan Notes** Extended Cafe General Floor Plan Notes shall apply Adding sink at Messy Kitchen unless noted otherwise on plan. Wall Heights: Typically 9'-1 1/2" at first floor and 8'-1 1/2" at second floor and attics U.N.O. All walls are constructed using a double top plate. Splices at Double Top Plate do not need to occur at Vertical Studs but must be at least 24" apart from Joint in other Top Plate layer. Special wall heights are noted (3)3/0x5/0 on plans where they occur. Covered Wall Thickness is typically 3 1/2". 2x6 frame shall be used at walls that back up to plumbing fixtures. Walls greater than 10' high shall be framed with 2x6 framing or greater and will be noted as a special condition where it occurs on plan. CAFE PATIO/ DECK OPT. VAULTED CEILING <u>FOYER</u> Typical header height shall be 6'-11" AFF at First Floor, and 6'-11" AFF at Second Floor U.N.O. on elevation drawings. Windows at front elevation may be higher at the first floor. Door at Pantry 4. Jacks: Openings up to 3'-4" wide shall have (1) 2x4 jack stud SPF on each side. Openings greater than 3'-4" wide shall have (2) 2x4 jack studs SPF on each 3/0X6/8 W/ 12" TRANSOM 2'-6" 2'-6" Soffits, Coffered Ceilings, Trey Ceilings and other significant ceiling plan elements are shown on the floor plans and are denoted as single dashed lines. Unless specifically call out as included, Kitchens do POCKET FAMILY ROOM not include soffits over wall cabinetry. **OFFICE** Fireplace Door & Window Frames, where occurring near corners, shall be a minimum of 4 1/2" from corner. Except for walk-in-closets with doors near a corner, doors at closets shall be centered on closet. Bumpout 2'-6" . Windows: Shall have at least (1) window in each 5 SHELVES sleeping room, that meets egress. Shall be provided with tempered glass at hazardous glazing areas. False windows shall be installed with obscure PORCH Closets for clothing or coat storage shall be equipped with 1 rod/shelf. Closets for linen shall have 4 open equal shelves. Closets for pantries shall have 4 equal wood shelves, painted. 4/0x8/0 C.O. Stair treads shall be a min of 9" deep, risers shall be a maximum of 8 1/4", unless noted otherwise, per the current North Carolina Residential Code STORAGE UNDER STAIRS OPT. POCKET OFFICE the finished surface of the ramp surface of the stair. Handrails at landings and overlooks of multilevel spaces shall be 36" above finished floor. Guards W/SMART DOOR DELIVERY CENTER (pickets or balusters) shall be spaced with no more than 4" between guards. SCALE: 1/8"=1'-0" ON 11x17, 1/4"=1'-0" ON 22x34 OPT. EXTENDED CAFE 11. Attic Access shall be provided at all attic area with a height greater than 30". Minimum clear attic access shall be 20" x 30". Pull down stairs and access doors in knee walls meeting minimum criteria are also acceptable. SCALE: 1/8"=1'-0" ON 11x17, 1/4"=1'-0" ON 22x34 **Gourmet Kitchen** 12.Garage Door to Living Space shall be 2'-8" x 6'-8" minimum size and shall be 20 minute fire rated and 13. Garage Walls, as a minimum, shall be separated from living space by installing 1/2" gypsum board on the garage side of the wall. With habitable space above, the inside of all garage walls require 1/2" GWB supporting 5/8" type X GWB on ceiling.

First Floor Plan Options 'Georgian'

-RH

THE HOLLY


DRAWN BY: South Designs ISSUE DATE: 7/1/2021 CURRENT REVISION DATE:

1/8" = 1'-0"

#### **General Floor Plan Notes**

General Floor Plan Notes shall apply unless noted otherwise on plan.


- Wall Heights: Typically 9"-1 1/2" at first floor and 8"-1 1/2" at second floor and attics U.N.O. All walls are constructed using a double top plate. Splices at Double Top Plate do not need to occur at Vertical Studs but must be at least 24" apart from Joint in other Top Plate layer. Special wall heights are noted on plans where they occur.
- Wall Thickness is typically 3 1/2". 2x6 frame shall be used at walls that back up to plumbing fixtures.
   Walls greater than 10' high shall be framed with 2x6 framing or greater and will be noted as a special condition where it occurs on plan.
- Typical header height shall be 6'-11" AFF at First Floor, and 6'-11" AFF at Second Floor U.N.O. on elevation drawings. Windows at front elevation may be higher at the first floor.
- Jacks: Openings up to 3'-4" wide shall have (1) 2x4
  jack stud SPF on each side. Openings greater than
  3'-4" wide shall have (2) 2x4 jack studs SPF on each
  side.
- Soffits, Coffered Ceilings, Trey Ceilings and other significant ceiling pian elements are shown on the floor pians and are denoted as single dashed lines. Unless specifically call out as included, Kitchens do not include soffits over wall cabinety.
- Door & Window Frames, where occurring near corners, shall be a minimum of 4 1/2" from corner. Except for walk-in closets with doors near a corner, doors at closets shall be centered on closet.
- Windows: Shall have at least (1) window in each sleeping room, that meets egress. Shall be provided with tempered glass at hazardous glazing areas. False windows shall be installed with obscure glazing.
- Closets for clothing or coat storage shall be equipped with 1 rod/shelf. Closets for linen shall have 4 open equal shelves. Closets for pontries shall have 4 equal wood shelves, painted.
- Stair treads shall be a min of 9" deep, risers shall be a maximum of 8 1/4", unless noted otherwise, per the current North Carolina Residential Code
- 10. Handrails and Guards at stairs shall be 34" above the finished surface of the ramp surface of the stair. Handrails at landings and overlooks of multilevel spaces shall be 36" above finished floor. Guards (pickets or balusters) shall be spaced with no more than 4" between guards.
- 11. Attic Access shall be provided at all attic area with a height greater than 30". Minimum clear attic access shall be 20" x 30". Pull down stairs and access doors in knee walls meeting minimum criteria are also acceptable.
- 12. Garage Door to Living Space shall be 2'-8" x 6'-8" minimum size and shall be 20 minute fire rated and weather sealed.
- 13. Garage Walls, as a minimum, shall be separated from living space by installing 1/2" gypsum board on the garage side of the wall. With habitable space above, the inside of all garage walls require 1/2" GWB supporting 5/8" type X GWB on ceiling.

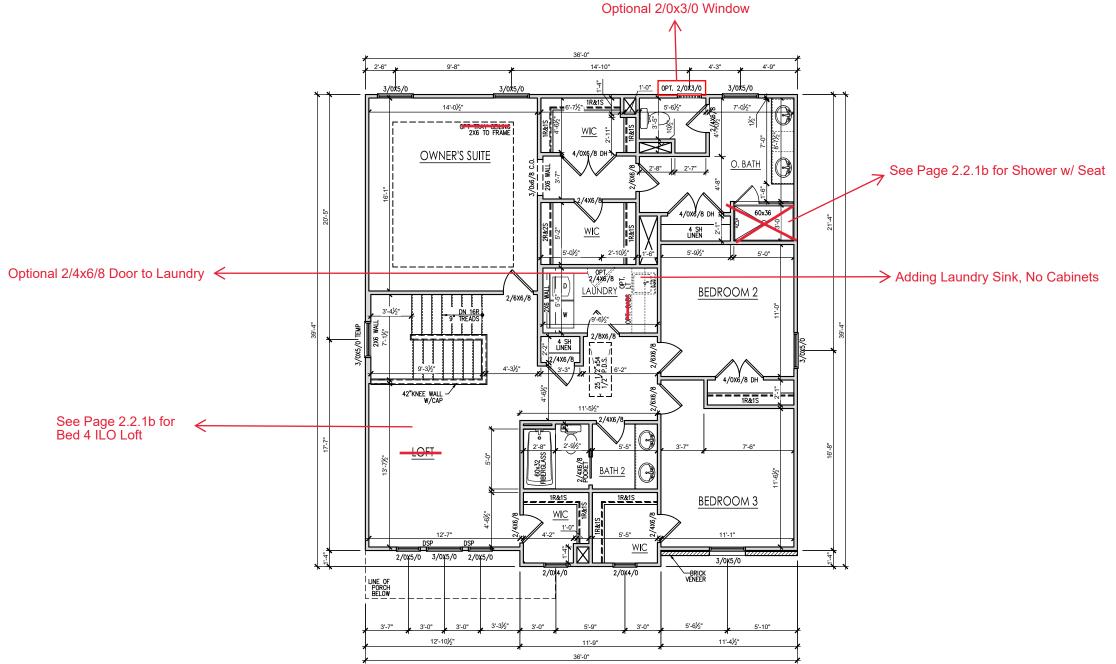

SECOND FLOOR PLAN 'GEORGIAN'

SCALE: 1/8"=1'-0" ON 11x17, 1/4"=1'-0" ON 22x34



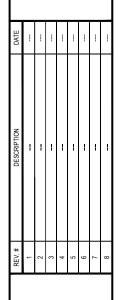

'Georgian'

Plan

Second Floor

RH

HOLLY

THE

DRAWN BY: South Designs

ISSUE DATE: 7/1/2021 CURRENT REVISION DATE

SCALE: 1/8" = 1'-0"


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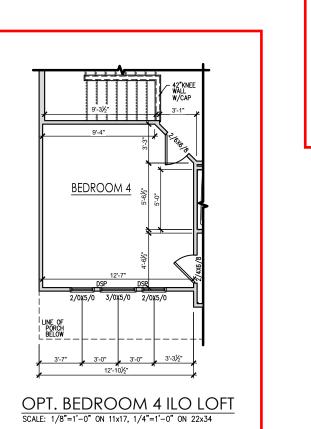
#### **General Floor Plan Notes**

General Floor Plan Notes shall apply unless noted otherwise on plan.

- Wall Heights: Typically 9'-1 1/2" at first floor and 8'-1 you'n reignis. Typicully 7-11/2 an iss noot and 5-11/2" at second floor and affics U.N.O. All walls are constructed using a double top plate. Splices at Double Top Plate do not need to occur at Vertical Studs but must be at least 24" apart from Joint in other Top Plate layer. Special wall heights are noted on plans where they occur.
- Wall Thickness is typically 3 1/2". 2x6 frame shall be used at walls that back up to plumbing fixtures. Walls greater than 10' high shall be framed with 2x6 framing or greater and will be noted as a special condition where it occurs on plan.
- Typical header height shall be 6'-11" AFF at First Floor, and 6'-11" AFF at Second Floor U.N.O. on elevation drawings. Windows at front elevation may be higher at the first floor.
- 4. Jacks: Openings up to 3'-4" wide shall have (1) 2x4 jack stud SPF on each side. Openings greater than 3'-4" wide shall have (2) 2x4 jack studs SPF on each
- Soffits, Coffered Ceilings, Trey Ceilings and other significant ceiling plan elements are shown on the floor plans and are denoted as single dashed lines. Unless specifically call out as included, Kitchens do not include soffits over wall cabinetry.
- Door & Window Frames, where occurring near corners, shall be a minimum of 4 1/2" from corner. Except for walk-in closets with doors near a corner, doors at closets shall be centered on closet.
- 7. Windows: Shall have at least (1) window in each sleeping room, that meets egress. Shall be provided with tempered glass at hazardous glazing areas. False windows shall be installed with obscure
- Closets for clothing or coat storage shall be equipped with 1 rod/shelf. Closets for linen shall have 4 open equal shelves. Closets for panties shall have 4 equal wood shelves, painted.
- Stair treads shall be a min of 9" deep, risers shall be a maximum of 8 1/4", unless noted otherwise, per the current North Carolina Residential Code
- the finished surface of the ramp surface of the stair. Handrails at landings and overlooks of multilevel spaces shall be 36" above finished floor. Guards (pickets or balusters) shall be spaced with no more than 4" between guards.
- 11. Attic Access shall be provided at all attic area with a height greater than 30". Minimum clear attic access shall be 20" x 30". Pull down stairs and access doors in knee walls meeting minimum criteria are also acceptable.
- 12.Garage Door to Living Space shall be 2'-8" x 6'-8" minimum size and shall be 20 minute fire rated and
- 13. Garage Walls, as a minimum, shall be separated from living space by installing 1/2" gypsum board on the garage side of the wall. With habitable space above, the inside of all garage walls require 1/2" GWB supporting 5/8" type X GWB on ceiling.

# Tile Walls w/ 42"x42" Shower Pan



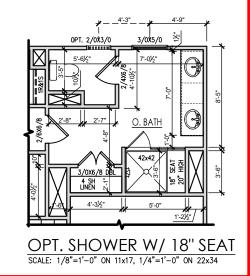

| REV.# DESCRIPTION  2 | DATE        |   |   | - |   |   |   |   |   |  |
|----------------------|-------------|---|---|---|---|---|---|---|---|--|
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Plan Options 'Georgian' -RH HOLLY THE


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Second Floor

ISSUE DATE: 7/1/2021

CURRENT REVISION DATE:

1/8" = 1'-0"

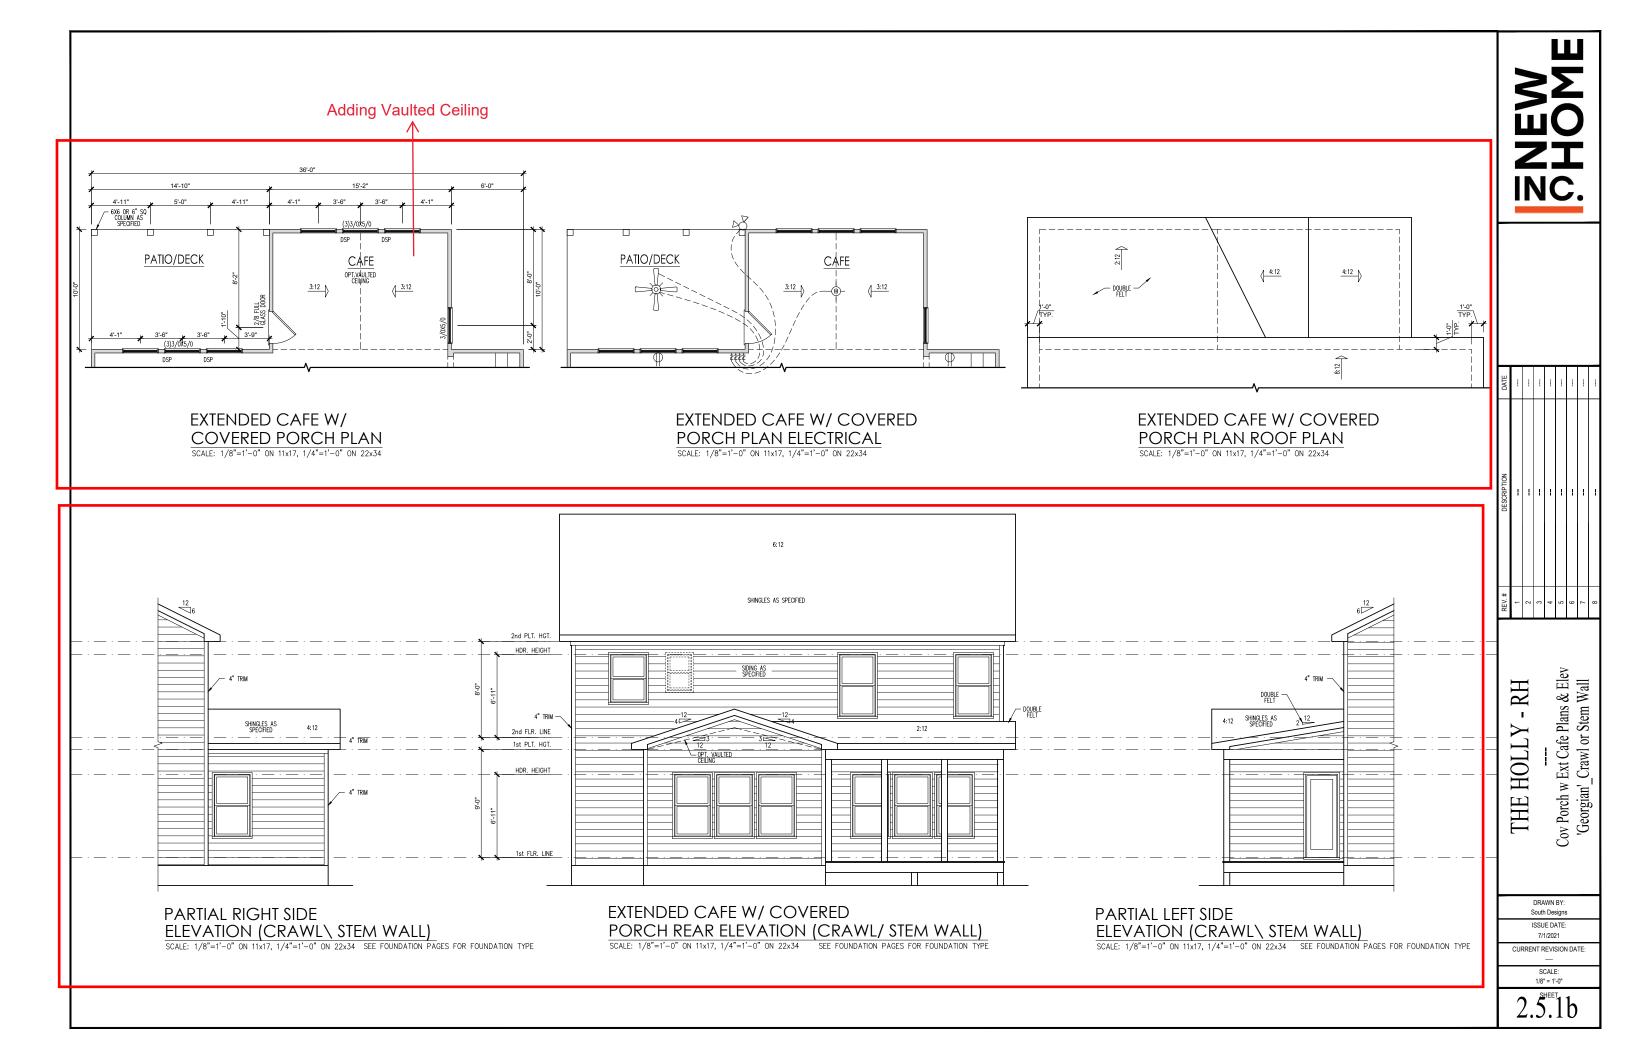

#### **General Elevation Notes**


General Elevation Notes shall apply unless noted otherwise on plan.


- Roof shall be finished with architectural composition shingles with slopes as noted on plan.
- Ridge Vent shall be provided and installed on all ridges greater than 6' in length per manufacturer's specifications.
- 3. Soffit Vent shall be continuous soffit vent
- House Wrap, "tyvek" or approved equal shall be installed over entire exterior wall per manufacturer's specifications and recommendations.
- Flashing shall be provided above all door and window openings, above finish wall material changes and at wall surfaces where lower roof areas abut vertical wall surfaces.
- Porch Railings shall be provided at all porch walking surfaces greater than 30° above adjacent finished grade. It shall be 36° high with guards spaced no more than 4" apart. Consult community specifications for material.
- Finish Wall Material shall be as noted on elevation drawings.
- 8. Brick Veneer, if included on elevation shall be tied to wall surface with galvanized corrugated metal ties at a rate of 24" oc horizontally and 16" oc verticallys so that no more than 2.67st of brick is supported by (1) tie. Space between face of wall and back face of brick shall be limited to a maximum of 1". Flashing shall be provided behind brick above all wall openings and at base of brick wall. Flashing shall be a minimum of 6-mil poly or other corrosion resistant material and shall be installed so that it laps under the house wrap material a minimum of 2".
  Weepholes shall be provided at a rate of 48" oc and shall not be less than 3/16" in diameter and shall be located immediately above flashing.
- Brick Veneer Support Lintels shall be provided if brick veneer is included on elevation. Lintels shall be provided as listed in the following schedule and shall have a minimum bearing length of 6". Masonry Lintels shall be provided so that deflection is limited to 1/AID.

Masonry Opening Lintel Schedule


Opening Size Angle

up to 4'-0" 3-1/2" x 3-1/2" x 5/16" 4'-1" to 5'-6" 4" x 3-1/2" x 5/16" LLV 5'-7" to 6'-6" 5" x 3-1/2" x 5/16" LLV 6'-7" to 8'-4" 6" x 3-1/2" x 5/16" LLV 8'-5" to 16'-4" 7" x 4" x 3/8" LLV

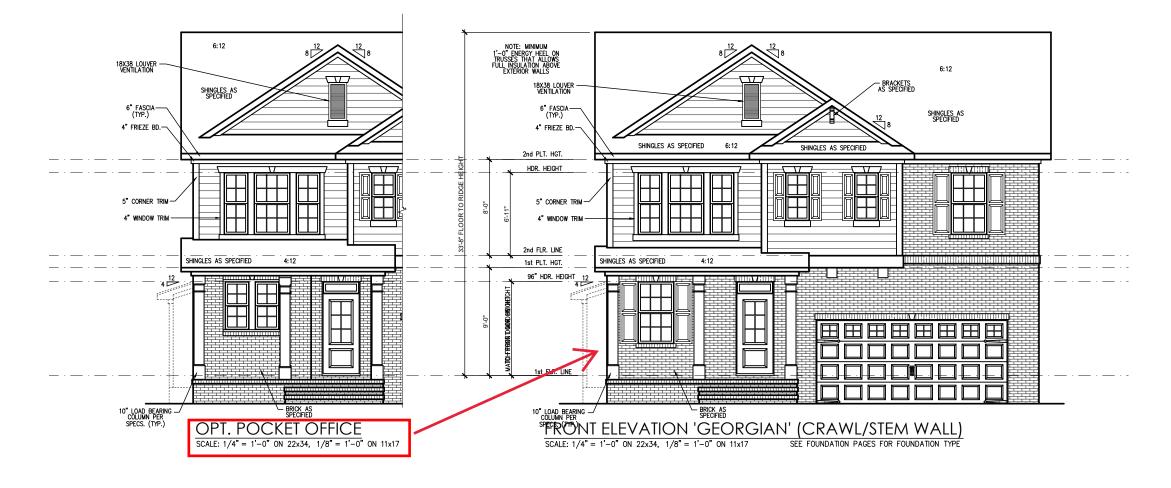

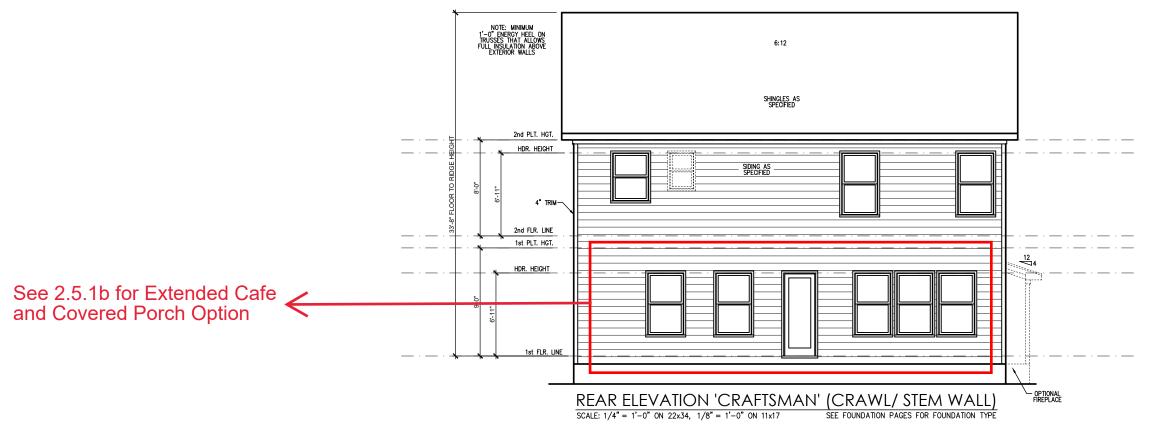



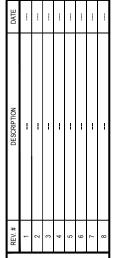

THE HOLLY - RH
--Front & Rear Elevations 'Georgian'\_Crawl or
Stem Wall

DRAWN BY: South Designs ISSUE DATE:


7/1/2021

CURRENT REVISION DATE:

SCALE: 1/8" = 1'-0"

3.1.1h

### **General Elevation Notes** General Elevation Notes shall apply unless noted otherwise on plan. Roof shall be finished with architectural composition shingles with slopes as noted on plan. Ridge Vent shall be provided and installed on all ridges greater than 6' in length per manufacturer's specifications. SHINGLES AS SPECIFIED 3. Soffit Vent shall be continuous soffit vent House Wrap, "tyvek" or approved equal shall be installed over entire exterior wall per manufacturer's specifications and recommendations. Flashing shall be provided above all door and 2nd PLT. HGT. Porch Railings shall be provided at all porch walking surfaces greater than 30" above adjacent finished HDR. HEIGHT Finish Wall Material shall be as noted on elevation SIDING AS SPECIFIED Brick Veneer, if included on elevation shall be tied to wall surface with galvanized corrugated metal ties at a rate of 24" oc horizontally and 16" oc vertically so 2nd FLR. LINE a rate of 24" oc horizontally and 16" oc vertically so that no more than 2.67st of brick is supported by (1) fle. Space between face of wall and back face of brick shall be limited to a maximum of 1". Flashing shall be provided behind brick above all wall openings and at base of brick wall. Flashing shall be a minimum of 6-mil poly or other corrosion resistant material and shall be installed so that it laps under the house wrap material a minimum of 2". Weepholes shall be provided at a rate of 48" oc and shall not be less than 3/16" in diameter and shall be located immediately above flashing. 1st PLT. HGT. HDR. HEIGHT Brick Veneer Support Lintels shall be provided if brick veneer is included on elevation. Lintels shall be provided as listed in the following schedule and shall have a minimum bearing length of 6". Masonry Lintels shall be provided so that deflection is limited to L/600. 1st FLR. LINE Opening Size LEFT SIDE ELEVATION 'GEORGIAN' (CRAWL/STEMWALL) up to 4'-0" 4'-1" to 5'-6" 5'-7" to 6'-6" 6'-7" to 8'-4" 8'-5" to 16'-4" 3-1/2" x 3-1/2" x 5/16" SCALE: 1/4" = 1'-0" ON 22x34, 1/8" = 1'-0" ON 11x17 SEE FOUNDATION PAGES FOR FOUNDATION TYPE SHINGLES AS SPECIFIED Side Elevations 'Georgian' Crawl or RH SIDING AS SPECIFIED 8:12 2nd PLT. HGT. HDR. HEIGHT THE HOLLY SIDING AS SPECIFIED 2nd FLR. LIN 1st PLT. HGT. 96" HDR. HEIGHT HDR. HEIGHT Fireplace Bumpout DRAWN BY: South Designs ISSUE DATE: 1st FLR. LIN CURRENT REVISION DATE: RIGHT SIDE ELEVATION 'GEORGIAN' (CRAWL/STEM WALL) OPT. POCKET OFFICE 1/8" = 1'-0" SCALE: 1/4" = 1'-0" ON 22x34, 1/8" = 1'-0" ON 11x17SCALE: 1/4" = 1'-0" ON 22x34, 1/8" = 1'-0" ON 11x17 SEE FOUNDATION PAGES FOR FOUNDATION TYPE

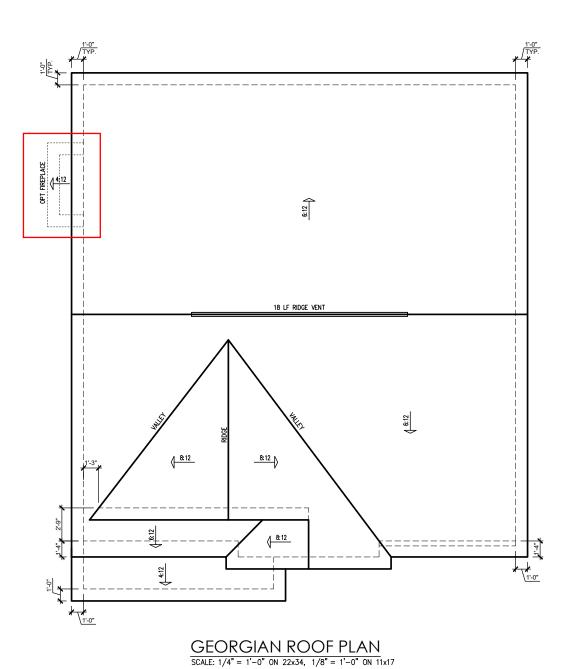

| ATTIC VENT SCHEDULE                    |            |                |          |                     |                             |                             |                                |                             |                                |  |
|--|------------|----------------|----------|---------------------|-----------------------------|-----------------------------|--------------------------------|-----------------------------|--------------------------------|--|
| GEORGIAN                               |            |                |          |                     |                             |                             |                                |                             |                                |  |
| MAIN HOUSE SQ FTG 1393 AT / NEAR RIDGE |            |                |          |                     |                             | AT / NE                     | AR EAVE                        |                             |                                |  |
| VENT TYPE                              | SQ<br>REQL | . FT.<br>JIRED | SQ. FT.  | PERCENT<br>OF TOTAL | POT LARGE<br>(SQ. FT. EACH) | POT SMALL<br>(SQ. FT. EACH) | RIDGE VENT<br>(SQ. FT. PER LF) | EAVE VENT<br>(SQ. IN. EACH) | CONT. VENT<br>(SQ. IN. PER LF) |  |
| D                                      | RAN        |                | SUPPLIED | SUPPLIED            | 0.4236                      | 0.2778                      | 0.125                          | 0.1944                      | 0.0625                         |  |
| RIDGE VENT                             | 1.86       | 2.32           | 3.00     | 44.44               | 0                           | 0                           | 24.00                          |                             |                                |  |
| SOFFIT VENTS                           | 2.79       | 2.32           | 3.75     | 55.56               |                             |                             |                                | 0                           | 60.00                          |  |
| TOTAL (MIN)                            | 4.64       | 4.64           | 6.75     | 100.00              | POT VENTS MAY BE            | E REQUIRED IF THERE         | IS INSUFFICIENT RIC            | IGE AVAILABLE               |                                |  |

\* SCHEDULE HAS BEEN CALCULATED ASSUMING EAVE VENTILATION AT 50-60% OF TOTAL AND RIDGE AT 40-50% OF TOTAL REQUIRED VENTILATION


THE HOLLY - RH
--Roof Plan 'Georgian'

DRAWN BY: South Designs


South Designs
ISSUE DATE:
7/1/2021


CURRENT REVISION DATE:
--SCALE:
1/8" = 1'-0"


3.3b

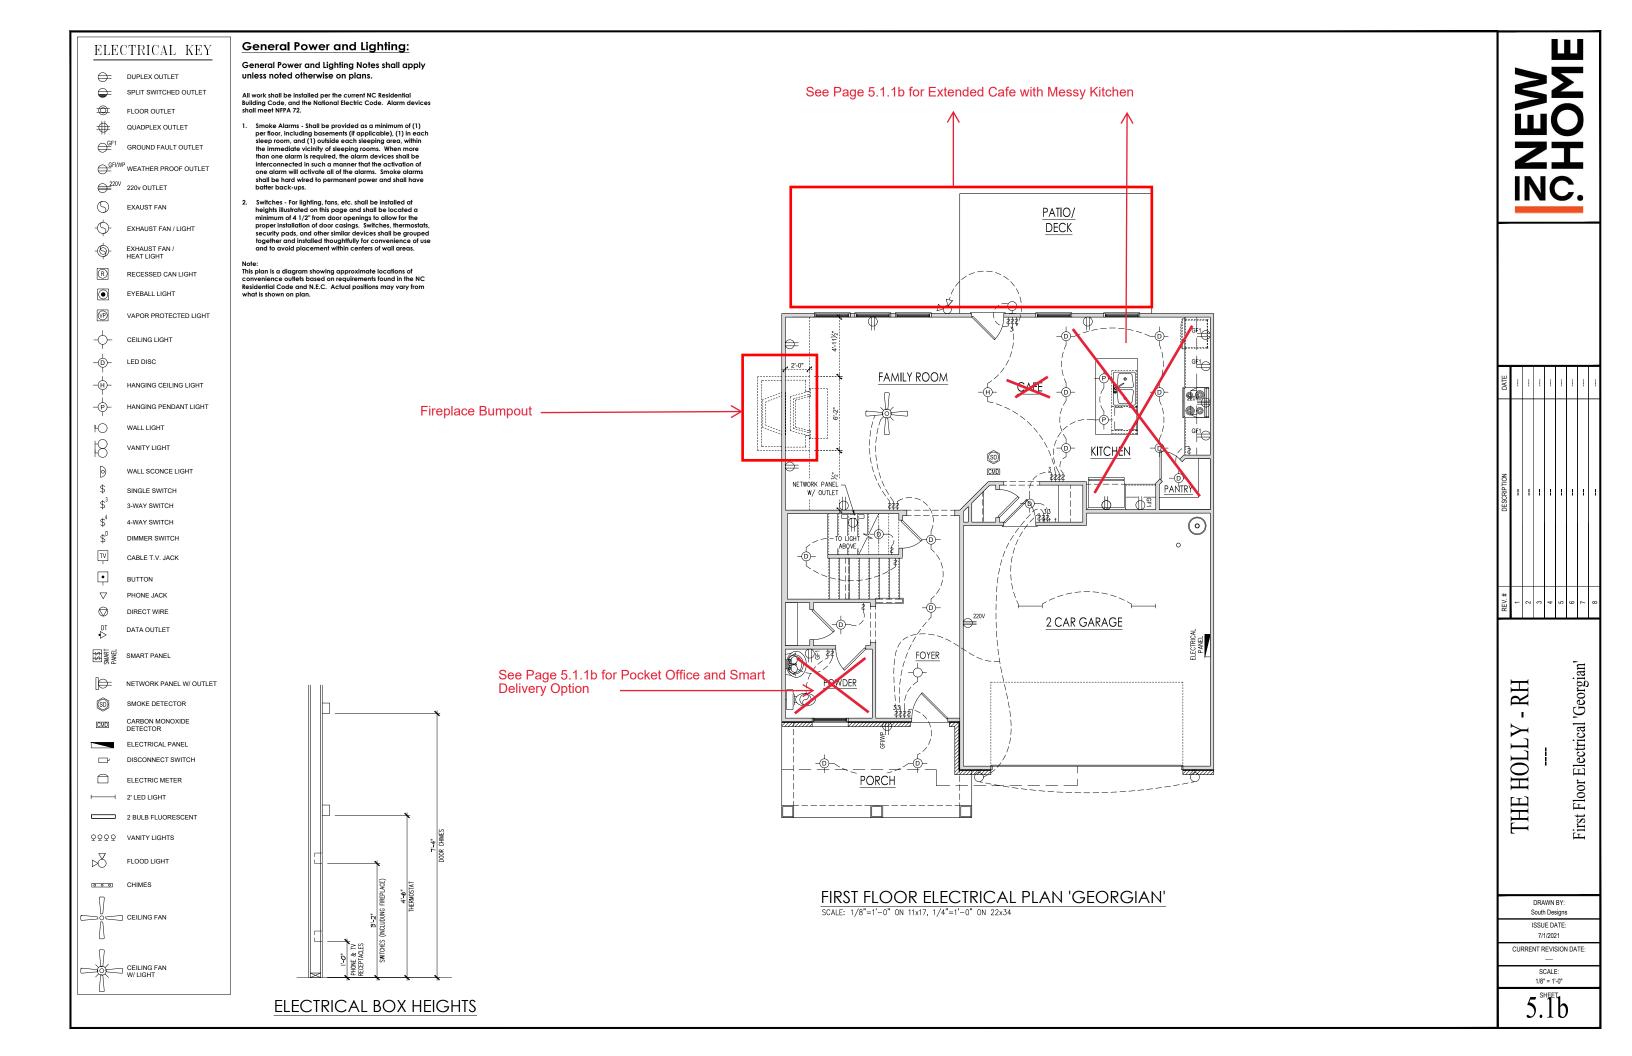


#### **General Power and Lighting:** ELECTRICAL KEY General Power and Lighting Notes shall apply DUPLEX OUTLET unless noted otherwise on plans. SPLIT SWITCHED OUTLET 0 FLOOR OUTLET # QUADPLEX OUTLET GROUND FAULT OUTLET $\bigoplus^{\mathsf{GFIWP}}\mathsf{WEATHER}\,\mathsf{PROOF}\,\mathsf{OUTLET}$ 220V OUTLET (5) EXAUST FAN **\( \)** EXHAUST FAN / LIGHT **\( \)** EXHAUST FAN / R RECESSED CAN LIGHT $\odot$ EYEBALL LIGHT (P) VAPOR PROTECTED LIGHT CEILING LIGHT <u>-(b</u>)-LED DISC HANGING CEILING LIGHT HANGING PENDANT LIGHT Ю WALL LIGHT VANITY LIGHT WALL SCONCE LIGHT SINGLE SWITCH \$<sup>3</sup> 3-WAY SWITCH 4-WAY SWITCH DIMMER SWITCH ΤV CABLE T.V. JACK · BUTTON PHONE JACK $\bigcirc$ DIRECT WIRE DATA OUTLET SMART PANEL NETWORK PANEL W/ OUTLET (SD) SMOKE DETECTOR ELECTRICAL PANEL DISCONNECT SWITCH ELECTRIC METER 2 BULB FLUORESCENT QQQQ VANITY LIGHTS FLOOD LIGHT CHIMES CEILING FAN

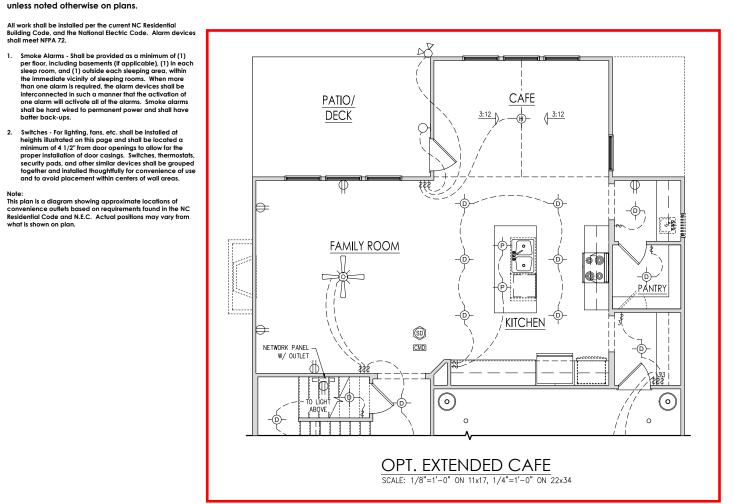

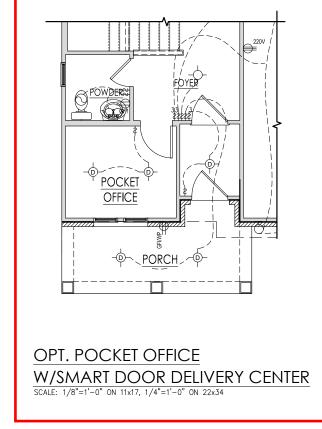

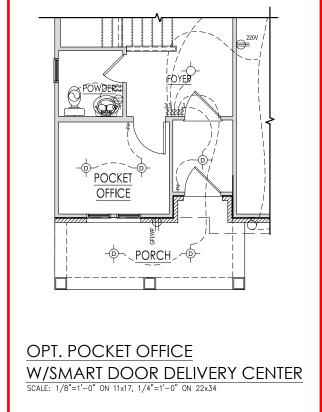

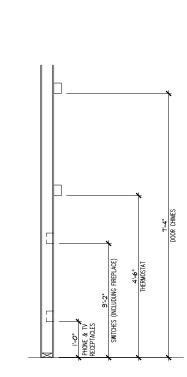


**ELECTRICAL BOX HEIGHTS** 

First Floor Options Electrical 'Georgian' RH THE HOLLY DRAWN BY: South Designs ISSUE DATE:

CURRENT REVISION DATE:

1/8" = 1'-0"

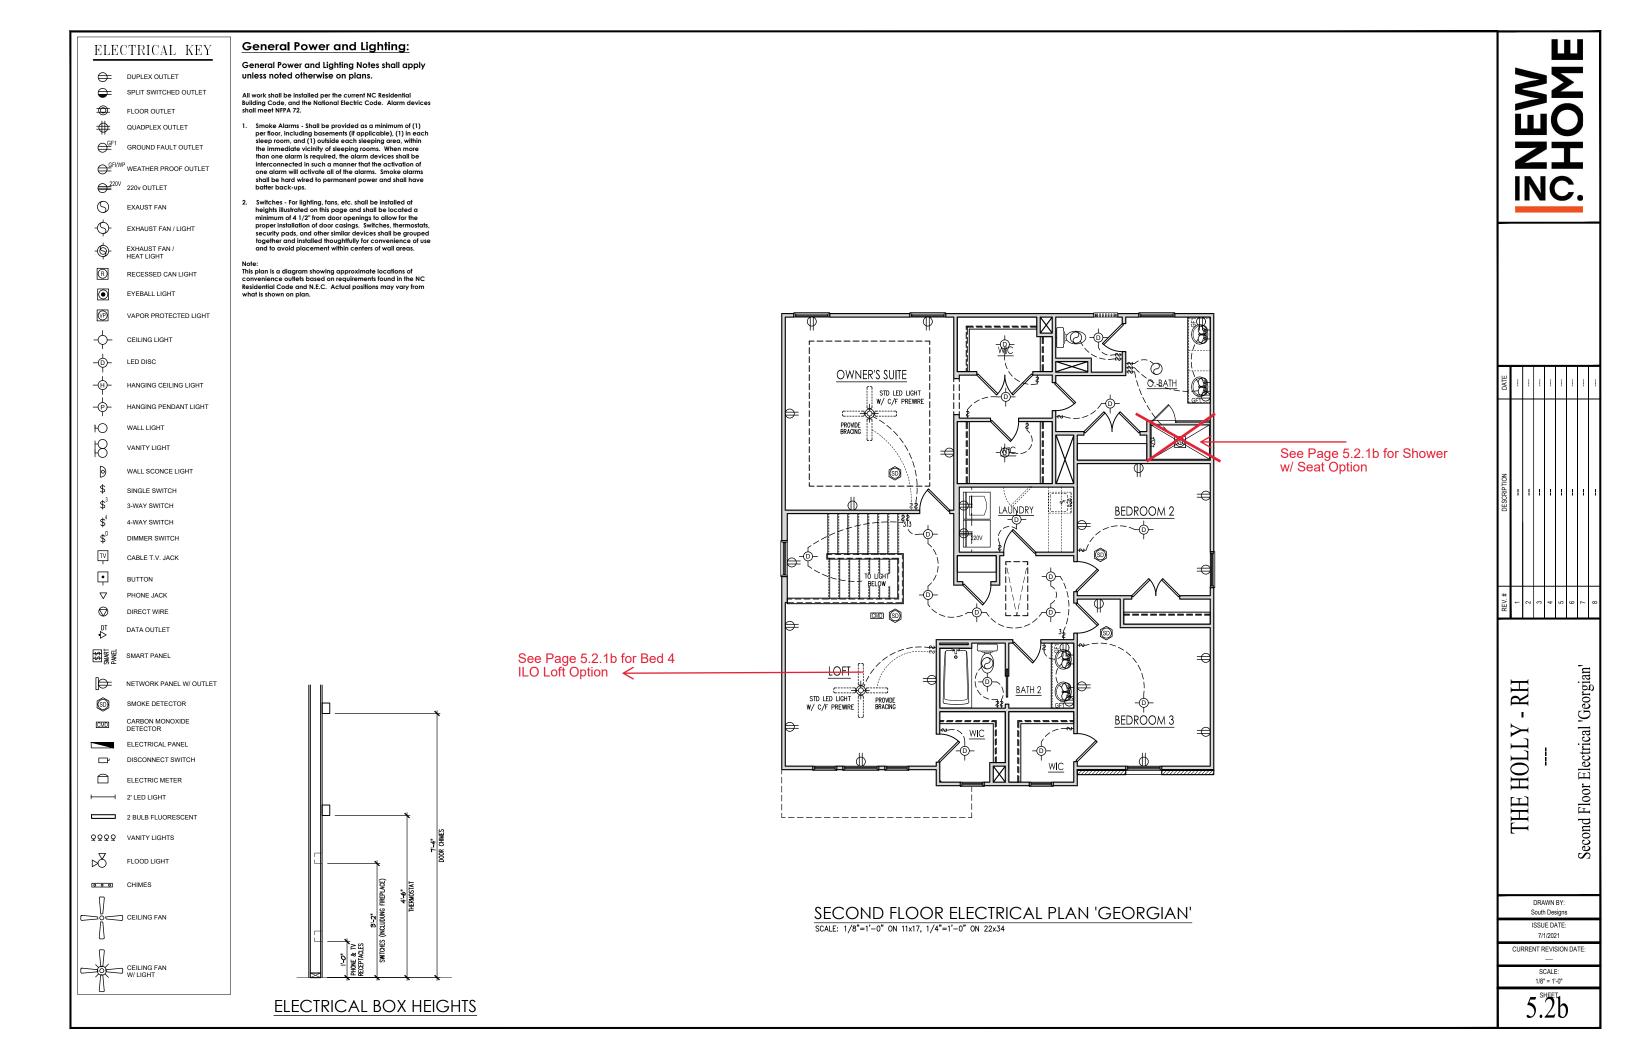

#### ELECTRICAL KEY DUPLEX OUTLET SPLIT SWITCHED OUTLET **O** FLOOR OUTLET # QUADPLEX OUTLET GROUND FAULT OUTLET GFIWP WEATHER PROOF OUTLET 220V 220v OUTLET 9 EXAUST FAN EXHAUST FAN / LIGHT **\( \)** EXHAUST FAN / HEAT LIGHT ${\Bbb R}$ RECESSED CAN LIGHT $\odot$ EYEBALL LIGHT (P) VAPOR PROTECTED LIGHT CEILING LIGHT <del>-</del>--LED DISC HANGING CEILING LIGHT HANGING PENDANT LIGHT Ю WALL LIGHT VANITY LIGHT 9 WALL SCONCE LIGHT \$ SINGLE SWITCH \$<sup>3</sup> 3-WAY SWITCH \$<sup>4</sup> 4-WAY SWITCH \$<sup>D</sup> DIMMER SWITCH ŢΫ CABLE T.V. JACK · BUTTON PHONE JACK DIRECT WIRE DT DATA OUTLET SMART PANEL NETWORK PANEL W/ OUTLET (SD) SMOKE DETECTOR ELECTRICAL PANEL DISCONNECT SWITCH ELECTRIC METER ── 2' LED LIGHT 2 BULB FLUORESCENT QQQQ VANITY LIGHTS FLOOD LIGHT O O CHIMES CEILING FAN


#### **General Power and Lighting:**


General Power and Lighting Notes shall apply unless noted otherwise on plans.


All work shall be installed per the current NC Residential Building Code, and the National Electric Code. Alarm devices shall meet NFPA 72.

- Smoke Alarms Shall be provided as a minimum of (1)
  per floor, including basements (if applicable), (1) in each
  sleep room, and (1) outside each sleeping area, within
  the immediate vicinity of sleeping rooms. When more
  than one alarm is required, the alarm devices shall be
  interconnected in such a manner that the activation of
  one alarm will activate all of the alarms. Smoke alarms
  shall be hard wired to permanent power and shall have
  batter back-ups.
- Switches For lighting, fans, etc. shall be installed at heights illustrated on this page and shall be located a minimum of 4 1/2" from door openings to allow for the proper installation of door casings. Switches, thermostats, security pads, and other similar devices shall be grouped together and installed thoughtfully for convenience of use and to avoid placement within centers of wall areas.

Note:
This plan is a diagram showing approximate locations of convenience outlets based on requirements found in the NC Residential Code and N.E.C. Actual positions may vary from

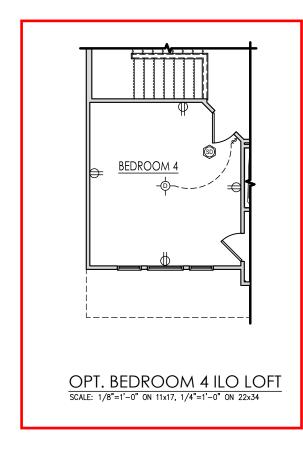


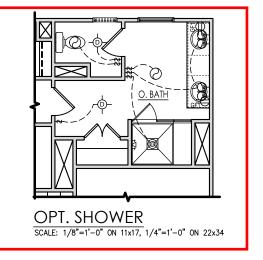

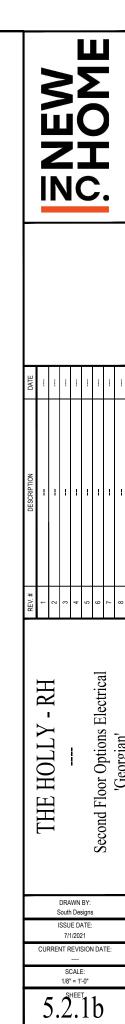



**ELECTRICAL BOX HEIGHTS** 

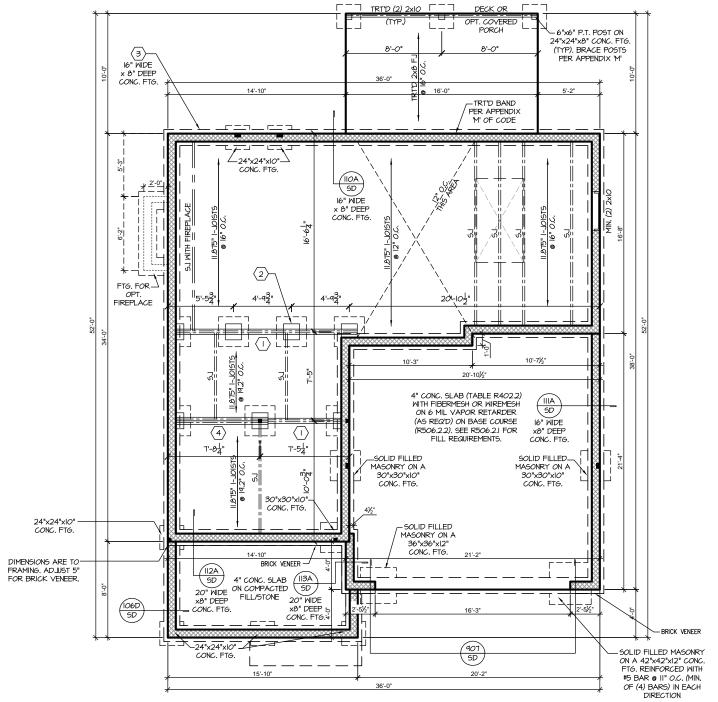

## CRAWL FOUNDATION PLAN 'GEORGIAN'

SCALE: 1/8"=1'-0" ON 11x17, 1/4"=1'-0" ON 22x34

#### TRUSS SYSTEM REQUIREMENTS NC (2018 NCRC): Wind: 115-120 mph

- TRUSS SYSTEM LAYOUTS (PLACEMENT PLANS) SHALL BE DESIGNED IN ACCORDANCE WITH SEALED STRUCTURAL PLANS. ANY NEED TO CHANGE TRUSSES SHALL BE COORDINATED WITH SOUTHERN
- TRUSS SCHEMATICS (PROFILES) SHALL BE 2. PREPARED AND SEALED BY TRUSS MANUFACTURER.
- ALL TRUSSES SHALL BE DESIGNED FOR BEARING ON SPF #2 OR #3 PLATES OR LEDGERS (UNO).
- ALL REQUIRED ANCHORS FOR TRUSSES DUE TO UPLIET OR BEARING SHALL MEET THE REQUIREMENTS AS SPECIFIED ON THE TRUSS SCHEMATICS.

#### MOOD "I" JOISTS

(SHALL BE ONE OF THE FOLLOWING):

TJI 210 BY TRUS JOIST

- LPI 20 PLUS BY LP BCI 5000s I.8 BY BC
- ALL WOOD "I"JOISTS SHALL BE INSTALLED ACCORDING TO MANUFACTURER'S SPECIFICATIONS.
- INSTALL SQUASH BLOCKS, WEB STIFFENERS, ETC. AS REQUIRED BY AND ACCORDING TO THE I-JOIST MANUFACTURER'S SPECIFICATIONS AND INSTRUCTIONS.
- HANGERS FOR I-JOISTS ARE THE RESPONSIBILITY OF THE I-JOIST SUPPLIER.
- FLOOR TRUSSES BY MANUFACTURER MAY BE

#### FOUNDATION STRUCTURAL NOTES NC (2018 NCRC): Wind: 115-120 mph - CRAWL

(I.) (3)2xIO SYP#2 OR SPF#2 GIRDER, TYPICAL UNO

2> CONCRETE BLOCK PIER SIZE SHALL BE: HOLLOW <u>SOLID</u> UP TO 5'-0" SIZE UP TO 32" 8xl6 UP TO 48" UP TO 9'-0' 12x16 UP TO 64" 24×24 UP TO 96"

WITH 30" x 30" x 10" CONCRETE FOOTING, UNO.

(3) WALL FOOTING AS FOLLOWS 8" - UP TO 2 STORY 10" - 3 STORY

16" - UP TO 2 STORY 20" - 3 STORY BRICK: 16" - I STORY 20" - 2 STORY 24" - 3 STORY

- FOR FOUNDATION WALL HEIGHT AND BACKFILL REQUIREMENTS, REFER TO CODE TABLE R404.I.I (I THRU 4) NOTE: ASSUMED SOIL BEARING CAPACITY = 2000 PSF. CONTRACTOR MUST VERIFY SITE CONDITIONS AND CONTACT SOILS ENGINEER IF MARGINAL OR UNSTABLE SOILS ARE ENCOUNTERED
- 4 (4) 2xIO SPF #2 OR SYP #2 GIRDER
- (5.) (2) 1.75x9.25 LVL OR LSL GIRDER
- 6 (3) 1.75x9.25 LVL OR LSL GIRDER
- "" DESIGNATES A SIGNIFICANT POINT LOAD TO HAVE SOLID BLOCKING TO PIER. SOLID BLOCK ALL BEAM BEARING POINTS NOTED TO HAVE THREE OR MORE STUDS TO FND, TYPICAL.
- ABBREVIATIONS:
- "SJ" = SINGLE JOIST
- "D.I" = DOUBLE JOIST "TJ" = TRIPLE JOIST
- ADJUST SUBFLOOR THICKNESS OR JOIST SPACING AS REQ'D FOR FLOOR FINISH MATERIALS.



PROJECT # 21-2816.1-RH

P.A. 27609


Southern Engineers, F 3716 Benson Drive, Raleigh, NC 2' Phone: (919) 878-1617

SOUTH DESIGNS

RH Holly HOM

Plan

REFER TO "SD" SHEET(S) FOR S-1.2 STANDARD DETAILS BRACING DETAILS AND STRUCTURAL NOTES

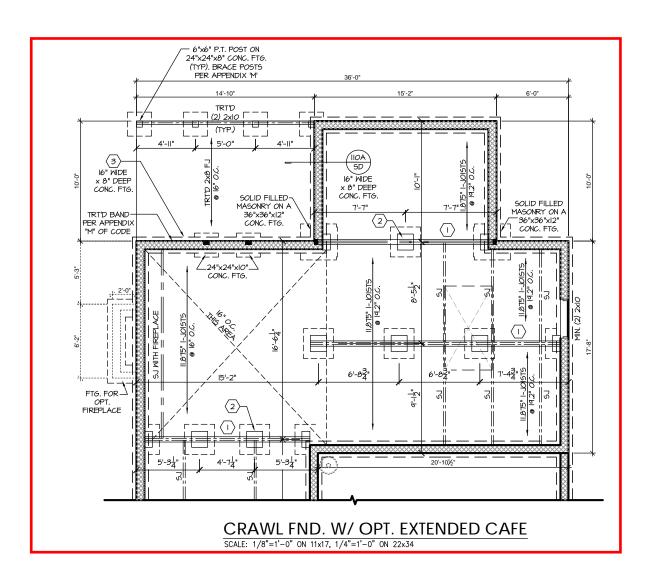



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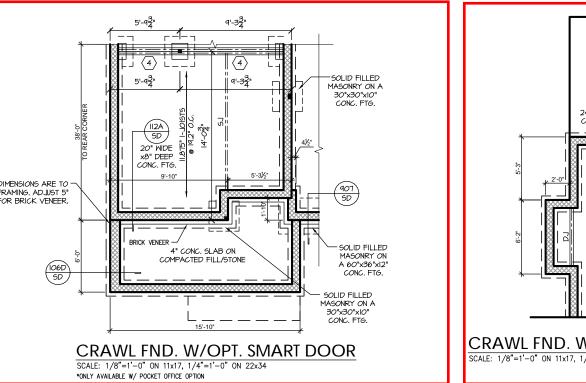
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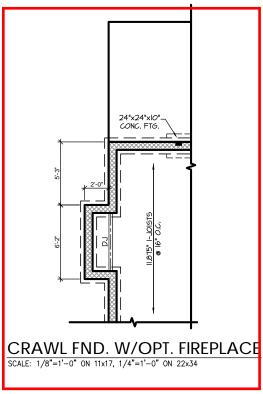
21-2816.1-RH

SOUTH DESIGNS

-RH Holly NEW HOME, Plan

REFER TO "SD" SHEET(S) FOR STANDARD DETAILS, BRACING DETAILS AND STRUCTURAL NOTES.





DIMENSIONS ARE TO -FRAMING. ADJUST 5" FOR BRICK VENEER.

FIRST FLOOR PLAN 'GEORGIAN' SCALE: 1/8"=1'-0" ON 11x17, 1/4"=1'-0" ON 22x34

PORCH HEADER

MOOD "I" JOISTS

(SHALL BE ONE OF THE FOLLOWING):

- TJI 210 BY TRUS JOIST LPI 20 PLUS BY LP
- BCI 5000s I.8 BY BC
- ALL WOOD "I"JOISTS SHALL BE INSTALLED ACCORDING TO MANUFACTURER'S SPECIFICATIONS.
- INSTALL SQUASH BLOCKS, WEB STIFFENERS, ETC. AS REQUIRED BY AND ACCORDING TO THE I-JOIST MANUFACTURER'S SPECIFICATIONS
- HANGERS FOR I-JOISTS ARE THE RESPONSIBILITY OF THE I-JOIST SUPPLIER.
- FLOOR TRUSSES BY MANUFACTURER MAY BE SUBSTITUTED FOR I-JOISTS.

#### PORCH POST NOTES:

- 4X4 (6x6) TRT'D POST (OR EQUAL).
   ATTACH TRUSSES (RAFTERS) AT PORCH WITH HURRICANE CONNECTORS.
  POST CAP: SIMPSON AC4-MAX (AC6-MAX)
- POST CAP AT CORNER: (2) SIMPSON LCE4 (MITER HEADER AT CORNER). HIGH WIND; ADD (1) SIMPSON H6.

  3. POST BASE: SIMPSON ABU44 (ABU66).
- 3. MONO: % ANCHOR (EMBED 1")
  3.2. CML: % ANCHOR (EXTEND TO FOOTING HIGH WIND ONLY)
  4. POST BASE: WOOD FOUNDATION: (2) SIMPSON
- CSI6 STRAPS AT POSTS. EXTEND 12" ONTO EACH POST (UPPER AND LOWER) OR TO GIRDER
- NOTE: THE ABOVE CONNECTORS ARE SUGGESTIONS. EQUIVALENT CONNECTORS THAT MEET THE REQUIREMENTS OF THE NC RESIDENTIAL BUILDING CODE, LOCAL CODES, AND/OR ARE APPROVED BY THE BUILDING INSPECTOR MAY BE SUBSTITUTED.

#### TRUSS SYSTEM REQUIREMENTS NC (2018 NCRC): Wind: 115-120 mph

- TRUSS SYSTEM LAYOUTS (PLACEMENT PLANS)
  SHALL BE DESIGNED IN ACCORDANCE WITH SEALED STRUCTURAL PLANS. ANY NEED TO CHANGE TRUSSES SHALL BE COORDINATED WITH SOUTHERN
- TRUSS SCHEMATICS (PROFILES) SHALL BE PREPARED AND SEALED BY TRUSS MANUFACTURER.
- ALL TRUSSES SHALL BE DESIGNED FOR BEARING ON SPF #2 OR #3 PLATES OR LEDGERS (UNO).
- ALL REQUIRED ANCHORS FOR TRUSSES DUE TO UPLIET OR BEARING SHALL MEET THE REQUIREMENTS AS SPECIFIED ON THE TRUSS SCHEMATICS

#### HEADER/BEAM & COLUMN NOTES

- ALL EXTERIOR AND LOAD BEARING HEADERS SHALL BE MIN. (2)2x6 (4" WALL) OR (3)2x6 (6' WALL) WITH (I) SUPPORT STUD, UNLESS NOTED
- 2. THE NUMBER SHOWN AT BEAM AND HEADER SUPPORTS INDICATES THE NUMBER OF SUPPORT STUDS REQUIRED IN STUD POCKET OR COLUMN. THE NUMBER OF KING STUDS AT EACH END OF HEADERS IN EXTERIOR WALLS SHALL BE ACCORDING TO ITEM "d" IN TABLE R602.3(5) OR AS BELOW PER NCDOI COMMENTARY "KING STUDS AT WALL OPENINGS" REVISED I-9-2020: UP TO 3' SPAN: (I) KING STUD
- OVER 3' UP TO 6' SPAN: (2) KING STUDS
- OVER 6' UP TO 9' SPAN: (3) KING STUDS OVER 9' UP TO 12' SPAN: (4) KING STUDS
- OVER 12' UP TO 15' SPAN: (5) KING STUDS

#### FRAMING NOTES

NC (2018 NCRC): Wind: 115-120 mph

- BRACING METHOD AND TYPE: CONTINUOUSLY SHEATHED WSP: CS-WSP. NOTE THAT THE WALL BRACING AMOUNT PROVIDED ON THE PLANS (DETAILS AND SPECIFICATIONS) IS GREATER THAN THE AMOUNT OF WALL BRACING REQUIRED BY SECTION R602.10 OF THE CODE. SEE NOTES BELOW FOR DETAILS AND SPECIFICATIONS FOR WALL BRACING AND WALL FRAMING.
- 2. EXTERIOR WALL SHEATHING: WALLS SHALL BE BRACED BY SHEATHING WALLS ON ALL STORIES WITH WOOD STRUCTURAL PANEL SHEATHING (WSP) (EXPOSURE B: 7/16". EXPOSURE C: 15/32"). SHEATHING SHALL BE ATTACHED WITH 8d NAILS AT A 6"/12" NAILING PATTERN (6" OC AT PANEL EDGES AND 12" OC AT INTERMEDIATE SUPPORTS). INSTALL BLOCKING AT ALL PANEL EDGES.
- 3. WSP SHEATHING SHALL EXTEND TO THE UPPERMOST DOUBLE BEARING PLATE, BLOCK AT ROOF PER SECTION R602.10.4.5 AND ATTACH BRACED WALLS PER CODE. WSP SHEATHING BETWEEN FLOORS SHALL BE SPLICED ALONG CONTINUOUS BAND OR THE WSP SHEATHING MAY BE SPLICED ACROSS STUDS (CONTINUOUS ACROSS FLOOR SYSTEM) WITH BLOCKING AT PANEL EDGES. (MINIMUM 12" BEYOND FLOOR BREAK) OR OTHER APPROVED METHOD.
- 4.  $\frac{\text{"HD"} = \text{HOLDOWN}.}{\text{SHALL BE AN 800 POUND CAPACITY ASSEMBLY AS NOTED ON PLANS.}}$ SEE DETAILS FOR HD ASSEMBLY.

  \*\*GROUND/FIRST FLOOR: USE "HD HOLD-DOWN DETAIL" ON SD SHEET
- \*\*UPPER FLOORS: ATTACH BASE OF KING STUD WITH A SIMPSON
- C520 OR C5HP20 STRAP DOWN ACROSS THE BAND AND DOWN TO A STUD BELOW OR HEADER BELOW. EXTEND STRAP 7" MIN ALONG EACH STUD (OR HEADER) AND ATTACH EACH END W (1) 8d NAILS.
- 5. INTERIOR BRACED WALL: (NOTED AS "IBW" ON PLANS) ATTACH I/2" GYPSIM BOARD (GB) ON EACH SIDE OF WALL WITH A MIN. OF 5d COOLER NAILS OR #6 SCREWS @ 7" O.C. ALONG THE EDGES AND AT INTERMEDIATE SUPPORTS. SEE SECTION R602.10.4.4 OF THE CODE.
- 6. INTERIOR BRACED WALL-WOOD STRUCTURAL PANEL: (NOTED AS "IBW-WSP" ON PLANS). ATTACH ONE SIDE WITH 1/6" WSP SHEATHING WITH 8d NAILS AT A 6"/12" NAILING PATTERN (6" OC AT PANEL EDGES AND 12" OC AT INTERMEDIATE SUPPORTS). INSTALL BLOCKING AT ALL PANEL EDGES. ATTACH GB OVER WSP AS REQUIRED. ATTACH OPPOSITE SIDE WITH I/2" GB WITH A MIN. OF 5d COOLER NAILS OR #6 SCREWS @  $7^{\circ}$  OC ALONG THE EDGES AND AT INTERMEDIATE SUPPORTS. SEE SECTION R602.IO.4.4 OF THE CODE.

REFER TO "SD" SHEET(S) FOR STANDARD DETAILS BRACING DETAILS AND STRUCTURAL NOTES.


PROJECT # 21-2816.1-RH

P.A. 27609 Engineers, Drive, Raleigh, NC e: (919) 878-1617 Southern Engi 3716 Benson Drive, Ra Phone: (919) 8

SOUTH DESIGNS

 $\mathbb{H}$ Holly

Plan

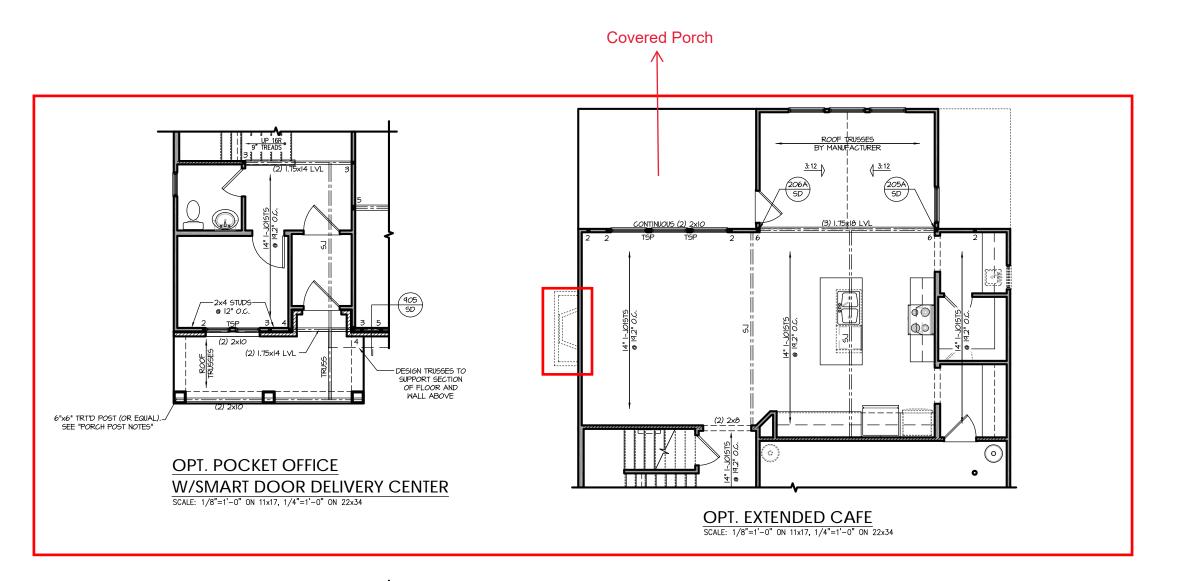



PROJECT # 21-2816.1-RH

onditions as

document.
Seal does not include construction means, methods, tech
sequences, procedures or safety precautions.
Any deviations or discrepancies on plans are to be broug
immediate attention of Southern Engineers. Failure to do
void Southern Engineers' lability.

Southern Engineers, P.A. 3716 Benson Drive, Raleigh, NC 27609 Phone: (919) 878-1617 License: C-4772

SOUTH DESIGNS

Plan 2 - The Holly -RH
NEW HOME, INC.

S-2.1.1

REFER TO "SD" SHEET(S) FOR STANDARD DETAILS, BRACING DETAILS AND STRUCTURAL NOTES. → See Page S-2.2.1 for Shower w/ Seat

SECOND FLOOR PLAN 'GEORGIAN' SCALE: 1/8"=1'-0" ON 11x17, 1/4"=1'-0" ON 22x34

TRUSS SYSTEM REQUIREMENTS NC (2018 NCRC): Wind: 115-120 mph

TRUSS SYSTEM LAYOUTS (PLACEMENT PLANS)
SHALL BE DESIGNED IN ACCORDANCE WITH SEALED STRUCTURAL PLANS. ANY NEED TO CHANGE TRUSSES SHALL BE COORDINATED WITH SOUTHERN

- TRUSS SCHEMATICS (PROFILES) SHALL BE PREPARED AND SEALED BY TRUSS MANUFACTURER.
- ALL TRUSSES SHALL BE DESIGNED FOR BEARING ON SPF #2 OR #3 PLATES OR LEDGERS (UNO).
- ALL REQUIRED ANCHORS FOR TRUSSES DUE TO UPLIET OR BEARING SHALL MEET THE REQUIREMENTS AS SPECIFIED ON THE TRUSS SCHEMATICS.

#### HEADER/BEAM & COLUMN NOTES

- I. ALL EXTERIOR AND LOAD BEARING HEADERS SHALL BE MIN. (2)2x6 (4" WALL) OR (3)2x6 (6" WALL) WITH (I) SUPPORT STUD, UNLESS NOTED
- 2. THE NUMBER SHOWN AT BEAM AND HEADER SUPPORTS INDICATES THE NUMBER OF SUPPORT STUDS REQUIRED IN STUD POCKET OR COLUMN. THE NUMBER OF KING STUDS AT EACH END OF HEADERS IN EXTERIOR WALLS SHALL BE ACCORDING TO ITEM "d" IN TABLE R602.3(5) OR AS BELOW PER NCDOI COMMENTARY "KING STUDS AT WALL OPENINGS" REVISED I-9-2020:
- UP TO 3' SPAN: (I) KING STUD OVER 3' UP TO 6' SPAN: (2) KING STUDS
- OVER 6' UP TO 9' SPAN: (3) KING STUDS OVER 9' UP TO 12' SPAN: (4) KING STUDS
- OVER 12' UP TO 15' SPAN: (5) KING STUDS

#### FRAMING NOTES

NC (2018 NCRC): Wind: 115-120 mph

- BRACING METHOD AND TYPE: CONTINUOUSLY SHEATHED WSP: CS-WSP. NOTE THAT THE WALL BRACING AMOUNT PROVIDED ON THE PLANS (DETAILS AND SPECIFICATIONS) IS GREATER THAN THE AMOUNT OF WALL BRACING REQUIRED BY SECTION R602.10 OF THE CODE. SEE NOTES BELOW FOR DETAILS AND SPECIFICATIONS FOR WALL BRACING AND WALL FRAMING.
- 2. EXTERIOR WALL SHEATHING: WALLS SHALL BE BRACED BY SHEATHING WALLS ON ALL STORIES WITH WOOD STRUCTURAL PANEL SHEATHING (MSP) (EXPOSURE B: 1/16". EXPOSURE C: 15/32"). SHEATHING SHALL BE ATTACHED WITH 8d NAILS AT A 6"/12" NAILING PATTERN (6" OC AT PANEL EDGES AND 12" OC AT INTERMEDIATE SUPPORTS). INSTALL BLOCKING AT ALL PANEL EDGES.
- 3. WSP SHEATHING SHALL EXTEND TO THE UPPERMOST DOUBLE BEARING PLATE. BLOCK AT ROOF PER SECTION R602.IO.4.5 AND ATTACH BRACED WALLS PER CODE. WSP SHEATHING BETWEEN FLOORS SHALL BE SPLICED ALONG CONTINUOUS BAND OR THE WSP SHEATHING MAY BE SPLICED ACROSS STUDS (CONTINUOUS ACROSS FLOOR SYSTEM)
  WITH BLOCKING AT PANEL EDGES. (MINIMUM 12" BEYOND FLOOR BREAK) OR OTHER APPROVED METHOD.
- 4.  $\frac{\text{"HD"} = \text{HOLDOWN}.}{\text{SHALL BE AN 800 POUND CAPACITY ASSEMBLY AS NOTED ON PLANS.}}$ SEE DETAILS FOR HD ASSEMBLY.

  \*\*GROUND/FIRST FLOOR: USE "HD HOLD-DOWN DETAIL" ON SD SHEET
- (CR EGUIV.)

  \*\*UPPER FLOORS: ATTACH BASE OF KING STUD WITH A SIMPSON CS2O OR CSHP2O STRAP DOWN ACROSS THE BAND AND DOWN TO A STUD BELOW OR HEADER BELOW. EXTEND STRAP 7\* MIN ALONG EACH STUD (OR HEADER) AND ATTACH EACH END W (1) 8d NAILS.
- 5. INTERIOR BRACED WALL: (NOTED AS "IBW" ON PLANS) ATTACH I/2" GYPSIM BOARD (GB) ON EACH SIDE OF WALL WITH A MIN. OF 5d COOLER NAILS OR #6 SCREWS @ 7" O.C. ALONG THE EDGES AND AT INTERMEDIATE SUPPORTS. SEE SECTION R602.10.4.4 OF THE CODE.
- 6. INTERIOR BRACED WALL-WOOD STRUCTURAL PANEL: (NOTED AS "IBW-WSP" ON PLANS). ATTACH ONE SIDE WITH 1/6" WSP SHEATHING WITH 8d NAILS AT A 6"/12" NAILING PATTERN (6" OC AT PANEL EDGES AND 12" OC AT INTERMEDIATE SUPPORTS). INSTALL BLOCKING AT ALL PANEL EDGES. ATTACH GB OVER WSP AS REQUIRED. ATTACH OPPOSITE SIDE WITH I/2" GB WITH A MIN. OF 5d COOLER NAILS OR #6 SCREMS @ 7" OC ALONG THE EDGES AND AT INTERMEDIATE SUPPORTS. SEE SECTION R602.10.4.4 OF THE CODE.

REFER TO "SD" SHEET(S) FOR STANDARD DETAILS BRACING DETAILS AND STRUCTURAL NOTES.

PROJECT # 21-2816.1-RH

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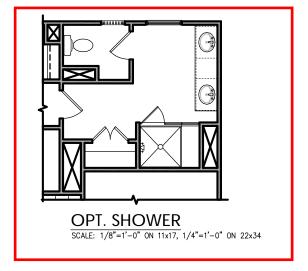
SOUTH DESIGNS

-RH Holly


S-2.2

Plan





NO STRUCTURAL CHANGES FROM BASE PLAN

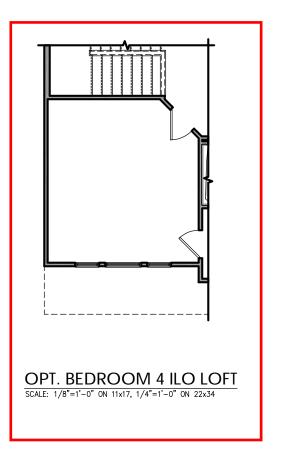


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PROJECT # 21-2816.1-RH

SOUTH DESIGNS

The Holly -RH

NEW HOME, INC. Plan

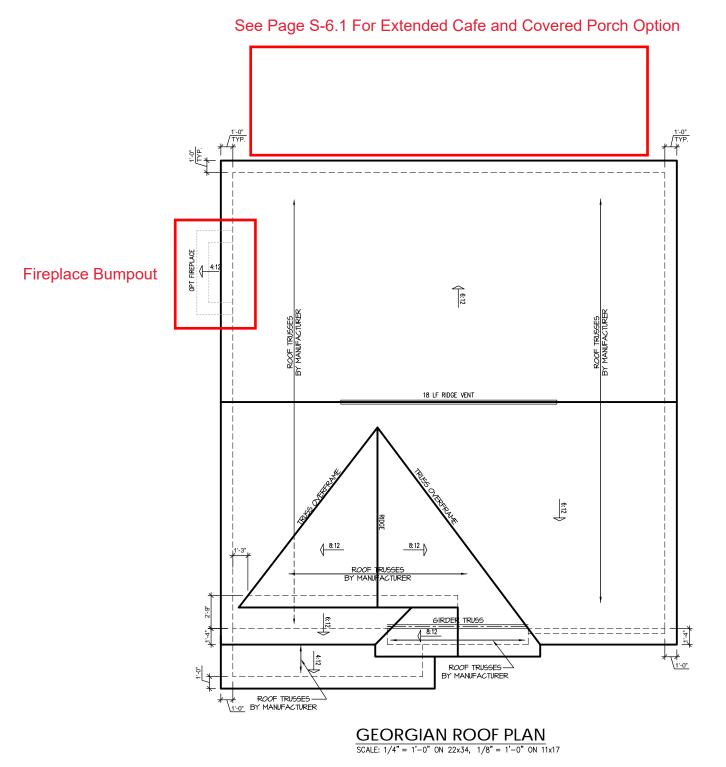

TRUSS SYSTEM REQUIREMENTS NC (2018 NCRC): Wind: 115-120 mph

- TRUSS SYSTEM LAYOUTS (PLACEMENT PLANS)
  SHALL BE DESIGNED IN ACCORDANCE WITH SEALED
  STRUCTURAL PLANS. ANY NEED TO CHANGE
  TRUSSES SHALL BE COORDINATED WITH SOUTHERN
- 2. TRUSS SCHEMATICS (PROFILES) SHALL BE PREPARED AND SEALED BY TRUSS MANUFACTURER.
- ALL TRUSSES SHALL BE DESIGNED FOR BEARING ON SPF #2 OR #3 PLATES OR LEDGERS (UNO).
- ALL REQUIRED ANCHORS FOR TRUSSES DUE TO UPLIFT OR BEARING SHALL MEET THE REQUIREMENTS AS SPECIFIED ON THE TRUSS



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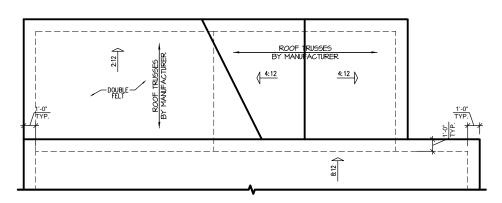
SOUTH DESIGNS

The Holly -RH

REFER TO "SD" SHEET(S) FOR STANDARD DETAILS, BRACING DETAILS AND STRUCTURAL NOTES.

Plan





EXTENDED CAFE W/ COVERED PORCH PLAN ROOF PLAN SCALE: 1/8"=1'-0" ON 11x17, 1/4"=1'-0" ON 22x34


BALLOON FRAME GABLE END
WALL WITH 2x4 STUDS AT 12"
OC. INSTALL SCIESOR TRUES
ON GABLE END.

CONTINUOUS
(2) 2x10

(3) 1.T5x18 LVL
(2) 2x10

(2) 2x10

EXTENDED CAFE W/
COVERED PORCH PLAN
SCALE: 1/8"=1'-0" ON 11x17, 1/4"=1'-0" ON 22x34

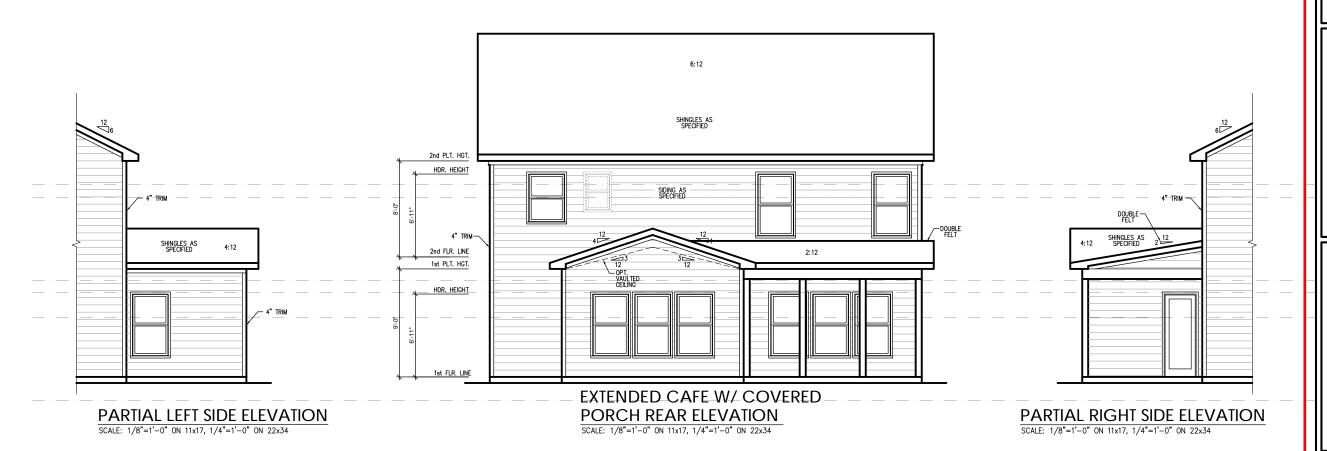

REFER TO "5D" SHEET(5) FOR STANDARD DETAILS, BRACING DETAILS AND STRICTURAL NOTES. PROJECT # 21-2816.1-RH

ipplies only to structural components on this nclude construction means, methods, techniques, edures or safety precautions.

Seal does not include construction means, methors equences, procedures or safety precautions.

Any deviations or discrepancies on plans are to immediate attention of Southern Engineers' Bailing, yold Southern Engineer's Italiality.

Is no of these plans constitutes annowal of terms


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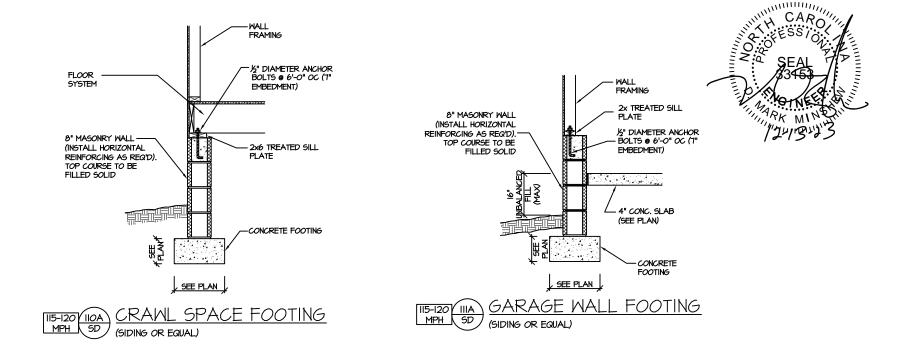
SOUTH DESIGNS


2 - The Holly -RH
NEW HOME, INC.


Plan 2 - The F

S-6.1



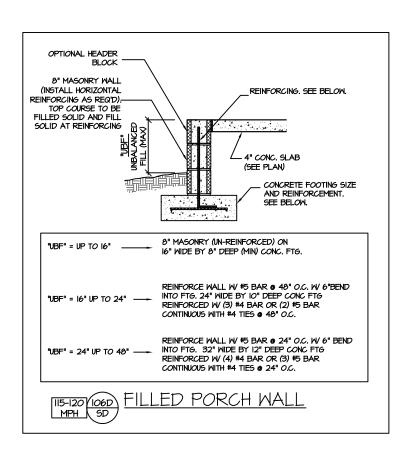

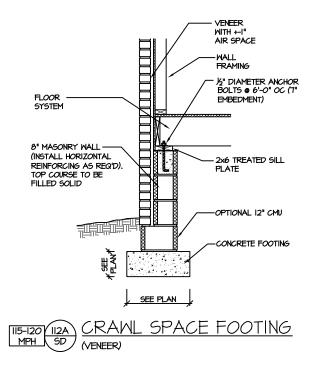

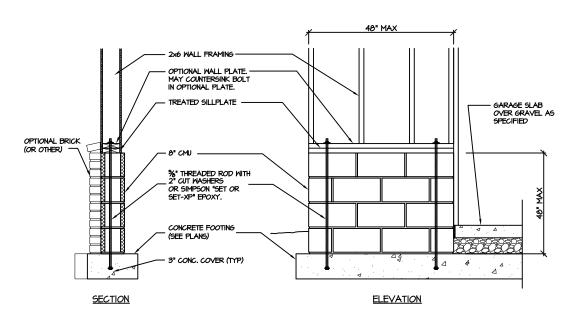

GARAGE 'WING WALL' REINFORCING PER IRC FIGURE R602.10.4.3

CRAWL SPACE FOUNDATION

PROJECT # 21-2816.1

are to be brought to the cres. Failure to do so will creater of the creater of th

I include construction means, methods, technique cocedures or safety precautions.

In or discrepancies on plans are to be brought to ttention of Southern Engineers. Failure to do so was negative experience.


eers, P.A. Seal does not include sequences, procedures sequences, procedures sequences, procedures sequences procedures sequences procedure sequencians or discontinuity of seal is solid for nonion void southern Engine

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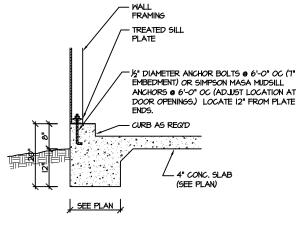
SOUTH DESIGNS

PLAN 2 - THE HOLLY
NEW HOME, INC.


SD




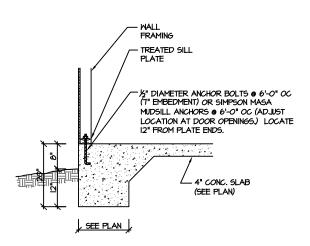






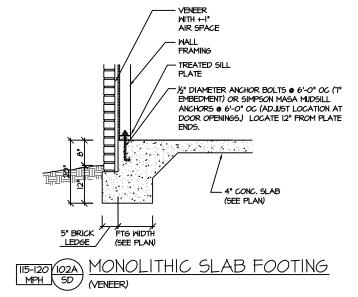

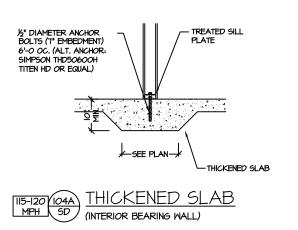

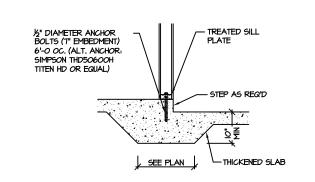



PROJECT # 21-2816.1


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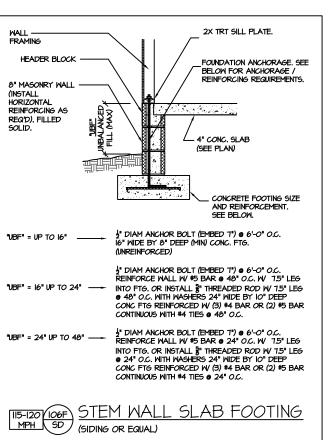
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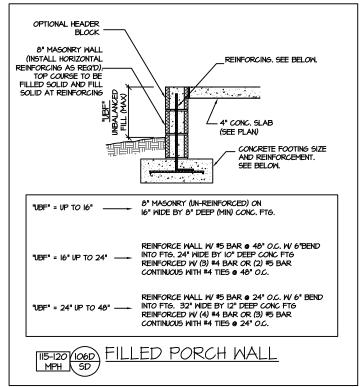
THE HOLLY NEW HOME, INC.  $\sim$ PLAN

SD


SLAB FOUNDATION







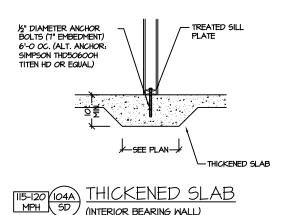




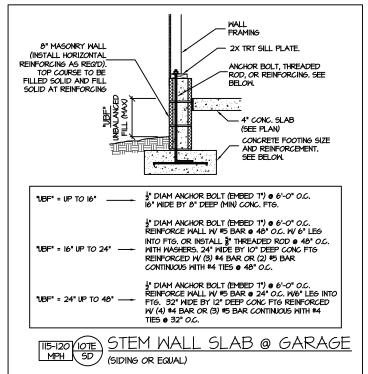

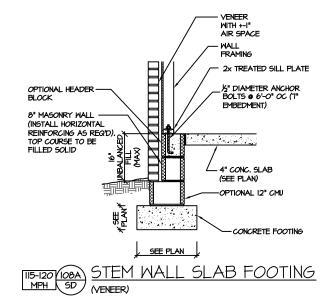

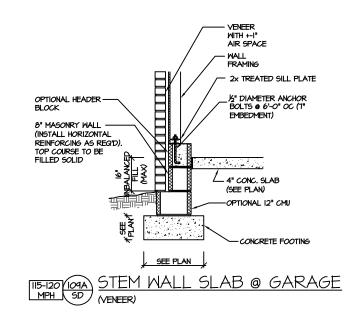

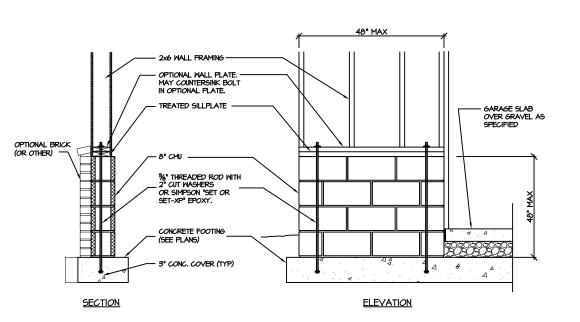

GARAGE 'WING WALL' REINFORCING PER IRC FIGURE R602.IO.4.3

STEM WALL SLAB FOUNDATION

PROJECT # 21-2816.1

P.A. 27609


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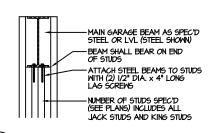
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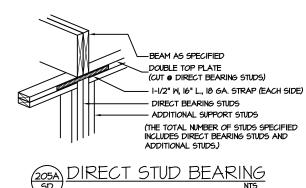
NC (2018 NCRC): Wind: 115-120 mph


- . ENGINEER'S SEAL APPLIES ONLY TO STRUCTURAL COMPONENTS INCLUDING ROOF RAFTERS, HIPS, VALLEYS, RIDGES, FLOORS, WALLS, BEAMS AND HEADERS, COLUMNS, CANTILEYERS, OFFSET LOAD BEARING WALLS, PIER & GIRDER SYSTEM, FOOTING, AND PILING SYSTEM: ENGINEER'S SEAL DOES NOT CERTIFY DIMENSIONAL ACCURACY OR ARCHITECTURAL LAYOUT INCLUDING ROOF SYSTEM, ALL REQUIREMENTS FOR PROFESSIONAL CERTIFICATION SHALL BE PROVIDED BY THE APPROPRIATE PROFESSIONAL. SOUTHERN ENGINEERS, P.A. CERTIFIES ONLY THE STRUCTURAL COMPONENTS AS SPECIFICALLY STATED.
- 2. ALL CONSTRUCTION SHALL CONFORM TO THE LATEST REQUIREMENTS OF THE 2018 NC RESIDENTIAL CODE, PLUS ALL LOCAL CODES AND REGULATIONS, THE STRUCTURAL ENGINEER IS NOT RESPONSIBLE FOR, AND MILL NOT HAVE CONTROL OF, CONSTRUCTION MEANS, METHODS, TECHNIQUES, SEQUENCES OR PROCEDURES, OR FOR SAFETY PRECAUTIONS AND PROGRAMS IN CONNECTION WITH THE CONSTRUCTION WORK, NOR WILL THE ENGINEER BE RESPONSIBLE FOR THE CONTRACTORS FAILURE TO CARRY OUT THE CONSTRUCTION WORK IN ACCORDANCE WITH THE CONTRACT DOCUMENTS, "CONSTRUCTION REVIEW" SERVICES ARE NOT PART OF OUR CONTRACT. ALL MEMBERS SHALL BE FRAMED ANCHORED, TIED AND BRACED IN ACCORDANCE WITH GOOD CONSTRUCTION PRACTICE AND THE BUILDING CODE.
- 3. DESIGN LOADS (LISTED AS: LIVE LOAD, DEAD LOAD, DEFLECTION)
- ROOMS OTHER THAN SLEEPING ROOMS: (40 PSF, IO PSF, L/360)
- SLEEPING ROOMS: (30 PSF, IO PSF, L/360)
- ATTIC WITH PERMANENT STAIR: (40 PSF, IO PSF, L/360)


  ATTIC WITHOUT PERMANENT STAIR: (20 PSF, IO PSF, L/360)
- ATTIC WITHOUT PERMANENT STAIR: (20 PSF, IO PSF, L/360)
   ATTIC WITHOUT STORAGE: (10 PSF, IO PSF, L/240)
- STAIRS: (40 PSF, IO PSF, L/360)
- DECKS AND EXTERIOR BALCONIES: (40 PSF, IO PSF, L/360)
- PASSENGER VEHICLE GARAGES: (50 PSF, IO PSF, L/360)
- SNOW: (20 PSF)
- WALLS SHALL BE BRACED BY SHEATHING WALLS ON ALL STORIES WITH WOOD STRUCTURAL PANELS. SEE FRAMING NOTES FOR THICKNESS AND NAILING REQUIREMENTS.
- 5. SEE APPENDIX M (DCA6) FOR EXTERIOR DECK REQUIREMENTS INCLUDING ATTACHMENTS FOR
- 6. CONCRETE SHALL HAVE A MINIMUM 20 DAY STRENGTH OF 3000 PSI AND A MAXIMUM SLUMP OF 5 INCHES UNLESS NOTED OTHERNISE (UNO). AIR ENTRAINED PER TABLE 402.2. ALL CONCRETE SHALL BE PROPORTIONED, MIXED, HANDLED, SAMPLED, ITESTED, AND PLACED IN ACCORDANCE WITH ACI STANDARDS. ALL SAMPLES FOR PUMPING SHALL BE TAKEN FROM THE EXIT END OF THE PIMP. CONTROL JOINTS IN SLABS SHALL BE SPACED ON A GRID OF ←30 TIMES THE DEPTH (D). CONTROL JOINTS SHALL BE SANCUT TO A DEPTH OF I/D. (I.E. 4" CONCRETE SLABS SHALL HAVE ¼" DEEP CONTROL JOINTS SANCUT IN SLAB ON A ←10~0" x ←10~0" GRID.)
- 7. ALLOWABLE SOIL BEARING PRESSURE ASSUMED TO BE 2000 PSF. THE CONTRACTOR MUST CONTACT A GEOTECHNICAL ENGINEER AND THE STRUCTURAL ENGINEER IF UNGATISFACTORY SUBSURFACE CONDITIONS ARE ENCOUNTERED. THE SURFACE AREA ADJACENT TO THE FOUNDATION WALL SHALL BIE PROVIDED WITH ADEQUATE DRAINAGE, AND SHALL BE GRADED SO AS TO DRAIN SURFACE WATER AWAY FROM FOUNDATION WALLS.
- ALL FRAMING LUMBER SHALL BE SPF #2 (Fb = 675 PSI) UNLESS NOTED OTHERWISE (UNO). ALL
  TREATED LUMBER SHALL BE SYP # 2. PLATE MATERIAL MAY BE SPF # 3 OR SYP #3 (Fc(perp) :
  475 PG 1 MIN)
- L.V.L. SHALL BE LAMINATED VENEER LUMBER: Fb=2600 PSI, Fv=285 PSI, E=1.9xI0 PSI.
   P.S.L. SHALL BE PARALLEL STRAND LUMBER: Fb=2900 PSI, Fv=290 PSI, E=2.0xI0 PSI.
   L.S.L. SHALL BE LAMINATED STRAND LUMBER: Fb=2250 PSI, Fv=400 PSI, E=1.55xI0 PSI.
   INSTALL ALL CONNECTIONS FER MANUFACTURERS INSTRUCTIONS.
- IO. ALL ROOF TRUSS AND I-JOIST LAYOUTS SHALL BE PREPARED IN ACCORDANCE WITH THE SEALED STRUCTURAL DRAWINGS, TRUSSES AND I-JOISTS SHALL BE INSTALLED ACCORDING TO THE MANUFACTURE'S SPECIFICATIONS, ANY CHANGE IN TRUSS OR I-JOIST LAYOUT SHALL BE COORDINATED WITH SOUTHERN ENGINEERS.
- II. ALL STRUCTURAL STEEL SHALL BE ASTM A-36. STEEL BEAMS SHALL BE SUPPORTED AT EACH END WITH A MINIMUM BEARING LENGTH OF 3 I/2\* INCHES AND FULL FLANGE WIDTH. PROVIDE SOLID BEARING FROM BEAM SUPPORT TO FOUNDATION. BEAMS SHALL BE ATTACHED TO EACH SUPPORT WITH TWO LAG SCREMS (I/2\* DIAMETER X 4\* LONG). LATERAL SUPPORT IS 6 ONSIDERED ADEQUIATE PROVIDING THE JOIST ARE TOE NAILED TO THE SOLE PLATE, AND SOLE PLATE IS NAILED OR BOLTED TO THE BEAM FLANGE © 48\* O.C. ALL STEEL TUBING SHALL BE ASTM A500.
- REBAR SHALL BE DEFORMED STEEL, ASTM615, GRADE 60. LAP ALL REBAR SPLICES 30 BAR DIAMETERS.
- 13. FLITCH BEAMS SHALL BE BOLTED TOGETHER USING (2) ROWS OF I/2" DIAMETER BOLTS (ASTM A325) WITH MASHERS PLACED UNDER THE THREADED END OF BOLT. BOLTS SHALL BE SPACED AT 24" O.C. (MAX), AND STAGGERED AT THE TOP AND BOTTOM OF BEAM (2" EDGE DISTANCE), WITH 2 BOLTS LOCATED AT 6" FROM EACH END.
- I4. BRICK LINTELS (WHEN REQUIRED) SHALL BE 3 1/2'x3 1/2'x1/4" STEEL ANGLE FOR UP TO 6'-0" SPAN AND 6'x4'x5/16" STEEL ANGLE WITH 6" LEG VERTICAL FOR SPANS UP TO 4'-0". SEE PLANS FOR SPANS OVER 4'-0". SEE ALSO SECTION RT03.8.3 LINTELS.
- I5. METAL CONNECTORS REFERENCED ON PLANS CORRESPOND TO SIMPSON STRONG-TIE BRAND. CONNECTORS OF EQUAL OR BETTER CAPACITY ARE ACCEPTABLE. CORROSION RESISTANCE PER CODE AND AS RECOMMENDED BY MANUFACTURER.





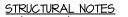

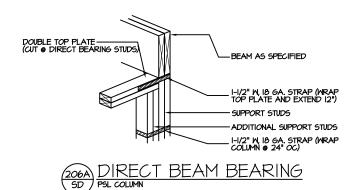

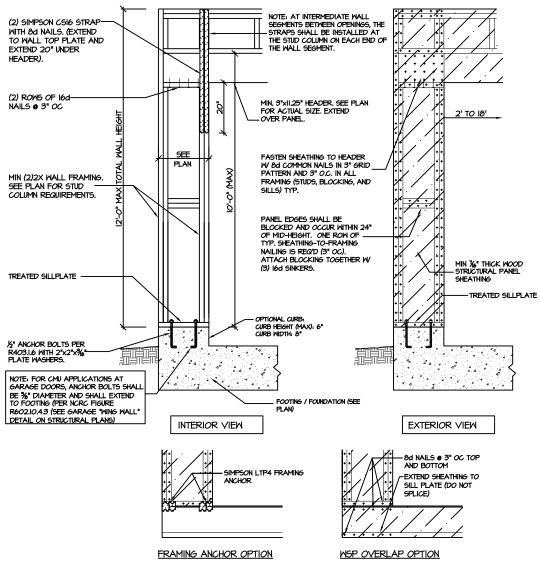

CS-PF - OVER WOOD FLOOR

GS-PF: CONTINUOUS PORTAL FRAME CONSTRUCTION
DETAIL AND APPLICATION BASED ON NCRC FIGURE
R602.10.1 - PORTAL FRAME CONSTRUCTION

21-2816.1

ruction means, methods, techniques, fety precautions. ecise on plans are to be brought to the ciese on plans are to be brought to the them Engineers. Failure to do so will bility.

PROJECT #

sequences, procedures or safety precautions. Any deviations or discrepancies on plans an immediate attention of Southern Engineers void Southern Engineers' liability. Seals is valid to proprotes permitted one year (Use of these plans constitutes approval of the

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SOUTH ]

NEW HOME, INC.

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