REVISION LOG

REVISION:001

ADD STEM WALL SLAB FOUNDATION SHEETS.
ADD "STEM WALL" TO CRAWL ELEVATION TITLES AND ADD NOTE "SEE FOUNDATION PAGES FOR FOUNDATION TYPE". UPDATE SHEET TITLES

DATE: 7/22/2022

3. ADD ELECTRICAL PLANS

- DATE: 9/14/2022 ADD OPT OWNER'S SUITE W/ LARGER WALK-IN CLOSET. UPDATE ELEVATIONS, FLOOR PLANS AND FOUNDATION SHEETS.
 ADD 2ND ACCESS TO STORAGE @ GAMEROOM.
 ADD OPTIONAL 2440 WINDOW IN OWNER'S BATH @ OPT OWNER'S SUITE W/ SITTING

REVISION:2 DATE: 11-10-2023

- DORMERS WITH DIMENSIONS AND WINDOW SIZES SHOWN ON THE SECOND FLOOR PLANS. CHANGED THE NAME OF THE ENGLISH COUNTRY TO CRAFTSMAN UPDATED STANDARD OWNERS'S SHOWER TO GOT'36" CHANGED THE ROOM NAME FLEX ROOM TO POCKET OFFICE FOR OPTIONS MOVED DOC WASH TO BE AGAINST THE DROP ZONE. PLUMBING ON THE FOUNDATIONS ADJUSTED.

- CHANGED SMART DOOR DELIVERY DOOR TO AN INSWING LABELED THE POCKET OFFICE SECOND FLOOR DOOR TO FULL GLASS

11-27-23 - Initial Redlines

Lot 121 DC - 155 Duncan Creek Rd,, Lillington, NC 27546

Trademark Plus

NC.



DESIGN CRITERIA:

THIS PLAN IS TO BE BUILT IN CONFORMANCE WITH THE 2018 NORTH CAROLINA STATE BUILDING CODE: RESIDENTIAL CODE

DIMENSIONS SHALL GOVERN OVER SCALE, AND CODE SHALL GOVERN OVER DIMENSIONS.

PLAN 1 The Clayton - LH

'LOW COUNTRY' ELEVATION

eet No.	Sheet Description					
0.0	Cover Sheet					
1.1	Foundation (Slab)					
1.1.1	Foundation Options (Slab)					
1.2	Foundation (Crawl)					
1.2.1	Foundation Options (Crawl)					
1.3	Foundation (Stem Wall Slab)					
1.3.1	Foundation Options (Stem Wall Slab)					
2.1	First Floor Plan					
2.1.1	First Floor Plan Options					
2.1.2	First Floor Plan Options					
2.2	Optional Second Floor Plan					
2.2.1	Second Floor Plan Options					
2.4	Covered Porch Plans & Elevations (Slab)					
2.4.1	Covered Porch Plans & Elevations (Crawl/ Stem Wall)					
2.5	Extended Covered Porch Plans & Elevations (Slab)					
2.5.1	Extended Covered Porch Plans & Elevations (Crawl/ Stem Wall)					
3.1	Front & Rear Elevations (Slab)					
3.1.1	Front & Rear Elevations (Crawl/ Stem Wall)					
3.2	Side Elevations (Slab)					
3.2.1	Side Elevations (Crawl/ Stem Wall)					
3.3	Side Load Garage Elevations (Slab)					
3.3.1	Side Load Garage Elevations (Crawl/Stem Wall)					
3.4	Side Load Garage Elevations (Crawl/Stem Wall)					
5.1	First Floor Electrical Plan					
5.1.1	First Floor Options Electrical Plan					
5.1.2	Alternate First Floor Electrical Plan					
5.2	Optional Second Floor Electrical Plan					

SQUARE FOOTAGE								
	LOW COUNTRY							
	UNHEATED	HEATED						
FIRST FLOOR	0	1871						
FRONT PORCH	147	0						
2 CAR GARAGE	468	0						
PATIO/ DECK	196	0						
SUBTOTALS	811	1871						
TOTAL UNDER ROOF 2682								
O	PTIONS							
	UNHEATED S.F.	HEATED S.F.						
SECOND FLOOR	0	803						
COVERED PORCH	196	0						
EXTENDED COVERED PORCH	+65	0						
SMART DOOR	-25	+25						




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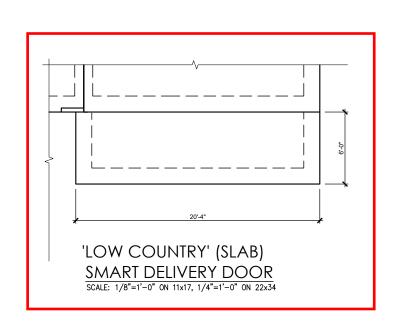
Cover Sheet 'Low Country'


THE CLAYTON - LH


ISSUE DATE: 7/1/2021 CURRENT REVISION DATE: 1/8" = 1'-0"

 $0.0^{\text{SHEET}}\!a$



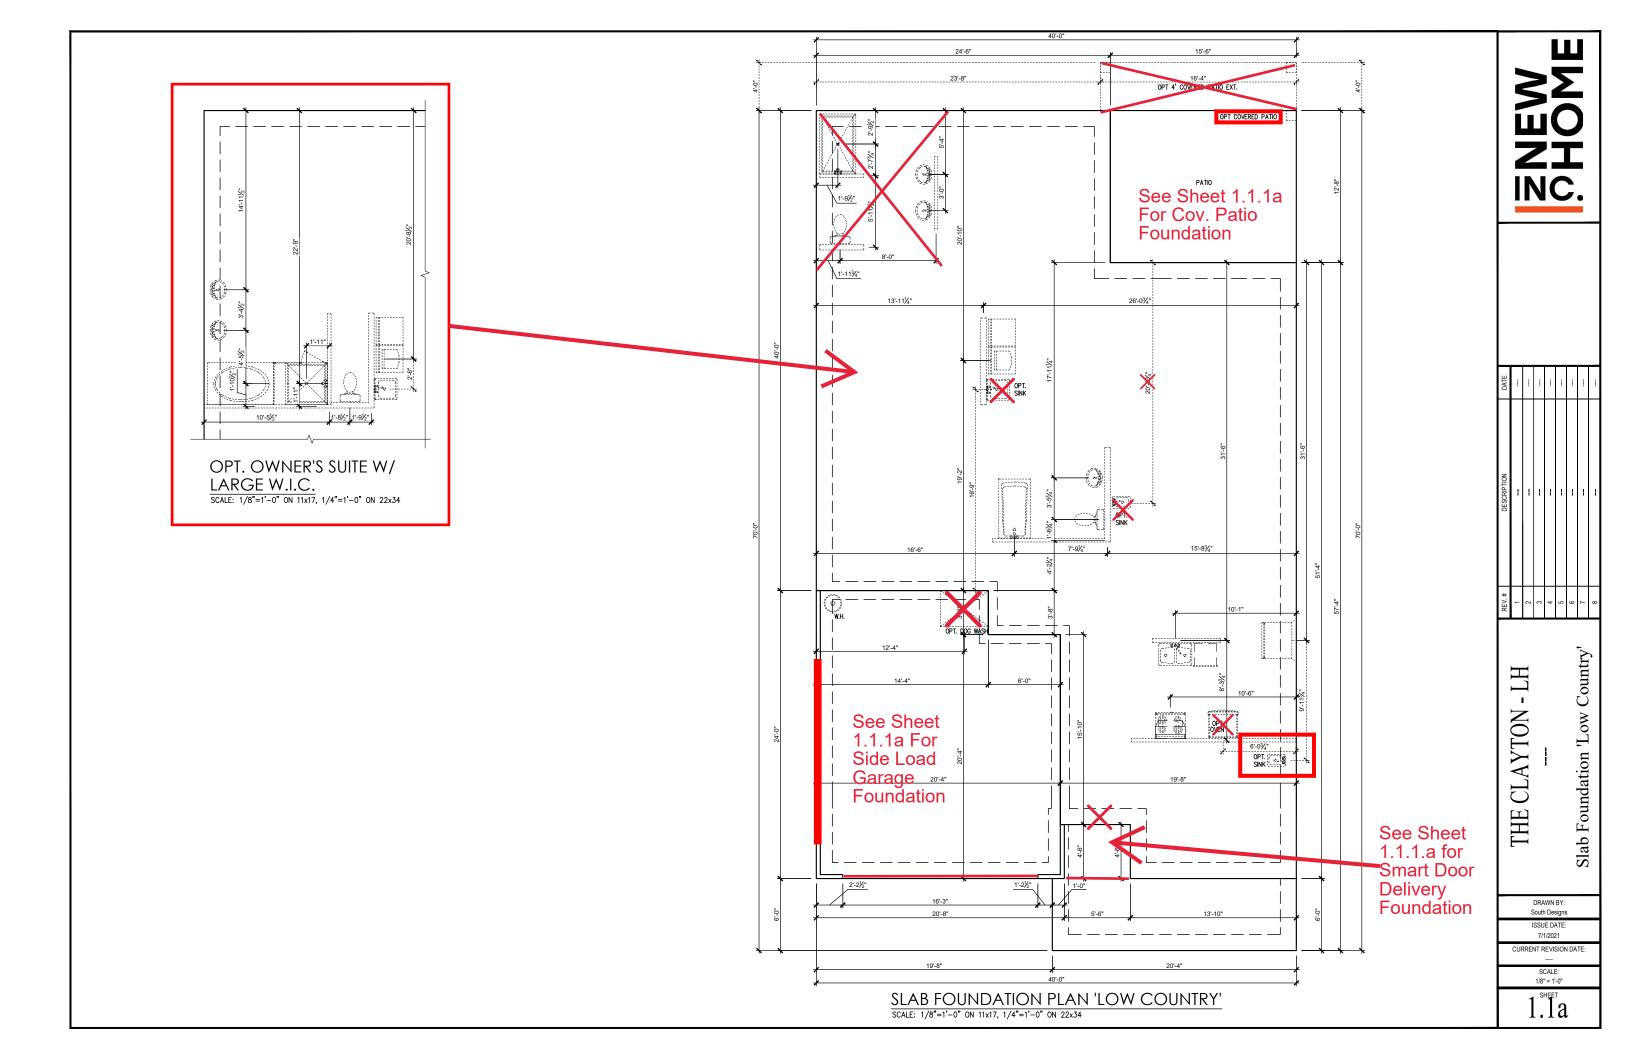

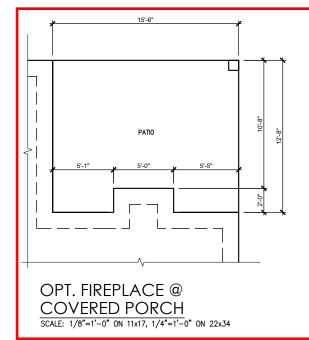

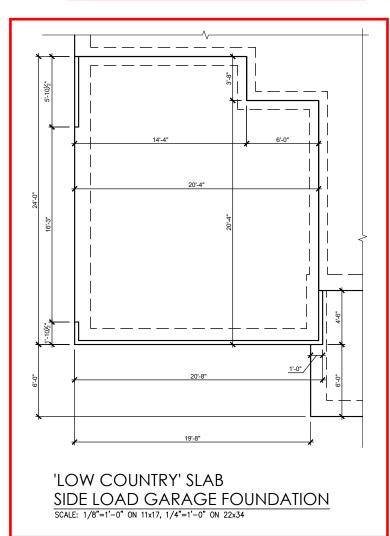



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THE CLAYTON - LH
--Slab Foundation Options 'Low Coun

DRAWN BY: South Designs


ISSUE DATE: 7/1/2021

CURRENT REVISION DATE:
---SCALE:
1/8" = 1'-0"

1.1.1a


General Floor Plan Notes shall apply unless noted otherwise on plan.


- Wall Heights: Typically 9-1 1/2" at first floor and second floor, and 9-1 1/2" at affics U.N.O. All walls are constructed using a double top plate. Splices at Double Top Plate do not need to occur at Vertical Studs but must be at least 24" apart from Joint in other Top Plate layer. Special wall heights are noted on plans where they occur.
- Wall Thickness is typically 3 1/2". 2x6 frame shall be used at walls that back up to plumbing fixtures.
 Walls greater than 10' high shall be framed with 2x6 framing or greater and will be noted as a special condition where it occurs on plan.
- Typical header height shall be 7'-8" AFF at First Floor, and 7'-4" AFF at Second Floor U.N.O.
- Jacks: Openings up to 3'-4" wide shall have (1) 2x4 jack stud SPF on each side. Openings greater than 3'-4" wide shall have (2) 2x4 jack studs SPF on each
- Soffits, Coffered Ceilings, Trey Ceilings and other significant ceiling plan elements are shown on the floor plans and are denoted as single dashed lines. Unless specifically call out as included, Kitchens do not include soffits over wall cabinetry.
- Door & Window Frames, where occurring near corners, shall be a minimum of 4 1/2" from corner. Except for walk-in-closets with doors near a corner, doors at closets shall be centered on closet.
- Windows: Shall have at least (1) window in each sleeping room, that meets egress. Shall be provided with tempered glass at hazardous glazing areas. False windows shall be installed with obscure glazing.
- Closets for clothing or coat storage shall be equipped with 1 rod/shelf. Closets for linen shall have 4 open equal shelves. Closets for pantries shall have 4 equal wood shelves, painted.
- Stair treads shall be a min of 9" deep, risers shall be a maximum of 8 1/4", unless noted otherwise, per the current North Carolina Residential Code
- 10. Handrails and Guards at stairs shall be 34" above the finished surface of the ramp surface of the stair. Handrails at landings and overlooks of multilevel spaces shall be 36" above finished floor. Guards (pickets or balusters) shall be spaced with no more than 4" between augrds.
- 11. Attic Access shall be provided at all attic area with a height greater than 30". Minimum clear attic access shall be 20" x 30". Pull down stairs and access doors in knee walls meeting minimum criteria are also acceptable.
- 12. Garage Door to Living Space shall be 2'-8" x 6'-8" minimum size and shall be 20 minute fire rated and weather sealed.
- 13. Garage Walls, as a minimum, shall be separated from living space by installing 1/2" gypsum board on the garage side of the wall. With habitable space above, the inside of all garage walls require 1/2" GWB supporting 5/8" type X GWB on ceiling.

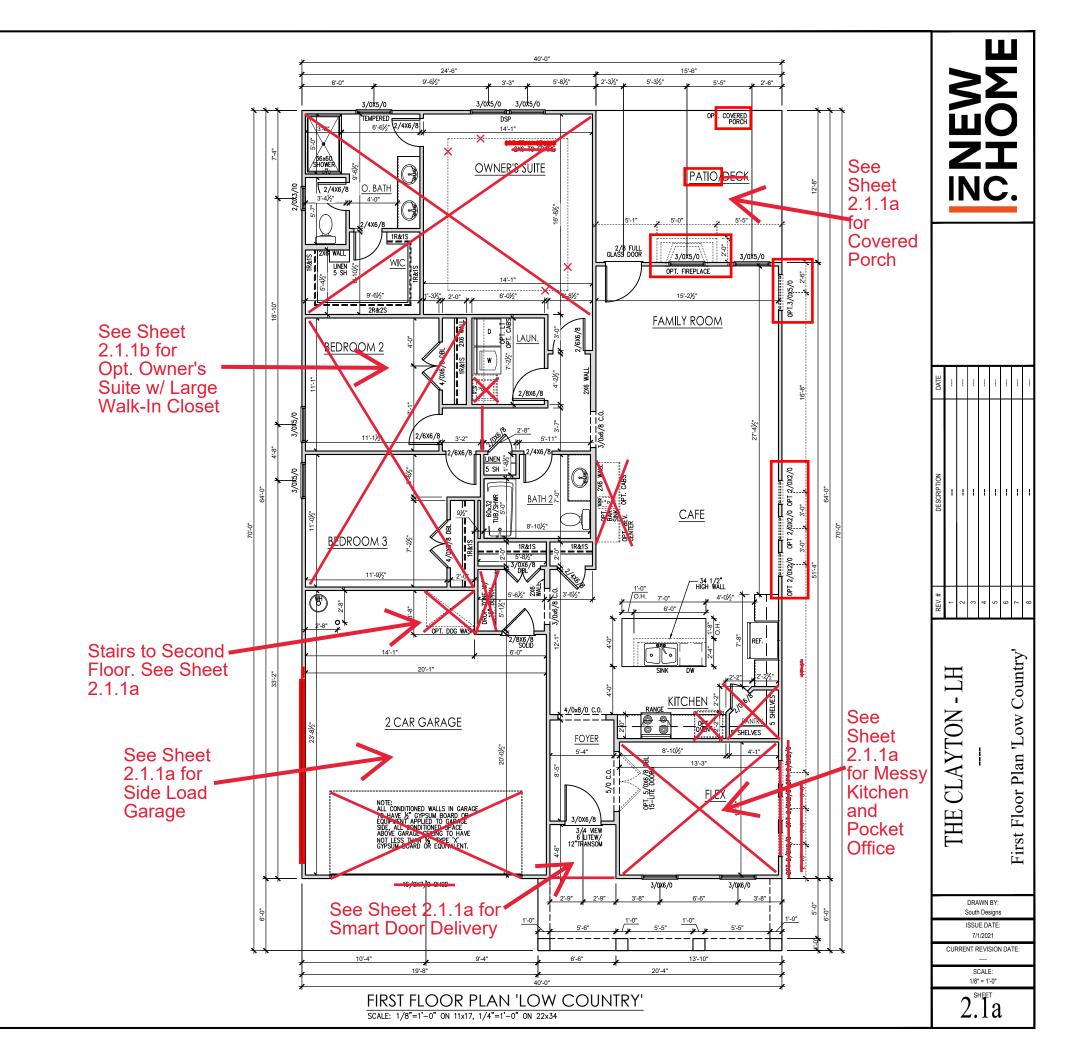



General Floor Plan Notes shall apply unless noted otherwise on plan.


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- 13. Garage Walls, as a minimum, shall be separated from living space by installing 1/2" gypsum board on the garage side of the wall. With habitable space above, the inside of all garage walls require 1/2" GWB supporting 5/8" type X GWB on ceiling.

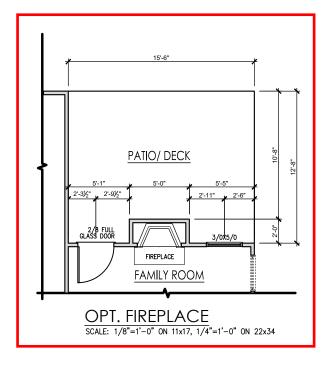

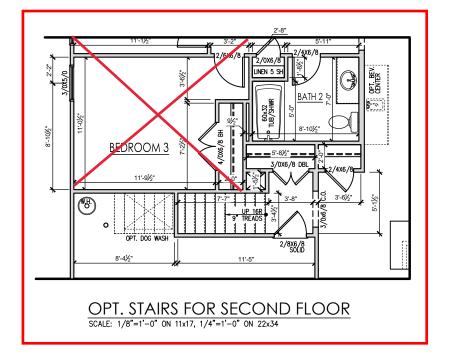


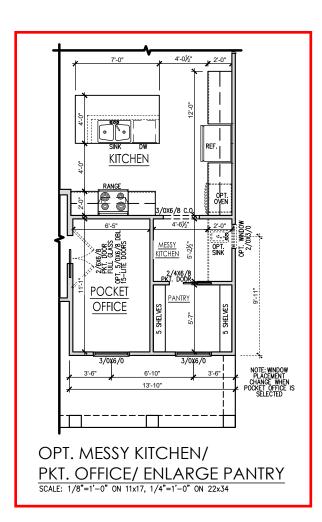

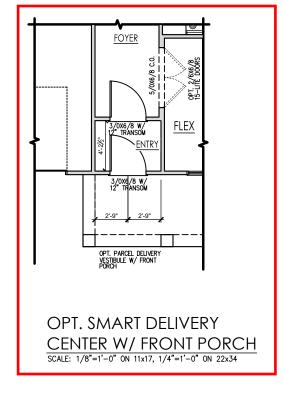

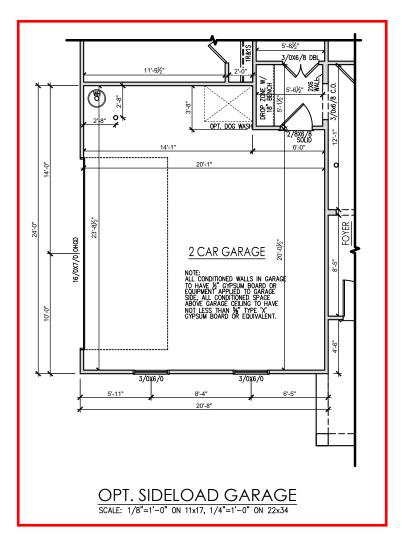



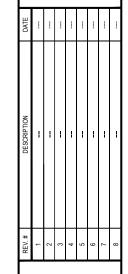

THE CLAYTON - LH
--First Floor Options 'Low Country'

DRAWN BY: South Designs ISSUE DATE:


7/1/2021 CURRENT REVISION DATE

1/8" = 1'-0"

General Floor Plan Notes shall apply unless noted otherwise on plan.

- 1. Wall Heights: Typically 9'-1 1/2" at first floor and wall Heights: Typically Y-1 1/2" at a trist floor and second floor, and 9'-1 1/2" at at thics U.N.O. All walls are constructed using a double top plate. Splices at Double Top Plate do not need to occur at Verifical Studs but must be at least 24" apart from Joint in other Top Plate layer. Special wall heights are noted on plans where they occur.
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- 5. Soffits, Coffered Cellings, Trey Cellings and other significant celling plan elements are shown on the floor plans and are denoted as single dashed lines. Unless specifically call out as included, Kitchens do not include soffits over wall cabinetry.
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-LH Alternate First Floor Plan 'French Country' CLAYTON THE

> DRAWN BY: South Designs

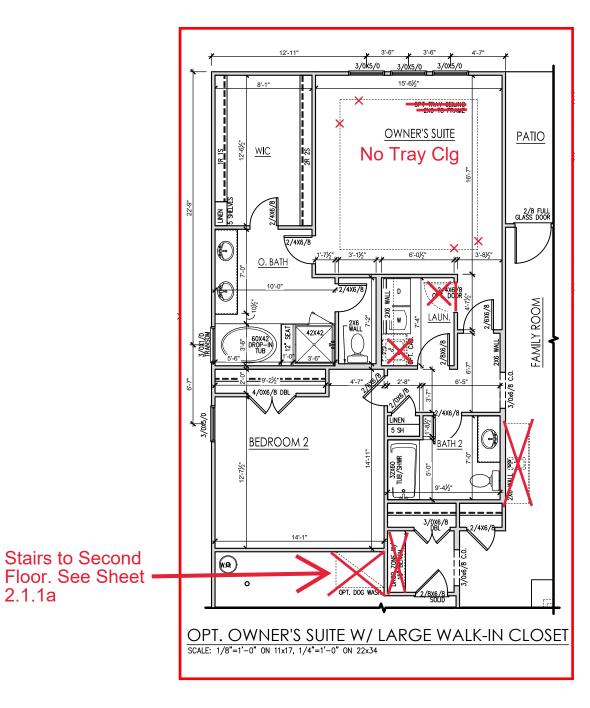
ISSUE DATE: 7/1/2021

CURRENT REVISION DATE:

1/8" = 1'-0"

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THE CLAYTON - LH
--Opt. Second Floor Plan 'Low Country'


DRAWN BY: South Designs

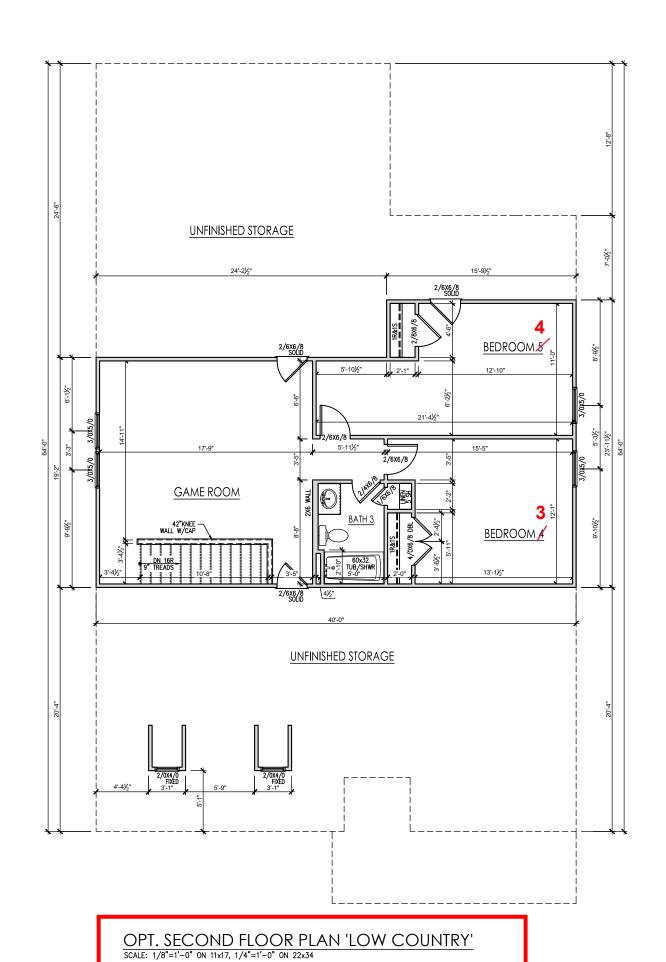ISSUE DATE: 7/1/2021

CURRENT REVISION DATE:

1/8" = 1'-0"

2.2a

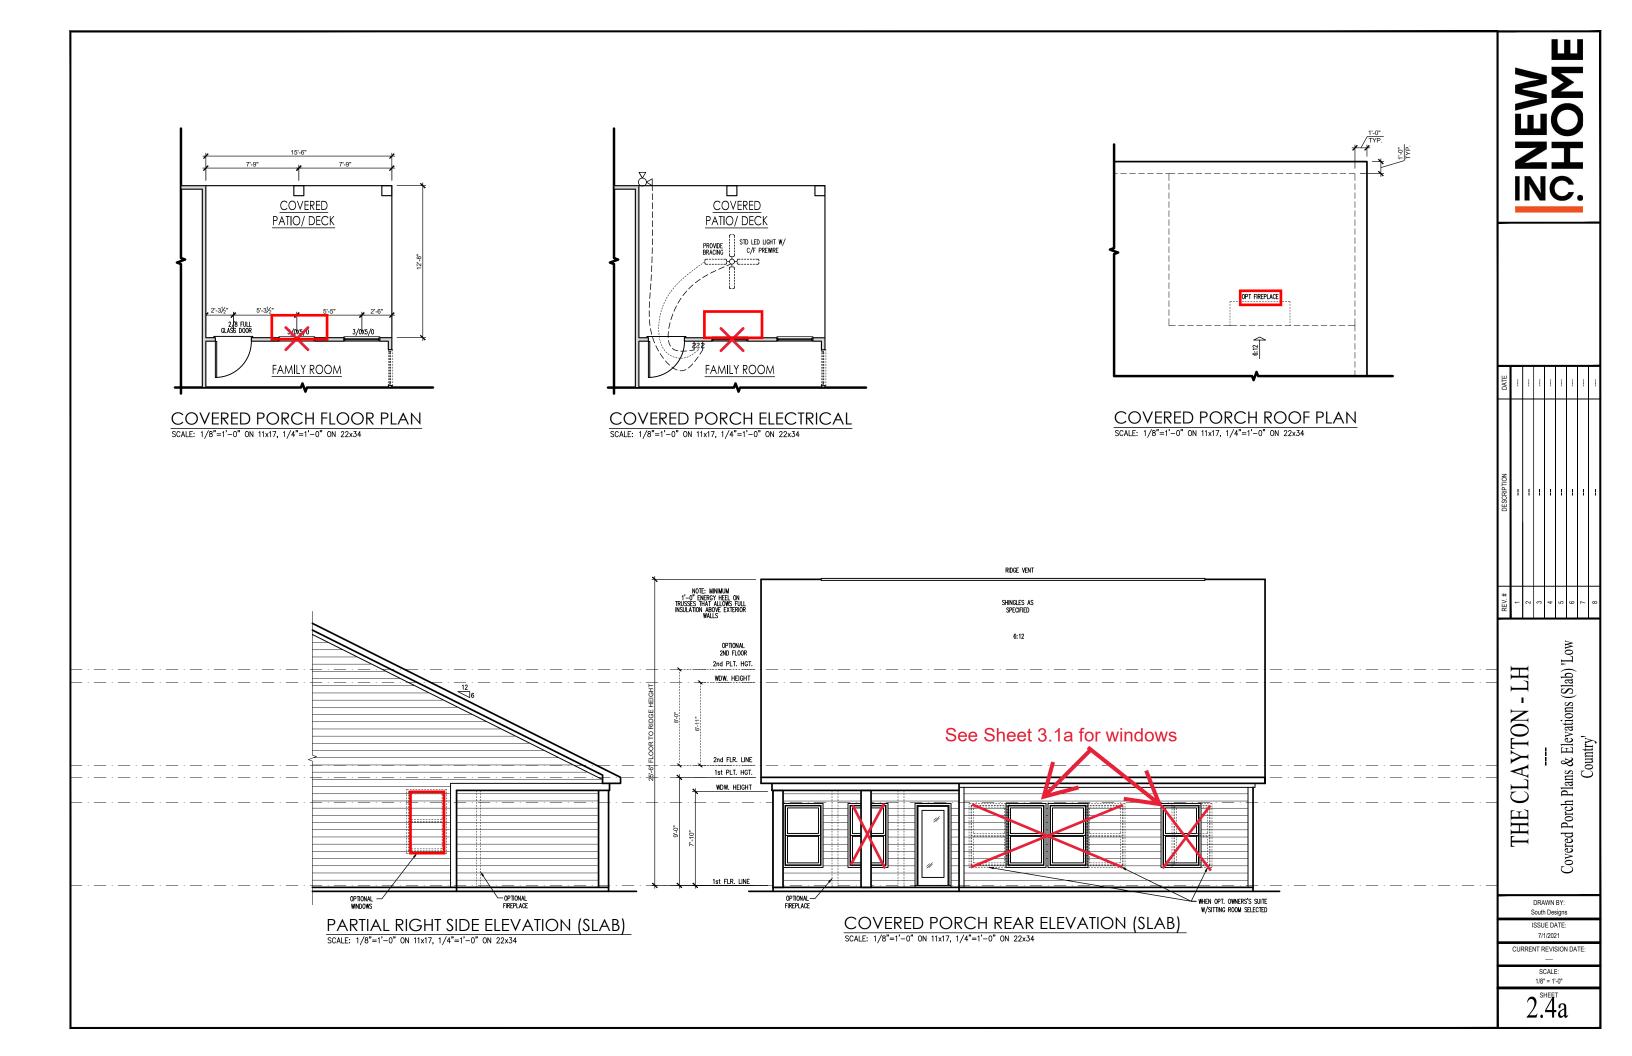

General Elevation Notes


General Elevation Notes shall apply unless noted otherwise on plan.

- Roof shall be finished with architectural composition shingles with slopes as noted on plan.
- Ridge Vent shall be provided and installed on all ridges greater than 6' in length per manufacturer's specifications.
- 3. Soffit Vent shall be continuous soffit vent
- House Wrap, "tyvek" or approved equal shall be installed over entire exterior wall per manufacturer's specifications and recommendations.
- Flashing shall be provided above all door and window openings, above finish wall material changes and at wall surfaces where lower roof area abut vertical wall surfaces.
- Porch Railings shall be provided at all porch walking surfaces greater than 30" above adjacent finished grade. It shall be 36" high with guards spaced no more than 4" apart. Consult community specifications for material.
- Finish Wall Material shall be as noted on elevation
- Brick Veneer, if included on elevation shall be tied to wall surface with galvanized corrugated metal ties at a rate of 24" oc horizontally and 16" oc vertically so that no more than 2.67st of brick is supported by (1) tie. Space between face of wall and back face of brick shall be limited to a maximum of 1". Flashing shall be provided behind brick above all wall openings and at base of brick wall. Flashing shall be a minimum of 6-mil poly or other corrosion resistant material and shall be installed so that it laps under the house wrap material a minimum of 2". Weepholes shall be provided at a rate of 48" oc and shall not be less than 31/6" in diameter and shall be located immediately above flashing. that no more than 2.67sf of brick is supported by (1)
- Brick Veneer Support Lintels shall be provided if brick veneer is included on elevation. Lintels shall be provided as listed in the following schedule and shall have a minimum bearing length of 6". Masonry Lintels shall be provided so that deflection is limited


Masonry Opening Lintel Schedule


Opening Size	Angle

up to 4'-0"
4'-1" to 5'-6"
5'-7" to 6'-6"
6'-7" to 8'-4"
8'-5" to 16'-4" 3-1/2" x 3-1/2" x 5/16"

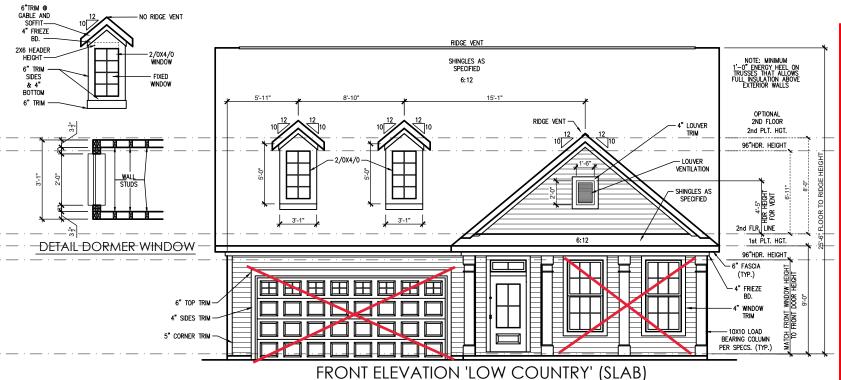


SCALE: 1/8"=1'-0" ON 11x17, 1/4"=1'-0" ON 22x34

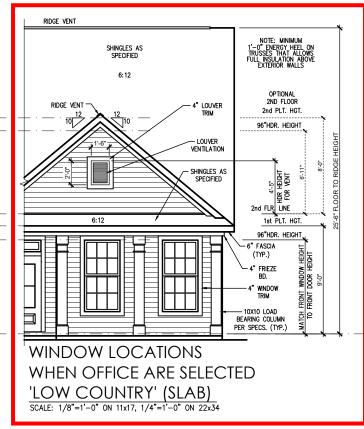

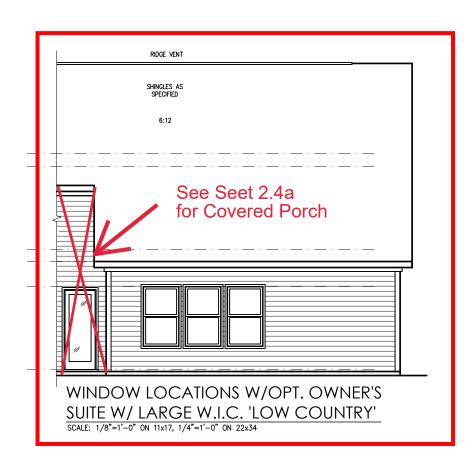



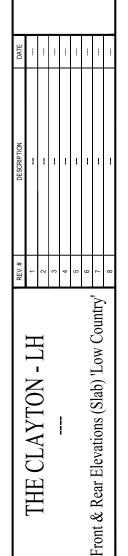


CLAYTON THE

> DRAWN BY: South Designs ISSUE DATE:

7/1/2021 CURRENT REVISION DATE:


1/8" = 1'-0" 3.1a

General Elevation Notes General Elevation Notes shall apply unless noted otherwise on plan. Roof shall be finished with architectural composition NOTE: MINIMUM 1'-0" ENERGY HEEL ON TRUSSES THAT ALLOWS FULL INSULATION ABOVE EXTERIOR WALLS shingles with slopes as noted on plan Ridge Vent shall be provided and installed on all ridges greater than 6' in length per manufacturer's 3. Soffit Vent shall be continuous soffit vent House Wrap, "tyvek" or approved equal shall be installed over entire exterior wall per manufacturer's specifications and recommendations. RIDGE VENT 2nd PLT. HGT. WDW. HEIGHT Flashing shall be provided above all door and window openings, above finish wall material changes and at wall surfaces where lower roof areas abut vertical wall surfaces. SHINGLES AS SPECIFIED Porch Railings shall be provided at all porch walking surfaces greater than 30" above adjacent finished grade. It shall be 36" high with guards spaced no more than 4" apart. Consult community specifications for material. 2nd FLR. LINE Finish Wall Material shall be as noted on elevation 1st PLT. HGT. Brick Veneer, if included on elevation shall be tied to wall surface with galvanized corrugated metal ties at a rate of 24" oc horizontally and 16" oc vertically so

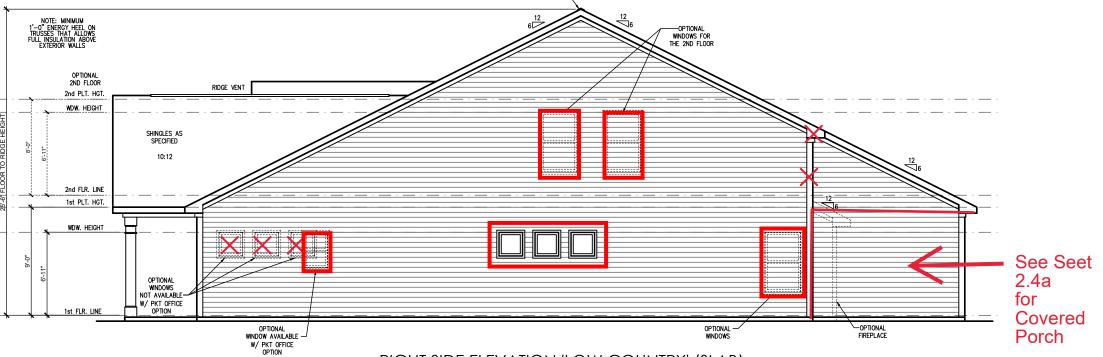


RIGHT SIDE ELEVATION 'LOW COUNTRY' (SLAB)

SCALE: 1/8"=1'-0" ON 11x17, 1/4"=1'-0" ON 22x34

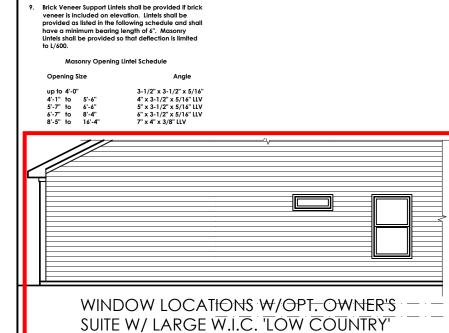

SCALE: 1/8"=1'-0" ON 11x17, 1/4"=1'-0" ON 22x34

a rate of 24" oc horizontally and 16" oc vertically so that no more than 2.67st of brick is supported by (1) the. Space between face of wall and back face of brick shall be limited to a maximum of 1". Flashing shall be provided behind brick above all wall openings and at base of brick wall. Flashing shall be a minimum of 6-mil poly or other corrosion resistant material and shall be installed so that it laps under the house wrap material a minimum of 2". Weepholes shall be provided at a rate of 48" oc and shall no be less than 3716" in diameter and shall be located immediately above flashing.

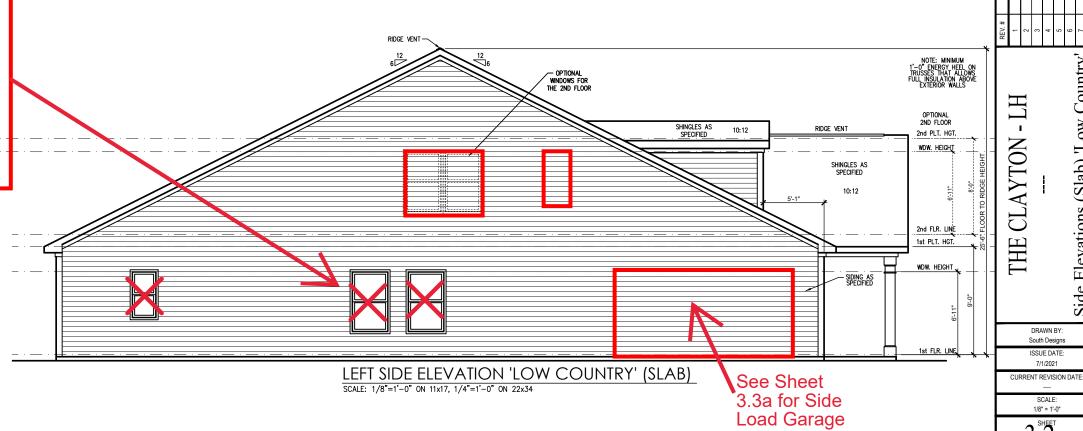

Side Elevations (Slab) 'Low Country'

General Elevation Notes


General Elevation Notes shall apply unless noted otherwise on plan.

- Roof shall be finished with architectural composition shingles with slopes as noted on plan.
- Ridge Vent shall be provided and installed on all ridges greater than 6' in length per manufacturer's specifications.
- 3. Soffit Vent shall be continuous soffit vent
- House Wrap, "tyvek" or approved equal shall be installed over entire exterior wall per manufacturer's specifications and recommendations.
- Flashing shall be provided above all door and window openings, above finish wall material changes and at wall surfaces where lower roof areas abut vertical wall surfaces.
- Porch Raillings shall be provided at all porch walking surfaces greater than 30" above adjacent finished grade. It shall be 36" high with guards spaced no more than 4" apart. Consult community specifications for material.
- Finish Wall Material shall be as noted on elevation drawings.
- 8. Brick Veneer, if included on elevation shall be fied to wall surface with galvanized corrugated metal fies a rate of 24" oc horizontally and 16" oc vertically so that no more than 2.67sf of brick is supported by (1) fie. Space between face of wall and back face of brick shall be limited to a maximum of 1". Flashing shall be provided behind brick above all wall openings and at base of brick wall. Flashing shall be a minimum of 6-mil poly or other corrosion resistant material and shall be installed so that it laps under the house wrap material a minimum of 2".

 Weepholes shall be provided at a rate of 48" oc and shall not be less than 3/16" in diameter and shall be located immediately above flashing.
- Brick Veneer Support Lintels shall be provided if brick veneer is included on elevation. Lintels shall be provided as listed in the following schedule and shall have a minimum bearing length of 6". Masonry Lintels shall be provided so that deflection is limited to 1/600.

Masonry Opening Lintel Schedule

Angle
3-1/2" x 3-1/2" x 5/16"
4" x 3-1/2" x 5/16" LLV
5" x 3-1/2" x 5/16" LLV
6" x 3-1/2" x 5/16" LLV
7" x 4" x 3/8" LLV

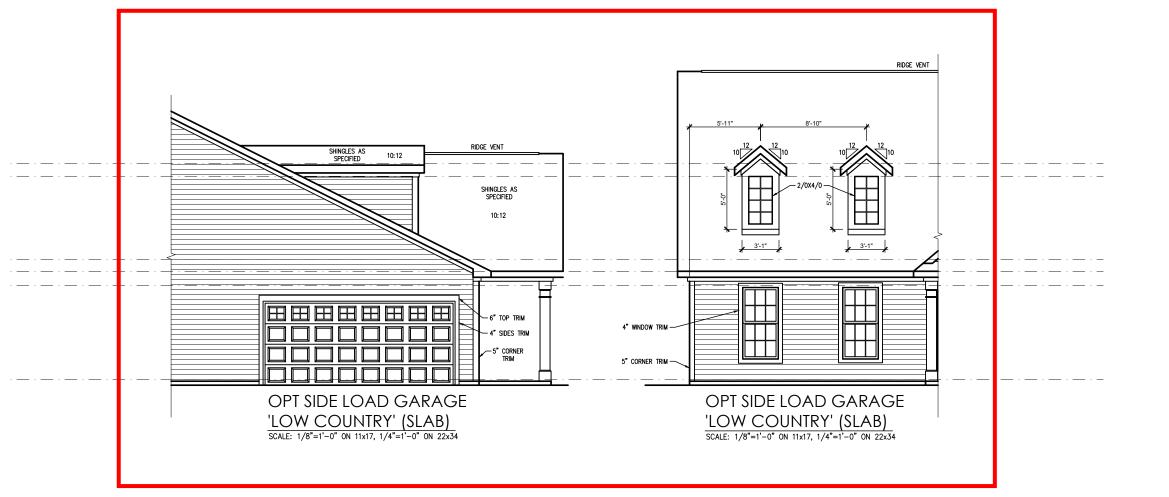



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THE CLAYTON - LH


--Side Load Garage Elevations
(Slab) 'Low Country'

DRAWN BY: South Designs

ISSUE DATE: 7/1/2021 CURRENT REVISION DATE:

> SCALE: 1/8" = 1'-0"

3.3a

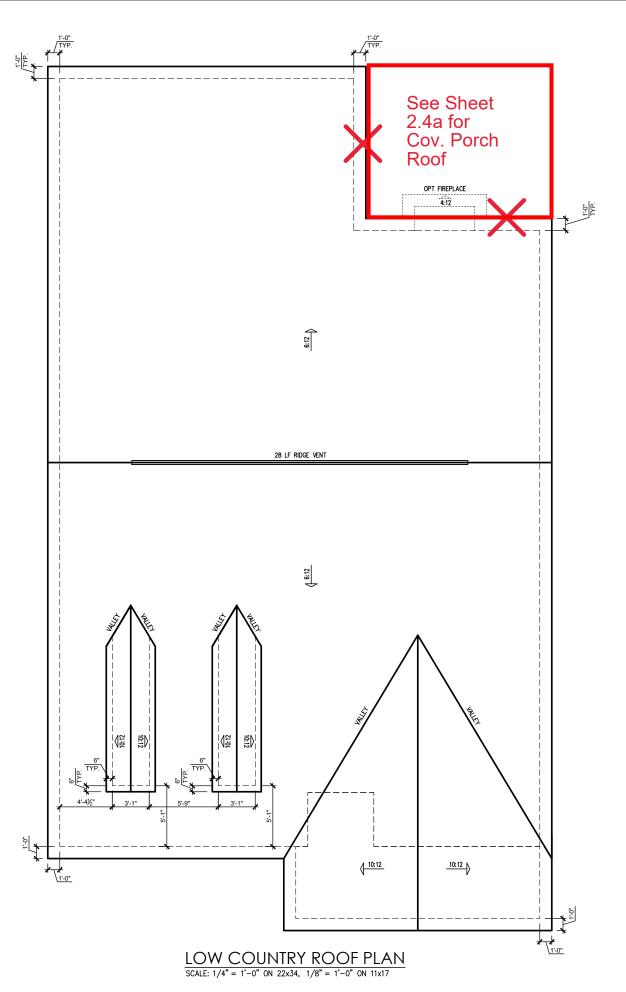

ATTIC VENT SCHEDULE										
				L	OW COU	NTRY				
MAIN HOUSE			SQ FTG	2486	AT	/ NEAR RID	AT / NEAR EAVE			
VENT TYPE	SQ. F		SQ. FT.		POT LARGE (SQ. FT. EACH)	POT SMALL (SQ. FT. EACH)	RIDGE VENT (SQ. FT. PER LF)	EAVE VENT (SQ. IN. EACH)	CONT. VENT (SQ. IN. PER LF)	
72.11.11.2	RAN		SUPPLIED	SUPPLIED	0.4236	0.2778	0.125	0.1944	0.0625	
0										
RIDGE VENT	3.31	4.14	7.50	70.59	0	0	60.00			
SOFFIT VENTS	4.97	4.14	3.13	29.41				0	50.00	
TOTAL (MIN)	8.29	8.29	10.63	100.00	POT VENTS MAY BE REQUIRED IF THERE IS INSUFFICIENT RID			IGE AVAILABLE		

* Schedule has been calculated assuming eave ventilation at 50–60% of total and ridge at 40–50% of total required ventilation

ZNEW PHOME

DATE			ı	-	-				
DESCRIPTION			1	1	1	1	1		
REV. #	1	2	3	4	9	9	7	8	

THE CLAYTON - LH
--Roof Plan 'Low Country'


DRAWN BY: South Designs ISSUE DATE:

ISSUE DATE:
7/1/2021

CURRENT REVISION DATE:

SCALE: 1/8" = 1'-0"


3.4a

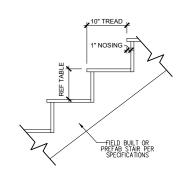

RISER HEIGHTS PER STAIR CONFIGURATION											
PLATE HEIGHT	10" FLOOR SYSTEM	16" FLOOR SYSTEM									
8'-1 1/2"	14 RISERS @ 7 11/16"	15 RISERS @ 7 1/2"	15 RISERS @ 7 5/8"								
9'-1 1/2"	16 RISERS @ 7 1/2"	16 RISERS @ 7 3/4"	17 RISERS @ 7 7/16"								
10'-1 1/2"	17 RISERS @ 7 3/4"	18 RISERS @ 7 9/16"	18 RISERS @ 7 11/16"								


TYPICAL STAIR DETAIL

SCALE: 1" = 1'-0" ON 22x34, 1/2" = 1'-0" ON 11x17

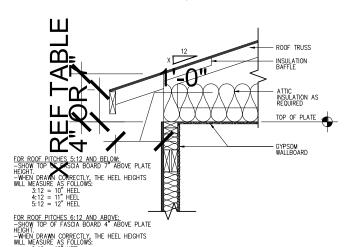


LL IMPORTANT REMINDER: THE LOWEST PITCH ROOF ALWAYS MANDATES THE EL CONDITION. FOR EXAMPLE , A ROOF WITH A 4:12 PITCH AND A 6:12 PITCH, EL WOULD FOLLOW THE 7" ABOVE PLATE HEIGHT RULE. THE HELE FOR THE EEL 6:12 ROOF IN THIS CONDITION WILL DIFFER FROM WHAT IS LISTED HERE.

ENERGY HEEL DETAIL: CZ 2 & 3 SCALE: 1" = 1'-0" ON 22x34, 1/2" = 1'-0" ON 11x17

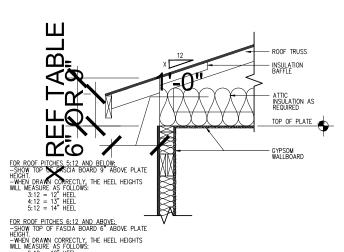

IMPORTANT REMINDER: THE LOWEST PITCH ROOF ALWAYS MANDATES THE CONDITION. FOR EXAMPLE. A ROOF WITH A 4:12 PITCH AND A 6:12 PITCH, WOULD FOLLOW THE 9" ABOVE PLATE HEIGHT RULE. THE HEEL FOR THE 6:12 ROOF IN THIS CONDITION WILL DIFFER FROM WHAT IS LISTED HERE.

ENERGY HEEL DETAIL: CZ 4 & 5
SCALE: 1" = 1'-0" ON 22x34, 1/2" = 1'-0" ON 11x17

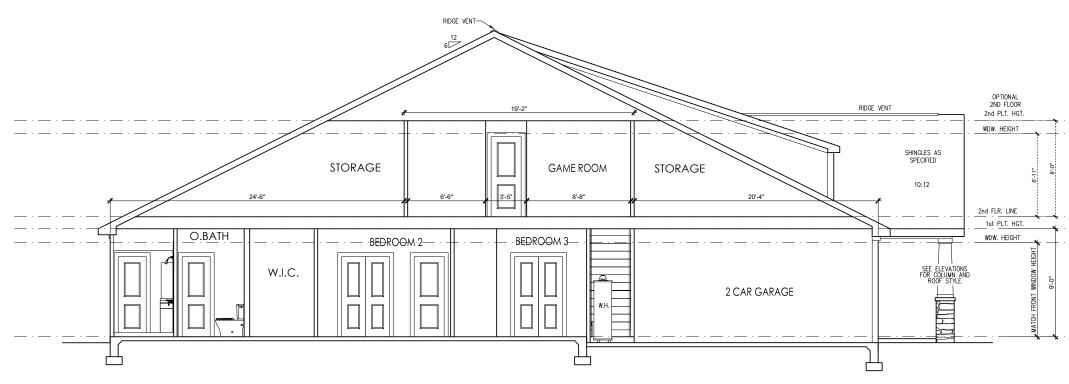

MUNC.

Building Sections 'Low Country'


CLAYTON

THE

South Designs
ISSUE DATE:
7/1/2021

CURRENT REVISION DATE:

SCALE: 1/8" = 1'-0" 4.0a

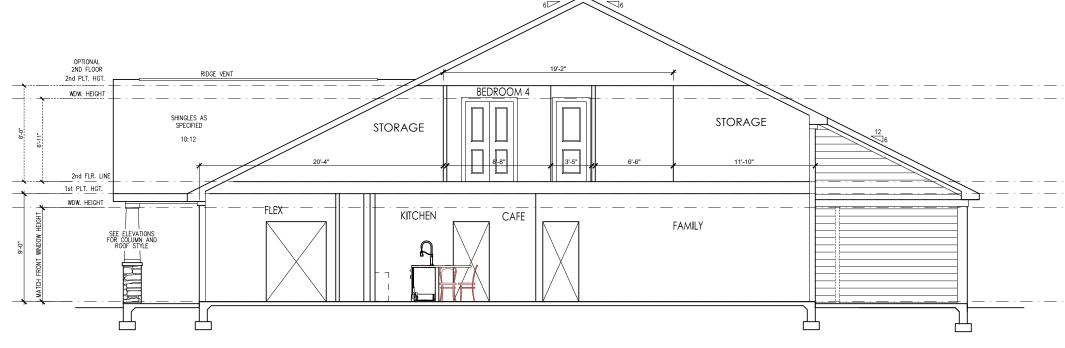

RIDGE VENT-

ELECTRICAL KEY DUPLEX OUTLET SPLIT SWITCHED OUTLET **O** FLOOR OUTLET # QUADPLEX OUTLET ⊕^{GF1} GROUND FAULT OUTLET GFIWP WEATHER PROOF OUTLET 220V 220v OUTLET (S) EXAUST FAN \$ EXHAUST FAN / LIGHT **\(\rightarrow\)** EXHAUST FAN / HEAT LIGHT R RECESSED CAN LIGHT ledowEYEBALL LIGHT (P) VAPOR PROTECTED LIGHT CEILING LIGHT LED DISC HANGING CEILING LIGHT HANGING PENDANT LIGHT Ю WALL LIGHT VANITY LIGHT WALL SCONCE LIGHT \$3 3-WAY SWITCH \$^D DIMMER SWITCH TV CABLE T.V. JACK • ∇ PHONE JACK \bigcirc DIRECT WIRE DATA OUTLET NETWORK PANEL W/ OUTLET (SD) SMOKE DETECTOR CARBON MONOXIDE CMD ELECTRICAL PANEL DISCONNECT SWITCH ELECTRIC METER → 2' LED LIGHT 2 BULB FLUORESCENT QQQQ VANITY LIGHTS FLOOD LIGHT CEILING FAN CEILING FAN W/ LIGHT


General Power and Lighting:


General Power and Lighting Notes shall apply unless noted otherwise on plans.

All work shall be installed per the current NC Residential Building Code, and the National Electric Code. Alarm devices shall meet NFPA 72.

- Smoke Alarms Shall be provided as a minimum of (1) per floor, including basements (if applicable), (1) in each sleep room, and (1) outside each sleeping area, within the immediate vicinity of sleeping rooms. When more than one alarm is required, the alarm devices shall be interconnected in such a manner that the activation of one alarm will activate all of the alarms. Smoke alarms shall be hard wired to permanent power and shall have
- Switches For lighting, fans, etc. shall be installed at heights illustrated on this page and shall be located a minimum of 4 1/2" from door openings to allow for the proper installation of door casings. Switches, thermostats, security pads, and other similar devices shall be grouped together and installed thoughtfully for convenience of use and to avoid placement within centers of wall areas.

Note:
This plan is a diagram showing approximate locations of convenience outlets based on requirements found in the NC Residential Code and N.E.C. Actual positions may vary from what is shown on plan.

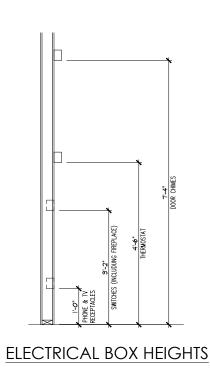

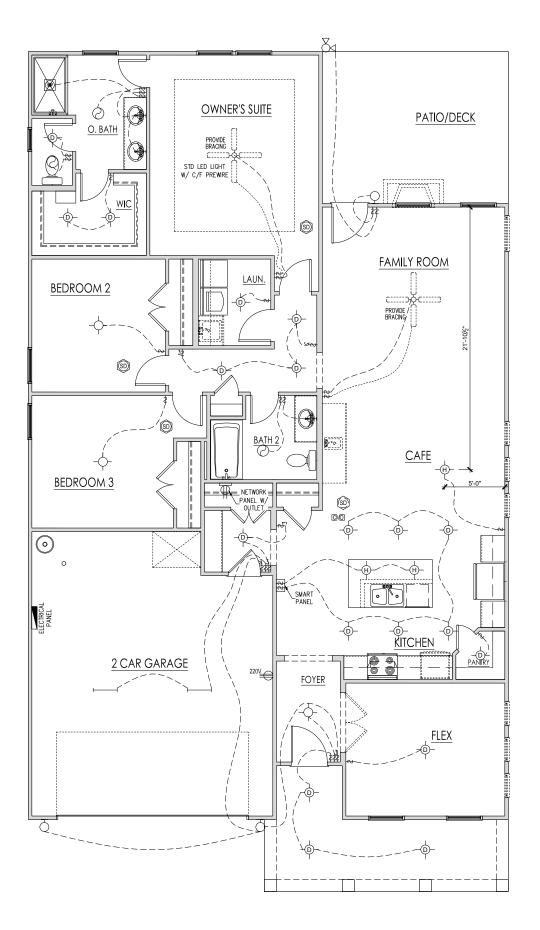

FIRST FLOOR ELECTRICAL PLAN 'LOW COUNTRY' SCALE: 1/8"=1'-0" ON 11x17, 1/4"=1'-0" ON 22x34

DATE	-	-	-				-	-
DESCRIPTION								
REV.#	1	2	3	7	2	9	2	8

First Floor Electrical 'Low Country' CLAYTON THE

> DRAWN BY: South Designs ISSUE DATE: 7/1/2021

CURRENT REVISION DATE:

1/8" = 1'-0"

ELECTRICAL KEY \Rightarrow DUPLEX OUTLET SPLIT SWITCHED OUTLET **©** FLOOR OUTLET # QUADPLEX OUTLET ⊕^{GF1} GROUND FAULT OUTLET GFI/WP WEATHER PROOF OUTLET 220V OUTLET (S) EXAUST FAN \$ EXHAUST FAN / LIGHT EXHAUST FAN / HEAT LIGHT R RECESSED CAN LIGHT ledowEYEBALL LIGHT (P) VAPOR PROTECTED LIGHT CEILING LIGHT -ф-LED DISC HANGING CEILING LIGHT ---|--HANGING PENDANT LIGHT Ю WALL LIGHT VANITY LIGHT WALL SCONCE LIGHT \$ \$ 3-WAY SWITCH \$^D DIMMER SWITCH CABLE T.V. JACK • ∇ PHONE JACK \bigcirc DIRECT WIRE DATA OUTLET NETWORK PANEL W/ OUTLET (SD) SMOKE DETECTOR CARBON MONOXIDE CMD ELECTRICAL PANEL DISCONNECT SWITCH ELECTRIC METER 2' LED LIGHT 2 BULB FLUORESCENT QQQQ VANITY LIGHTS FLOOD LIGHT CEILING FAN **ELECTRICAL BOX HEIGHTS** CEILING FAN W/ LIGHT


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KITCHEN

P,OCKET

OFFICE


OPT. MESSY KITCHEN/

SCALE: 1/8"=1'-0" ON 11x17, 1/4"=1'-0" ON 22x34

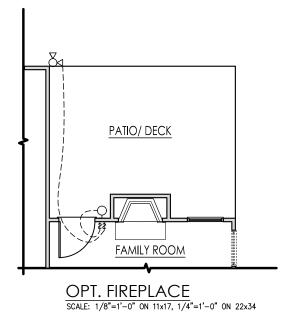PKT. OFFICE/ ENLARGE PANTRY


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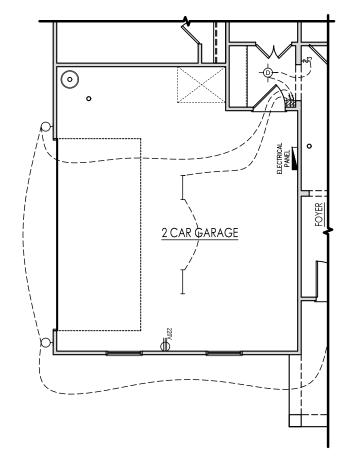


OPT. SHOWER SCALE: 1/8"=1'-0" ON 11x17, 1/4"=1'-0" ON 22x34

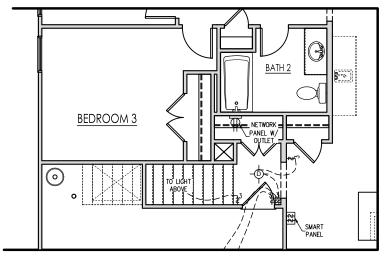OPT. STAIRS FOR SECOND FLOOR SCALE: 1/8"=1'-0" ON 11x17, 1/4"=1'-0" ON 22x34




OPT. SMART DELIVERY CENTER W/ FRONT PORCH SCALE: 1/8"=1'-0" ON 11x17, 1/4"=1'-0" ON 22x34

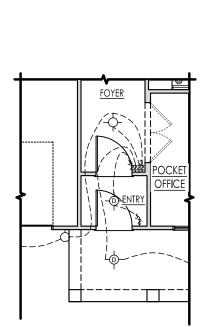

OPT. SIDELOAD GARAGE SCALE: 1/8"=1'-0" ON 11x17, 1/4"=1'-0" ON 22x34




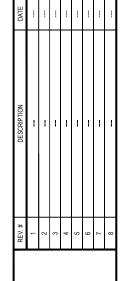

First Floor Options Electrical Low Country' CLAYTON THE

> DRAWN BY: South Designs ISSUE DATE: 7/1/2021

CURRENT REVISION DATE: SCALE: 1/8" = 1'-0"

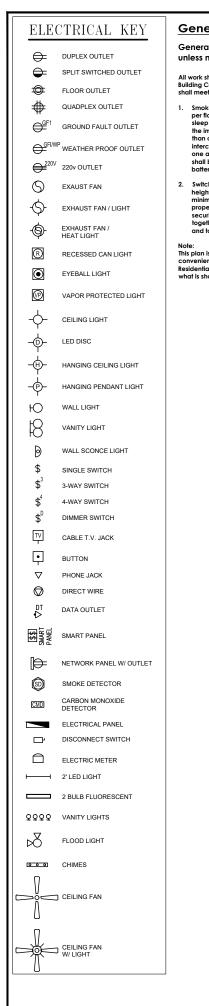

General Power and Lighting:

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All work shall be installed per the current NC Residential Building Code, and the National Electric Code. Alarm devices shall meet NFPA 72.

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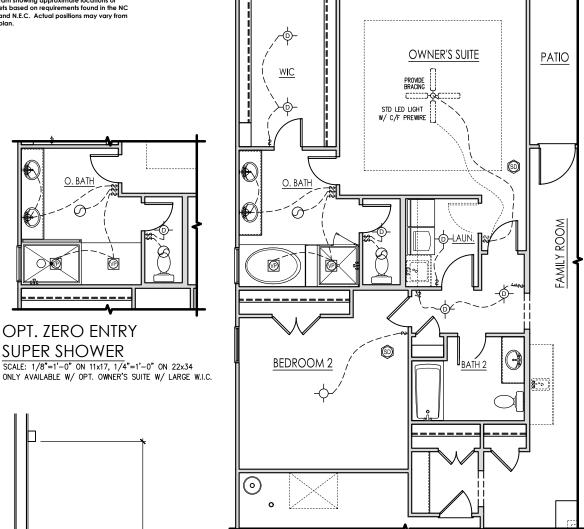
O. BATH

ELECTRICAL BOX HEIGHTS


OPT. ZERO ENTRY

SUPER SHOWER


This plan is a diagram showing approximate locations of convenience outlets based on requirements found in the NC Residential Code and N.E.C. Actual positions may vary from what is shown on plan.




OPT. OWNER'S SUITE W/ LARGE WALK-IN CLOSET SCALE: 1/8"=1'-0" ON 11x17, 1/4"=1'-0" ON 22x34

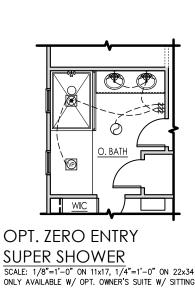

SCALE: 1/8"=1'-0" ON 11x17, 1/4"=1'-0" ON 22x34 ONLY AVAILABLE W/ OPT. OWNER'S SUITE W/ SITTING ROOM

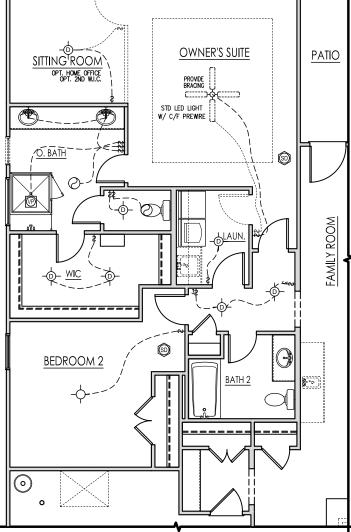


OPT. OWNER'S SUITE W/ SITTING ROOM SCALE: 1/8"=1'-0" ON 11x17, 1/4"=1'-0" ON 22x34

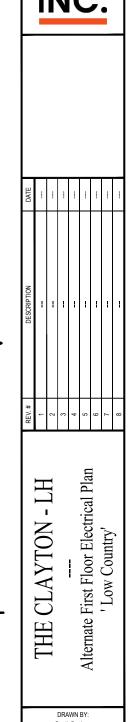



South Designs

ISSUE DATE: CURRENT REVISION DATE

1/8" = 1'-0"

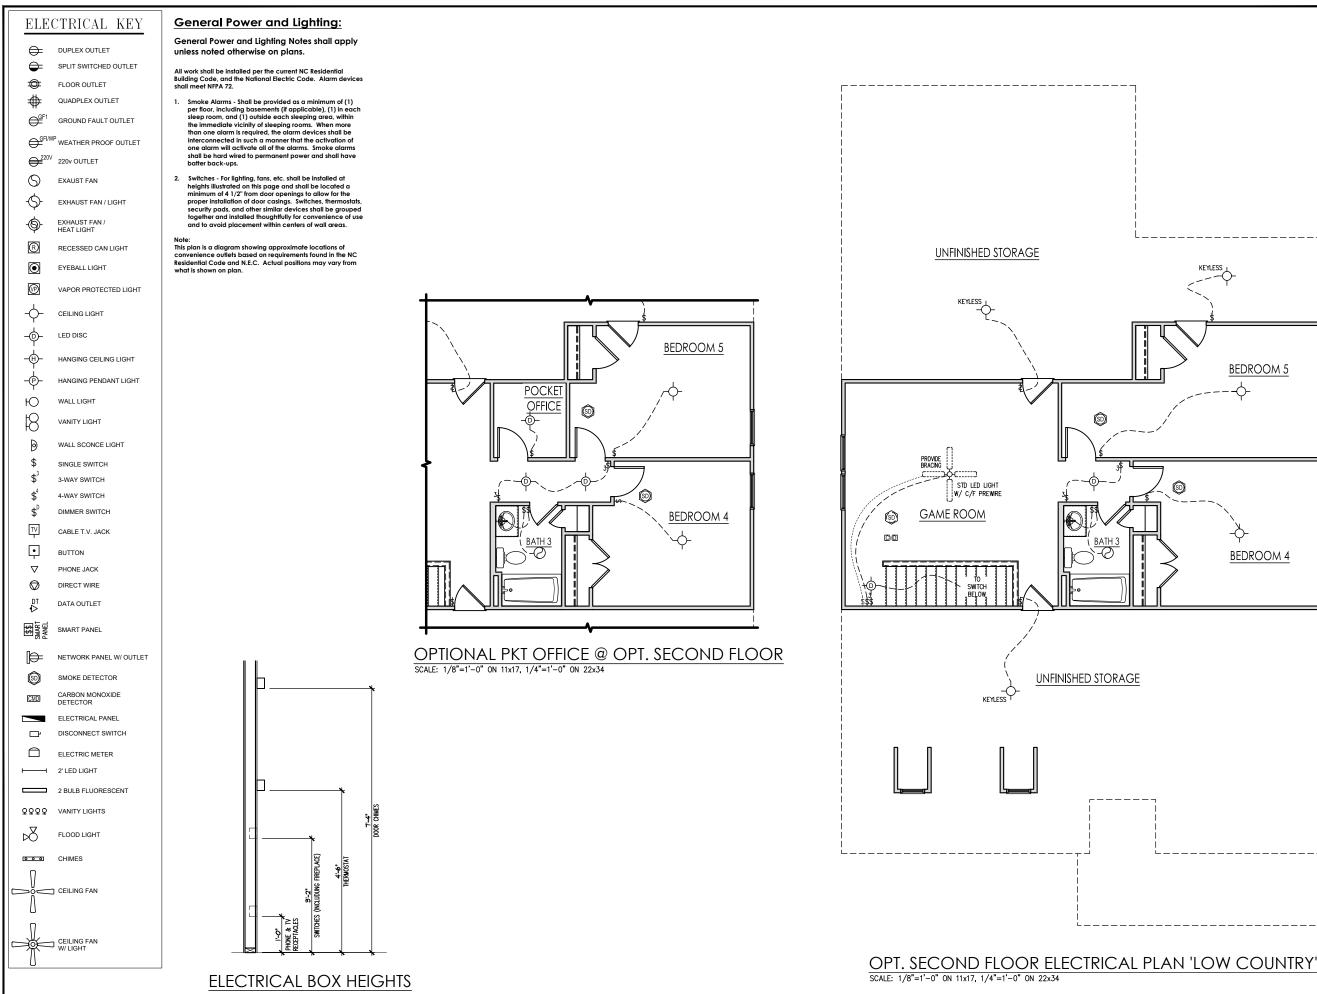

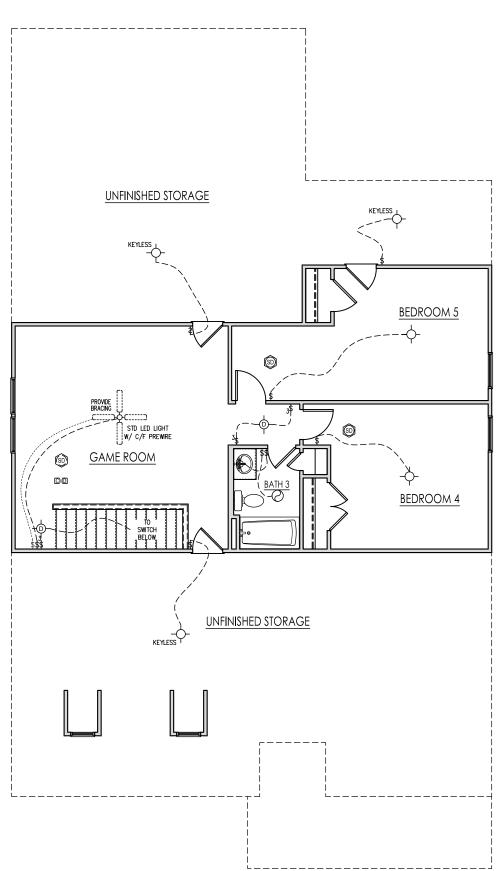

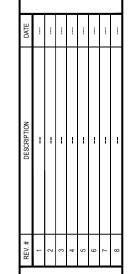

-LH CLAYTON THE


Second Floor Electrical 'Low Country'


DRAWN BY: South Designs


ISSUE DATE: 7/1/2021


CURRENT REVISION DATE

1/8" = 1'-0"

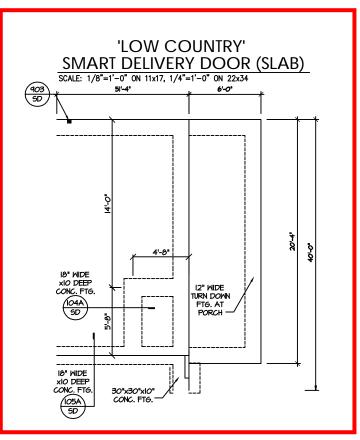

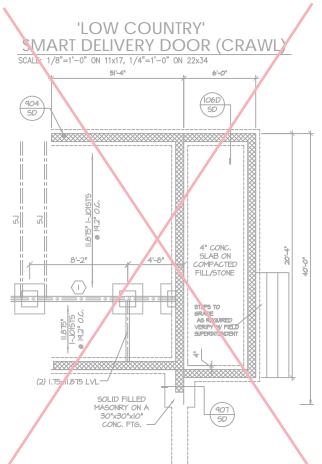

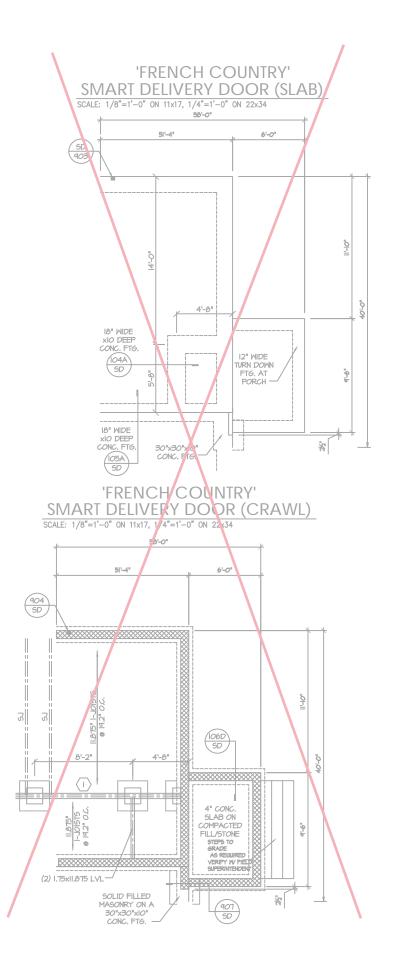

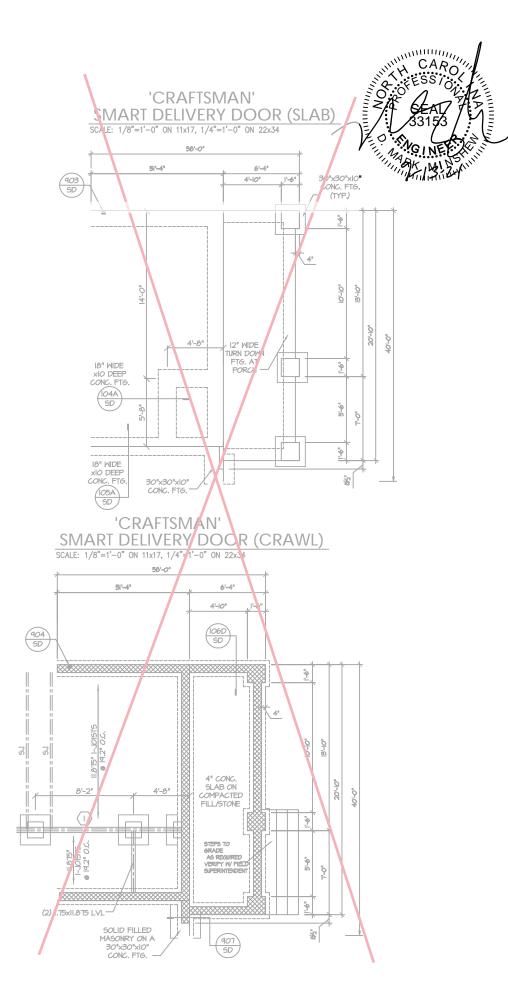

PROJECT # 21-2967-GL

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Seal does not include construction means, methods, technique sequences, procedures or safety precautions.
Any devations or discrepancies on plans are to be brought to immediate attention of Southern Engineers, Failure to do so void Southern Engineers Failure to do so void Southern Engineers liability.

Southern Engineers, P.A. 3716 Benson Drive, Raleigh, NC 27609 Phone: (919) 878-1617 License: C-4772 www.southernengineers.com

AJ DESIGNS

Plan 01
Garage Left
NEW HOME, INC.

S-1.5

PROJECT # 21-2967-GL


s not include construction means, methods, techniques, se, procedures or safety precautions. iations or discrepancies on plans are to be brought to the ite attention of Southern Engineers. Failure to do so will them Engineers liability.


Southern Engineers, P.A. 3716 Benson Drive, Raleigh, NC 27609 Phone: (919) 878-1617 License: C-4772 www.southernengineers.com


AJ DESIGNS


Plan 01
Garage Left
NEW HOME, INC.


S-2.2

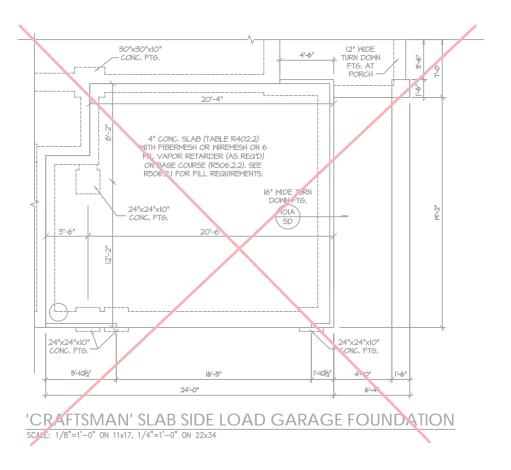


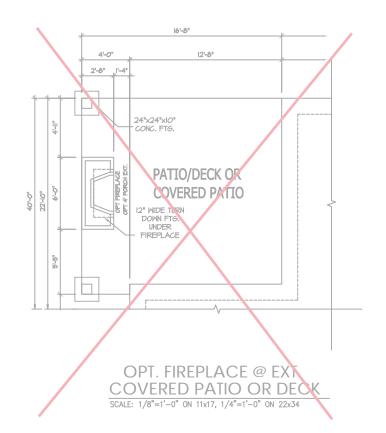


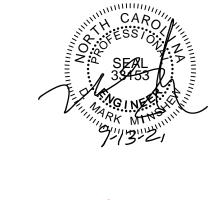

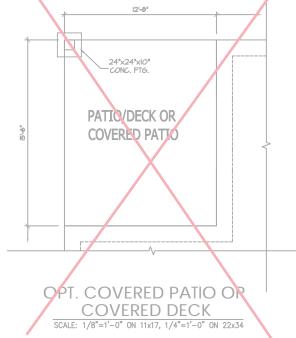

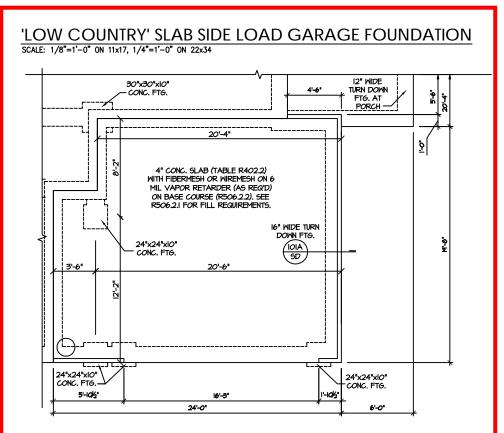

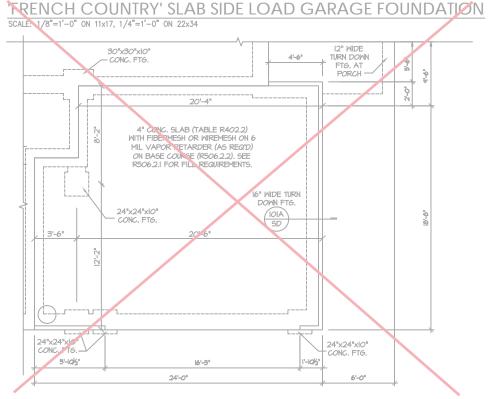

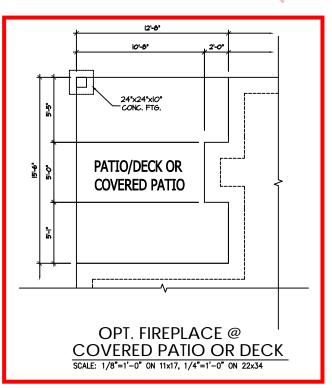

Plan 01
Garage Left
NEW HOME, INC.

DESIGNS

A

S-2.4

PROJECT # 21-2967-GL

Enginee's Seat appures ouny to structural compounds.

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Seal is valid for projects permitted one year from date of seal. Use of these plans constitutes approval of terms & conditions as defined in the customer agreement.

Southern Engineers, P.A. Scale Scale State Phone: (919) 878-1617 Scale Www.southernengineers.com

FRAMING NOTES

NC (2018 NCRC): Wind: 115-120 mph

- BRACING METHOD AND TYPE: CONTINUOUSLY SHEATHED MGP; CS-MGP, NOTE THAT THE WALL BRACING AMOUNT PROVIDED ON THE PLANS (DETAILS AND SPECIFICATIONS) IS GREATER THAN THE AMOUNT OF WALL BRACING REQUIRED BY SECTION R602.10 OF THE CODE. SEE NOTES BELOW FOR DETAILS AND SPECIFICATIONS FOR WALL BRACING AND WALL FRAMING
- EXTERIOR WALL SHEATHING: WALLS SHALL BE BRACED BY SHEATHING WALLS ON ALL STORIES WITH MOOD STRUCTURAL PANEL SHEATHING (MSP) (EXPOSURE B: 7/16". EXPOSURE C: 15/32"). SHEATHING SHALL BE ATTACHED WITH & NAILS AT A 6"/12" NAILING PATTERN (6" OC AT PANEL EDGES AND 12" OC AT INTERMEDIATE SUPPORTS). INSTALL BLOCKING AT ALL PANEL EDGES.
- 3. WSP SHEATHING SHALL EXTEND TO THE UPPERMOST DOUBLE BEARING PLATE, BLOCK AT ROOF PER SECTION R602.10.45 AND ATTACH BRACED WALLS PER CODE, WEP SHEATHING BETWEEN FLOORS SHALL BE SPLICED ALONG CONTINUOUS BAND OR THE WSP SHEATHING MAY BE SPLICED ACROSS STUDS (CONTINUOUS ACROSS FLOOR SYSTEM) WITH BLOCKING AT PANEL EDGES. (MINIMUM 12" BEYOND FLOOR BREAK) OR
- 4. "HD" = HOLDOWN: HOLD-DOWN DEVICE (NOTED AS "HD" ON PLANS) SHALL BE AN 800 POUND CAPACITY ASSEMBLY AS NOTED ON PLANS. SEE DETAILS FOR HD ASSEMBLY.
- **SCRUND/FIRST FLOOR: USE "HD HOLD-DOWN DETAIL" ON SD SHEET (OR EQUIV.)

 **UPPER FLOORS: ATTACH BASE OF KING STUD WITH A SIMPSON CS22 STRAP DOWN
 ACROSS THE BAND AND DOWN TO A STUD BELOW OR HEADER BELOW. EXTEND STRAP 7" MIN ALONG EACH STUD (OR HEADER) AND ATTACH EACH END W (1) 8d
- INTERIOR BRACED WALL: (NOTED AS "IBM" ON PLANS) ATTACH I/2" GYPSUM BOARD (GB) ON EACH SIDE OF WALL WITH A MIN. OF 5d COOLER NAILS OR #6 SCREWS 7" O.C. ALONG THE EDGES AND AT INTERMEDIATE SUPPORTS.
- 6. INTERIOR BRACED WALL-WOOD STRUCTURAL PANEL: (NOTED AS "IBW-WSP" ON PLANS). ATTACH ONE SIDE WITH 1/6" WSP SHEATHING WITH 8d NAILS AT A 6"/12" NAILING PATTERN (6" OC AT PANEL EDGES AND 12" OC AT INTERMEDIATE SUPPORTS). INSTALL BLOCKING AT ALL PANEL EDGES, ATTACH 6B OVER MEP AS REQUIRED, ATTACH OPPOSITE SIDE WITH 1/2" GB WITH A MIN. OF 5d COOLER NAILS OR #6 SCREMS @ 7" OC ALONG THE EDGES AND AT INTERMEDIATE SUPPORTS.

HEADER/BEAM & COLUMN NOTES

- ALL EXTERIOR AND LOAD BEARING HEADERS SHALL BE MIN. (2)2x6 (4" WALL) OR (3)2x6 (6" WALL) WITH (I) SUPPORT STUD, UNLESS NOTED OTHERWISE.
- THE NUMBER SHOWN AT BEAM AND HEADER SUPPORTS INDICATES THE NUMBER OF SUPPORT STUDS REQUIRED IN STUD POCKET OR COLUMN, THE NUMBER OF KING STUDS AT EACH END OF HEADERS IN EXTERIOR WALLS SHALL BE ACCORDING TO ITEM "d" IN TABLE R602.3(5) OR AS BELOW PER NCDOI COMMENTARY "KING STUDS AT WALL OPENINGS"
- REVISED I-9-2020: UP TO 3' SPAN: (I) KING STUD
- OVER 3' UP TO 6' SPAN: (2) KING STUDS OVER 6' UP TO 9' SPAN: (3) KING STUDS
- OVER 9' UP TO 12' SPAN: (4) KING STUDS OVER 12' UP TO 15' SPAN: (5) KING STUDS

TRUSS SYSTEM REQUIREMENTS

NC (2018 NCRC): Wind: 115-120 mph

- TRUSS SYSTEM LAYOUTS (PLACEMENT PLANS) SHALL BE DESIGNED IN ACCORDANCE WITH SEALED STRUCTURAL PLANS, ANY NEED TO CHANGE TRUSSES SHALL BE COORDINATED WITH SOUTHERN
- TRUSS SCHEMATICS (PROFILES) SHALL BE PREPARED AND SEALED BY TRUSS MANUFACTURER.
- ALL TRUSSES SHALL BE DESIGNED FOR BEARING ON SPF #2 OR #3 PLATES OR LEDGERS (UNO).
- ALL REQUIRED ANCHORS FOR TRUSSES DUE TO UPLIFT OR BEARING SHALL MEET THE REQUIREMENTS AS SPECIFIED ON THE TRUSS

MOOD I-JOISTS
(SHALL BE ONE OF THE FOLLOWING):
TII 210 BY TRUS JOIST
LPI 20 PLUS BY LP


- BCI 5000s I.8 BY BC
- ALL WOOD I-JOISTS SHALL BE INSTALLED ACCORDING TO MANUFACTURER'S SPECIFICATIONS
- INSTALL SQUASH BLOCKS, WEB STIFFENERS, ETC. AS REQUIRED BY AND ACCORDING TO THE I-JOIST MANUFACTURER'S SPECIFICATIONS AND
- HANGERS FOR I-JOISTS ARE THE RESPONSIBILITY OF THE I-JOIST SUPPLIER.
- FLOOR TRUSSES BY MANUFACTURER MAY BE


PORCH POST NOTES:

• 4"x4" (6"x6") TRT'D POST (OR EQUAL).

- ATTACH TRUSSES (RAFTERS) AT PORCH WITH HURRICANE CONNECTORS.
- POST CAP: SIMPSON AC4-MAX (AC6-MAX)
 POST CAP AT CORNER: (2) SIMPSON LCE4
- (MITER HEADER AT CORNER). HIGH WIND; ADD (I) SIMPSON H6.
- 3. POST BASE: SIMPSON ABU44 (ABU66).
 31. MONO; %" ANCHOR (EMBED T!)
 32. CMU; %" ANCHOR (EXTEND TO FOOTING HIGH NIND ONLY)
- POST BASE: WOOD FOUNDATION: (2) SIMPSON
 CSIG STRAPS AT POSTS. EXTEND 12" ONTO
 EACH POST (UPPER AND LOWER) OR TO GIRDER.
- NOTE: EQUIVALENT POST CAP AND BASE ACCEPTABLE.



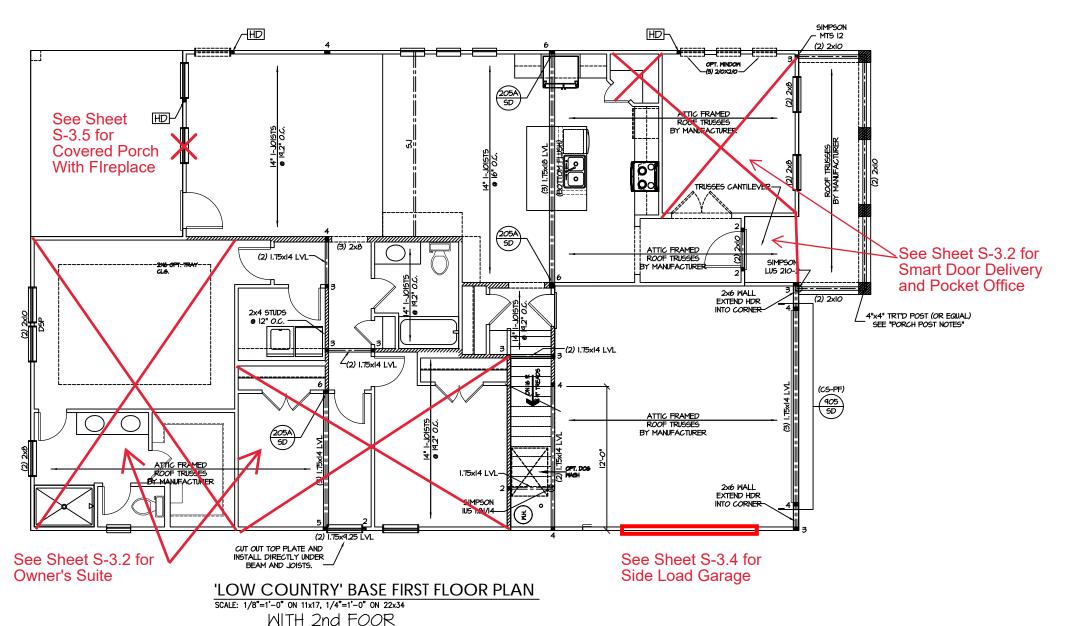

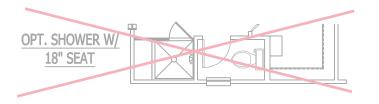


PROJECT # 21-2967-GL


ons. is are to be brought to the eers. Failure to do so will


P.A. 27609 Southern Engineers, F 3716 Benson Drive, Raleigh, NC 2-Phone: (919) 878-1617

www.southernengineers.com

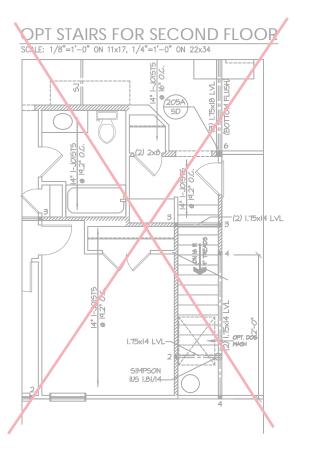




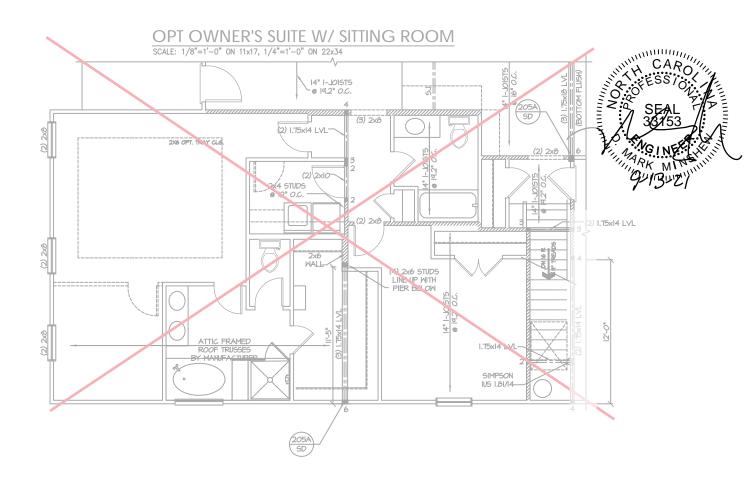

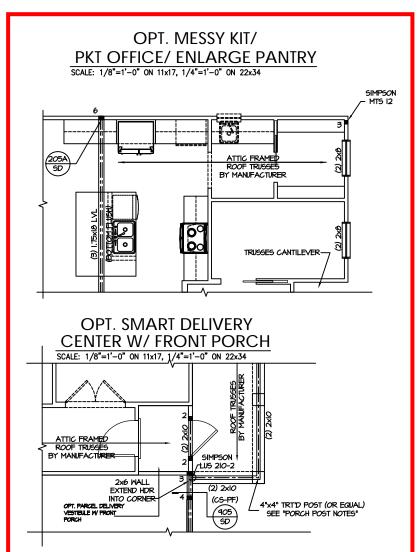



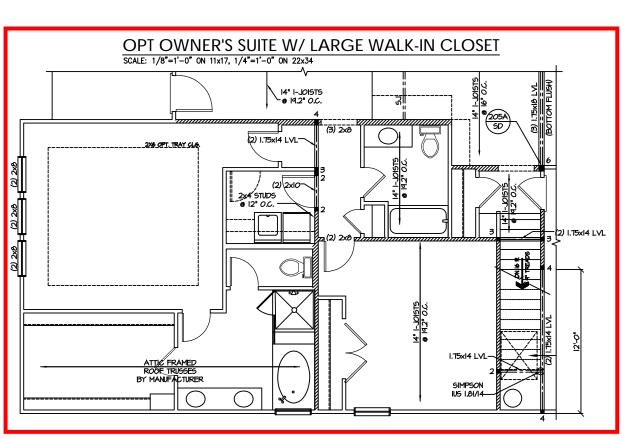

PROJECT # 21-2967-GL

Engineers seal applies only to structural components on this document.

Seal does not include construction means, methods, techniques, sequences, procedures or safety precautions.

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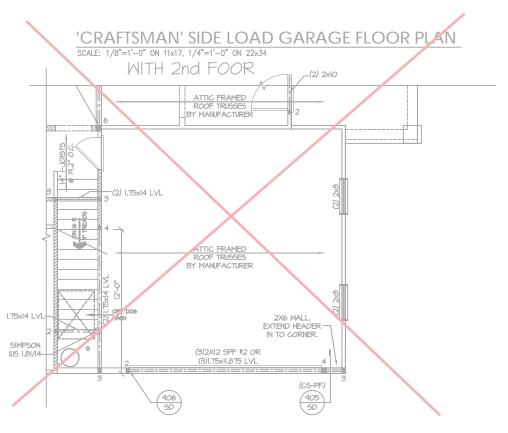
Seal is valid for projects permitted one year from date of seal. Use of these plans constitutes approval of terms & conditions as defined in the customer agreement.


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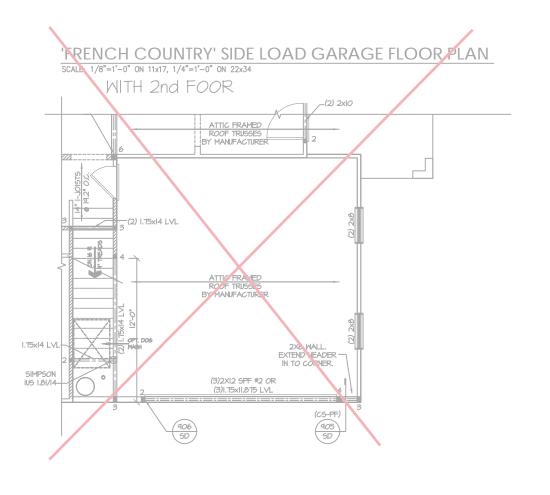
NEW HOME, INC. Plan 01 Garage Left

S-3.2







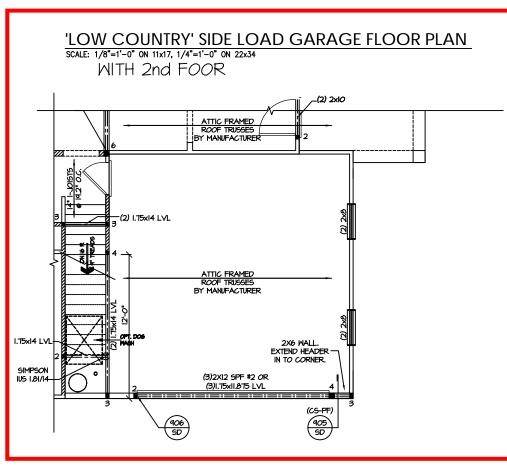

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S-3.4



- PORCH POST NOTES:

 4 *'x4" (6'x6") TRITO POST (OR EQUAL).

 ATTACH TRUSSES (RAFTERS) AT PORCH WITH HURRICANE CONNECTORS.

 1. POST CAP, SIMPSON AC4-MAX (AC6-MAX)


 2. POST CAP AT CORNER; (2) SIMPSON LCE4 (MITER HEADER AT CORNER), HIGH MIND; ADD (1) SIMPSON H6.


 3. POST BASE; SIMPSON ABU44 (ABU66).


 31. MOND; %" ANCHOR (EMBED T")

 32. CMJ; %" ANCHOR (EXTEND TO FOOTING HIGH MIND ONLY)

 4. POST BASE; WOOD FOUNDATION; (2) SIMPSON CSI6 STRAPS AT POSTS, EXTEND 12" ONTO EACH POST (UPPER AND LOWER) OR TO GIRDER.
- <u>NOTE:</u> EQUIVALENT POST CAP AND BASE ACCEPTABLE.

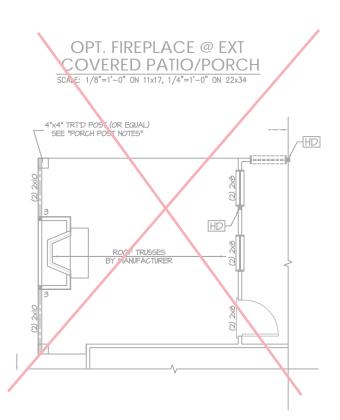

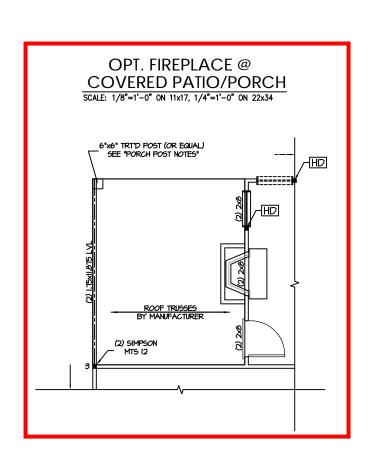

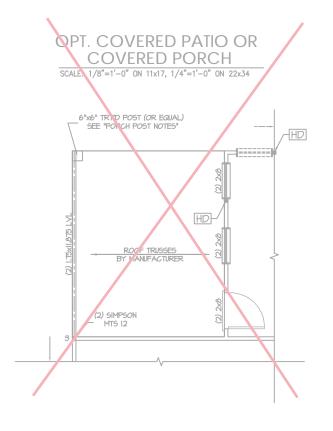

Engineers seal applies only to structural components on this document.

document.
Seal does not include construction means, methods, techniques, sequences, procedures or safety precautions.

Any deviations or discrepancies on plans are to be brought to the immediate attention of Southern Engineers. Failure to do so will void Southern Engineers liability.

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S-3.5

FRAMING NOTES

NC (2018 NCRC): Wind: 115-120 mph

- BRACING METHOD AND TYPE: CONTINUOUSLY SHEATHED WSP: CS-MSP. NOTE THAT THE WALL BRACING AMOUNT PROVIDED ON THE CS-YEP. NOTE INAT THE WALL BRACING AMOUNT MCVILLED ON THE PLANS (DETAILS AND SPECIFICATIONS) IS GREATER THAN THE AMOUNT OF WALL BRACING REQUIRED BY SECTION R602.10 OF THE CODE, SEE NOTES BELOW FOR DETAILS AND SPECIFICATIONS FOR WALL BRACING AND WALL FRAMING.
- 2. EXTERIOR WALL SHEATHING: WALLS SHALL BE BRACED BY SHEATHING WALLS ON ALL STORIES WITH WOOD STRUCTURAL PANEL SHEATHING (WSP) (EXPOSURE B. 7/16*, EXPOSURE C. 15/32*), SHEATHING SHALL BE ATTACHED WITH & NAILS AT A 6*/12* NAILING PATTERN (6" OC AT PANEL EDGES AND 12" OC AT INTERMEDIATE SUPPORTS). INSTALL BLOCKING AT ALL PANEL EDGES.
- 3. WSP SHEATHING SHALL EXTEND TO THE UPPERMOST DOUBLE BEARING PLATE. BLOCK AT ROOF PER SECTION R602.IO.4.5 AND ATTACH BRACED WALLS PER CODE. WSP SHEATHING BETWEEN FLOORS SHALL BE SPLICED ALONG CONTINUOUS BAND OR THE WSP SHEATHING MAY BE SPLICED ACROSS STUDS (CONTINUOUS ACROSS FLOOR SYSTEM) WITH BLOCKING AT PANEL EDGES. (MINIMUM 12" BEYOND FLOOR BREAK) OR OTHER APPROVED METHOD.
- 4. "HD" = HOLDOWN. HOLD-DOWN DEVICE (NOTED AS "HD" ON PLANS)
 SHALL BE AN 800 POUND CAPACITY ASSEMBLY AS NOTED ON
 PLANS, SEE DETAILS FOR HD ASSEMBLY.

 #46ROUND/FIRST FLOOR. USE "HD HOLD-DOWN DETAIL" ON SD
- SHEET (OR EQUIV.)
- SHEET (O'R EGUIV.)

 ""UPPER ELOORS, ATTACH BASE OF KING STUD MITH A SIMPSON
 CS22 STRAP DOWN ACROSS THE BAND AND DOWN TO A STUD
 BELOW O'R HEADER BELOW. EXTEND STRAP 7" MIN ALONG EACH
 STUD (O'R HEADER) AND ATTACH EACH END W (1) 8d NAILS.
- 5. INTERIOR BRACED WALL: (NOTED AS "IBM" ON PLANS) ATTACH 1/2" GYPSUM BOARD (GB) ON EACH SIDE OF WALL WITH A MIN. OF 5d COOLER NAILS OR #6 SCREWS @ 7" O.C. ALONG THE EDGES AND AT
- 6. INTERIOR BRACED WALL-WOOD STRUCTURAL PANEL: (NOTED AS "IBN-MSP" ON PLANS). ATTACH ONE SIDE WITH 1/6" MSP SHEATHING WITH 8d NAILS AT A 6"/12" NAILING PATTERN (6" OC AT PANEL EDGES AND 12" OC AT INTERMEDIATE SUPPORTS). INSTALL BLOCKING AT ALL PANEL EDGES, ATTACH 6B OVER WEP AS REQUIRED. ATTACH OPPOSITE SIDE WITH 1/2" 6B WITH A MIN. OF 5d COOLER NAILS OR \$6 SCREWS © 1" OC ALONG THE EDGES AND AT

HEADER/BEAM & COLUMN NOTES


- ALL EXTERIOR AND LOAD BEARING HEADERS SHALL BE MIN. (2)2x6 (4" WALL) OR (3)2x6 (6" WALL) WITH (1) SUPPORT STUD, UNLESS NOTED OTHERWISE.
- 2. THE NUMBER SHOWN AT BEAM AND HEADER SUPPORTS INDICATES THE NUMBER OF SUPPORT STUDS REQUIRED IN STUD POCKET OR COLUMN. THE NUMBER OF KING STUDS AT EACH END OF HEADERS IN EXTERIOR WALLS SHALL BE ACCORDING TO ITEM "d" IN TABLE R602.3(5) OR AS BELOW PER NCDOI COMMENTARY "KING STUDS AT WALL OPENINGS" REVISED I-4-2020: UP TO 3' SPAN: (I) KING STUD
- OVER 3' UP TO 6' SPAN: (2) KING STUDS OVER 6' UP TO 9' SPAN: (3) KING STUDS
- OVER 12' UP TO 15' SPAN: (5) KING STUDS

TRUSS SYSTEM REQUIREMENTS

NC (2018 NCRC): Wind: 115-120 mph

- TRUSS SYSTEM LAYOUTS (PLACEMENT PLANS) SHALL BE DESIGNED IN ACCORDANCE WITH SEALED STRUCTURAL PLANS, ANY NEED TO CHANGE TRUSSES SHALL BE COORDINATED WITH SOUTHERN
- TRUSS SCHEMATICS (PROFILES) SHALL BE PREPARED AND SEALED BY TRUSS MANUFACTURER.
- ALL TRUSSES SHALL BE DESIGNED FOR BEARING ON SPF #2 OR #3 PLATES OR LEDGERS (UNO).
- ALL REQUIRED ANCHORS FOR TRUSSES DUE TO UPLIFT OR BEARING SHALL MEET THE REQUIREMENTS AS SPECIFIED ON THE TRUSS SCHEMATICS.



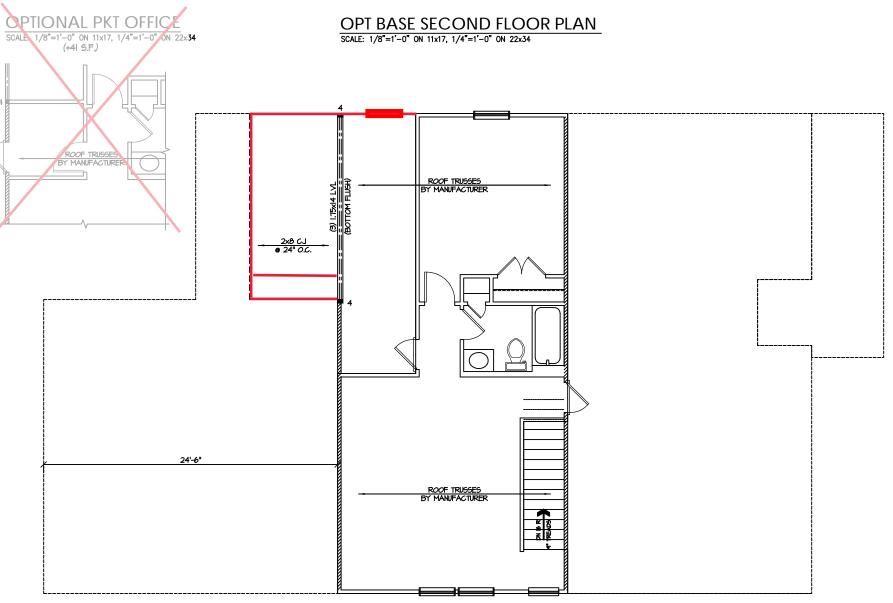

e construction means, methods, techniques, so or safety precautions. crepancies on plans are to be brought to the of Southern Engineers. Failure to do so will


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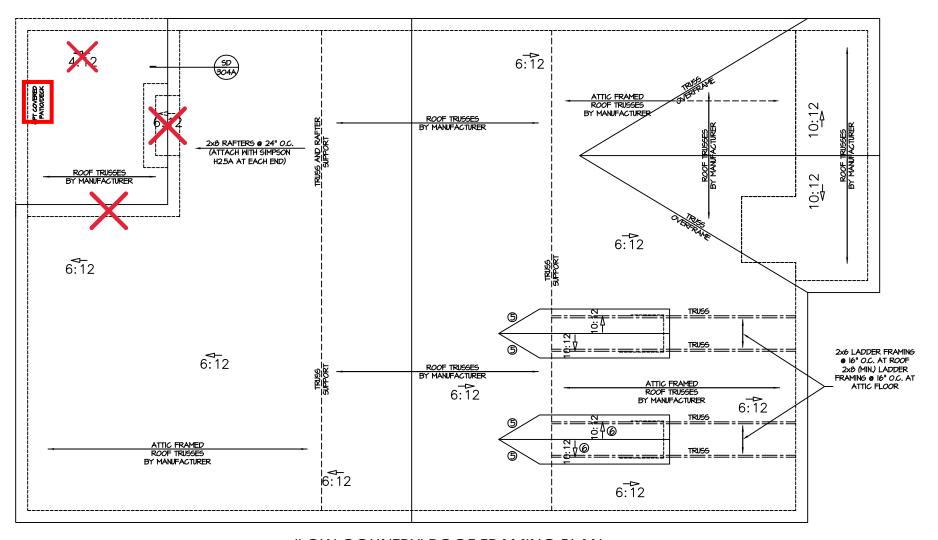
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DESIGNS AJ

NEW HOME, IN Garage Left Plan 01





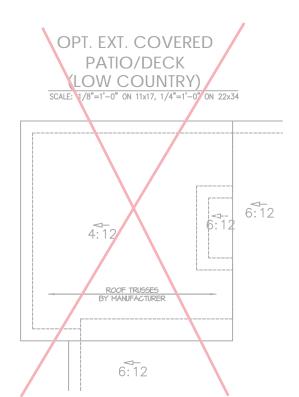

'LOW COUNTRY' ROOF FRAMING PLAN SCALE: 1/8"=1'-0" ON 11x17, 1/4"=1'-0" ON 22x34

WITH 2nd FOOR


PROJECT # 21-2967-GL


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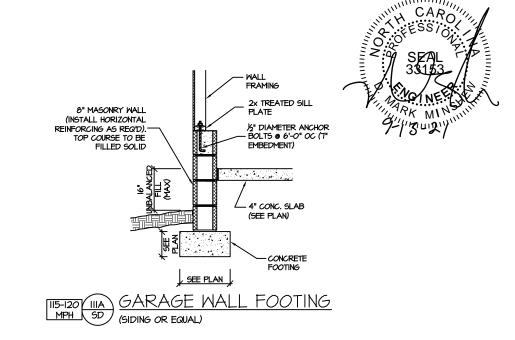
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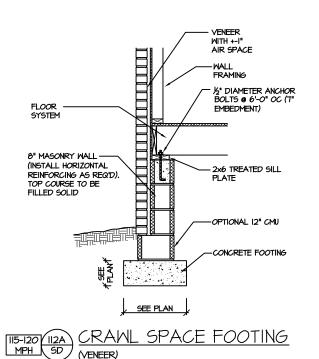
NEW HOME, INC. Plan 01 Garage Left


S-5.1





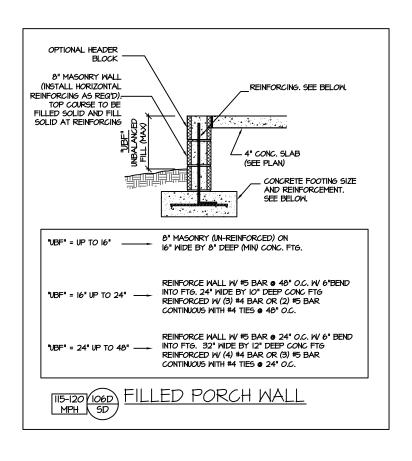


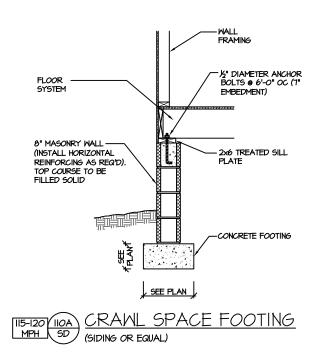

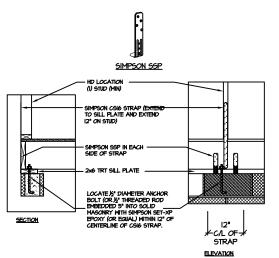



NOTE: SIMPSON DTT-IZ IS ACCEPTABLE ALTERNATE NOTE: ALTERNATE HD HOLD-DOWN DEVICES OR SYSTEMS MAY BE USED TO MEET THE CODE REQUIRED 800 LB CAPACITY IN LIEU OF THE ABOVE DETAIL.

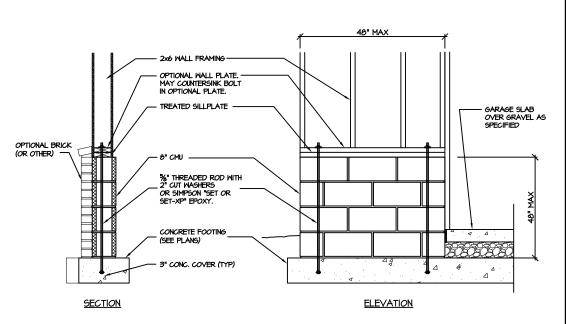

GARAGE 'WING WALL' REINFORCING PER IRC FIGURE R602.IO.4.3

CRAWL SPACE FOUNDATION

PROJECT # 21-2967

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3. not include construction means, methods, lechniques, es, procedures or safety precautions.

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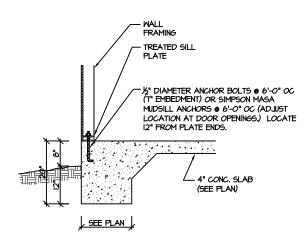
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> **DESIGNS** AJ


01 PLAN

NEW HOME, INC.


SD






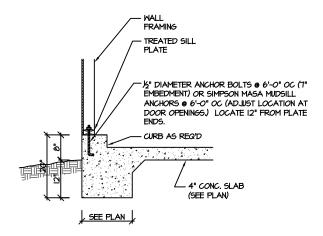





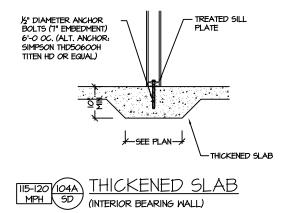

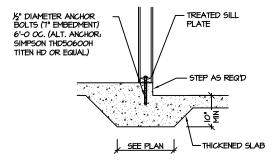



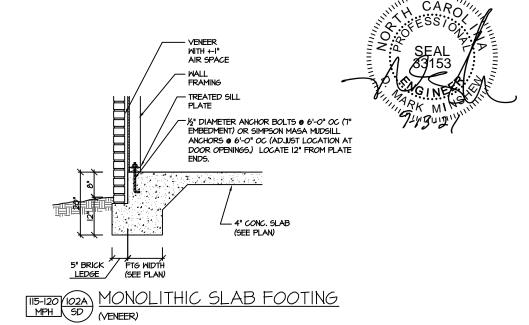

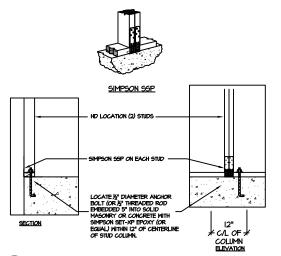

BRACED WALL END CONDITION "HD" HOLD-DOWN DETAIL

NOTE: SIMPSON DTT-IZ IS ACCEPTABLE ALTERNATE
NOTE: ALTERNATE HD HOLD-DOWN DEVICES OR SYSTEMS MAY
BE USED TO MEET THE CODE REQUIRED 800 LB CAPACITY IN
LIEU OF THE ABOVE DETAIL.

SLAB FOUNDATION

PROJECT # 21-2967

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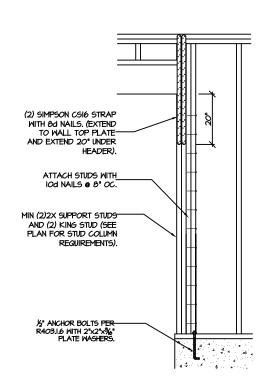
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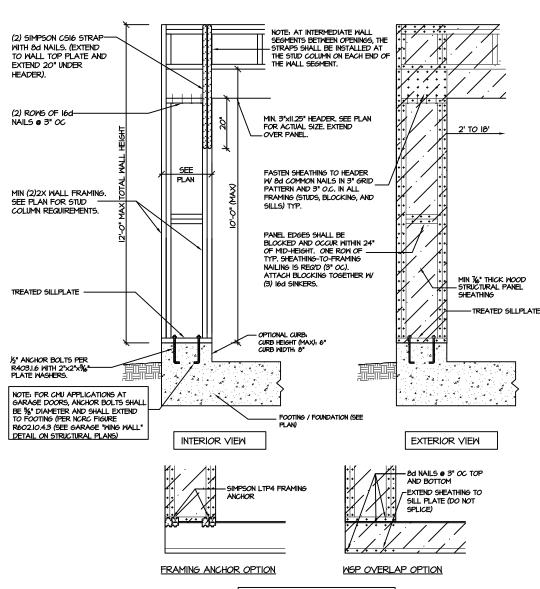
PLAN 01
NEW HOME, INC.

SD



CS-PF: END CONDITION DETAIL (FOR USE WITH SINGLE CS-PF CONDITION) DETAIL AND APPLICATION BASED ON NORC FIGURE

R602.IO.I - PORTAL FRAME CONSTRUCTION



CS-PF - OVER WOOD FLOOR

CS-PF: CONTINUOUS PORTAL FRAME CONSTRUCTION DETAIL AND APPLICATION BASED ON NORC FIGURE R602.IO.I - PORTAL FRAME CONSTRUCTION



STRUCTURAL NOTES NC (2018 NCRC): Wind: 115-120 mph

- ENGINEER'S SEAL APPLIES ONLY TO STRUCTURAL COMPONENTS INCLUDING ROOF RAFTERS, HIPS, ENGINEER'S SEAL APPLIES ONLY TO STRUCTURAL COMPONENTS INCLUDING ROOF RAFTERS, HIPS, VALLEYS, RIDGES, FLOORS, WALLS, BEANS AND HEADERS, COLUMNS, CANTILEVERS, OFFSET LOAD BEARING WALLS, PIER & GIRDER SYSTEM, FOOTING, AND PILING SYSTEM. ENGINEER'S SEAL DOES NOT CERTIFY DIMENSIONAL ACCURACY OR ARCHITECTURAL LAYOUT INCLUDING ROOF SYSTEM. ALL REQUIREMENTS FOR PROFESSIONAL CERTIFICATION SHALL BE PROVIDED BY THE APPROPRIATE PROFESSIONAL. SOUTHERN ENGINEERS, P.A. CERTIFIES ONLY THE STRUCTURAL COMPONENTS AS SPECIFICALLY STATED.
- 2. ALL CONSTRUCTION SHALL CONFORM TO THE LATEST REQUIREMENTS OF THE 2018 NC RESIDENTIAL CODE, PLUS ALL LOCAL CODES AND REGULATIONS. THE STRUCTURAL ENGINEER IS NOT RESPONSIBLE FOR, AND WILL NOT HAVE CONTROL OF, CONSTRUCTION MEANS, METHODS, TECHNIQUES, SEQUENCES OR PROCEDURES, OR FOR SAFETY PRECAUTIONS AND PROGRAMS IN CONNECTION WITH THE CONSTRUCTION WORK, NOR WILL THE ENGINEER BE RESPONSIBLE FOR THE CONTRACTOR'S FAILURE TO CARRY OUT THE CONSTRUCTION WORK IN ACCORDANCE WITH THE CONTRACT DOCUMENTS, "CONSTRUCTION REVIEW" SERVICES ARE NOT PART OF OUR CONTRACT. ALL MEMBERS SHALL BE FRAMED ANCHORED, TIED AND BRACED IN ACCORDANCE WITH GOOD CONSTRUCTION PRACTICE AND THE BUILDING CODE.
- DESIGN LOADS (LISTED AS: LIVE LOAD, DEAD LOAD, DEFLECTION) ROOMS OTHER THAN SLEEPING ROOMS: (40 PSF, 10 PSF, L/360)
- SLEEPING ROOMS: (30 PSF, IO PSF, L/360)
- ATTIC WITH PERMANENT STAIR: (40 PSF. IO PSF. L/360) ATTIC WITHOUT PERMANENT STAIR: (20 PSF, IO PSF, L/360)
- ATTIC WITHOUT STORAGE: (10 PSF, 10 PSF, L/240)
- STAIRS: (40 PSF, IO PSF, L/360) EXTERIOR BALCONIES: (60 PSF, IO PSF, L/360)
- DECKS: (40 PSF, 10 PSF, L/360)
- GUARDRAILS AND HANDRAILS: (200 LBS)
 PASSSENGER VEHICLE GARAGES: (50 PSF, IO PSF, L/360)
- FIRE ESCAPES: (40 PSF, 10 PSF, L/360)
- SNOW: (20 PSF)
- WALLS SHALL BE BRACED BY SHEATHING WALLS ON ALL STORIES WITH WOOD STRUCTURAL PANELS. SEE FRAMING NOTES FOR THICKNESS AND NAILING REQUIREMENTS.
- 5. SEE APPENDIX M (DCA6) FOR EXTERIOR DECK REQUIREMENTS INCLUDING ATTACHMENTS FOR LATERAL LOADS.
- CONCRETE SHALL HAVE A MINIMUM 28 DAY STRENGTH OF 3000 PSI AND A MAXIMUM SLUMP OF 5 INCHES UNLESS NOTED OTHERWISE (UNO). AIR ENTRAINED PER TABLE 402.2. ALL CONCRETE SHALL BE PROPORTIONED, MIXED, HANDLED, SAMPLED, TESTED, AND PLACED IN ACCORDANCE WITH ACI STANDARDS, ALL SAMPLES FOR PUMPING SHALL BE TAKEN FROM THE EXIT END OF THE PUMP. CONTROL JOINTS IN SLABS SHALL BE SPACED ON A GRID OF +-30 TIMES THE DEPTH (D). CONTROL JOINTS SHALL BE SAWCUT TO A DEPTH OF I/D. (I.E. 4" CONCRETE SLABS SHALL HAVE 1/4" DEEP CONTROL JOINTS SAWCUT IN SLAB ON A +-10'-0" x +-10'-0" GRID).
- 7. ALLOWABLE SOIL BEARING PRESSURE ASSUMED TO BE 2000 PSF. THE CONTRACTOR MUST CONTACT A GEOTECHNICAL ENGINEER AND THE STRUCTURAL ENGINEER IF UNGATISFACTORY SUBSURFACE CONDITIONS ARE ENCOUNTERED. THE SURFACE AREA ADJACENT TO THE FOUNDATION WALL SHALL BE PROVIDED WITH ADEQUATE DRAINAGE, AND SHALL BE GRADED 50 AS TO DRAIN SURFACE WATER AWAY FROM FOUNDATION WALLS.
- 8. ALL FRAMING LUMBER SHALL BE SPF #2 (Fb = 875 PSI) UNLESS NOTED OTHERNISE (UNO). ALL TREATED LUMBER SHALL BE SYP # 2. PLATE MATERIAL MAY BE SPF # 3 OR SYP #3 (Fc(perp) =
- 9.
 L.V.L. SHALL BE LAMINATED VENEER LUMBER: Fb=2600 PSI, Fv=265 PSI, E=1.9xi0 PSI.

 9.
 P.S.L. SHALL BE PARALLEL STRAND LUMBER: Fb=2900 PSI, Fv=290 PSI, E=2.0xi0 PSI.

 9.
 L.S.L. SHALL BE LAMINATED STRAND LUMBER: Fb=2250 PSI, Fv=400 PSI, E=1.55xi0 PSI.
 INSTALL ALL CONNECTIONS PER MANUFACTURERS INSTRUCTIONS
- IO. ALL ROOF TRUSS AND I-JOIST LAYOUTS SHALL BE PREPARED IN ACCORDANCE WITH THE SEALED STRUCTURAL DRAWINGS, TRUSSES AND I-JOISTS SHALL BE INSTALLED ACCORDING TO THE MANUFACTURE'S SPECIFICATIONS, ANY CHANGE IN TRUSS OR I-JOIST LAYOUT SHALL BE
- ALL STRUCTURAL STEEL SHALL BE ASTM A-36. STEEL BEAMS SHALL BE SUPPORTED AT EACH END WITH A MINIMUM BEARING LENGTH OF 3 1/2" INCHES AND FULL FLANGE WIDTH, PROVIDE SOLID BEARING FROM BEAM SUPPORT TO FOUNDATION. BEAMS SHALL BE ATTACHED TO EACH SUPPORT WITH TWO LAG SCREWS (I/2" DIAMETER x 4" LONG), LATERAL SUPPORT IS CONSIDERED SUPPORT WITH TWO LAG SECTION (1/2 DIAMETERS X + LONG), L'ALERAL SUPPORT IS COMMITTED ADEQUATE PROVIDING THE JOILE PLATE AND SOILE PLATE IS NAILED OR BOLTED TO THE BEAM FLANGE • 48" O.C. ALL STEEL TUBING SHALL BE ASTM A500.
- 12. REBAR SHALL BE DEFORMED STEEL, ASTM615, GRADE 60. LAP ALL REBAR SPLICES 30 BAR
- 13. FLITCH BEAMS SHALL BE BOLTED TOGETHER USING (2) ROWS OF 1/2" DIAMETER BOLTS (ASTM A325) WITH WASHERS PLACED UNDER THE THREADED END OF BOLT. BOLTS SHALL BE SPACED AT 24" O.C. (MAX), AND STAGGERED AT THE TOP AND BOTTOM OF BEAM (2" EDGE DISTANCE), WITH 2 BOLTS LOCATED AT 6" FROM EACH END.
- 14. BRICK LINTELS (WHEN REQUIRED) SHALL BE 3 1/2"x3 1/2"x1/4" STEEL ANGLE FOR UP TO 6'-0" SPAN AND 6"x4"x5/16" STEEL ANGLE WITH 6" LEG VERTICAL FOR SPANS UP TO 9"-0". SEE PLANS FOR SPANS OVER 9"-0". SEE ALSO SECTION RTO3.8.3 LINTELS.

PROJECT # 21-2967

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> **DESIGNS** Ą

> > INC. NEW HOME,

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