

RENAISSANCE

RESIDENTIAL DESIGN, INC.
WILMINGTON NC 28401
(919) 649-4128
WWW.RRDCAROLINA.COM

"The art of transforming your vision into reality."

RENAISSANCE RESIDENTIAL DESIGN, INC.
RESERVES THE RIGHT TO MAKE
MODIFICATIONS TO FLOOR PLANS,
DIMENSIONS, MATERIALS, AND
SPECIFICATIONS WITHOUT NOTICE.
THESE DRAWINGS ARE FOR THE
PURPOSE OF CONVEYING AN

RENAISSANCE RESIDENTIAL DESIGN, INC.
HEREBY EXPRESSLY RESERVES ITS
COMMON LAW COPYRIGHT AND OTHER
PROPERTY RIGHTS IN THESE PLANS.
THESE PLANS AND DRAWINGS ARE NOT
TO BE REPRODUCED, CHANGED, OR
COPIED IN ANY FORM OR MANNER
WITHOUT FIRST OBTAINING THE EXPRESS
WRITTEN CONSENT OF RENAISSANCE
RESIDENTIAL DESIGN, INC. NOR ARE
THEY TO BE ASSIGNED TO ANY THIRD
PARTY WITHOUT FIRST OBTAINING SAID
WRITTEN PERMISSION AND CONSENT.

ARCHITECTURAL CONCEPT ONLY.

J.S.THOMPSON ENGINEERING, INC 333 E. SIX FORKS RD. SUITE 180 RALEIGH, NC 27609 PHONE: (919) 789-9919 FAX: (919) 789-9921 N.C. LICENSE NO.: C-1733



PRICES, PROMOTIONS, INCENTIVES, FEATURES, OPTIONS, FLOOR PLANS, ELEVATIONS, DESIGNS, MATERIALS AND DIMENSIONS ARE SUBJECT TO CHANGE WITHOUT NOTICE. QUARE FOOTAGE AND DIMENSIONS ARE ESTIMATED AND MAY RAY IN ACTUAL CONSTRUCTION. ACTUAL POSITION OF HOUSE ON LOT WILL BE DETERMINED BY THE SITE PLAN AND PLOT AN. FLOOR PLANS AND ELEVATION RENDERINGS ARE ARTIST CONCEPTIONS. FLOOR PLANS ARE THE COPYRIGHTED PROPERTY OF A&G RESIDENTIAL. ANY USE, REPRODUCTION, ADAPTATION, OR DISPLAY OF THE PLANS IS STRICTLY PROHIBITED. SEE NEW HOME SALES CONSULTANT FOR CURRENT DETAILS. COPYRIGHT © 2019 A&G RESIDENTIAL

A&G RESIDENTIAL MADISON

DATE: OCTOBER 7, 2022

KEV.:

SCALE: AS NOTED


DRAWN BY: WG
ENGINEERED BY: WFB

REVIEWED BY: MGS

B - ELEVATIONS

A-2

C:\Users\xbox\OneDrive\Projects\A&G\Madison\Madison_10-7-22.dwg, 10/20/2022 4:28:30 PM

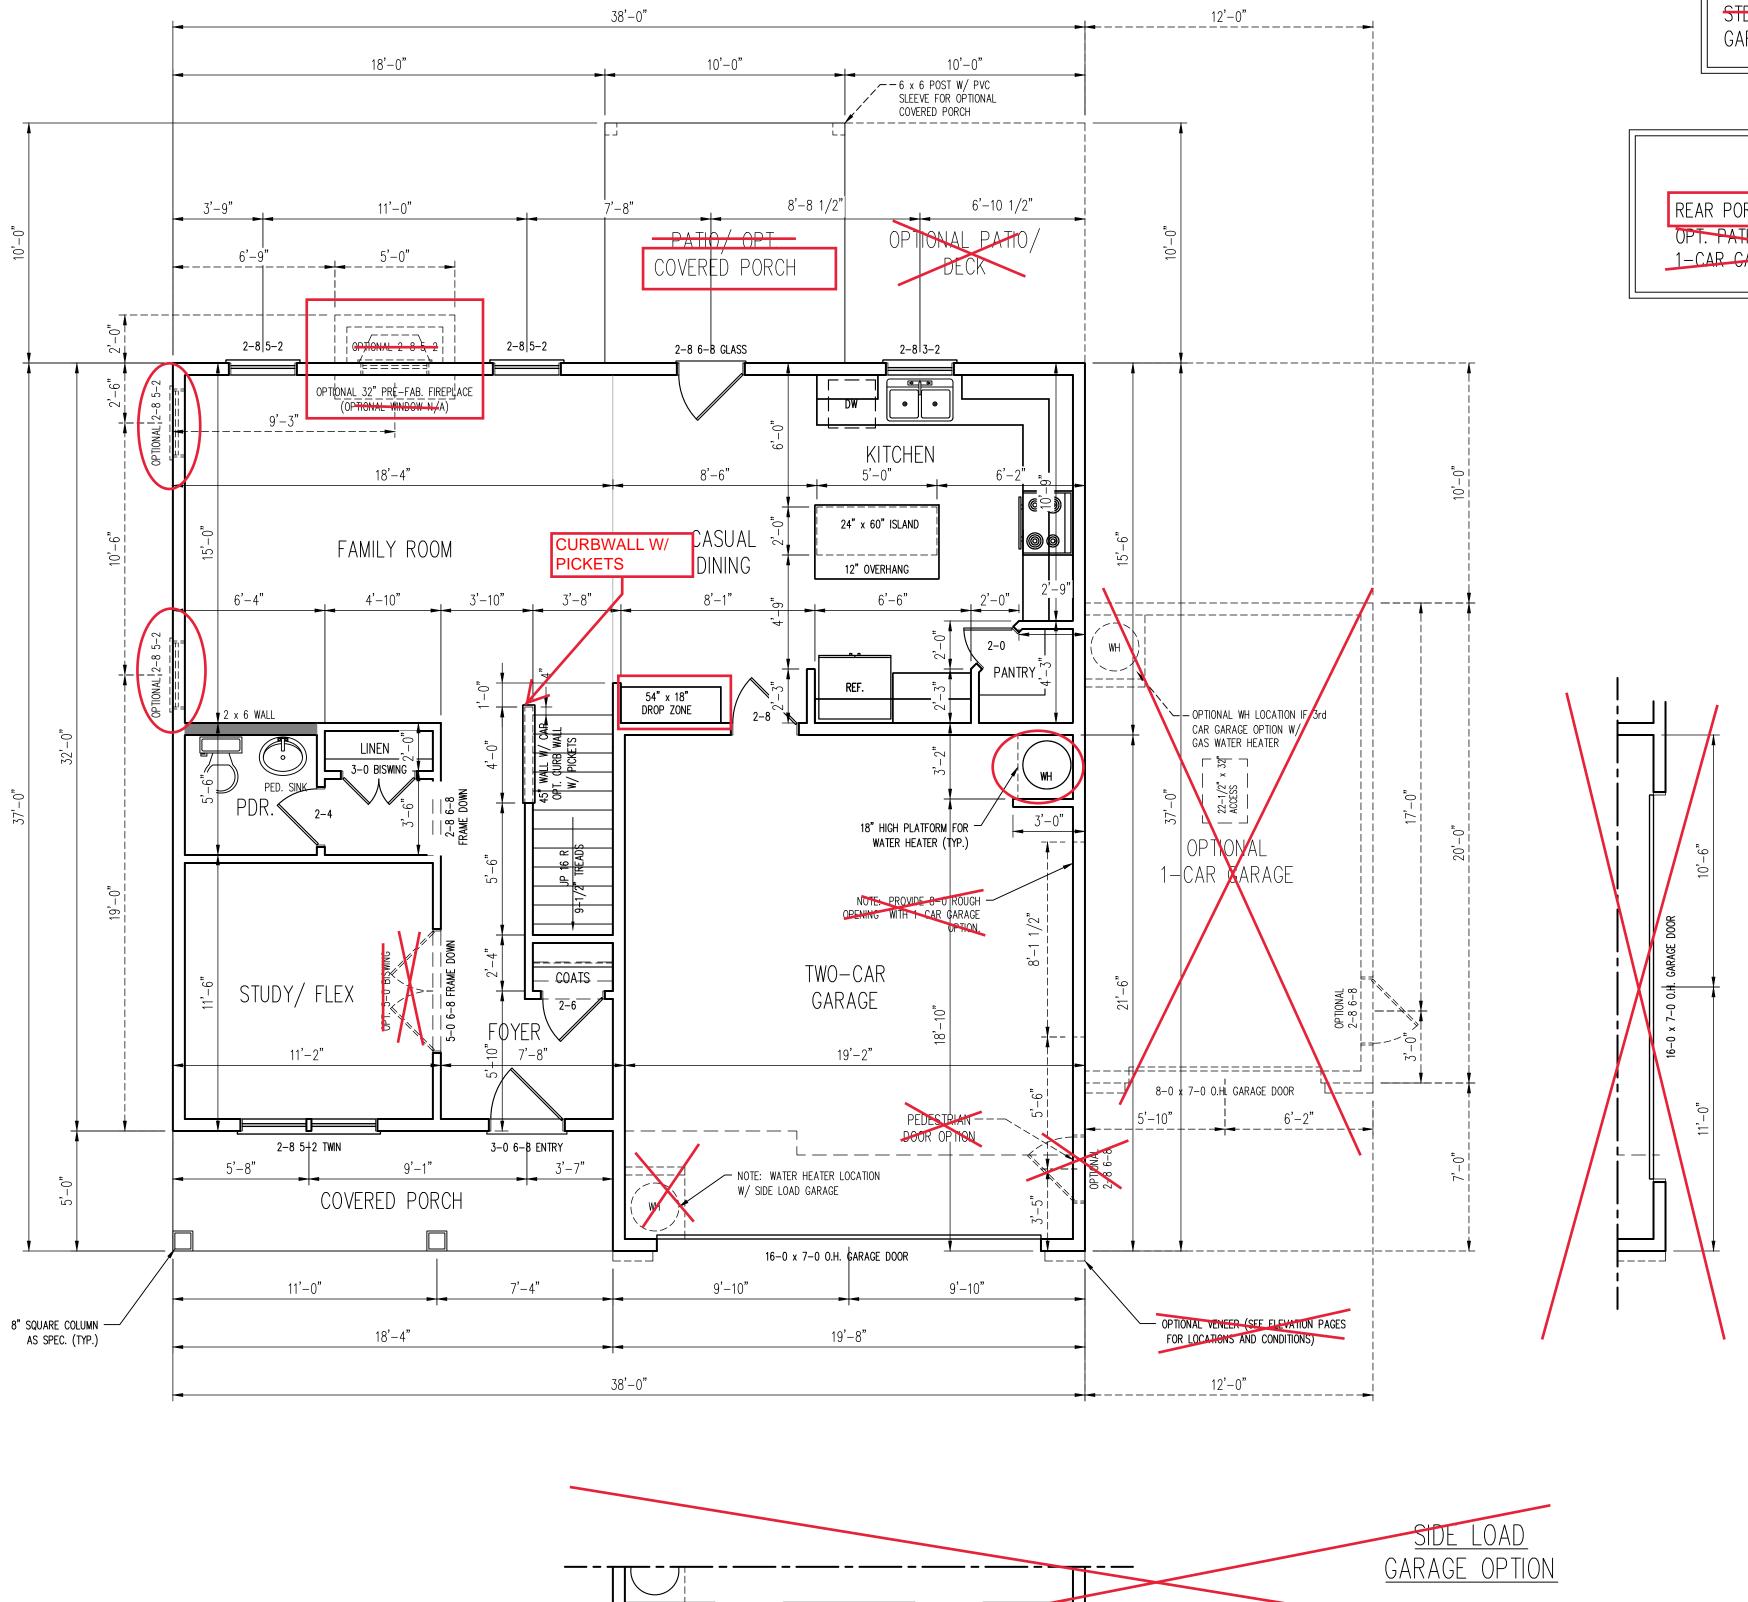

SQUARE FOOTAGE

 1st FLOOR:
 900 SQ. FT.

 2nd FLOOR:
 1228 SQ. FT.

 TOTAL:
 2128 SQ. FT.

 FRONT PORCH:
 92 SQ. FT.

 STD. REAR PATIO:
 100 SQ. FT.

 GARAGE:
 415 SQ. FT.

SQUARE FOOTAGE (OPTIONS)

REAR PORCH:

OPT. PATIO/ DECK:

1-CAR CARAGE:


100 SQ. FT.

240 SQ. FT.

*NOTE: ALL EXTERIOR WALLS AND ATTIC WALLS ARE TO BE 2 x 4 @ 16" O.C. MIN. (UNO). 2 x 6 @ 16" O.C. EXTERIOR WALLS MAY BE CONSTRUCTED IN LIEU OF 2 x 4 WALLS. ALL INTERIOR LOAD BEARING WALLS ARE TO BE 2 x 4 @ 16" O.C. (UNO) AND NON-LOAD BEARING INTERIOR WALLS ARE TO BE 2 x 4 @ 24" O.C. (UNO).

2x6 WALL

* SHADED WALLS ARE TO BE 2 x 6 @ 16"
O.C. (LOAD BEARING) OR 2 x 6 @ 24" O.C.
(NON-LOAD BEARING) REGARDLESS OF
EXTERIOR WALL CONDITION

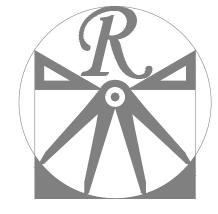

RENAISSANCE

RESIDENTIAL DESIGN, INC.
WILMINGTON NC 28401
(919) 649-4128
WWW.RRDCAROLINA.COM

"The art of transforming your vision into reality.

RENAISSANCE RESIDENTIAL DESIGN, INC.
RESERVES THE RIGHT TO MAKE
MODIFICATIONS TO FLOOR PLANS,
DIMENSIONS, MATERIALS, AND
SPECIFICATIONS WITHOUT NOTICE.
THESE DRAWINGS ARE FOR THE
PURPOSE OF CONVEYING AN
ARCHITECTURAL CONCEPT ONLY.

RENAISSANCE RESIDENTIAL DESIGN, INC. HEREBY EXPRESSLY RESERVES ITS COMMON LAW COPYRIGHT AND OTHER PROPERTY RIGHTS IN THESE PLANS. THESE PLANS AND DRAWINGS ARE NOT TO BE REPRODUCED, CHANGED, OR COPIED IN ANY FORM OR MANNER WITHOUT FIRST OBTAINING THE EXPRESS WRITTEN CONSENT OF RENAISSANCE RESIDENTIAL DESIGN, INC. NOR ARE THEY TO BE ASSIGNED TO ANY THIRD PARTY WITHOUT FIRST OBTAINING SAID WRITTEN PERMISSION AND CONSENT.

J.S.THOMPSON ENGINEERING, INC 333 E. SIX FORKS RD. SUITE 180 RALEIGH, NC 27609 PHONE: (919) 789-9919 FAX: (919) 789-9921 N.C. LICENSE NO.: C-1733



FLOOR PLANS, ELEVATIONS, DESIGNS, MATERIALS AND DIMENSIONS ARE SUBJECT TO CHANGE WITHOUT NOTICE. UARE FOOTAGE AND DIMENSIONS ARE ESTIMATED AND MAY BY IN ACTUAL CONSTRUCTION. ACTUAL POSITION OF HOUSE IN LOT WILL BE DETERMINED BY THE SITE PLAN AND PLOT AN. FLOOR PLANS AND ELEVATION RENDERINGS ARE ARTIST CONCEPTIONS. FLOOR PLANS ARE THE COPYRIGHTED SOPPRATION, OR DISPLAY OF THE PLANS IS STRICTLY PROHIBITED. SEE NEW HOME SALES CONSULTANT FOR CURRENT DETAILS. COPYRIGHT © 2019 A&G RESIDENTIAL

A&G RESIDENTIAL MADISON

DATE: OCTOBER 7, 2022

KEV.:


SCALE: 1/4"=1'-0"

DRAWN BY: WG
ENGINEERED BY: WFB

REVIEWED BY: MGS
FIRST FLOOR

PLAN


A-3

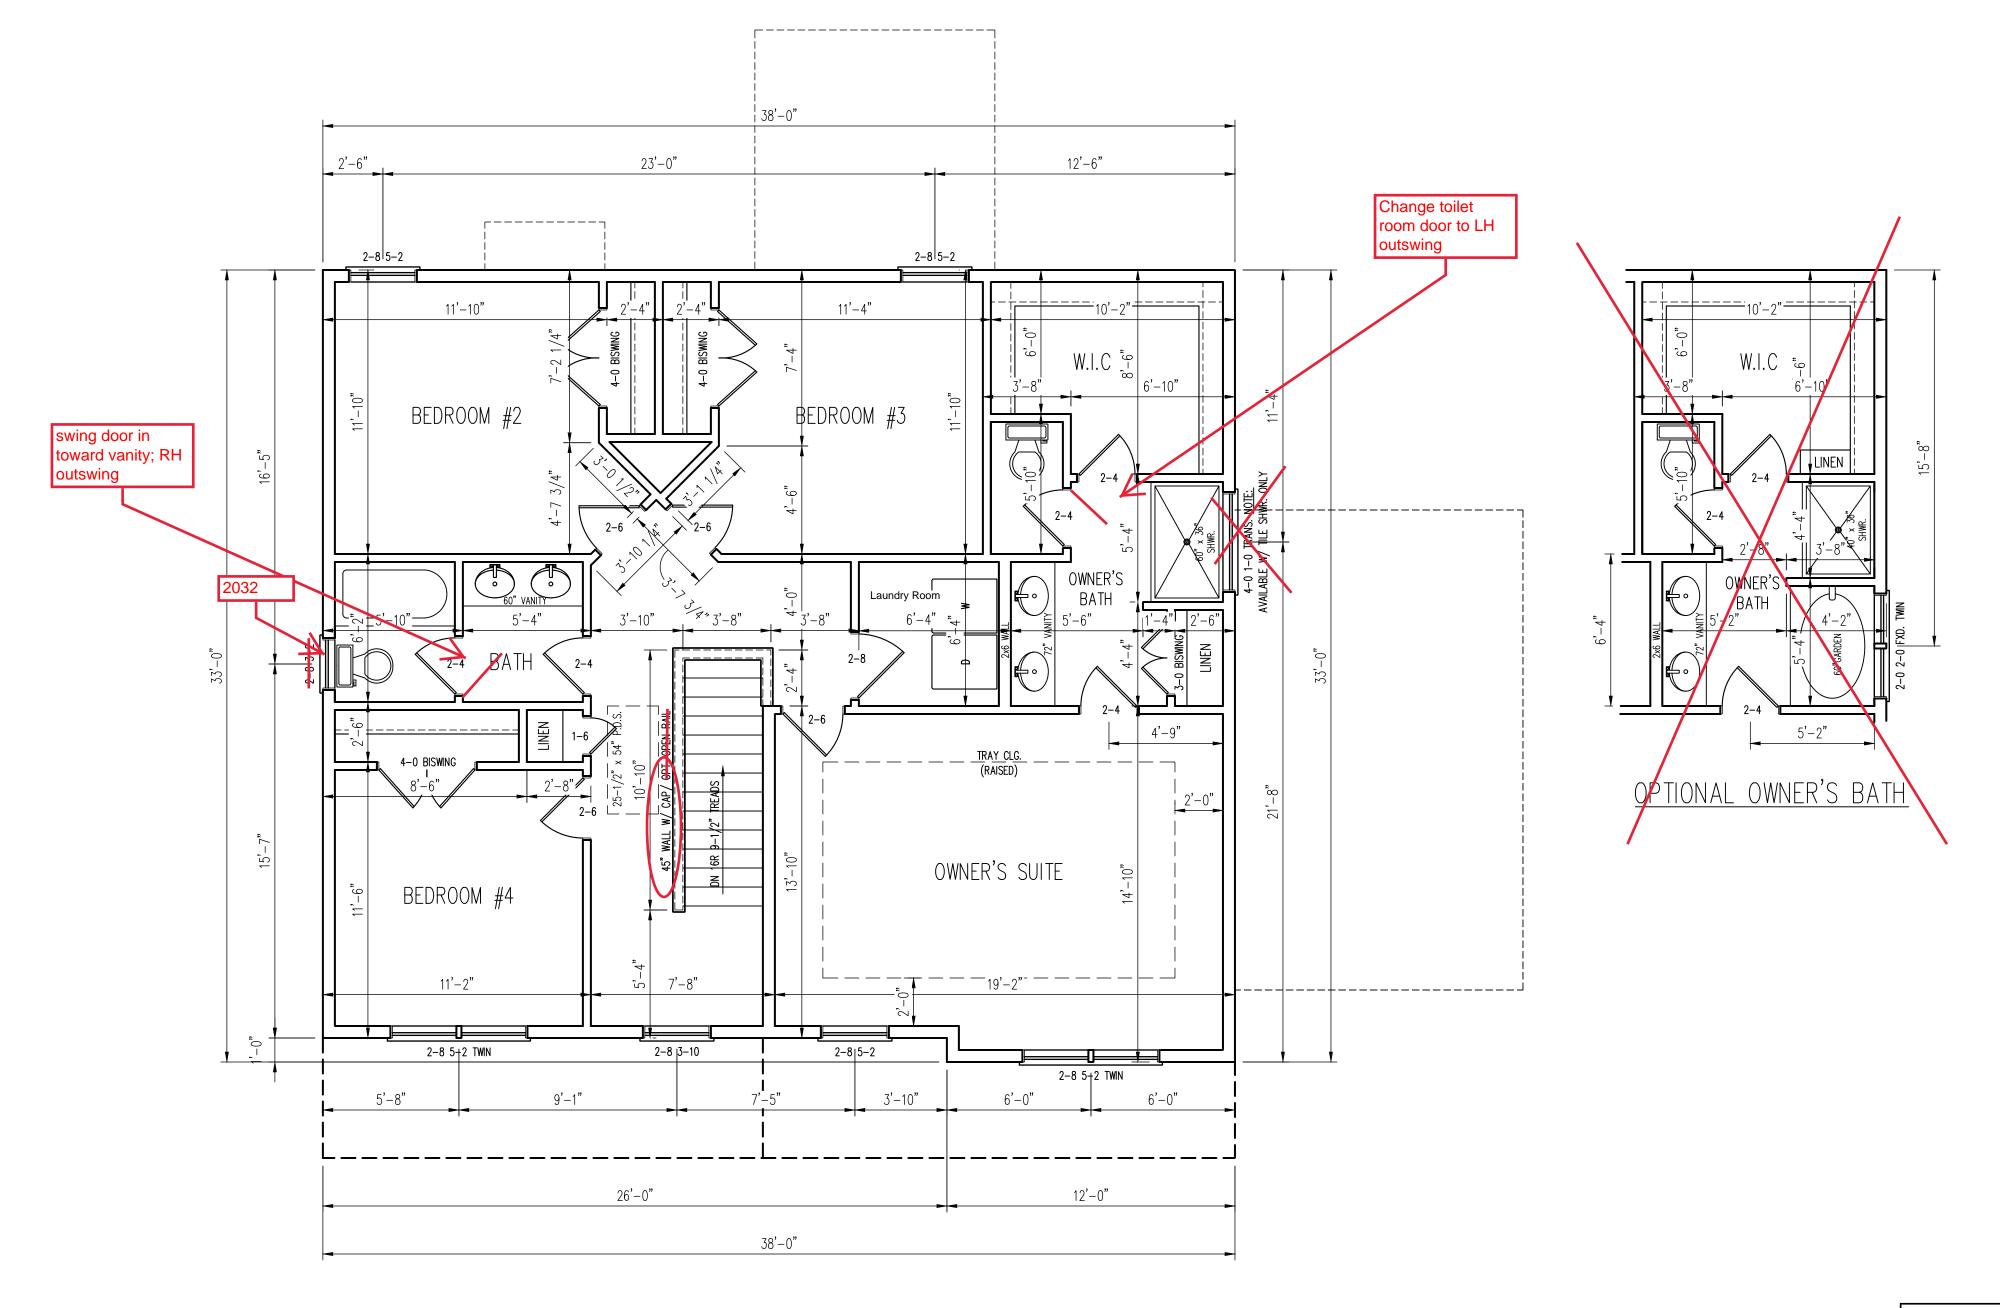

*NOTE: ALL EXTERIOR WALLS AND ATTIC WALLS ARE TO BE 2 x 4 @ 16" O.C. MIN. (UNO). 2 x 6 @ 16" O.C. EXTERIOR WALLS MAY BE CONSTRUCTED IN LIEU OF 2 x 4 WALLS. ALL INTERIOR LOAD BEARING WALLS ARE TO BE 2 x 4 @ 16" O.C. (UNO) AND NON—LOAD BEARING INTERIOR WALLS ARE TO BE 2 x 4 @ 24" O.C. (UNO).

2x6 WALL

* SHADED WALLS ARE TO BE 2 x 6 @ 16"
O.C. (LOAD BEARING) OR 2 x 6 @ 24" O.C.
(NON-LOAD BEARING) REGARDLESS OF
EXTERIOR WALL CONDITION

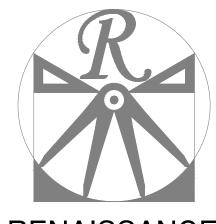


RENAISSANCE

RESIDENTIAL DESIGN, INC.
WILMINGTON NC 28401
(919) 649-4128
WWW.RRDCAROLINA.COM
"The art of transforming your vision into reality."

RENAISSANCE RESIDENTIAL DESIGN, INC.
RESERVES THE RIGHT TO MAKE
MODIFICATIONS TO FLOOR PLANS,
DIMENSIONS, MATERIALS, AND
SPECIFICATIONS WITHOUT NOTICE.
THESE DRAWINGS ARE FOR THE
PURPOSE OF CONVEYING AN
ARCHITECTURAL CONCEPT ONLY.

RENAISSANCE RESIDENTIAL DESIGN, INC.
HEREBY EXPRESSLY RESERVES ITS
COMMON LAW COPYRIGHT AND OTHER
PROPERTY RIGHTS IN THESE PLANS.
THESE PLANS AND DRAWINGS ARE NOT
TO BE REPRODUCED, CHANGED, OR
COPIED IN ANY FORM OR MANNER
WITHOUT FIRST OBTAINING THE EXPRESS
WRITTEN CONSENT OF RENAISSANCE
RESIDENTIAL DESIGN, INC. NOR ARE
THEY TO BE ASSIGNED TO ANY THIRD
PARTY WITHOUT FIRST OBTAINING SAID
WRITTEN PERMISSION AND CONSENT.

J.S.THOMPSON ENGINEERING, INC 333 E. SIX FORKS RD. SUITE 180 RALEIGH, NC 27609 PHONE: (919) 789-9919 FAX: (919) 789-9921 N.C. LICENSE NO.: C-1733

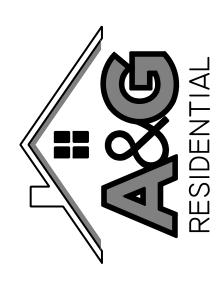

PRICES, PROMOTIONS, INCENTIVES, FEATURES, OPTIONS, FLOOR PLANS, ELEVATIONS, DESIGNS, MATERIALS AND DIMENSIONS ARE SUBJECT TO CHANGE WITHOUT NOTICE. UARE FOOTAGE AND DIMENSIONS ARE ESTIMATED AND MAY BY IN ACTUAL CONSTRUCTION. ACTUAL POSITION OF HOUSE ON LOT WILL BE DETERMINED BY THE SITE PLAN AND PLOT AN. FLOOR PLANS AND ELEVATION RENDERINGS ARE ARTIST CONCEPTIONS. FLOOR PLANS ARE THE COPYRIGHTED ROPERTY OF A&G RESIDENTIAL. ANY USE, REPRODUCTION, ADAPTATION, OR DISPLAY OF THE PLANS IS STRICTLY PROHIBITED. SEE NEW HOME SALES CONSULTANT FOR CHRENT DETAILS.

A&G RESIDENTIAL MADISON

DATE: OCTOBER 7, 2022

KEV.:

SCALE: 1/4"=1'-0"

DRAWN BY: WG


ENGINEERED BY: WFB

REVIEWED BY: MGS

SECOND FLOOR PLAN

A-4

 $C: \label{linear_continuous_con$

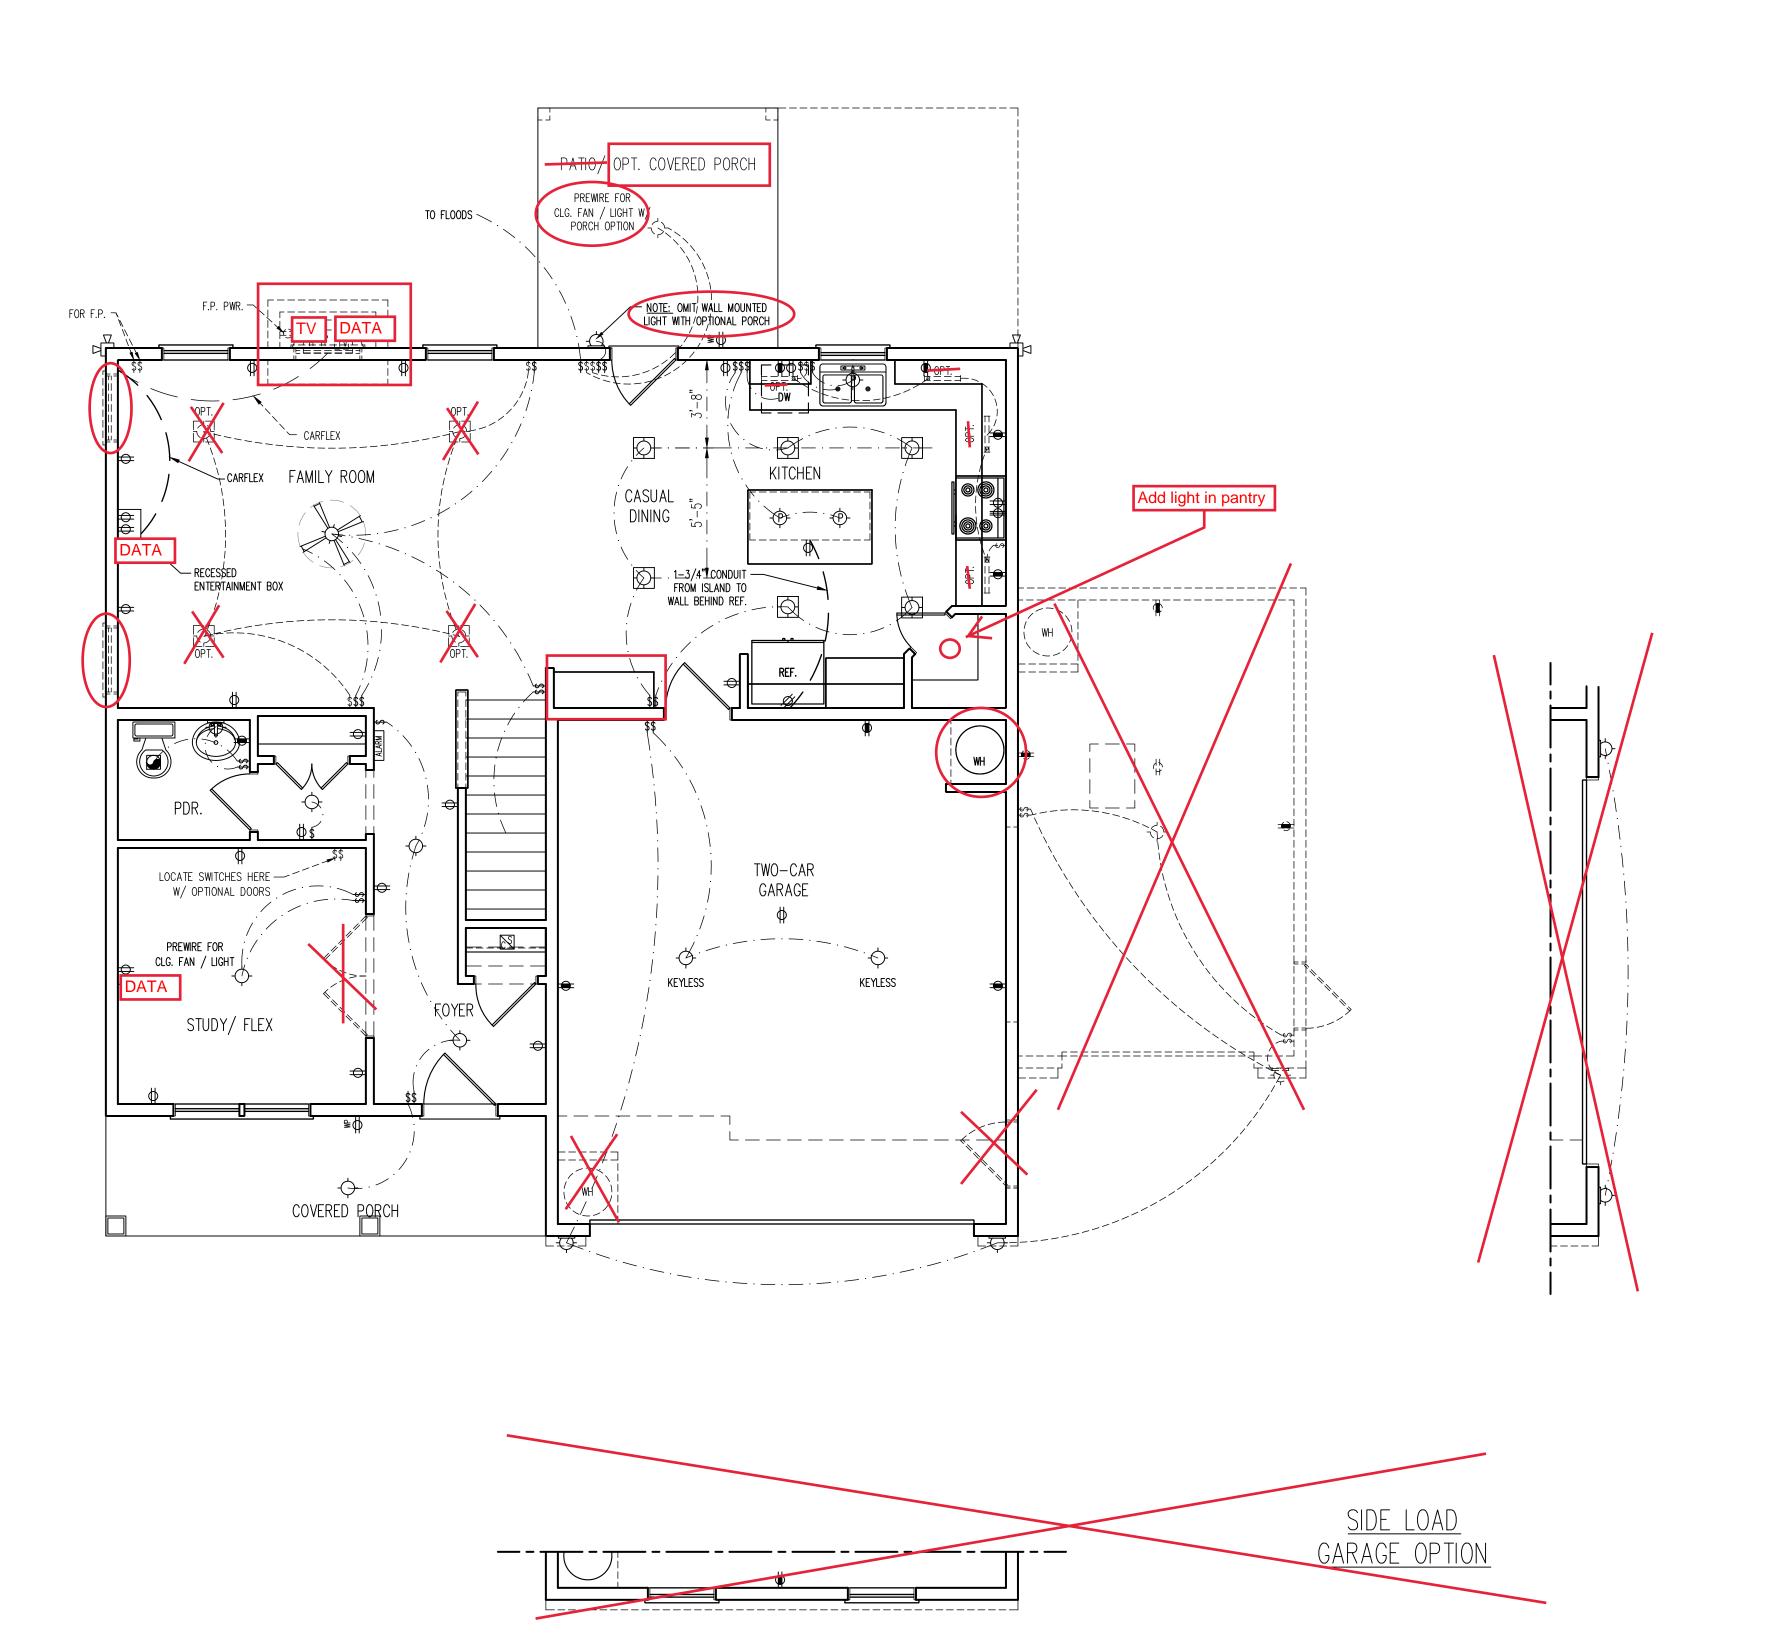

ELECTRICAL LAYOUT NOTES:

1.) BLOCK AND WIRE FOR ALL CELING FANS PER PLAN.

2.) VANITY LIGHTS TO BE SET @ 90" A.F.F. (TYP.)

3.) ADDITIONAL EXTERIOR OUTLETS
REQUIRED BY CODE TO BE
LOCATED BY ELECTRICIAN.

4.) PLACE SWITCHES 8" (MIN.) FROM ROUGH OPENINGS.

ELECTRICAL LEGEND

- 110 V OUTLET 🗢
- 110 V GFI OUTLET 👄
- 110 V SWITCHED OUTLET 🗢
- 110 V BASEBOARD OUTLET

 → BB

 4-PLEX

 → BB
- COUNTER OR FLOOR MOUNTED
- COUNTER OR FLOOR MOUNTED 110V GFI
 - WEATHERPROOF Q

 - 220 V DEDICATED CIRCUIT
- SPECIAL PURPOSE (240 V, ETC.)
 - WALL MOUNT LIGHT -
 - PENDANT LIGHT -(P)-
 - PENDANT LIGHT
 - RECESSED CAN LIGHT
 - MINI CAN LIGHT

 EYEBALL LIGHT
 - FLUORESCENT LIGHT
 - UNDERCABINET LIGHT TO THE PROPERTY OF THE PROP
 - SWITCH \$

TELEPHONE 🔺

- DIMMER SWITCH
- DATA \triangle
- TV CONNECTION -TV
- TV/ DATA 📆
- CONDUIT FOR COMPONENT WIRING -CD
 SPEAKER SPE
- 110 V SMOKE/ CM DETECTOR SD
 - EXHAUST FAN
- LOW VOLTAGE PANEL


 ALARM PANEL

 ALARM

_



CEILING FAN W/ LIGHT

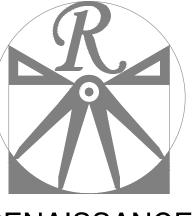

RENAISSANCE

RESIDENTIAL DESIGN, INC.
WILMINGTON NC 28401
(919) 649-4128

WWW.RRDCAROLINA.COM
"The art of transforming your vision into reality."

RENAISSANCE RESIDENTIAL DESIGN, INC.
RESERVES THE RIGHT TO MAKE
MODIFICATIONS TO FLOOR PLANS,
DIMENSIONS, MATERIALS, AND
SPECIFICATIONS WITHOUT NOTICE.
THESE DRAWINGS ARE FOR THE
PURPOSE OF CONVEYING AN

ARCHITECTURAL CONCEPT ONLY.

RENAISSANCE RESIDENTIAL DESIGN, INC.
HEREBY EXPRESSLY RESERVES ITS
COMMON LAW COPYRIGHT AND OTHER
PROPERTY RIGHTS IN THESE PLANS.
THESE PLANS AND DRAWINGS ARE NOT
TO BE REPRODUCED, CHANGED, OR
COPIED IN ANY FORM OR MANNER
WITHOUT FIRST OBTAINING THE EXPRESS
WRITTEN CONSENT OF RENAISSANCE
RESIDENTIAL DESIGN, INC. NOR ARE
THEY TO BE ASSIGNED TO ANY THIRD
PARTY WITHOUT FIRST OBTAINING SAID
WRITTEN PERMISSION AND CONSENT.

J.S.THOMPSON ENGINEERING, INC 333 E. SIX FORKS RD. SUITE 180 RALEIGH, NC 27609 PHONE: (919) 789-9919 FAX: (919) 789-9921

N.C. LICENSE NO.: C-1733



OF PLANS, ELEVATIONS, DESIGNS, WATERHALS AND NISIONS ARE SUBJECT TO CHANGE WITHOUT NOTICE. FOOTAGE AND DIMENSIONS ARE ESTIMATED AND MAY ACTUAL CONSTRUCTION. ACTUAL POSITION OF HOUSE OF WILL BE DETERMINED BY THE SITE PLAN AND PLOT LOOR PLANS AND ELEVATION RENDERINGS ARE ARTIST NCEPTIONS, FLOOR PLANS ARE THE COPYRIGHTED SETY OF A&G RESIDENTIAL. ANY USE, REPRODUCTION, APTATION, OR DISPLAY OF THE PLANS IS STRICTLY HIBITED. SEE NEW HOME SALES CONSULTANT FOR SENT DETAILS. COPYRIGHT © 2019 A&G RESIDENTIAL

A&G RESIDENTIAL MADISON

DATE: OCTOBER 7, 2022

REV.:

SCALE: 1/4"=1'-0"


DRAWN BY: WG

ENGINEERED BY: WFB

REVIEWED BY: MGS

FIRST FLOOR ELECTRICAL PLAN

E-1

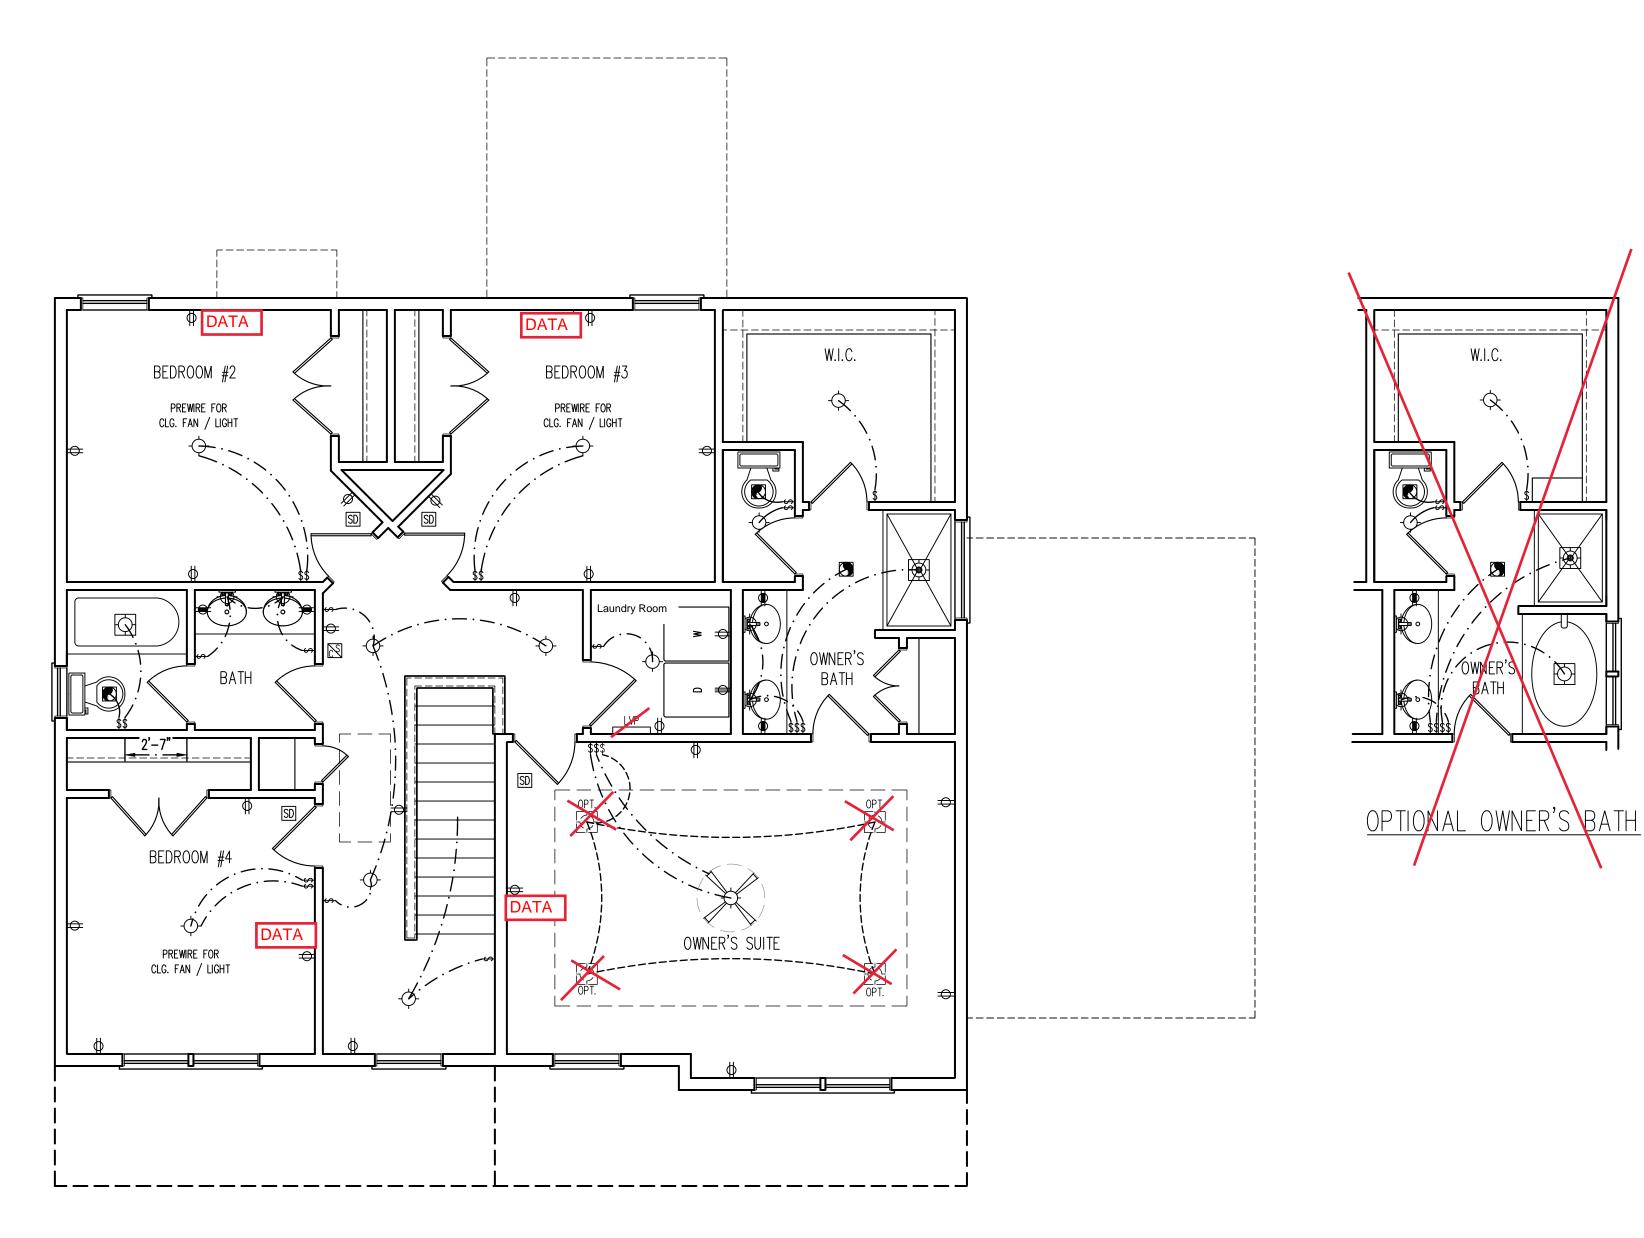

ELECTRICAL LAYOUT NOTES:

 BLOCK AND WIRE FOR ALL CELING FANS PER PLAN.

2.) VANITY LIGHTS TO BE SET @ 90" A.F.F. (TYP.)

3.) ADDITIONAL EXTERIOR OUTLETS REQUIRED BY CODE TO BE LOCATED BY ELECTRICIAN.

4.) PLACE SWITCHES 8" (MIN.) FROM ROUGH OPENINGS.

ELECTRICAL LEGEND

110 V OUTLET 🚓

110 V GFI OUTLET =

110 V SWTCHED OUTLET

→ BB

110 V BASEBOARD OUTLET

→ BB

4−PLEX I

COUNTER OR FLOOR MOUNTED

COUNTER OR FLOOR MOUNTED 110V GFI

WEATHERPROOF +

110 V DEDICATED CIRCUIT

220 V DEDICATED CIRCUIT

SPECIAL PURPOSE (240 V, ETC.)

WALL MOUNT LIGHT CEILING MOUNT LIGHT

PENDANT LIGHT -

RECESSED CAN LIGHT

MINI CAN LIGHT

EYEBALL LIGHT

FLUORESCENT LIGHT UNDERCABINET LIGHT

FLOOD LIGHT

SWITCH \$
DIMMER SWITCH \$

TELEPHONE

DATA riangle

TV CONNECTION -TV

TV/ DATA -

CONDUIT FOR COMPONENT WIRING -CD
SPEAKER SPE

110 V SMOKE/ CO DETECTOR

110 V SMOKE DETECTOR SD


EXHAUST FAN

LOW VOLTAGE PANEL LVP

ALARM PANEL ALARM

ALARM PANEL ALARM

CEILING FAN W/ LIGHT

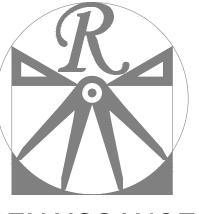

RENAISSANCE

RESIDENTIAL DESIGN, INC.
WILMINGTON NC 28401
(919) 649-4128
WWW.RRDCAROLINA.COM

"The art of transforming your vision into reality."

RENAISSANCE RESIDENTIAL DESIGN, INC.
RESERVES THE RIGHT TO MAKE
MODIFICATIONS TO FLOOR PLANS,
DIMENSIONS, MATERIALS, AND
SPECIFICATIONS WITHOUT NOTICE.
THESE DRAWINGS ARE FOR THE
PURPOSE OF CONVEYING AN
ARCHITECTURAL CONCEPT ONLY.

RENAISSANCE RESIDENTIAL DESIGN, INC.
HEREBY EXPRESSLY RESERVES ITS
COMMON LAW COPYRIGHT AND OTHER
PROPERTY RIGHTS IN THESE PLANS.
THESE PLANS AND DRAWINGS ARE NOT
TO BE REPRODUCED, CHANGED, OR
COPIED IN ANY FORM OR MANNER
WITHOUT FIRST OBTAINING THE EXPRESS
WRITTEN CONSENT OF RENAISSANCE
RESIDENTIAL DESIGN, INC. NOR ARE
THEY TO BE ASSIGNED TO ANY THIRD
PARTY WITHOUT FIRST OBTAINING SAID
WRITTEN PERMISSION AND CONSENT.

J.S.THOMPSON ENGINEERING, INC 333 E. SIX FORKS RD. SUITE 180 RALEIGH, NC 27609 PHONE: (919) 789-9919 FAX: (919) 789-9921

N.C. LICENSE NO.: C-1733



LOOR PLANS, ELEVATIONS, DESIGNS, MATERIALS AND MENSIONS ARE SUBJECT TO CHANGE WITHOUT NOTICE. RE FOOTAGE AND DIMENSIONS ARE ESTIMATED AND MAY IN ACTUAL CONSTRUCTION. ACTUAL POSITION OF HOUSE LOT WILL BE DETERMINED BY THE SITE PLAN AND PLOT FLOOR PLANS AND ELEVATION RENDERINGS ARE ARTIST CONCEPTIONS. FLOOR PLANS ARE THE COPYRIGHTED PERTY OF A&G RESIDENTIAL. ANY USE, REPRODUCTION, ADAPTATION, OR DISPLAY OF THE PLANS IS STRICTLY ROHIBITED. SEE NEW HOME SALES CONSULTANT FOR RRENT DETAILS. COPYRIGHT © 2019 A&G RESIDENTIAL

A&G RESIDENTIAL MADISON

DATE: OCTOBER 7, 2022

KEV.:

SCALE: 1/4"=1'-0"


DRAWN BY: WG

ENGINEERED BY: WFB
REVIEWED BY: MGS

SECOND FLOOR ELECTRICAL PLAN

E-2

 $\label{lem:c:Users} $$ C:\Users\x\ox\OneDrive\Projects\A\&G\Madison\Madison_10-7-22.dwg, 1/4/2023 10:05:28 AM $$ AM $$$

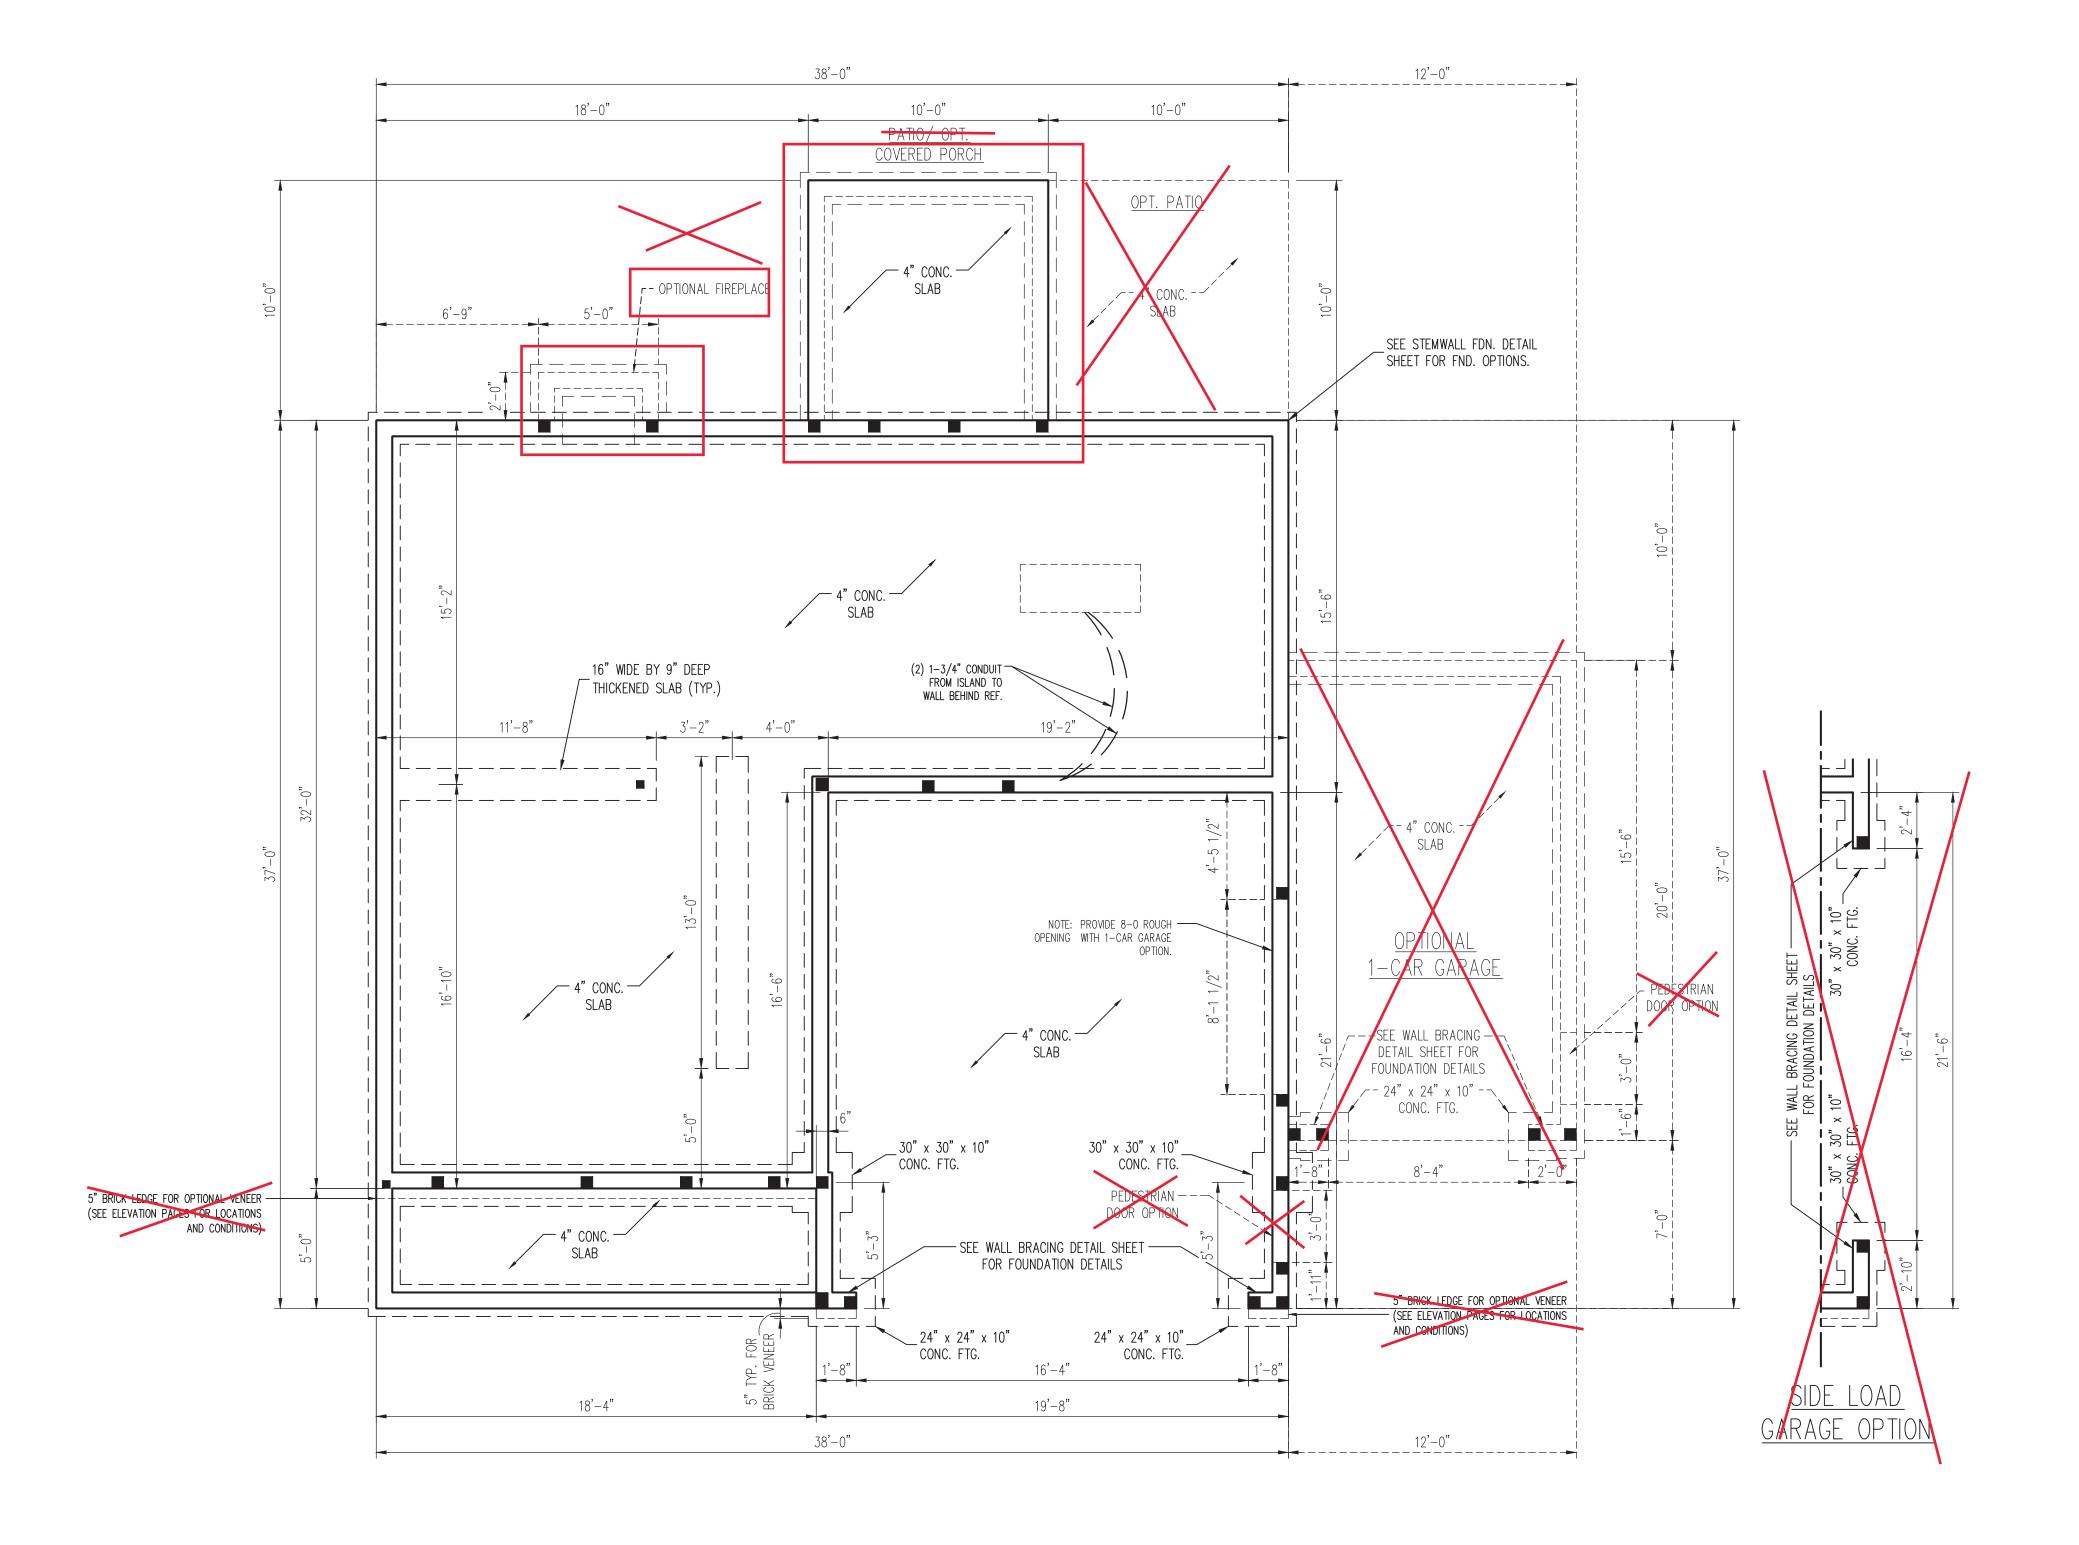

120 MPH ULTIMATE DESIGN WIND SPEED NOTES FOR LESS THAN

- ENGINEER'S SEAL APPLIES ONLY TO STRUCTURAL COMPONENTS. ENGINEER'S SEAL DOES NOT CERTIFY DIMENSIONAL ACCURACY OR ARCHITECTURAL LAYOUT INCLUDING ROOF SYSTEM.
- STRUCTURAL DESIGN PER NORTH CAROLINA RESIDENTIAL CODE, 2018 EDITION. INSTALL 1/2" ANCHOR BOLTS 6'-0" O.C. AND
- INTO MASONRY OR CONCRETE. LOCATE BOLT WITHIN MIDDLE THIRD OF PLATE WIDTH.
- 6. WALL CLADDING DESIGNED FOR +15.5 PSF AND -20 PSF (+/- INDICATE POSITIVE / NEGATIVE PRESSURE (TYP).
- PSF AND -36 PSF FOR ROOF PITCHED 2.25/12 TO 8. INSTALL 7/16" OSB SHEATHING ON ALL EXTERIOR
- WALLS OF ALL STORIES IN ACCORDANCE WITH SECTION R602.10.3 OF THE NCRC, 2018 EDITION. SEE THE WALL BRACING NOTES AND DETAILS SHEET
- FOR MORE INFORMATION. . ENERGY EFFICIENCY COMPLIANCE AND INSULATION WITH CHAPTER 11 OF THE NCRC, 2018 EDITION.
- 10. REFER TO NOTES AND DETAIL SHEETS FOR ADDITIONAL STRUCTURAL INFORMATION.
- COMPONENTS. ENGINEER'S SEAL DOES NOT
- CERTIFY DIMENSIONAL ACCURACY OR
- RESIDENTIAL CODE, 2018 EDITION. INSTALL 1/2" ANCHOR BOLTS 4'-0" O.C. AND WITHIN 1'-0" FROM END OF EACH CORNER. ANCHOR BOLTS MUST EXTEND A MINIMUM OF 7"
- INTO MASONRY OR CONCRETE. LOCATE BOLT WITHIN MIDDLE THIRD OF PLATE WIDTH. . MEAN ROOF HEIGHT IS LESS THAN 30 FEET.
- 6. WALL CLADDING DESIGNED FOR +18.2 PSF AND -24 PSF (+/- INDICATE POSITIVE / NEGATIVE PRESSURE (TYP).
- -21 PSF FOR ROOF PITCHES 7/12 TO 12/12 AND +10.5 PSF AND -43 PSF FOR ROOF PITCHED 2.25/12 TO 7/12.
- WALLS OF ALL STORIES IN ACCORDANCE WITH SECTION R602.10.3 OF THE NCRC, 2018 EDITION. SEE THE WALL BRACING NOTES AND DETAILS SHEET FOR MORE INFORMATION.
- VALUES OF THE BUILDING TO BE IN ACCORDANCE WITH CHAPTER 11 OF THE NCRC, 2018 EDITION. 10. REFER TO NOTES AND DETAIL SHEETS FOR

_			
	LEGEND		
	CONT	CONTINUOUS	
	XJ	EXTRA JOIST	
	DJ	DOUBLE JOIST	
	TJ	TRIPLE JOIST	
	EA	EACH	
	FDN	FOUNDATION	
	FTG	FOOTING	
	OC	ON CENTER	
	SPF	SPRUCE PINE FIR	
	SYP	SOUTHERN YELLOW PINE	
	TRTD	PRESSURE TREATED	
	TYP	TYPICAL	

10/20/2022

30' MEAN ROOF HEIGHT:

- WITHIN 1'-0" FROM END OF EACH CORNER. ANCHOR BOLTS MUST EXTEND A MINIMUM OF 7"

RENAISSANCE

RESIDENTIAL DESIGN, INC.

WILMINGTON NC 28401

(919) 649-4128

WWW.RRDCAROLINA.COM

"The art of transforming your vision into re ality."

RENAISSANCE RESIDENTIAL DESIGN, INC.

MODIFICATIONS TO FLOOR PLANS, DIMENSIONS, MATERIALS, AND

SPECIFICATIONS WITHOUT NOTICE THESE DRAWINGS ARE FOR THE PURPOSE OF CONVEYING AN

ARCHITECTURAL CONCEPT ONLY.

RENAISSANCE RESIDENTIAL DESIGN, INC.

HEREBY EXPRESSLY RESERVES ITS

COMMON LAW COPYRIGHT AND OTHER PROPERTY RIGHTS IN THESE PLANS.

THESE PLANS AND DRAWINGS ARE NOT

TO BE REPRODUCED, CHANGED, OR

COPIED IN ANY FORM OR MANNER

WITHOUT FIRST OBTAINING THE EXPRESS WRITTEN CONSENT OF RENAISSANCE RESIDENTIAL DESIGN, INC. NOR ARE

THEY TO BE ASSIGNED TO ANY THIRD PARTY WITHOUT FIRST OBTAINING SAID WRITTEN PERMISSION AND CONSENT.

J.S.THOMPSON ENGINEERING, INC

333 E. SIX FORKS RD. SUITE 180

RALEIGH, NC 27609 PHONE: (919) 789-9919

FAX: (919) 789-9921 N.C. LICENSE NO.: C-1733

- . MEAN ROOF HEIGHT IS LESS THAN 30 FEET. EXTERIOR WALLS DESIGNED FOR 120 MPH WINDS.
- ROOF CLADDING DESIGNED FOR +14.2 PSF AND -18 PSF FOR ROOF PITCHES 7/12 TO 12/12 AND +10

- VALUES OF THE BUILDING TO BE IN ACCORDANCE

130 MPH ULTIMATE DESIGN WIND SPEED NOTES FOR LESS THAN 30' MEAN ROOF HEIGHT:

- ENGINEER'S SEAL APPLIES ONLY TO STRUCTURAL
- ARCHITECTURAL LAYOUT INCLUDING ROOF SYSTEM. STRUCTURAL DESIGN PER NORTH CAROLINA
- 5. EXTERIOR WALLS DESIGNED FOR 130 MPH WINDS.
- ROOF CLADDING DESIGNED FOR +16.7 PSF AND
- 3. INSTALL 7/16" OSB SHEATHING ON ALL EXTERIOR
- ENERGY EFFICIENCY COMPLIANCE AND INSULATION
- ADDITIONAL STRUCTURAL INFORMATION.

	LEGEND			
CONT	CONTINUOUS			
XJ	EXTRA JOIST			
DJ	DOUBLE JOIST			
TJ	TRIPLE JOIST			
EA	EACH			
FDN	DN FOUNDATION			
FTG	FOOTING			
OC	ON CENTER			
SPF	SPRUCE PINE FIR			
SYP	SOUTHERN YELLOW PINE			
TRTD	PRESSURE TREATED			
TYP	TYPICAL			
UNO	UNLESS NOTED OTHERWISE			

A&G RESIDENTIAL MADISON


DATE: OCTOBER 7, 2022

REV.:

SCALE: 1/4"=1'-0" DRAWN BY: WG

ENGINEERED BY: WFB REVIEWED BY: MGS

STEM WALL FOUNDATION PLAN

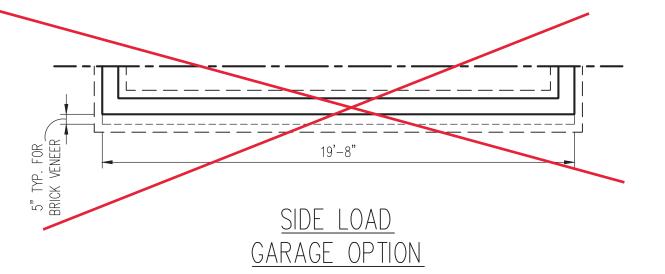

2X4 WALLS

*NOTE: ALL EXTERIOR WALLS AND ATTIC WALLS ARE TO BE 2 x 4 @ 16" O.C. MIN. (UNO). 2 x 6 @ 16" O.C. EXTERIOR WALLS MAY BE CONSTRUCTED IN LIEU OF 2 x 4 WALLS. ALL INTERIOR LOAD BEARING WALLS ARE TO BE 2 x 4 @ 16" O.C. (UNO) AND NON-LOAD BEARING INTERIOR WALLS ARE TO BE 2 x 4 @ 24" O.C. (UNO).

监 (3) 2 x 6 JACKS

& (5) 2 x 6 -

KING STUDS

(4) 2 x 6

<u>OAD GARAGE</u> OPTION

	LEGEND
CONT	CONTINUOUS
XJ	EXTRA JOIST
DJ	DOUBLE JOIST
TJ	TRIPLE JOIST
EA	EACH
()	NUMBER OF STUDS
DSP	DOUBLE STUD POCKET
TSP	TRIPLE STUD POCKET
ОС	ON CENTER
SPF	SPRUCE PINE FIR
SYP	SOUTHERN YELLOW PINE
TRTD	PRESSURE TREATED
TYP	TYPICAL
UNO	UNLESS NOTED OTHERWISE

BRACED WALL DESIGN

SIDE 1B

SIDE 2B

<u>RECTANGLE A</u> SIDE 1A (FRONT LOAD) METHOD: CS-WSP/PF TOTAL REQUIRED LENGTH: 11.5'

TOTAL PROVIDED LENGTH: 15.04' SIDE 2A METHOD: CS-WSP TOTAL REQUIRED LENGTH: 11.5' TOTAL PROVIDED LENGTH: 23.92'

SIDE 3A METHOD: CS-WSP TOTAL REQUIRED LENGTH: 11.8' TOTAL PROVIDED LENGTH: 30.25' SIDE 4A (SIDE LOAD) METHOD: CS-WSP/PF

SIDE 3B / 4A COMBINED METHOD: CS-WSP TOTAL REQUIRED LENGTH: 13.9' TOTAL PROVIDED LENGTH: 17' SIDE 4B METHOD: CS-WSP

METHOD: CS-WSP/PF

METHOD: CS-WSP

<u>RECTANGLE B</u>

TOTAL REQUIRED LENGTH: 2.85'

TOTAL PROVIDED LENGTH: 6.0'

TOTAL REQUIRED LENGTH: 2.85'

TOTAL PROVIDED LENGTH: 12.0'

TOTAL REQUIRED LENGTH: 2.1' TOTAL REQUIRED LENGTH: 11.8' TOTAL PROVIDED LENGTH: 15.58' TOTAL PROVIDED LENGTH: 22.2'

BRACED WALL DESIGN NOTES:

- 1. BRACED WALL DESIGN PER SECTION R602.10 OF THE NCRC 2018 EDITION. 2. CS-WSP REFERS TO "CONTINUOUS SHEATHING - WOOD STRUCTURAL PANELS" CONTRACTOR IS TO INSTALL 7/16" OSB ON ALL EXTERIOR WALLS ATTACHED w/ 8d NAILS SPACED 6" O.C. ALONG PANEL EDGES AND 12"
- O.C. IN THE FIELD. . *GB REFERS TO "GYPSUM BOARD" CONTRACTOR IS TO INSTALL 1/2" (MIN.) GYPSUM WALL BOARD WHERE NOTED ON THE PLANS. FASTEN GB WITH 1 1/4" SCREWS OR 1 5/8" NAILS SPACED 7" O.C. ALONG PANEL EDGES AND IN THE FIELD INCLUDING TOP AND BOTTOM PLATES.
- BRACED WALL DESIGN APPLIED IN WIND ZONES UP TO 130 MPH. FOR HIGH WIND ZONES, BRACE WALLS ARE TO BE CONSTRUCTED IN ACCORDANCE WITH CHAPTER 45 OF THE NCRC 2018 EDITION.
- 5. SEE NOTES AND DETAIL SHEETS FOR ADDITIONAL BRACED WALL

INFORMATION.

BCI 4500s-1.8 JOISTS MAY BE INSTALLED

ALTERNATIVE

IN LIEU OF TJI 110 JOISTS AT THE DEPTH

AND SPACING INDICATED ON THE PLAN SEE SHEET D-1 FOR FLOOR TRUSS


- ALL FRAMING LUMBER TO BE SPF #2 (UNO). ALL TREATED LUMBER TO BE SYP #2 (UNO.)
- INSTALL AN EXTRA JOIST UNDER WALLS PARALLEL
- WINDOW AND DOOR HEADERS TO BE SUPPORTED w/ (1) JACK STUD AND (1) KING STUD EA. END (UNO.). SEE TABLE R602.7.5 FOR ADDITIONAL KING STUD REQUIREMENTS.
- SQUARES DENOTE POINT LOADS WHICH REQUIRE SOLID BLOCKING TO GIRDER OR FOUNDATION. ALL SQUARES TO BE (2) STUDS (UNO.)
- w/ SIMPSON ABU44 POST BASES (OR EQUAL) AND 6 x 6 POSTS w/ ABU66 POST BASES (OR EQUAL) (UNO). ALL 4 x 4 AND 6 x 6 POSTS TO BE INSTALLED WITH 700 LB CAPACITY UPLIFT
- OTHERS, SECURE TO SLAB w/ (2) METAL ANGLES USING 2" CONC. SCREWS. FASTEN ANGLES TO COLUMNS w/ 1/4" THROUGH BOLTS w/ NUTS AND WASHERS. LOCATE ANGLES ON OPPOSITE SIDES
- REFER TO NOTES AND DETAIL SHEETS FOR ADDITIONAL STRUCTURAL INFORMATION.

TABLE R602.7.5 MINIMUM NUMBER OF FULL HEIGHT KING STUDS AT EACH END OF HEADERS IN EXTERIOR WALLS

HEADER SPAN (FEET)	MINIMUM NUMBER OF FUL HEIGHT STUDS (KINGS)
UP TO 3'	1
> 3' TO 6'	2
> 6' TO 9'	3
> 9' TO 12'	4
> 12' TO 15'	5

STRUCTURAL NOTES:

- ALL LOAD BEARING HEADERS TO BE (2) 2 x 6
- TO FLOOR JOISTS WHERE NOTED ON THE PLANS.
- ALL 4 x 4 POSTS SHALL BE ANCHORED TO SLABS
- CONNECTORS AT TOP (UNO.) FOR FIBERGLASS, ALUMINUM, OR COLUMN ENG. BY
- OF COLUMN. THROUGH BOLTS MUST BE INSTALLED PRIOR TO SETTING COLUMN.

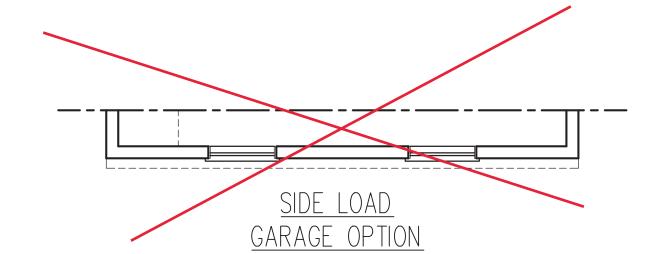

CORNER w/ (3) 2 x 6 JACKS EA. BRG. PT.

— GARAGE PORTAL FRAME. SEE METHOD

PF WALL BRACING DETAIL

38'-0" SIDE 2A

w/ OPT. FIREPLACE:

<u>OR:</u> 2 x 6 @ 16" O.C.

OPTIONAL FIREPLACE

| (OPTIONAL WINDOW N/A)

w/ OPT. FIREPLACE: \

 $(2) 2 \times 10 \text{ w}/(2)^{-1}$

(2) 2 x 10 w/ (2)

4 x 4 TRTD. POST

MIN. (TYP.)

JACKS EA. END

(2) 1 3/4" x 14" LVL FLUSH

(2) 2 x 10 (TYP.)

LOCATION OF WATER -

LOAD GARAGE

HEATER WITH SIDE

1'-10"

38'-0" SIDE 1A RECTANGLE A

CONTR. 2'-9"

ROOF TRUSSES ENG. BY OTHERS —

COVERED PORCH

(2) 2 x 10 (TYP.)

 $-(3) 2 \times 4 OR$

(3) 2 x 6

__4 x 4 TRTD. POST

MIN. (TYP. w/ OPT. PORCH)

<u>12'-0" SIDE 2B</u>

CAR GARAG

3) 2 x 12 CONT. FROM CORNEF

— GARAGE PORTAL FRAME. SEE—

METHOD PF WALL BRACING DETAIL

INCORPORATE SECOND FLOOR

12'-0" SIDE 1B RECTANGLE B

TRUSSES ENG. BY OTHERS

-BUMP OUT INTO ROOF


CONTR. 2'-9"

2'-2"

CONTR. 3'-3"

(4) 2 x 6

CONTR. $2^{1/2}9^{1/2}$

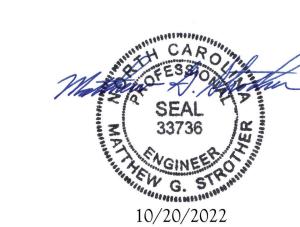



RENAISSANCE RESIDENTIAL DESIGN, INC.

WILMINGTON NC 28401

(919) 649-4128 WWW.RRDCAROLINA.COM

The art of transforming your vision into re ality." RENAISSANCE RESIDENTIAL DESIGN, INC. MODIFICATIONS TO FLOOR PLANS, DIMENSIONS, MATERIALS, AND

ARCHITECTURAL CONCEPT ONLY RENAISSANCE RESIDENTIAL DESIGN, INC. HEREBY EXPRESSLY RESERVES ITS COMMON LAW COPYRIGHT AND OTHER PROPERTY RIGHTS IN THESE PLANS. TO BE REPRODUCED, CHANGED, OR COPIED IN ANY FORM OR MANNER

SPECIFICATIONS WITHOUT NOTICE

THESE DRAWINGS ARE FOR THE PURPOSE OF CONVEYING AN

WRITTEN CONSENT OF BENAISSANCE RESIDENTIAL DESIGN, INC. NOR ARE THEY TO BE ASSIGNED TO ANY THIRD PARTY WITHOUT FIRST OBTAINING SAID WRITTEN PERMISSION AND CONSENT.

J.S.THOMPSON ENGINEERING, INC 333 E. SIX FORKS RD. SUITE 180 RALEIGH, NC 27609 PHONE: (919) 789-9919 FAX: (919) 789-9921 N.C. LICENSE NO.: C-1733



A&G RESIDENTIA MADISON

DATE: OCTOBER 7, 2022

REV.:

SCALE: 1/4"=1'-0"

DRAWN BY: WG ENGINEERED BY: WFB

REVIEWED BY: MGS

SECOND FLOOR FRAMING PLAN

2X4 WALLS

______ (2) 2 x 10 w/ (2) JACKS EA. END

L-----

*NOTE: ALL EXTERIOR WALLS AND ATTIC WALLS ARE TO BE 2 x 4 @ 16" O.C. MIN. (UNO). 2 x 6 @ 16" O.C. EXTERIOR WALLS MAY BE CONSTRUCTED IN LIEU OF 2 x 4 WALLS. ALL INTERIOR LOAD BEARING WALLS ARE TO BE 2 x 4 @ 16" O.C. (UNO) AND NON-LOAD BEARING INTERIOR WALLS ARE TO BE 2 x 4 @ 24" O.C. (UNO).

BRACED WALL DESIGN NOTES:

- 1. BRACED WALL DESIGN PER SECTION R602.10 OF THE NCRC 2018 EDITION. 2. CS-WSP REFERS TO "CONTINUOUS SHEATHING - WOOD STRUCTURAL PANELS" CONTRACTOR IS TO INSTALL 7/16" OSB ON ALL EXTERIOR WALLS ATTACHED w/ 8d NAILS SPACED 6" O.C. ALONG PANEL EDGES AND 12" O.C. IN THE FIELD.
- 3. *GB REFERS TO "GYPSUM BOARD" CONTRACTOR IS TO INSTALL 1/2" (MIN.) GYPSUM WALL BOARD WHERE NOTED ON THE PLANS. FASTEN GB WITH 1 1/4" SCREWS OR 1 5/8" NAILS SPACED 7" O.C. ALONG PANEL EDGES AND IN THE FIELD INCLUDING TOP AND BOTTOM PLATES.
- BRACED WALL DESIGN APPLIED IN WIND ZONES UP TO 130 MPH. FOR HIGH WIND ZONES, BRACE WALLS ARE TO BE CONSTRUCTED IN ACCORDANCE WITH CHAPTER 45 OF THE NCRC 2018 EDITION.
- 5. SEE NOTES AND DETAIL SHEETS FOR ADDITIONAL BRACED WALL INFORMATION.

CHANGES

OPTIONAL OWNER'S BAT

- 1. PER SECTION R602.10.3.2 OF THE 2018 NCRC, THE AMOUNT OF BRACING ON THE SECOND FLOOR EXCEEDS THE AMOUNT REQUIRED FOR THE FIRST FLOOR AND NO BRACED WALL ANALYSIS IS REQUIRED.
- 2. SHEATH ALL EXTERIOR WALLS WITH 7/16" OSB SHEATHING ATTACHED WITH 8d NAILS AT 6" O.C. ALONG PANEL EDGES AND 12" O.C. IN THE FIELD.

STRUCTURAL NOTES:


- ALL FRAMING LUMBER TO BE #2 SPF (UNO). 2. ALL LOAD BEARING HEADERS TO BE (2) 2 x 6
- WINDOW AND DOOR HEADERS TO BE SUPPORTED w/ (1) JACK STUD AND (1) KING STUD EA. END (UNO.). SEE TABLE R602.7.5 FOR ADDITIONAL KING STUD REQUIREMENTS. SQUARES DENOTE POINT LOADS WHICH REQUIRE
- SOLID BLOCKING TO GIRDER OR FOUNDATION. SQUARES TO BE (2) STUDS (UNO.) REFER TO NOTES AND DETAIL SHEETS FOR ADDITIONAL STRUCTURAL INFORMATION.


TABLE R602.7.5 MINIMUM NUMBER OF FULL HEIGHT KING STUDS AT EACH END OF HEADERS IN EXTERIOR WALLS

HEADER SPAN (FEET)	MINIMUM NUMBER OF FULL HEIGHT STUDS (KINGS)
UP TO 3'	1
> 3' TO 6'	2
> 6' TO 9'	3
> 9' TO 12'	4
> 12' TO 15'	5
	•

LEGEND		
CONT	CONTINUOUS	
XT	EXTRA TRUSS	
TS	TRUSS SUPPORT	
EA	EACH	
()	NUMBER OF STUDS	
DSP	DOUBLE STUD POCKET	
TSP	TRIPLE STUD POCKET	
OC	ON CENTER	
SPF	SPRUCE PINE FIR	
SYP	SOUTHERN YELLOW PINE	
TRTD	PRESSURE TREATED	
TYP	TYPICAL	
UNO	UNLESS NOTED OTHERWISE	



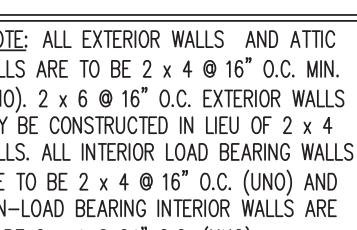

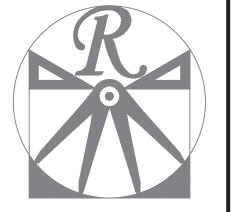

RENAISSANCE RESIDENTIAL DESIGN, INC.

WILMINGTON NC 28401

(919) 649-4128 WWW.RRDCAROLINA.COM "The art of transforming your vision into re ality."

RENAISSANCE RESIDENTIAL DESIGN, INC. MODIFICATIONS TO FLOOR PLANS, DIMENSIONS, MATERIALS, AND THESE DRAWINGS ARE FOR THE PURPOSE OF CONVEYING AN ARCHITECTURAL CONCEPT ONLY.

RENAISSANCE RESIDENTIAL DESIGN, INC. HEREBY EXPRESSLY RESERVES ITS COMMON LAW COPYRIGHT AND OTHER PROPERTY RIGHTS IN THESE PLANS. TO BE REPRODUCED, CHANGED, OR COPIED IN ANY FORM OR MANNER WITHOUT FIRST OBTAINING THE EXPRESS WRITTEN CONSENT OF RENAISSANCE RESIDENTIAL DESIGN, INC. NOR ARE THEY TO BE ASSIGNED TO ANY THIRD PARTY WITHOUT FIRST OBTAINING SAID WRITTEN PERMISSION AND CONSENT.

J.S.THOMPSON ENGINEERING, INC 333 E. SIX FORKS RD. SUITE 180 RALEIGH, NC 27609 PHONE: (919) 789-9919 FAX: (919) 789-9921 N.C. LICENSE NO.: C-1733



A&G RESIDENTIA MADISON

DATE: OCTOBER 7, 2022

SCALE: 1/4"=1'-0"


DRAWN BY: WG ENGINEERED BY: WFB

REVIEWED BY: MGS

ATTIC FLOOR

FRAMING PLAN

2X4 WALLS

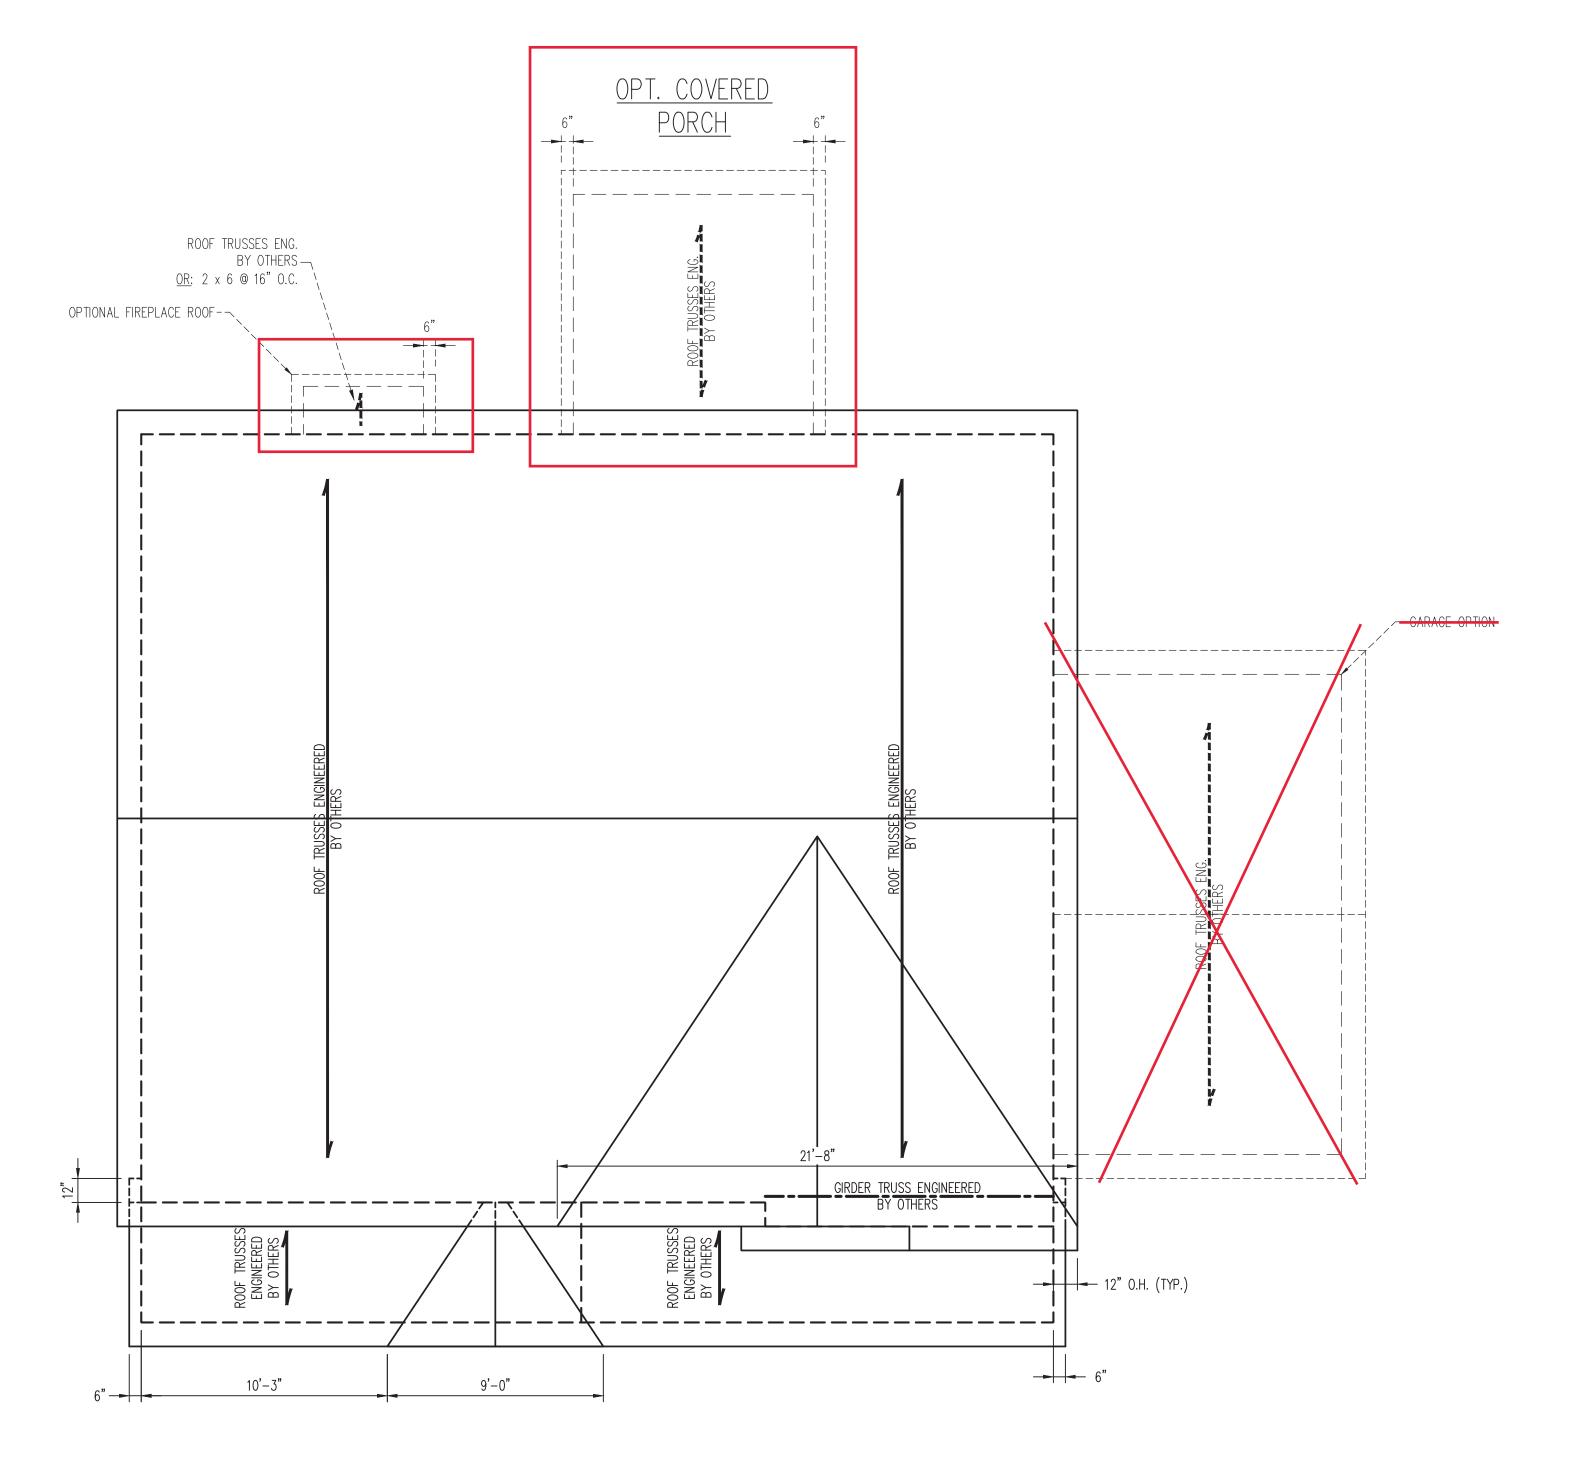


STRUCTURAL NOTES:

- ALL FRAMING LUMBER TO BE #2 SPF (UNO).
 CIRCLES DENOTE (3) 2 x 4 POSTS FOR ROOF SUPPORT
- 3. FRAME DORMER WALLS ON TOP OF DOUBLE OR TRIPLE RAFTERS.
- 4. HIP SPLICES ARE TO BE SPACED A MIN. OF 8'-0". FASTEN MEMBERS WITH THREE ROWS OF 12d NAILS @ 16" O.C. (TYP.)
- 2 x 8 RIDGES, 2 x 6 RAFTERS @ 16" O.C. AND FLAT 2 x 10 VALLEYS OR USE VALLEY TRUSSES.

 FASTEN FLAT VALLEYS TO RAFTERS OR TRUSSES WITH SIMPSON H2.5A HURRICANE TIES @ 32" O.C. MAX. PASS HURRICANE TIES THROUGH NOTCH IN ROOF SHEATHING. EACH RAFTER IS TO BE FASTENED TO THE FLAT VALLEY WITH A MIN. OF (6) 12d TOE NAILS.
- REFER TO SECTION R802.11 OF THE 2018 NCRC FOR REQUIRED UPLIFT RESISTANCE AT RAFTERS AND TRUSSES.
- REFER TO NOTES AND DETAIL SHEETS FOR ADDITIONAL STRUCTURAL INFORMATION.

NOTE: REFER TO ARCHITECTURAL DRAWINGS FOR ROOF PITCHES, PLATE HEIGHTS, DIMENSIONS, OVERHANG WIDTHS, AND ATTIC VENT CALCS.

LEGEND			
XT	XT EXTRA TRUSS		
TS	TRUSS SUPPORT		
CONT	CONTINUOUS		
EA	EACH		
OC	ON CENTER		
SPF	SPRUCE PINE FIR		
SYP	SOUTHERN YELLOW PINE		
TYP	TYPICAL		
UNO	UNLESS NOTED OTHERWISE		

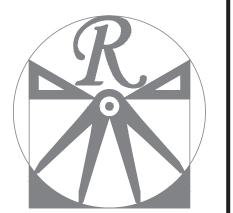

RENAISSANCE RESIDENTIAL DESIGN, INC.

WILMINGTON NC 28401

(919) 649-4128

WWW.RRDCAROLINA.COM

"The art of transforming your vision into re ality."

RENAISSANCE RESIDENTIAL DESIGN, INC.
RESERVES THE RIGHT TO MAKE
MODIFICATIONS TO FLOOR PLANS,
DIMENSIONS, MATERIALS, AND
SPECIFICATIONS WITHOUT NOTICE.
THESE DRAWINGS ARE FOR THE
PURPOSE OF CONVEYING AN
ARCHITECTURAL CONCEPT ONLY.

RENAISSANCE RESIDENTIAL DESIGN, INC.
HEREBY EXPRESSLY RESERVES ITS
COMMON LAW COPYRIGHT AND OTHER
PROPERTY RIGHTS IN THESE PLANS.
THESE PLANS AND DRAWINGS ARE NOT
TO BE REPRODUCED, CHANGED, OR
COPIED IN ANY FORM OR MANNER
WITHOUT FIRST OBTAINING THE EXPRESS
WRITTEN CONSENT OF RENAISSANCE
RESIDENTIAL DESIGN, INC. NOR ARE
THEY TO BE ASSIGNED TO ANY THIRD
PARTY WITHOUT FIRST OBTAINING SAID
WRITTEN PERMISSION AND CONSENT.

J.S.THOMPSON ENGINEERING, INC 333 E. SIX FORKS RD. SUITE 180 RALEIGH, NC 27609 PHONE: (919) 789-9919 FAX: (919) 789-9921 N.C. LICENSE NO.: C-1733



FLOOR PLANS, ELEVATIONS, DESIGNS, MATERIALS AND DIMENSIONS ARE SUBJECT TO CHANGE WITHOUT NOTICE. SOUARE FOOTAGE AND DIMENSIONS ARE ESTIMATED AND MAY ARY IN ACTUAL CONSTRUCTION. ACTUAL POSITION OF HOUSE ON LOT WILL BE DETERMINED BY THE SITE PLAN AND PLOT CONCEPTIONS. FLOOR PLANS ARE THE COPYRIGHTED PROPERTY OF A&G RESIDENTIAL. ANY USE, REPRODUCTION, ADAPTATION, OR DISPLAY OF THE PLANS IS STRICTLY PROHIBITED. SEE NEW HOME SALES CONSULTANT FOR CURRENT DETAILS. COPYRIGHT © 2019 A&G RESIDENTIAL

A&G RESIDENTIAL MADISON

SEAL 33736

DATE: OCTOBER 7, 2022

REV.:

SCALE: 1/4"=1'-0"


DRAWN BY: WG

ENGINEERED BY: WFB

REVIEWED BY: MGS

ROOF PLAN

Z:\CAD Drawings\JST-ENG CAD\A&G Residential\Madison\Madison_10-7-22.dwg, 10/20/2022 6:39:43 PM, Whitney Boykin, J.S. Thompson Engineering Inc.

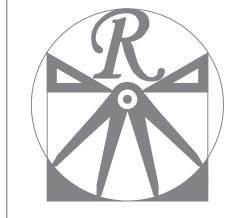

RENAISSANCE RESIDENTIAL DESIGN, INC.

WILMINGTON NC 28401 (919) 649-4128 WWW.RRDCAROLINA.COM "The art of transforming your vision into re ality."

> RENAISSANCE RESIDENTIAL DESIGN, INC. RESERVES THE RIGHT TO MAKE
> MODIFICATIONS TO FLOOR PLANS,
> DIMENSIONS, MATERIALS, AND
> SPECIFICATIONS WITHOUT NOTICE. THESE DRAWINGS ARE FOR THE PURPOSE OF CONVEYING AN ARCHITECTURAL CONCEPT ONLY.

HEREBY EXPRESSLY RESERVES ITS COMMON LAW COPYRIGHT AND OTHER PROPERTY RIGHTS IN THESE PLANS. THESE PLANS AND DRAWINGS ARE NOT TO BE REPRODUCED, CHANGED, OR COPIED IN ANY FORM OR MANNER WITHOUT FIRST OBTAINING THE EXPRESS WRITTEN CONSENT OF RENAISSANCE RESIDENTIAL DESIGN, INC. NOR ARE THEY TO BE ASSIGNED TO ANY THIRD PARTY WITHOUT FIRST OBTAINING SAID WRITTEN PERMISSION AND CONSENT.

RENAISSANCE RESIDENTIAL DESIGN, INC.

J.S.THOMPSON ENGINEERING, INC 333 E. SIX FORKS RD. SUITE 180 RALEIGH, NC 27609 PHONE: (919) 789-9919 FAX: (919) 789-9921 N.C. LICENSE NO.: C-1733



A&G RESIDENTIAL MADISON

DATE: OCTOBER 7, 2022

SCALE: 1/4"=1'-0"

DRAWN BY: WG

ENGINEERED BY: WFB

REVIEWED BY: MGS


FLOOR TRUSS

ALTERNATIVE


D-1

10/20/2022



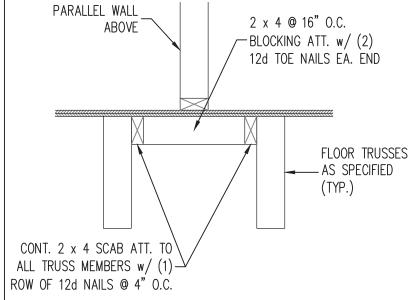

- 1. FLOOR TRUSSES ENGINEERED BY OTHERS AT THE DEPTH INDICATED ON THE PLAN SPACED AT 19.2" O.C. MAY BE USED IN LIEU OF I-JOISTS.
- 2. FIRST FLOOR SYSTEM TRUSSES ARE TO BE DESIGNED TO SUPPORT ADDITIONAL
- LOADING FROM OFFSET LOAD AND ISLAND. 3. AT POINT LOADS WITHIN OFFSET LOADS, INSTALL (2) 2 x 12 BLOCKING BETWEEN TRUSSES w/ FACE MOUNT HANGERS AT EA. END.
- 4. GIRDER TRUSSES ENGINEERED BY OTHERS ARE TO BE INSTALLED IN LIEU OF DOUBLE JOISTS SPECIFIED PER PLAN.
- 5. PROVIDE (1) LSL RIM BOARD MATCHING DEPTH OF FLOOR TRUSSES AT END OF CANT w/ EXTRA TRUSSES AT SIDES.
- 6. INSTALL 2 x 4 @ 16" O.C. BLOCKING BETWEEN ADJACENT TRUSSES UNDER WALLS PARALLEL TO FLOOR TRUSSES WHERE WALL LENGTH EXCEEDS 1/3 OF TRUSS SPAN (SEE DETAIL THIS SHEET). TRUSS DESIGNER TO DESIGN ADJACENT TRUSSES FOR ADDITIONAL LOADING FROM WALLS.

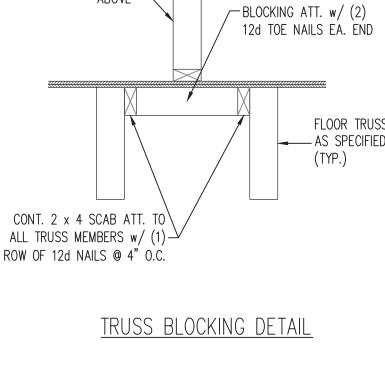

DATE: AUGUST 30, 2022 SCALE: NTS

DRAWN BY: JST

ENGINEERED BY: JST

FOUNDATION DETAILS

MASONRY STEMWALL SPECIFICATIONS MASONRY WALL TYPE WALL HEIGHT 4" BRICK AND 4" BRICK AND (FEET) 8" CMU 12" CMU 2 AND GROUT SOLID UNGROUTED UNGROUTED UNGROUTED BELOW UNGROUTED GROUT SOLID UNGROUTED UNGROUTED GROUT SOLID w/ #4 GROUT SOLID w/ #4 GROUT SOLID GROUT SOLID REBAR @ 64" O.C. REBAR @ 48" O.C. GROUT SOLID w/ #4 GROUT SOLID w/ #4 GROUT SOLID w/ #4 NOT APPLICABLE REBAR @ 36" O.C. REBAR @ 36" O.C. REBAR @ 64" O.C. GROUT SOLID w/ #4 GROUT SOLID w/ #4 GROUT SOLID w/ #4 NOT APPLICABLE 6 REBAR @ 24" O.C. REBAR @ 24" O.C. REBAR @ 64" O.C.

STRUCTURAL NOTES:

ENGINEERED DESIGN BASED ON SITE CONDITIONS

- 1) WALL HEIGHT MEASURED FROM TOP OF FOOTING TO TOP OF THE WALL.
- 2) TIE MULTIPLE WYTHES TOGETHER WITH LADDER WIRE AT 16" O.C. VERTICALLY.
- 3) CHART APPLICABLE FOR HOUSE FOUNDATION ONLY, CONSULT ENGINEER FOR DESIGN OF GARAGE FOUNDATION NOT COMMON TO HOUSE.
- 4) BACKFILL OF CLEAN #57 / #67 WASHED STONE IS ALLOWABLE.
- 5) BACKFILL OF WELL DRAINED OR SAND GRAVEL MIXTURE SOILS (45 PSF/FT BELOW GRADE) CLASSIFIED AS GROUP I ACCORDING TO UNIFIED SOILS CLASSIFICATION SYSTEM IN ACCORDANCE WITH <u>TABLE R405.1</u> OF THE 2018 NORTH CAROLINA RESIDENTIAL CODE ARE ALLOWABLE.
- 6) PREP SLAB PER <u>R506.2.1</u> AND <u>R506.2.2</u> BASE AND <u>EXCEPTION</u> OF 2018 NORTH CAROLINA RESIDENTIAL CODE.
- 1) MINIMUM 24" LAP SPLICE LENGTH.

7 AND

GREATER

- 8) LOCATE REBAR IN CENTER OF FOUNDATION WALL.
- 9) WHERE REQUIRED, FILL BLOCK SOLID WITH TYPE "S" MORTAR OR 3000 PSI GROUT. USE OF "LOW LIFT GROUTING" METHOD REQUIRED WHEN FILLING WALLS WITH GROUT AT HEIGHTS OF 5' AND GREATER.

PLATE(\$) A. BOLTS. ING AND REMENTS SHEATHING LADDER WIRE IN TOP TWO COURSES (w/ VENEER ONLY) OPTIONAL BRICK VENEER FINISHED GRADE EVERY OTHER COURSE WALL AND REMENT TO BE FILLED SOLID. SIDING AS SPEC. SHEATHING LADDER WIRE IN TOP TWO COURSES (w/ VENEER ONLY) OPTIONAL BRICK VENEER EVERY OTHER COURSE CHART FOR SPACING IS WIDE BY 8" DEEP CONT. CONC. FTG.	2 x 4 STUD FRAMING (UNO) W/ TRTD. BOTTOM PLATE(S) 2 x 4 TRTD. BOTTOM PLATE(S) 3 EECURED BY 1/2" DIA. BOLTS. 3 EEC CHART FOR SPACING AND EMBEDMENT REQUIREMENTS 4" CONCRETE SLAB W/ FIBER REINFORCING OR WELDED WIRE FABRIC 6 MIL. VAPOR BARRIER 4" WASHED STONE UNDISTURBED EARTH, COMPACTED FILL OR WASHED STONE TOP TWO COURSES OF STEM WALL AND ALL CELLS W/ REINFORCEMENT TO BE FILLED SOLID. BRICK TIES 6 1'-0" VERTICALLY AND 2'-8" HORIZONTALLY 4" BRICK VENEER FLASHING FLASHING FLASHING EEF HOLES **O ** ** ** ** ** ** ** **
STEM WALL FDN. DETAIL 1	STEM WALL FDN. W/ BRICK AND CURB (2)
BRICK TIES @ I'-O" VERTICALLY AND 2'-8" HORIZONTALLY BOLTS. NG AND EMENTS WEEP HOLES	2 x 4 STUD FRAMING (UNO) W/ TRTD. BOTTOM PLATE(S) 2 x 4 TRTD. BOTTOM PLATE(S) SECURED BY 1/2" DIA. BOLTS. SEE CHART FOR SPACING AND EMBEDMENT REQUIREMENTS 4" CONCRETE SLAB W/ FIBER REINFORCING OR WELDED WIRE FABRIC 6 MIL. VAPOR BARRIER

2 x 4 STUD FRAMING (UNO) W/ TRID. BOTTOM PLATE(9) 2 x 4 TRID. BOTTOM PLATE(9) 3 ECURED BY 1/2" DIA. BOLTS. 5 EE CHART FOR \$PACING AND EMBEDMENT REQUIREMENTS 4" BRICK VENEER 4" BRICK VENEER FLASHING 4" CONCRETE \$LAB W/ FIBER REINFORCING OR WELDED WIRE FABRIC 6 MIL. VAPOR BARRIER 4" WASHED STONE UNDISTURBED EARTH, COMPACTED FILL OR WASHED STONE TOP TWO COURSES OF STEM WALL AND TOP TWO COURSES OF STEM WALL AND ALL CELLS W/ REINFORCEMENT TO BE FILLED SOLID. 10 BRICK TIES ® I'-0" VERTICALLY AND 2'-8" HORIZONTALLY 4" BRICK TIES ® I'-0" VERTICALLY AND 2'-8" HORIZONTALLY 4" BRICK TIES ® I'-0" VERTICALLY AND 2'-8" HORIZONTALLY 4" BRICK TIES ® I'-0" VERTICALLY AND 2'-8" HORIZONTALLY 4" BRICK TIES ® I'-0" VERTICALLY AND 2'-8" HORIZONTALLY 4" BRICK TIES ® I'-0" VERTICALLY AND 2'-8" HORIZONTALLY 4" BRICK TIES ® I'-0" VERTICALLY AND 2'-8" HORIZONTALLY 4" BRICK TIES ® I'-0" VERTICALLY AND 2'-8" HORIZONTALLY 4" BRICK TIES ® I'-0" VERTICALLY AND 2'-8" HORIZONTALLY 4" BRICK TIES ® I'-0" VERTICALLY AND 2'-8" HORIZONTALLY 4" BRICK TIES ® I'-0" VERTICALLY AND 2'-8" HORIZONTALLY 4" BRICK TIES ® I'-0" VERTICALLY AND 2'-8" HORIZONTALLY 4" BRICK TIES ® I'-0" VERTICALLY AND 2'-8" HORIZONTALLY 4" BRICK TIES ® I'-0" VERTICALLY AND 2'-8" HORIZONTALLY 4" BRICK TIES ® I'-0" VERTICALLY AND 2'-8" HORIZONTALLY 4" BRICK TIES ® I'-0" VERTICALLY AND 2'-8" HORIZONTALLY 4" BRICK TIES SE I'-0" VERTICALLY AND 2'-8" HORIZONTALLY 4" BRICK TIES SE I'-0" VERTICALLY I'-0" VERTICALLY 4" BRICK TIES SE I'-0" VERTICALLY I'-0	2 × 4 TRTD. BOTTOM PLATE(\$) SECURED BY 1/2" DIA. BOLT9. SEE CHART FOR SPACING AND EMBEDMENT REQUIREMENTS 4" CONCRETE \$LAB W/ FIBER REINFORCING OR WELDED WIRE FABRIC 6 MIL. VAPOR BARRIER 4" WASHED \$TONE UNDISTURBED EARTH, COMPACTED FILL OR WASHED \$TONE TOP TWO COURSES OF STEM WALL AND ALL CELLS W/ REINFORCEMENT TO BE FILLED \$0LID. FOR OPTIONAL BRICK WATERTABLE, INCREASE TO 20" WIDE BY 8" DEEP CONT. CONC. FTG.
STEM WALL FDN. W/ BRICK DETAIL (3)	STEM WALL FDN. W/ OPTIONAL BRICK WATERTABLE DETAIL (4)

2 x 4 STUD FRAMING (UNO) W/ TRTD. BOTTOM PLATE(S)

2 x 4 TRTD. BOTTOM PLATE(S)—

SECURED BY 1/2" DIA. BOLTS.

SEE CHART FOR SPACING AND EMBEDMENT REQUIREMENTS

THICKENED SLAB

4" CONCRETE SLAB-

6 MIL. VAPOR

UNDISTURBED EARTH,

COMPACTED FILL

OR WASHED STONE

TOP TWO COURSES OF STEM WALL AND-

ALL CELLS W/ REINFORCEMENT TO BE

W/ FIBER REINFORCING OR WELDED WIRE FABRIC


4" WASHED STONE


NOT REQUIRED


ANCHOR SPACING AND EMBEDMENT			NOTE:
WIND ZONE	120 MPH	130 MPH	THREADED ROD WITH EPOXY,
SPACING	6'-0" O.C. INSTALL MIN. (2) ANCHORS PER PLATE SECTION AND (1) ANCHOR WITHIN 12" OF CORNERS	4'-0" O.C. INSTALL MIN. (2) ANCHORS PER PLATE SECTION AND (1) ANCHOR WITHIN 12" OF CORNERS	SIMPSON TITEN HD, OR APPROVED ANCHORS SPACED AS REQUIRED TO PROVIDE EQUIVALENT ANCHORAGE TO 1/2" DIAMETER ANCHOR BOLTS MAY BE USED IN
EMBEDMENT	7"	15" INTO MASONRY 7" INTO CONCRETE	LIEU OF 1/2" ANCHOR BOLTS.


This sealed page is to be used in conjunction with a full plan set engineered by J.S. Thompson Engineering, Inc. only. Use of this individual sealed page within architectural pages or shop drawings by others is a punishable offense under N.C. Statute § 89C-23

- WALL BRACING DESIGNED IN ACCORDANCE WITH CHAPTER 6 OF THE 2018 NC RESIDENTIAL BUILDING CODE (NCRC). TABLES AND FIGURES REFERENCED ARE FROM THE 2018 NCRC.
- SEE THIS SHEET FOR GENERAL DETAILS. REFER TO THE 2018 NCRC FOR ADDITIONAL INFORMATION AS NEEDED BRACED EXTERIOR WALLS SUPPORTING ROOF TRUSSES AND RAFTERS, INCLUDING STORIES BELOW THE TOP FLOOR, HAVE BEEN DESIGNED PER R602.3.5 (3). WALL SHEATHING AND FASTENERS HAVE BEEN DESIGNED TO RESIST COMBINED UPLIFT AND SHEAR FORCES IN ACCORDANCE WITH ACCEPTED ENGINEERED PRACTICE.
- . SEE STRUCTURAL SHEETS FOR BRACED WALL LOCATIONS, DIMENSIONS, HOLD DOWN TYPE AND LOCATIONS, BRACED WALL LINE KEY WITH WALL DESIGN SUMMARY OF REQUIRED/PROVIDED TOTALS FOR EACH WALL LINE AND ANY SPECIAL NOTES OR REQUIREMENTS 5. ALL EXTERIOR WALLS ARE TO BE SHEATHED WITH CS-WSP IN ACCORDANCE WITH SECTION R602.10.3 UNLESS NOTED OTHERWISE.
- 6. ALL EXTERIOR AND INTERIOR WALLS TO HAVE 1/2" GYPSUM INSTALLED. WHEN NOT USING METHOD "GB", GYPSUM TO BE FASTENED PER TABLE R702.3.5. METHOD GB TO BE FASTENED PER TABLE R602.10.1
- 7. CS-WSP REFERS TO THE "CONTINUOUS SHEATHING WOOD STRUCTURAL PANELS" WALL BRACING METHOD. 7/16" OSB SHEATHING IS TO BE INSTALLED ON ALL EXTERIOR WALLS ATTACHED w/ 6d COMMON NAILS OR 8d (2 1/2" LONG x 0.113" DIAMETER) NAILS SPACED 6" O.C. ALONG PANEL EDGES AND 12" O.C. IN THE FIELD (U.N.O.).
- B. GB REFERS TO THE "GYPSUM BOARD" WALL BRACING METHOD. 1/2" (MIN.) GYPSUM WALL BOARD IS TO BE INSTALLED ON BOTH SIDES OF THE BRACED WALL FASTENED WITH 1 1/4" SCREWS OR 1 5/8" NAILS SPACED 7" O.C. ALONG PANEL EDGES INCLUDING TOP AND BOTTOM PLATES AND INTERMEDIATE SUPPORTS (U.N.O.). VERIFY ALL FASTENER OPTIONS FOR 1/2" AND 5/8" GYPSUM PRIOR TO CONSTRUCTION. FOR INTERIOR FASTENER OPTIONS SEE TABLE R702.3.5. FOR EXTERIOR FASTENER OPTIONS SEE TABLE R602.3(1). EXTERIOR GB TO BE INSTALLED VERTICALLY.
- REQUIRED BRACED WALL LENGTH FOR EACH SIDE OF THE CIRCUMSCRIBED RECTANGLE ARE INTERPOLATED PER TABLE R602. 10.3. METHOD CS-WSP CONTRIBUTES ITS ACTUAL LENGTH, METHOD GB CONTRIBUTES .5 ITS ACTUAL LENGTH, AND METHOD PF CONTRIBUTES 1.5 TIMES ITS ACTUAL LENGTH.

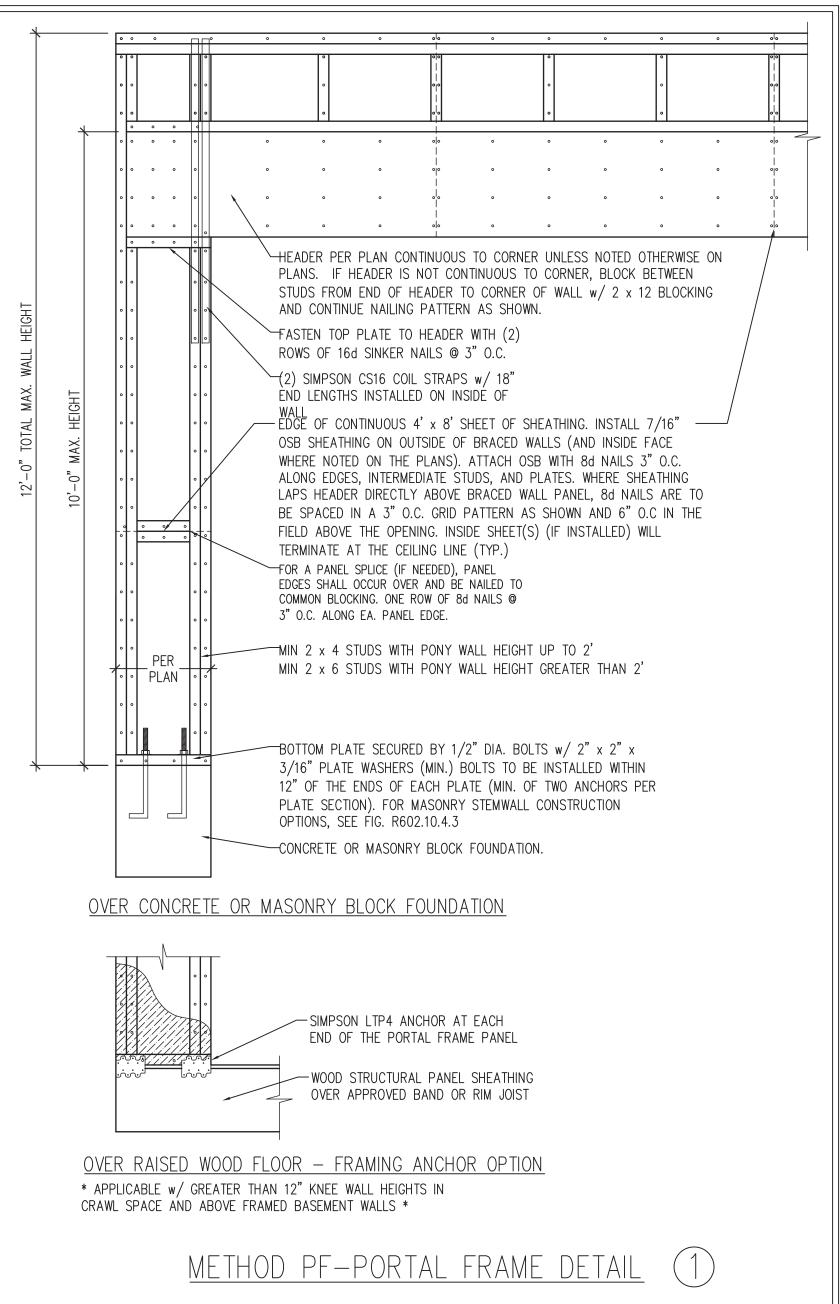

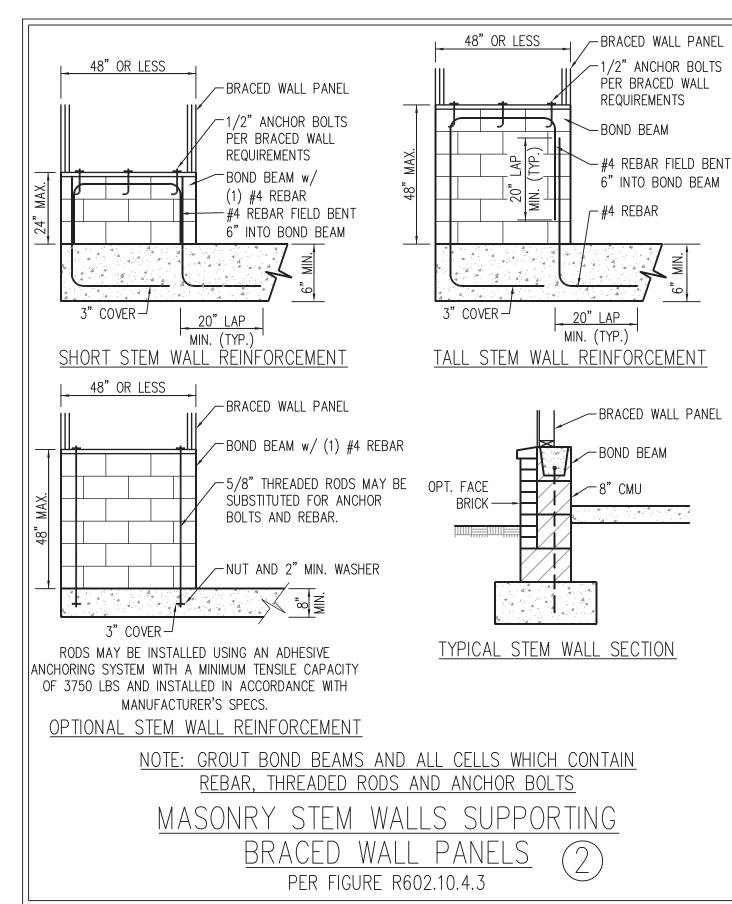


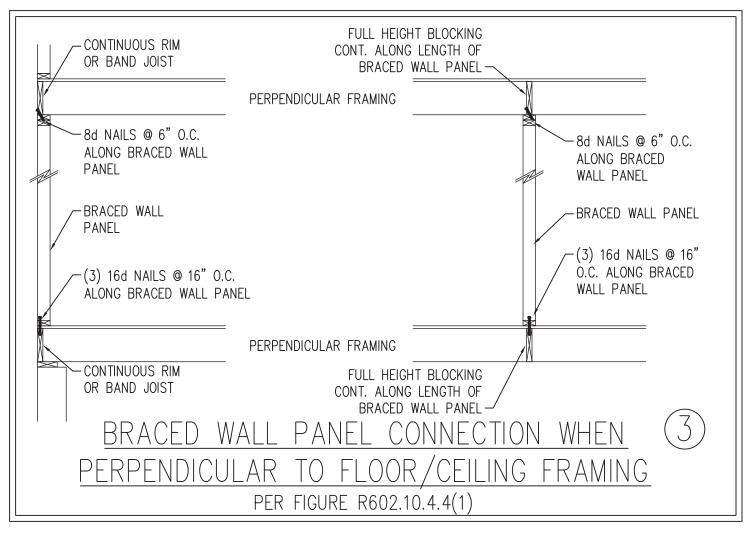

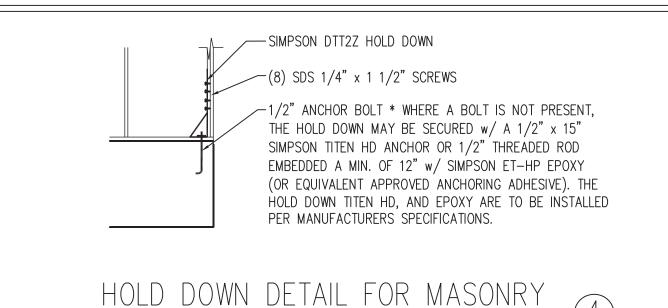



FOUNDATION OR MONOLITHIC SLAB


* APPLICABLE ONLY WHERE SPECIFIED ON PLAN *

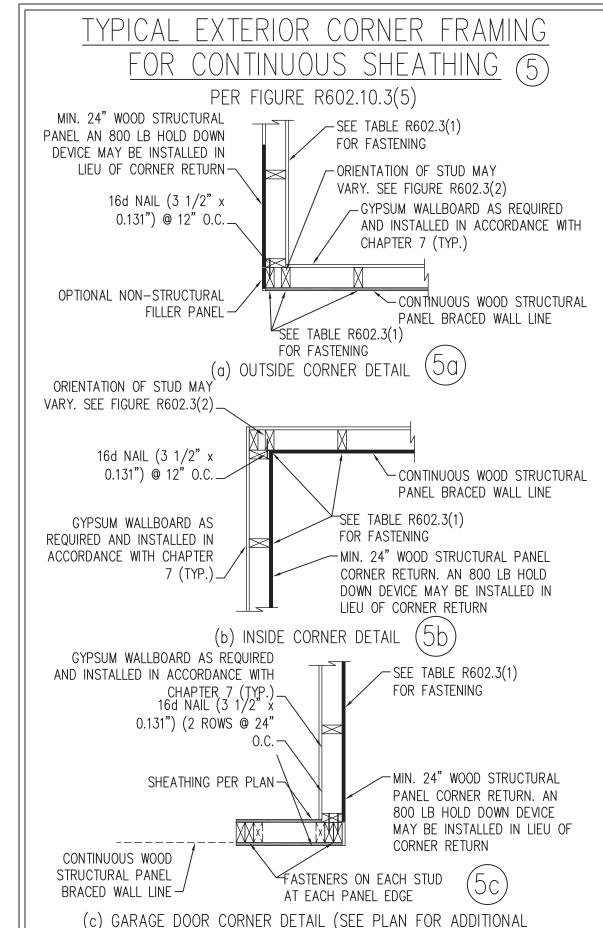


STRUCTURAL INFORMATION OR ALTERNATE CONFIGURATIONS)

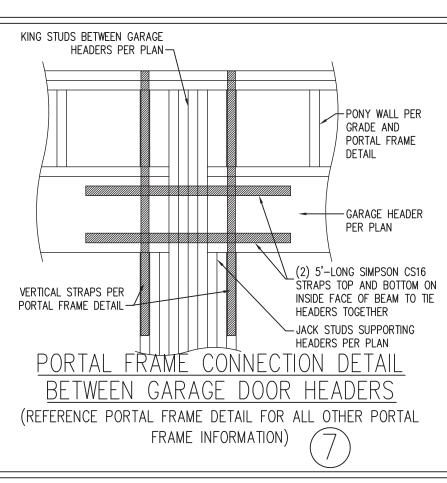

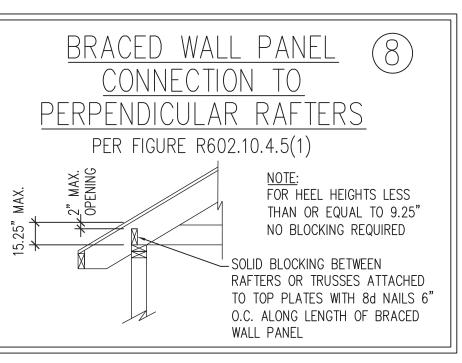

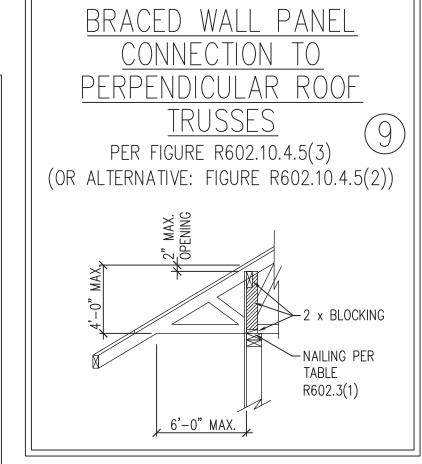

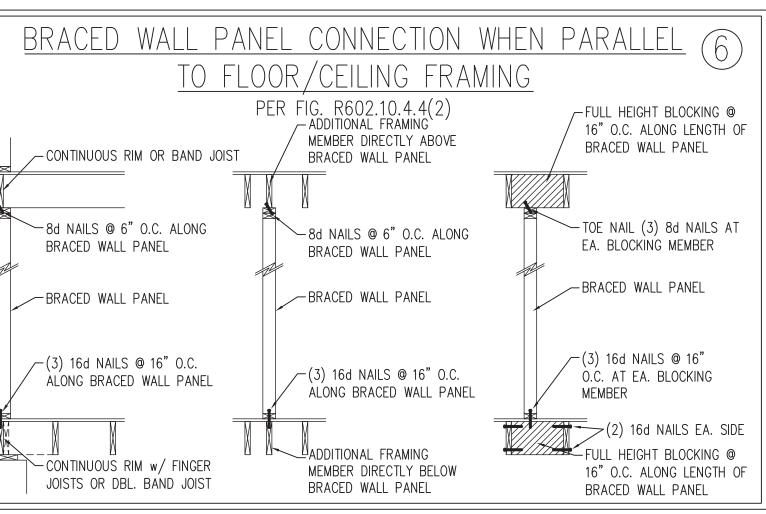

This sealed page is to be used in conjunction with a full plan set engineered by J.S. Thompson Engineering, Inc. only. Use of this individual sealed page within architectural pages or shop drawings by others is a punishable offense under N.C. Statute § 89C-23



10/20/2022

ANI BRACING

DATE: AUGUST 30, 2022

SCALE: 1/4" = 1'-0"

BRACED WALL NOTES AND DETAILS AND PF DETAIL

1. ALL FRAMING LUMBER SHALL BE #2 SPF MINIMUM (Fb = 875 PSI, Fv = 375 PSI, E = 1600000 PSI) UNLESS NOTED OTHERWISE (UNO). ALL TREATED LUMBER SHALL BE #2 SYP MINIMUM (Fb = 975 PSI, Fv = 175 PSI, E = 1600000 PSI) UNLESS NOTED OTHERWISE (UNO). 2. LAMINATED VENEER LUMBER (LVL) SHALL HAVE THE FOLLOWING MINIMUM PROPERTIES: Fb = 2600 PSI, Fv = 285 PSI, E = 1900000 PSI. LAMINATED

STRAND LUMBER (LSL) SHALL HAVE THE FOLLOWING MINIMUM PROPERTIES: Fb = 2325 PSI, Fv = 310 PSI, E = 1550000 PSI. PARALLEL STRAND LUMBER (PSL) UP TO 7" DEPTH SHALL HAVE THE FOLLOWING MINIMUM PROPERTIES: Fc = 2500 PSI, E =1800000 PSI. PARALLEL STRAND LUMBER (PSL) MORE THAN 7" DEPTH SHALL HAVE THE FOLLOWING MINIMUM PROPERTIES: Fc = 2900 PSI, E = 2000000 PSI. INSTALL ALL CONNECTIONS

4. STEEL BEAMS SHALL BE SUPPORTED AT EACH END WITH A MINIMUM BEARING LENGTH OF 3 1/2" AND FULL FLANGE WIDTH (UNO). PROVIDE SOLID BEARING FROM BEAM SUPPORT TO FOUNDATION. BEAMS SHALL BE ATTACHED AT THE BOTTOM FLANGE TO EACH SUPPORT AS FOLLOWS (UNO):

ASTM A53, GRADE B, TYPE E OR S

FRAMING NOTES

A. WOOD FRAMING (2) 1/2" DIA. x 4" LONG LAG SCREWS (2) 1/2" DIA. x 4" WEDGE ANCHORS B. CONCRETE (2) 1/2" DIA. x 4" LONG SIMPSON TITEN HD ANCHORS C. MASONRY (FULLY GROUTED) (4) 3/4" DIA. A325 BOLTS OR 3/16" FILLET WELD D. STEEL PIPE COLUMN

ASTM A992

ASTM A36

ASTM A36

ASTM A500 GRADE B

PER MANUFACTURER'S SPECIFICATIONS.

W AND WT SHAPES:

PLATES AND BARS:

STEEL PIPE:

CHANNELS AND ANGLES:

HOLLOW STRUCTURAL SECTIONS:

3. STRUCTURAL STEEL SHALL CONFORM TO THE FOLLOWING ASTM SPECIFICATIONS

LATERAL SUPPORT IS CONSIDERED ADEQUATE PROVIDING THE JOISTS ARE TOE NAILED TO THE 2x NAILER ON TOP OF THE STEEL BEAM, AND THE 2x NAILER IS SECURED TO THE TOP OF THE STEEL BEAM w/(2) ROWS OF SELF TAPPING SCREWS @ 16" O.C. OR (2) ROWS OF 1/2" DIAMETER BOLTS @ 16" O.C. IF 1/2" BOLTS ARE USED TO FASTEN THE NAILER, THE STEEL BEAM SHALL BE FABRICATED w/ (2) ROWS OF 9/16" DIAMETER HOLES @ 16" O.C.

- 5. SQUARES DENOTE POINT LOADS WHICH REQUIRE SOLID BLOCKING TO GIRDER OR FOUNDATION. SHADED SQUARES DENOTE POINT LOADS FROM ABOVE WHICH REQUIRE SOLID BLOCKING TO SUPPORTING MEMBER BELOW.
- 6. ALL LOAD BEARING HEADERS TO CONFORM TO TABLE R602.7(1) AND R602.7(2) OF THE NCRC, 2018 EDITION OR BE (2) 2 x 6 WITH (1) JACK AND (1) KING STUD EACH END (UNO), WHICHEVER IS GREATER ALL HEADERS TO BE SECURED TO EACH JACK STUD WITH (4) 8d NAILS. ALL BEAMS TO BE SUPPORTED WITH (2) STUDS AT EACH BEARING POINT (UNO). INSTALL KING STUDS PER SECTION R602.7.5 OF THE NORTH CAROLINA RESIDENTIAL CODE, 2018 EDITION.
- 7. ALL BEAMS, HEADERS, OR GIRDER TRUSSES PARALLEL TO WALL ARE TO BEAR FULLY ON (1) JACK OR (2) STUDS MINIMUM OR THE NUMBER OF JACKS OR STUDS NOTED. ALL BEAMS OR GIRDER TRUSSES PERPENDICULAR TO WALL AND SUPPORTED BY (3) STUDS OR LESS ARE TO HAVE 1 1/2" MINIMUM BEARING (UNO). ALL BEAMS OR GIRDER TRUSSES PERPENDICULAR TO WALL AND SUPPORTED BY MORE THAN (3) STUDS OR OTHER NOTED COLUMN ARE TO BEAR FULLY ON SUPPORT COLUMN FOR ENTIRE WALL DEPTH (UNO). BEAM ENDS THAT BUTT INTO ONE ANOTHER ARE TO EACH BEAR EQUAL LENGTHS (UNO).
- 8. FLITCH BEAMS SHALL BE BOLTED TOGETHER USING 1/2" DIAMETER BOLTS (ASTM A307) WITH WASHERS PLACED AT THREADED END OF BOLT. BOLTS SHALL BE SPACED AT 24" CENTERS (MAXIMUM). AND STAGGERED AT TOP AND BOTTOM OF BEAM (2" EDGE DISTANCE). WITH (2) BOLTS LOCATED AT 6" FROM EACH END (UNO).
- 9. ALL I-JOIST OR TRUSS LAYOUTS ARE TO BE IN COMPLIANCE WITH THE OVERALL DESIGN SPECIFIED ON THE PLANS. ALL DEVIATIONS ARE TO BE BROUGHT TO THE ATTENTION OF THE ENGINEER OF RECORD PRIOR TO INSTALLATION.
- 10. BRACED WALL PANELS SHALL BE CONSTRUCTED ACCORDING TO THE NORTH CAROLINA RESIDENTIAL CODE 2018 EDITION WALL BRACING CRITERIA. THE AMOUNT, LENGTH, AND LOCATION OF BRACING SHALL COMPLY WITH ALL APPLICABLE TABLES IN SECTION R602.10.
- 11. PROVIDE DOUBLE JOIST UNDER ALL WALLS PARALLEL TO FLOOR JOISTS. PROVIDE SUPPORT UNDER ALL WALLS PARALLEL TO FLOOR TRUSSES OR I-JOISTS PER MANUFACTURER'S SPECIFICATIONS. INSTALL BLOCKING BETWEEN JOISTS OR TRUSSES FOR POINT LOAD SUPPORT FOR ALL POINT LOADS ALONG OFFSET LOAD LINES.
- 12. FOR ALL HEADERS SUPPORTING BRICK VENEER THAT ARE LESS THAN 8'-0" IN LENGTH, REST A 6" x 4" x 5/16" STEEL ANGLE WITH 6" MINIMUM EMBEDMENT AT SIDES FOR BRICK SUPPORT (U.N.O). FOR ALL HEADERS 8'-0" AND GREATER IN LENGTH, BOLT A 6" x 4" x 5/16" STEEL ANGLE TO HEADER WITH 1/2" LAG SCREWS AT 12" O.C. STAGGERED FOR BRICK SUPPORT. FOR ALL BRICK SUPPORT AT ROOF LINES, BOLT A 6" x 4" x 5/16" STEEL ANGLE TO (2) 2 x 10 BLOCKING INSTALLED w/ (4) 12d NAILS EA. PLY BETWEEN WALL STUDS WITH (2) ROWS OF 1/2" LAG SCREWS AT 12" O.C. STAGGERED AND IN ACCORDANCE WITH SECTION R703.8.2.1 OF THE NCRC, 2018 EDITION.
- 13. FOR STICK FRAMED ROOFS: CIRCLES DENOTE (3) 2 x 4 POSTS FOR ROOF MEMBER SUPPORT. HIP SPLICES ARE TO BE SPACED A MINIMUM OF 8'-0". FASTEN MEMBERS WITH THREE ROWS OF 12d NAILS AT 16" O.C. FRAME DORMER WALLS ON TOP OF DOUBLE OR TRIPLE RAFTERS AS SHOWN (UNO).
- 14. FOR TRUSSED ROOFS: FRAME DORMER WALLS ON TOP OF 2 x 4 LADDER FRAMING AT 24" O.C. BETWEEN ADJACENT ROOF TRUSSES. STICK FRAME OVER-FRAMED ROOF SECTIONS WITH 2 x 8 RIDGES, 2 x 6 RAFTERS AT 16" O.C. AND FLAT 2 x 10 VALLEYS (UNO).
- 15. ALL 4 x 4 AND 6 x 6 POSTS TO BE INSTALLED WITH 700 LB CAPACITY UPLIFT CONNECTORS TOP AND BOTTOM (UNO.) POSTS MAY BE SECURED USING ONE SIMPSON H6 OR LTS12 UPLIFT CONNECTOR FASTENED TO THE BAND AT THE BOTTOM AND THE BEAM AT THE TOP OF EACH POST. ONE 16" SECTION OF SIMPSON CS16 COIL STRAPPING WITH (8) 8d HDG NAILS AT EACH END MAY BE USED IN LIEU OF EACH TWIST STRAP IF DESIRED. FOR MASONRY OR CONCRETE FOUNDATION USE SIMPSON POST BASE.

GENERAL NOTES

- 1. ENGINEER'S SEAL APPLIES ONLY TO STRUCTURAL COMPONENTS INCLUDING ROOF RAFTERS, HIPS, VALLEYS, RIDGES, FLOORS, WALLS, BEAMS, HEADERS, COLUMNS, CANTILEVERS, OFFSET LOAD BEARING WALLS, PIERS, GIRDER SYSTEM AND FOOTING. ENGINEER'S SEAL DOES NOT CERTIFY DIMENSIONAL ACCURACY OF ARCHITECTURAL LAYOUT INCLUDING ROOF. ENGINEER'S SEAL DOES NOT APPLY TO I-JOIST OR FLOOR/ROOF TRUSS LAYOUT DESIGN AND ACCURACY.
- 2. ALL CONSTRUCTION SHALL CONFORM TO THE LATEST REQUIREMENTS OF THE NORTH CAROLINA RESIDENTIAL CODE (NCRC), 2018 EDITION, PLUS ALL LOCAL CODES AND REGULATIONS. THE STRUCTURAL ENGINEER IS NOT RESPONSIBLE FOR, AND WILL NOT HAVE CONTROL OF, CONSTRUCTION MEANS, METHODS, TECHNIQUES, SEQUENCES OR PROCEDURES, OR SAFETY PRECAUTIONS AND PROGRAMS IN CONNECTION WITH THE CONSTRUCTION WORK. NOR WILL THE ENGINEER BE RESPONSIBLE FOR THE CONTRACTORS FAILURE TO CARRY OUT THE CONSTRUCTION WORK IN ACCORDANCE WITH THE CONTRACT DOCUMENTS.
- 3. STRUCTURAL DESIGN BASED ON THE PROVISIONS OF THE NCRC, 2018 EDITION (R301.4 R301.7)

DESIGN CRITERIA:	LIVE LOAD (PSF)	DEAD LOAD (PSF)	DEFLECTION (IN)
ATTIC WITH LIMITED STORAGE	20	10	L/240 (L/360 w/ BRITTLE FINISHES)
ATTIC WITHOUT STORAGE	10	10	L/360
DECKS	40	10	L/360
EXTERIOR BALCONIES	40	10	L/360
FIRE ESCAPES	40	10	L/360
HANDRAILS/GUARDRAILS	200	10	L/360
PASSENGER VEHICLE GARAGE	50	10	L/360
ROOMS OTHER THAN SLEEPING ROOM	40	10	L/360
SLEEPING ROOMS	30	10	L/360
STAIRS	40	10	L/360
WIND LOAD	(BASED ON TABLE R301.2(4) WIND ZONE AND EXPOSURE)		
GROUND SNOW LOAD: Pg	20 (PSF)	,	

- I-JOIST SYSTEMS DESIGNED WITH 12 PSF DEAD LOAD AND DEFLECTION (IN) OF L/480 - FLOOR TRUSS SYSTEMS DESIGNED WITH 15 PSF DEAD LOAD

- 4. FOR 115 AND 120 MPH WIND ZONES, FOUNDATION ANCHORAGE IS TO COMPLY WITH SECTION R403.1.6 OF THE NCRC, 2018 EDITION. FOR 130 MPH, 140 MPH, AND 150 MPH WIND ZONES, FOUNDATION ANCHORAGE IS TO COMPLY WITH SECTION 4504 OF THE NCRC, 2018 EDITION.
- 5. ENERGY EFFICIENCY COMPLIANCE AND INSULATION VALUES OF THE BUILDING TO BE IN ACCORDANCE WITH CHAPTER 11 OF THE NCRC, 2018 EDITION.

FOOTING AND FOUNDATION NOTES

- 1. FOUNDATION DESIGN BASED ON A MINIMUM ALLOWABLE BEARING CAPACITY OF 2000 PSF. CONTACT GEOTECHNICAL ENGINEER IF BEARING CAPACITY IS NOT ACHIEVED.
- 2. FOR ALL CONCRETE SLABS AND FOOTINGS, THE AREA WITHIN THE PERIMETER OF THE BUILDING ENVELOPE SHALL HAVE ALL VEGETATION, TOP SOIL AND FOREIGN MATERIAL REMOVED. FILL MATERIAL SHALL BE FREE OF VEGETATION AND FOREIGN MATERIAL. THE FILL SHALL BE COMPACTED TO ASSURE UNIFORM SUPPORT OF THE SLAB, AND EXCEPT WHERE APPROVED, THE FILL DEPTHS SHALL NOT EXCEED 24" FOR CLEAN SAND OR GRAVEL. A 4" THICK BASED COURSE CONSISTING OF CLEAN GRADED SAND OR GRAVEL SHALL BE PLACED. A BASE COURSE IS NOT REQUIRED WHERE A CONCRETE SLAB IS INSTALLED ON WELL-DRAINED OR SAND-GRAVEL MIXTURE SOILS CLASSIFIED AS GROUP 1, ACCORDING TO THE UNITED SOIL CLASSIFICATION SYSTEM IN ACCORDANCE WITH TABLE R405.1 OF THE NCRC, 2018 EDITION.
- 3. PROPERLY DEWATER EXCAVATION PRIOR TO POURING CONCRETE WHEN BOTTOM OF CONCRETE SLAB IS AT OR BELOW WATER TABLE. IF APPLICABLE, 3/4" — 1" DEEP CONTROL JOINTS ARE TO BE SAWED WITHIN 4 TO 12 HOURS OF CONCRETE FINISHING AND WALL LOCATIONS HAVE BEEN MARKED. ADJUST WHERE NECESSARY.
- 4. CONCRETE SHALL CONFORM TO SECTION R402.2 OF THE NCRC, 2018 EDITION. CONCRETE REINFORCING STEEL TO BE ASTM A615 GRADE 60. WELDED WIRE FABRIC TO BE ASTM A185. MAINTAIN A MINIMUM CONCRETE COVER AROUND REINFORCING STEFL OF 3" IN FOOTINGS AND 1 1/2" IN SLABS. FOR POURED CONCRETE WALLS, CONCRETE COVER FOR REINFORCING STEEL MEASURED FROM THE INSIDE FACE OF THE WALL SHALL NOT BE LESS THAN 3/4". CONCRETE COVER FOR REINFORCING STEEL MEASURED FROM THE OUTSIDE FACE OF THE WALL SHALL NOT BE LESS THAN 1 1/2" FOR #5 BARS OR SMALLER, AND NOT LESS THAN 2" FOR #6 BARS OR LARGER.
- 5. MASONRY UNITS TO CONFORM TO ACE 530/ASCE 5/TMS 402. MORTAR SHALL CONFORM TO ASTM C270.
- 6. THE UNSUPPORTED HEIGHT OF MASONRY PIERS SHALL NOT EXCEED FOUR TIMES THEIR LEAST DIMENSION FOR UNFILLED HOLLOW CONCRETE MASONRY UNITS AND TEN TIMES THEIR LEAST DIMENSION FOR SOLID OR SOLID FILLED PIERS. PERS MAY BE FILLED SOLID WITH CONCRETE OR TYPE M OR S MORTAR. PIERS AND WALLS SHALL BE CAPPED WITH 8" OF SOLID MASONRY.
- 7. THE CENTER OF EACH OF THE PIERS SHALL BEAR IN THE MIDDLE THIRD OF ITS RESPECTIVE FOOTING. EACH GIRDER SHALL BEAR IN THE MIDDLE THIRD OF THE PIERS.
- 8. ALL CONCRETE AND MASONRY FOUNDATION WALLS ARE TO BE CONSTRUCTED IN ACCORDANCE WITH THE PROVISIONS OF SECTION R404 OF THE NCRC, 2018 EDITION OR IN ACCORDANCE WITH ACI 318, ACI 332, NCMA TR68-A OR ACE 530/ASCE 5/TMS 402. MASONRY FOUNDATION WALLS ARE TO BE REINFORCED PER TABLE R404.1.1(1), R404.1.1(2), R404.1.1(3), OR R404.1.1(4) OF THE NCRC, 2018 EDITION. CONCRETE FOUNDATION WALLS ARE TO BE REINFORCED PER TABLE R404.1.1(5) OF THE NCRC, 2018 EDITION. STEP CONCRETE FOUNDATION WALLS TO 2 x 6 FRAMED WALLS AT 16" O.C. WHERE GRADE PERMITS (UNO).

This sealed page is to be used in conjunction with a full plan set engineered by J.S. Thompson Engineering, Inc. only. Use of this individual sealed page within architectural pages or shop drawings by others is a punishable offense under N.C. Statute § 89C-23

STRUCTURAL

NOTES

S AR

ENGINEERED BY: JST

DATE: AUGUST 30, 2022

DRAWN BY: JST