#### **REVISION LOG**

REVISION:001

ADJUST OPTION SQUARE FOOTAGES TO ACCURATELY SHOW THE DIFFERENCES FROM THE BASE PLAN SQUARE FOOTAGE TOTALS.

REVISION:002

1. ADJUST OPTION SQUARE FOOTAGES TO ACCURATELY SHOW THE DIFFERENCES FROM THE BASE PLAN SQUARE FOOTAGE TOTALS.
2. EXTENDED TRIM AT GARAGE DOOR DOWN TO BASE AND CUT STONE BACK
3. ADJUSTED KITCHEN ISLAND
4. RESIZED THE FIREPLACE OPTION
5. RELOCATED THE WINDOW IN THE MESSY KITCHEN TO BEHIND THE OPT. SINK
6. CHANGED MESSY KITCHEN WINDOW TO OPTIONAL
7. ADDED CHASE TO OWNER'S WIC
8. ADDED DIMST TO 0. BATH VANITY FOR CLARIFICATION
9. REMOVED OPT. DOOR TO LOFT
10. ADDED CHASE TO LOFT WIC
11. RELOCATED LINEN IN THE 0. BATH OPTIONS
12. REMOVED THE OPT. SUPER SHOWER (ZERO ENTRY)
13. FLIPPED SMART DOOR DELIVERY DOOR HANDING
14. CHANGED ALL LINEN CLOSETS TO HAVE ONLY 4 SHELVES
15. CHANGED SIZE OF BASE SHOWER TO GOX36
16. UPDATED OPTIONAL SQ. FTIG. CHART
17. REMOVED HALE WALLS AT KITCHEN ISLAND AND UPDATED PER CABINET PROVIDER
18. EXTEND PORCH SLAB 4\* AF FRONT AND EXTEND AROUND CORNER 20\* TO SUPPORT STONE VENEER
19. EXTEND PORCH SLAB 4\* AROUND THE PERMETER AT THE 'CRAFTSMAN' ELEVATION

REVISION:003 DATE: 3/30/2022

EXTEND PORCH SLAB 4" AROUND THE PERIMETER AT THE 'CRAFTSMAN' ELEVATION

ADDED A COLUMN DETAIL FOR CLARITY ON THE "CRAFTSMAM" ELEVATION
ADDED A SEPARATE OPTION FOR THE POCKET OFFICE WITH THE SMART DELIVERY DOOR
ADDED ELECTRICAL PLAN SHEETS

DATE: 7/22/2022

REVISION:004 DATE: 6/20/2022

1. ADD SIDE LOAD GARAGE.

REVISION:005

ADD STEM WALL SLAB FOUNDATION SHEETS CORRECT OPTIONAL SMART DELIVERY DOOR LOCATION ON FOUNDATION PLANS TO MATCH FLOOR PLAN.

REVISION:006 DATE: 10/29/23

CHANNEL MORAL STRUMENT IN MACAMA.

ADDED SIDE LOAD GARAGE FOUNDATION FOR EXTENDED CAFE OPTION.

UPDATED SQUARE FOOTAGE CHART TO ADD EXTENDED PATIO TO THE EXTENDED CAFE
OPTION

4. MOVED WATER HEATER TO INNER CORNER FOR ALL SIDE LOAD OPTIONS.

12-12-23 - Reverse Plan from LH to RH

Lot 2B Heritage @ Neil's Creek

1701 Neills Creek Rd. Lillington, NC 27546

Signature Series

# NC.



Right Side Load Garage

#### **DESIGN CRITERIA:**

THIS PLAN IS TO BE BUILT IN CONFORMANCE WITH THE 2018 NORTH CAROLINA STATE BUILDING CODE: RESIDENTIAL CODE

DIMENSIONS SHALL GOVERN OVER SCALE, AND CODE SHALL GOVERN OVER DIMENSIONS.

## PLAN 2 The Holly - RH

### **'ENGLISH COUNTRY' ELEVATION**

Sheet No.	Sheet Description
0.0	Cover Sheet
1.1	Foundation (Slab)
1.1.1	Foundation Options (Slab)
1.1.2	Foundation Options (Slab)
1.2	Foundation (Crawl)
1.2.1	Foundation Options (Crawl)
1.2.2	Foundation Options (Crawl)
1.3	Foundation (Stem Wall Slab)
1.3.1	Foundation Options (Stem Wall Slab)
1.3.2	Foundation Options (Stem Wall Slab)
2.1	First Floor Plan
2.1.1	First Floor Plan Options
2.2	Second Floor Plan
2.2.1	Second Floor Plan Options
2.4	Covered Porch Plans & Elevations (Slab)
2.4.1	Covered Porch Plans & Elevations (Crawl/Stem Wall)
2.5	Covered Porch w/ Extended Cafe Plans & Elevations (Slab)
2.5.1	Covered Porch w/ Extended Cafe Plans & Elevations (Crawl/ Stem Wall
2.6	Extended Cafe Plans & Elevations (Slab)
2.6.1	Extended Cafe Plans & Elevations (Crawl/ Stem Wall)
2.7	2-Car Sideload Garage Plans
2.7.1	2-Car Sideload Garage Elevations
3.1	Front & Rear Elevations (Slab)
3.1.1	Front & Rear Elevations (Crawl/ Stem Wall)
3.2	Side Elevations (Slab)
3.2.1	Side Elevations (Crawl/ Stem Wall)
3.3	Roof Plan
5.1	First Floor Electrical
5.1.1	First Floor Options Electrical
5.2	Second Floor Electrical
5.2.1	Second Floor Options Electrical

SQUARE	FOOTA	4GE
	ENGLISH (	COUNTRY
	UNHEATED	HEATED
FIRST FLOOR	0	872
SECOND FLOOR	0	1337
FRONT FORCH	132	0
2 CAR GARAGE	437	0
PATIO	160	0
SUBTOTALS	727	2209
TOTAL UNDER ROOF	29	38
OF	PTIONS	
	UNHEATED S.F.	HEATED S.F.
COVERED PATIO	160	0
EXTENDED CAFE w/ PATIO	+148	+152
REAR POCKET OFFICE	0	+60-
FRONT POCKET OFFICE	0	+37
FRONT PORCH W/	142	0
FRONT POCKET OFFICE		
W/ SMART DOOR	+18	+51





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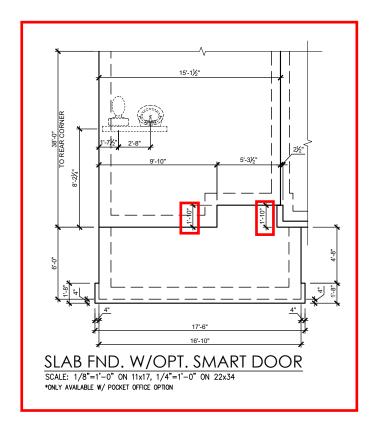
Sheet 'English Country -RH THE HOLLY Cover

DRAWN BY: South Designs ISSUE DATE: CURRENT REVISION DATE

1/8" = 1'-0"



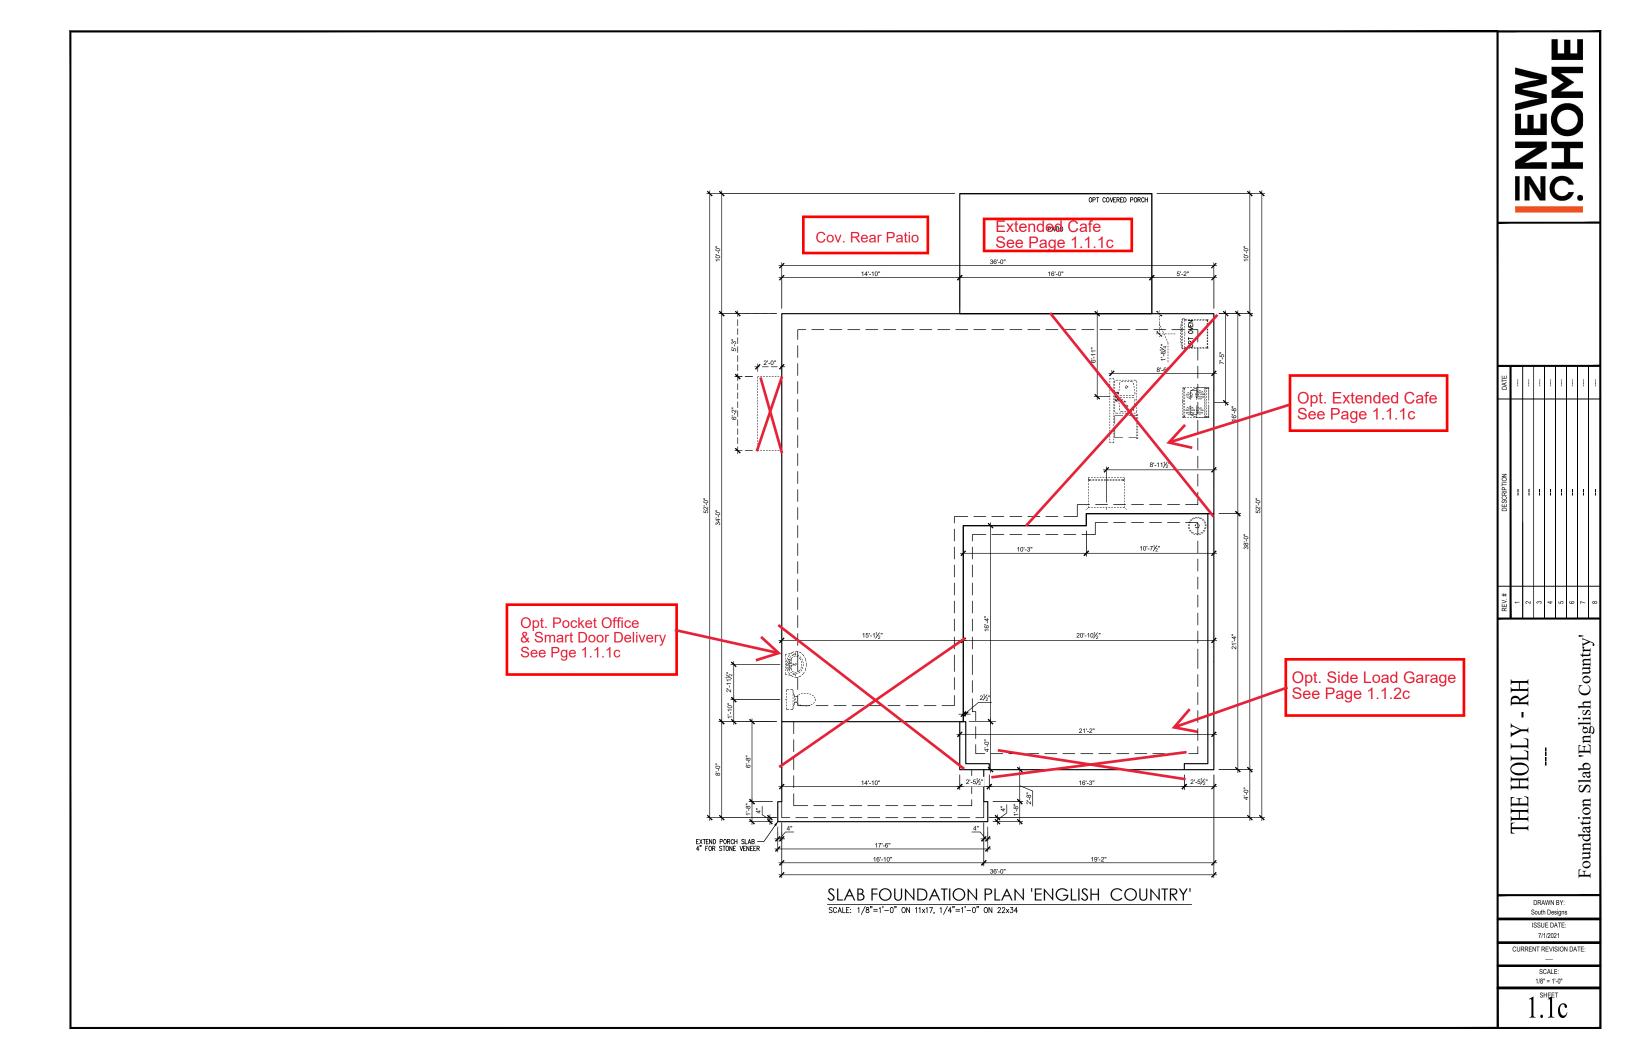

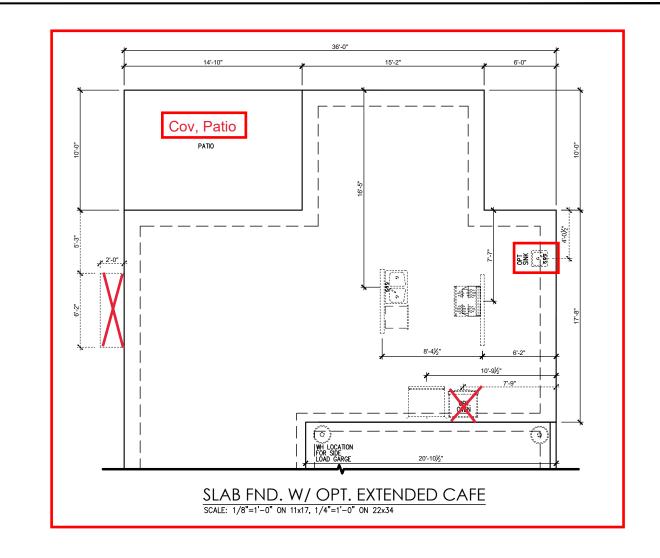




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THE HOLLY - RH
--Foundation Slab Options 'English
Country'

DRAWN BY: South Designs

ISSUE DATE: 7/1/2021


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SCALE: 1/8" = 1'-0"
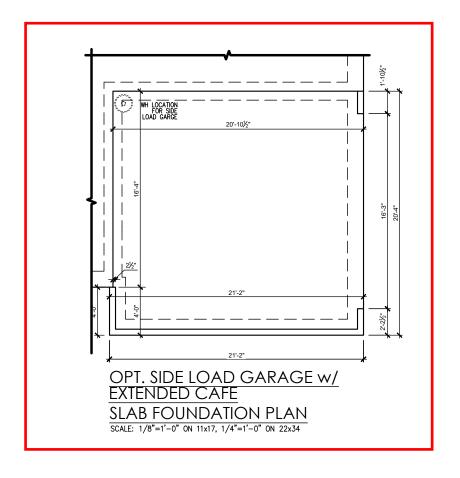
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General Floor Plan Notes shall apply unless noted otherwise on plan.

- Wall Heights: Typically 9-1 1/2" at first floor and 8-1 1/2" at second floor and attics U.N.O. All walls are constructed using a double top plate. Splices at Double Top Plate do not need to occur at Vertical Studs but must be at least 24" apart from Joint in other Top Plate layer. Special wall heights are noted on plans where they occur.
- Wall Thickness is typically 3 1/2". 2x6 frame shall be used at walls that back up to plumbing fixtures.
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- Jacks: Openings up to 3'-4" wide shall have (1) 2x4
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  side.
- Soffits, Coffered Ceilings, Trey Ceilings and other significant ceiling plan elements are shown on the floor plans and are denoted as single dashed lines. Unless specifically call out as included, Kitchens do not include soffits over wall cabinetry.
- Door & Window Frames, where occurring near corners, shall be a minimum of 4 1/2" from corner. Except for walk-in closets with doors near a corner, doors at closets shall be centered on closet.
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- Closets for clothing or coat storage shall be equipped with 1 rod/shelf. Closets for linen shall have 4 open equal shelves. Closets for pantries shall have 4 equal wood shelves, painted.
- Stair treads shall be a min of 9" deep, risers shall be a maximum of 8 1/4", unless noted otherwise, per the current North Carolina Residential Code
- 10.Handralis and Guards at stairs shall be 34" above the finished surface of the ramp surface of the stair. Handralis at landings and overlooks of multilevel spaces shall be 36" above finished floor. Guards (pickets o balusters) shall be spaced with no more than 4" between guards.
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Plan 'English Country'

First Floor

RH

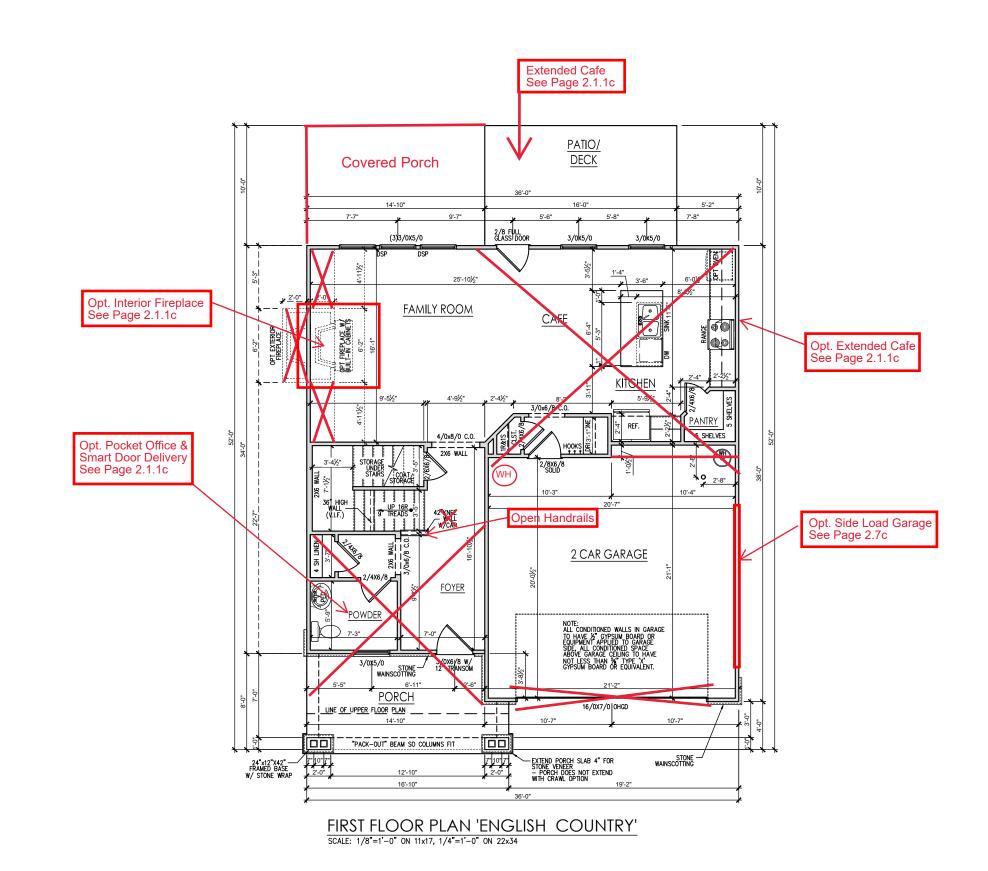**НОГГУ** 

THE


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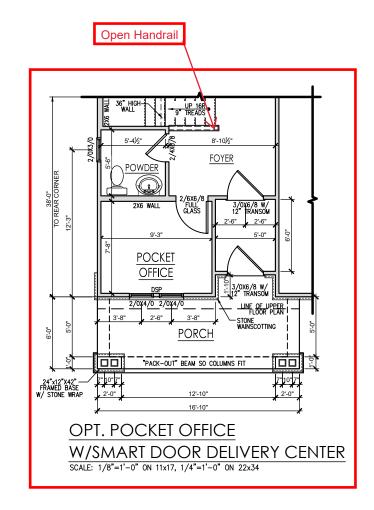
South Designs
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7/1/2021
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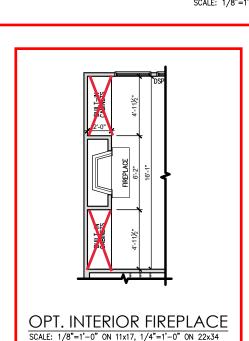
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THE HOLLY - RH
--First Floor Plan Options 'English Country'


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SCALE: 1/8"=1'-0" ON 11x17, 1/4"=1'-0" ON 22x34

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THE HOLLY - RH
--Second Floor Plan 'English Country'

DRAWN BY: South Designs


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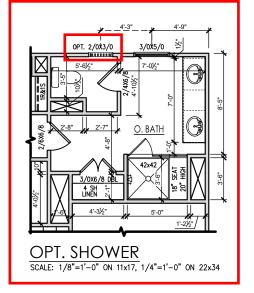
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 $2^{\text{SHEET}}$ 
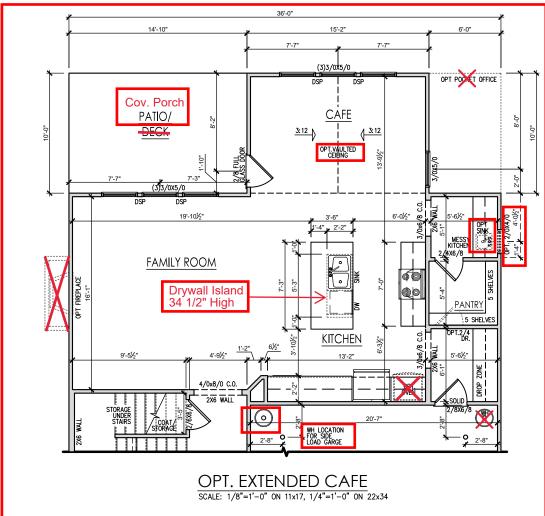
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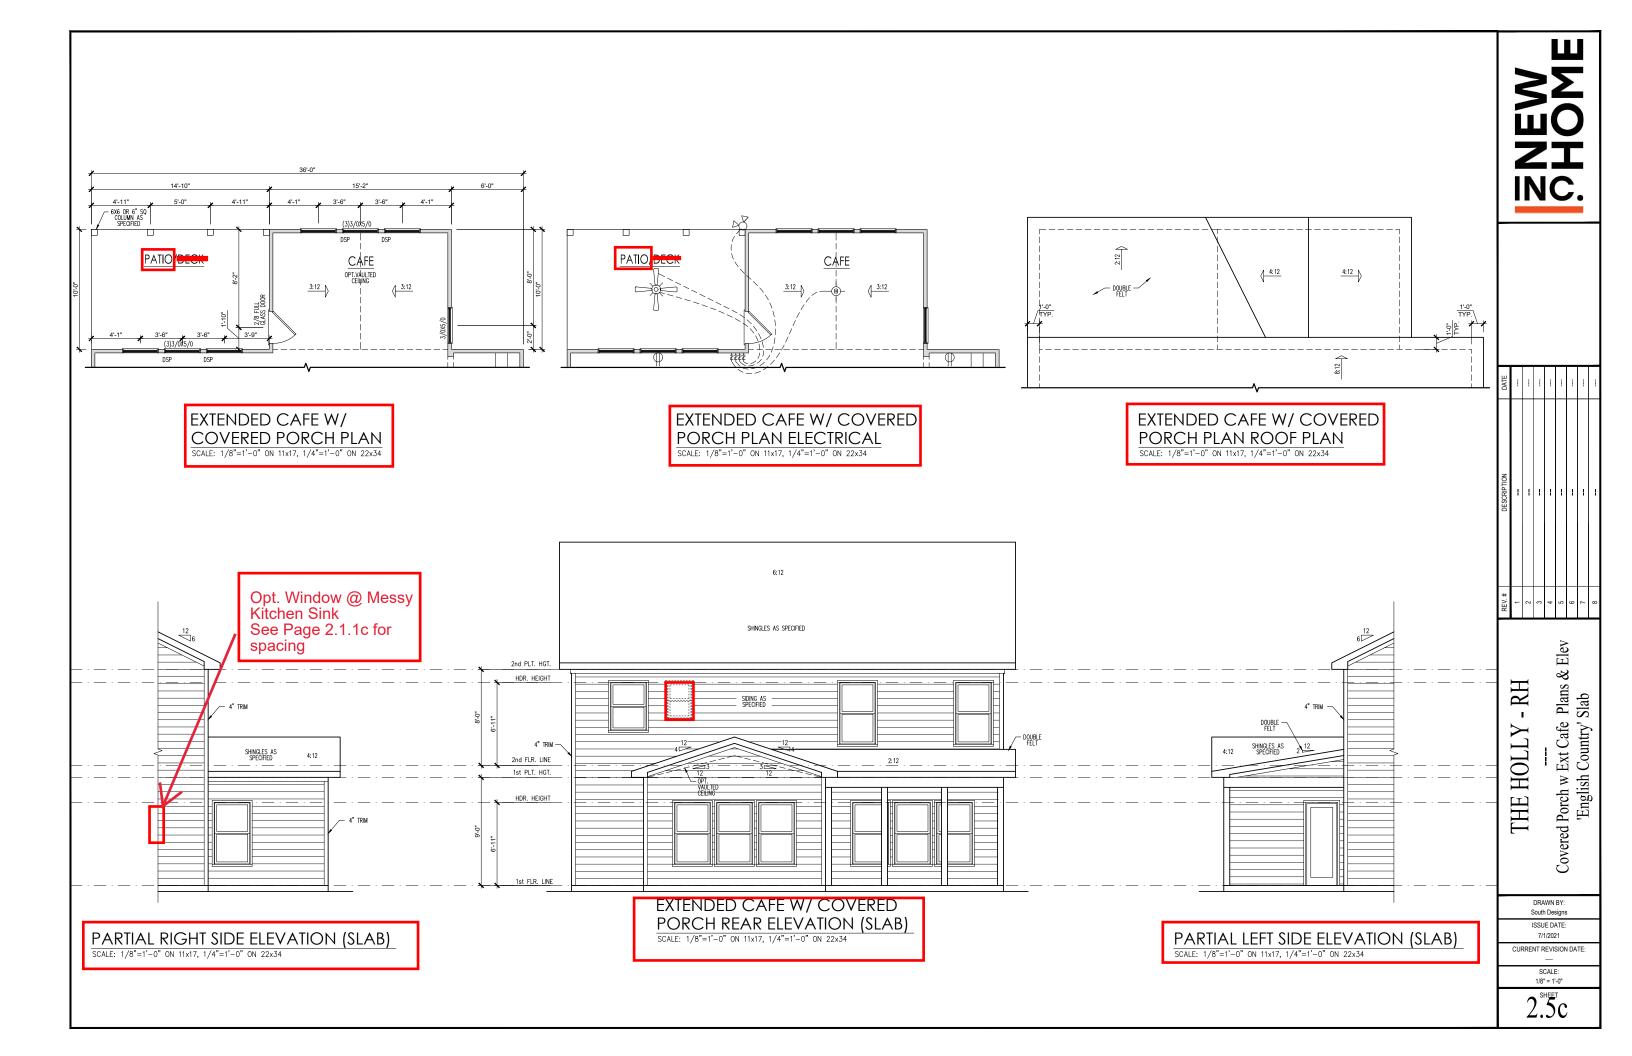
Second Floor Plan Options 'English Country' -RH THE HOLLY

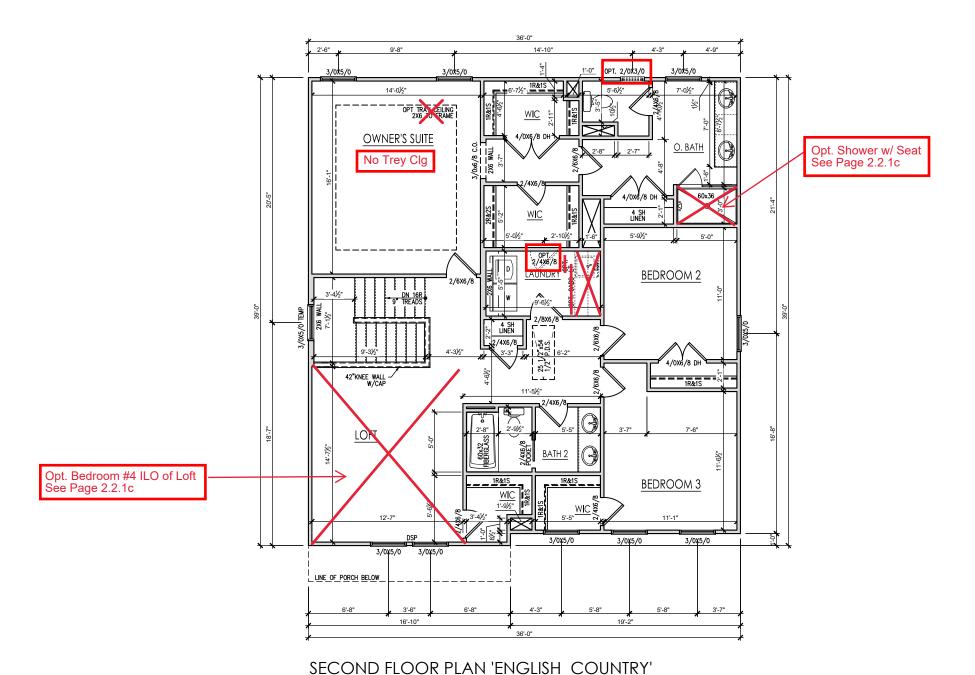
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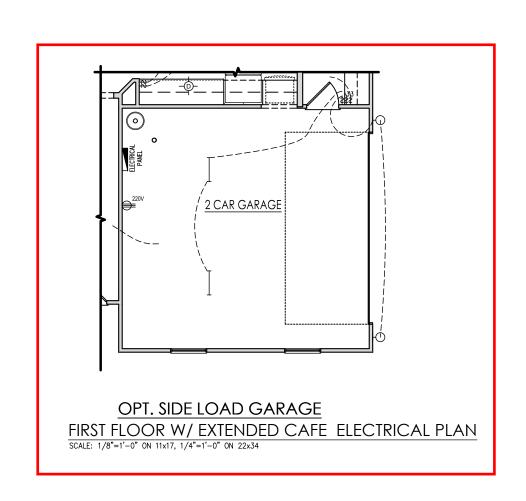
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CURRENT REVISION DATE:

1/8" = 1'-0"



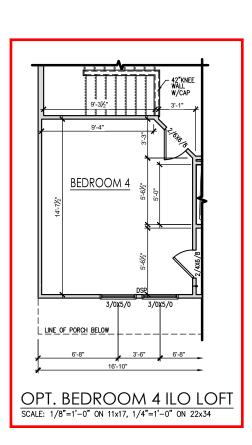



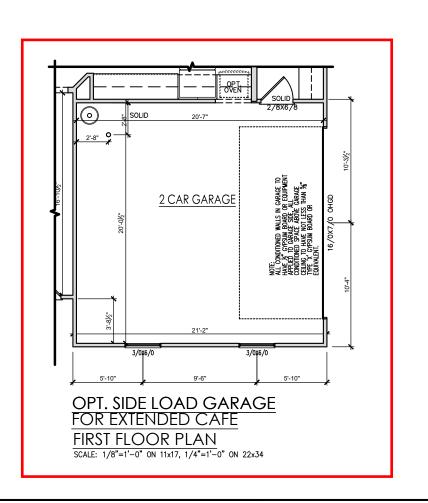

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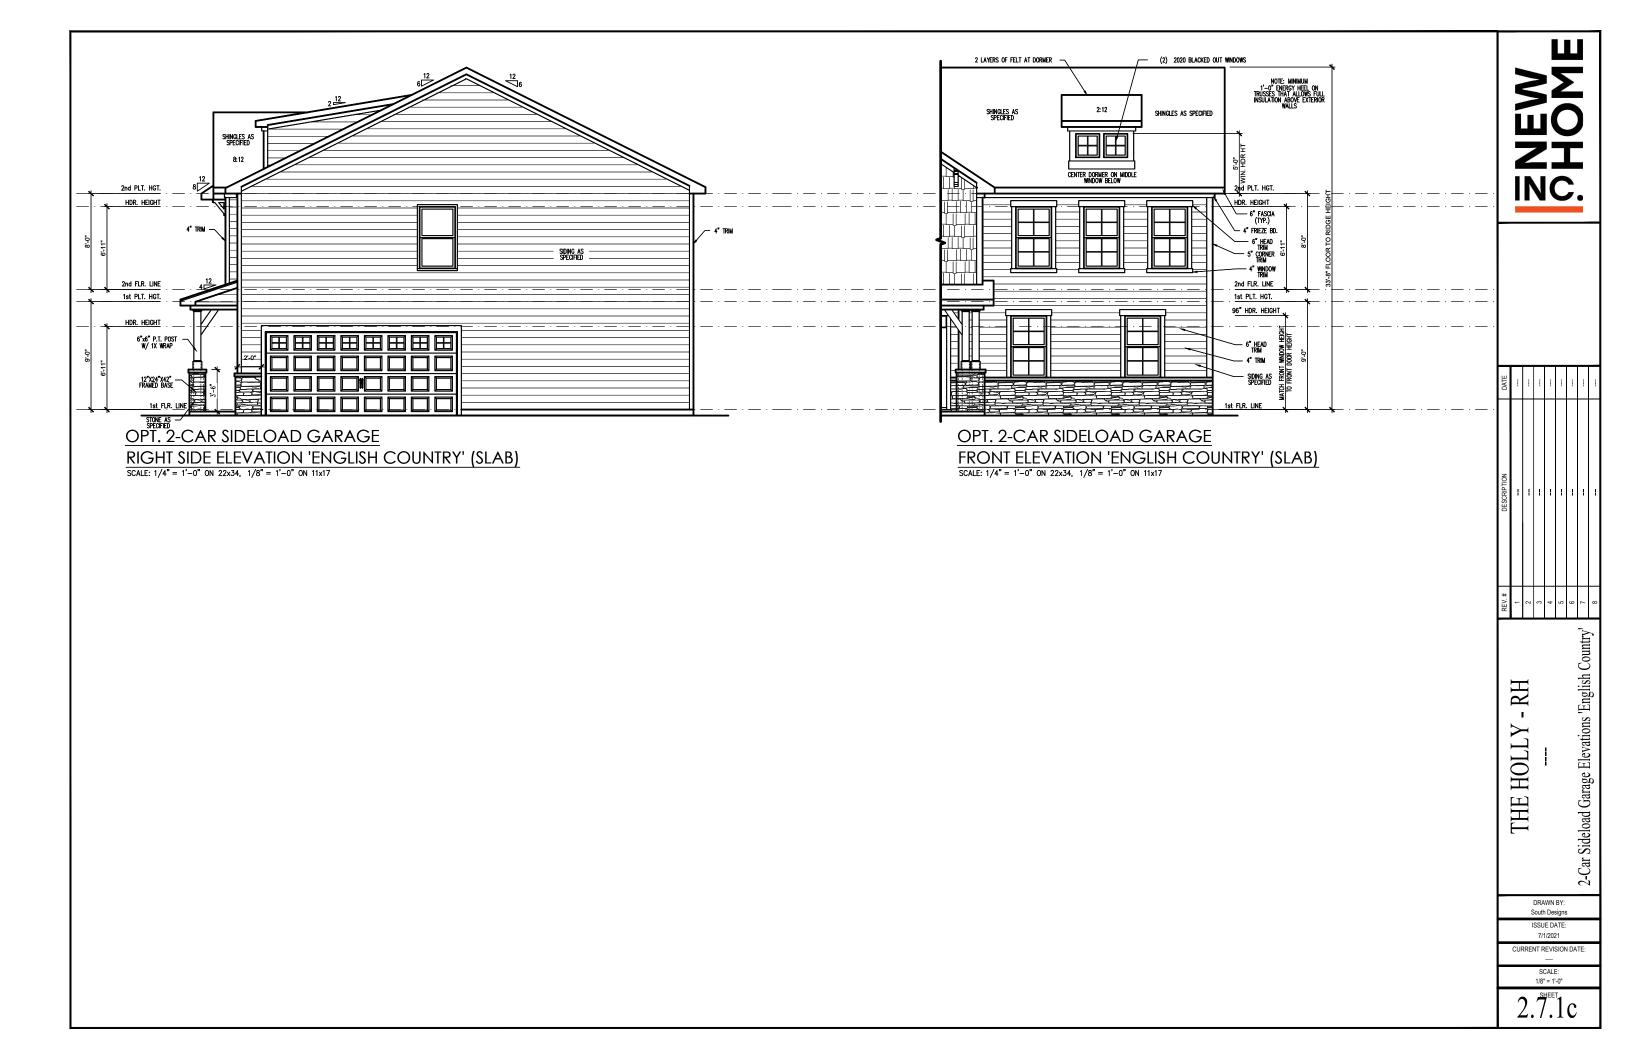
THE HOLLY - RH
--2-Car Sideload Garage Plans 'English Country'

DRAWN BY: South Designs

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1/8" = 1'-0"

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#### **General Elevation Notes**

General Elevation Notes shall apply unless


- Roof shall be finished with architectural composition shingles with slopes as noted on plan.
- Ridge Vent shall be provided and installed on all ridges greater than 6' in length per manufacturer's specifications.
- 3. Soffit Vent shall be continuous soffit vent
- House Wrap, "tyvek" or approved equal shall be installed over entire exterior wall per manufacturer's specifications and recommendations
- Flashing shall be provided above all door and window openings, above finish wall material changes and at wall surfaces where lower roof areas abut vertical wall surfaces.
- Porch Railings shall be provided at all porch walking surfaces greater than 30" above adjacent finished grade. It shall be 36" high with guards spaced no more than 4" apart. Consult community specifications for material.
- Finish Wall Material shall be as noted on elevation drawings.
- 8. Brick Veneer, if included on elevation shall be tied to wall surface with galvanized corrugated metal ties at a rate of 24" oc horizontally and 16" oc vertically so that no more than 2.67st of brick is supported by (1) tie. Space between face of wall and back face of brick shall be limited to a maximum of 1". Flashing shall be provided behind brick above all wall openings and at base of brick wall. Flashing shall be a minimum of 6-mil poly or other corrosion resistant material and shall be installed so that it laps under the house wrap material a minimum of 2".

  Weepholes shall be provided at a rate of 48" oc and shall not be less than 3/16" in diameter and shall be located immediately above flashing. located immediately above flashing
- Brick Veneer Support Lintels shall be provided if brick veneer is included on elevation. Lintels shall be provided as listed in the following schedule and shall have a minimum bearing length of 6". Masonry Lintels shall be provided so that deflection is limited to L/600.

Masonry Opening Lintel Schedule

Openina Size Angle


up to 4'-	0"	3-1/2" x 3-1/2" x 5/16"
4'-1" to	5'-6"	4" x 3-1/2" x 5/16" LLV
5'-7" to	6'-6"	5" x 3-1/2" x 5/16" LLV
6'-7" to	8'-4"	6" x 3-1/2" x 5/16" LLV
8'-5" to	16'-4"	7" x 4" x 3/8" LLV

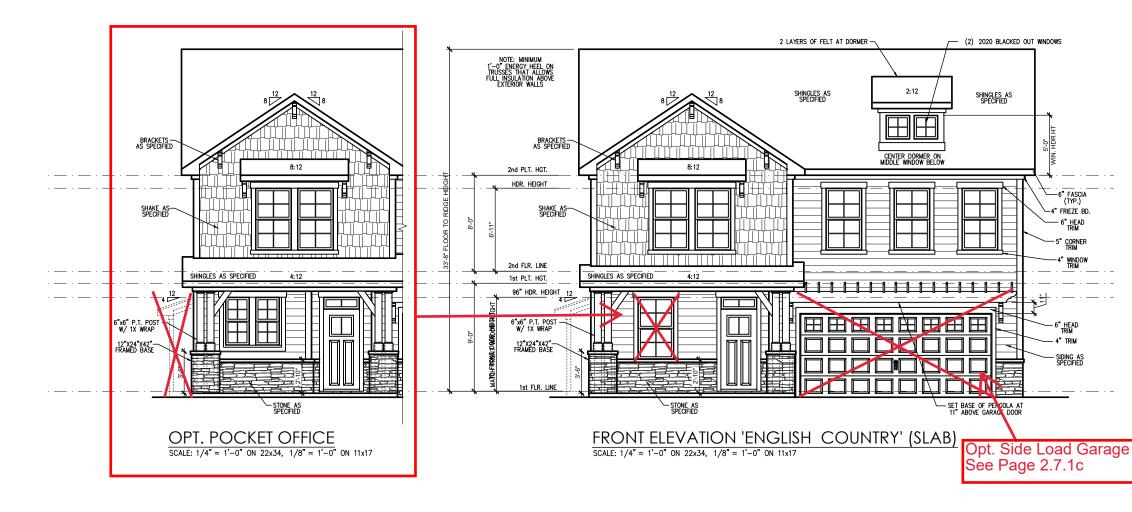

— 6" HEAD TRIM 5" CORNER

-4" WINDOW TRIM

4" TRIM

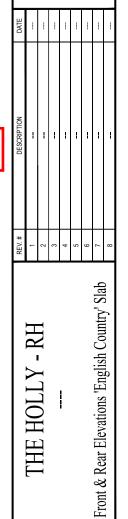


-RH THE HOLLY


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ISSUE DATE: 7/1/2021

CURRENT REVISION DATE: SCALE: 1/8" = 1'-0"

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			A	ATTIC '	VENT S	CHEDU	LE		
				EN	GLISH CO	UNTRY			
MAIN	HOUSE		SQ FTG	1393	AT	/ NEAR RID	AT / NE	AR EAVE	
VENT TYPE	SQ. REQL	. FT.	SQ. FT.	PERCENT OF TOTAL	POT LARGE (SQ. FT. EACH)	POT SMALL (SQ. FT. EACH)	RIDGE VENT (SQ. FT. PER LF)	EAVE VENT (SQ. IN. EACH)	CONT. VEN
	RAN		SUPPLIED	SUPPLIED	0.4236 0.2778 0.125		0.1944	0.0625	
RIDGE VENT 1.86 2.32 3.00 44.44			0	0	24.00				
SOFFIT VENTS	2.79	2.32	3.75	55.56				0	60.00
TOTAL (MIN)	4.64	4.64	6.75	100.00	POT VENTS MAY B	E REQUIRED IF THERI	E IS INSUFFICIENT RIE	GE AVAILABLE	

\* SCHEDULE HAS BEEN CALCULATED ASSUMING EAVE VENTILATION AT 50-60% OF TOTAL AND RIDGE AT 40-50% OF TOTAL REQUIRED VENTILATION
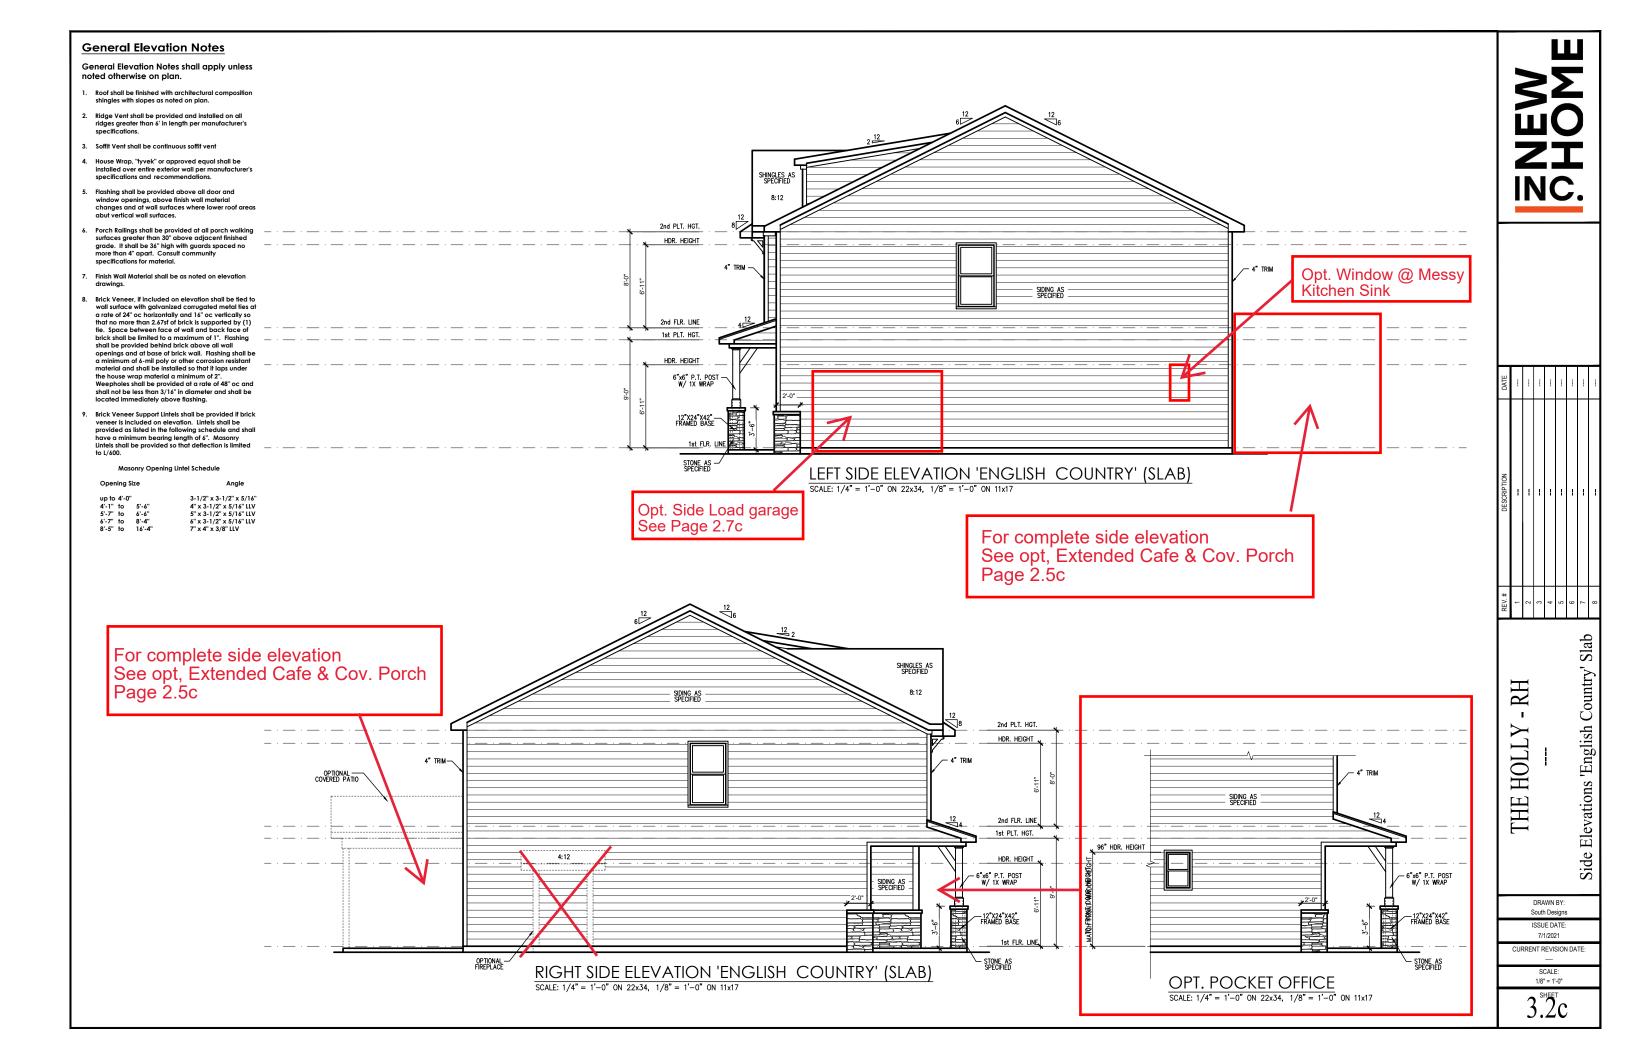
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THE HOLLY - RH --- Roof Plan 'English Country'

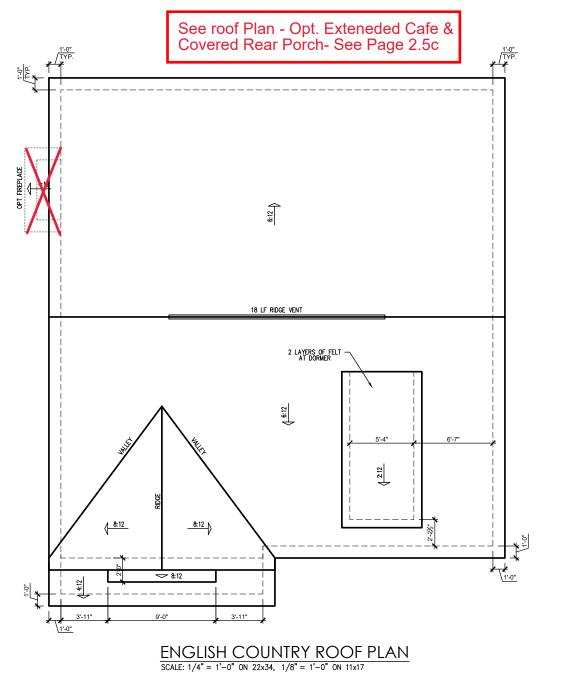DRAWN BY: South Designs

ISSUE DATE: 7/1/2021

SCALE: 1/8" = 1'-0"

3.3c

SOUTH DESIGNS

Southern Engineers, P.A. 3716 Benson Drive, Raleigh, NC 27609 Phone: (919) 878-1617 License: C-4772 www.southernengineers.com

PROJECT # 21-2816-RH

Engineers seal applies only to structural components on this document.

Seal does not include construction means, methods, techniques, sequences, procedures or safety precautions.

Any deviations or discrepancies on plans are to be brought to the immediate attention of Southern Engineers. Failure to do so will void Southern Engineers liability.

Seal is valid for projects permitted one year from date of seal.


Use of these plans constitutes approval of terms & conditions as defined in the customer agreement.

2 - The Holly - RH
NEW HOME, INC.


S-1.1

12" WIDE TURN-DOWN FTG. FOR COVERED PATIO – 24"x24"x10" CONC. FTG. – WITH OPT. COVERED PATIO OPT EXTENDED PATIO OPT COVERED PORCH Opt. Extended Cafe See Page S-1.1.1 Cov. Porch See Page S-7.1 14'-10" 5'-2" Opt. Extended Cafe ∠24"x24"x10" △ CONC. FTG. See Page S-1.1.1 IO4A SD IO" WIDE XIO" DEEP (TYP.) FTG. FOR OPT.
FIREPLACE 18" WIDE XIO" DEEP 10'-71/2" Opt. Side Load garage See Page S-1.1.2 9'-103' 5'-23" 4" CONC. SLAB (TABLE R402.2) WITH FIBERMESH OR WIREMESH ON 6 MIL VAPOR RETARDER (IOIA) SD I6" WIDE TURNDOWN FTG. (AS REQ'D) ON BASE COURSE (R506.2.2). SEE R506.2.1 FOR FILL REQUIREMENTS. Opt. Pocket Office & 30"x30"x10" CONC. FTG. 30"x30"x10" \_\_/ CONC. FTG. **Smart Door Delivery** See Page S-1.1.1 24"x24"xlo CONC. FTG – 36"x24"xIO" (MIN.)— CONC. FTG. SOLID FILLED MASONRY PEDEDSTAL ABOVE -42"x42"x12" CONC. FTG. REINFORCED WITH #5 BAR @ II" O.C. (MIN. OF (4) BARS) IN EACH DIRECTION 32"x32"x10" CONC. FTG. EXTEND PORCH SLAB — 4" FOR STONE VENEER 16'-10" SLAB FOUNDATION PLAN 'ENGLISH COUNTRY'

SCALE: 1/8"=1'-0" ON 11x17, 1/4"=1'-0" ON 22x34

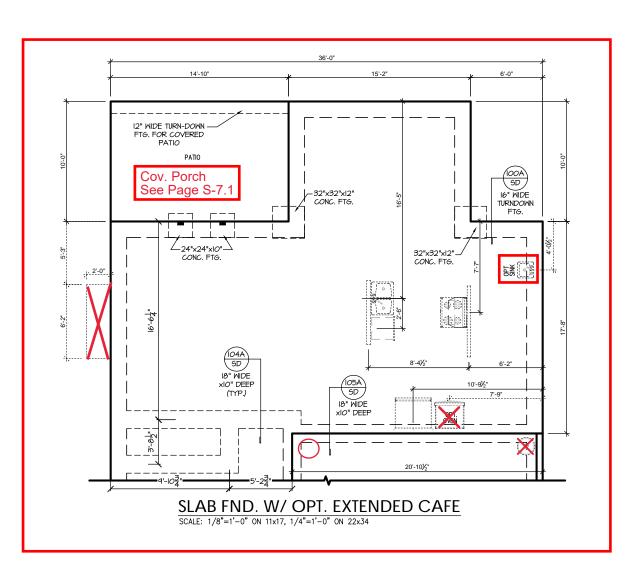



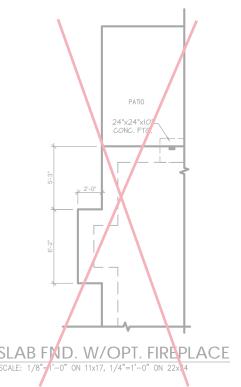


-30"x30"x10" CONC. FTG. **Reduce Offset** from 3'-6"t o 1'-10' 30"x30"x10" CONC. FTG. — 36"x24"xI0" (MIN.)— CONC. FTG. SOLID FILLED MASONRY PEDEDSTAL ABOVE - 42"x42"x12" CONC, FTG, REINFORCED WITH #5 BAR @ II" O.C. MIN, OF (4) BARS) IN EACH DIRECTION - 42"x42"x12" CONC. FTG. REINFORCED MITH #5 BAR @ II" O.C. (MIN. OF (4) BARG) IN EACH DIRECTION SLAB FND. W/OPT. SMART DOOR SCALE: 1/8"=1'-0" ON 11x17, 1/4"=1'-0" ON 22x34 SLAB FND. W/OPT. POCKET OFFICE SPALE: 1/8"=1'-0" ON 11x17, 1/4"=1'-0" ON 22x34 \*ONLY AVAILABLE W/ POCKET OFFICE OPTION

REFER TO "SD" SHEET(S) FOR STANDARD DETAILS, BRACING DETAILS AND STRUCTURAL NOTES. PROJECT # 21-2816-RH

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SOUTH DESIGNS

RH The Holly NEW HOME,  $\sim$ 

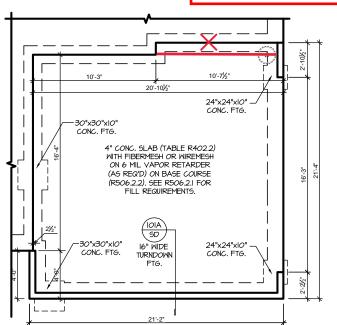

**ENGLISH COUNTRY** OPT. SIDE LOAD GARAGE **SLAB FOUNDATION PLAN** SCALE: 1/8"=1'-0" ON 11x17, 1/4"=1'-0" ON 22x34



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SOUTH DESIGNS

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2

REFER TO "SD" SHEET(S) FOR STANDARD DETAILS, BRACING DETAILS AND STRUCTURAL NOTES.

#### TRUSS SYSTEM REQUIREMENTS NC (2018 NCRC): Wind: 115-120 mph

- TRUSS SYSTEM LAYOUTS (PLACEMENT PLANS) SHALL BE DESIGNED IN ACCORDANCE WITH SEALED STRUCTURAL PLANS ANY NEED TO CHANGE TRUSSES SHALL BE COORDINATED WITH SOUTHERN
- TRUSS SCHEMATICS (PROFILES) SHALL BE PREPARED AND SEALED BY TRUSS MANUFACTURER.
- ALL TRUSSES SHALL BE DESIGNED FOR BEARING ON SPF #2 OR #3 PLATES OR LEDGERS (UNO).
- ALL REQUIRED ANCHORS FOR TRUSSES DUE TO UPLIFT OR BEARING SHALL MEET THE REQUIREMENTS AS SPECIFIED ON THE TRUSS

#### HEADER/BEAM & COLUMN NOTES

- ALL EXTERIOR AND LOAD BEARING HEADERS SHALL BE MIN. (2)2x6 (4" WALL) OR (3)2x6 (6" WALL) WITH (I) SUPPORT STUD, UNLESS NOTED
- 2. THE NUMBER SHOWN AT BEAM AND HEADER SUPPORTS INDICATES THE NUMBER OF SUPPORT STUDS REQUIRED IN STUD POCKET OR COLUMN HEADERS IN EXTERIOR WALLS SHALL BE ACCORDING TO ITEM "d" IN TABLE R602.3(5)
  OR AS BELOW PER NCDOI COMMENTARY "KING STUDS AT WALL OPENINGS" REVISED I-9-2020: UP TO 3' SPAN: (I) KING STUD
- OVER 3' UP TO 6' SPAN: (2) KING STUDS OVER 6' UP TO 9' SPAN: (3) KING STUDS
- OVER 9' UP TO 12' SPAN: (4) KING STUDS
- OVER 12' UP TO 15' SPAN: (5) KING STUDS

#### WOOD "I" JOISTS

- (SHALL BE ONE OF THE FOLLOWING):

   TJI 210 BY TRUS JOIST
- I PI 20 PI IS BY I P
- ALL WOOD "I"JOISTS SHALL BE INSTALLED ACCORDING TO MANUFACTURER'S SPECIFICATIONS.
- INSTALL SQUASH BLOCKS, WEB STIFFENERS ETC. AS REQUIRED BY AND ACCORDING TO THE I-JOIST MANUFACTURER'S SPECIFICATIONS AND INSTRUCTIONS
- HANGERS FOR I-JOISTS ARE THE RESPONSIBILITY OF THE I-JOIST SUPPLIER.
- FLOOR TRUSSES BY MANUFACTURER MAY BE

- PORCH POST NOTES:

  4X4 (6x6) TRT'D POST (OR EQUAL).
- ATTACH TRUSSES (RAFTERS) AT PORCH WITH HURRIGANE CONNECTORS.
- POST CAP: SIMPSON AC4-MAX (AC6-MAX) POST CAP AT CORNER: (2) SIMPSON LCE4 MITER HEADER AT CORNER). HIGH WIND; ADD (1)
- SIMPSON H6. POST BASE: SIMPSON ABU44 (ABU66).
- MONO: %" ANCHOR (EMBED 7")
  CMU: %" ANCHOR (EXTEND TO FOOTING -
- HIGH WIND ONLY) POST BASE: WOOD FOUNDATION: (2) SIMPSON
- CSI6 STRAPS AT POSTS. EXTEND 12" ONTO EACH POST (UPPER AND LOWER) OR TO GIRDER.
- NOTE: EQUIVALENT POST CAP AND BASE ACCEPTABLE.

#### FRAMING NOTES


NC (2018 NCRC): Wind: 115-120 mph

- BRACING METHOD AND TYPE: CONTINUOUSLY SHEATHED WSP. CS-WSP. NOTE THAT THE WALL BRACING AMOUNT PROVIDED ON THE PLANS (DETAILS AND SPECIFICATIONS) IS GREATER THAN THE AMOUNT OF WALL BRACING REQUIRED BY SECTION R602.10 OF THE CODE. SEE NOTES BELOW FOR DETAILS AND SPECIFICATIONS FOR WALL BRACING AND WALL FRAMING.
- 2. EXTERIOR WALL SHEATHING: WALLS SHALL BE BRACED BY SHEATHING WALLS ON ALL STORIES WITH WOOD STRUCTURAL PANEL SHEATHING (WSP) (EXPOSURE B: T/16", EXPOSURE C: 15/32"), SHEATHING SHALL BE ATTACHED WITH 8d NAILS AT A 6"/12" NAILING PATTERN (6" OC AT PANEL EDGES AND 12" OC AT INTERMEDIATE SUPPORTS). INSTALL BLOCKING AT ALL PANEL EDGES.
- 3. WSP SHEATHING SHALL EXTEND TO THE UPPERMOST DOUBLE BEARING PLATE. BLOCK AT ROOF PER SECTION R602.IO.4.5 AND ATTACH BRACED WALLS PER CODE WSP SHEATHING BETWEEN FLOORS SHALL BE SPLICED ALONG CONTINUOUS BAND OR THE MSP SHEATHING MAY BE SPLICED ACROSS STUDS (CONTINUOUS ACROSS FLOOR SYSTEM) WITH BLOCKING AT PANEL EDGES. (MINIMUM 12" BEYOND FLOOR BREAK) OR OTHER APPROVED METHOD.
- 4. "HD" = HOLDOWN: HOLD-DOWN DEVICE (NOTED AS "HD" ON PLANS)
  SHALL BE AN 800 POUND CAPACITY ASSEMBLY AS NOTED ON PLANS,
  SEE DETAILS FOR HD ASSEMBLY.
- \*\*GROUND/FIRST FLOOR: USE "HD HOLD-DOWN DETAIL" ON SD SHEET
- (OR EGUIV.)

  \*\*UPPER FLOORS: ATTACH BASE OF KING STUD WITH A SIMPSON CS22

  STRAP DOWN ACROSS THE BAND AND DOWN TO A STUD BELOW OR

  HEADER BELOW. EXTEND STRAP 7" MIN ALONG EACH STUD (OR HEADER) AND ATTACH EACH END W/ (7) 8d NAILS.
- 5. INTERIOR BRACED WALL: (NOTED AS "IBW" ON PLANS) ATTACH I/2" GYPSUM BOARD (GB) ON EACH SIDE OF WALL MITH A MIN. OF 5d COOLER NAILS OR #6 SCREMS @ 7" O.C. ALONG THE EDGES AND AT INTERMEDIATE SUPPORTS.
- 6. INTERIOR BRACED WALL-WOOD STRUCTURAL PANEL: (NOTED AS "IBM-MSP" ON PLANS). ATTACH ONE SIDE WITH 1/6" MSP SHEATHING WITH 8d NAILS AT A 6"/12" NAILING PATTERN (6" OC AT PANEL EDGES AND 12" OC AT INTERMEDIATE SUPPORTS). INSTALL BLOCKING AT ALL PANEL EDGES, ATTACH GB OVER WSP AS REQUIRED, ATTACH OPPOSITE SIDE WITH 1/2" GB WITH A MIN. OF 5d COOLER NAILS OR #6 SCREMS @ 7" OC ALONG THE EDGES AND AT INTERMEDIATE

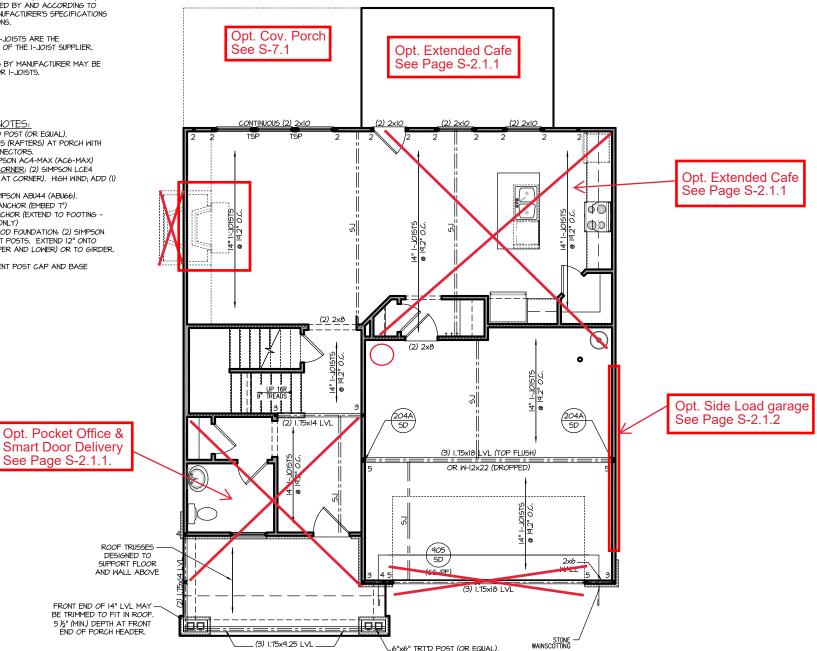



SCALE: 1/8"=1'-0" ON 11x17, 1/4"=1'-0" ON 22x34

PROJECT # 21-2816-RH


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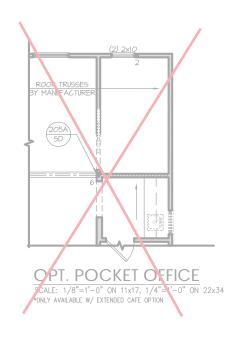
e to be brought to the . Failure to do so will one year from date of seal. oval of terms & conditions

**P.A.** 27609

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REFER TO "SD" SHEET(S) FOR STANDARD DETAILS BRACING DETAILS AND STRUCTURAL NOTES.





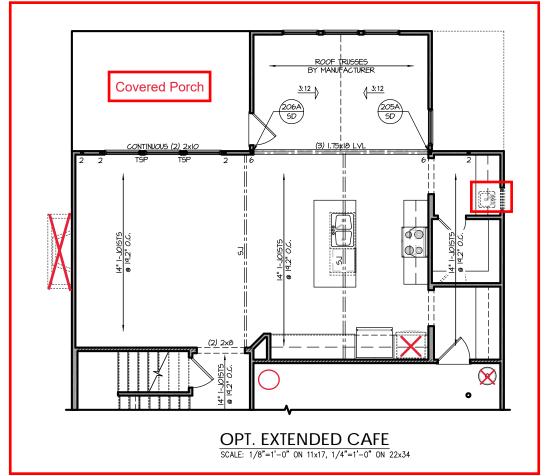



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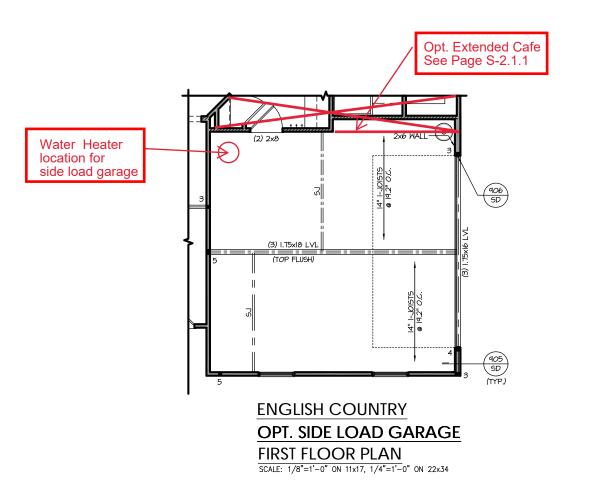
SOUTH DESIGNS

RH NEW HOME, INC.

The Holly  $\sim$ 

REFER TO "SD" SHEET(S) FOR STANDARD DETAILS, BRACING DETAILS AND STRUCTURAL NOTES.

ROOF TRUSSES -DESIGNED TO SUPPO PORTION OF FLOOP A "x6" TRT'D POST (OR EQUAL). SEE "PORCH POST NOTES" OPT. POCKET OFFICE



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PROJECT # 21-2816-RH

SOUTH DESIGNS

- RH The Holly NEW HOME, INC.

REFER TO "SD" SHEET(S) FOR STANDARD DETAILS, BRACING DETAILS AND STRUCTURAL NOTES.

#### TRUSS SYSTEM REQUIREMENTS NC (2018 NCRC): Wind: 115-120 mph

- TRUSS SYSTEM LAYOUTS (PLACEMENT PLANS) SHALL BE DESIGNED IN ACCORDANCE WITH SEALED STRUCTURAL PLANS ANY NEED TO CHANGE TRUSSES SHALL BE COORDINATED WITH SOUTHERN
- TRUSS SCHEMATICS (PROFILES) SHALL BE PREPARED AND SEALED BY TRUSS MANUFACTURER.
- ALL TRUSSES SHALL BE DESIGNED FOR BEARING ON SPF #2 OR #3 PLATES OR LEDGERS (UNO).
- ALL REQUIRED ANCHORS FOR TRUSSES DUE TO UPLIFT OR BEARING SHALL MEET THE REQUIREMENTS AS SPECIFIED ON THE TRUSS

#### HEADER/BEAM & COLUMN NOTES

- ALL EXTERIOR AND LOAD BEARING HEADERS SHALL BE MIN. (2)2x6 (4" WALL) OR (3)2x6 (6" WALL) WITH (I) SUPPORT STUD, UNLESS NOTED
- 2. THE NUMBER SHOWN AT BEAM AND HEADER SUPPORTS INDICATES THE NUMBER OF SUPPORT STUDS REQUIRED IN STUD POCKET OR COLUMN. THE NUMBER OF KING STUDS AT EACH END OF HEADERS IN EXTERIOR WALLS SHALL BE ACCORDING TO ITEM "d" IN TABLE R602.3(5)
  OR AS BELOW PER NCDOI COMMENTARY "KING STUDS AT WALL OPENINGS" REVISED I-9-2020: UP TO 3' SPAN: (I) KING STUD
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#### FRAMING NOTES

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Opt. Bedroom #4

See Page S-2.2.

ILO of Loft


- 3. WSP SHEATHING SHALL EXTEND TO THE UPPERMOST DOUBLE BEARING PLATE. BLOCK AT ROOF PER SECTION R602.IO.4.5 AND ATTACH BRACED WALLS PER CODE, WSP SHEATHING BETWEEN FLOORS SHALL BE SPLICED ALONG CONTINUOUS BAND OR THE MSP SHEATHING MAY BE SPLICED ACROSS STUDS (CONTINUOUS ACROSS FLOOR SYSTEM) WITH BLOCKING AT PANEL EDGES. (MINIMUM 12" BEYOND FLOOR BREAK) OR OTHER APPROVED METHOD.
- 4. "HD" = HOLDOWN: HOLD-DOWN DEVICE (NOTED AS "HD" ON PLANS)
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  SEE DETAILS FOR HD ASSEMBLY.
- \*\*GROUND/FIRST FLOOR: USE "HD HOLD-DOWN DETAIL" ON SD SHEET
- (OR EGUIV.)

  \*\*UPPER FLOORS: ATTACH BASE OF KING STUD WITH A SIMPSON CS22

  STRAP DOWN ACROSS THE BAND AND DOWN TO A STUD BELOW OR

  HEADER BELOW. EXTEND STRAP 7" MIN ALONG EACH STUD (OR HEADER) AND ATTACH EACH END W/ (7) 8d NAILS.
- 5. INTERIOR BRACED WALL: (NOTED AS "IBW" ON PLANS) ATTACH I/2" GYPSUM BOARD (GB) ON EACH SIDE OF WALL WITH A MIN. OF 5d COOLER NAILS OR #6 SCREWS @ 7" O.C. ALONG THE EDGES AND AT INTERMEDIATE SUPPORTS.
- 6. INTERIOR BRACED WALL-WOOD STRUCTURAL PANEL: (NOTED AS "IBM-MSP" ON PLANS). ATTACH ONE SIDE WITH 1/6" MSP SHEATHING WITH 8d NAILS AT A 6"/12" NAILING PATTERN (6" OC AT PANEL EDGES AND 12" OC AT INTERMEDIATE SUPPORTS). INSTALL BLOCKING AT ALL PANEL EDGES, ATTACH GB OVER WSP AS REQUIRED, ATTACH OPPOSITE SIDE WITH 1/2" GB WITH A MIN. OF 5d COOLER NAILS OR #6 SCREMS @ 7" OC ALONG THE EDGES AND AT INTERMEDIATE



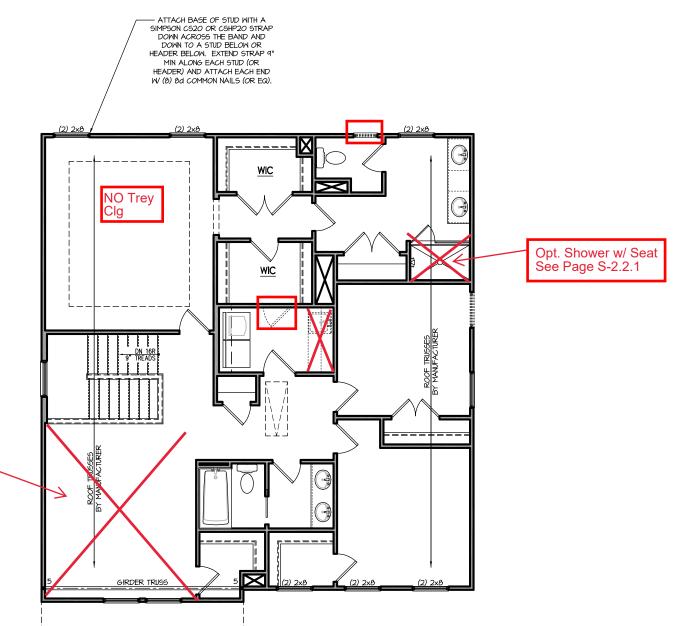

SECOND FLOOR PLAN 'ENGLISH COUNTRY' SCALE: 1/8"=1'-0" ON 11x17, 1/4"=1'-0" ON 22x34

> REFER TO "SD" SHEET(S) FOR STANDARD DETAILS BRACING DETAILS AND STRUCTURAL NOTES.

PROJECT # 21-2816-RH


e to be brought to the . Failure to do so will

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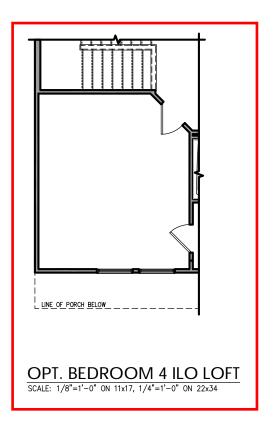






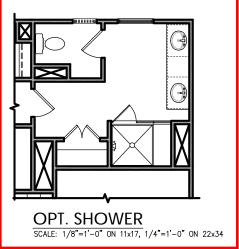

NO STRUCTURAL CHANGES FROM BASE PLAN



document.

C 27609

Any deviations or discrepancies immediate attention of Southern Void Southern Engineer's liability.

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SOUTH DESIGNS

2 - The Holly - RH
NEW HOME, INC.

Plan 2 - T

SHEET(S) FOR STALLS, BRACING

#### TRUSS SYSTEM REQUIREMENTS NC (2018 NCRC): Wind: 115-120 mph

- TRUSS SYSTEM LAYOUTS (PLACEMENT PLANS) SHALL BE DESIGNED IN ACCORDANCE WITH SEALED STRUCTURAL PLANS. ANY NEED TO CHANGE TRUSSES SHALL BE COORDINATED WITH SOUTHERN
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- ALL TRUSSES SHALL BE DESIGNED FOR BEARING ON SPF #2 OR #3 PLATES OR LEDGERS (UNO).
- ALL REQUIRED ANCHORS FOR TRUSSES DUE TO UPLIFT OR BEARING SHALL MEET THE REQUIREMENTS AS SPECIFIED ON THE TRUSS SCHEMATICS.

			A	ATTIC '	VENT S	CHEDU	LE			
				EN	GLISH CO	UNTRY				
MAIN HOUSE SQ FTG 1393					AT	/ NEAR RID	GE	AT / NEAR EAVE		
VENT TYPE	SQ. REQL		SQ. FT.	PERCENT OF TOTAL	POT LARGE (SQ. FT. EACH)	POT SMALL (SQ. FT. EACH)	RIDGE VENT (SQ. FT. PER LF)	EAVE VENT (SQ. IN. EACH)	CONT. VENT (SQ. IN. PER LF)	
VE.W. 111. E	RAN		SUPPLIED	SUPPLIED	SUPPLIED	0.4236	0.2778	0.125	0.1944	0.0625
RIDGE VENT	1.86	2.32	3.00	44.44	0	0	24.00			
SOFFIT VENTS	2.79	2.32	3.75	55.56	0 60.00					
TOTAL (MIN)	4.64	4.64	6.75	100.00	POT VENTS MAY B	E REQUIRED IF THEF	RE IS INSUFFICIENT RIE	OGE AVAILABLE		

\* SCHEDULE HAS BEEN CALCULATED ASSUMING EAVE VENTILATION AT 50-60% OF TOTAL AND RIDGE AT 40-50% OF TOTAL REQUIRED VENTILATION



Opt. Extended Cafe, Opt Covered Porch See Page S-7.1 ROOF TRUSSES 3Y MANUFACTURER 18 LF RIDGE VENT 2 LAYERS OF FELT -AT DORMER 8:12 FALSE DORMER — DESIGN TRUSSES TO SUPPORT AND ANCHOR DORMER 1'-0" ROOF TRUSSES —/
BY MANUFACTURER

> **ENGLISH COUNTRY ROOF PLAN** SCALE: 1/4" = 1'-0" ON 22x34, 1/8" = 1'-0" ON 11x17


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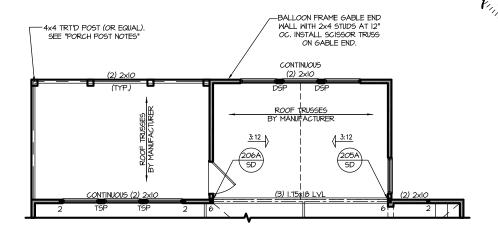
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SOUTH DESIGNS


RH The Holly NEW HOME,  $\sim$ 

REFER TO "SD" SHEET(S) FOR STANDARD DETAILS, BRACING DETAILS AND STRUCTURAL NOTES.



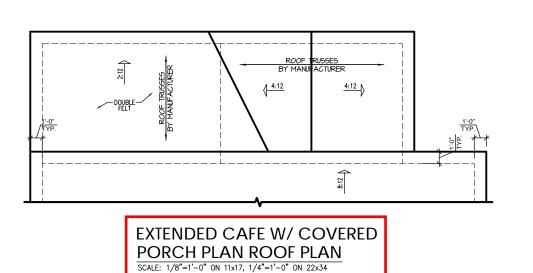

EXTENDED CAFE W/ **COVERED PORCH PLAN** SCALE: 1/8"=1'-0" ON 11x17, 1/4"=1'-0" ON 22x34

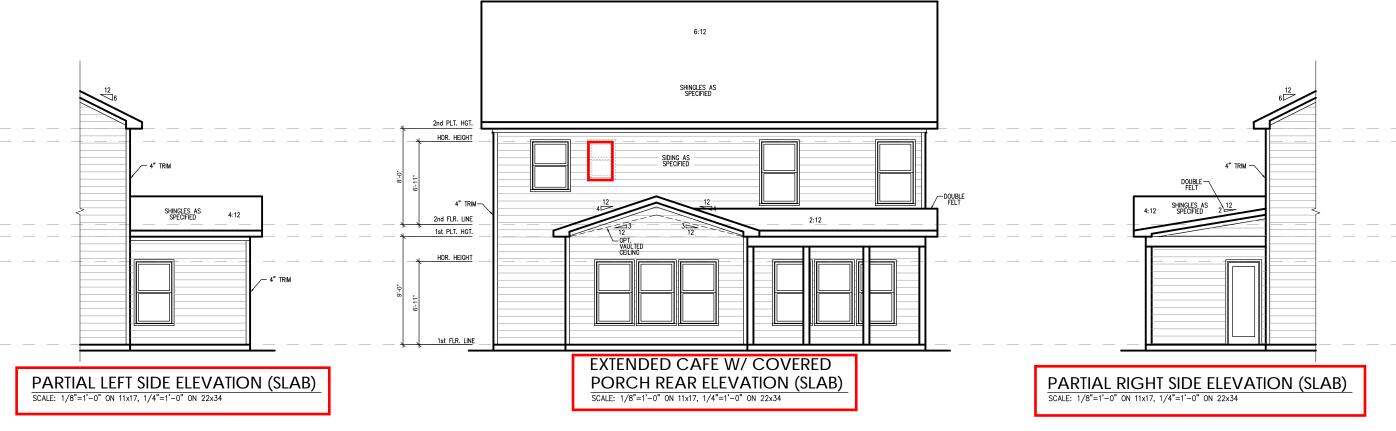

REFER TO "SD" SHEET(S) FOR STANDARD DETAILS, BRACING DETAILS AND STRUCTURAL NOTES.


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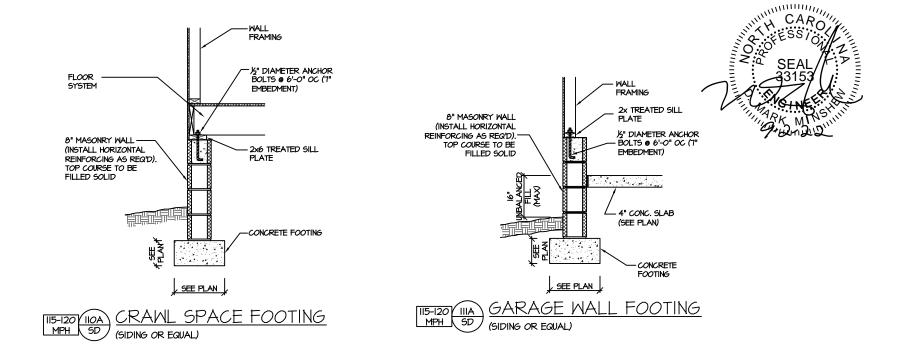
P.A. 27609


Southern Engineers, P 3716 Benson Drive, Raleigh, NC 27 Phone: (919) 878-1617


SOUTH DESIGNS

RH The Holly NEW HOME,



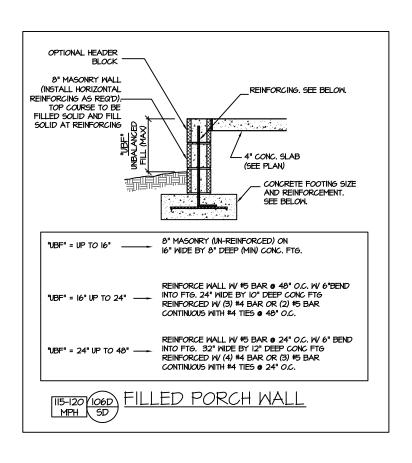

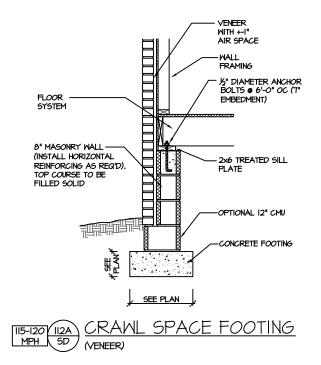

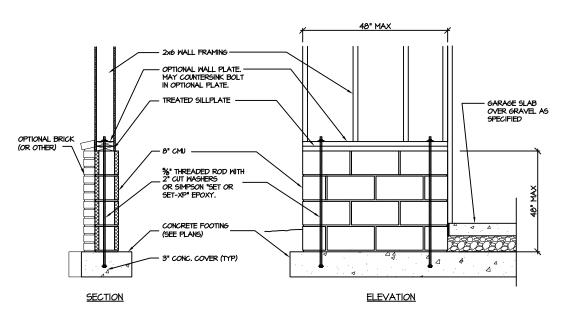

GARAGE 'WING WALL' REINFORCING
PER IRC FIGURE R602.10.4.3

CRAWL SPACE FOUNDATION

PROJECT # 21-2816

e to be brought to the .: Failure to do so will from date of seal.

tot include construction means, methods, techniqu procedures or safety precautions. ions or discrepancies on plans are to be brought to attention of Southern Engineers. Failure to do so

sequences, procedures or safety precautions.

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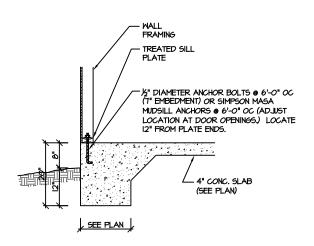
Seal is valid for projects permitted one year if I see the deventive one year if I see the deventive and some processing the property provides provided to the page of these plans constitutes around of the page.

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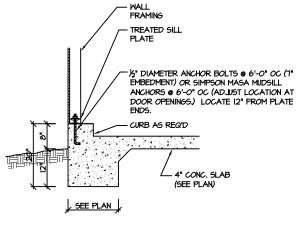
SOUTH DESIGNS

PLAN 2 - THE HOLLY
NEW HOME, INC.


SD











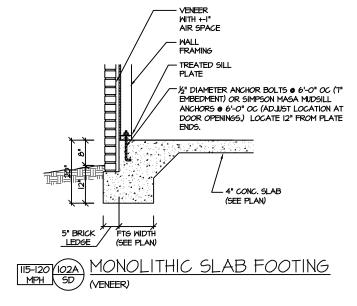

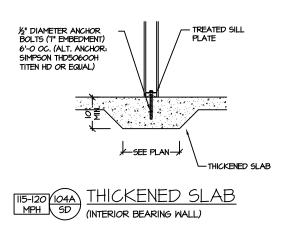

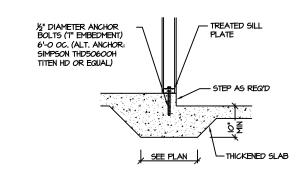

THICKENED SLAB @ GARAGE (INTERIOR GARAGE WALL)

PROJECT # 21-2816


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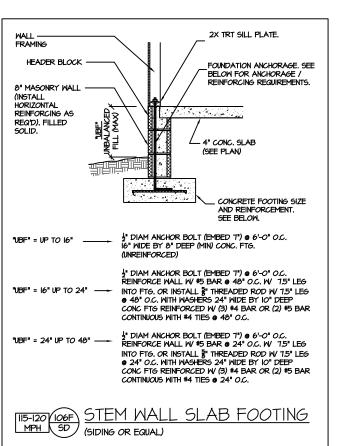
SOUTH DESIGNS


THE HOLLY NEW HOME, INC.  $\sim$ **PLAN** 

SD


SLAB FOUNDATION




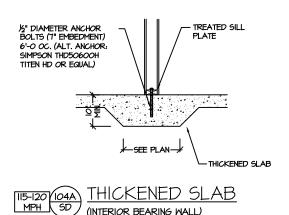


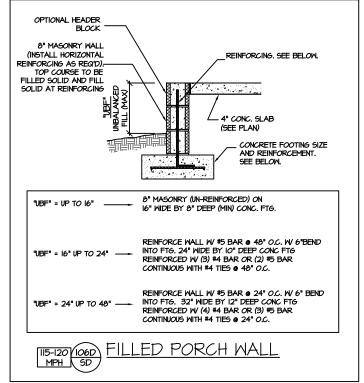




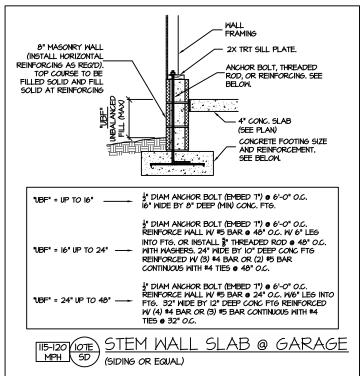

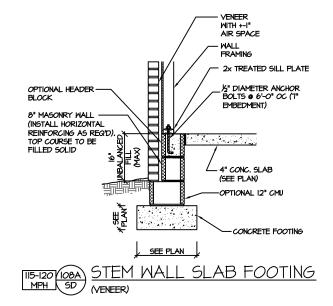

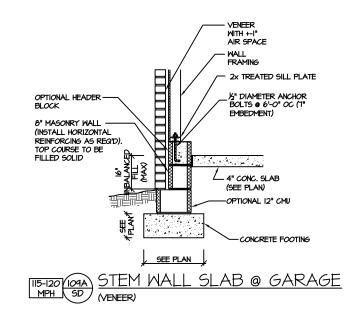

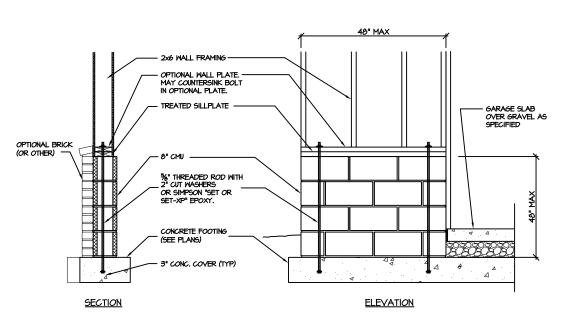

GARAGE 'WING WALL' REINFORCING PER IRC FIGURE R602.IO.4.3

STEM WALL SLAB FOUNDATION

PROJECT # 21-2816

P.A. 27609 Southern Engineers, P 3716 Benson Drive, Raleigh, NC 2' Phone: (919) 878-1617 License: C-4772


www.southernengineers.com

SOUTH DESIGNS


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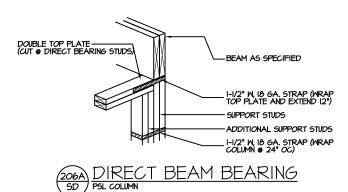
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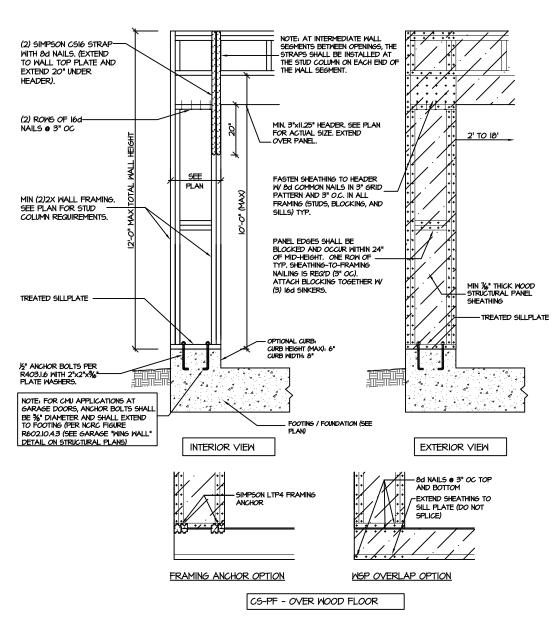
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## (204A)TYP. GARAGE BEAM BEARING





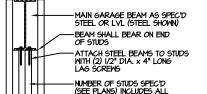

CS-PF: CONTINUOUS PORTAL FRAME CONSTRUCTION DETAIL AND APPLICATION BASED ON NORC FIGURE R602.IO.I - PORTAL FRAME CONSTRUCTION
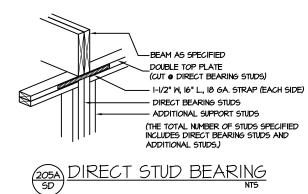
#### STRUCTURAL NOTES NC (2018 NCRC): Wind: 115-120 mph

- ENGINEER'S SEAL APPLIES ONLY TO STRUCTURAL COMPONENTS INCLUDING ROOF RAFTERS, HIPS, VALLEY'S, RIDGES, FLOORS, WALLS, BEAMS AND HEADERS, COLUMMS, CANTILEVERS, OFFSET LOAD BEARING WALLS, PIER & GIRDER SYSTEM, FOOTING, AND PILING SYSTEM. ENGINEER'S SEAL DOES NOT CERTIFY DIMENSIONAL ACCURACY OR ARCHITECTURAL LATOUT INCLUDING ROOF SYSTEM, ALL REQUIREMENTS FOR PROFESSIONAL CERTIFICATION SHALL BE PROVIDED BY THE APPROPRIATE PROFESSIONAL. SOUTHERN ENGINEERS, P.A. CERTIFIES ONLY THE STRUCTURAL COMPONENTS AS SPECIFICALLY STATED.
- ALL CONSTRUCTION SHALL CONFORM TO THE LATEST REQUIREMENTS OF THE 2018 NC RESIDENTIAL CODE, PLUS ALL LOCAL CODES AND REGULATIONS. THE STRUCTURAL ENGINEER IS NOT RESPONSIBLE FOR, AND WILL NOT HAVE CONTROL OF, CONSTRUCTION MEANS, METHODS, TECHNIQUES, SEQUENCES OR PROCEDURES, OR FOR SAFETY PRECAUTIONS AND PROGRAMS IN CONNECTION WITH THE CONSTRUCTION MORK, NOR WILL THE ENGINEER BE RESPONSIBLE FOR THE CONTRACTOR'S FAILURE TO CARRY OUT THE CONSTRUCTION WORK IN ACCORDANCE WITH THE CONTRACT DOCUMENTS. "CONSTRUCTION REVIEW" SERVICES ARE NOT PART OF OUR CONTRACT.
  ALL MEMBERS SHALL BE FRAMED ANCHORED, TIED AND BRACED IN ACCORDANCE WITH GOOD CONSTRUCTION PRACTICE AND THE BUILDING CODE.
- DESIGN LOADS (LISTED AS: LIVE LOAD, DEAD LOAD, DEFLECTION) ROOMS OTHER THAN SLEEPING ROOMS: (40 PSF, IO PSF, L/360)
- SLEEPING ROOMS: (30 PSF, IO PSF, L/360)
- ATTIC WITH PERMANENT STAIR: (40 PSF, IO PSF, L/360)
- ATTIC WITHOUT PERMANENT STAIR: (20 PSF, IO PSF, L/360) ATTIC WITHOUT STORAGE: (IO PSF, IO PSF, L/240)
- STAIRS: (40 PSF, IO PSF, L/360)
- EXTERIOR BALCONIES: (60 PSF, 10 PSF, L/360) DECKS: (40 PSF, 10 PSF, L/360)
- GUARDRAILS AND HANDRAILS: (200 LBS) PASSSENGER VEHICLE GARAGES: (50 PSF, IO PSF, L/360)
- FIRE ESCAPES: (40 PSF, IO PSF, L/360)
- 4. WALLS SHALL BE BRACED BY SHEATHING WALLS ON ALL STORIES WITH WOOD STRUCTURAL PANELS. SEE FRAMING NOTES FOR THICKNESS AND NAILING REQUIREMENTS.
- 5. SEE APPENDIX M (DCA6) FOR EXTERIOR DECK REQUIREMENTS INCLUDING ATTACHMENTS FOR LATERAL LOADS.
- 6. CONCRETE SHALL HAVE A MINIMUM 28 DAY STRENGTH OF 3000 PSI AND A MAXIMUM SLUMP OF 5 INCHES UNLESS NOTED OTHERWISE (UNO). AIR ENTRAINED PER TABLE 402.2. ALL CONCRETE SHALL BE PROPORTIONED MIXED HANDLED SAMPLED TESTED AND PLACED IN ACCORDANCE WITH ACI STANDARDS. ALL SAMPLES FOR PUMPING SHALL BE TAKEN FROM THE EXIT END OF THE PUMP, CONTROL JOINTS IN SLABS SHALL BE SPACED ON A GRID OF +30 TIMES THE DEPTH (D). CONTROL JOINTS SHALL BE SAWCUT TO A DEPTH OF 1/D, (I.E. 4" CONCRETE SLABS SHALL HAVE 1/4" DEEP CONTROL JOINTS SAWOUT IN SLAB ON A +-10'-0" x +-10'-0" GRID).
- ALLOWABLE SOIL BEARING PRESSURE ASSUMED TO BE 2000 PSF. THE CONTRACTOR MUST CONTACT A GEOTECHNICAL ENGINEER AND THE STRUCTURAL ENGINEER IF UNGATISFACTORY SUBSURFACE CONDITIONS ARE ENCOUNTERED. THE SURFACE AREA ADJACENT TO THE FOUNDATION WALL SHALL BE PROVIDED WITH ADEQUATE DRAINAGE, AND SHALL BE GRADED SO AS TO DRAIN SURFACE WATER AWAY FROM FOUNDATION WALLS.
- 8. ALL FRAMING LUMBER SHALL BE SPF #2 (Fb = 875 PSI) UNLESS NOTED OTHERWISE (UNO). ALL TREATED LUMBER SHALL BE SYP # 2. PLATE MATERIAL MAY BE SPF # 3 OR SYP #3 (Fc(perp) =
- 9. L.V.L. SHALL BE LAMINATED VENEER LUMBER: Fb=2600 PSI, Fv=285 PSI, E=I.9xi0 PSI. P.S.L. SHALL BE PARALLEL STRAND LUMBER: Fb=2400 PSI, Fv=240 PSI, E=2.0xl0 PSI. L.S.L. SHALL BE LAMINATED STRAND LUMBER: Fb=2250 PSI, Fv=400 PSI, E=1.55xl0 PSI. INSTALL ALL CONNECTIONS PER MANUFACTURERS INSTRUCTIONS.
- IO. ALL ROOF TRUSS AND I-JOIST LAYOUTS SHALL BE PREPARED IN ACCORDANCE WITH THE SEALED STRUCTURAL DRAWINGS, TRUSSES AND I-JOISTS SHALL BE INSTALLED ACCORDING TO THE MANUFACTURE'S SPECIFICATIONS, ANY CHANGE IN TRUSS OR I-JOIST LAYOUT SHALL BE
- ALL STRUCTURAL STEEL SHALL BE ASTM A-36. STEEL BEAMS SHALL BE SUPPORTED AT EACH END WITH A MINIMUM BEARING LENGTH OF 3 1/2" INCHES AND FULL FLANGE WIDTH, PROVIDE SOLID BEARING FROM BEAM SUPPORT TO FOUNDATION. BEAMS SHALL BE ATTACHED TO EACH SUPPORT WITH TWO LAG SCREWS (I/2" DIAMETER x 4" LONG). LATERAL SUPPORT IS CONSIDERED ADEQUATE PROVIDING THE JOIST ARE TOE NAILED TO THE SOLE PLATE, AND SOLE PLATE IS NAILED OR BOLTED TO THE BEAM FLANGE @ 48" O.C. ALL STEEL TUBING SHALL BE ASTM A500.
- 12. REBAR SHALL BE DEFORMED STEEL, ASTM615, GRADE 60. LAP ALL REBAR SPLICES 30 BAR DIAMETERS.
- 13. FLITCH BEAMS SHALL BE BOLTED TOGETHER USING (2) ROWS OF I/2" DIAMETER BOLTS (ASTM A325) WITH WASHERS PLACED UNDER THE THREADED END OF BOLT, BOLTS SHALL BE SPACED AT 24" O.C. (MAX), AND STAGGERED AT THE TOP AND BOTTOM OF BEAM (2" EDGE DISTANCE), WITH 2 BOLTS LOCATED AT 6" FROM EACH END.
- I4. BRICK LINTELS (WHEN REQUIRED) SHALL BE 3 I/2"x3 I/2"x1/4" STEEL ANGLE FOR UP TO 6'-0" SPAN AND 6"x4"x5/16" STEEL ANGLE WITH 6" LEG VERTICAL FOR SPANS UP TO 9'-0". SEE PLANS FOR SPANS OVER 4'-0". SEE ALSO SECTION R703.8.3 LINTELS.

PROJECT # 21-2816

P.A. 27609

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