BUILDER SHALL VERIFY ALL DIMENSIONS AND CONDITIONS AT TIME OF CONSTRUCTION.


ALL CONSTRUCTION SHALL CONFORM TO THE 2018 EDITION OF THE NC STATE BUILDING CODE.

CODES GOVERN OVER DRAWINGS.

FRAMING.

DIMENSIONS GOVERN OVER SCALE. VERIFY ALL MECHANICAL REQUIREMENTS BEFORE

YUNCANNON DESIGNS DOES NOT ASSUME LIABILITY FOR ANY DEVIATION OF OR CONSTRUCTION METHODS OF THESE PLANS.

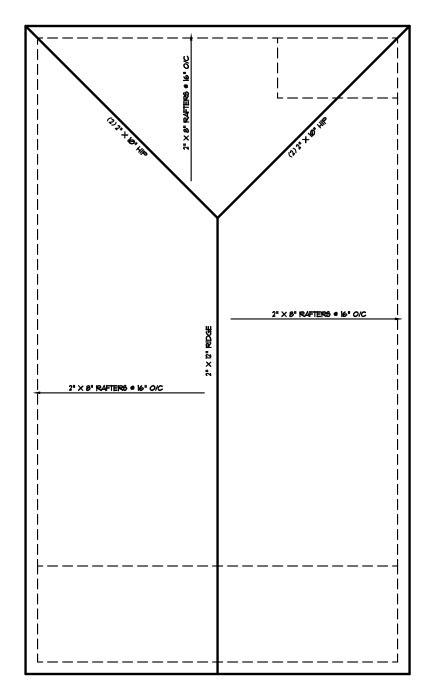

ROOF PLAN "B"

SCALE: 1/8" = 1'-∅"

ATTIC SPACE VENTILATION

MAIN ROOF ATTIC AREA = 1560 SQ. FT. REQUIRED AREA = A/300 = 5.2 SQ. FT.

ALL EAVES TO HAVE 2" CONTINUOUS SOFFIT VENT ALLOW I" AIR SPACE ABOVE INSULATION FOR AIR FLOW


GENERAL ROOF NOTES:

- I. THIS PLAN DESIGNED IN ACCORDANCE WITH NC RESIDENTIAL CODE, 2018 EDITION.
- 2. ROOF CLADDING DESIGN VALUES (POSITIVE/NEGATIVE) SHALL BE AS FOLLOWS:
 - 45.5 */SF FOR ROOF PITCHES FROM Ø /12 TO 2.25 /12
 - 34.5 */SF FOR ROOF PITCHES FROM 2.25 /12 TO 7 /12 21 */SF FOR ROOF PITCHES FROM 7 /12 TO 12 /12
- 3. ALL ROOFING ELEMENTS SHALL MEET THE REQUIREMENTS OF CHAPTER 8 OF THE CODE.
- 4. ALL LUMBER SHALL BE *2 SPF OR BETTER. RAFTERS MAY BE FINGER JOINTED PER NATIONAL DESIGN SPECIFICATIONS FOR WOOD CONSTRUCTION, AND MUST HAVE THE STRUCTURAL CERTIFICATION STAMPED ON THE MEMBER.
- 5. RAFTER SIZES, SPANS AND SPACING SHALL NOT EXCEED THE FOLLOWING:

2×6 2×8 2×1Ø SPACING 12" O.C. 14'-9" 19'-6" 24'-10"

SPACING 16" O.C. 13'-5" 17'-9" 22'-3"

- 6. ALL RAFTERS TO BE 2X8 @ 16" O.C. *2 SPF UNLESS NOTED OTHERWISE.
- 7. 2-2XIØ HIPS MAY BE SPLICED WITH A MIN. 6'-Ø" OVERLAP.
- 8. PROVIDE DOUBLE RAFTER EACH SIDE OF DORMERS WITH DOUBLE HEADER.
- 9. ATTACH VAULTED RAFTERS WITH HURRICANE CLIP SIMPSON "H-5" OR EQUIVALENT. PROVIDE DOUBLE OPPOSING RAFTERS WHERE NOTED.
- 10.2X8 RAFTERS @ CATHEDRAL OR VAULTED CEILINGS TO BE FURRED DOWN 2" OR USE 2XIØ RAFTERS FOR INSULATION PER CODE.
- 11. PROVIDE 2X4 COLLAR TIES EVERY SECOND RAFTER (TYPICAL)
- 12. PROVIDE 2X4 RAFTER TIES @ 32" O.C. (TYPICAL)
- 13. FRAME RAFTERS ON 2X4 PLATE ON TOP OF CEILING JOISTS UNLESS NOTED OTHERWISE.
- 14. SHINGLES ASSUMED TO BE 240 LB. FIBERGLASS, OR EQUAL. MINIMUM ROOF PITCH TO BE AS INDICATED ON ARCHITECTURAL PLAN SHEETS.
- 15. PROVIDE DOUBLE LAYER OF ROOF FELT WHERE ROOF PITCH 16 LESS THAN 4 /12.
- 16. THESE DESIGN DRAWINGS WERE PRODUCED BY HOWERTON SERVICES, PLLC ASSUMES
- NO LIABILITY FOR THE CORRECTNESS OF ARCHITECTURAL FEATURES, DIMENSIONS OR FIXTURES.
- 17. ALL HIP RIDGES AND VALLEYS SHALL BE DOUBLE 2XIØ UNLESS NOTED OTHERWISE.
- 18. CONTRACTOR IS RESPONSIBLE FOR REVIEWING DRAWINGS FOR CONSTRUCTABILITY PRIOR TO BEGINNING CONSTRUCTION.
- 19. VALLEY RAFTERS WITH SPANS LONGER THAN 15' SHALL BE LYLS SUPPORTED AS NOTED. PROVIDE TEMPORARY STIFF KNEE SUPPORT UNTIL ALL SHEATHING AND RAFTER TIES/COLLARS ARE INSTALLED.
- 20. DO NOT SCALE THESE DRAWINGS. IF DESCREPANCIES ARE NOTED, CONTACT THE DESIGNER.

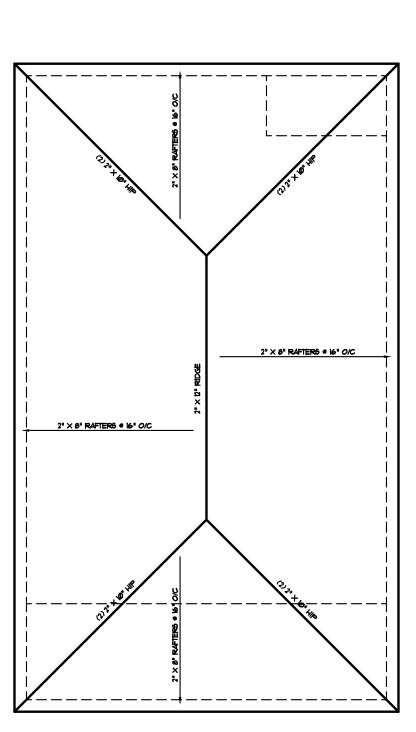


ROOF PLAN "A"

SCALE: 1/8" = 1'-0"

CORNER

NUMBER OF VENTS REQUIRED

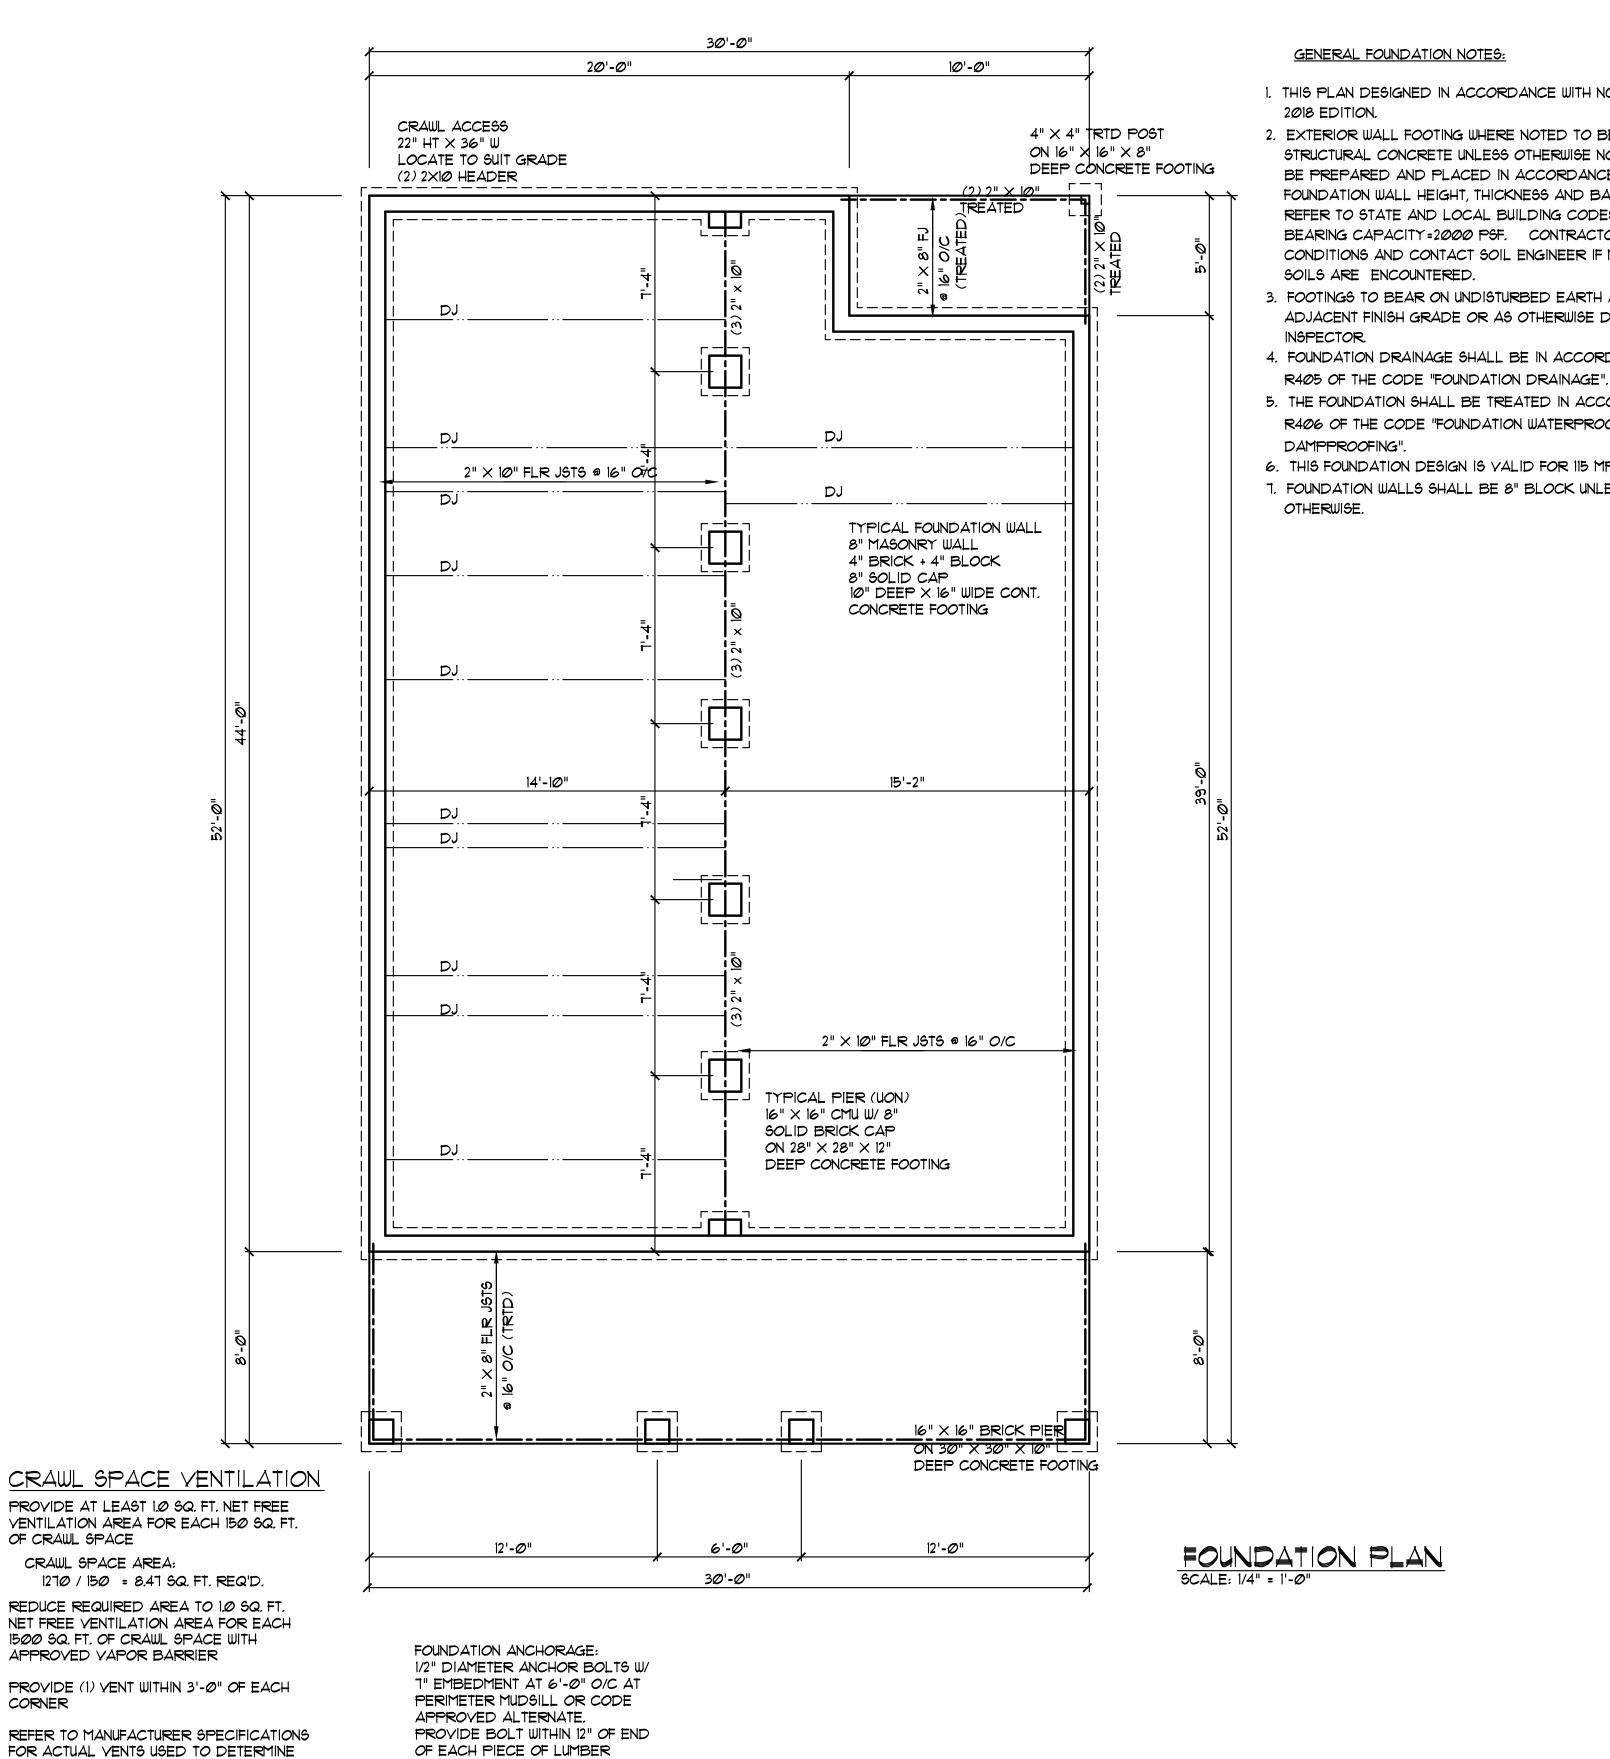

- 1. THIS PLAN DESIGNED IN ACCORDANCE WITH NC RESIDENTIAL CODE,
- 2. EXTERIOR WALL FOOTING WHERE NOTED TO BE 16" X 10" 3000 PSI STRUCTURAL CONCRETE UNLESS OTHERWISE NOTED. CONCRETE TO BE PREPARED AND PLACED IN ACCORDANCE WITH ACI 318. FOR FOUNDATION WALL HEIGHT, THICKNESS AND BACKFILL REQUIREMENTS, REFER TO STATE AND LOCAL BUILDING CODES. NOTE: ASSUMED SOIL BEARING CAPACITY = 2000 PSF. CONTRACTOR MUST VERIFY CONDITIONS AND CONTACT SOIL ENGINEER IF MARGINAL OR UNSTABLE
- 3. FOOTINGS TO BEAR ON UNDISTURBED EARTH A MIN. OF 12" BELOW ADJACENT FINISH GRADE OR AS OTHERWISE DIRECTED BY LOCAL
- 4. FOUNDATION DRAINAGE SHALL BE IN ACCORDANCE WITH SECTION
- 5. THE FOUNDATION SHALL BE TREATED IN ACCORDANCE W/SECTION R406 OF THE CODE "FOUNDATION WATERPROOFING AND
- 6. THIS FOUNDATION DESIGN IS VALID FOR 115 MPH WIND ZONES ONLY.
- 1. FOUNDATION WALLS SHALL BE 8" BLOCK UNLESS NOTED

9

DRAWN BY : WRV CHK'D BY : WRY DATE: 11/2*0*/23 REVISIONS :

Plan No. 1270-10