REVISION LOG

REVISION:001

DATE: 7/22/2022

- ADD STEM WALL SLAB FOUNDATION SHEETS.
 ADD "STEM WALL" TO CRAWL ELEVATION TITLES AND ADD NOTE "SEE FOUNDATION PAGES FOR FOUNDATION TYPE". UPDATE SHEET TITLES
- 3. ADD ELECTRICAL PLANS

- DATE: 9/14/2022
- ADD OPT OWNER'S SUITE W/ LARGER WALK-IN CLOSET. UPDATE ELEVATIONS, FLOOR PLANS AND FOUNDATION SHEETS.
 ADD 2ND ACCESS TO STORAGE @ GAMEROOM.
 ADD OPTIONAL 2440 WINDOW IN OWNER'S BATH @ OPT OWNER'S SUITE W/ SITTING

REVISION:3

DATE: 8/16/2023

1. CHANGED NAME OF FLEX ROOM TO POCKET OFFICE

Lot 34 Woodbridge South

87 Willow Creek Place Fuguay Varina, NC 27526

NC.



DESIGN CRITERIA:

THIS PLAN IS TO BE BUILT IN CONFORMANCE WITH THE 2018 NORTH CAROLINA STATE BUILDING CODE; RESIDENTIAL CODE

DIMENSIONS SHALL GOVERN OVER SCALE, AND CODE SHALL GOVERN OVER DIMENSIONS.

PLAN 1 The Clayton - LH

'LOW COUNTRY' ELEVATION

heet No.	Sheet Description
0.0	Cover Sheet
1.1	Foundation (Slab)
1.1.1	Foundation Options (Slab)
1.2	Foundation (Crawl)
1.2.1	Foundation Options (Crawl)
1.3	Foundation (Stem Wall Slab)
1.3.1	Foundation Options (Stem Wall Slab)
2.1	First Floor Plan
2.1.1	First Floor Plan Options
2.1.2	First Floor Plan Options
2.2	Optional Second Floor Plan
2.2.1	Second Floor Plan Options
2.4	Covered Porch Plans & Elevations (Slab)
2.4.1	Covered Porch Plans & Elevations (Crawl/ Stem Wall)
2.5	Extended Covered Porch Plans & Elevations (Slab)
2.5.1	Extended Covered Porch Plans & Elevations (Crawl/ Stem Wall)
3.1	Front & Rear Elevations (Slab)
3.1.1	Front & Rear Elevations (Crawl/ Stem Wall)
3.2	Side Elevations (Slab)
3.2.1	Side Elevations (Crawl/ Stem Wall)
3.3	Side Load Garage Elevations (Slab)
3.3.1	Side Load Garage Elevations (Crawl/Stem Wall)
3.4	Side Load Garage Elevations (Crawl/Stem Wall)
5.1	First Floor Electrical Plan
5.1.1	First Floor Options Electrical Plan
5.1.2	Alternate First Floor Electrical Plan
5.2	Optional Second Floor Electrical Plan

SQUARE	FOOT/	4GE		
	LOW CO	YATMUC		
	UNHEATED	HEATED		
FIRST FLOOR	0	1871		
FRONT PORCH	147	0		
2 CAR GARAGE	468	0		
PATIO/ DECK	176	0		
SUBTOTALS	811	1871		
TOTAL UNDER ROOF	26	82		
0	PTIONS			
	UNHEATED S.F.	HEATED S.F.		
SECOND FLOOR	0	803		
COVERED PORCH	196	0		
EXTENDED COVERED PORCH	165	0		
SMART DOOR	-25	+25		




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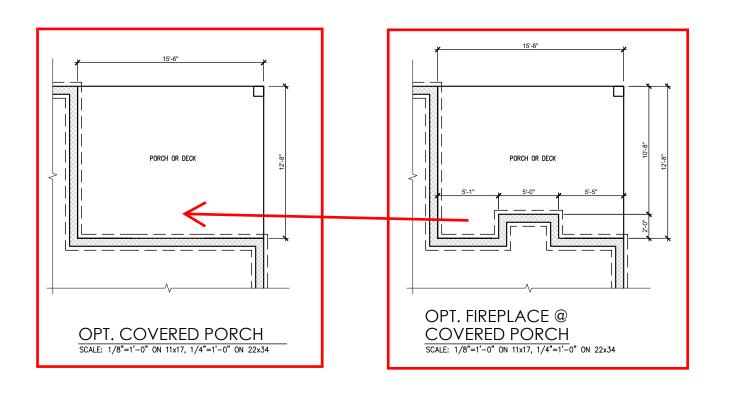
Cover Sheet 'Low Country'


- THE CLAYTON - LH

PLAN 1 7/1/2021 CURRENT REVISION DATE:

> 1/8" = 1'-0" 0.0 a



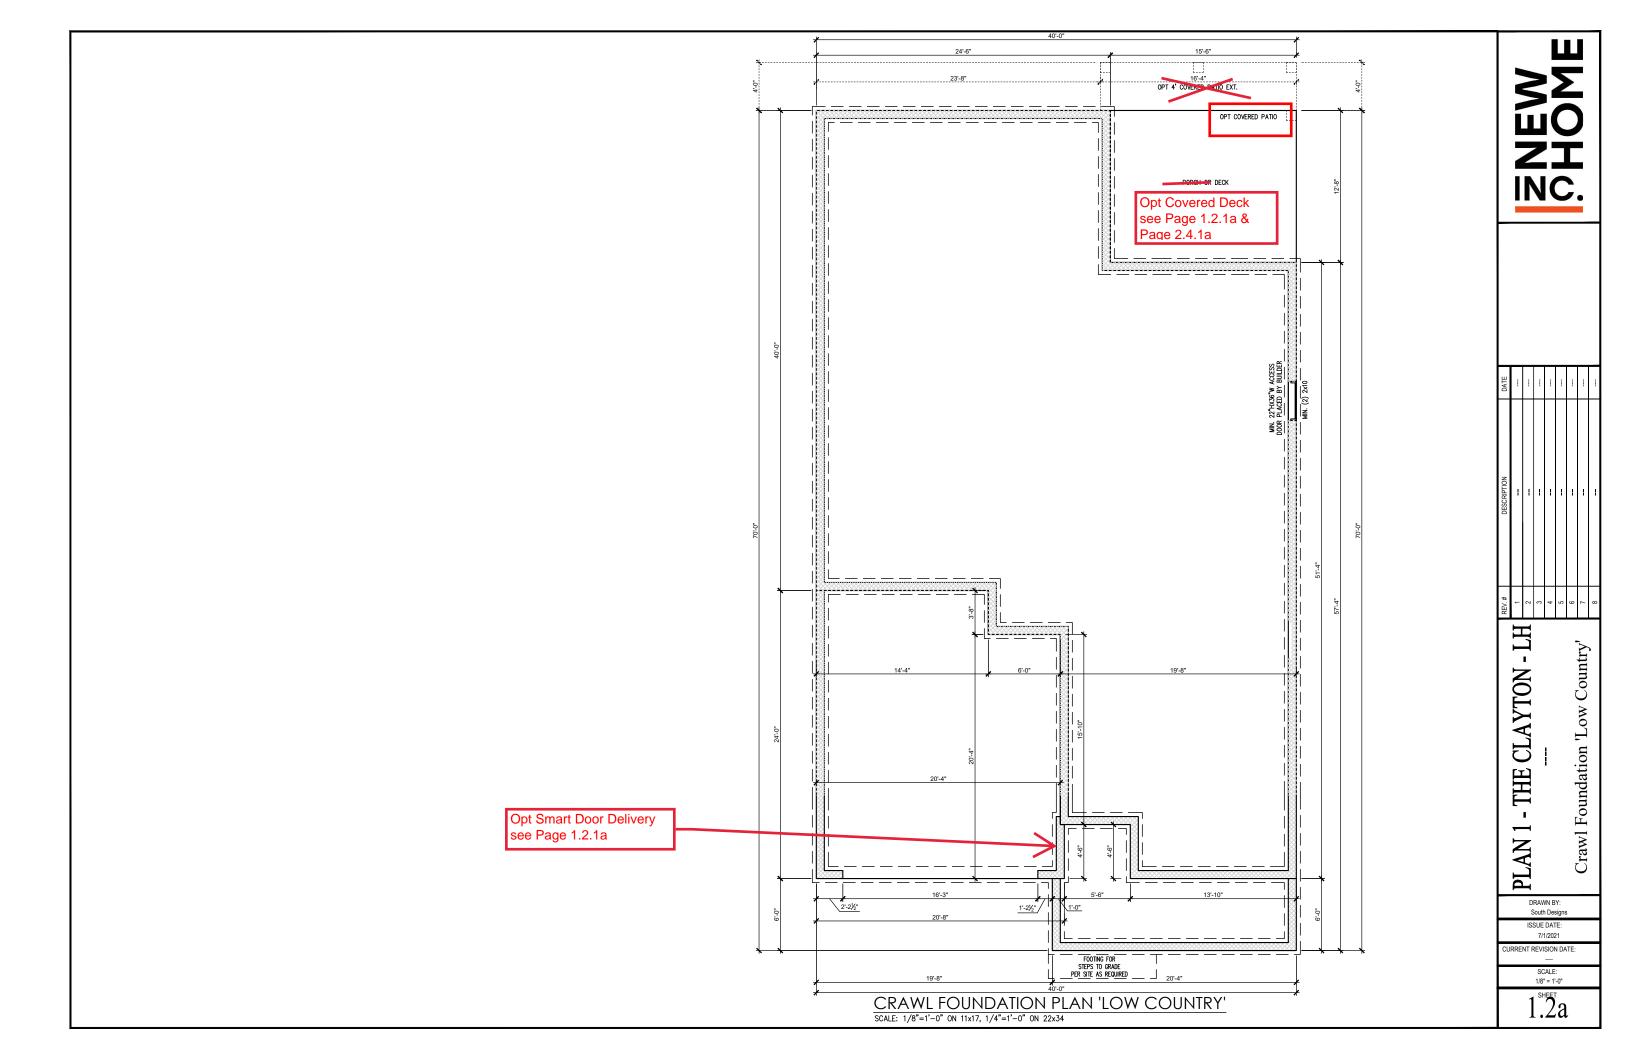

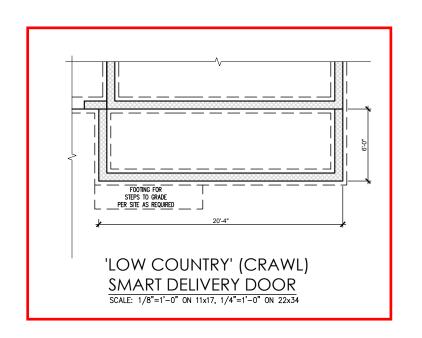


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DRAWN BY: South Designs

ISSUE DATE:

CURRENT REVISION DATE: SCALE: 1/8" = 1'-0"

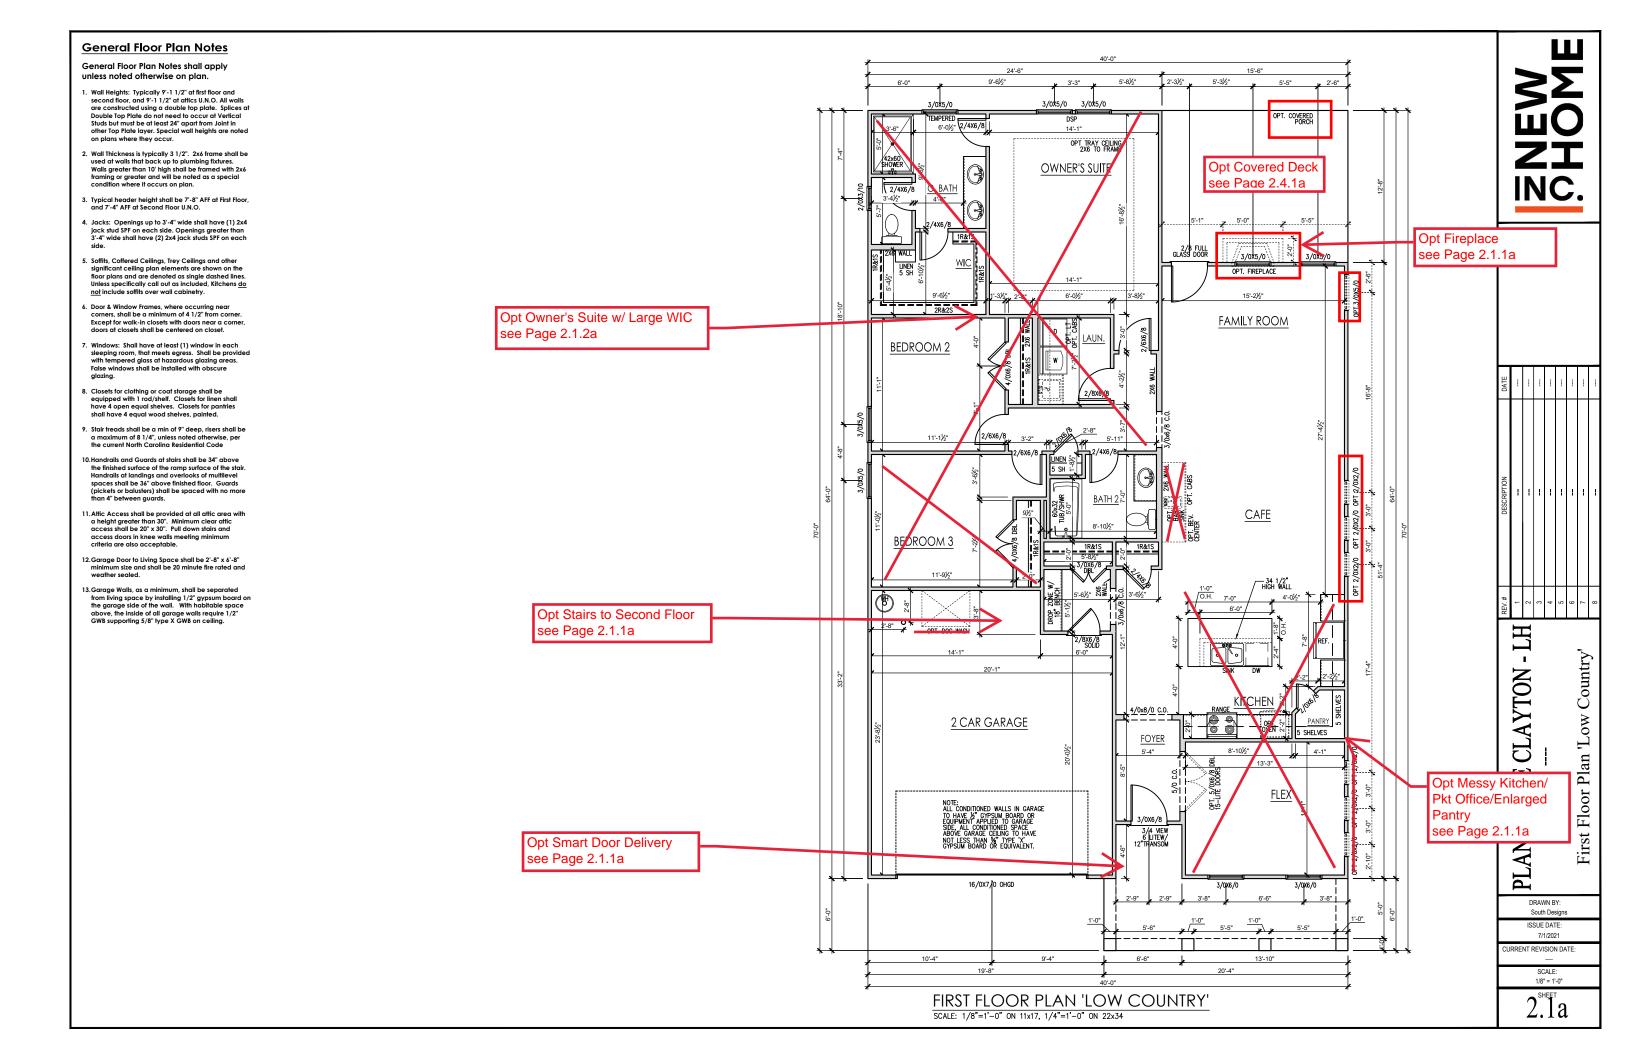



General Floor Plan Notes

General Floor Plan Notes shall apply unless noted otherwise on plan.

- Wall Heights: Typically 9'-1 1/2" at first floor and wain reignis. Typically 3-11/2" at affics U.N.O. All walls are constructed using a double top plate. Splices at Double Top Plate do not need to occur at Vertical Studs but must be at least 24" apart from Joint in other Top Plate layer. Special wall heights are noted on plans where they occur.
- Wall Thickness is typically 3 1/2". 2x6 frame shall be used at walls that back up to plumbing fixtures.
 Walls greater than 10' high shall be framed with 2x6 framing or greater and will be noted as a special condition where it occurs on plan.
- Typical header height shall be 7'-8" AFF at First Floor, and 7'-4" AFF at Second Floor U.N.O.
- Jacks: Openings up to 3'-4" wide shall have (1) 2x4 jack stud SPF on each side. Openings greater than 3'-4" wide shall have (2) 2x4 jack studs SPF on each
- Soffits, Coffered Ceilings, Trey Ceilings and other significant ceiling plan elements are shown on the floor plans and are denoted as single dashed lines. Unless specifically call out as included, Kitchens do not include soffits over wall cabinetry.
- 6. Door & Window Frames, where occurring near corners, shall be a minimum of 4 1/2" from corner. Except for walk-in closets with doors near a corner, doors at closets shall be centered on closet.
- Windows: Shall have at least (1) window in each sleeping room, that meets egress. Shall be provided with tempered glass at hazardous glazing areas. False windows shall be installed with obscure
- Closets for clothing or coat storage shall be equipped with 1 rod/shelf. Closets for linen shall have 4 open equal shelves. Closets for pantries
- Stair treads shall be a min of 9" deep, risers shall be a maximum of 8 1/4", unless noted otherwise, per the current North Carolina Residential Code
- 10. Handrails and Guards at stairs shall be 34" above the finished surface of the ramp surface of the stair. Handrails at landings and overlooks of mullilevel spaces shall be 36" above finished floor. Guards (pickets or balusters) shall be spaced with no more
- 11. Attic Access shall be provided at all attic area with a height greater than 30". Minimum clear attic access shall be 20" x 30". Pull down stairs and access doors in knee walls meeting minimum criteria are also acceptable.
- 12. Garage Door to Living Space shall be 2'-8" x 6'-8" minimum size and shall be 20 minute fire rated and weather sealed.
- 13. Garage Walls, as a minimum, shall be separated from living space by installing 1/2" gypsum board on the garage side of the wall. With habitable space above, the inside of all garage walls require 1/2" GWB supporting 5/8" type X GWB on ceilling.

Gas Stub Out - Gourmet Kitchen

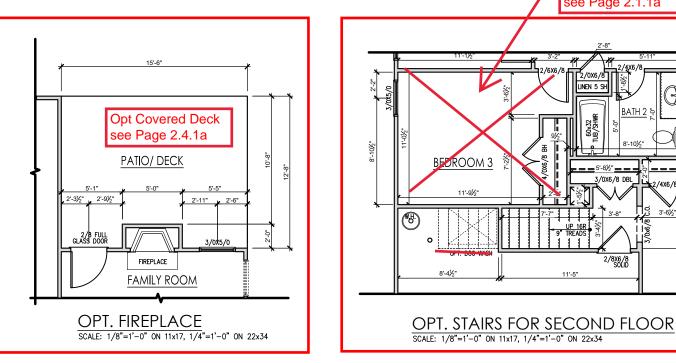

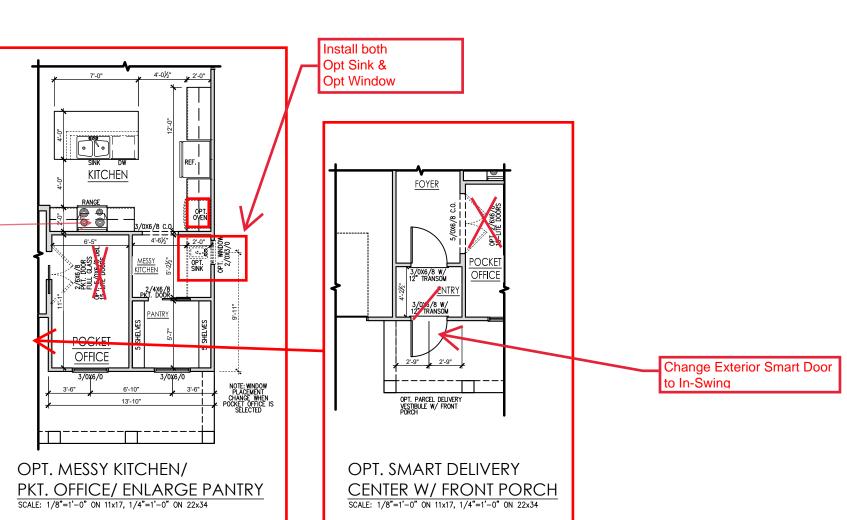

Opt Owners Suite w/ Large WIC

see Page 2.1.1a

____5'-8½"____ 3/0X6/8 DBL

2/8X6/8 SOLID



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PLAN DRAWN BY: South Designs ISSUE DATE:

First Floor Options 'Low Country'

7/1/2021 JRRENT REVISION DATE

CLAYTON-

THE

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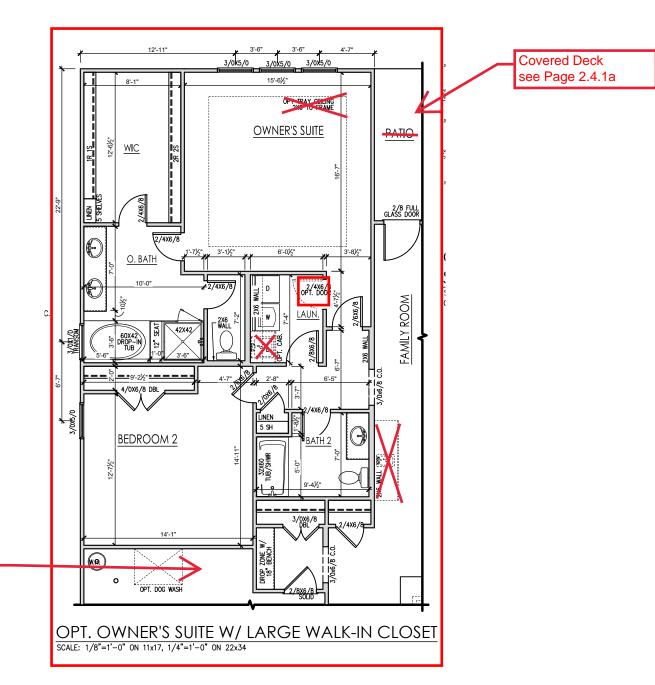
1/8" = 1'-0"

General Floor Plan Notes

General Floor Plan Notes shall apply unless noted otherwise on plan.

- Wall Heights: Typically 9'-1 1/2" at first floor and second floor, and 9'-1 1/2" at affics U.N.O. All walls are constructed using a double top plate. Splices at Double Top Plate do not need to occur at Vertical Studs but must be at least 24" apart from Joint in other Top Plate layer. Special wall heights are noted on plans where they occur.
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 Walls greater than 10' high shall be framed with 2x6 framing or greater and will be noted as a special condition where it occurs on plan.
- Typical header height shall be 7'-8" AFF at First Floor, and 7'-4" AFF at Second Floor U.N.O.
- Jacks: Openings up to 3'-4" wide shall have (1) 2x4 jack stud SPF on each side. Openings greater than 3'-4" wide shall have (2) 2x4 jack studs SPF on each
- 5. Soffits, Coffered Cellings, Trey Cellings and other significant celling plan elements are shown on the floor plans and are denoted as single dashed lines. Unless specifically call out as included, Kitchens do not include soffits over wall cabinetry.
- Door & Window Frames, where occurring near corners, shall be a minimum of 4 1/2" from corner. Except for walk-in closets with doors near a corner, doors at closets shall be centered on closet.
- Windows: Shall have at least (1) window in each sleeping room, that meets egress. Shall be provided with tempered glass at hazardous glazing areas. False windows shall be installed with obscure alozina.
- Closets for clothing or coat storage shall be equipped with 1 rod/shelf. Closets for linen shall have 4 open equal shelves. Closets for pantries shall have 4 equal wood shelves, painted.
- Stair treads shall be a min of 9" deep, risers shall be a maximum of 8 1/4", unless noted otherwise, per the current North Carolina Residential Code
- 10. Handrails and Guards at stairs shall be 34" above the finished surface of the ramp surface of the stair. Handrails at landings and overlooks of multilevel spaces shall be 36" above finished floor. Guards (pickets or balusters) shall be spaced with no more than 4" between guards.
- 11. Attic Access shall be provided at all attic area with a height greater than 30". Minimum clear attic access shall be 20" x 30". Pull down stairs and access doors in knee walls meeting minimum criteria are also acceptable.
- 12. Garage Door to Living Space shall be 2'-8" x 6'-8" minimum size and shall be 20 minute fire rated and weather sealed.
- 13. Garage Walls, as a minimum, shall be separated from living space by instelling 1/2" gypsum board on the garage side of the wall. With habitable space above, the inside of all garage walls require 1/2" GWB supporting 5/8" type X GWB on ceiling.

Opt Stairs to 2nd Floor see Page 2.1.1a



NEW C.

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PLAN 1 - THE CLAYTON -

Alternate First Floor Plan ' Low Country'

DRAWN BY: South Designs ISSUE DATE:


7/1/2021 CURRENT REVISION DATE:

> 1/8" = 1'-0" SHEET

General Floor Plan Notes

General Floor Plan Notes shall apply unless noted otherwise on plan.

- . Wall Heights: Typically 9'-1 1/2" at first floor and wall Heights: Typically Y-1 1/2" at a first floor and second floor, and 9'-1 1/2" at at thics U.N.O. All walls are constructed using a double top plate. Splices at Double Top Plate do not need to occur at Verifical Studs but must be at least 24" apart from Joint in other Top Plate layer. Special wall heights are noted on plans where they occur.
- Wall Thickness is typically 3 1/2". 2x6 frame shall be used at walls that back up to plumbing fixtures.
 Walls greater than 10' high shall be framed with 2x6 framing or greater and will be noted as a special condition where it occurs on plan.
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- 6. Door & Window Frames, where occurring near corners, shall be a minimum of 4 1/2" from corner. Except for walk-in closets with doors near a corner, doors at closets shall be centered on closet.
- Windows: Shall have at least (1) window in each sleeping room, that meets egress. Shall be provided with tempered glass at hazardous glazing areas. False windows shall be installed with obscure
- Closets for clothing or coat storage shall be equipped with 1 rod/shelf. Closets for linen shall have 4 open equal shelves. Closets for pantries
- Stair treads shall be a min of 9" deep, risers shall be a maximum of 8 1/4", unless noted otherwise, per the current North Carolina Residential Code
- 10. Handrails and Guards at stairs shall be 34" above the finished surface of the ramp surface of the stair. Handrails at landings and overlooks of mullilevel spaces shall be 36" above finished floor. Guards (pickets or balusters) shall be spaced with no more than 4" between guards.
- 11. Affic Access shall be provided at all affic area with a height greater than 30". Minimum clear affic access shall be 20" x 30". Pull down stairs and access doors in knee walls meeting minimum criteria are also acceptable.
- 12. Garage Door to Living Space shall be 2'-8" x 6'-8" minimum size and shall be 20 minute fire rated and weather sealed.
- 13. Garage Walls, as a minimum, shall be separated from living space by installing 1/2" gypsum board on the garage side of the wall. With habitable space above, the inside of all garage walls require 1/2" GWB supporting 5/8" type X GWB on ceilling.

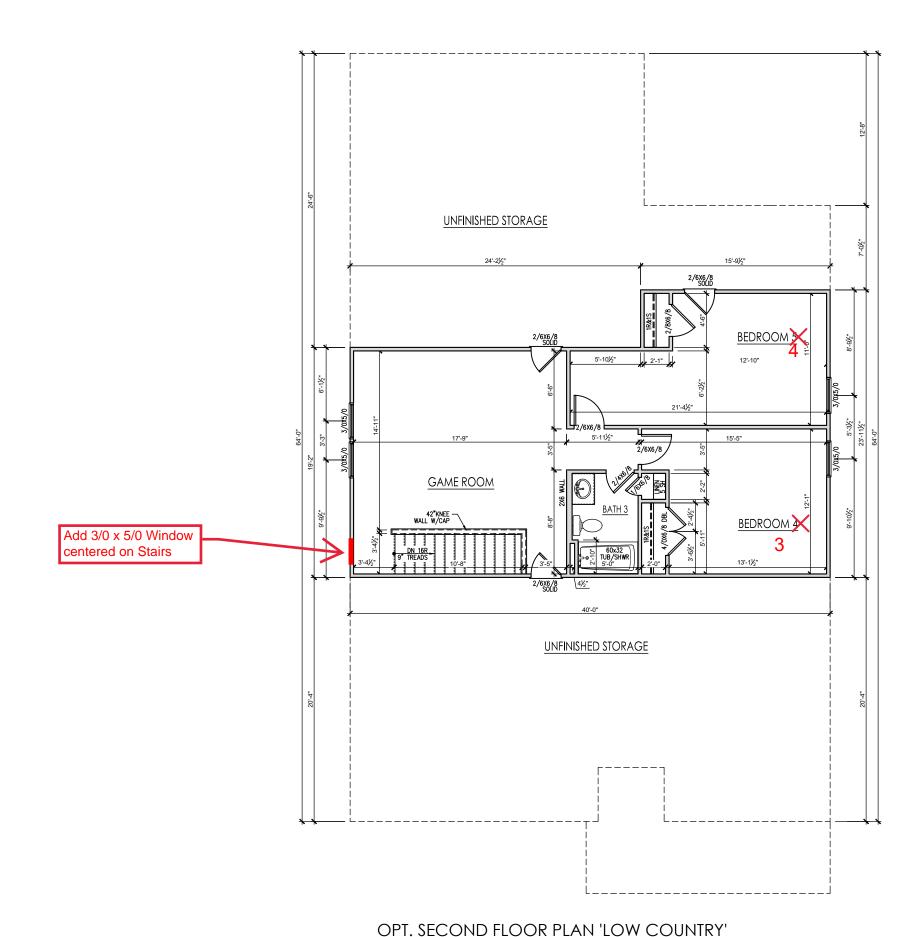

SCALE: 1/8"=1'-0" ON 11x17, 1/4"=1'-0" ON 22x34

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CLAYTON - LH Second Floor Plan 'Low Country THE • **PLAN**


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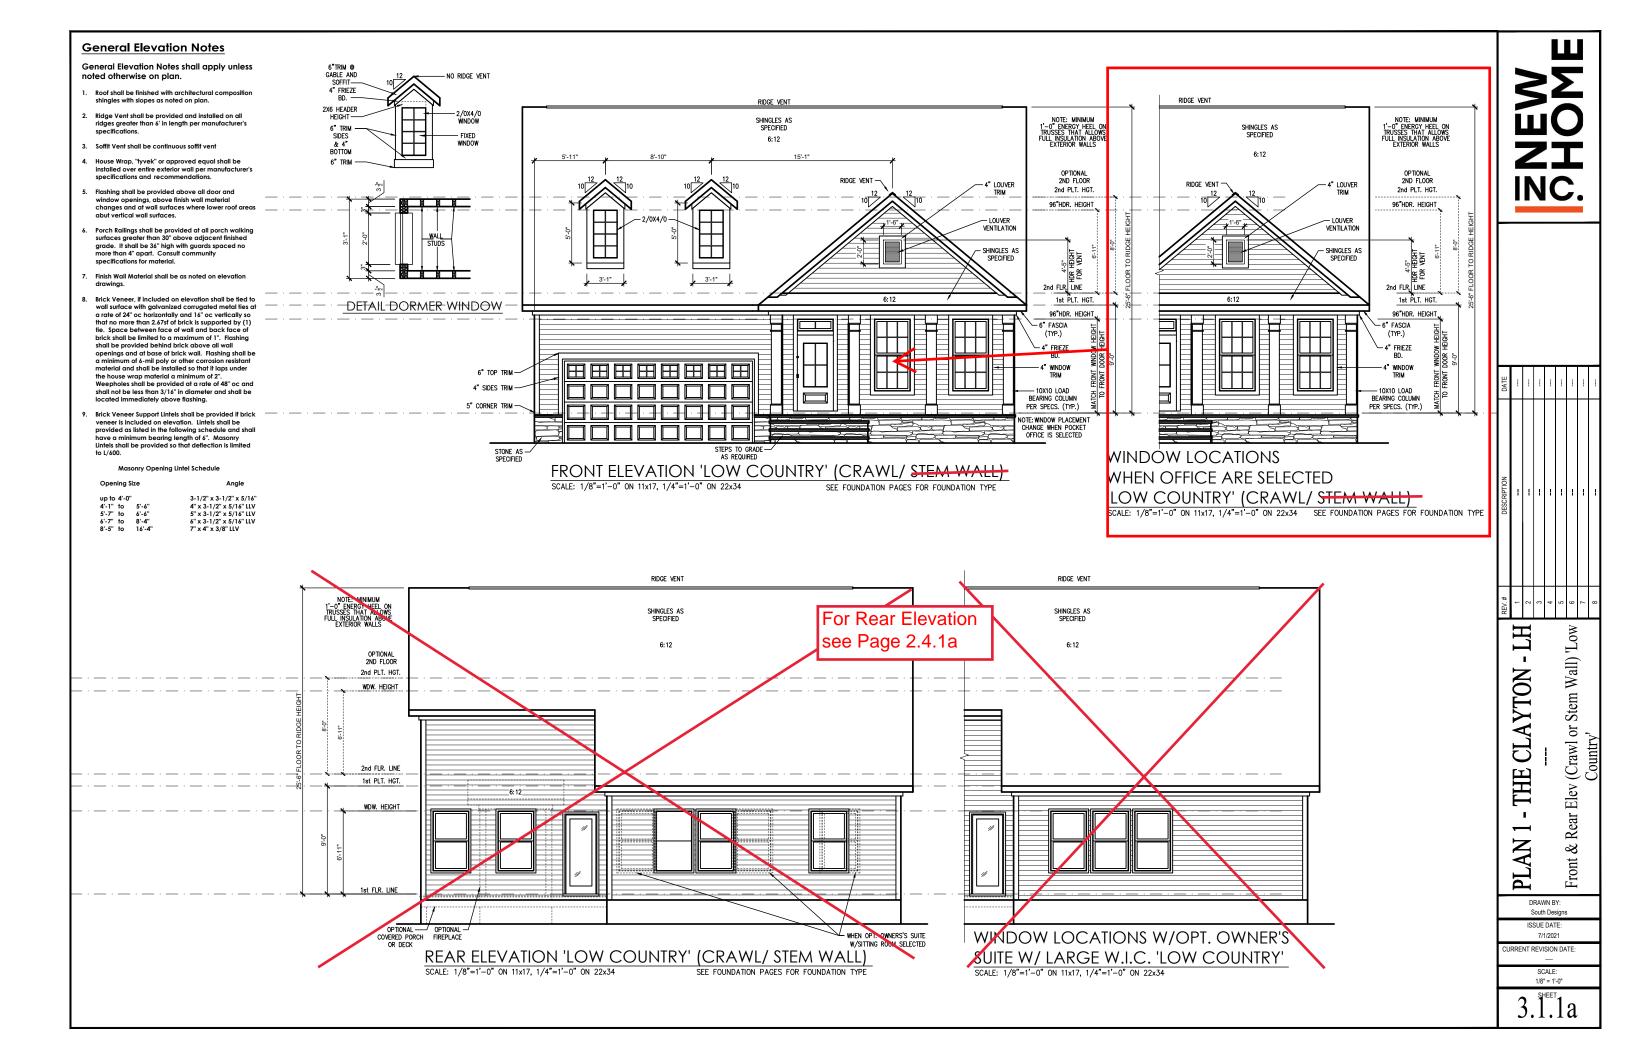
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ISSUE DATE: 7/1/2021


JRRENT REVISION DATE:

1/8" = 1'-0"



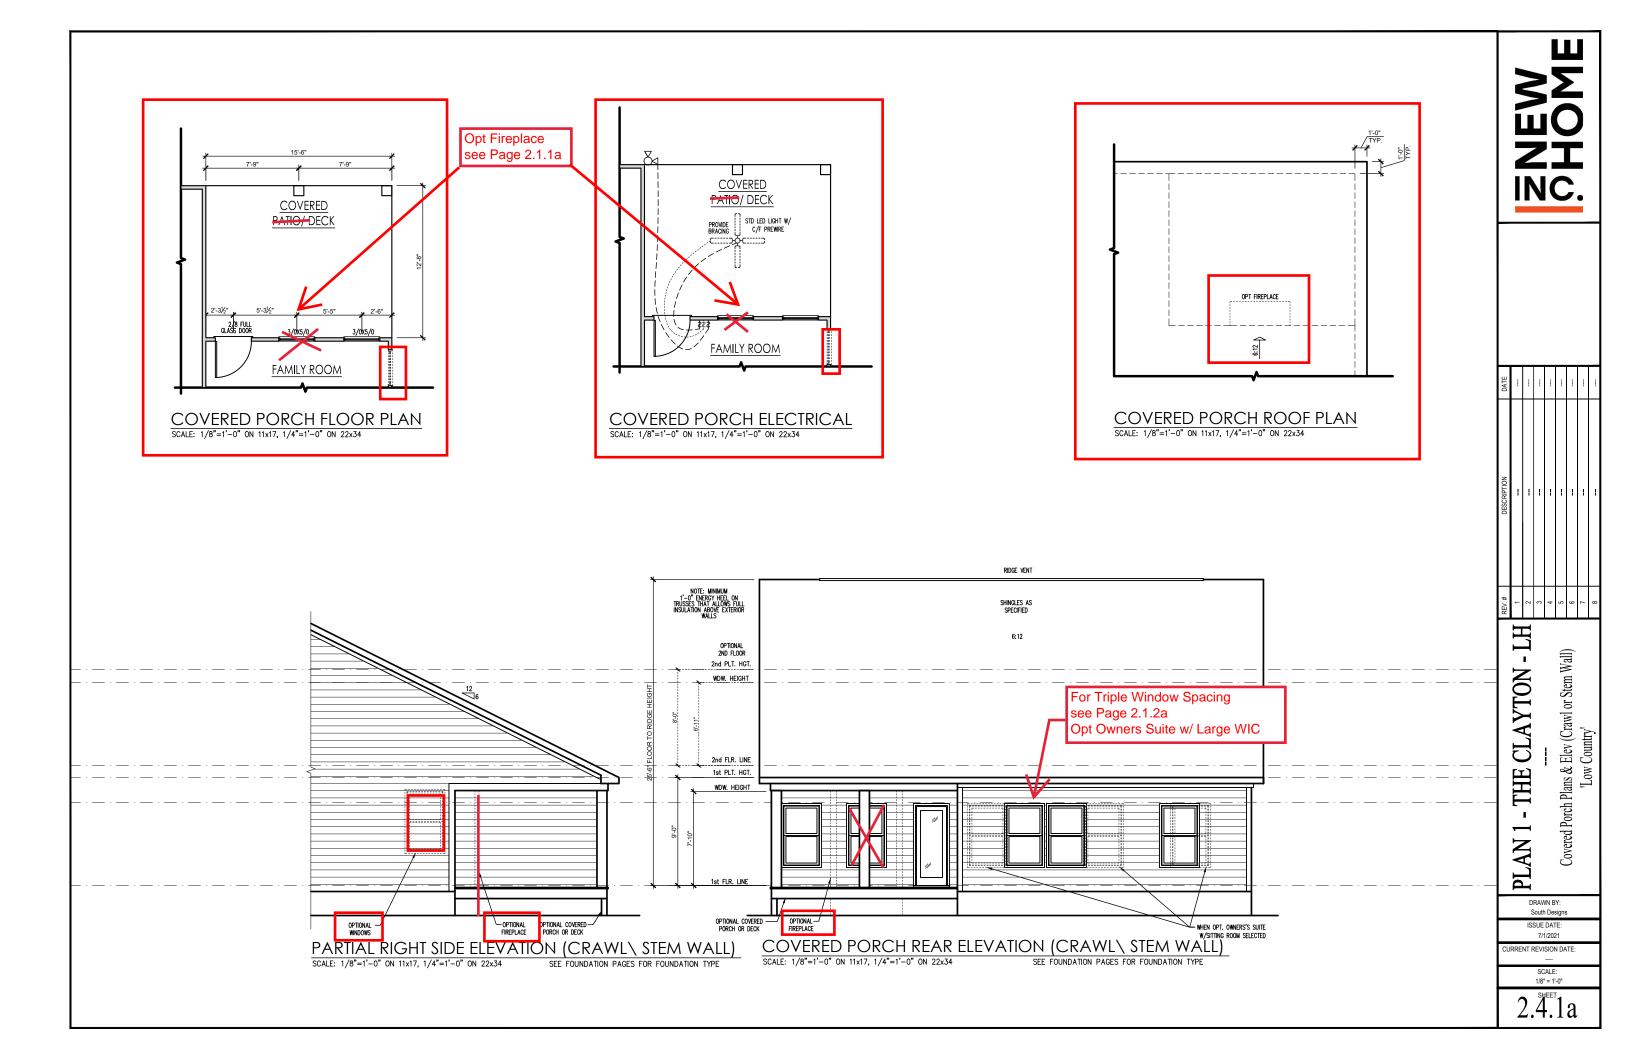

General Elevation Notes General Elevation Notes shall apply unless noted otherwise on plan. Roof shall be finished with architectural composition shingles with slopes as noted on plan Ridge Vent shall be provided and installed on all ridges greater than 6' in length per manufacturer's WINDOWS FOR THE 2ND FLOOR 3. Soffit Vent shall be continuous soffit vent House Wrap, "tyvek" or approved equal shall be installed over entire exterior wall per manufacturer's OPTIONAL 2ND FLOOR RIDGE VENT 2nd PLT. HGT. Flashing shall be provided above all door and window openings, above finish wall material changes and at wall surfaces where lower roof areas abut vertical wall surfaces. WDW. HEIGHT SHINGLES AS SPECIFIED Porch Railings shall be provided at all porch walking surfaces greater than 30" above adjacent finished grade. It shall be 36" high with guards spaced no more than 4" apart. Consult community 10:12 Finish Wall Material shall be as noted on elevation 2nd FLR. LINE Brick Veneer, if included on elevation shall be tied to wall surface with galvanized corrugated metal ties at a rate of 24" oc horizontally and 16" oc vertically so 1st PLT. HGT. that no more than 2.67st of brick is supported by (1) tie. Space between face of wall and back face of brick shall be limited to a maximum of 1". Flashing shall be provided behind brick above all wall openings and at base of brick wall. Flashing shall be a minimum of 6-mil poly or other corrosion resistant material and shall be installed so that it laps under the house wrap material a minimum of 2". Weepholes shall be provided at a rate of 48" oc and shall not be less than 31/6" in diameter and shall be located immediately above flashing. that no more than 2.67sf of brick is supported by (1) For Partial Covered Porch elevation see Page 2.4.1a OPTIONAL WINDOWS NOT AVAILABLE W/ PKT OFFICE OPTION Brick Veneer Support Lintels shall be provided if brick veneer is included on elevation. Lintels shall be provided as listed in the following schedule and shall Opt Messy Kitchen Window have a minimum bearing length of 6". Masonry Lintels shall be provided so that deflection is limited see Page 2.1.1a BLOCK & — PARGE OPTIONAL FIREPLACE OPTIONAL —/ COVERED PORCH OR DECK STEPS TO GRADE WINDOW AVAILABLE -W/ PKT OFFICE OPTION RIGHT SIDE ELEVATION 'LOW COUNTRY' (CRAWL/ STEM WALL) SCALE: 1/8"=1'-0" ON 11x17, 1/4"=1'-0" ON 22x34 SEE FOUNDATION PAGES FOR FOUNDATION TYPE up to 4'-0" 4'-1" to 5'-6" 5'-7" to 6'-6" 6'-7" to 8'-4" 8'-5" to 16'-4" 3-1/2" x 3-1/2" x 5/16" add 3/0 x 5/0 Window centered on the Staircase Elevations (Crawl or Stem Wall) 'Low Country' HT **CLAYTON** OPTIONAL 2ND FLOOR SHINGLES AS SPECIFIED RIDGE VENT 10:12 2nd PLT. HGT. WDW. HEIGHT WINDOW LOCATIONS W/OPT. OWNER'S SHINGLES AS SUITE W/ LARGE W.I.C. 'LOW COUNTRY' SCALE: 1/8"=1'-0" ON 11x17, 1/4"=1'-0" ON 22x34 THE 2nd FLR. LINE 1st PLT. HGT. WDW. HEIGHT — SIDING AS SPECIFIED **PLAN** Side DRAWN BY: South Designs ISSUE DATE: 7/1/2021 RRENT REVISION DATE: BLOCK & --PARGE STEPS TO GRADE — AS REQUIRED LEFT SIDE ELEVATION 'LOW COUNTRY' (CRAWL/ STEM WALL) SCALE: 1/8"=1'-0" ON 11x17, 1/4"=1'-0" ON 22x34 SEE FOUNDATION PAGES FOR FOUNDATION TYPE 1/8" = 1'-0"

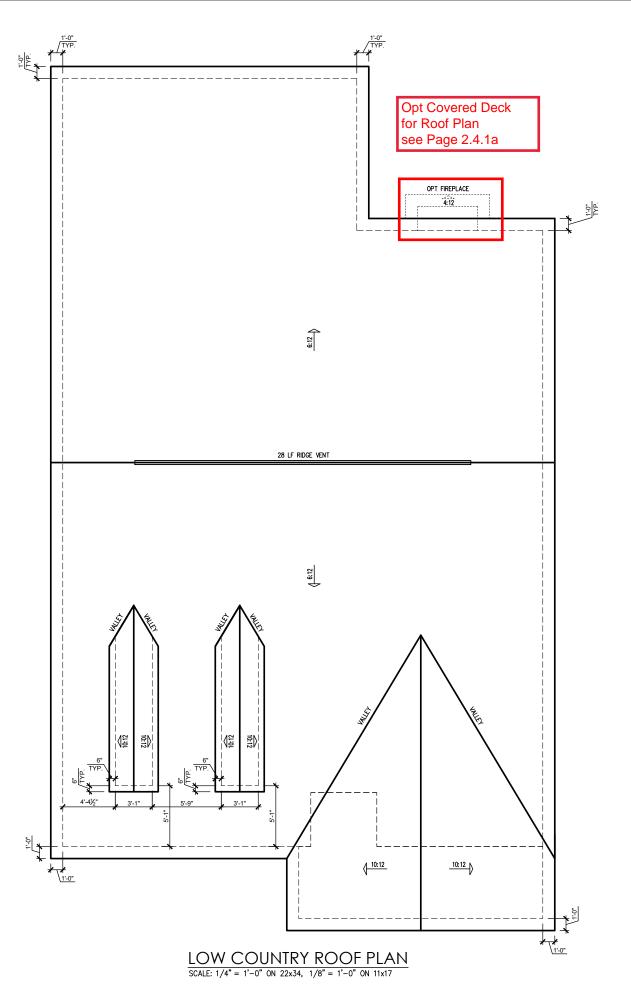

SO ET PERCENT POT LARGE POT SMALL RIDGE VENT EAVE VENT CONT. VE									
				L	OW COU	NTRY			
POT LARCE POT SMALL PIPCE VENT EAVE VENT CONT VE									
VENT TYPE									CONT. VENT (SQ. IN. PER LF)
721111112			SUPPLIED		0.4236	0.2778	0.125	0.1944	0.0625
0									
RIDGE VENT	3.31	4.14	7.50	70.59	0	0	60.00		
SOFFIT VENTS	4.97	4.14	3.13	29.41				0	50.00
TOTAL (MIN)	SQ. FT. REQUIRED RANGE SUPP			100.00	POT VENTS MAY B	E REQUIRED IF THERE	IS INSUFFICIENT RIC	OGE AVAILABLE	

* SCHEDULE HAS BEEN CALCULATED ASSUMING EAVE VENTILATION AT 50-60% OF TOTAL AND RIDGE AT 40-50% OF TOTAL REQUIRED VENTILATION

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PLAN 1 - THE CLAYTON - LF


Roof Plan 'Low Country'

DRAWN BY: South Designs ISSUE DATE: 7/1/2021

7/1/2021

CURRENT REVISION DATE:
--SCALE:
1/8" = 1'-0"


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	RISER HEIGHTS PER	STAIR CONFIGUR.	ATION
PLATE HEIGHT	10" FLOOR SYSTEM	14" FLOOR SYSTEM	16" FLOOR SYSTEM
8'-1 1/2"	14 RISERS @ 7 11/16"	15 RISERS @ 7 1/2"	15 RISERS @ 7 5/8"
9'-1 1/2"	16 RISERS @ 7 1/2"	16 RISERS @ 7 3/4"	17 RISERS @ 7 7/16"
10'-1 1/2"	17 RISERS @ 7 3/4"	18 RISERS @ 7 9/16"	18 RISERS @ 7 11/16"

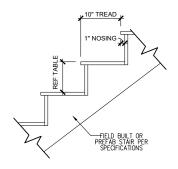
TYPICAL STAIR DETAIL

SCALE: 1" = 1'-0" ON 22x34, 1/2" = 1'-0" ON 11x17



IMPORTANT REMINDER: THE LOWEST PITCH ROOF ALWAYS MANDATES THE CONDITION. FOR EXAMPLE, A ROOF WITH A 4:12 PITCH AND A 6:12 PITCH WOULD FOLW THE 7 "ABOVE PLATE HEIGHT RULE. THE HEEL FOR THE 6:12 ROOF IN THIS CONDITION WILL DIFFER FROM WHAT IS LISTED HERE.

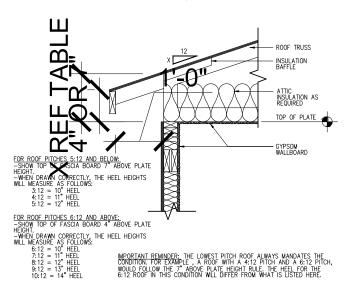
ENERGY HEEL DETAIL: CZ 2 & 3 SCALE: 1'' = 1'-0'' ON 22x34, 1/2'' = 1'-0'' ON 11x17

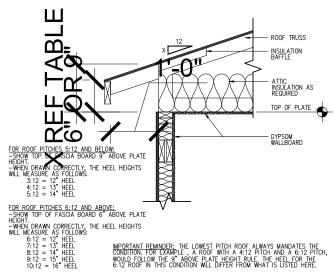


IMPORTANT REMINDER: THE LOWEST PITCH ROOF ALWAYS MANDATES THE CONDITION. FOR EXAMPLE, A ROOF WITH A 4:12 PITCH AND A 6:12 PITCH WOULD FOLLOW THE 9" ABOVE PLATE HEIGHT RULE. THE HEEL FOR THE 6:12 ROOF IN THIS CONDITION WILL DIFFER FROM WHAT IS LISTED HERE.

ENERGY HEEL DETAIL: CZ 4 & 5

SCALE: 1'' = 1'-0'' ON 22x34, 1/2'' = 1'-0'' ON 11x17

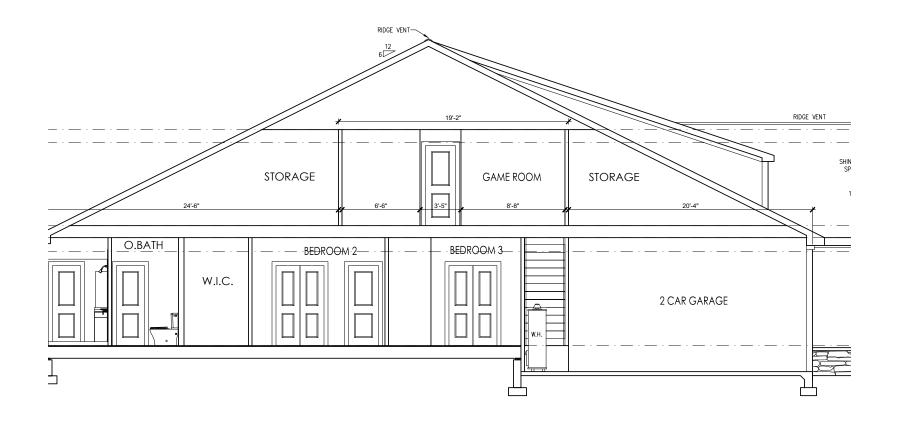

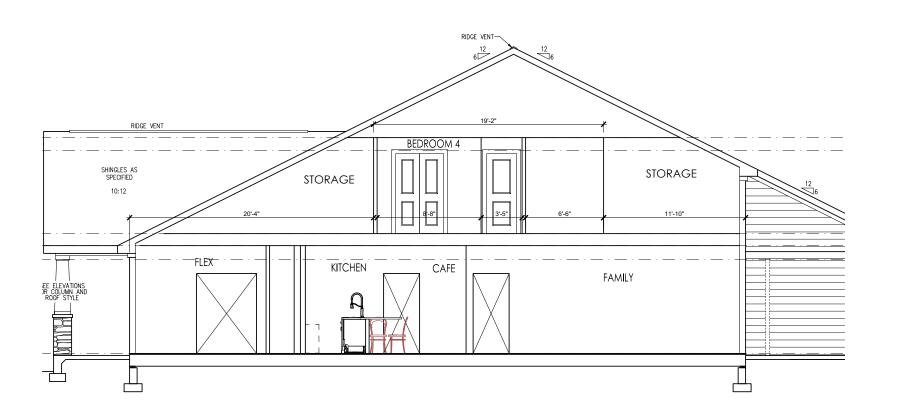



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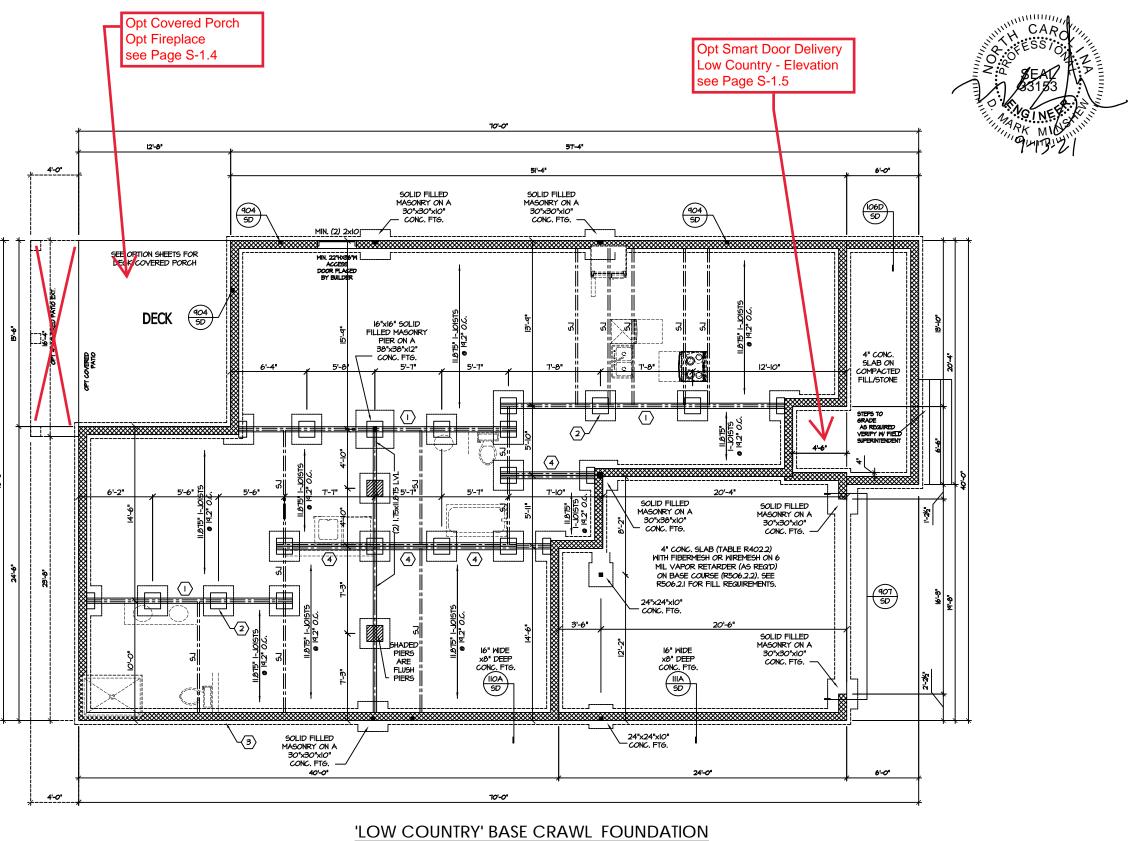
CLAYTON-- THE **PLAN**

Building Sections 'Farmhouse'_Crawl

South Designs

ISSUE DATE: 7/1/2021 CURRENT REVISION DATE:

SCALE: 1/8" = 1'-0"



SCALE: 1/8"=1'-0" ON 11x17, 1/4"=1'-0" ON 22x34

WITH 2nd FOOR AND OPT. OWNER'S SUITE WITH LARGE WALK-IN CLOSET

PROJECT # 21-2967-GL


P.A. 27609


Southern Engineers, P. 3716 Benson Drive, Raleigh, NC 271 Phone: (919) 878-1617 License: C-4772 www.southernengineers.com

AJ DESIGNS


NEW HOME, INC. Plan 01 Garage Left


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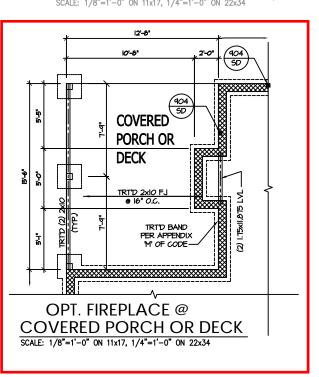


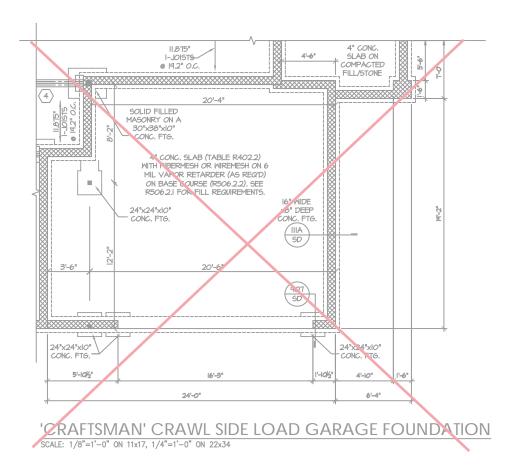

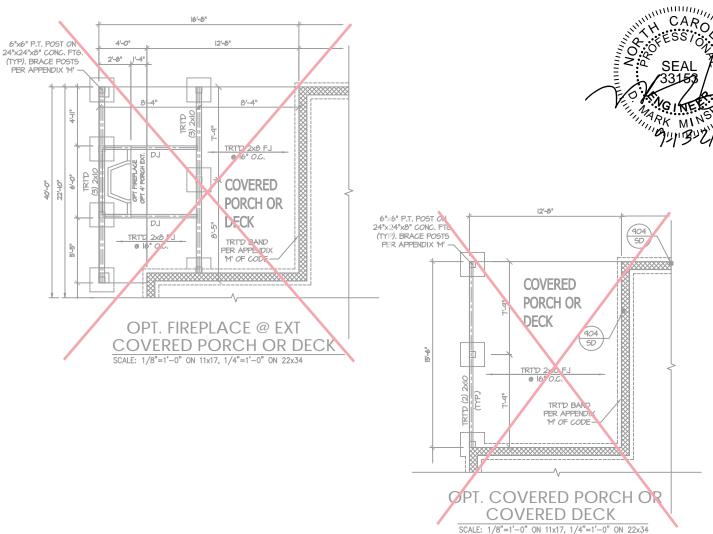'LOW COUNTRY' CRAWL SIDE LOAD GARAGE FOUNDATION
SCALE: \(\lambda 8"=1'-0"\) ON 11x17, 1/4"=1'-0" ON 22x34



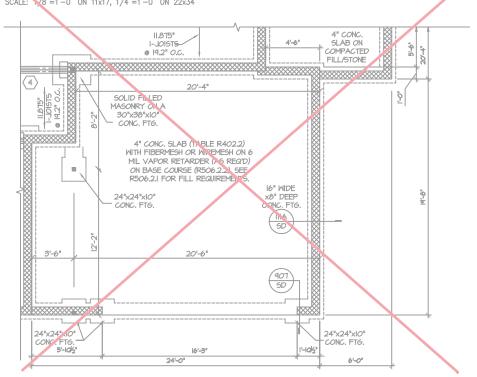

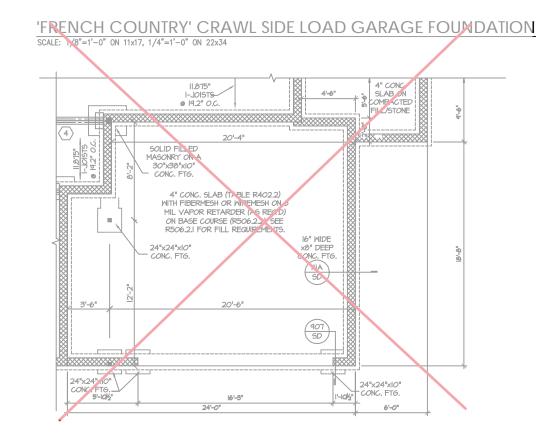


PROJECT # 21-2967-GL


Engueres occurrent to the construction means, methods, techniques, document. Seal does not include construction means, methods, techniques, sequences, procedures or safety precautions. Any deviations or discrepancies on plans are to be brought to the immediate attention of Southern Engineers. Failure to do so will void Southern Engineers liability. Seal is valid for projects permitted one year from date of seal. Use of these plans constitutes approval of terms & conditions as defined in the customer agreement.


P.A. 27609 Southern Engineers, P. 3716 Benson Drive, Raleigh, NC 276
Phone: (919) 878-1617
License: C-4772
www.southernengineers.com


> **DESIGNS** A

NEW HOME, INC. Plan 01 Garage Left

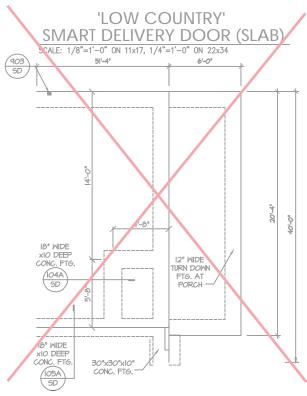

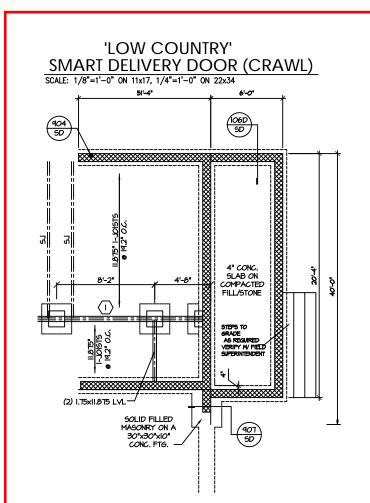

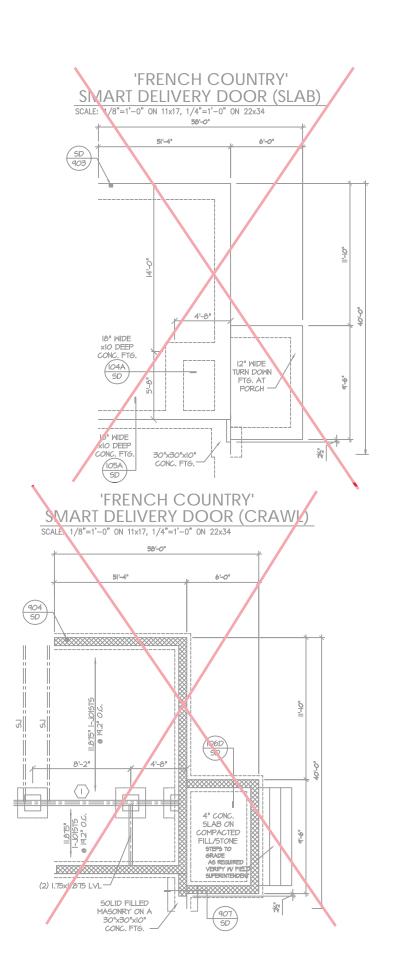

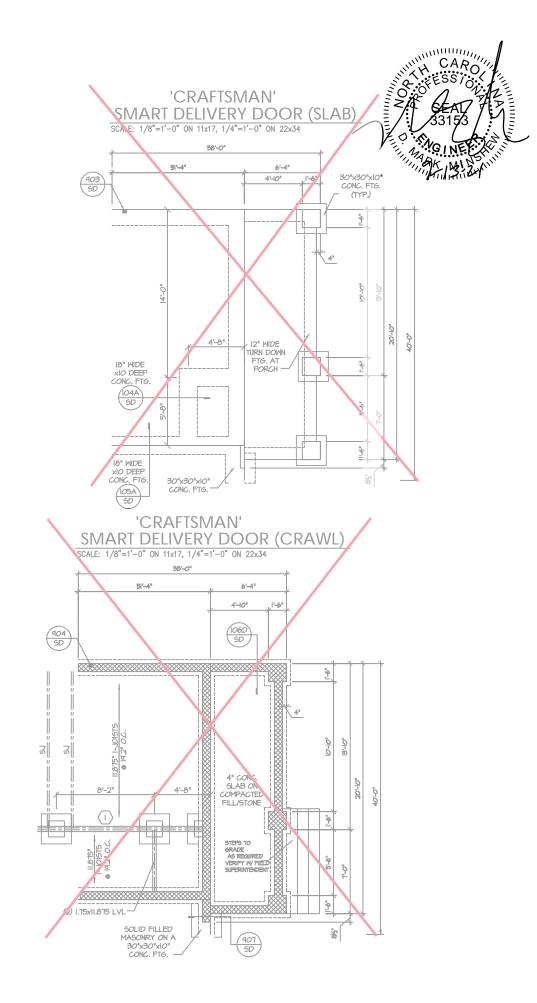

PROJECT # 21-2967-GL

toto.

Is are to be brought to the seers. Failure to do so will cear from date of seal

Solutions of include construction means, methods, techniq sequences, procedures or safety precautions.
Any deviations or discrepancies on plans are to be brought 1 immediate attention of Southern Engineers, Failure to do so void Southern Engineers' sliability.

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AJ DESIGNS

Plan 01
Garage Left
NEW HOME, INC.

S-1.5

FRAMING NOTES

NC (2018 NCRC): Wind: 115-120 mph

- BRACING METHOD AND TYPE: CONTINUOUSLY SHEATHED MGP; CS-MGP, NOTE THAT THE WALL BRACING AMOUNT PROVIDED ON THE PLANS (DETAILS AND SPECIFICATIONS) IS GREATER THAN THE AMOUNT OF WALL BRACING REQUIRED BY SECTION R602.10 OF THE CODE. SEE NOTES BELOW FOR DETAILS AND SPECIFICATIONS FOR WALL BRACING AND WALL FRAMING
- 2. EXTERIOR WALL SHEATHING: WALLS SHALL BE BRACED BY SHEATHING WALLS ON ALL STORIES WITH WOOD STRUCTURAL PANEL SHEATHING (MSP) (EXPOSURE B: 7/16". EXPOSURE C: 15/32"). SHEATHING SHALL BE ATTACHED WITH 8d NAILS AT A 6"/12" NAILING PATTERN (6" OC AT PANEL EDGES AND 12" OC AT INTERMEDIATE SUPPORTS). INSTALL BLOCKING AT ALL PANEL EDGES.
- 3. WSP SHEATHING SHALL EXTEND TO THE UPPERMOST DOUBLE BEARING PLATE, BLOCK AT ROOF PER SECTION R602.10.45 AND ATTACH BRACED WALLS PER CODE, WEP SHEATHING BETWEEN FLOORS SHALL BE SPLICED ALONG CONTINUOUS BAND OR THE WSP SHEATHING MAY BE SPLICED ACROSS STUDS (CONTINUOUS ACROSS FLOOR SYSTEM) WITH BLOCKING AT PANEL EDGES. (MINIMUM 12" BEYOND FLOOR BREAK) OR
- 4. "HD" = HOLDOWN: HOLD-DOWN DEVICE (NOTED AS "HD" ON PLANS) SHALL BE AN 800 POUND CAPACITY ASSEMBLY AS NOTED ON PLANS. SEE DETAILS FOR HD ASSEMBLY.
- ***GROUND/FIRST FLOOR: USE "HD HOLD-DOWN DETAIL" ON SD SHEET (OR EQUIV.)

 ***UPPER FLOORS: ATTACH BASE OF KING STUD WITH A SIMPSON CS22 STRAP DOWN ACROSS THE BAND AND DOWN TO A STUD BELOW OR HEADER BELOW. EXTEND STRAP 7" MIN ALONG EACH STUD (OR HEADER) AND ATTACH EACH END W (1) 8d
- INTERIOR BRACED WALL: (NOTED AS "IBM" ON PLANS) ATTACH I/2" GYPSUM BOARD (GB) ON EACH SIDE OF WALL WITH A MIN. OF 5d COOLER NAILS OR #6 SCREWS 7" O.C. ALONG THE EDGES AND AT INTERMEDIATE SUPPORTS.
- 6. INTERIOR BRACED WALL-WOOD STRUCTURAL PANEL: (NOTED AS "IBW-WSP" ON PLANS). ATTACH ONE SIDE WITH 1/4" WSP SHEATHING WITH 8d NAILS AT A 6"/12" NAILING PATTERN (6" OC AT PANEL EDGES AND 12" OC AT INTERMEDIATE SUPPORTS). INSTALL BLOCKING AT ALL PANEL EDGES, ATTACH 6B OVER MEP AS REQUIRED, ATTACH OPPOSITE SIDE WITH 1/2" GB WITH A MIN. OF 5d COOLER NAILS OR #6 SCREWS @ 7" OC ALONG THE EDGES AND AT INTERMEDIATE SUPPORTS.

HEADER/BEAM & COLUMN NOTES

- ALL EXTERIOR AND LOAD BEARING HEADERS SHALL BE MIN. (2)2x6 (4" WALL) OR (3)2x6 (6" WALL) WITH (I) SUPPORT STUD, UNLESS NOTED OTHERWISE.
- 2. THE NUMBER SHOWN AT BEAM AND HEADER SUPPORTS INDICATES THE NUMBER OF SUPPORT STUDS REQUIRED IN STUD POCKET OR COLUMN. THE NUMBER OF KING STUDS AT EACH END OF HEADERS IN EXTERIOR WALLS SHALL BE ACCORDING TO ITEM "d" IN TABLE R602.3(5) OR AS BELOW PER NCDOI COMMENTARY "KING STUDS AT WALL OPENINGS"
- REVISED I-9-2020: UP TO 3' SPAN: (I) KING STUD
- OVER 3' UP TO 6' SPAN: (2) KING STUDS OVER 6' UP TO 9' SPAN: (3) KING STUDS
- OVER 4' UP TO 12' SPAN: (4) KING STUDS
- OVER 12' UP TO 15' SPAN: (5) KING STUDS

TRUSS SYSTEM REQUIREMENTS

NC (2018 NCRC): Wind: 115-120 mph

- TRUSS SYSTEM LAYOUTS (PLACEMENT PLANS) SHALL BE DESIGNED IN ACCORDANCE WITH SEALED STRUCTURAL PLANS, ANY NEED TO CHANGE TRUSSES SHALL BE COORDINATED WITH SOUTHERN
- TRUSS SCHEMATICS (PROFILES) SHALL BE PREPARED AND SEALED BY TRUSS MANUFACTURER.
- ALL TRUSSES SHALL BE DESIGNED FOR BEARING ON SPF #2 OR #3 PLATES OR LEDGERS (UNO).
- ALL REQUIRED ANCHORS FOR TRUSSES DUE TO UPLIFT OR BEARING SHALL MEET THE REQUIREMENTS AS SPECIFIED ON THE TRUSS SCHEMATICS.

Opt Owner's Suite w/ Large WIC see Page S-3.2

MOOD I-JOISTS


(SHALL BE ONE OF THE FOLLOWING):

- TJI 210 BY TRUS JOIST LPI 20 PLUS BY LP
- BCI 5000s I.8 BY BC
- ALL WOOD I-JOISTS SHALL BE INSTALLED ACCORDING TO MANUFACTURER'S SPECIFICATIONS
- INSTALL SQUASH BLOCKS, WEB STIFFENERS, ETC. AS REQUIRED BY AND ACCORDING TO THE I-JOIST MANUFACTURER'S SPECIFICATIONS AND
- HANGERS FOR I-JOISTS ARE THE RESPONSIBILITY OF THE I-JOIST SUPPLIER.
- FLOOR TRUSSES BY MANUFACTURER MAY BE

- PORCH POST NOTES:


 4"x4" (6"x6") TRT'D POST (OR EQUAL). ATTACH TRUSSES (RAFTERS) AT PORCH WITH HURRICANE CONNECTORS.
- POST CAP: SIMPSON AC4-MAX (AC6-MAX)
 POST CAP AT CORNER: (2) SIMPSON LCE4
- (MITER HEADER AT CORNER). HIGH WIND; ADD (1) SIMPSON H6.
- 3. POST BASE: SIMPSON ABU44 (ABU66).
- MONO: %" ANCHOR (EMBED 7")
 CMU: %" ANCHOR (EXTEND TO FOOTING HIGH WIND ONLY)
- POST BASE; WOOD FOUNDATION; (2) SIMPSON
 CSIG STRAPS AT POSTS, EXTEND 12" ONTO
 EACH POST (UPPER AND LOWER) OR TO GIRDER.
- NOTE: EQUIVALENT POST CAP AND BASE ACCEPTABLE.



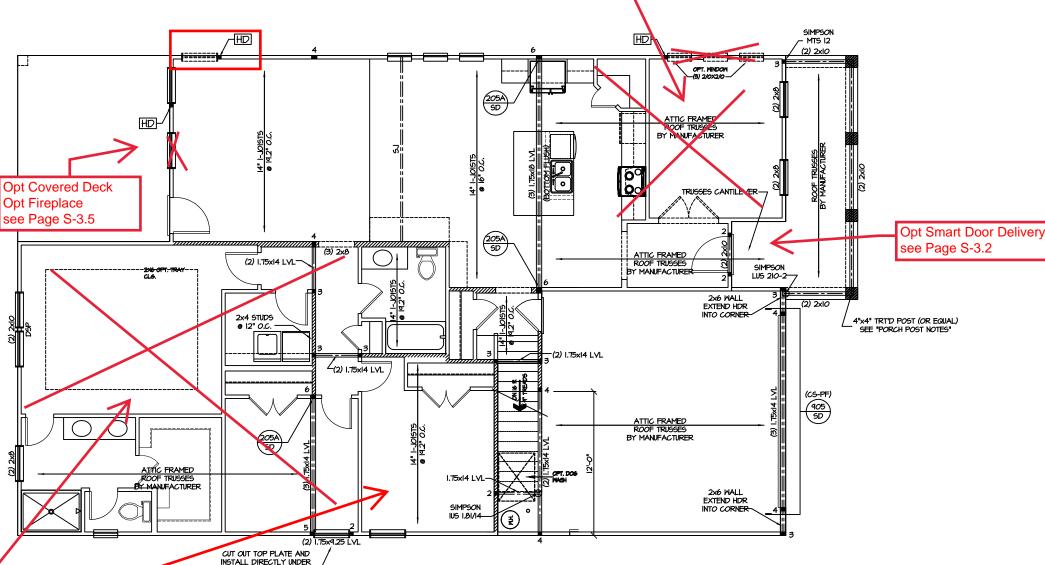

'LOW COUNTRY' BASE FIRST FLOOR PLAN SCALE: 1/8"=1'-0" ON 11x17, 1/4"=1'-0" ON 22x34

WITH 2nd FOOR

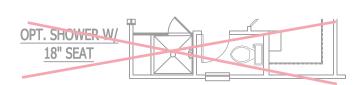

PROJECT # 21-2967-GL


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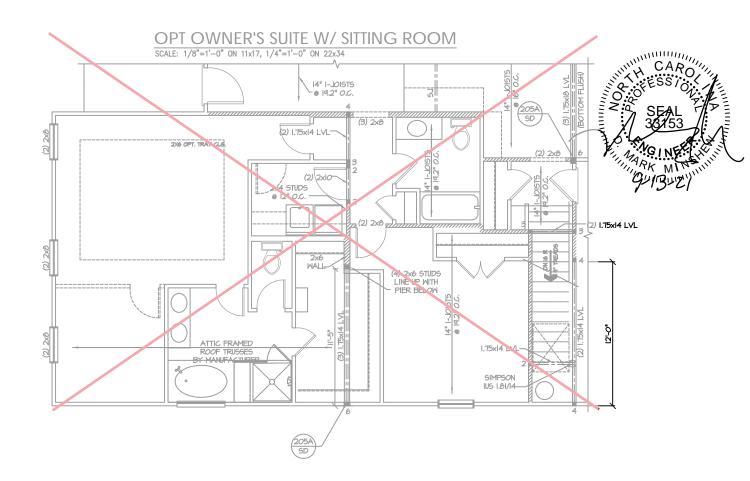
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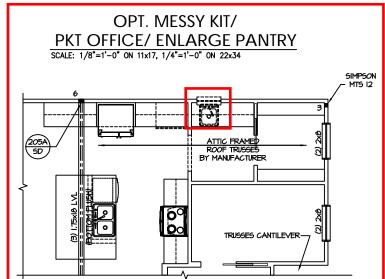
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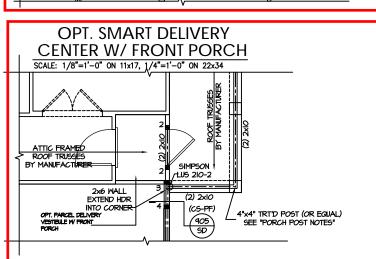
NEW HOME, IN










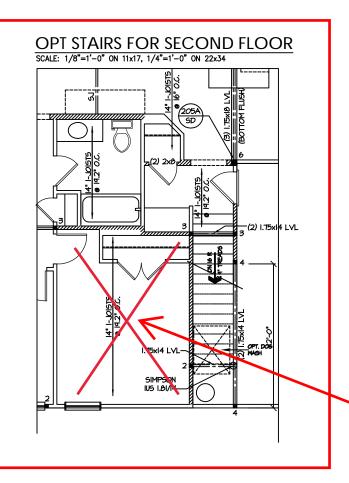



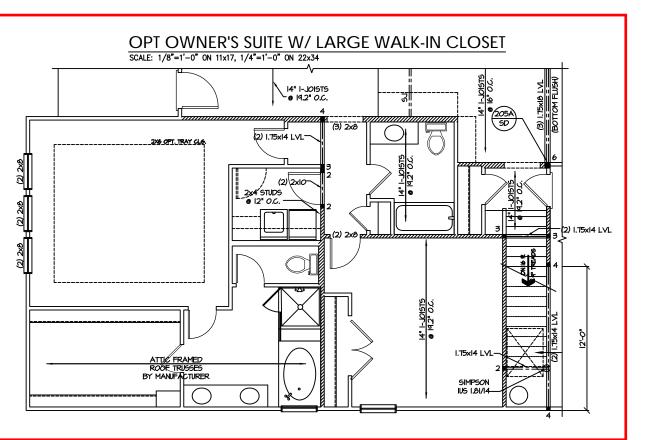

PROJECT # 21-2967-GL

Engineers seal applies only to structure compensation of comment.

document.
Seal does not include construction means, methods, techniques, sequences, procedures or safety precautions.

Any deviations or discrepaniers on plans are to be brought to the immediate attention of Southern Engineers. Failure to do so will void Southern Engineer's liability.


Seal is valid for projects permitted one year from date of seal.
Use of these plans constitutes approval of terms & conditions as defined in the customer agreement.

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AJ DESIGNS

NEW HOME, INC. Plan 01 Garage Left

S-3.2

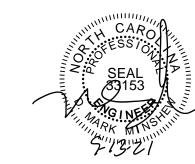

- PORCH POST NOTES:

 4 *'x4" (6'x6") TRITO POST (OR EQUAL).

 ATTACH TRUSSES (RAFTERS) AT PORCH WITH HURRICANE CONNECTORS.

 1. POST CAP, SIMPSON AC4-MAX (AC6-MAX)


 2. POST CAP AT CORNER; (2) SIMPSON LCE4 (MITER HEADER AT CORNER), HIGH MIND; ADD (1) SIMPSON H6.


 3. POST BASE; SIMPSON ABU44 (ABU66).


 31. MOND; %" ANCHOR (EMBED T")

 32. CMJ; %" ANCHOR (EXTEND TO FOOTING HIGH MIND ONLY)

 4. POST BASE; WOOD FOUNDATION; (2) SIMPSON CSI6 STRAPS AT POSTS, EXTEND 12" ONTO EACH POST (UPPER AND LOWER) OR TO GIRDER.
- <u>NOTE:</u> EQUIVALENT POST CAP AND BASE ACCEPTABLE.

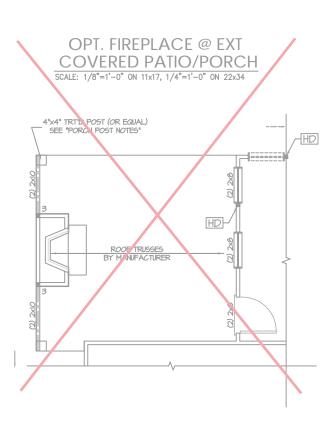

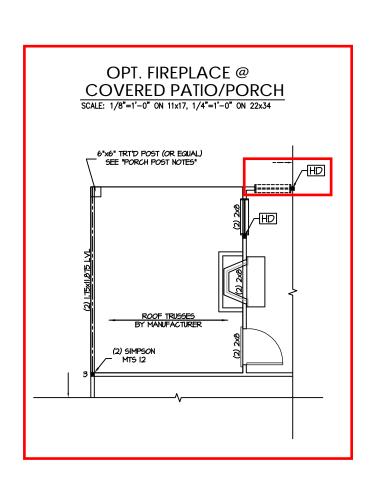

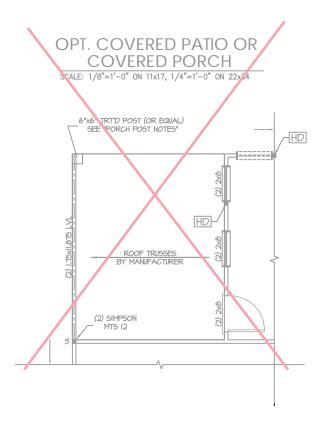

Engineers seal applies only to structural components on this document.

document.
Seal does not include construction means, methods, techniques, sequences, procedures or safety precautions.

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S-3.5

FRAMING NOTES

NC (2018 NCRC): Wind: 115-120 mph

- BRACING METHOD AND TYPE: CONTINUOUSLY SHEATHED WSP: CS-MSP. NOTE THAT THE WALL BRACING AMOUNT PROVIDED ON THE CS-YEP. NOTE THAT THE WALL BRACING AYOUNT PROVIDED ON THE PLANS (DETAILS AND SPECIFICATIONS) IS GREATER THAN THE AMOUNT OF WALL BRACING REQUIRED BY SECTION R602.10 OF THE CODE, SEE NOTES BELOW FOR DETAILS AND SPECIFICATIONS FOR WALL BRACING AND WALL FRAMING.
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- 3. WSP SHEATHING SHALL EXTEND TO THE UPPERMOST DOUBLE BEARING PLATE. BLOCK AT ROOF PER SECTION R602.IO.4.5 AND ATTACH BRACED WALLS PER CODE. WSP SHEATHING BETWEEN FLOORS SHALL BE SPLICED ALONG CONTINUOUS BAND OR THE WSP SHEATHING MAY BE SPLICED ACROSS STUDS (CONTINUOUS ACROSS FLOOR SYSTEM) WITH BLOCKING AT PANEL EDGES. (MINIMUM 12" BEYOND FLOOR BREAK) OR OTHER APPROVED METHOD.
- 4. "HD" = HOLDOWN. HOLD-DOWN DEVICE (NOTED AS "HD" ON PLANS)
 SHALL BE AN 800 POUND CAPACITY ASSEMBLY AS NOTED ON
 PLANS, SEE DETAILS FOR HD ASSEMBLY.

 #46ROUND/FIRST FLOOR. USE "HD HOLD-DOWN DETAIL" ON SD
- SHEET (OR EQUIV.)
- SHEET (O'R EGUIV.)

 ""UPPER ELOORS, ATTACH BASE OF KING STUD MITH A SIMPSON
 CS22 STRAP DOWN ACROSS THE BAND AND DOWN TO A STUD
 BELOW O'R HEADER BELOW. EXTEND STRAP 7" MIN ALONG EACH
 STUD (O'R HEADER) AND ATTACH EACH END W (1) 8d NAILS.
- 5. INTERIOR BRACED WALL: (NOTED AS "IBM" ON PLANS) ATTACH 1/2" GYPSUM BOARD (GB) ON EACH SIDE OF WALL WITH A MIN. OF 5d COOLER NAILS OR #6 SCREWS @ 7" O.C. ALONG THE EDGES AND AT
- 6. INTERIOR BRACED WALL-WOOD STRUCTURAL PANEL: (NOTED AS "IBN-MSP" ON PLANS), ATTACH ONE SIDE MITH 1/6" MSP SHEATHING MITH 8d NAILS AT A 6"/12" NAILING PATTERN (6" OC AT PANEL EDGES AND 12" OC AT INTERMEDIATE SUPPORTS). INSTALL BLOCKING AT ALL PANEL EDGES, ATTACH 6B OVER WEP AS REQUIRED. ATTACH OPPOSITE SIDE WITH 1/2" 6B WITH A MIN. OF 5d COOLER NAILS OR \$6 SCREWS © 1" OC ALONG THE EDGES AND AT

HEADER/BEAM & COLUMN NOTES


- ALL EXTERIOR AND LOAD BEARING HEADERS SHALL BE MIN. (2)2x6 (4" WALL) OR (3)2x6 (6" WALL) WITH (1) SUPPORT STUD, UNLESS NOTED OTHERWISE.
- 2. THE NUMBER SHOWN AT BEAM AND HEADER SUPPORTS INDICATES THE NUMBER OF SUPPORT STUDS REQUIRED IN STUD POCKET OR COLUMN. THE NUMBER OF KING STUDS AT EACH END OF HEADERS IN EXTERIOR WALLS SHALL BE ACCORDING TO ITEM "d" IN TABLE R602.3(5) OR AS BELOW PER NCDOI COMMENTARY "KING STUDS AT WALL OPENINGS" REVISED I-4-2020: UP TO 3' SPAN: (I) KING STUD
- OVER 3' UP TO 6' SPAN: (2) KING STUDS OVER 6' UP TO 9' SPAN: (3) KING STUDS
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TRUSS SYSTEM REQUIREMENTS

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PROJECT # 21-2967-GL


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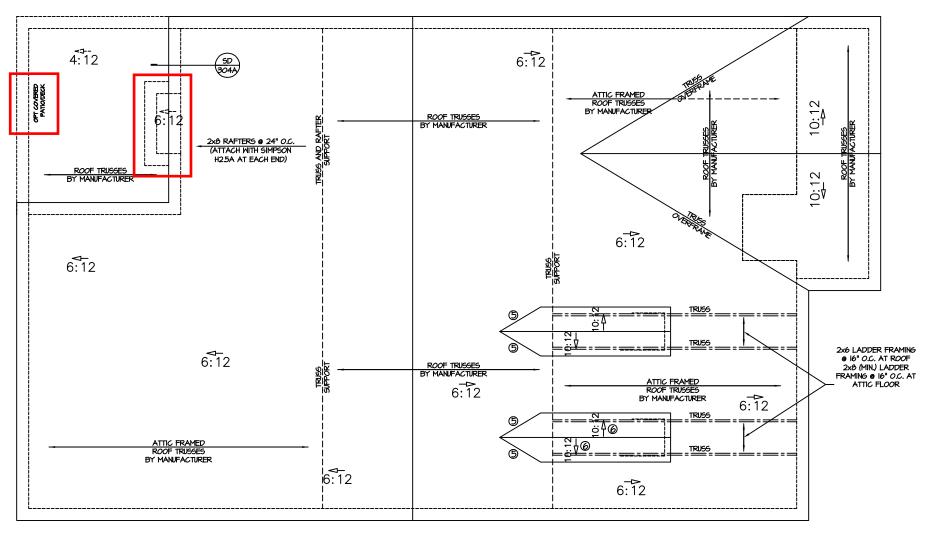
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DESIGNS AJ

NEW HOME, IN Garage Left Plan 01



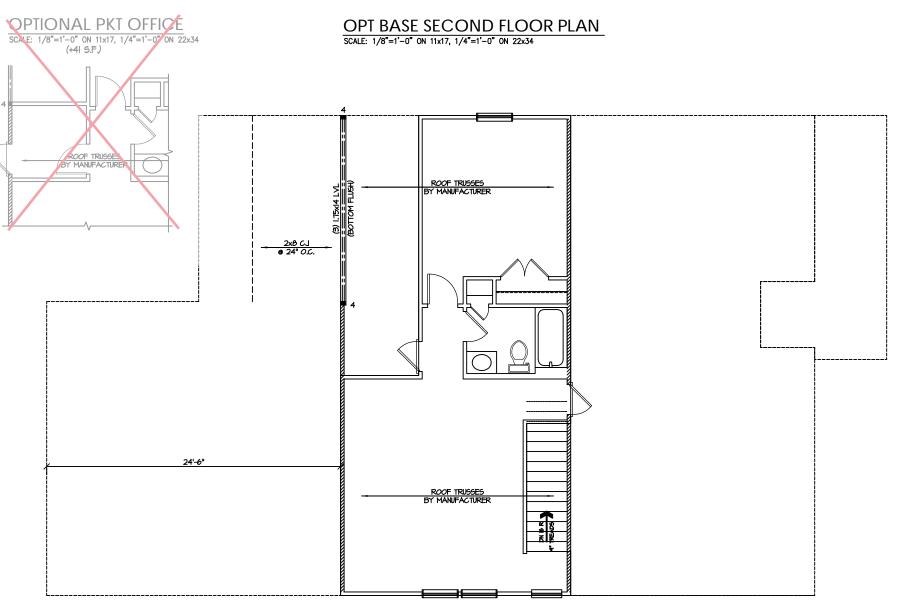

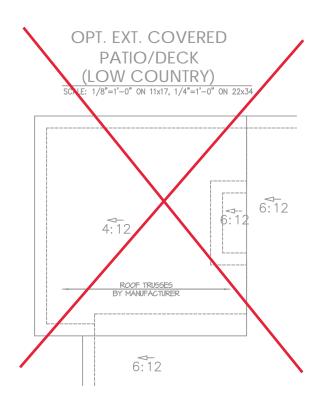

'LOW COUNTRY' ROOF FRAMING PLAN SCALE: 1/8"=1'-0" ON 11x17, 1/4"=1'-0" ON 22x34

WITH 2nd FOOR


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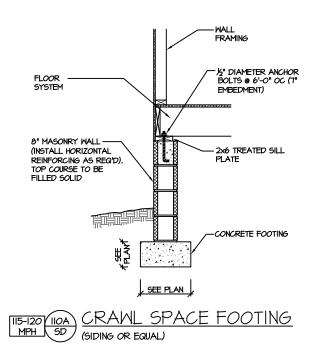
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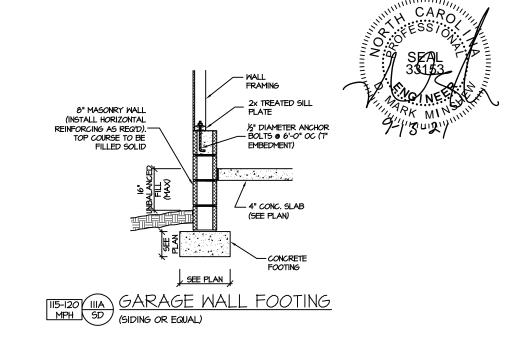
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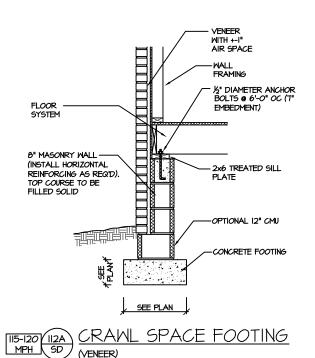
NEW HOME, INC. Plan 01 Garage Left


S-5.1








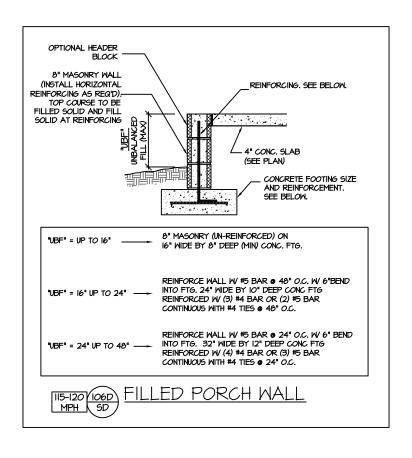

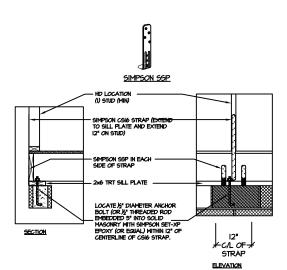

BRACED WALL END CONDITION " HD" HOLD-DOWN DETAIL

NOTE: SIMPSON DTT-IZ IS ACCEPTABLE ALTERNATE NOTE: ALTERNATE HD HOLD-DOWN DEVICES OR SYSTEMS MAY BE USED TO MEET THE CODE REQUIRED 800 LB CAPACITY IN LIEU OF THE ABOVE DETAIL.

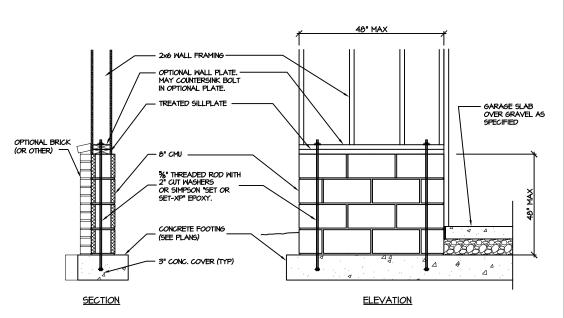

GARAGE 'WING WALL' REINFORCING PER IRC FIGURE R602.IO.4.3

CRAWL SPACE FOUNDATION

PROJECT # 21-2967

nt.

3. not include construction means, methods, lechniques, es, procedures or safety precautions.


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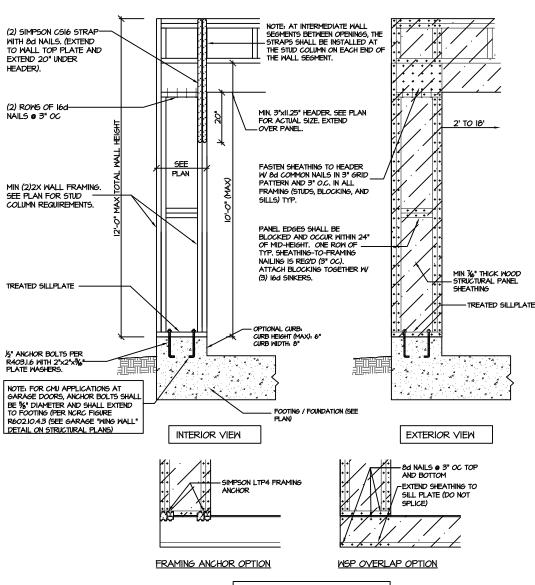
> **DESIGNS** AJ

NEW HOME, INC. 01 PLAN

SD



CS-PF: END CONDITION DETAIL (FOR USE WITH SINGLE CS-PF CONDITION) DETAIL AND APPLICATION BASED ON NORC FIGURE R602.IO.I - PORTAL FRAME CONSTRUCTION

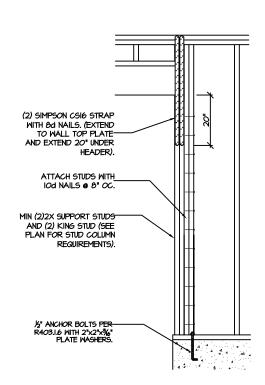

CS-PF - OVER WOOD FLOOR

CS-PF: CONTINUOUS PORTAL FRAME CONSTRUCTION DETAIL AND APPLICATION BASED ON NORC FIGURE R602.IO.I - PORTAL FRAME CONSTRUCTION



STRUCTURAL NOTES NC (2018 NCRC): Wind: 115-120 mph

- ENGINEER'S SEAL APPLIES ONLY TO STRUCTURAL COMPONENTS INCLUDING ROOF RAFTERS, HIPS, ENGINEER'S SEAL APPLIES ONLY TO STRUCTURAL COMPONENTS INCLUDING ROOF RAFTERS, HIPS, VALLEYS, RIDGES, FLOORS, WALLS, BEANS AND HEADERS, COLUMNS, CANTILEVERS, OFFSET LOAD BEARING WALLS, PIER & GIRDER SYSTEM, FOOTING, AND PILING SYSTEM. ENGINEER'S SEAL DOES NOT CERTIFY DIMENSIONAL ACCURACY OR ARCHITECTURAL LAYOUT INCLUDING ROOF SYSTEM. ALL REQUIREMENTS FOR PROFESSIONAL CERTIFICATION SHALL BE PROVIDED BY THE APPROPRIATE PROFESSIONAL. SOUTHERN ENGINEERS, P.A. CERTIFIES ONLY THE STRUCTURAL COMPONENTS AS SPECIFICALLY STATED.
- 2. ALL CONSTRUCTION SHALL CONFORM TO THE LATEST REQUIREMENTS OF THE 2018 NC RESIDENTIAL CODE, PLUS ALL LOCAL CODES AND REGULATIONS. THE STRUCTURAL ENGINEER IS NOT RESPONSIBLE FOR, AND WILL NOT HAVE CONTROL OF, CONSTRUCTION MEANS, METHODS, TECHNIQUES, SEQUENCES OR PROCEDURES, OR FOR SAFETY PRECAUTIONS AND PROGRAMS IN CONNECTION WITH THE CONSTRUCTION WORK, NOR WILL THE ENGINEER BE RESPONSIBLE FOR THE CONTRACTOR'S FAILURE TO CARRY OUT THE CONSTRUCTION WORK IN ACCORDANCE WITH THE CONTRACT DOCUMENTS, "CONSTRUCTION REVIEW" SERVICES ARE NOT PART OF OUR CONTRACT. ALL MEMBERS SHALL BE FRAMED ANCHORED, TIED AND BRACED IN ACCORDANCE WITH GOOD CONSTRUCTION PRACTICE AND THE BUILDING CODE.
- DESIGN LOADS (LISTED AS: LIVE LOAD, DEAD LOAD, DEFLECTION) ROOMS OTHER THAN SLEEPING ROOMS: (40 PSF, 10 PSF, L/360)
- SLEEPING ROOMS: (30 PSF, IO PSF, L/360)
- ATTIC WITH PERMANENT STAIR: (40 PSF. IO PSF. L/360) ATTIC WITHOUT PERMANENT STAIR: (20 PSF, IO PSF, L/360)
- ATTIC WITHOUT STORAGE: (10 PSF, 10 PSF, L/240)
- STAIRS: (40 PSF, IO PSF, L/360) EXTERIOR BALCONIES: (60 PSF, IO PSF, L/360)
- DECKS: (40 PSF, 10 PSF, L/360)
- GUARDRAILS AND HANDRAILS: (200 LBS)
 PASSSENGER VEHICLE GARAGES: (50 PSF, IO PSF, L/360)
- FIRE ESCAPES: (40 PSF, 10 PSF, L/360)
- SNOW: (20 PSF)
- WALLS SHALL BE BRACED BY SHEATHING WALLS ON ALL STORIES WITH WOOD STRUCTURAL PANELS. SEE FRAMING NOTES FOR THICKNESS AND NAILING REQUIREMENTS.
- 5. SEE APPENDIX M (DCA6) FOR EXTERIOR DECK REQUIREMENTS INCLUDING ATTACHMENTS FOR LATERAL LOADS.
- CONCRETE SHALL HAVE A MINIMUM 28 DAY STRENGTH OF 3000 PSI AND A MAXIMUM SLUMP OF 5 INCHES UNLESS NOTED OTHERWISE (UNO). AIR ENTRAINED PER TABLE 402.2. ALL CONCRETE SHALL BE PROPORTIONED, MIXED, HANDLED, SAMPLED, TESTED, AND PLACED IN ACCORDANCE WITH ACI STANDARDS, ALL SAMPLES FOR PUMPING SHALL BE TAKEN FROM THE EXIT END OF THE PUMP. CONTROL JOINTS IN SLABS SHALL BE SPACED ON A GRID OF +-30 TIMES THE DEPTH (D). CONTROL JOINTS SHALL BE SAWCUT TO A DEPTH OF I/D. (I.E. 4" CONCRETE SLABS SHALL HAVE 1/4" DEEP CONTROL JOINTS SAWCUT IN SLAB ON A +-10'-0" x +-10'-0" GRID).
- 7. ALLOWABLE SOIL BEARING PRESSURE ASSUMED TO BE 2000 PSF. THE CONTRACTOR MUST CONTACT A GEOTECHNICAL ENGINEER AND THE STRUCTURAL ENGINEER IF UNGATISFACTORY SUBSURFACE CONDITIONS ARE ENCOUNTERED. THE SURFACE AREA ADJACENT TO THE FOUNDATION WALL SHALL BE PROVIDED WITH ADEQUATE DRAINAGE, AND SHALL BE GRADED 50 AS TO DRAIN SURFACE WATER AWAY FROM FOUNDATION WALLS.
- 8. ALL FRAMING LUMBER SHALL BE SPF #2 (Fb = 875 PSI) UNLESS NOTED OTHERNISE (UNO). ALL TREATED LUMBER SHALL BE SYP # 2. PLATE MATERIAL MAY BE SPF # 3 OR SYP #3 (Fc(perp) =
- 9.
 L.V.L. SHALL BE LAMINATED VENEER LUMBER: Fb=2600 PSI, Fv=265 PSI, E=1.9xi0 PSI.

 9.
 P.S.L. SHALL BE PARALLEL STRAND LUMBER: Fb=2900 PSI, Fv=290 PSI, E=2.0xi0 PSI.

 9.
 L.S.L. SHALL BE LAMINATED STRAND LUMBER: Fb=2250 PSI, Fv=400 PSI, E=1.55xi0 PSI.
 INSTALL ALL CONNECTIONS PER MANUFACTURERS INSTRUCTIONS
- IO. ALL ROOF TRUSS AND I-JOIST LAYOUTS SHALL BE PREPARED IN ACCORDANCE WITH THE SEALED STRUCTURAL DRAWINGS, TRUSSES AND I-JOISTS SHALL BE INSTALLED ACCORDING TO THE MANUFACTURE'S SPECIFICATIONS, ANY CHANGE IN TRUSS OR I-JOIST LAYOUT SHALL BE
- ALL STRUCTURAL STEEL SHALL BE ASTM A-36. STEEL BEAMS SHALL BE SUPPORTED AT EACH END WITH A MINIMUM BEARING LENGTH OF 3 1/2" INCHES AND FULL FLANGE WIDTH, PROVIDE SOLID BEARING FROM BEAM SUPPORT TO FOUNDATION. BEAMS SHALL BE ATTACHED TO EACH SUPPORT WITH TWO LAG SCREWS (I/2" DIAMETER x 4" LONG), LATERAL SUPPORT IS CONSIDERED SUPPORT WITH TWO LAG SECTION (1/2 DIAMETERS X + LONG), L'ALERAL SUPPORT IS COMMITTED ADEQUATE PROVIDING THE JOILE PLATE AND SOILE PLATE IS NAILED OR BOLTED TO THE BEAM FLANGE • 48" O.C. ALL STEEL TUBING SHALL BE ASTM A500.
- 12. REBAR SHALL BE DEFORMED STEEL, ASTM615, GRADE 60. LAP ALL REBAR SPLICES 30 BAR
- 13. FLITCH BEAMS SHALL BE BOLTED TOGETHER USING (2) ROWS OF 1/2" DIAMETER BOLTS (ASTM A325) WITH WASHERS PLACED UNDER THE THREADED END OF BOLT. BOLTS SHALL BE SPACED AT 24" O.C. (MAX), AND STAGGERED AT THE TOP AND BOTTOM OF BEAM (2" EDGE DISTANCE), WITH 2 BOLTS LOCATED AT 6" FROM EACH END.
- 14. BRICK LINTELS (WHEN REQUIRED) SHALL BE 3 1/2"x3 1/2"x1/4" STEEL ANGLE FOR UP TO 6'-0" SPAN AND 6"x4"x5/16" STEEL ANGLE WITH 6" LEG VERTICAL FOR SPANS UP TO 9"-0". SEE PLANS FOR SPANS OVER 9"-0". SEE ALSO SECTION RTO3.8.3 LINTELS.

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PROJECT # 21-2967

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