

PLAN: Wyatt W/ Porch

ELEVATIONS

PROJECT ADDRESS: 83 Rush Ln. Liberty Meadows Lot 62

Precision Custom Hom Raeford, NC n@PrecisionCustomHom

DATE:


12/20/23


SCALE:

1/4" = 1'


SHEET:

A-1

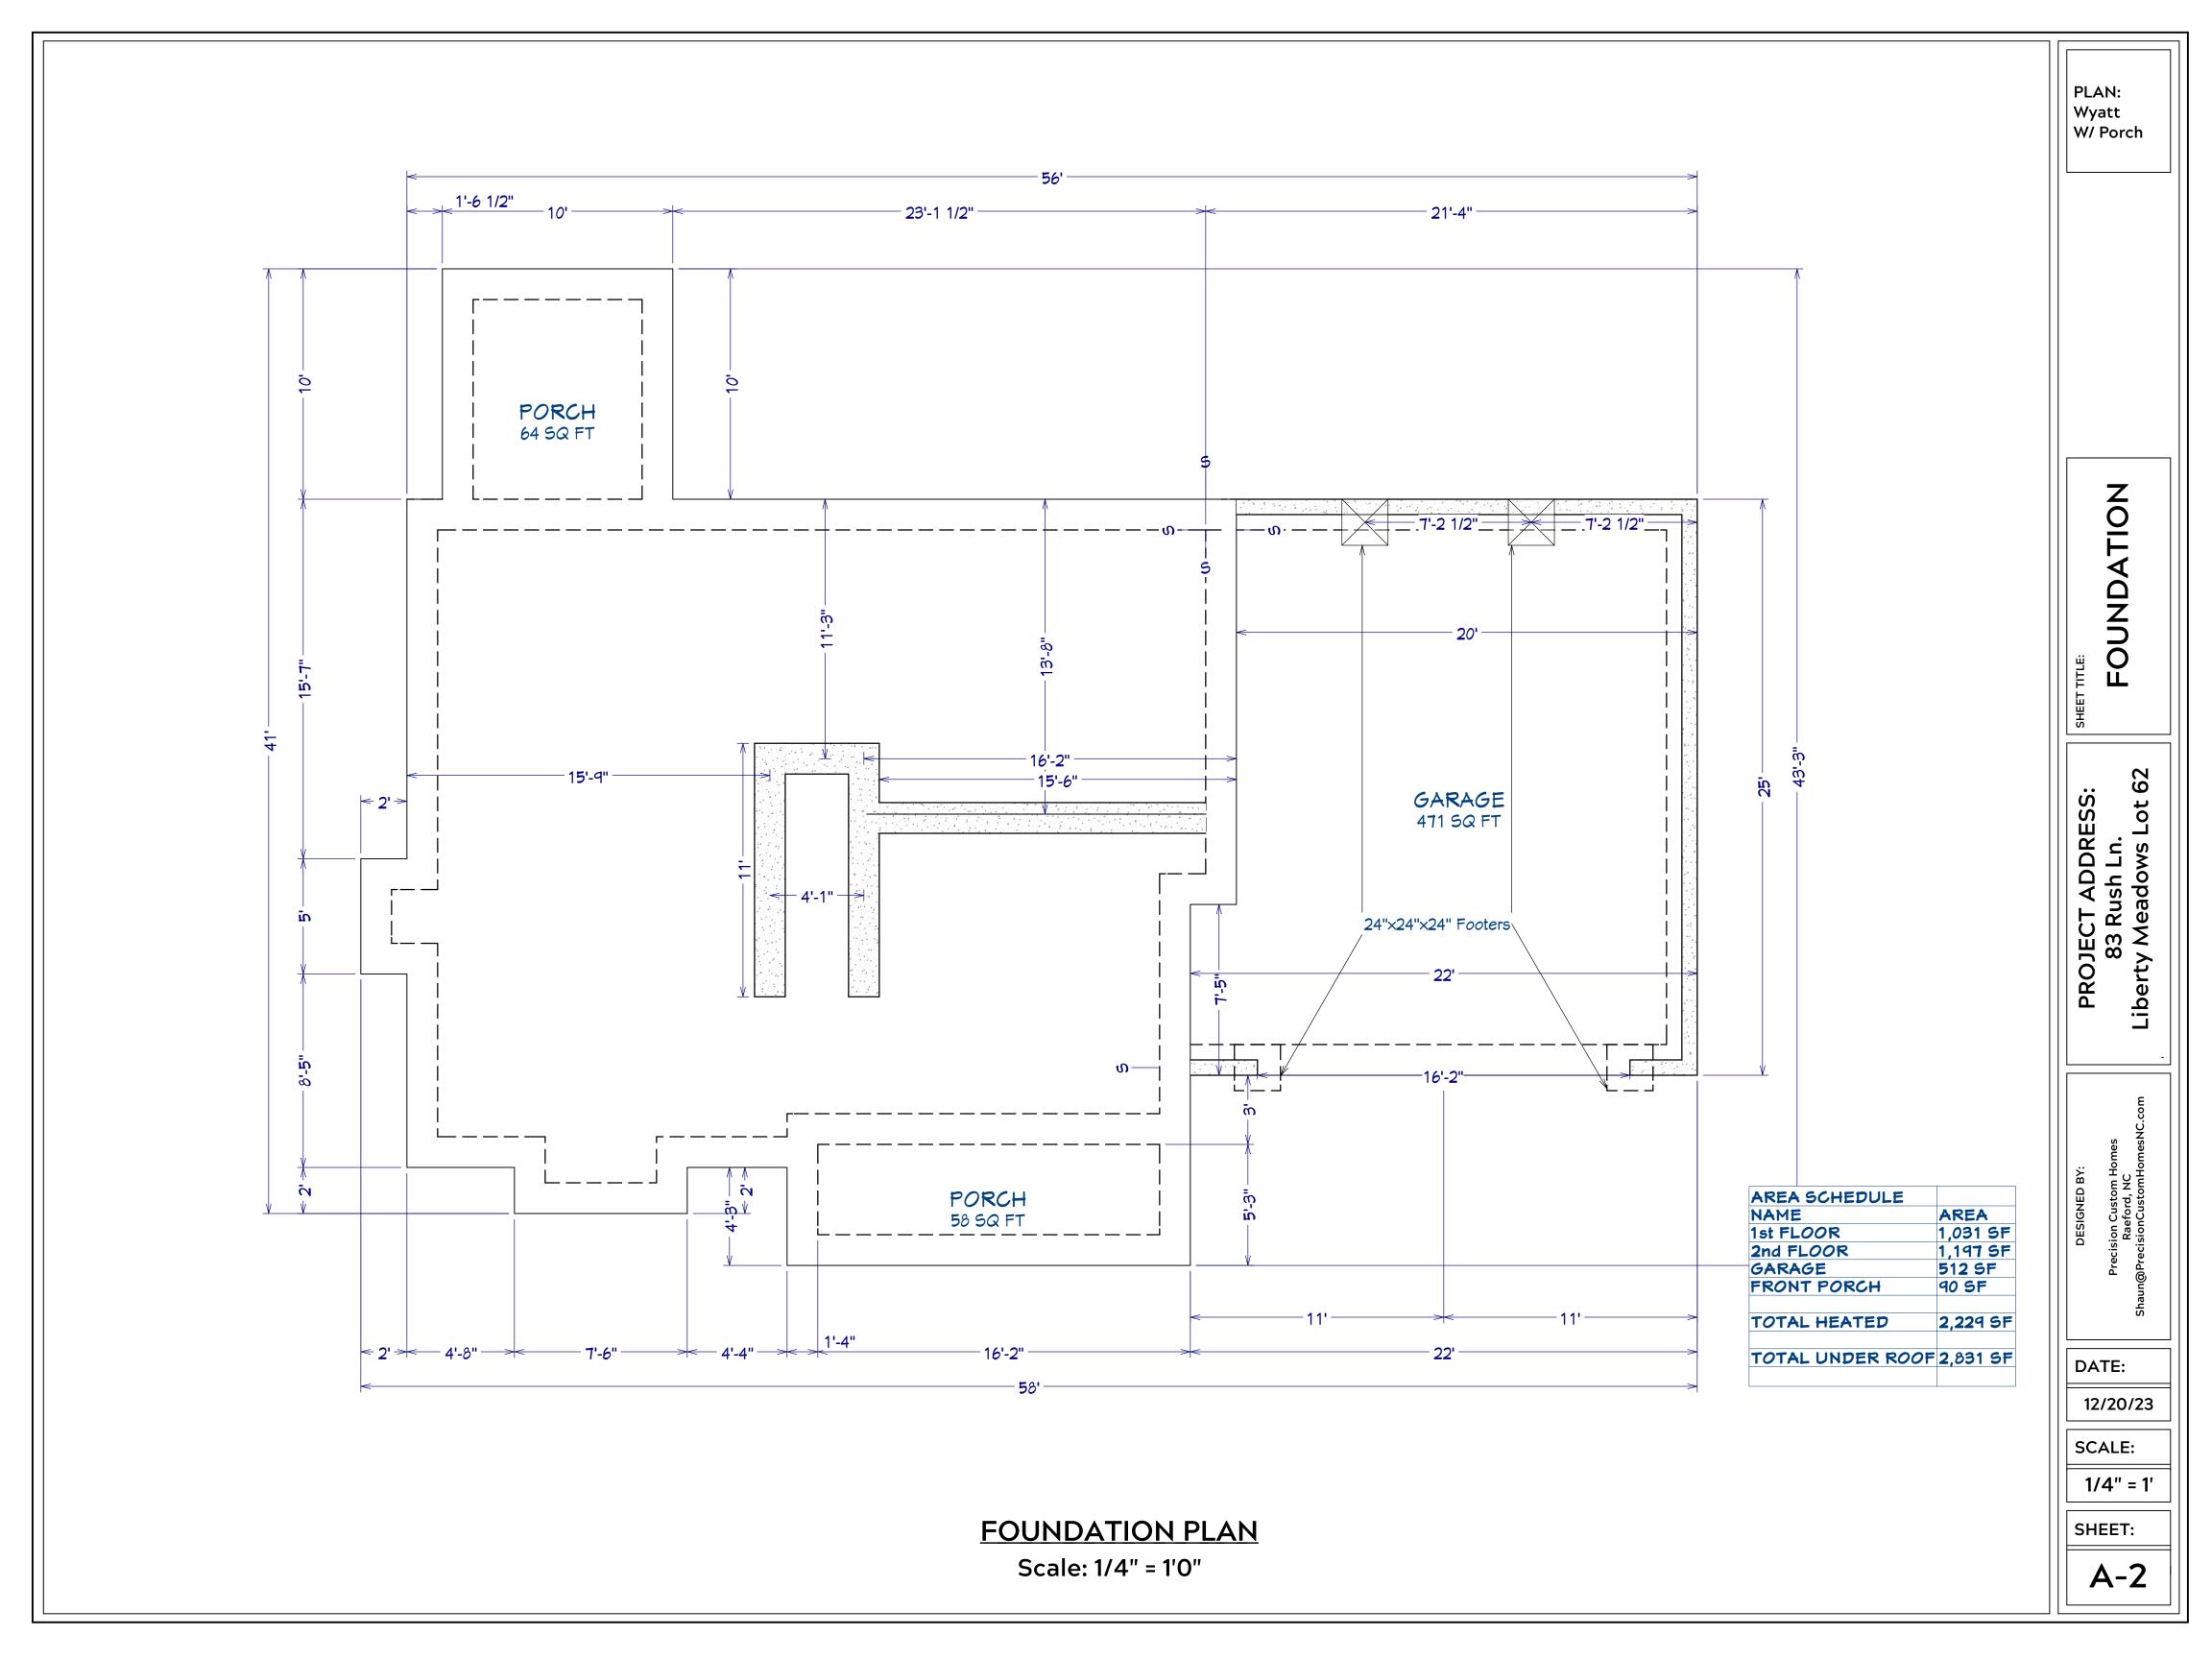


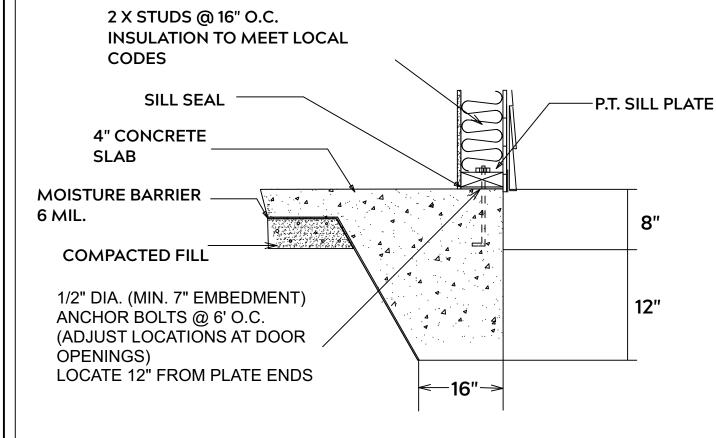

MONOLITHIC SLAB

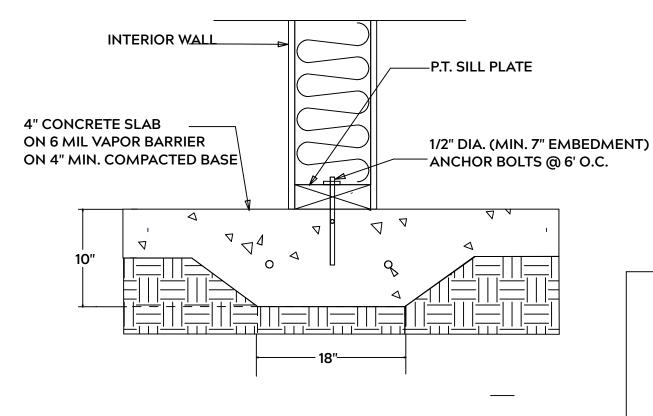

LUG FOOTING

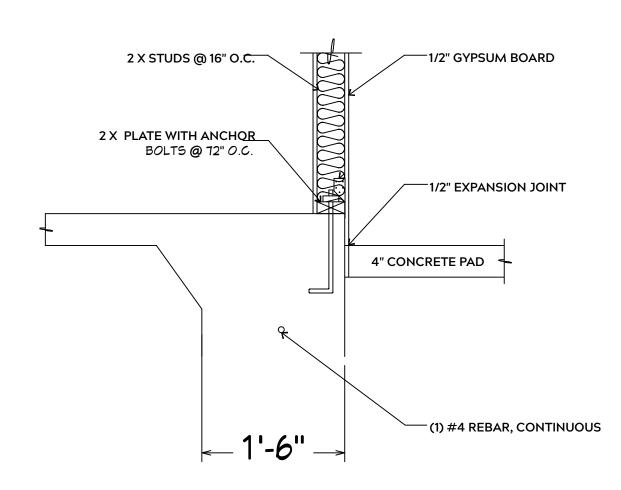

FOUNDATION NOTES:

GENERAL FRAMING NOTES:

TO ITS ORIGINAL CAPACITY

AND USE 3 X 16d NAILS 2" IN AT EACH END.

PRESSURE TREATED

AND / OR KILN DRIED

ENGINEER

TREATED

ALL FOOTINGS SHALL BEAR ON ORIGINAL UNDISTURBED SOIL THE 28 DAY COMPRESSIVE STRENGTH OF ALL FOOTINGS IS 3000 PSI

PROVIDE WATER PROOFING AND PERIMTER DRAINS AS REQUIRED

FOOTING WIDTHS ARE BASED ON A LOAD BEARING SOIL CAPACITY OF 2000 PSI

PROVIDE 6 MIL POLY VAPOR BARRIER TO COVER GROUND IN CRAWL SPACE AND GROUND UNDER POURED CONCRETE

ALL ANCHOR BOLTS TO BE 1/2" X 12" LONG.
ANCHOR BOLTS SHALL BE SPACED AT A
MAXIMUM OF 6' ON CENTER AND NO MORE
THEN 1' FROM EACH CORNER

ALL LUMBER IN CONTACT WITH CONCRETE OR MASONRY SHALLE BE

FRAMING LUMBER SHALL BE SYP #2 GRADE AND / OR SPRUCE PINE FIR #1

SHALL PROVIDE DRAWINGS / SCHEMATICS, WHICH SHALL BEAR OF A N.C.

STUDS AND JOISTS SHALL NOT BE CUT TO INSTALL PLUMBING OR WIRING

NAIL MULTIPLE MEMBERS WITH 2 ROWS OF 16d NAILS STAGGERED 32" O.C.

ALL FRAMING TO BE 16" O.C. WALL FRAMING DIMENSIONS ARE BASED ON 2X4

OR 2X6 EXTERIOR WALLS AND 2X4 INTERIOR WALLS. DOULBE / TRIPLE JACK

ALL EXPOSED FRAMING ON PORCHES OR DECKS SHALL BE PRESSURE

NAIL FLOOR JOISTS TO SILL PLATE WITH WITH 8d TOE NAILS


PROVIDE WATERPROOFING AND DRAINS AS REQUIRED

STUDS AS NECESSARY UNDER HEADERS AS REQUIRED

LVL'S TO BE SIZED BY OTHERS (TRUSS MANUFACTURER)


WITHOUT ADDING METAL OR WOOD SIDE PANELS TO STRENGTHEN MEMBER

WHERE PRE-ENGINEERED JOISTS AND TRUSSES ARE USED, MANUFACTURER

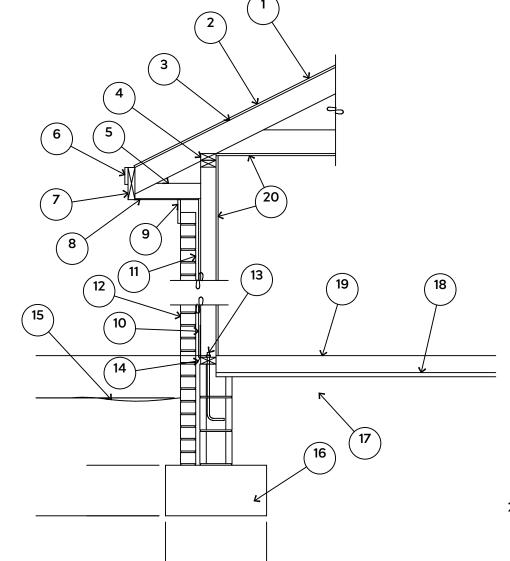

- 1. 15# FELT UNDERLAYMENT UNDER COMPOSITION SHINGLES.
- 2. ROOF DECKING.
- 3. 2 X RAFTERS / ENGINEERED TRUSSES
- 4. DOUBLE TOP PLATE.5. 2 X 4 RETURN.
- 6. 3/4" FASCIA OR PVC TRIM COIL
- 7 2 V EASCIA
- 7. 2 X FASCIA
- 1/4" PLYWOOD OR VINYL SOFFIT
 1X FREIZE BOARD (TO BE USED WITH BRICK VENEERS)
- 10. INSULATION BOARD OR HOUSE WRAP
- 11. AIR SPACE.
- 12 BRICK WITH BRICK TIES PER MANUFACTURER'S SPECIFICATIONS.
- 13. 1/2" X 12" ANCHOR BOLTS, 6'-0" O.C., 12" FROM CORNERS.
- 14. FLASHING WITH WEEP HOLES @ 48" O.C.
- 48° O.C. 15. FINISHED GRADE.
- 16. FOOTING
- 17. COMPACTED EARTH FILL
- 18. 6 MIL. VAPOR BARRIER
- 19. 4" CONCRETE SLAB, 3,000 P.S.I. WITH 6" X 6" 10 GA. X 10 GA. WELDED WIRE FABRIC.
- 20. 1/2" GYPSUM BOARD.

EXTERIOR WALL SECTION

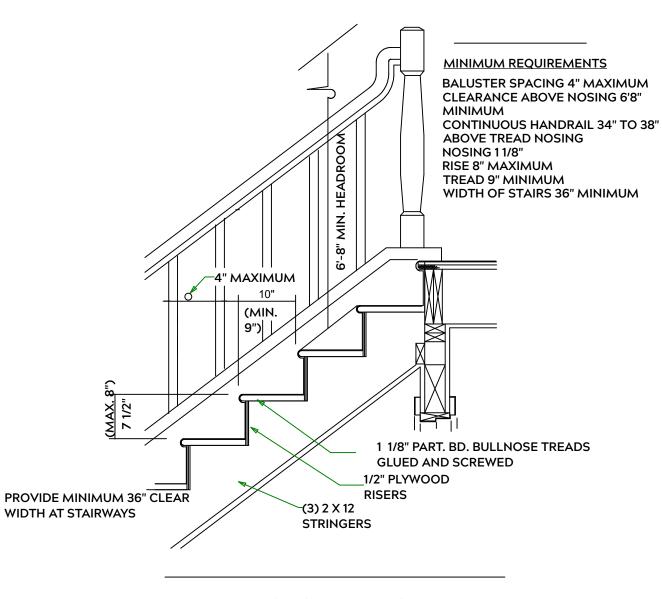

STAIR DETAIL

INTERIOR WALL @ GARAGE STEP DOWN

PLAN: Wyatt W/ Porch

ETAIL SHEETS

ADDRESS: SHEE ISH Ln. D Adows Lot 62

PROJECT ADDRI 83 Rush Ln. Liberty Meadows I

> Precision Custom Homes Raeford, NC @PrecisionCustomHomesNC.cor

DATE:


12/20/23

SCALE:

1/4" = 1'

SHEET:

A-3

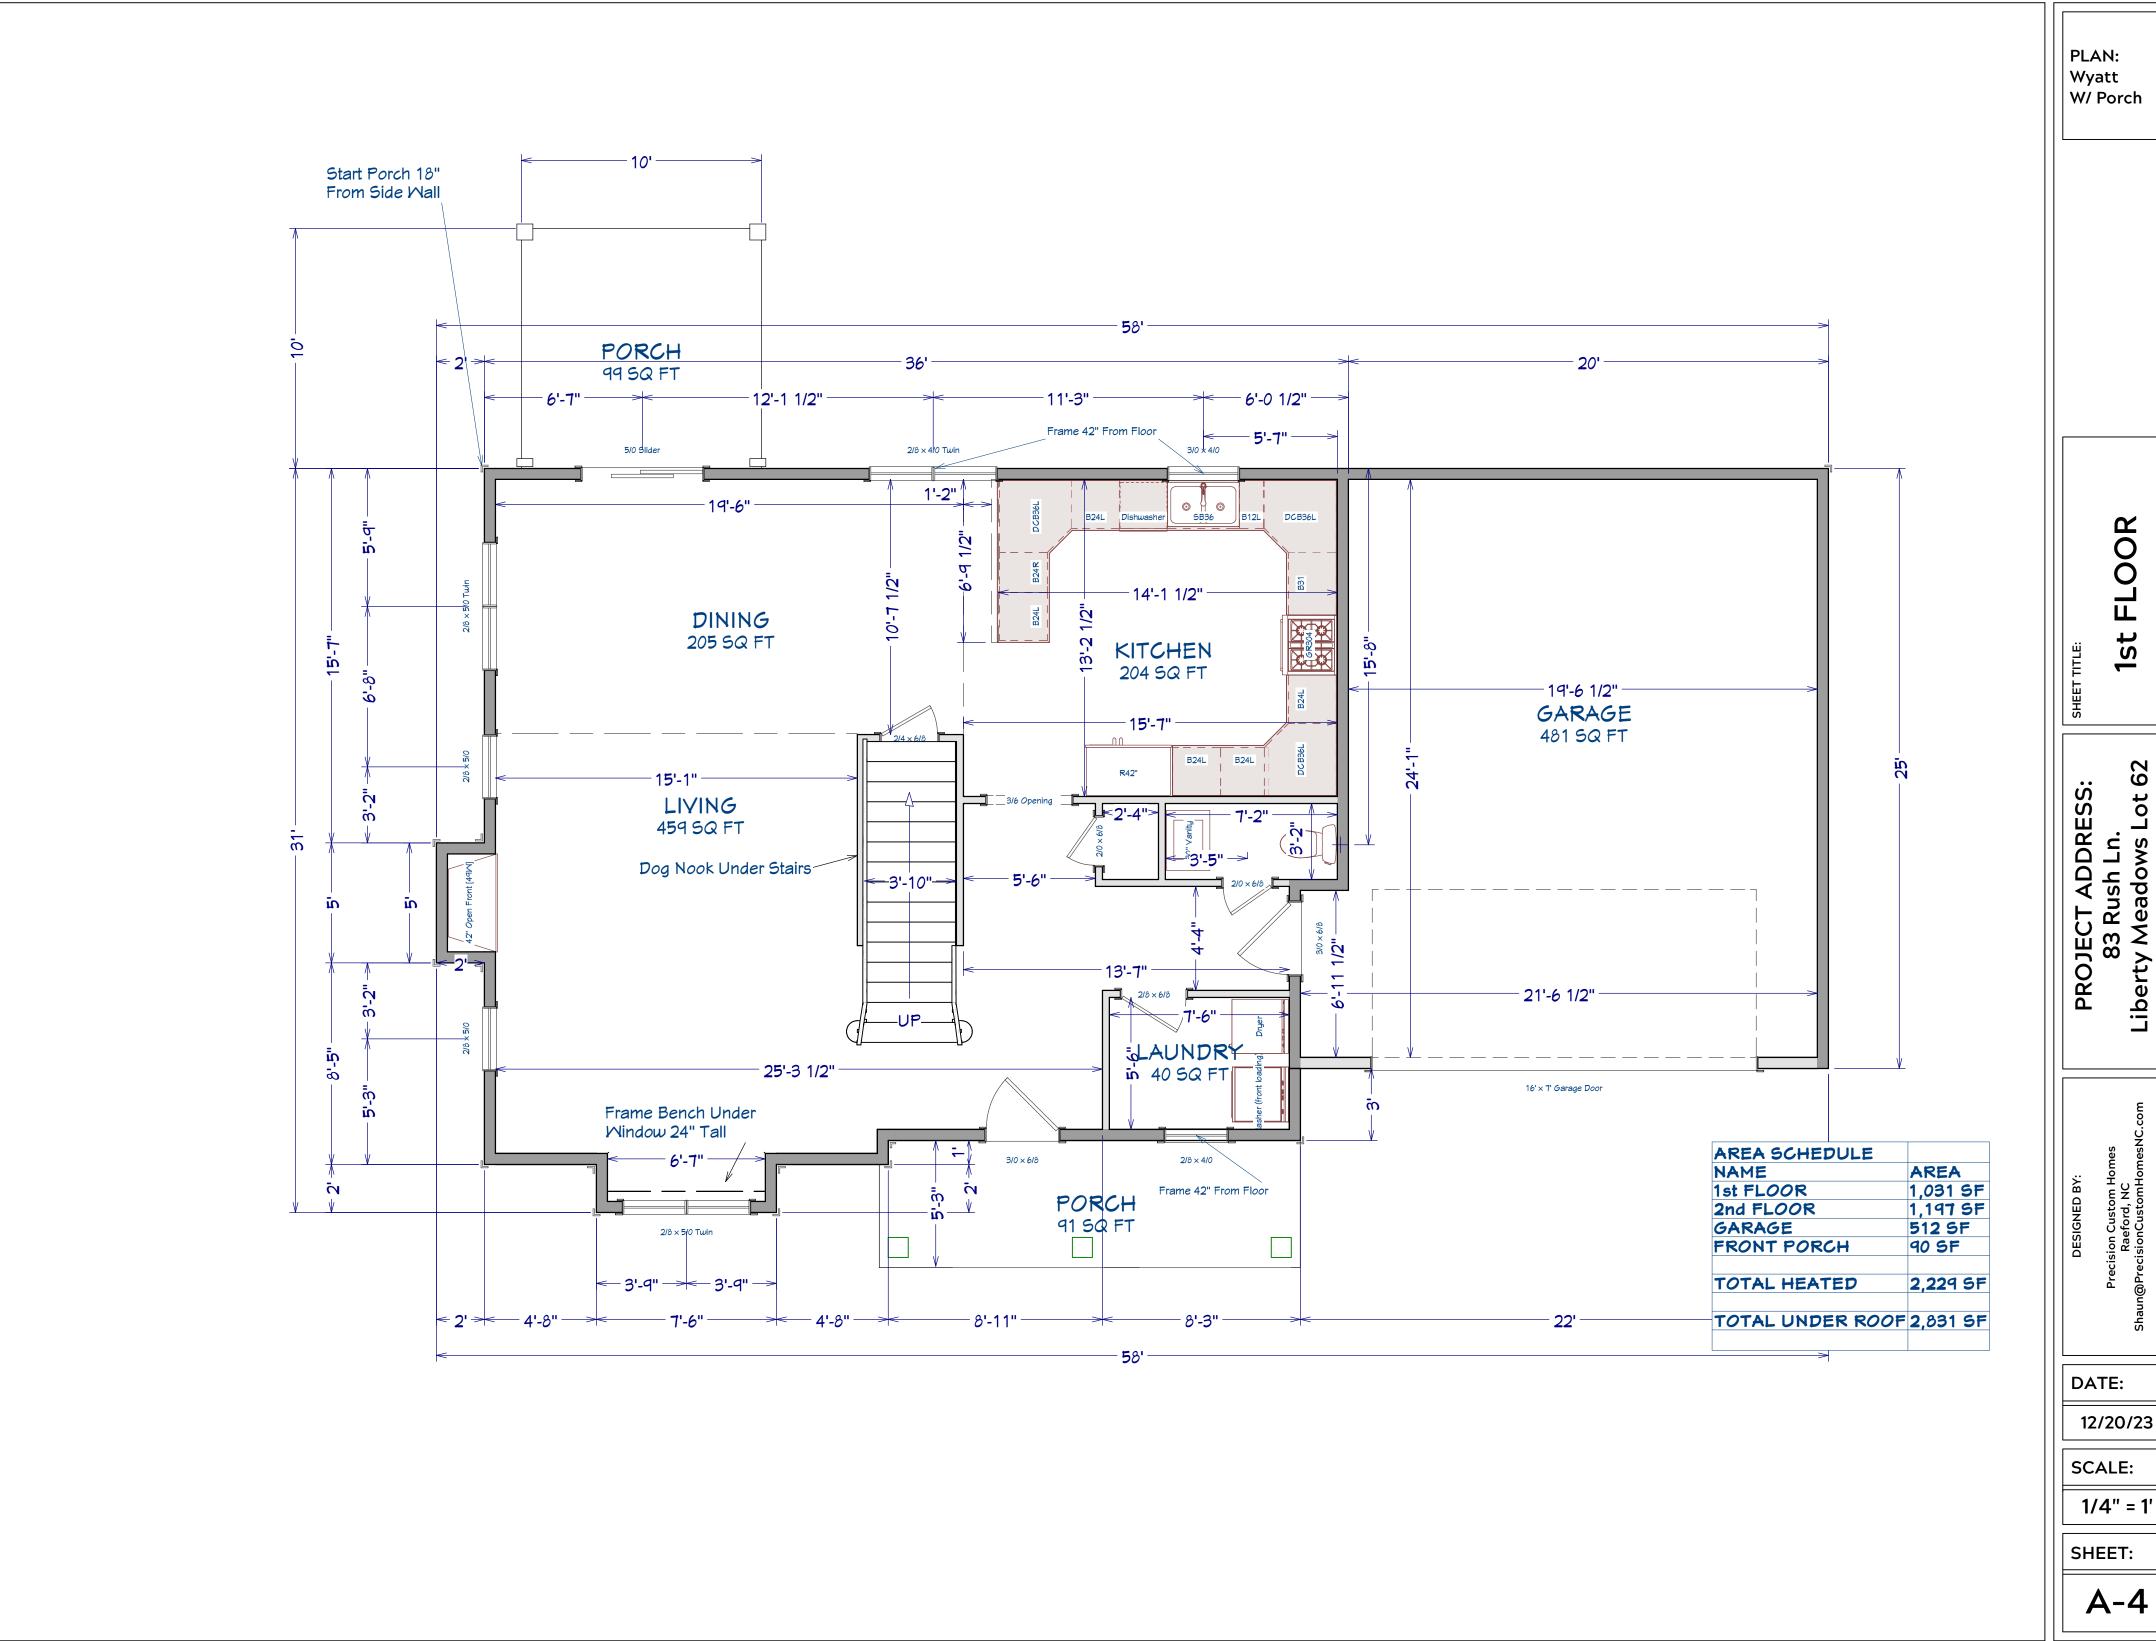

PLAN: Wyatt W/ Porch

1st FLOOR

PROJECT ADDRESS: 83 Rush Ln. Liberty Meadows Lot 62


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DATE:


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A-4



Precision Custom Hom Raeford, NC n@PrecisionCustomHom



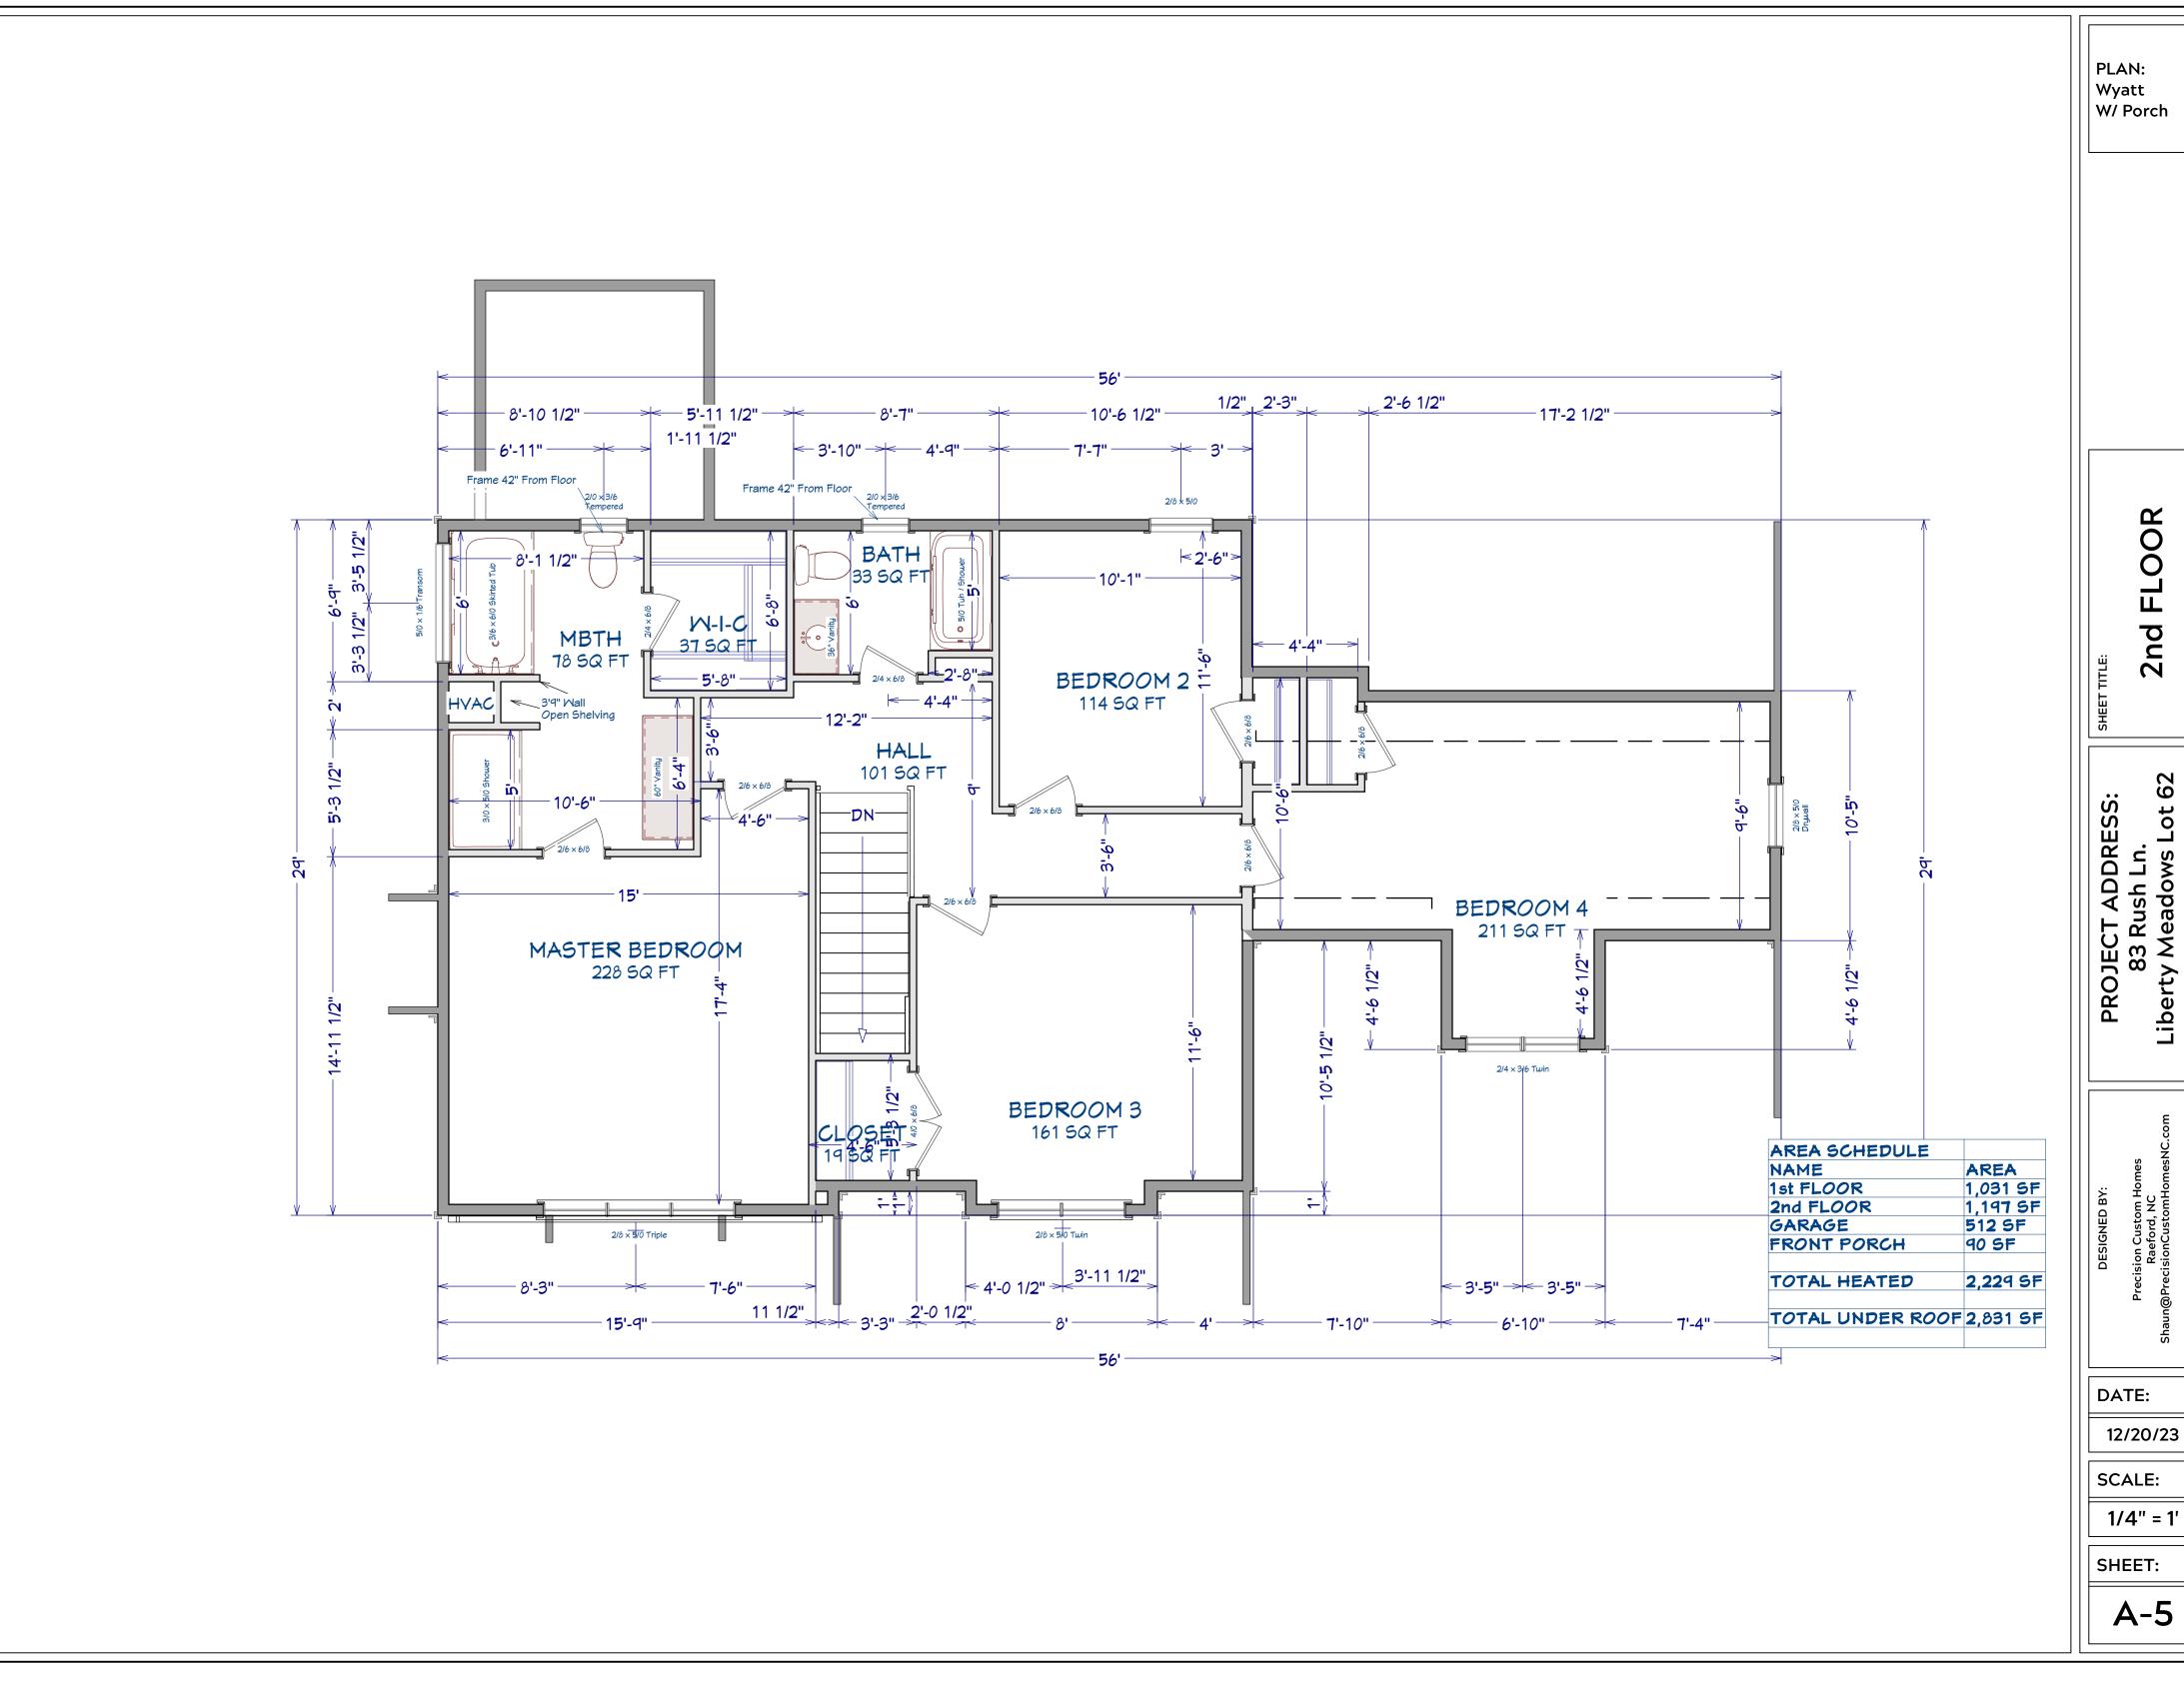

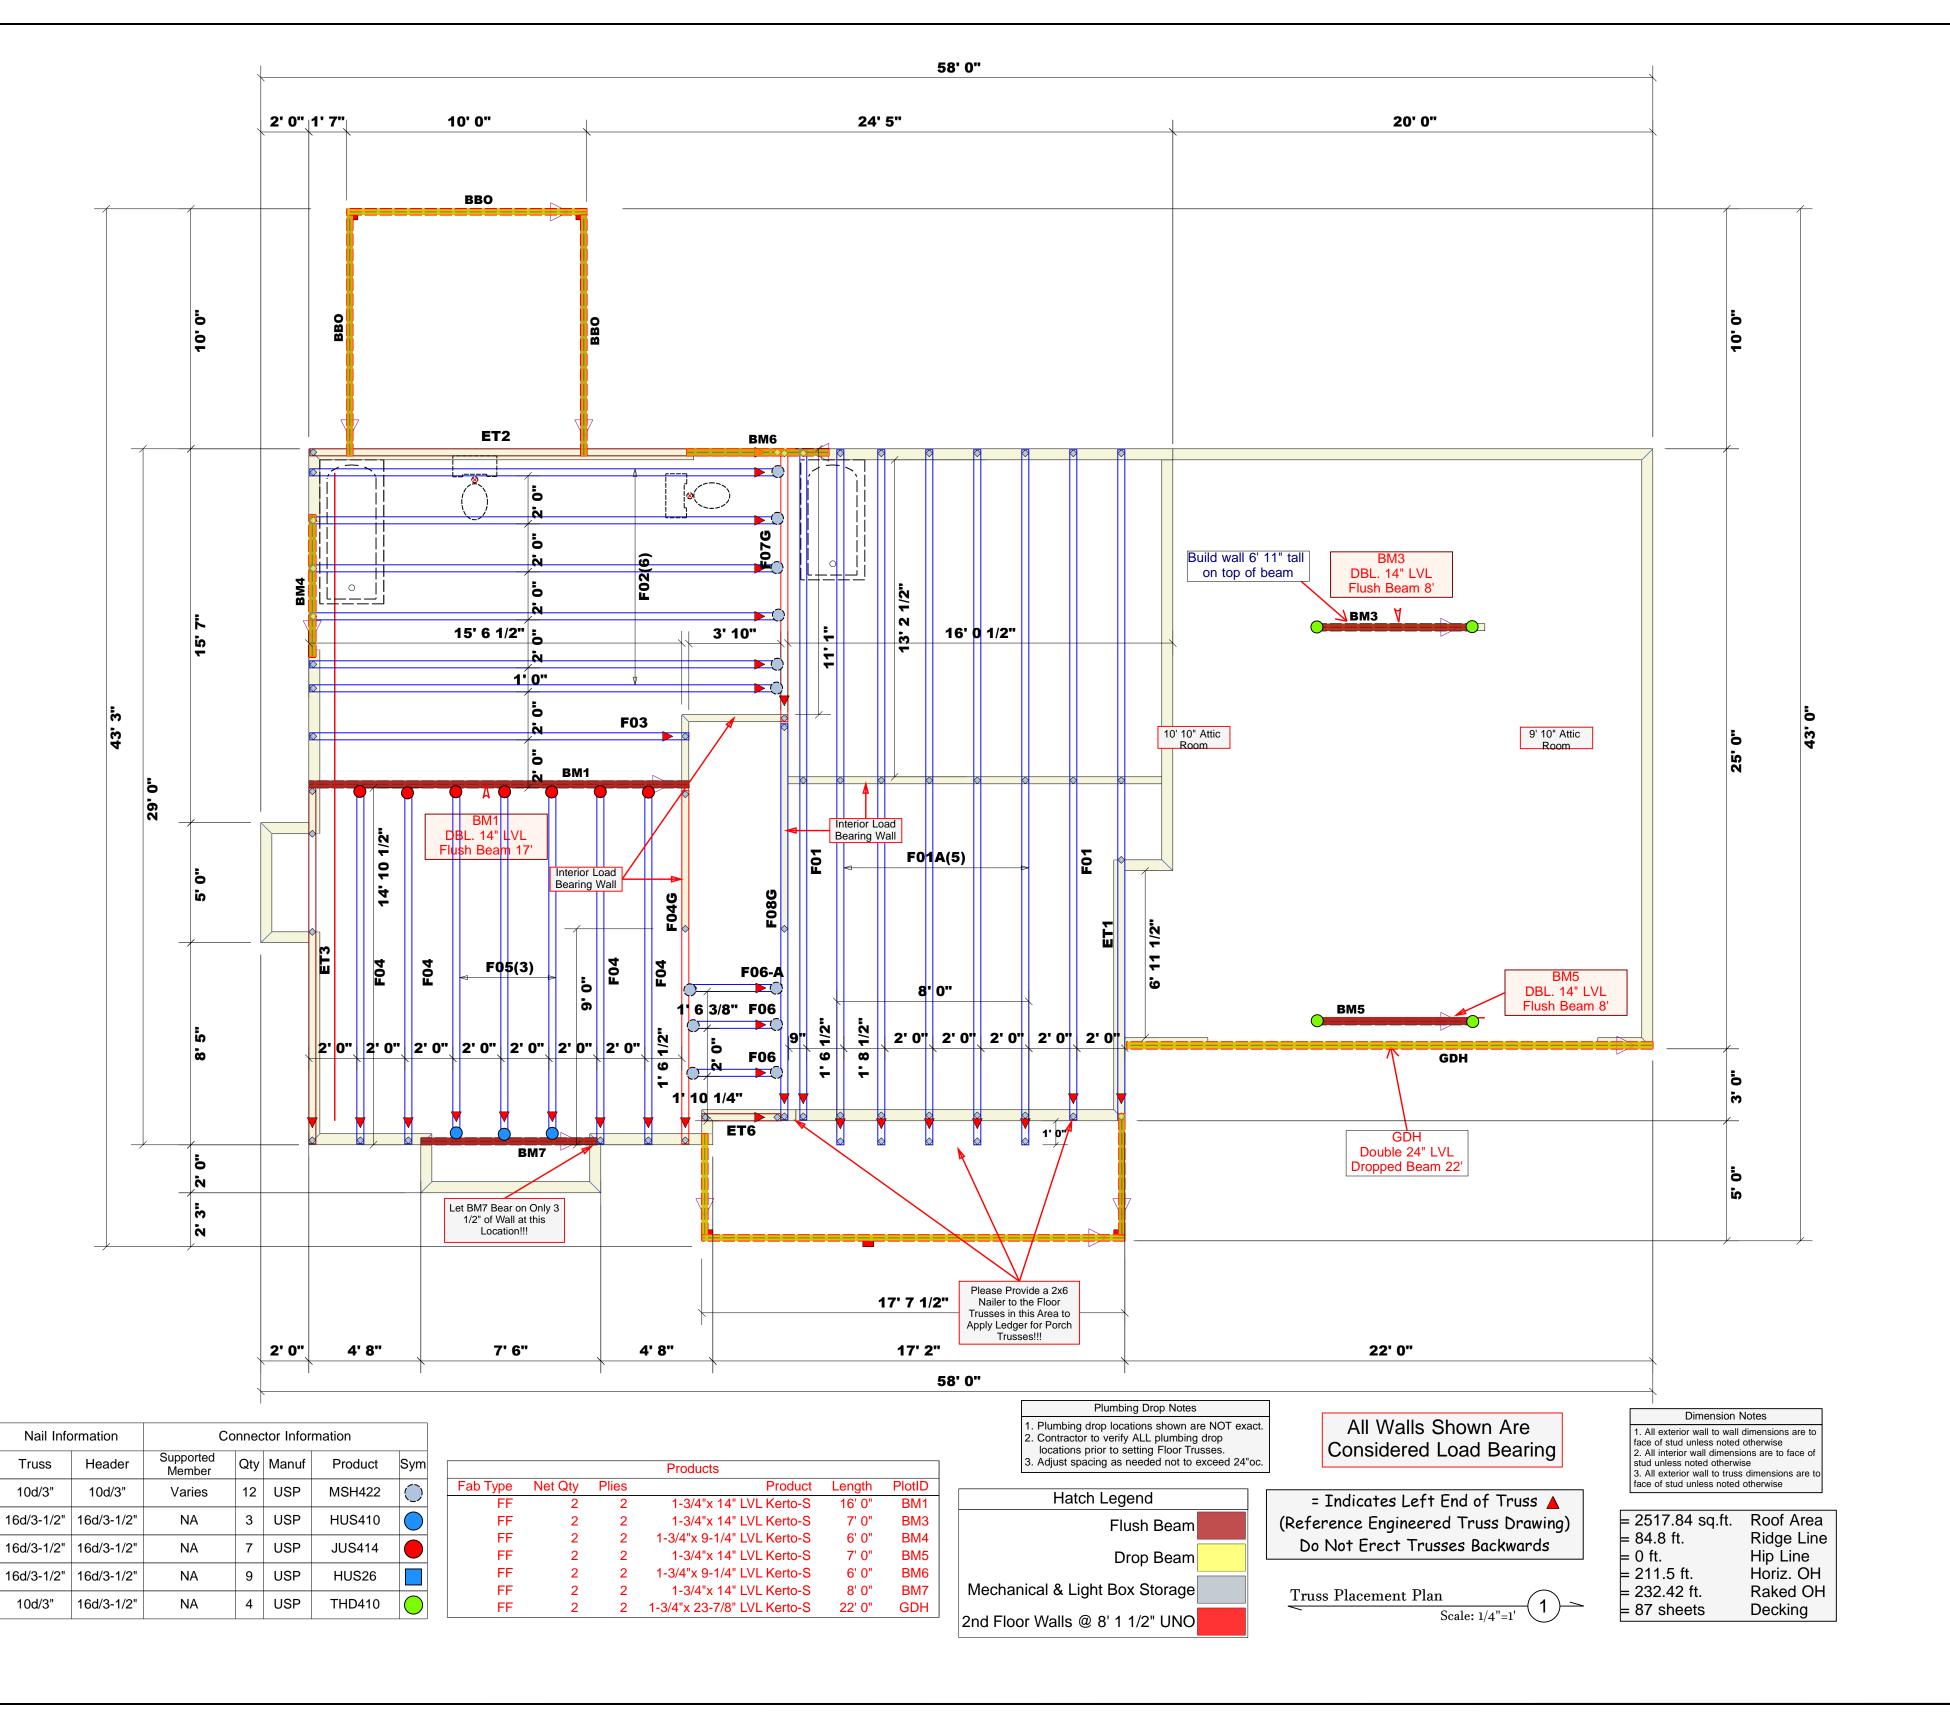Reilly Road Industrial Park Fayetteville, N.C. 28309 Phone: (910) 864-8787 Fax: (910) 864-4444

aring reactions less than or equal to 3000# are emed to comply with the prescriptive Code quirements. The contractor shall refer to the ached Tables (derived from the prescriptive

Neil Baggett

LOAD CHART FOR JACK STUDS (BASED ON TABLES R502.5(1) & (b))

Harnett	83 Rush Lane, Cameron, NC	Floor	11/21/2023	DRAWN BY Neil Baggett	SALESMAN Neil Baggett
COUNTY	ADDRESS	MODEL	DATE REV.	DRAWN BY	SALESMAN
Precision Custom Homes & Renovations	Lot 62 Liberty Meadows	Wyatt 2.0 w/CP	N/A	N/A	J0923-5137

THIS IS A TRUSS PLACEMENT DIAGRAM ONLY. THIS IS A TRUSS PLACEMENT DIAGRAM ONLY. These trusses are designed as individual building components to be incorporated into the building design at the specification of the building designer. See individual design sheets for each truss design identified on the placement drawing. The building designer is responsible for temporary and permanent bracing of the roof and floor system and for the overall structure. The design of the truss support structure including headers, beams, walls, and columns is the responsibility of the building designer. For general guidance regarding bracing, consult BCSI-B1 and BCSI-B3 provided with the truss delivery package or online @ sbcindustry.com

russ delivery package or online @ sbcindustry.co

PLAN


SEAL DATE

QUOTE;

NAME

JOB

BUILDER

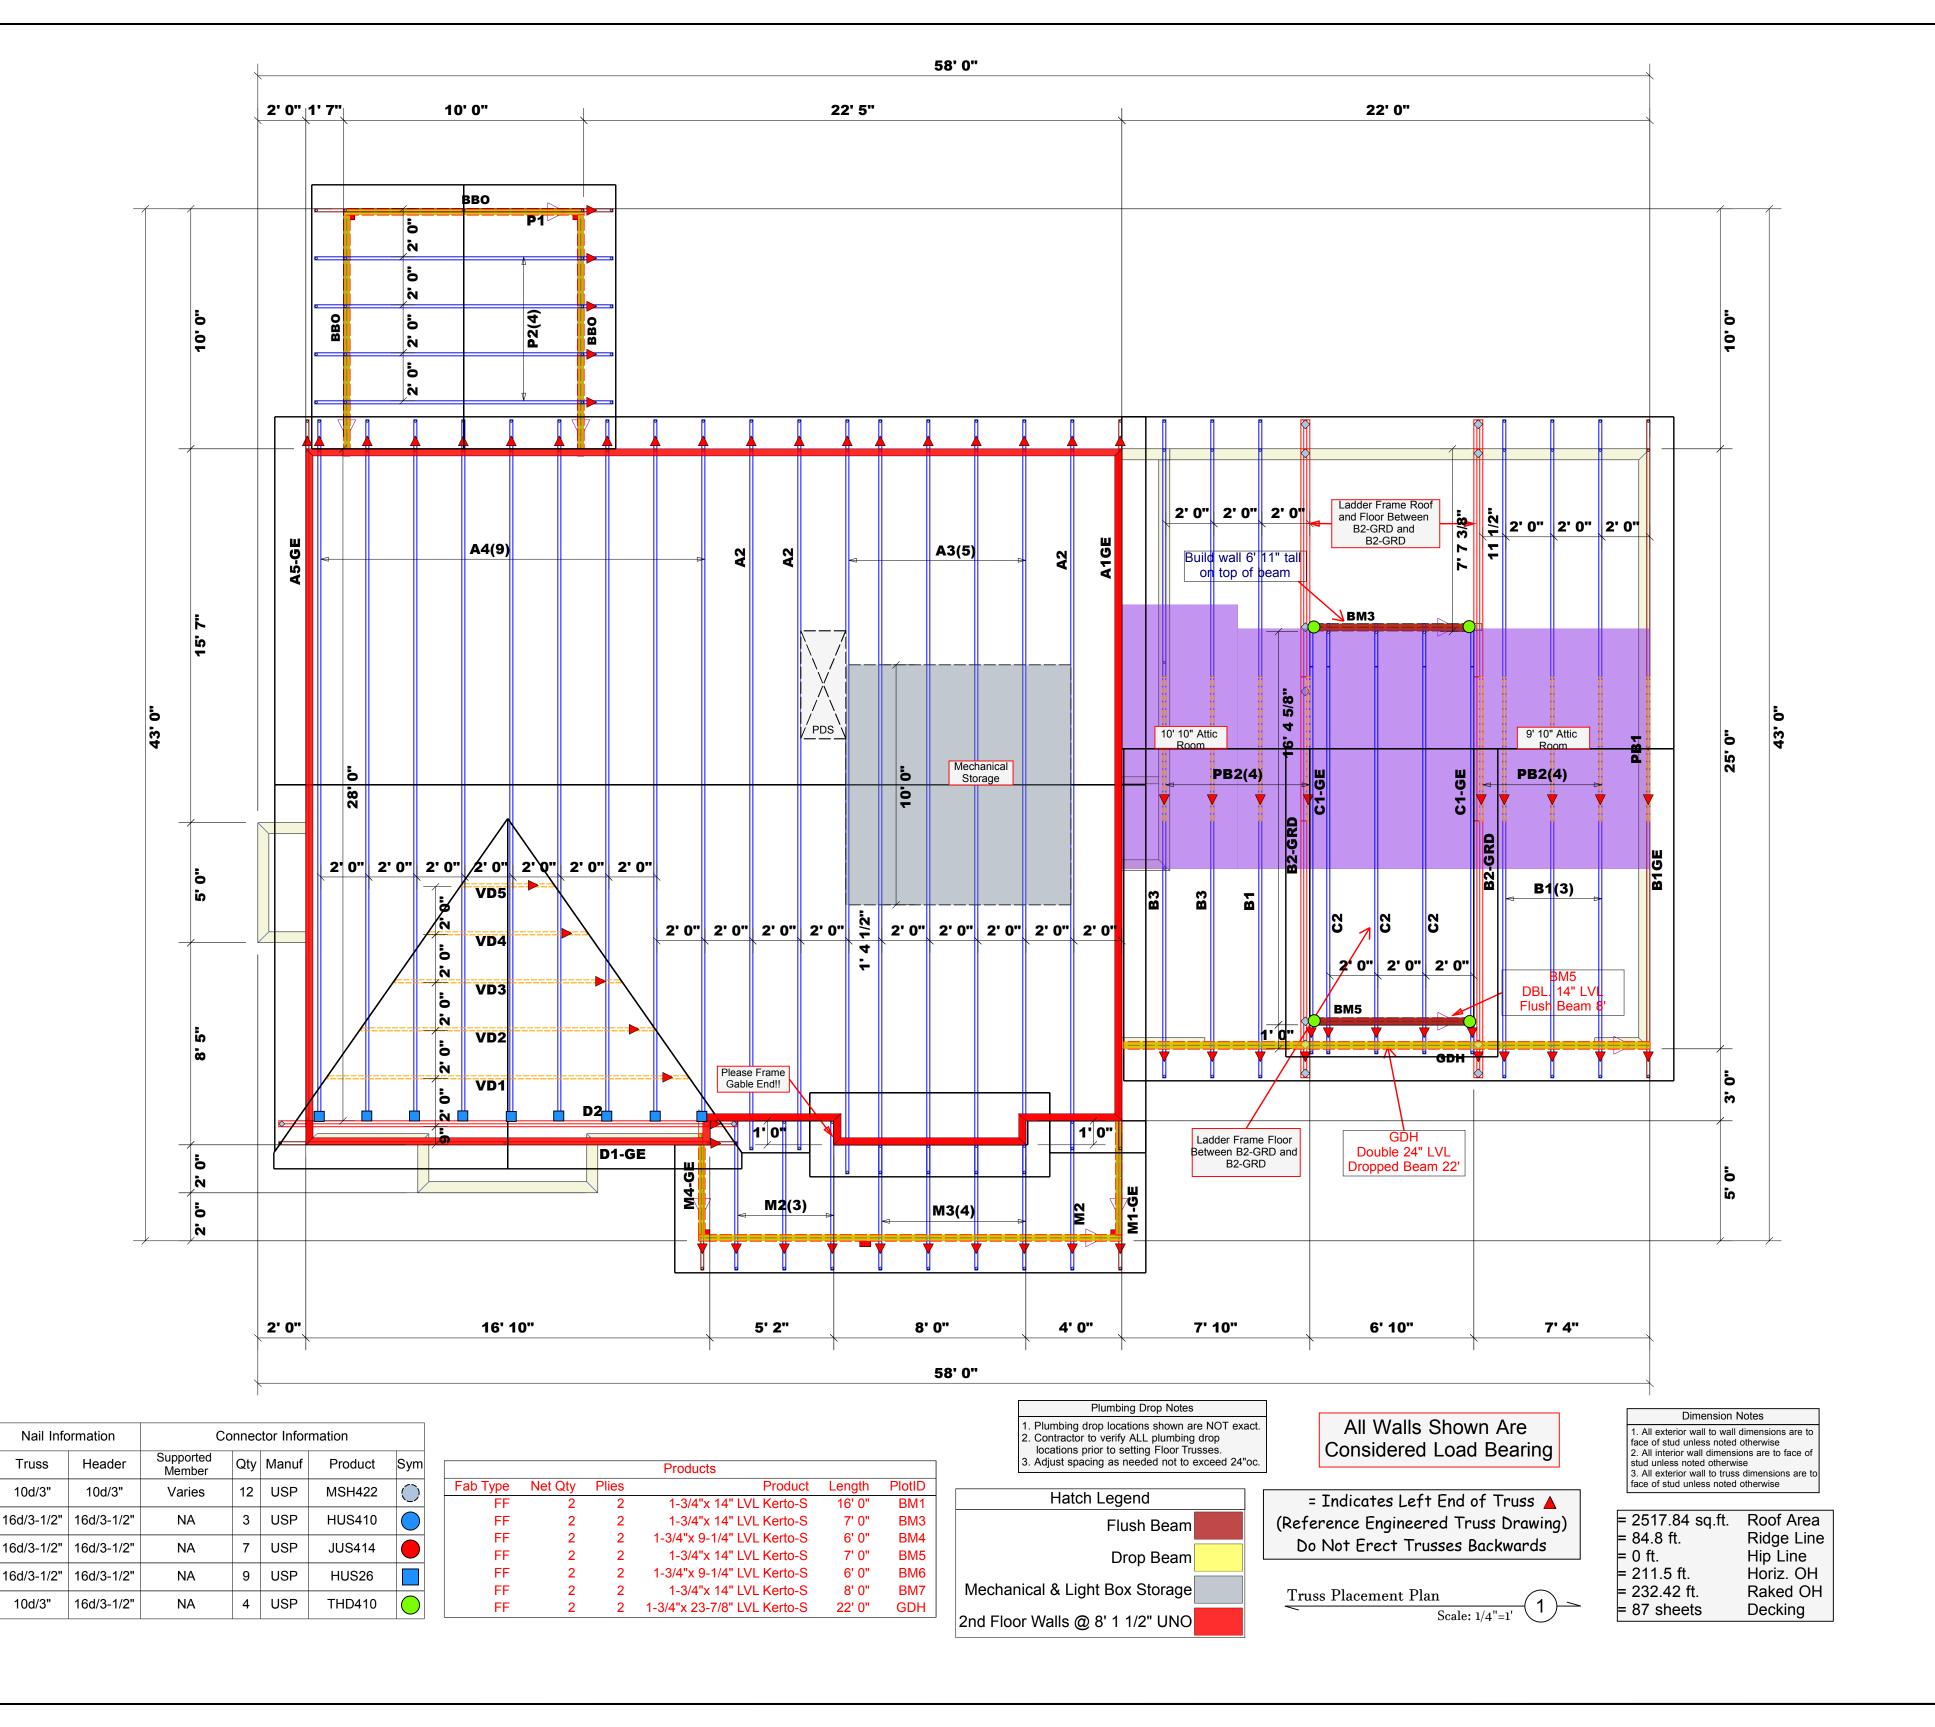



TRUSSES & BEAMS

Reilly Road Industrial Park Fayetteville, N.C. 28309 Phone: (910) 864-8787 Fax: (910) 864-4444

Bearing reactions less than or equal to 3000# are deemed to comply with the prescriptive Code requirements. The contractor shall refer to the attached Tables (derived from the prescriptive Code requirements) to determine the minimum foundation size and number of wood studs required to support reactions greater than 3000# but not greater than 15000#. A registered design professional shall he retained to design the professional shall be retained to design the support system for any reaction that exceeds those specified in the attached Tables. A registered design professional shall be retained design the support system for all reactions that exceed 15000#.

Neil Baggett

LOAD CHART FOR JACK STUDS (BASED ON TABLES R502.5(1) & (b)) NUMBER OF JACK STUDS REQUIRED @ EA END OF

		HEADER/	GIRDER	₹		
END REACTION (UP TO)	REQ'D STUDS FOR (2) PLY HEADER	END REACTION (UP TO)	REQ'D STUDS FOR (3) PLY HEADER		END REACTION (UP TO)	
1700	1	2550	1		3400)
3400	2	5100	2		6800)
5100	3	7650	3		1020	0
6800	4	10200	4		1360	0
8500	5	12750	5		1700	0
10200	6	15300	6			
11900	7					
13600	8					
15300	9					

Renovations	COUNTY	Harnett
	ADDRESS	83 Rush Lane, Cameron, NC
	MODEL	Roof
	DATE REV . 11/21/2023	11/21/2023
	DRAWN BY	DRAWN BY Neil Baggett
	SALESMAN	SALESMAN Neil Baggett

Precision Custom Homes & Liberty Meadows J0923-5136 2.0 62 Wyatt N/A N/A Lo_t JOB NAME SEAL DATE BUILDER QUOTE ; PLAN

THIS IS A TRUSS PLACEMENT DIAGRAM ONLY. THIS IS A TRUSS PLACEMENT DIAGRAM ONLY. These trusses are designed as individual building components to be incorporated into the building design at the specification of the building designer. See individual design sheets for each truss design identified on the placement drawing. The building designer is responsible for temporary and permanent bracing of the roof and floor system and for the overall structure. The design of the truss support structure including headers, beams, walls, and columns is the responsibility of the building designer. For general guidance regarding bracing, consult BCSI-B1 and BCSI-B3 provided with the truss delivery package or online @ sbcindustry.com

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North Carolina 2018 - R402.1.5 Total UA

Property 83 Rush Ln Cameron, NC 28326 Model: Wyatt

Community: Liberty Meadows

Template - SMG Precision - Liberty Meadows Lot 62 - CZ 4 slab -Liberty Meadows Lot 62

Organization

Southern Energy Manager

Justin Smith

Builder

SMG Precision Properties



Inspection Status

Results are projected

This report is based on a proposed design and does not confirm field enforcement of design elements.

Building UA

Elements	NC Reference	As Designed
Ceilings	39.2	35.3
Above-Grade Walls	178.3	132.3
Windows, Doors and Skylights	115.8	104.0
Slab Floor:	64.4	83.8
Framed Floors	13.0	14.1
Foundation Walls	0.0	0.0
Rim Joists	7.4	6.0
Overall UA (Design must be equal or lower):	418.1	375.5

Requirements

R402.1.5	Total UA alternative compliance passes by 10.2%.	The proposed home meets the UA requirement by 10.2%
402.3.2	Average SHGC: 0.28 Max SHGC: 0.30	Average SHGC of 0.28 is greater than the maximum of 0.30.
R402.4.2.2	Air Leakage Testing	Air sealing is 4.80 ACH at 50 Pa. It must not exceed 5.00 ACH at 50 Pa.
R402.5	Area-weighted average fenestration SHGC	Area-weighted average fenestration SHGC is 0.28. The maximum allowed value is [No Limit].
R402.5	Area-weighted average fenestration U-Factor	
R404.1	Lighting Equipment	At least 75.0% of fixtures shall be high-efficacy lamps, currently 90.0% are high-efficacy.
Mandatory Checklist	Mandatory code requirements that are not checked by Ekotrope must be met.	2015 IECC Mandatory Checklist must be checked as complete.
R403.3.1	Duct Insulation	Duct insulation meets the requirements specified in North Carolina 2018 Code Section 403.3.1.
403.3.3	Duct Testing	

Design exceeds requirements for North Carolina 2018 Prescriptive compliance by 10.2%.

Name:	Justin Smith	Signature:	Justin Smith
Organization:	Southern Energy Management	Digitally signed:	11/17/23 at 11:33 AM

Property 83 Rush Ln Cameron, NC 28326 Model: Wyatt Community: Liberty Meadows

Template - SMG Precision - Liberty Meadows Lot 62 - CZ 4 slab - ecoSelect Liberty Meadows Lot 62

OrganizationSouthern Energy Management
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Builder

SMG Precision Properties

Inspection Status Results are projected



General Building Informatio	n
Number Of Bedrooms	4
Number Of Floors	2
Conditioned Floor Area [sq. ft.]	2,228
Has Electric Vehicle Ready Space	No
Unconditioned, attached garage?	Yes
Conditioned Volume [cu. ft.]	19,886
Total Units in Building	1
Residence Type	Single family detached
Number of Floors in Building	-
Floor Number	-
Model	Wyatt
Community	Liberty Meadows
RESNET/IECC 2006-2018 Climate Zone	4A
IECC 2021 Climate Zone	3A

Foundation Wall

None Present

Foundation Wall Library List

None Present

,	Slab								
Г	Name	Library Type	Perimeter	Floor Grade	e Carpet R	R Exposed Masonry Area		Location	Enclosing
ı	slab	Uninsulated	134	On Grade	1	0	1,031.0 ft²	Exposed Exterior	Conditioned Space

Slab Library	List							
Name	Wall Construction Type					Insulation Is	Thermal Break Et	ffective R-value
Uninsulated	Wood Frame / Other	No	0	0	0	Yes	No	0.00

Property 83 Rush Ln Cameron, NC 28326 Model: Wyatt Community: Liberty Meadows

community: Liberty Meadows

Template - SMG Precision - Liberty Meadows Lot 62 - CZ 4 slab - ecoSelect Liberty Meadows Lot 62

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Builder SMG Precision Properties Inspection Status Results are projected



Framed Floo	r				
Name	Library Type	Carpet R	Floor Grade	Surface Area	Location
over ambient	R 19, 16"OC G1 Carpet	0	Above Grade	8.0 ft²	Exposed Exterior
over garage	R 19, 16"OC G1 Carpet	0	Above Grade	268.0 ft²	Unconditioned, attached garage

ľ	Framed Floor Library List	
Г	Name	Effective R-value
	R 19, 16"OC G1 Carpet	19.566

Rim Joist			
Name	Library Type	Surface Area	Location
1st floor ambient	R 19 G1, 16"OC	107.0 ft²	Exposed Exterior
1st floor garage	R 19 G1, 16"OC	27.0 ft²	Unconditioned, attached garage

Rim Joist Library I	List
Name	Effective Insulation R-value
l	
R 19 G1, 16"OC	17.30

Wall				
Name	Library Type	Surface Color	Surface Area	Location
1st floor ambient	R 19 Adv. Framing G1 16" O.C	Medium	963.0 ft²	Exposed Exterior
1st floor garage	R 19 Adv. Framing G1 16" O.C	Medium	243.0 ft²	Unconditioned, attached garage
2nd floor ambient	R 19 Adv. Framing G1 16" O.C	Medium	933.0 ft²	Exposed Exterior
2nd floor attic	R 19 Adv. Framing G1 16" O.C	Medium	507.0 ft²	Attic

Property 83 Rush Ln Cameron, NC 28326 Model: Wyatt Community: Liberty Meadows

Community: Liberty Meadows

Template - SMG Precision - Liberty Meadows Lot 62
- CZ 4 slab - ecoSelect
Liberty Meadows Lot 62

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Justin Smith

Builder SMG Precision Properties Inspection Status Results are projected



Wall Library List		
Nam	e Effective R-value	ue
R 19 Adv. Framing G1 16" O.C	17.492	92

Glazing									
Name	Library Type	Wall Assignment	Foundation Wall Assignment	ls Operable	Overhang Depth	Overhang Ft To Top	Overhang Ft To Bottom	Orientation	Surface Area
front 2nd unshaded	33/28	2nd floor ambient		Yes	0	0	0	West	83.6 ft²
front shaded	33/28	1st floor ambient		Yes	5	1	5	West	10.8 ft²
front unshaded	33/28	1st floor ambient		Yes	0	0	0	West	27.0 ft²
left 2nd unshaded	33/28	2nd floor ambient		Yes	0	0	0	North	7.5 ft²
left unshaded	33/28	1st floor ambient		Yes	0	0	0	North	54.0 ft²
rear 2nd unshaded	33/28	2nd floor ambient		Yes	0	0	0	East	27.5 ft²
rear shaded	33/28	1st floor ambient		Yes	10	2	9	East	33.5 ft²
rear unshaded	33/28	1st floor ambient		Yes	0	0	0	East	33.6 ft²
right 2nd unshaded	33/28	2nd floor ambient		Yes	0	0	0	South	13.5 ft²

Glazing Libra	ary List	
Name	Shgc	U-factor
33/28	0.28	0.330

Skylight		
	None Present	

Property 83 Rush Ln Cameron, NC 28326 Model: Wyatt Community: Liberty Meadows

Template - SMG Precision - Liberty Meadows Lot 62 - CZ 4 slab - ecoSelect Liberty Meadows Lot 62

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Builder SMG Precision Properties Inspection Status Results are projected



Skylight Library List

None Present

Opaque Doo	r							
Name	Library Type	Wall Assignment	Foundation Wall Assignment	Emittance	Solar Absorptance		Surface Area	Location
front entry	Fiberglass R-5	1st floor ambient		0.9	0.75	Medium	20.0 ft²	Exposed Exterior
garage entry	Fiberglass R-5	1st floor garage		0.9	0.75	Medium	20.0 ft²	Unconditioned, attached garage

ı	Opaque Door Library Lis	t
Г	Name	Effective U-factor
	Fiberglass R-5	0.200

	Roof Insulation	on					
ĺ	Name	Library Type	Attic Exterior Area [ft²]	Clay or Concrete Roof Tiles		Surface Area	Location
	attic	R 38 Attic BLOWN FG G1 2x10 24"OC NO	1,921.29	No	Dark	1,307.0 ft²	Attic

Roof Insulation	Library List	
Name	Has Radiant Barrier	Effective R-value
R 38 Attic BLOWN FG G1 2x10 24"OC NO	No	37.074

Infiltration Measurement Type Shelter Class
71
1590 CFM at 50 Pa Blower-door tested 4

Property 83 Rush Ln Cameron, NC 28326 Model: Wyatt Community: Liberty Meadows

Template - SMG Precision - Liberty Meadows Lot 62 - CZ 4 slab - ecoSelect Liberty Meadows Lot 62

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Builder SMG Precision Properties Inspection Status Results are projected



Mechanical Ventilation	
	None Present

Lighting					
% Interior Fluorescent Lighting	% Interior LED Lighting	% Exterior Fluorescent Lighting		% Garage Fluorescent Lighting	% Garage LED Lighting
0	90	0	0	0	0

1	Lighting	Lighting		ining Eighting		
	o	90	0	0	0	0
	Onsite Gener	ration				

Onsite Generation Library List

None Present

None Present

Solar Generation	
	None Present

Dehumidifier	
	None Present

Dehumidifier Library List None Present

Property 83 Rush Ln Cameron, NC 28326 Model: Wyatt Community: Liberty Meadows

Template - SMG Precision - Liberty Meadows Lot 62 - CZ 4 slab - ecoSelect Liberty Meadows Lot 62

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Builder

SMG Precision Properties



Inspection Status Results are projected

Whole House Fan

None Present

Whole House Fan Library List

None Present

Conditioning Equipment								
Name	Library Type	Serial Number	Heating Percent Load	Cooling Percent Load	i Hot Water Percent Load			
1st floor heat pump	z 24k 14 SEER 8.0hspf		48%	48%	0%	Attic		
2nd floor heat pump	z 24k 14 SEER 8.0hspf		52%	52%	0%	Attic		
Water Heating	z 50 gal. 0.95 EF Elec		0%	0%	100%	Unconditioned Garage		

Equipment Type: z 24k 14 SEER 8.0hspf				
Equipment Type	Air Source Heat Pump			
Fuel Type	Electric			
Distribution Type	Forced Air			
Motor Type	PSC (Single Speed)			
Heat Pump System Type	Unspecified			
Heating Efficiency	8 HSPF			
Heating Capacity [kBtu/h]	24			
Backup Fuel Type	Electric			
Switchover Temperature [°F]	0			
Backup Heating Efficiency	1 COP			
Use default Supplemental Heat	Yes			
Cooling Efficiency	14 SEER			
Cooling Capacity [kBtu/h]	24			

Property 83 Rush Ln Cameron, NC 28326 Model: Wyatt Community: Liberty Meadows

Template - SMG Precision - Liberty Meadows Lot 62 - CZ 4 slab - ecoSelect Liberty Meadows Lot 62

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Inspection Status

Results are projected

Builder SMG Precision Properties



Equipment Type: z 24k 14 SEER 8.0hspf				
Air Source Heat Pump				
Electric				
Forced Air				
PSC (Single Speed)				
Unspecified				
8 HSPF				
24				
Electric				
0				
1 COP				
Yes				
14 SEER				
24				

Equipment Type: z 50 gal. 0.95 EF Elec			
Equipment Type	Residential Water Heater		
Fuel Type	Electric		
Distribution Type	Hydronic Delivery (Radiant)		
Hot Water Efficiency	0.95 Energy Factor		
Tank Capacity (gal.)	50		
Hot Water Capacity [kBtu/h]	40		
Recovery Efficiency	0.98		

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Template - SMG Precision - Liberty Meadows Lot 62 - CZ 4 slab - ecoSelect Liberty Meadows Lot 62

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Inspection Status

Results are projected

Builder SMG Precision Properties



Distribution System	
Distribution Type	Forced Air
Heating Equipment	1st floor heat pump
Cooling Equipment	1st floor heat pump
Sq. Feet Served	1,031
# Return Grilles	2
Supply Duct R Value	8
Return Duct R Value	8
Supply Duct Area [ft²]	278.37
Return Duct Area [ft²]	103.1
Leakage to Outdoors	41 CFM @ 25Pa (3.98 / 100 ft²)
Total Leakage	41 CFM25
Total Leakage Duct Test Conditions	Post-Construction
Use Default Flow Rate	Yes
Duct 1	
Duct Location	Attic (well vented)
Percent Supply Area	60
Percent Return Area	60
Duct 2	
Duct Location	Conditioned Space
Percent Supply Area	40
Percent Return Area	40
Duct 3	
Duct Location	Conditioned Space
Percent Supply Area	0
Percent Return Area	0
Duct 4	
Duct Location	Conditioned Space
Percent Supply Area	0
Percent Return Area	0
Duct 5	One different One on
Duct Location	Conditioned Space
Percent Supply Area	0
Percent Return Area	0
Duct 6	Canditioned Chase
Duct Location	Conditioned Space
Percent Supply Area Percent Return Area	0
Percent Return Area	U

Property 83 Rush Ln Cameron, NC 28326 Model: Wyatt Community: Liberty Meadows

Template - SMG Precision - Liberty Meadows Lot 62 - CZ 4 slab - ecoSelect Liberty Meadows Lot 62

Organization Southern Energy Management Justin Smith Inspection Status

Results are projected

Builder

SMG Precision Properties



Distribution System	
Distribution Type	Forced Air
Heating Equipment	2nd floor heat pump
Cooling Equipment	2nd floor heat pump
Sq. Feet Served	1,197
# Return Grilles	2
Supply Duct R Value	8
Return Duct R Value	8
Supply Duct Area [ft²]	323.19
Return Duct Area [ft²]	119.7
Leakage to Outdoors	47 CFM @ 25Pa (3.93 / 100 ft²)
Total Leakage	47 CFM25
Total Leakage Duct Test Conditions	Post-Construction
Use Default Flow Rate	Yes
Duct 1	
Duct Location	Attic (well vented)
Percent Supply Area	100
Percent Return Area	100
Duct 2	
Duct Location	Conditioned Space
Percent Supply Area	0
Percent Return Area	0
Duct 3	
Duct Location	Conditioned Space
Percent Supply Area	0
Percent Return Area	0
Duct 4	
Duct Location	Conditioned Space
Percent Supply Area	0
Percent Return Area	0
Duct 5	
Duct Location	Conditioned Space
Percent Supply Area	0
Percent Return Area	0
Duct 6	
Duct Location	Conditioned Space
Percent Supply Area	0
Percent Return Area	0

HVAC Grading

HVAC Grading Not Conducted

Ceiling Fan	
Has Ceiling Fan No	
Cfm Per Watt 100	

Property 83 Rush Ln Cameron, NC 28326 Model: Wyatt Community: Liberty Meadows

Template - SMG Precision - Liberty Meadows Lot 62 - CZ 4 slab - ecoSelect Liberty Meadows Lot 62

Hot Water Recirculation System?

Drain Water Heat Recovery?

Recirculation System Pipe Loop Length [ft]

Organization Southern Energy Management Justin Smith Inspection Status

Results are projected

Builder

SMG Precision Properties



iberty Meadows Lot 62					
Water Distribution					
Water Fixture Type	Low-flow				
Use Default Hot Water Pipe Length	No				
Hot Water Pipe Length [ft]	87				
At Least R3 Pipe Insulation?	No				

Clothes Dryer	
Cef	3.01
Fuel Type	Electric
Field Utilization	Timer Controls
Is Outside Conditioned Space	No
Clothes Dryer Available	Yes
Defaults Type	HERS Reference

No

20

No

153 kWh/Year
\$12.00
\$0.11/kWh
\$1.22/Therm
3.31
2.1547
Custom
Front-load
6
No
Yes

Dishwasher	
Dishwasher Defaults Type	ENERGY STAR Standard
Dishwasher Size	Standard
Dishwasher Efficiency	270 kWh
Annual Gas Cost	\$22.23
Electric Rate	\$0.12/kWh
Gas Rate	\$1.09/Therm
Is Outside Conditioned Space	No
Dishwasher Available	Yes

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Builder SMG Precision Properties



Appliances and Controls	
Thermostat Cooling Setpoint	* * * * 75.0
Thermostat Heating Setpoint	* * * * 70.0
Range/Oven Fuel	Electric
Convection Oven?	No
Induction Range?	No
Range/Oven Outside Conditioned Space?	No
Refrigerator Consumption	538 kWh/Year
Refrigerator Outside Conditioned Space?	No

Notes		
Initial Inputs	JS 11/17/23	
-confirm HVAC specs -confirm water heater specs -confirm ventilation entry -modeled to worst case orientation -confirm cfl lighting %		