### **REVISION LOG**

6x6 © COVERED PORCH, PACK OUT BEAM.
CHANGE WALL BETWEEN PANTRY/ COAT CLOSET TO A 2X6 WALL.
NOTE 3/0 C.O. "3/0X6/8 C.O.".

DATE: 11/24/21

- 4. CHANGE WALL BETWEEN KITCHEN COUNTER & MESSY KITCHEN TO 28" LENGTH.

- 4. CHANGE WALL BETWEEN KITCHEN COUNTER & MESSY KITCHEN TO 28" LENGTH.
  LOCATE / 2/8X6/8 C.O. © END OF THE WALL.

  5. ADD (3) OPT 2/0X2/0 © CAFE, CENTERED © 21'-4" FRONT REAR WALL.

  6. CHANGE IST FLOOR STAIR RAIL AND WALL FROM A 2X4 WALL TO A 2X6 WALL.

  SLIDE BATH #2 WALL 2" TO MAINTAN 3'-4" STAIR WIDTH. ADJUSTED WALL AND STAIR ON THE 2ND FLOOR.

  7. END STAIR RAIL 10'-0" FROM WIC WALL.

  8. REMOVE WIDE WALL BEHIND BATH #2 TUB.

  9. CHANGE BATH #2 WIDTH TO 5'-0" & ADD ROOM TO BED #2.

  10. CHANGE WALL BEHIND THE OWNER'S TOLLET WALL FROM A 2X6 WALL TO A 2X4 WALL & MOVE WALL INTO WIC TO INCREASE DEPTH THE TOLLET TO 6'-1". REVISE ALL OWNER'S BATH OPTONS TO MATCH.
- ALL OWNER'S BATH OPTIONS TO MATCH.

  11. ADD GOURMET KITCHEN W/ WALL OVEN AND 36" COOKTOP.

- 11. ADD GOVERN RICHEN W/ WALL OVEN AND 36 COURTOP.

  12. ADD 24"X36" ATTIC ACCESS TO BED #4 MC.

  13. CHANGE 2ND FLOOR 3/0 C.O. TO A 5/0X6/8 C.O.

  14. CHANGE 2ND FLOOR 3/0 C.O. TO A 5/0X6/8 © FOYER CLOSET, BATH #2, WC

  © BED #2, BATH #3, LINEN, WIC © BED #3 & WIC © BED #4.

  15. FLIP DOOR SWING INTO OPT. OFFICE/HOME GYM.

  16. ADD 8"-0" DEEP MECHANICAL RM TO REAR OF OPT. SUPER GAMEROOM/ HOME

- GYM/ OFFICE.

  17. 2X10 BEAM UNDER TOP PLATES © FRONT PORCHES.

  18. ALIGN (3) 2/0X2/0 WINDOW HEADER HT © FLEX ROOM W/ FRONT DOOR HEADER
- HI.

  19. ADD PARTIAL FOR OPT FIREPLACE.

  20. ADD PARTIAL ELEVATIONS FOR OWNER'S BATH OPTIONS.

  21. ADD PARTIAL FOR OPT SMART DELIVERY DOOR.
- 22. 4 3" DSP BETWEEN WINDOWS & DIMENSION TO THE CENTER.
  23. DIMENSION WIDTH OF HIPS

### REVISION:002 DATE: 2/4/2022

- DIMENSION TRIPLE STUD POCKETS (4.5") RELOCATED & RESIZE KITCHEN ISLAND PER REDLINES, & REMOVE UNDER-COUNTER WALL TO THE RIGHT OF KITCHEN SINK. SHOW FULL HEIGHT WALL AT STANDARD MASTER BATH SHOWER.

- CHANGE MASTER BATH LINEN CLOSET DOOR TO 4/0X6/8 DOUBLE DOOR.
  CALL OUT ALL LINEN CLOSETS AS (4) SHELVES.
  REMOVE SHELF/ROD BEHIND WATER CLOSET & ADJACENT TO DOOR IN MASTER WIC
- CALL OUT FRONT PORCH COLUMNS AS 6X6 P.T. POST W/ 1X WRAP. LABEL 12" DROPPED HEADER.

- Label 12 Drupped Header.
   REMOVE THE OWNER'S ENTRY OPTION.
   RESIZE/RELOCATE/REMOVE UNDER-COUNTER WALL IN KITCHEN ISLAND PER BASE.
- PLAN. '
  11. SHOW 42X42 SHOWER W/ 18" SEAT FOR TUB SHOWER COMBO PER REVISION

- 11. SHOW 42X42 SHOWER W/ 18 SEAT FOR TUB SHOWER COMBUT PER REVISION REDURES.
  12. SHOW OPT. STANDALONE 42X42 W/ 18\* SEAT.
  13. LOCATE SHOWER YALVE ON HALF WALL FOR SUPER SHOWER OPT.
  14. LABEL OPT DOOR TO FLEX ROOM AS 15—TUTE FRENCH DOORS
  15. SWING DOOR AT CAMEROOM INTO UNIFIN. ATTIC STORAGE.
  16. REMOVE FAUX SHUTTER FROM FARMHOUSE PLAN SINCE IT IS NOT SHOWING ON COMMENT.
- 17. UPDATE ROOF HEIGHT FOR REAR OPTIONS TO REFLECT STANDARD HEEL HEIGHT.

  18. REMOVED HALF WALLS AT KITCHEN ISLAND AND UPDATED PER CABINET PROVIDER

  20. EXTEND PORCH SLAB 4" AT FRONT AND EXTEND AROUND CORNER 20" TO SUPPORT STONE
- 21. REMOVED HALF WALLS AT KITCHEN ISLAND AND UPDATED PER CABINET PROVIDER
- 22. CHANGED THE BASE OWNER'S BATH WINDOW TO 4010
  23. CHANGED THE OWNER'S BATH OPTION SHOWER WINDOW TO 4010
  24. CHANGED THE OWNER'S BATH OPTION SUPER SHOWER WINDOWS TO (2)3010

### REVISION: 003 DATE: 3/21/2022

1. ADD ELECTRICAL PLANS

### REVISION: 004

DATE: 7/22/2022

- ADD STEM WALL SLAB FOUNDATION SHEETS
   ADD "STEM WALL" TO CRAIN. ELEVATION TITLES AND NOTE "SEE FOUNDATION PAGES FOR FOUNDATION TYPE". UPDATE SHEET TITLES.

1e0-25-23 - Initial Redlines

11-6-23 Updated Redlines to add Tankless Water Heater, Interior Doors

Lot 32 WS - 72 Willow Creek Place, Fuquay Varina, NC 27526

# **≧HOME**

# **Trademark Plus**



<u>. 1 001/</u>	
FARM	HOUSE
UNHEATED	HEATED
0	1955
0	945
147	0
437	0
220	0
804	2900
37	04
PTIONS	
UNHEATED S.F.	HEATED S.F.
220	0
0	+32
0	+183
0	+183
0	+183
-28	+28
+158	0
	FARMI UNHEATED 0 0 147 437 220 804 37 PTIONS UNHEATED S.F. 220 0 0

SQUARE FOOTAGE

# 'FARMHOUSE' **ELEVATION**

PLAN 6

The Raleigh - RH

eet No.	Sheet Description								
0.0	Cover Sheet								
1.1	Foundation (Slab)								
1.1.1	Foundation Options (Slab)								
1.1.2	Foundation Options (Slab)								
1.2	Foundation (Crawl)								
1.2.1	Foundation Options (Crawl)  Foundation Options (Crawl)								
1.2.2	Foundation (Stem Wall Slab)								
1.3.1	Foundation Options (Stem Wall Slab)								
1.3.2	Foundation Options (Stem Wall Slab)								
2.1	First Floor Plan								
2.1.1	First Floor Plan Options								
2.2	Second Floor Plan								
2.2.1	Second Floor Plan Options								
2.4	Covered Porch Plans & Elevations (Slab)								
2.4.1	Covered Porch Plans & Elevations (Crawl/Stem Wall)								
2.5	Extended Owner's Suite Plans & Elevations (Slab)								
2.5.1	Extended Owner's Suite Plans & Elevations (Crawl/ Stem Wall)								
2.6	Ext. Owner's Suite W/Cov. Porch Plans & Elevations (Slab)								
2.6.1	Ext. Owner's Suite W/Cov. Porch Plans & Elevations (Crawl/Stem Wall)								
2.7	2-Car Sideload Garage Plans								
2.7.1	2-Car Sideload Garage Elevations								
2.8	3-Car Garage Plans								
2.8.1	3-Car Garage Elevations (Crawl/ Stem Wall)								
2.8.2	3-Car Garage Elevations (Slab)								
3.1	Front & Rear Elevations (Slab)								
3.1.1	Front & Rear Elevations (Crawl/Stem Wall)								
3.2	Side Elevations (Slab)								
3.2.1	Side Elevations (Crawl/ Stem Wall)								
3.3	Roof Plan								
5.1	First Floor Electrical Plan								
5.1.1	First Floor Options Electrical Plan								
5.2	Second Floor Electrical Plan								
5.2.1	Second Floor Options Electrical Plan								

### **DESIGN CRITERIA:**

THIS PLAN IS TO BE BUILT IN CONFORMANCE WITH THE 2018 NORTH CAROLINA STATE BUILDING CODE: RESIDENTIAL CODE

DIMENSIONS SHALL GOVERN OVER SCALE, AND CODE SHALL GOVERN OVER DIMENSIONS.


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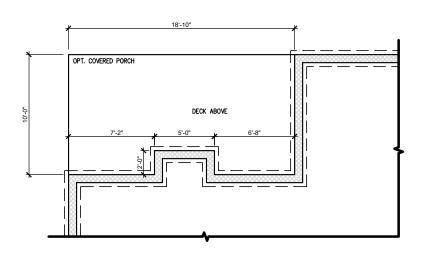
THE RALEIGH 9 **PLAN** 

Sheet


South Designs ISSUE DATE: 7/1/2021 CURRENT REVISION DATE:

1/8" = 1'-0'




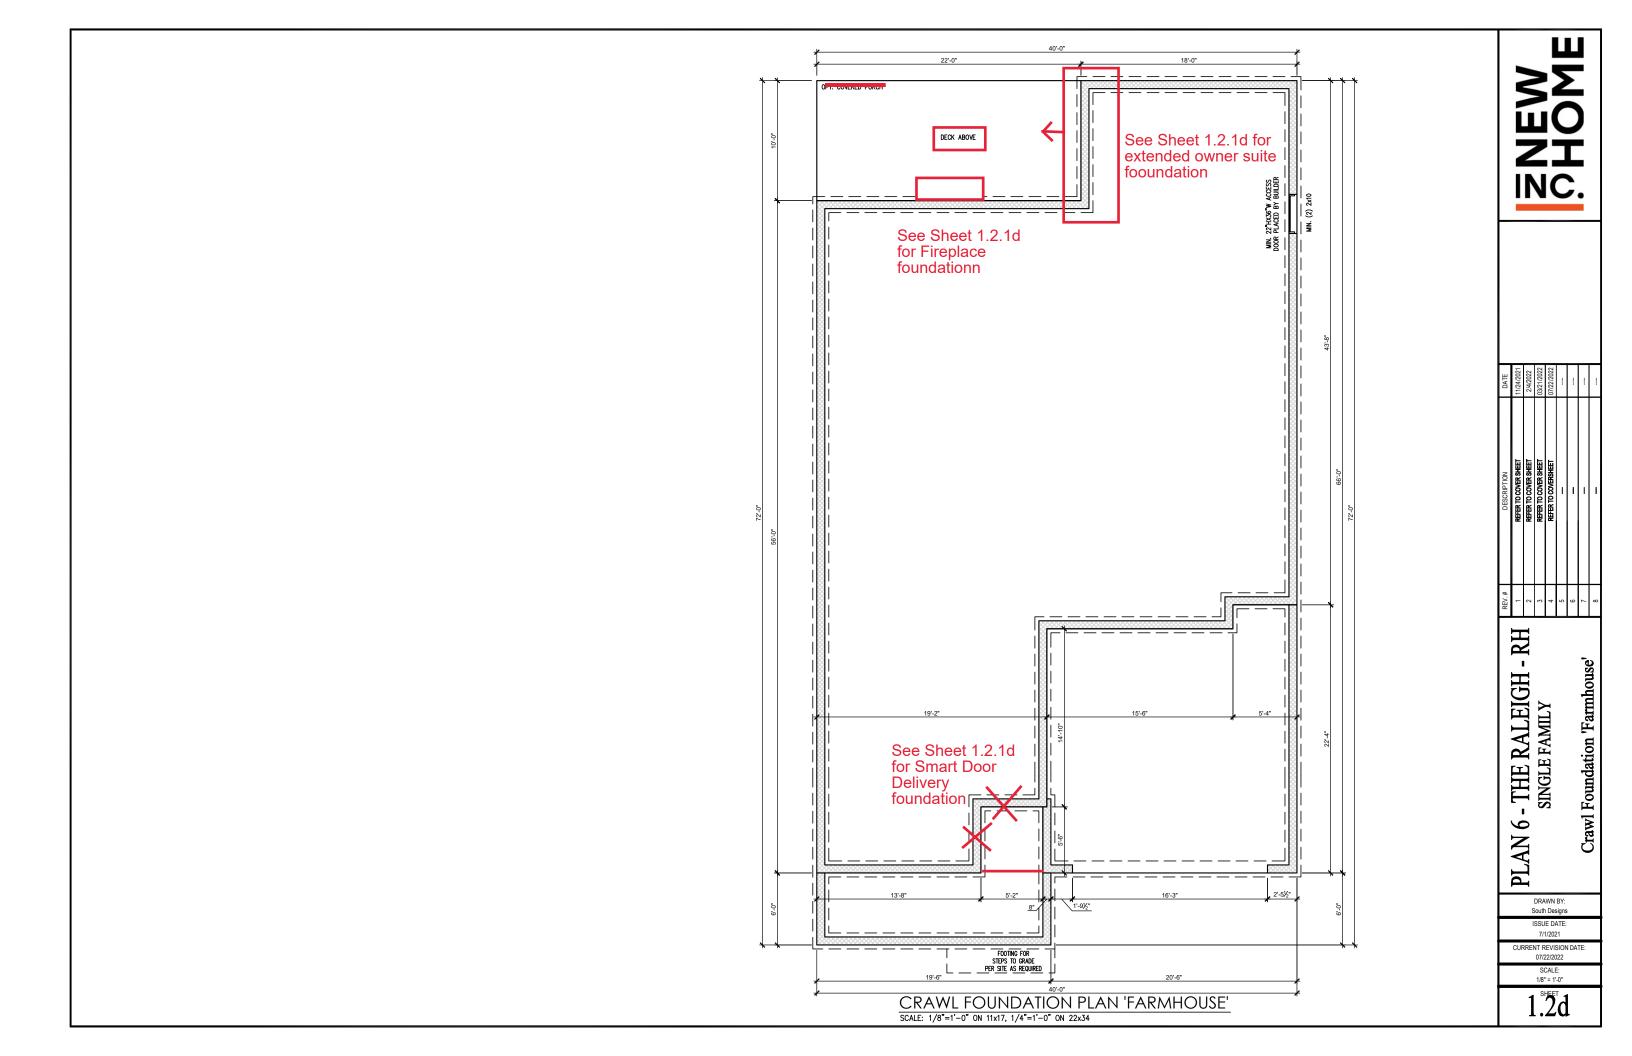

CRAWL FND. W/ OPT. FIREPLACE & EXTENDED OWNER'S SUITE SCALE: 1/8"=1'-0" ON 11x17, 1/4"=1'-0" ON 22x34

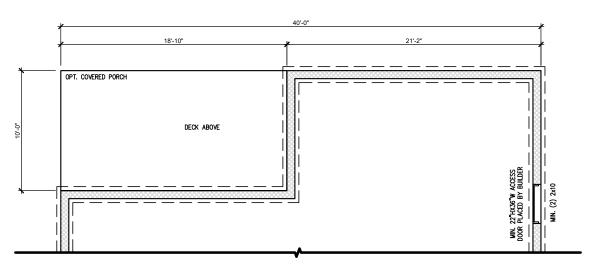

CRAWL FND. W/ OPT. EXTENDED OWNER'S SUITE SCALE: 1/8"=1'-0" ON 11x17, 1/4"=1'-0" ON 22x34

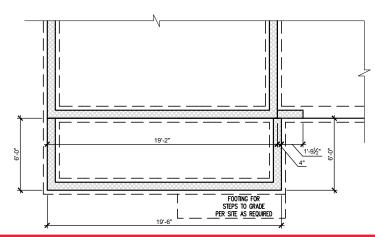

CRAWL FOUNDATION PLAN W/SMART DOOR DELIVERY
SCALE: 1/8"=1'-0" ON 11x17, 1/4"=1'-0" ON 22x34

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PLAN 6 - THE RALEIGH - RH
SINGLE FAMILY
Crawl Foundation Options 'Farmhouse'

DRAWN B South Design

South Designs
ISSUE DATE:


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SCALE: 1/8" = 1'-0"

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# General Floor Plan Notes General Floor Plan Notes shall apply unless noted otherwise on plan.


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- Wall Thickness is typically 3 1/2". 2x6 frame shall be used at walls that back up to plumbing fixtures. Walls greater than 10' high shall be framed with 2x6 framing or greater and will be noted as a special condition where it occurs on plan.
- Typical header height shall be 7'-8" AFF at First Floor, and 7'-4" AFF at Second Floor U.N.O.
- Jacks: Openings up to 3'-4" wide shall have (1) 2x4 jack stud SPF on each side. Openings greater than 3'-4" wide shall have (2) 2x4 jack studs SPF on each
- 5. Soffits, Coffered Ceilings, Trey Ceilings and other significant ceiling plan elements are shown on the floor plans and are denoted as single dashed lines. Unless specifically call out as included, Kitchens do not include soffits over wall cabinetry.
- Door & Window Frames, where occurring near corners, shall be a minimum of 4 1/2" from corner. Except for walk-in closets with doors near a corner, doors at closets shall be centered on closet.
- Windows: Shall have at least (1) window in each sleeping room, that meets egress. Shall be provided with tempered glass at hazardous glazing areas. False windows shall be installed with obscure glazing.
- Closets for clothing or coat storage shall be equipped with 1 rod/shelf. Closets for linen shall have 4 open equal shelves. Closets for pontries shall have 4 equal wood shelves, painted.
- Stair treads shall be a min of 9" deep, risers shall be a maximum of 8 1/4", unless noted otherwise, per the current North Carolina Residential Code
- 10. Handrails and Guards at stairs shall be 34" above the finished surface of the ramp surface of the stair. Handrails at landings and overlooks of multilevel spaces shall be 36" above finished floor. Guards (pickets or balusters) shall be spaced with no more than 4" between guards.
- 11. Affic Access shall be provided at all affic area with a height greater than 30°. Minimum clear affic access shall be 20° x 30°. Pull down stairs and access doors in knee walls meeting minimum criteria are also acceptable.
- 12.Garage Door to Living Space shall be 2'-8" x 6'-8" minimum size and shall be 20 minute fire rated and weather sealed.
- 13. Garage Walls, as a minimum, shall be separated from living space by installing 1/2" gypsum board on the garage side of the wall. With habitable space above, the inside of all garage walls require 1/2" GWB supporting 5/8" type X GWB on ceiling.




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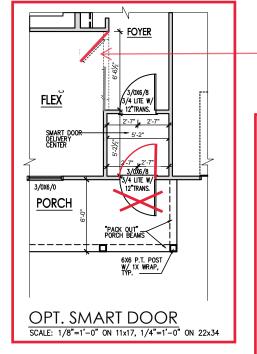
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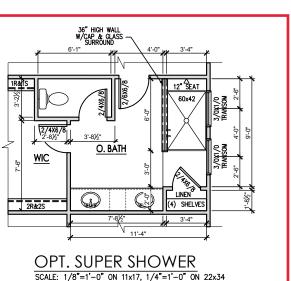


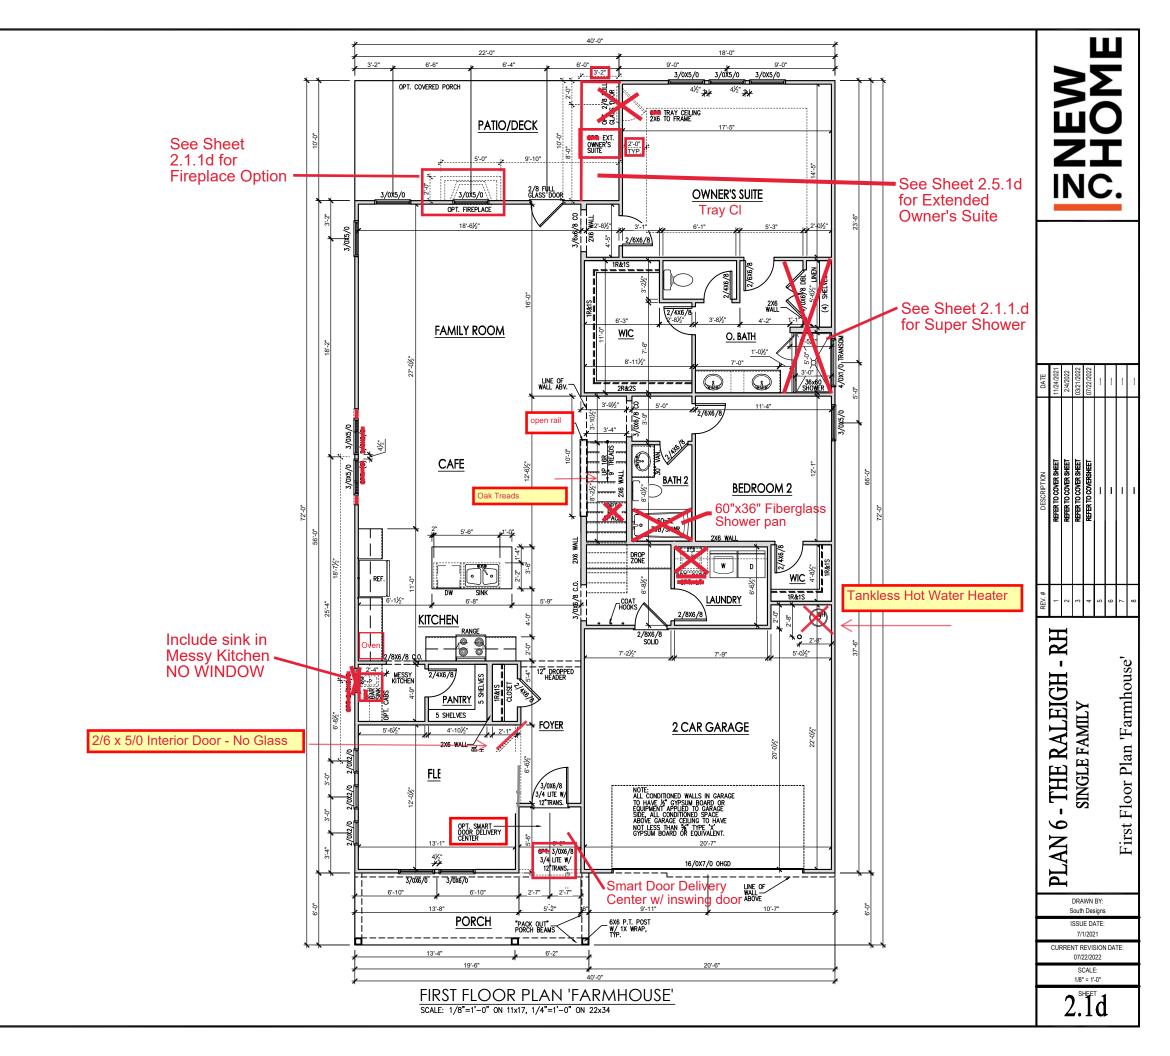

2/6 x 6/8 Interior

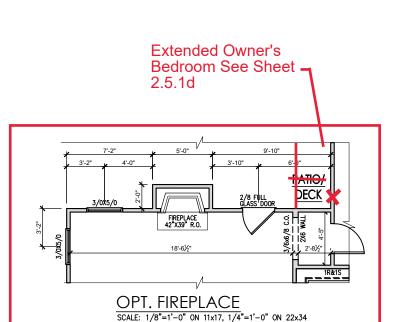Door - No Glass

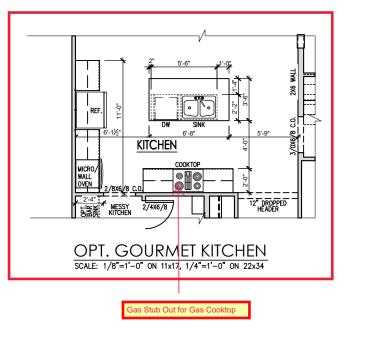





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PLAN 6 - THE RALEIGH SINGLE FAMILY

First Floor Options 'Farmhouse'

-RH

DRAWN BY: South Designs

ISSUE DATE: 7/1/2021


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1/8" = 1'-0"

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PLAN 6 - THE RALEIGH - RH SINGLE FAMILY

Plan

Floor

Second

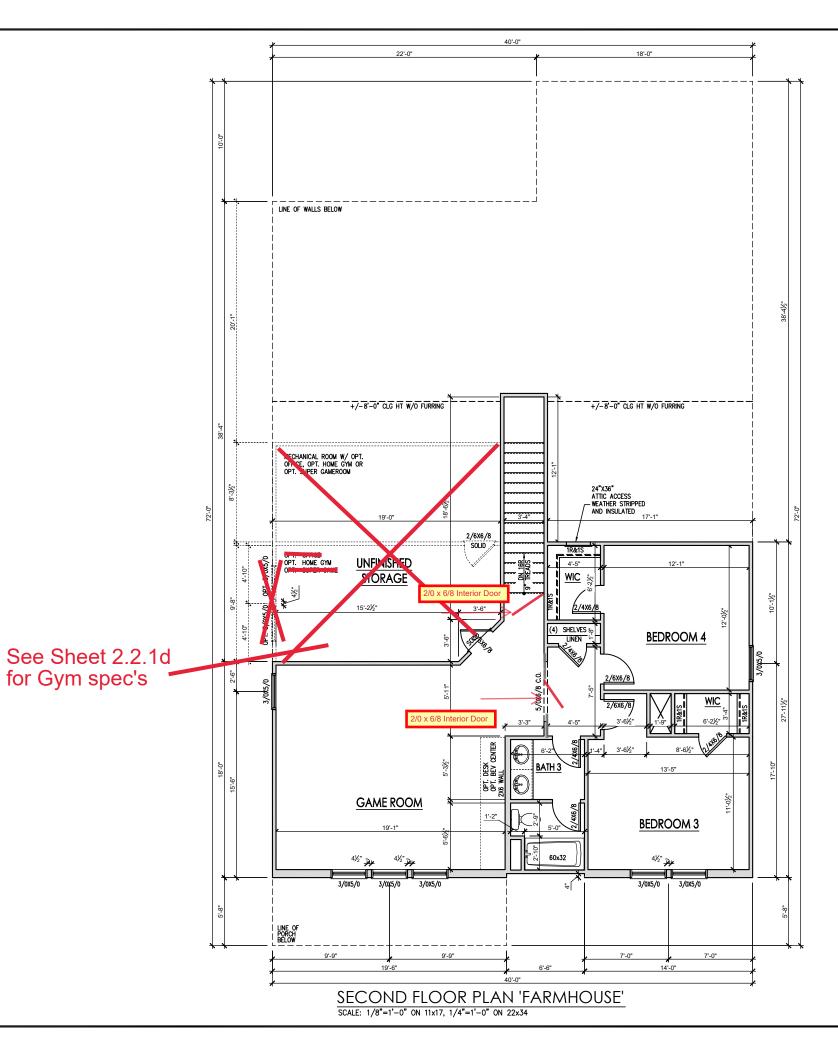DRAWN BY: South Designs

ISSUE DATE: 7/1/2021


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OPT. OFFICE

OPT. HOME GYM

SCALE: 1/8"=1'-0" ON 11x17, 1/4"=1'-0" ON 22x34

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PLAN 6 - THE RALEIGH SINGLE FAMILY

Options 'Farmhouse'

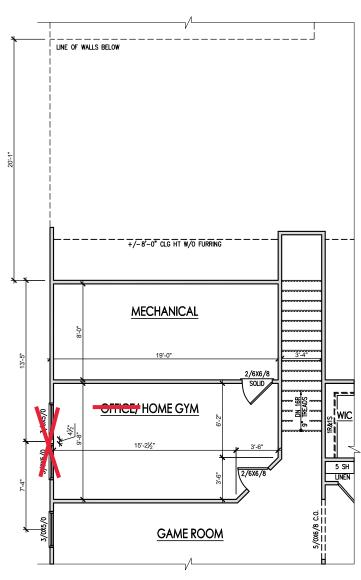Second Floor Plan

-RH


DRAWN BY: South Designs

ISSUE DATE:

7/1/2021 CURRENT REVISION DATE:

> SCALE: 1/8" = 1'-0"

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### **General Elevation Notes**

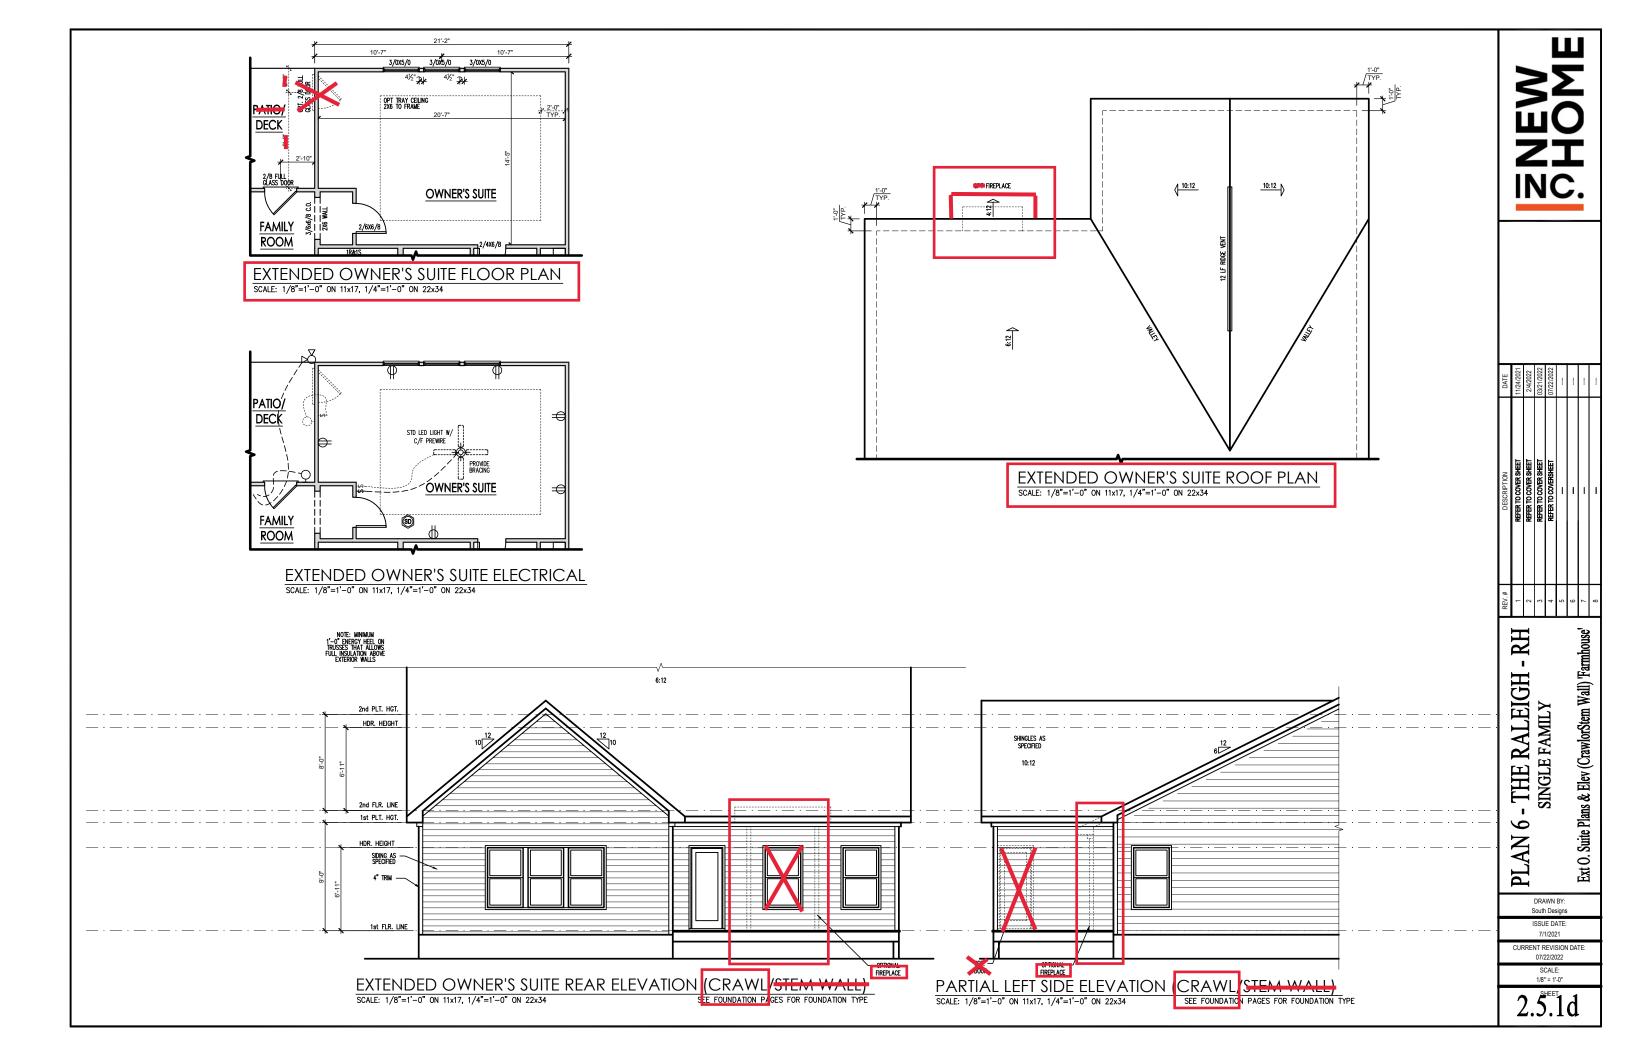General Elevation Notes shall apply unless noted otherwise on plan.

- Roof shall be finished with architectural composition shingles with slopes as noted on plan.
- Ridge Vent shall be provided and installed on all ridges greater than 6' in length per manufacturer's specifications.
- 3. Soffit Vent shall be continuous soffit vent
- House Wrap, "tyvek" or approved equal shall be installed over entire exterior wall per manufacturer's specifications and recommendations.
- Flashing shall be provided above all door and window openings, above finish wall material changes and at wall surfaces where lower roof areas abut vertical wall surfaces.
- Porch Railings shall be provided at all porch walking surfaces greater than 30" above adjacent finished grade. It shall be 33" high with guards spaced no more than 4" apart. Consult community specifications for material.
- Finish Wall Material shall be as noted on elevation drawings.
- 8. Brick Veneer, if included on elevation shall be fled to wall surface with galvanized corrugated metal fles at a rate of 24" oc horizontally and 16" oc vertically so that no more than 2.67sf of brick is supported by (1) fle. Space between face of wall and back face of brick shall be limited to a maximum of 1". Flashing shall be provided behind brick above all wall openings and at base of brick wall. Flashing shall be a minimum of 6-mil poly or other corrosion resistant material and shall be installed so that it laps under the house wrap material an inimum of 2". Weepholes shall be provided at a rate of 48" oc and shall not be less than 3/16" in diameter and shall be located immediately above flashing.
- Brick Veneer Support Lintels shall be provided if brick veneer is included on elevation. Lintels shall be provided as listed in the following schedule and shall have a minimum bearing length of 6". Masonry Lintels shall be provided so that deflection is limited to L/600.

Masonry Opening Lintel Schedule

Opening Size	Ang

ot au	4'-0"		3-1/2" x 3-1/2" x 5/16"
4'-1"	to	5'-6"	4" x 3-1/2" x 5/16" LLV
5'-7"	to	6'-6"	5" x 3-1/2" x 5/16" LLV
6'-7"	to	8'-4"	6" x 3-1/2" x 5/16" LLV
8'-5"	to	16'-4"	7" x 4" x 3/8" LLV





DATE	11/24/2021	2/4/2022	03/21/2022	07/22/2022				-
DESCRIPTION	REFER TO COVER SHEET	REFER TO COVER SHEET	REFER TO COVER SHEET	REFER TO COVERSHEET	-	-	-	-
REV.#	-	2	3	4	5	9	7	8


PLAN 6 - THE RALEIGH - RH
SINGLE FAMILY
Front & Rear Elevations (Crawl or Stem
Wall) 'Farmhouse'


DRAWN BY: South Designs

ISSUE DATE: 7/1/2021

CURRENT REVISION DATE: 07/22/2022 SCALE: 1/8" = 1'-0"

3.1.1d

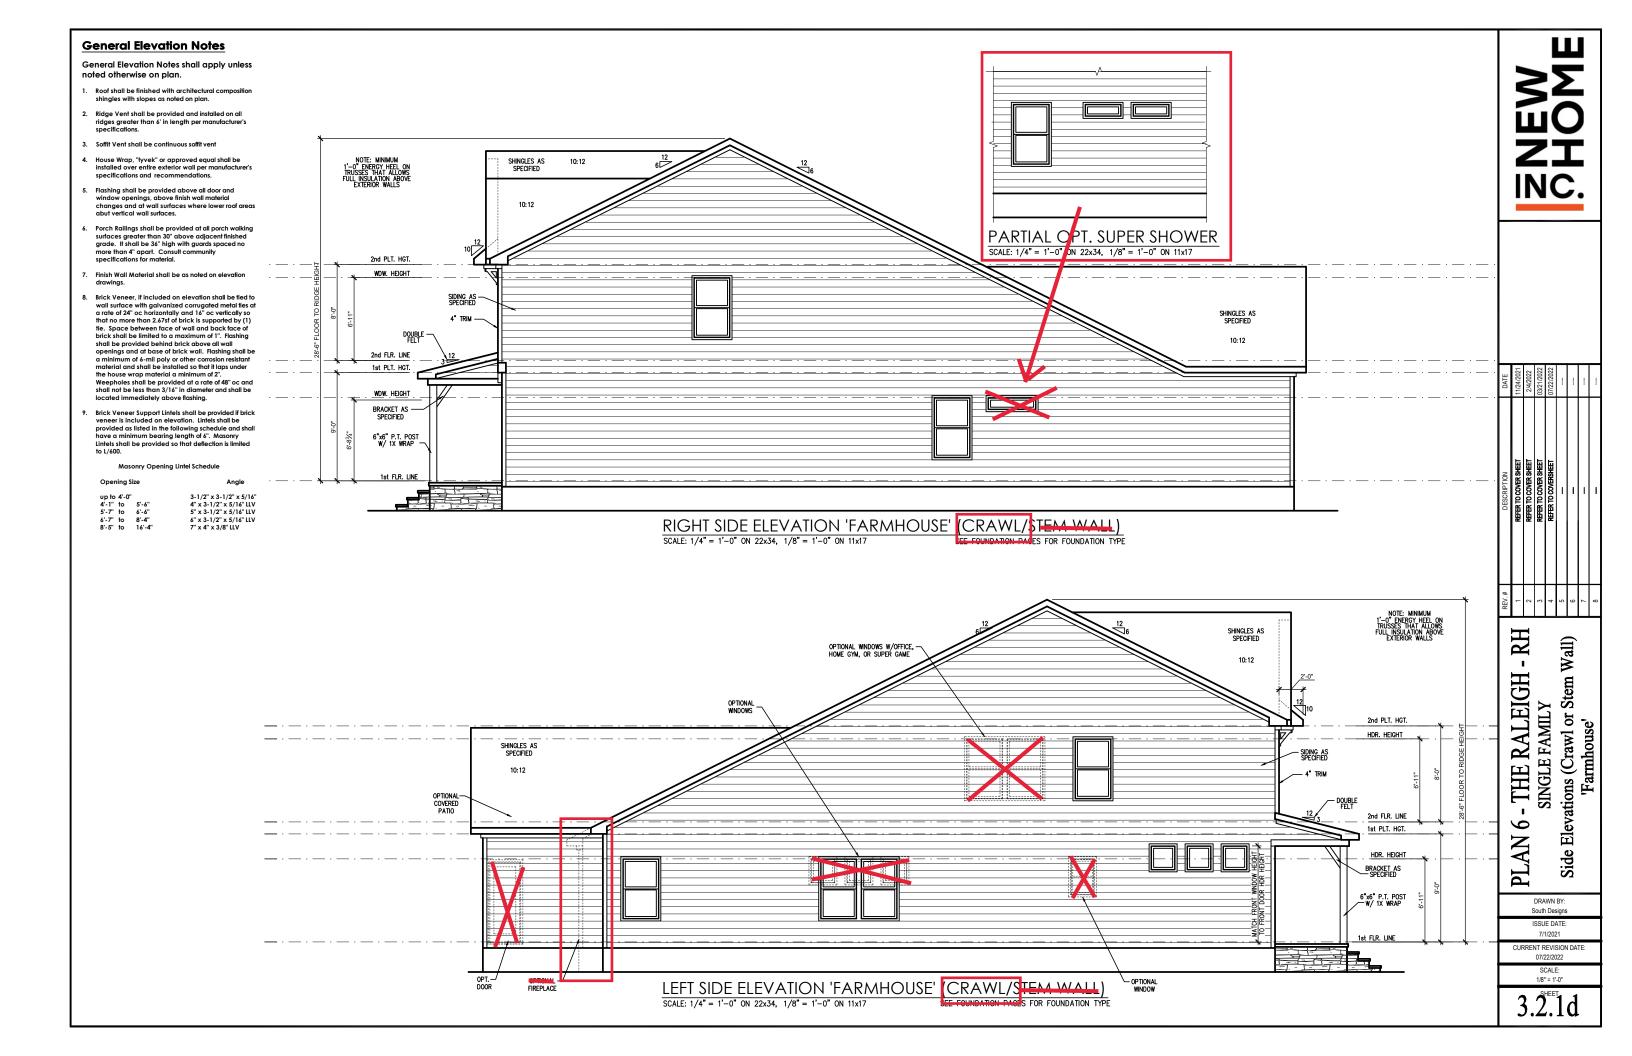

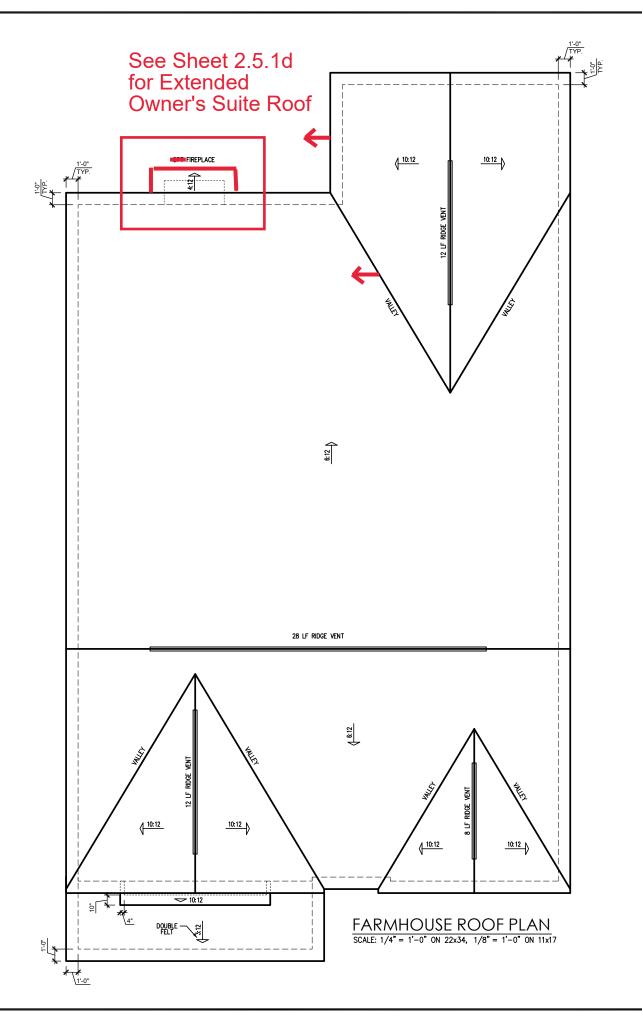

	ATTIC VENT SCHEDULE											
					FARMHOL	JSE						
MAIN	MAIN HOUSE SQ FTG 2431 AT / NEAR RIDGE AT / NEAR EAVE											
VENT TYPE	SQ. FT. VENT TYPE REQUIRED		SQ. FT.	PERCENT OF TOTAL	POT LARGE (SQ. FT. EACH)	POT SMALL (SQ. FT. EACH)	RIDGE VENT (SQ. FT. PER LF)	EAVE VENT (SQ. IN. EACH)	CONT. VENT (SQ. IN. PER LF)			
	RAN		SUPPLIED	SUPPLIED	0.4236	0.2778	0.125	0.1944	0.0625			
RIDGE VENT	RDGE VENT 3.24 4.05 7.50 72.29 0 0 60.00											
SOFFIT VENTS	4.86	4.05	2.88	27.71	0 46.00							
TOTAL (MIN)	8.10	8.10	10.38	100.00	POT VENTS MAY BE	REQUIRED IF THERE	IS INSUFFICIENT RID	GE AVAILABLE				

\* SCHEDULE HAS BEEN CALCULATED ASSUMING EAVE VENTILATION AT 50-60% OF TOTAL AND RIDGE AT 40-50% OF TOTAL REQUIRED VENTILATION

DATE	11/24/2021	2/4/2022	03/21/2022	07/22/2022				
DESCRIPTION	REFER TO COVER SHEET	REFER TO COVER SHEET	REFER TO COVER SHEET	REFER TO COVERSHEET	-	-	-	-
REV.#	1	2	3	4	5	9	7	8

PLAN 6 - THE RALEIGH - RH SINGLE FAMILY

> DRAWN BY: South Designs

ISSUE DATE: 7/1/2021

CURRENT REVISION DATE: 07/22/2022 SCALE: 1/8" = 1'-0"

3.3d

# ELECTRICAL KEY $\Rightarrow$ DUPLEX OUTLET SPLIT SWITCHED OUTLET **O** FLOOR OUTLET # QUADPLEX OUTLET ⊕<sup>GF1</sup> GROUND FAULT OUTLET GFIMP WEATHER PROOF OUTLET 220V OUTLET (5) EXAUST FAN \$ EXHAUST FAN / LIGHT **\( \)** EXHAUST FAN / HEAT LIGHT R RECESSED CAN LIGHT ledowEYEBALL LIGHT (P) VAPOR PROTECTED LIGHT CEILING LIGHT <del>-</del>6 LED DISC -(H)-HANGING CEILING LIGHT -(P)-HANGING PENDANT LIGHT Ю VANITY LIGHT WALL SCONCE LIGHT SINGLE SWITCH 3-WAY SWITCH 4-WAY SWITCH DIMMER SWITCH T۷ CABLE T.V. JACK • $\nabla$ PHONE JACK $\bigcirc$ DIRECT WIRE DATA OUTLET SMART PANEL NETWORK PANEL W/ OUTLET SMOKE DETECTOR CARBON MONOXIDE DISCONNECT SWITCH ELECTRIC METER H 2' LED LIGHT 2 BULB FLUORESCENT QQQQ VANITY LIGHTS FLOOD LIGHT O O CHIMES CEILING FAN CEILING FAN W/ LIGHT


### **General Power and Lighting:**


General Power and Lighting Notes shall apply unless noted otherwise on plans.

All work shall be installed per the current NC Residential

- Smoke Alarms Shall be provided as a minimum of (1) per floor, including basements (if applicable), (1) in each sleep room, and (1) outside each sleeping area, within steep room, and (1) obside each steeping area, within the immediate vicinity of sleeping rooms. When more than one alarm is required, the alarm devices shall be interconnected in such a manner that the activation of one alarm will activate all of the alarms. Smoke alarms shall be hard wired to permanent power and shall have
- Switches For lighting, fans, etc. shall be installed at heights illustrated on this page and shall be located a neights illustrated on this page and shall be located a minimum of 4 1/2" from door openings to allow for the proper installation of door casings. Switches, thermostats, security pads, and other similar devices shall be grouped together and installed thoughtfully for convenience of use and to avoid placement within centers of wall areas.

Note:
This plan is a diagram showing approximate locations of convenience outlets based on requirements found in the NC Residential Code and N.E.C. Actual positions may vary from what is shown on plan.

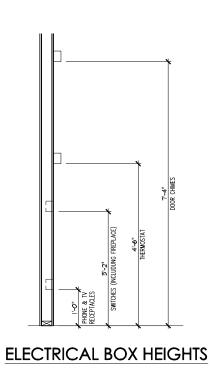

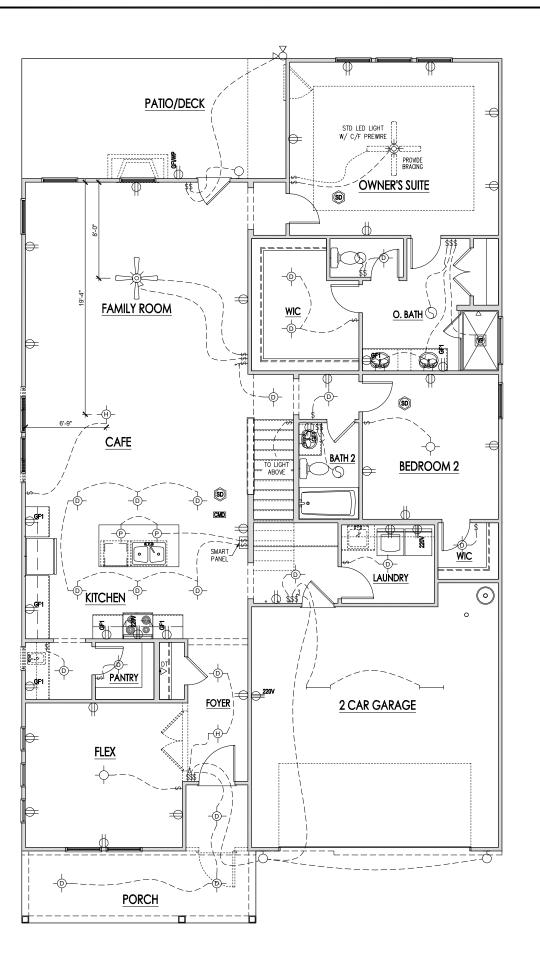

FIRST FLOOR ELECTRICAL PLAN 'FARMHOUSE'

SCALE: 1/8"=1'-0" ON 11x17, 1/4"=1'-0" ON 22x34



	REV.#	DESCRIPTION	DATE	
	1	REFER TO COVER SHEET	11/24/2021	
IN 0 - ITIE INTERIOII - INI	2	REFER TO COVER SHEET	2/4/2022	
CINICI E EANTI V	3	REFER TO COVER SHEET 0:	03/21/2022	
DINOLE I'AUVILL I	4	REFER TO COVERSHEET 0:	07/22/2022	
	2	-		
First Floor Electrical 'Farmhouse'	9	_		
THE TOO TION I WITHOUT	7	_		
	o			

PLAN

South Designs

ISSUE DATE: 7/1/2021 CURRENT REVISION DATE:

> SCALE: 1/8" = 1'-0"

# ELECTRICAL KEY DUPLEX OUTLET SPLIT SWITCHED OUTLET **©** FLOOR OUTLET # QUADPLEX OUTLET ⊕<sup>GF1</sup> GROUND FAULT OUTLET GFWP WEATHER PROOF OUTLET 220V OUTLET (2) EXAUST FAN **\( \)** EXHAUST FAN / LIGHT R RECESSED CAN LIGHT ledowEYEBALL LIGHT (P) VAPOR PROTECTED LIGHT <del>-</del> <del>-</del> <del>-</del> CEILING LIGHT -ф-LED DISC -⊕-HANGING CEILING LIGHT -**(**)-HANGING PENDANT LIGHT Ю VANITY LIGHT WALL SCONCE LIGHT \$ SINGLE SWITCH \$<sup>3</sup> 3-WAY SWITCH 4-WAY SWITCH \$<sup>D</sup> DIMMER SWITCH īν CABLE T.V. JACK • $\nabla$ PHONE JACK $\bigcirc$ DIRECT WIRE DATA OUTLET SMART SANEL NETWORK PANEL W/ OUTLET SMOKE DETECTOR CARBON MONOXIDE ELECTRICAL PANEL DISCONNECT SWITCH ELECTRIC METER 2' LED LIGHT 2 BULB FLUORESCENT QQQQ VANITY LIGHTS FLOOD LIGHT CHIMES CEILING FAN CEILING FAN W/ LIGHT


### **General Power and Lighting:**

General Power and Lighting Notes shall apply


All work shall be installed per the current NC Residential Building Code, and the National Electric Code. Alarm devices shall meet NFPA 72.


- Smoke Alarms Shall be provided as a minimum of (1) per floor, including basements (if applicable), (1) in each sleep room, and (1) outside each sleeping area, within sleep room, and (1) outside each sleeping area, within the immediate vicinity of sleeping rooms. When more than one alarm is required, the alarm devices shall be interconnected in such a manner that the activation of one alarm will activate all of the alarms. Smoke alarms shall be hard wired to permanent power and shall have
- Switches For lighting, fans, etc. shall be installed at heights illustrated on this page and shall be located a neights illustrated on this page and shall be locared a minimum of 4 1/2" from door openings to allow for the proper installation of door casings. Switches, thermostats, security pads, and other similar devices shall be grouped together and installed thoughtfully for convenience of use and to avoid placement within centers of wall areas.

This plan is a diagram showing approximate locations of convenience outlets based on requirements found in the NC Residential Code and N.E.C. Actual positions may vary from what is shown on plan.

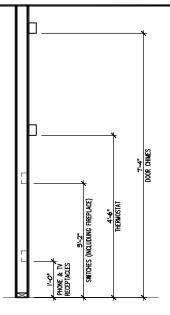


# **ELECTRICAL BOX HEIGHTS**

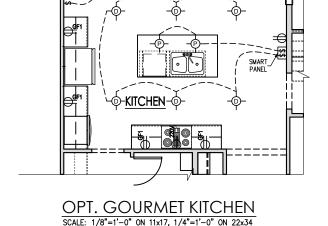


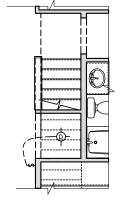


OPT. PET SPACE SCALE: 1/8"=1'-0" ON 11x17, 1/4"=1'-0" ON 22x34

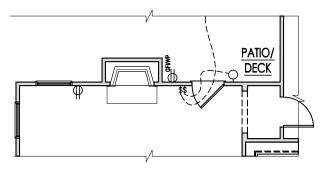

**OPT. FIREPLACE** SCALE: 1/8"=1'-0" ON 11x17, 1/4"=1'-0" ON 22x34

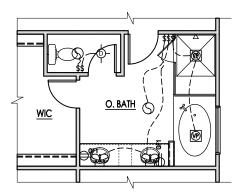



**OPT. TUB SHOWER** SCALE: 1/8"=1'-0" ON 11x17, 1/4"=1'-0" ON 22x34

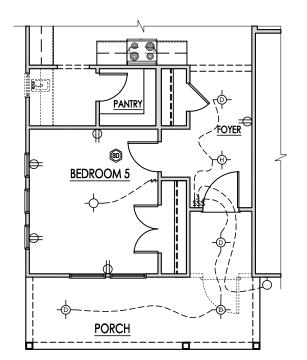


OPT. BEDROOM 5 ILO FLEX

SCALE: 1/8"=1'-0" ON 11x17, 1/4"=1'-0" ON 22x34

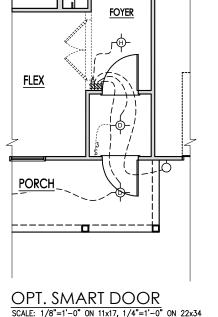


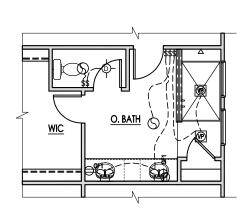

OPT. SUPER SHOWER SCALE: 1/8"=1'-0" ON 11x17, 1/4"=1'-0" ON 22x34

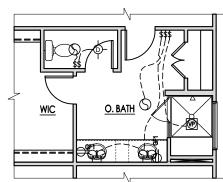

**OPT. SHOWER** SCALE: 1/8"=1'-0" ON 11x17, 1/4"=1'-0" ON 22x34

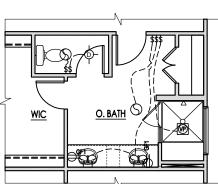

CURRENT REVISION DATE SCALE: 1/8" = 1'-0"

South Designs

ISSUE DATE: 7/1/2021

First Floor Options Electrical 'Farmhouse'

RH

.

- THE RALEIGH

9

**PLAN** 

# ELECTRICAL KEY DUPLEX OUTLET SPLIT SWITCHED OUTLET **©** FLOOR OUTLET # QUADPLEX OUTLET GROUND FAULT OUTLET GFWP WEATHER PROOF OUTLET 220V OUTLET (S) EXAUST FAN \$ EXHAUST FAN / LIGHT EXHAUST FAN / HEAT LIGHT R RECESSED CAN LIGHT ledotEYEBALL LIGHT (P) VAPOR PROTECTED LIGHT <del>-</del> 0-CEILING LIGHT ф-LED DISC -⊕-HANGING CEILING LIGHT -ф-HANGING PENDANT LIGHT Ю VANITY LIGHT 9 WALL SCONCE LIGHT \$ SINGLE SWITCH \$<sup>3</sup> 3-WAY SWITCH 4-WAY SWITCH \$<sup>D</sup> DIMMER SWITCH īν CABLE T.V. JACK · $\nabla$ PHONE JACK $\bigcirc$ DIRECT WIRE DATA OUTLET SMART PANEL NETWORK PANEL W/ OUTLET SMOKE DETECTOR CARBON MONOXIDE ELECTRICAL PANEL DISCONNECT SWITCH ELECTRIC METER → 2' LED LIGHT 2 BULB FLUORESCENT QQQQ VANITY LIGHTS FLOOD LIGHT CEILING FAN CEILING FAN W/ LIGHT


### **General Power and Lighting:**


General Power and Lighting Notes shall apply

All work shall be installed per the current NC Residential Building Code, and the National Electric Code. Alarm devices shall meet NFPA 72.

- Smoke Alarms Shall be provided as a minimum of (1) per floor, including basements (if applicable), (1) in each sleep room, and (1) outside each sleeping area, within the immediate vicinity of sleeping rooms. When more than one alarm is required, the alarm devices shall be interconnected in such a manner that the activation of one alarm will activate all of the alarms. Smoke alarms shall be hard wired to permanent power and shall have
- Switches For lighting, fans, etc. shall be installed at heights illustrated on this page and shall be located a minimum of 4 1/2" from door openings to allow for the proper installation of door casings. Switches, thermostals, security pads, and other similar devices shall be grouped together and installed thoughtfully for convenience of use and to avoid placement within centers of wall areas.

Note:
This plan is a diagram showing approximate locations of convenience outlets based on requirements found in the NC Residential Code and N.E.C. Actual positions may vary from what is shown on plan.

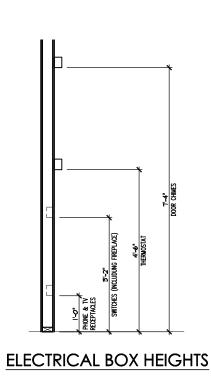

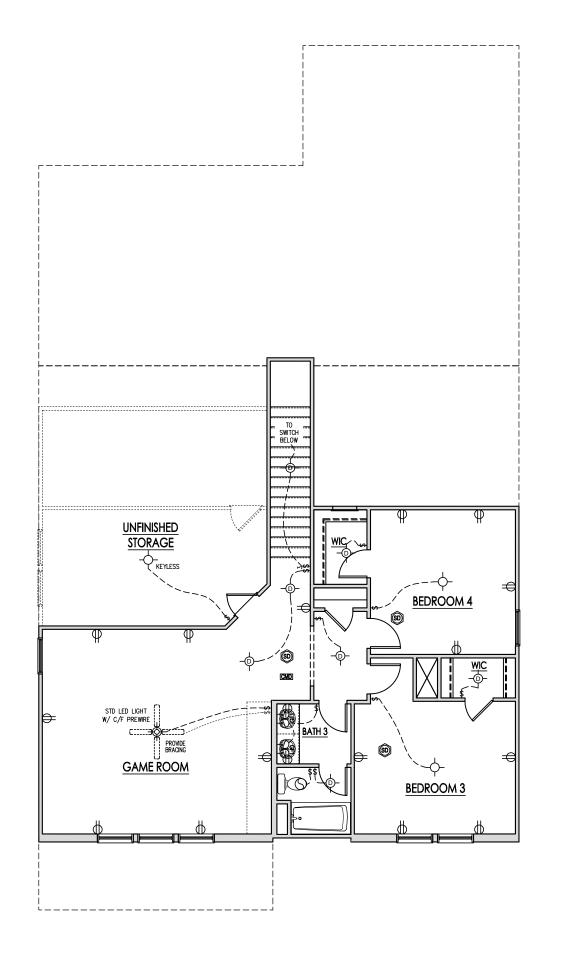

NOIT	/ER SHEET	/ER SHEET	/ER SHEET	VERSHEET				
DESCRIPTION	REFER TO COVER SHEET	REFER TO COVER SHEET	REFER TO COVER SHEET	REFER TO COVERSHEET				
REV.#	1	2	3	4	5	9	7	8

Second Floor Electrical 'Farmhouse' - THE RALEIGH 9 PLAN

South Designs

ISSUE DATE: 7/1/2021 CURRENT REVISION DATE

> SCALE: 1/8" = 1'-0"

5.2d

SECOND FLOOR ELECTRICAL PLAN 'FARMHOUSE' SCALE: 1/8"=1'-0" ON 11x17, 1/4"=1'-0" ON 22x34

### ELECTRICAL KEY DUPLEX OUTLET $\Rightarrow$ SPLIT SWITCHED OUTLET **©** FLOOR OUTLET # QUADPLEX OUTLET GROUND FAULT OUTLET GFWP WEATHER PROOF OUTLET 220V OUTLET (S) **EXAUST FAN** \$ EXHAUST FAN / LIGHT EXHAUST FAN / HEAT LIGHT R RECESSED CAN LIGHT ledotEYEBALL LIGHT (P) VAPOR PROTECTED LIGHT <del>-</del> 0-CEILING LIGHT ф-LED DISC -⊕-HANGING CEILING LIGHT -ф-HANGING PENDANT LIGHT Ю VANITY LIGHT 9 WALL SCONCE LIGHT \$ SINGLE SWITCH \$<sup>3</sup> 3-WAY SWITCH 4-WAY SWITCH \$<sup>D</sup> DIMMER SWITCH īν CABLE T.V. JACK · BUTTON $\nabla$ PHONE JACK $\bigcirc$ DIRECT WIRE DATA OUTLET SMART PANEL NETWORK PANEL W/ OUTLET SMOKE DETECTOR CARBON MONOXIDE DETECTOR ELECTRICAL PANEL DISCONNECT SWITCH ELECTRIC METER → 2' LED LIGHT 2 BULB FLUORESCENT QQQQ VANITY LIGHTS FLOOD LIGHT CHIMES CEILING FAN CEILING FAN W/ LIGHT


### **General Power and Lighting:**


General Power and Lighting Notes shall apply unless noted otherwise on plans.

All work shall be installed per the current NC Residential Building Code, and the National Electric Code. Alarm devices shall meet NFPA 72.


- Smoke Alarms Shall be provided as a minimum of (1) per floor, including basements (if applicable), (1) in each sleep room, and (1) outside each sleeping area, within the immediate vicinity of sleeping rooms. When more than one alarm is required, the alarm devices shall be interconnected in such a manner that the activation of one alarm will activate all of the alarms. Smoke alarms shall be hard wired to permanent power and shall have
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Note:
This plan is a diagram showing approximate locations of convenience outlets based on requirements found in the NC Residential Code and N.E.C. Actual positions may vary from what is shown on plan.



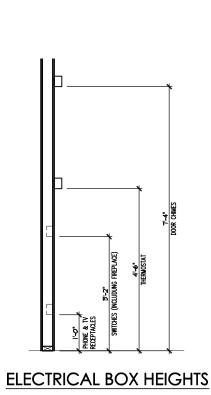

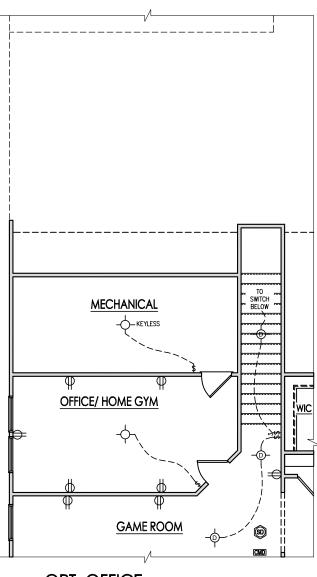

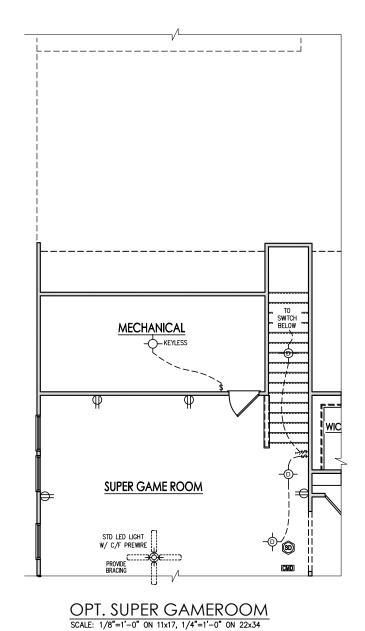


		NALLIOIT - INI	CINCI E EAMII V	raville I	Second Floor Ontions Flectrical	AIOUS LICOLIVAI	nonse'	200
REV.#	-	2	3	4	9	9	2	8
DESCRIPTION	REFER TO COVER SMEET	REFER TO COVER SHEET	REFER TO COVER SHEET	REFER TO COVERSHEET	-	-	-	ı
	11/24/202	2/4/2022	03/21/2022	07/22/2022				

**PLAN** South Designs

ISSUE DATE: 7/1/2021

CURRENT REVISION DATE SCALE: 1/8" = 1'-0"

5.2.1d

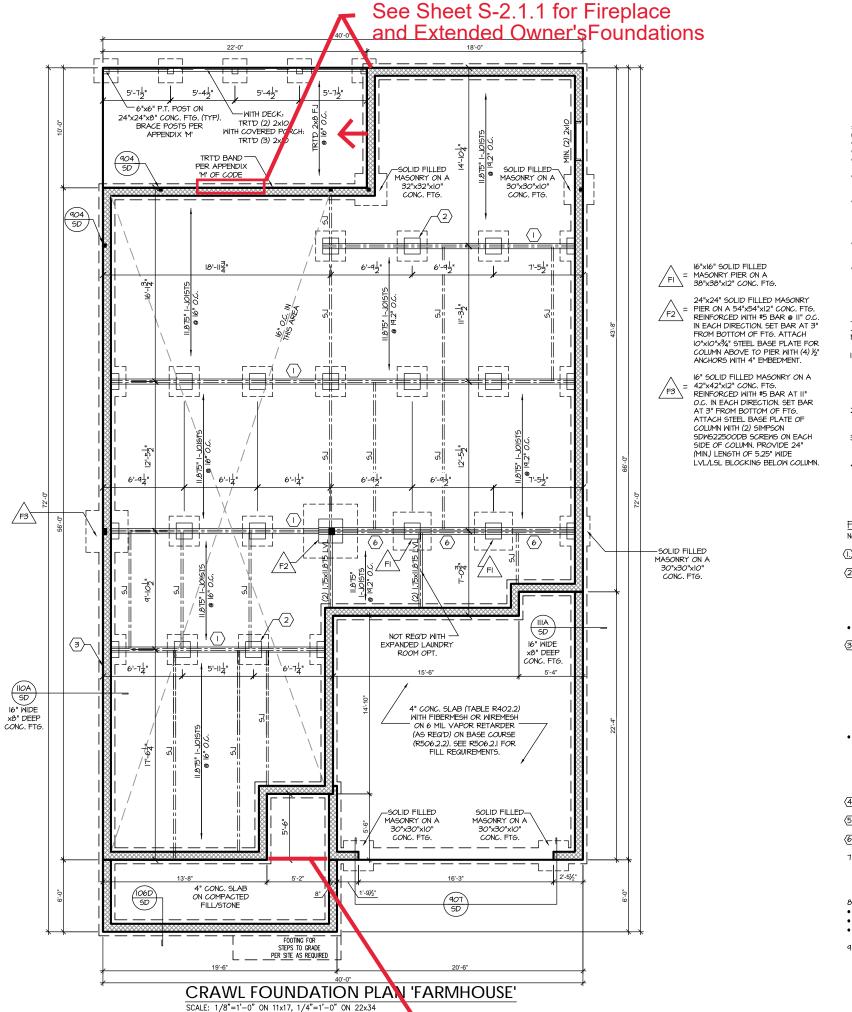



**MOOD I-JOISTS** 

(SHALL BE ONE OF THE FOLLOWING):

TJI 210 BY TRUS JOIST

- IPI 20 PI I/S BY I P
- ALL WOOD 1-JOISTS SHALL BE INSTALLED ACCORDING TO MANUFACTURER'S SPECIFICATIONS.
- INSTALL SQUASH BLOCKS, WEB STIFFENERS, ETC. AS REQUIRED BY AND ACCORDING TO THE I-JOIST MANUFACTURER'S SPECIFICATIONS AND
- HANGERS FOR I-JOISTS ARE THE RESPONSIBILITY OF THE I-JOIST SUPPLIER.
- FLOOR TRUSSES BY MANUFACTURER MAY BE SUBSTITUTED FOR I-JOISTS.

### TRUSS SYSTEM REQUIREMENTS NC (2018 NCRC): Wind: 115-120 mpt

- TRUSS SYSTEM LAYOUTS (PLACEMENT PLANS) SHALL BE DESIGNED IN ACCORDANCE WITH SEALED STRUCTURAL PLANS. ANY NEED TO CHANGE TRUSSES SHALL BE COORDINATED WITH SOUTHERN
- TRUSS SCHEMATICS (PROFILES) SHALL BE PREPARED AND SEALED BY TRUSS MANUFACTURER.
- ALL TRUSSES SHALL BE DESIGNED FOR BEARING ON SPF #2 OR #3 PLATES OR LEDGERS (UNO).
- ALL REQUIRED ANCHORS FOR TRUSSES DUE TO UPLIFT OR BEARING SHALL MEET THE REQUIREMENTS AS SPECIFIED ON THE TRUSS

### FOUNDATION STRUCTURAL NOTES NC (2018 NCRC): Wind: 115-120 mph - CRAWL

- (3)2xIO SYP#2 OR SPF#2 GIRDER, TYPICAL UNO.
- CONCRETE BLOCK PIER SIZE SHALL BE: HOLLOW UP TO 32" <u>SOLID</u> UP TO 5'-0" 8xl6
- UP TO 64" UP TO 12'-0" UP TO 96" 24x24
- WITH 30"  $\times$  30"  $\times$  10" CONCRETE FOOTING, UNO.
- 3> 8" - UP TO 2 STORY 10" - 3 STORY
- 16" UP TO 2 STORY SIDING: 16" - I STORY 20" - 2 STORY
- FOR FOUNDATION WALL HEIGHT AND BACKFILL REQUIREMENTS, REFER TO CODE TABLE R404.I.I (I THRU 4) NOTE: ASSUMED SOIL BEARING CAPACITY = CONDITIONS AND CONTACT SOILS ENGINEER IF MARGINAL OR UNSTABLE SOILS ARE ENCOUNTERED.

24" - 3 STORY

- (4) 2xIO SPF #2 OR SYP #2 GIRDER
- (2) 1.75×4.25 LVL OR LSL GIRDER
- (3) 1.75×9.25 LVL OR LSL GIRDER
- "" DESIGNATES A SIGNIFICANT POINT LOAD TO HAVE SOLID BLOCKING TO PIER. SOLID BLOCK ALL BEAM BEARING POINTS NOTED TO HAVE THREE OR MORE STUDS TO FND, TYPICAL.
- ABBREVIATIONS:
- "SJ" = SINGLE JOIST "DJ" = DOUBLE JOIST
- "TJ" = TRIPLE JOIST
- ADJUST SUBFLOOR THICKNESS OR JOIST SPACING AS REQ'D FOR FLOOR FINISH MATERIALS.

PROJECT #

21-2818-RH


**P.A.** 27609


Engineers, Drive, Raleigh, NC Southern Engi 3716 Benson Drive, Ra Phone: (919) 8


SOUTH DESIGNS


RH 90

REFER TO "SD" SHEET(S) FOR STANDARD DETAILS BRACING

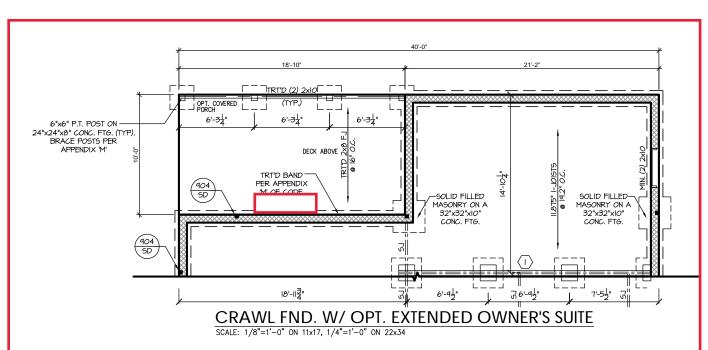

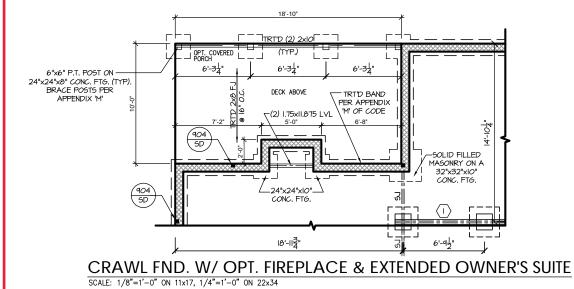

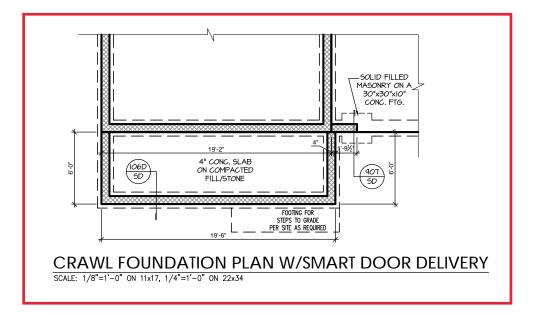

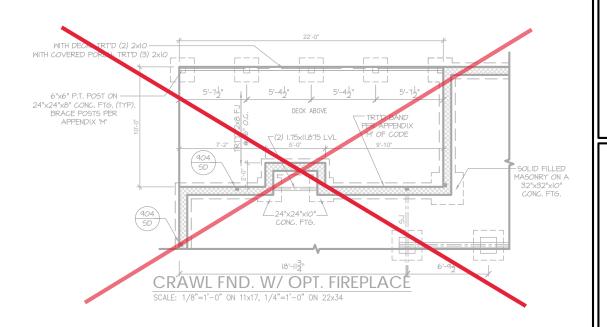


REFER TO "SD" SHEET(S) FOR STANDARD DETAILS, BRACING DETAILS AND STRUCTURAL NOTES. PROJECT # 21-2818-RH

P.A. 27609 Southern Engineers, P 3716 Benson Drive, Raleigh, NC 27 Phone: (919) 878-1617 License: C-4772 www.southernengineers.com

SOUTH DESIGNS

RH The Raleigh NEW HOME, INC. Plan 06

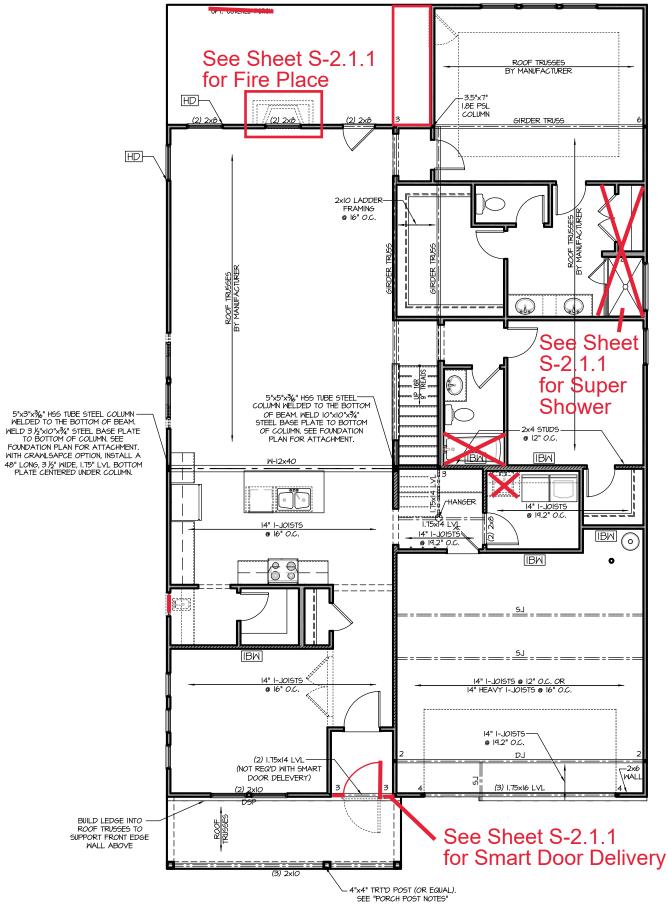

### **MOOD I-JOISTS**

(SHALL BE ONE OF THE FOLLOWING):

• TJI 210 BY TRUS JOIST

- LPI 20 PLUS BY LP
- BCI 50005 I.8 BY BC
- ALL WOOD I-JOISTS SHALL BE INSTALLED ACCORDING TO MANUFACTURER'S SPECIFICATIONS
- INSTALL SQUASH BLOCKS, WEB STIFFENERS, ETC AS REQUIRED BY AND ACCORDING TO THE I-JOIST MANUFACTURER'S SPECIFICATIONS AND
- HANGERS FOR I-JOISTS ARE THE RESPONSIBILITY OF THE I-JOIST SUPPLIER.
- FLOOR TRUSSES BY MANUFACTURER MAY BE SUBSTITUTED FOR I-JOISTS.

### TRUSS SYSTEM REQUIREMENTS

NC (2018 NCRC): Wind: 115-120 mph

- TRUSS SYSTEM LAYOUTS (PLACEMENT PLANS) SHALL BE DESIGNED IN ACCORDANCE WITH SEALED STRUCTURAL PLANS. ANY NEED TO CHANGE TRUSSES SHALL BE COORDINATED WITH SOUTHERN
- TRUSS SCHEMATICS (PROFILES) SHALL BE PREPARED AND SEALED BY TRUSS MANUFACTURER
- ALL TRUSSES SHALL BE DESIGNED FOR BEARING ON SPF #2 OR #3 PLATES OR LEDGERS (UNO)
- ALL REQUIRED ANCHORS FOR TRUSSES DUE TO UPLIFT OR BEARING SHALL MEET THE REQUIREMENTS AS SPECIFIED ON THE TRUSS SCHEMATICS.

# PORCH POST NOTES:

- 4"x4" (6"x6") TRT'D POST (OR EQUAL). ATTACH TRUSSES (RAFTERS) AT PORCH WITH
- HURRICANE CONNECTORS. POST CAP: SIMPSON AC4-MAX (AC6-MAX) POST CAP AT CORNER: (2) SIMPSON LCE4
- (MITER HEADER AT CORNER). HIGH WIND; ADD (1) 3. POST BASE: SIMPSON ABU44 (ABU66).
- MONO: 5% ANCHOR (EMBED 1")

  CM: 5% ANCHOR (EXTEND TO FOOTING HIGH WIND ONLY)
- POST BASE: WOOD FOUNDATION: (2) SIMPSON CSI6 STRAPS AT POSTS. EXTEND 12" ONTO EACH POST (UPPER AND LOWER) OR TO GIRDER
- NOTE: EQUIVALENT POST CAP AND BASE ACCEPTABLE.

### HEADER/BEAM & COLUMN NOTES

- ALL EXTERIOR AND LOAD BEARING HEADERS SHALL BE MIN. (2)2x6 (4" WALL) OR (3)2x6 (6" WALL) WITH (1) SUPPORT STUD, UNLESS NOTED OTHERWISE.
- 2. THE NUMBER SHOWN AT BEAM AND HEADER SUPPORTS INDICATES THE NUMBER OF SUPPORT STUDS REQUIRED IN STUD POCKET OR COLUMN. THE NUMBER OF KING STUDS AT EACH END OF HEADERS IN EXTERIOR WALLS SHALL BE ACCORDING TO ITEM "d" IN TABLE R602.3(5) OR AS BELOW PER NCDOI COMMENTARY "KING STUDS AT WALL OPENINGS" REVISED I-9-2020: UP TO 3' SPAN: (I) KING STUD
- OVER 3' UP TO 6' SPAN: (2) KING STUDS
- OVER 6' UP TO 9' SPAN: (3) KING STUDS OVER 9' UP TO 12' SPAN: (4) KING STUDS
- OVER 12' UP TO 15' SPAN: (5) KING STUDS

### FRAMING NOTES

NC (2018 NCRC): Wind: 115-120 mph

- BRACING METHOD AND TYPE: CONTINUOUSLY SHEATHED WSP: CS-MSP. NOTE THAT THE WALL BRACKING AMOUNT PROVIDED ON THE PLANS (DETAILS AND SPECIFICATIONS) IS GREATER THAN THE AMOUNT OF WALL BRACING REQUIRED BY SECTION R602.10 OF THE CODE. SEE NOTES BELOW FOR DETAILS AND SPECIFICATIONS FOR WALL BRACING AND WALL FRAMING
- EXTERIOR WALL SHEATHING: WALLS SHALL BE BRACED BY SHEATHING WALLS ON ALL STORIES WITH WOOD STRUCTURAL PANEL SHEATHING (WSP) (EXPOSURE B: 7/16", EXPOSURE C: 15/32"). SHEATHING SHALL BE ATTACHED WITH 8d NAILS AT A 6"/12" NAILING PATTERN (6" OC AT PANEL EDGES AND 12" OC AT INTERMEDIATE SUPPORTS). INSTALL BLOCKING AT ALL PANEL EDGES
- WSP SHEATHING SHALL EXTEND TO THE UPPERMOST DOUBLE BEARING PLATE. BLOCK AT ROOF PER SECTION R602.10.4.5 AND ATTACH BRACED WALLS PER CODE. MSP SHEATHING BETWEEN FLOORS SHALL BE SPLICED ALONG CONTINUOUS BAND OR THE WSP SHEATHING MAY BE SPLICED ACROSS STUDS (CONTINUOUS ACROSS FLOOR SYSTEM) WITH BLOCKING AT PANEL EDGES (MINIMUM 12" BEYOND FLOOR BREAK) OR OTHER APPROVED METHOD.
- "HD" = HOLDOWN: HOLD-DOWN DEVICE (NOTED AS "HD" ON PLANS) SHALL BE AN 800 POUND CAPACITY ASSEMBLY AS NOTED ON
- PLANS, SEE DETAILS FOR HD ASSEMBLY.

  \*\*GROUND/FIRST FLOOR: USE "HD HOLD-DOWN DETAIL" ON SD
- \*\*UPPER FLOORS: ATTACH BASE OF KING STUD WITH A SIMPSON C522 STRAP DOWN ACROSS THE BAND AND DOWN TO A STUD BELOW OR HEADER BELOW. EXTEND STRAP 7" MIN ALONG EACH STUD (OR HEADER) AND ATTACH EACH END W (7) 8d NAILS.
- INTERIOR BRACED WALL: (NOTED AS "I<u>BM</u>" ON PLANS) ATTACH I/2" GYPSUM BOARD (GB) ON EACH SIDE OF WALL WITH A MIN. OF 5d COOLER NAILS OR #6 SCREWS @ 7" O.C. ALONG THE EDGES AND AT
- INTERIOR BRACED WALL-WOOD STRUCTURAL PANEL: (NOTED AS "IBW-MSP" ON PLANS). ATTACH ONE SIDE MITH %" MSP SHEATHING MITH 8d NAILS AT A 6"/12" NAILING PATTERN (6" OC AT PANEL EDGES AND 12" OC AT INTERMEDIATE SUPPORTS), INSTALL BLOCKING AT ALL PANEL EDGES, ATTACH 6B OVER MSP AS REQUIRED, ATTACH OPPOSITE SIDE WITH 1/2" 6B WITH A MIN. OF 5d COOLER NAILS OR #6 SCREWS @ 7" OC ALONG THE EDGES AND AT

PROJECT # 21-2818-RH

e to be brought to the . Failure to do so will one year from date of seal. oval of terms & conditions

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P.A. 27609 Engineers, Drive, Raleigh, NC ?

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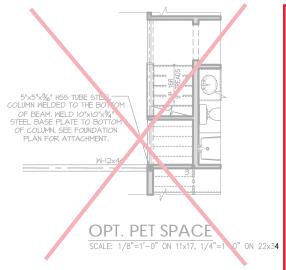
SOUTH DESIGNS


RH Raleigh HOME, 9


REFER TO "SD" SHEET(S) FOR STANDARD DETAILS BRACING

DETAILS AND STRUCTURAL NOTES.

FIRST FLOOR FLOORING PLAN 'FARMHOUSE' SCALE: 1/8"=1'-0" ON 11x17, 1/4"=1'-0" ON 22x34



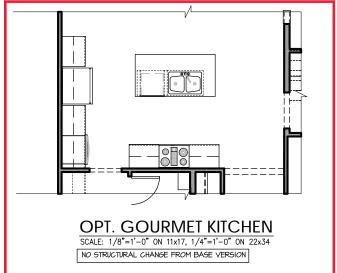

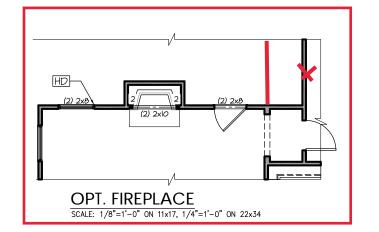






OPT. TUB SHOWER SCALE: 1/8"=1'-0" ON 11x17, 1/4"=1


OPT. SHOWER

SCALE: 1/8"=1'-0" ON 11x17, 1/4"=1'-0" ON 22x34

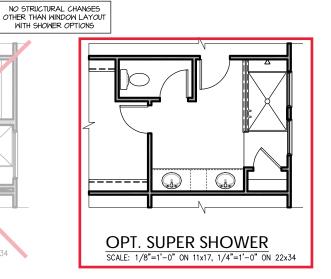

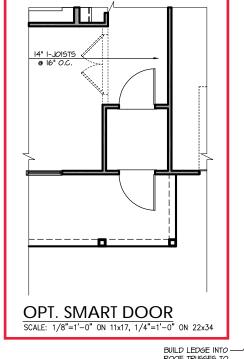

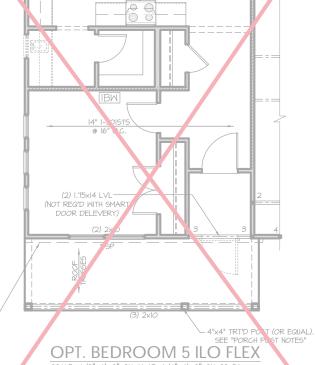

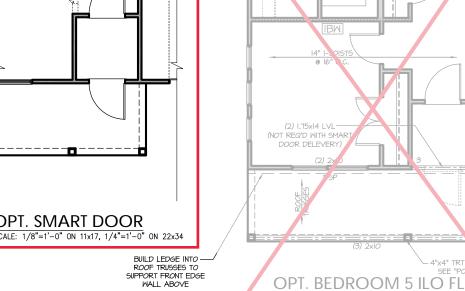

REFER TO "SD" SHEET(S) FOR STANDARD DETAILS, BRACING DETAILS AND STRUCTURAL NOTES.

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SOUTH DESIGNS

- RH - The Raleigh NEW HOME, INC. Plan 06



### TRUSS SYSTEM REQUIREMENTS

NC (2018 NCRC): Wind: 115-120 mph

- TRUSS SYSTEM LAYOUTS (PLACEMENT PLANS) SHALL BE DESIGNED IN ACCORDANCE WITH SEALED STRUCTURAL PLANS. ANY NEED TO CHANGE TRUSSES SHALL BE COORDINATED WITH SOUTHERN
- TRUSS SCHEMATICS (PROFILES) SHALL BE PREPARED AND SEALED BY TRUSS MANUFACTURER.
- ALL TRUSSES SHALL BE DESIGNED FOR BEARING ON SPF #2 OR #3 PLATES OR LEDGERS (UNO).
- ALL REQUIRED ANCHORS FOR TRUSSES DUE TO UPLIFT OR BEARING SHALL MEET THE REQUIREMENTS AS SPECIFIED ON THE TRUSS SCHEMATICS.

### HEADER/BEAM & COLUMN NOTES

- ALL EXTERIOR AND LOAD BEARING HEADERS SHALL BE MIN. (2)2x6 (4" WALL) OR (3)2x6 (6" WALL) WITH (I) SUPPORT STUD, UNLESS NOTED OTHERWISE.
- 2. THE NUMBER SHOWN AT BEAM AND HEADER SUPPORTS INDICATES THE NUMBER OF SUPPORT STUDS REQUIRED IN STUD POCKET OR COLUMN. THE NUMBER OF KING STUDS AT EACH END OF HEADERS IN EXTERIOR WALLS SHALL BE ACCORDING TO ITEM
  "d" IN TABLE R602.3(5) OR AS BELOW PER NCDOI COMMENTARY "KING STUDS AT WALL OPENINGS" REVISED 1-9-2020:
- UP TO 3' SPAN: (I) KING STUD
- OVER 3' UP TO 6' SPAN: (2) KING STUDS
- OVER 6' UP TO 9' SPAN: (3) KING STUDS OVER 9' UP TO 12' SPAN: (4) KING STUDS
- OVER 12' UP TO 15' SPAN: (5) KING STUDS

# FRAMING NOTES

- BRACING METHOD AND TYPE: CONTINUOUSLY SHEATHED WSP: CS-MSP. NOTE THAT THE WALL BRACING AMOUNT PROVIDED ON THE PLANS (DETAILS AND SPECIFICATIONS) IS GREATER THAN THE AMOUNT OF WALL BRACING REQUIRED BY SECTION R602.10 OF THE CODE, SEE NOTES BELOW FOR DETAILS AND SPECIFICATIONS FOR WALL BRACING AND WALL FRAMING
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- WSP SHEATHING SHALL EXTEND TO THE UPPERMOST DOUBLE BEARING PLATE. BLOCK AT ROOF PER SECTION R602.10.4.5 AND ATTACH BRACED WALLS PER CODE. MSP SHEATHING BETWEEN FLOORS SHALL BE SPLICED ALONG CONTINUOUS BAND OR THE WSP SHEATHING MAY BE SPLICED ACROSS STUDS (CONTINUOUS ACROSS FLOOR SYSTEM) WITH BLOCKING AT PANEL EDGES. (MINIMUM 12"
- \*\*UPPER FLOORS: ATTACH BASE OF KING STUD WITH A SIMPSON STUD (OR HEADER) AND ATTACH EACH END W (7) 8d NAILS.
- 5. INTERIOR BRACED WALL: (NOTED AS "IBW" ON PLANS) ATTACH I/2" GYPSUM BOARD (GB) ON EACH SIDE OF WALL WITH A MIN. OF 5d COOLER NAILS OR #6 SCREWS @ 7" O.C. ALONG THE EDGES AND AT
- INTERIOR BRACED WALL-WOOD STRUCTURAL PANEL: (NOTED AS "IBW-WSP" ON PLANS), ATTACH ONE SIDE WITH %" MSP SHEATHING WITH 8d NAILS AT A 6"/12" NAILING PATTERN (6" OC AT PANEL EDGES AND 12" OC AT INTERMEDIATE SUPPORTS), INSTALL BLOCKING AT ALL PANEL EDGES, ATTACH 6B OVER MSP AS REQUIRED, ATTACH OPPOSITE SIDE WITH 1/2" 6B WITH A MIN. OF 5d

NC (2018 NCRC): Wind: 115-120 mph

- SHEATHING SHALL BE ATTACHED WITH 8d NAILS AT A 6"/12" NAILING PATTERN (6" OC AT PANEL EDGES AND 12" OC AT INTERMEDIATE
- BEYOND FLOOR BREAK) OR OTHER APPROVED METHOD.
- "HD" = HOLDOWN: HOLD-DOWN DEVICE (NOTED AS "HD" ON PLANS) SHALL BE AN 800 POUND CAPACITY ASSEMBLY AS NOTED ON PLANS. SEE DETAILS FOR HD ASSEMBLY.
- \*\*GROUND/FIRST FLOOR: USE "HD HOLD-DOWN DETAIL" ON SD
- CS22 STRAP DOWN ACROSS THE BAND AND DOWN TO A STUD BELOW OR HEADER BELOW. EXTEND STRAP 7" MIN ALONG EACH
- COOLER NAILS OR #6 SCREWS @  $7^{\circ}$  OC ALONG THE EDGES AND AT INTERMEDIATE SUPPORTS.

SOUTH DESIGNS

RH Raleigh 9

REFER TO "SD" SHEET(S) FOR STANDARD DETAILS BRACING

DETAILS AND STRUCTURAL NOTES.

+/-8'-0" CLG HT W/O FURRING

TRUSS SUPPORT

MANUFACTURE

LADDER

a 16" 0 (

LINE OF WALLS BELOW

+/-8'-0" CLG HT W/O FURRING

TRUSS SUPPORT

See Sheet S-2.2.1

for Gym

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P.A. 27609

PROJECT # 21-2818-RH

LINE OF WALLS BELOW LINE OF WALLS BELOW +/-8'-0" CLG HT W/O FURRING +/-8'-0" CL HT W/O FURRING ROOF TRUSSES 3Y MANUFACTURER OPT. OFFICE OPT. SUPER GAMEROOM OPT. HOME GYM
SCALE: 1/8"=1'-0" ON 11x17, 1/4"=1'-0" ON 22x34 SCALE: 1/8"=1'-0" ON 11x17, 1/4"=1'-0" ON 22x34


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SOUTH DESIGNS

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S-2.2.1





### TRUSS SYSTEM REQUIREMENTS NC (2018 NCRC): Wind: 115-120 mph

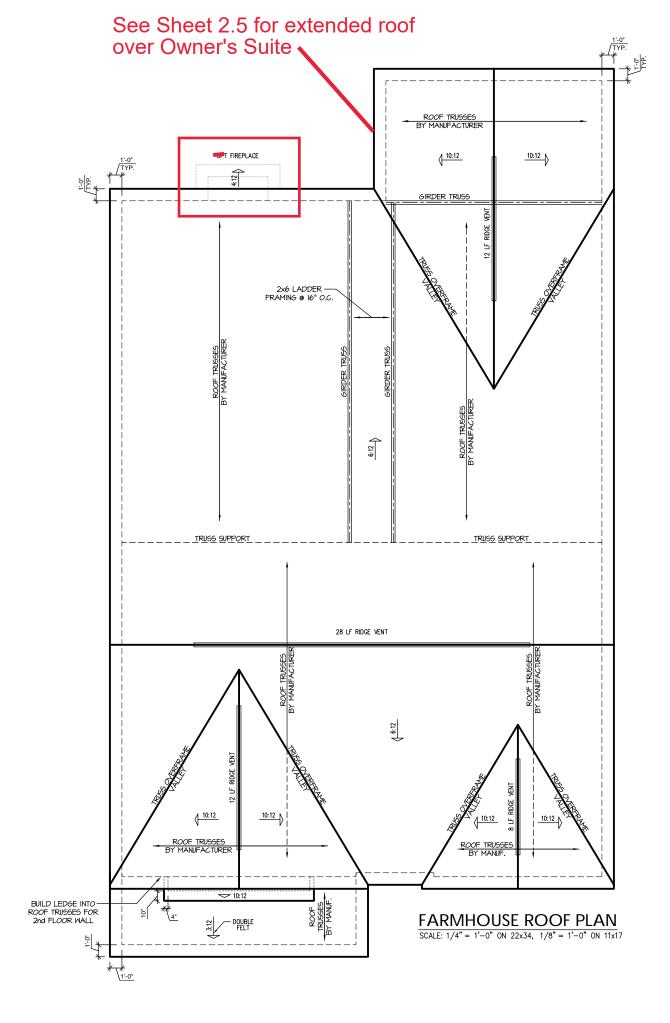- TRUSS SYSTEM LAYOUTS (PLACEMENT PLANS) SHALL BE DESIGNED IN ACCORDANCE WITH SEALED STRUCTURAL PLANS, ANY NEED TO CHANGE TRUSSES SHALL BE COORDINATED WITH SOUTHERN ENGINEERS.
- TRUSS SCHEMATICS (PROFILES) SHALL BE PREPARED AND SEALED BY TRUSS MANUFACTURER.
- ALL TRUSSES SHALL BE DESIGNED FOR BEARING ON SPF #2 OR #3 PLATES OR LEDGERS (UNO).
- ALL REQUIRED ANCHORS FOR TRUSSES DUE TO UPLIFT OR BEARING SHALL MEET THE REQUIREMENTS AS SPECIFIED ON THE TRUSS

ATTIC VENT SCHEDULE											
FARMHOUSE											
MAIN HOUSE SQ FTG 2431 AT / NEAR RIDGE AT / NEAR B								AR EAVE			
SQ. FT.		SQ. FT.	PERCENT OF TOTAL	POT LARGE (SQ. FT. EACH)	POT SMALL (SQ. FT. EACH)	RIDGE VENT (SQ. FT. PER LF)	EAVE VENT (SQ. IN. EACH)	CONT. VEN (SQ. N. PER LF)			
	RAN		SUPPLIED	SUPPLIED 0.4236 0.2778			0.125	0.1944	0.0625		
RIDGE VENT	3.24	4.05	7.50	72.29	0	0	60.00				
SOFFIT VENTS	4.86	4.05	2.88	27.71	0 46						
TOTAL (MIN)	8.10	8.10	10.38	100.00	POT VENTS MAY BE REQUIRED IF THERE IS INSUFFICIENT RIDGE AVAILABLE						

\* SCHEDULE HAS BEEN CALCULATED ASSUMING EAVE VENTILATION AT 50-60% OF TOTAL AND RIDGE AT 40-50% OF TOTAL REQUIRED VENTILATION


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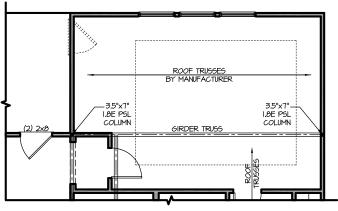
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RH The Raleigh Plan 06





EXTENDED OWNER'S SUITE FLOOR PLAN

SCALE: 1/8"=1'-0" ON 11x17, 1/4"=1'-0" ON 22x34
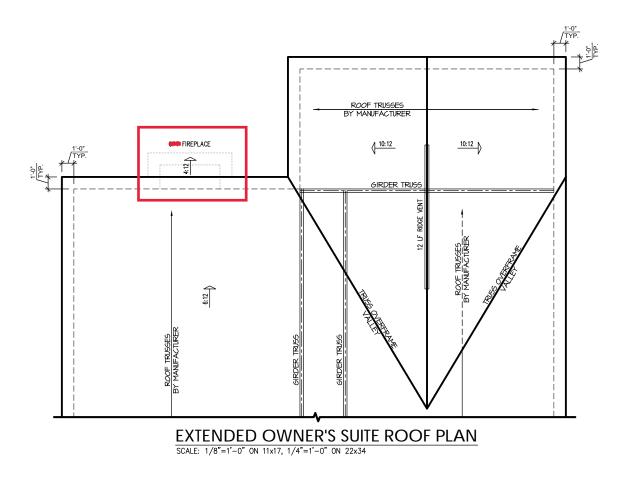
# TRUSS SYSTEM REQUIREMENTS

NC (2018 NCRC): Wind: 115-120 mph

- . TRUSS SYSTEM LAYOUTS (PLACEMENT PLANS)
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  TRUSSES SHALL BE COORDINATED WITH SOUTHERN
  ENGINEERS.
- TRUSS SCHEMATICS (PROFILES) SHALL BE
  PREPARED AND SEALED BY TRUSS MANUFACTURER.
- ALL TRUSSES SHALL BE DESIGNED FOR BEARING ON SPF #2 OR #3 PLATES OR LEDGERS (UNO).
- 4. ALL REQUIRED ANCHORS FOR TRUSSES DUE TO UPLIFT OR BEARING SHALL MEET THE REQUIREMENTS AS SPECIFIED ON THE TRUSS SCHEMATICS.



REFER TO "5D" SHEET(5) FOR STANDARD DETAILS, BRACING DETAILS AND STRUCTURAL NOTES. PROJECT # 21-2818-RH

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11.
s not include construction means, methods, technic
s., procedures or safety precautions.
iations or discrepancies on plans are to be brought
te attention of Southern Engineers. Failure to do so
them Engineer's liability.

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S-2.5