REVISION LOG

DATE: 11/24/21

- 6x6 © COVERED PORCH, PACK OUT BEAM.
 CHANGE WALL BETWEEN PANTRY/ COAT CLOSET TO A 2X6 WALL.
 NOTE 3/0 C.O. "3/0X6/8 C.O.".
- 4. CHANGE WALL BETWEEN KITCHEN COUNTER & MESSY KITCHEN TO 28" LENGTH.

- 4. CHANGE WALL BETWEEN KITCHEN COUNTER & MESSY KITCHEN TO 28" LENGTH.
 LOCATE / 2/8X6/8 C.O. © END OF THE WALL.

 5. ADD (3) OPT 2/0X2/0 @ CAFE, CENTERED @ 21'-4" FRONT REAR WALL.

 6. CHANGE IST FLOOR STAIR RAIL AND WALL FROM A 2X4 WALL TO A 2X6 WALL.

 SLIDE BATH #2 WALL 2" TO MAINTAN 3'-4" STAIR WIDTH. ADJUSTED WALL AND STAIR ON THE 2ND FLOOR.

 7. END STAIR RAIL 10'-0" FROM WIC WALL.

 8. REMOVE WIDE WALL BEHIND BATH #2 TUB.

 9. CHANGE WALL BEHIND THE OWNER'S TOLLET WALL FROM A 2X6 WALL TO A 2X4 WALL & MOVE WALL INTO WIC TO INCREASE DEPTH THE TOILET TO 6'-1". REVISE ALL OWNER'S BATH #0 PRONS TO MATCH.
- ALL OWNER'S BATH OPTIONS TO MATCH.

 11. ADD GOURMET KITCHEN W/ WALL OVEN AND 36" COOKTOP.

- 11. ADD GOVMEN, RICHEN MY WALL OVEN AND 36 COOKIOP.

 12. ADD 24"X36" ATTIC ACCESS TO BED #4 MC.

 13. CHANGE 2ND FLOOR 3/0 C.O. TO A 5/0X6/8 C.O.

 14. CHANGE DOOR SIZES FROM 2/6X6/8 TO 2/4X6/8 © FOYER CLOSET, BATH #2, WIC

 © BED #2, BATH #3, LINEN, WIC @ BED #3 & WIC @ BED #4.

 15. FLIP DOOR SWING INTO OPT. OFFICE/HOME GYM.

 16. ADD 8"-0" DEEP MECHANICAL RM TO REAR OF OPT. SUPER GAMEROOM/ HOME
- GYM/ OFFICE.

 17. 2X10 BEAM UNDER TOP PLATES © FRONT PORCHES.

 18. ALIGN (3) 2/0X2/0 WINDOW HEADER HT © FLEX ROOM W/ FRONT DOOR HEADER

- HI.

 19. ADD PARTIAL FOR OPT FIREPLACE.

 20. ADD PARTIAL ELEVATIONS FOR OWNER'S BATH OPTIONS.

 21. ADD PARTIAL FOR OPT SMART DELIVERY DOOR.
- 22. 4 $\frac{1}{2}$ " DSP BETWEEN WINDOWS & DIMENSION TO THE CENTER. 23. DIMENSION WIDTH OF HIPS

REVISION:002 DATE: 2/4/2022

- DIMENSION TRIPLE STUD POCKETS (4.5") RELOCATED & RESIZE KITCHEN ISLAND PER REDLINES, & REMOVE UNDER-COUNTER WALL TO THE RIGHT OF KITCHEN SINK. SHOW FULL HEIGHT WALL AT STANDARD MASTER BATH SHOWER.

- CHANGE MASTER BATH LINEN CLOSET DOOR TO 4/0X6/8 DOUBLE DOOR.
 CALL OUT ALL LINEN CLOSETS AS (4) SHELVES.
 REMOVE SHELF/ROD BEHIND WATER CLOSET & ADJACENT TO DOOR IN MASTER WIC
- CALL OUT FRONT PORCH COLUMNS AS 6X6 P.T. POST W/ 1X WRAP.

- Label 12 dropped Header.
 Remove The Owner's Entry Option.
 Resove The Owner's Entry Option.
 Resize/Relocate/Remove Under-Counter Wall in Kitchen Island per Base.
- PLAN. '
 11. SHOW 42X42 SHOWER W/ 18" SEAT FOR TUB SHOWER COMBO PER REVISION

- 11. SHOW 42X42 SHOWER W/ 18' SEAT FOR TUB SHOWER COMBUT PER REVISION REDUNES.

 12. SHOW OPT. STANDALONE 42X42 W/ 18' SEAT.

 13. LOCATE SHOWER VALVE ON HALF WALL FOR SUPER SHOWER OPT.

 14. LABEL OPT DOOR TO FLEX ROOM AS 15—LITE FRENCH DOORS

 15. SWING DOOR AT CAMEROOM INTO UNIFIN. ATTIC STORAGE.

 16. REMOVE FAUX SHUTTER FROM FARMHOUSE PLAN SINCE IT IS NOT SHOWING ON
- 12. Levation.

 1. Update Roof Height for rear options to reflect standard heel height.

 18. Removed Half Walls at kitchen Island and updated per Cabinet Provider

 20. Extend Porch Slab 4" at front and extend around corner 20" to support stone
- 21. REMOVED HALF WALLS AT KITCHEN ISLAND AND UPDATED PER CABINET PROVIDER
- 22. CHANGED THE BASE OWNER'S BATH WINDOW TO 4010
 23. CHANGED THE OWNER'S BATH OPTION SHOWER WINDOW TO 4010
 24. CHANGED THE OWNER'S BATH OPTION SUPER SHOWER WINDOWS TO (2)3010

FVISION.			
		7 /04 /0000	

1. ADD ELECTRICAL PLANS

REVISION: 004


DATE: 7/22/2022

- ADD STEM WALL SLAB FOUNDATION SHEETS
 ADD "STEM WALL" TO CRAIN. ELEVATION TITLES AND NOTE "SEE FOUNDATION PAGES FOR FOUNDATION TYPE". UPDATE SHEET TITLES.

NC. Lot 2 W

Lot 2 Woodbridge South

54 Yates Mill Drive Fuquay-Varina, NC 27526

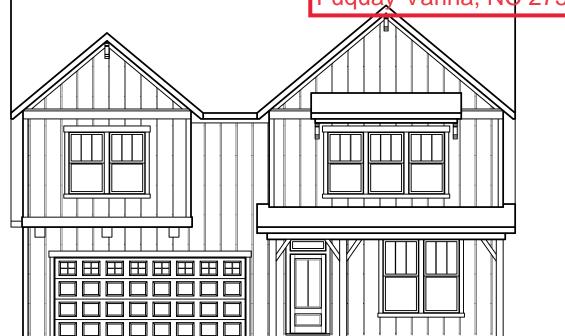

SQUARE	F	\circ	T /	4(GE			
	FARMHOUSE							
	U	NHEATEC)		HEATED			
FIRST FLOOR		0			1955			
SECOND FLOOR		0			945			
FRONT PORCH		147			0			
2 CAR GARAGE		437			0			
PATIO		220			û	-		
						_		
SUBTOTALS		804			2900	Г		
TOTAL UNDER ROOF			37	04				
O	PTIC	SNC						
	UNH	IEATED	S.F.	Н	EATED S.	F.		
COVERED PATIO		220			0			
EXTENDED		^			.20			
OWNER'S SUITE					-02			
SUPER GAME ROOM	-	-			1103			
OFFICE		0			+183			
HOME GYM	-	0			+100			
SMART DOOR		-28		Ė	+28			
MECHANICAL RM		+158			0			
3RD CAR GARAGE		+260						

PLAN 6 The Raleigh - LH

'FARMHOUSE' **ELEVATION**

eet No.	Sheet Description
0.0	Cover Sheet
1.1	Foundation (Slab)
1.1.1	Foundation Options (Slab)
1.1.2	Foundation Options (Slab)
1.2.1	Foundation (Crawl) Foundation Options (Crawl)
1.2.1	Foundation Options (Crawl)
1.3	Foundation (Stem Wall Slab)
1.3.1	Foundation Options (Stem Wall Slab)
1.3.2	Foundation Options (Stem Wall Slab)
2.1	First Floor Plan
2.1.1	First Floor Plan Options
2.2	Second Floor Plan
2.2.1	Second Floor Plan Options
2.4	Covered Porch Plans & Elevations (Slab)
2.4.1	Covered Porch Plans & Elevations (Crawl/Stem Wall)
2.5	Extended Owner's Suite Plans & Elevations (Slab)
2.5.1	Extended Owner's Suite Plans & Elevations (Crawl/ Stem Wall)
2.6	Ext. Owner's Suite W/Cov. Porch Plans & Elevations (Slab)
2.6.1	Ext. Owner's Suite W/Cov. Porch Plans & Elevations (Crawl/Stem Wall)
2.7	2-Car Sideload Garage Plans
2.7.1	2-Car Sideload Garage Elevations
2.8	3-Car Garage Plans
2.8.1	3-Car Garage Elevations (Crawl/ Stem Wall)
2.8.2	3-Car Garage Elevations (Slab)
3.1	Front & Rear Elevations (Slab)
3.1.1	Front & Rear Elevations (Crawl/Stem Wall)
3.2	Side Elevations (Slab)
3.2.1	Side Elevations (Crawl/ Stem Wall)
3.3	Roof Plan
5.1	First Floor Electrical Plan First Floor Options Electrical Plan
5.1.1	
5.2	Second Floor Electrical Plan Second Floor Options Electrical Plan

DESIGN CRITERIA:

THIS PLAN IS TO BE BUILT IN CONFORMANCE WITH THE 2018 NORTH CAROLINA STATE BUILDING CODE: RESIDENTIAL CODE

DIMENSIONS SHALL GOVERN OVER SCALE, AND CODE SHALL GOVERN OVER DIMENSIONS.


DATE	11/24/2021	2/4/2022	03/21/2022	07/22/2022				!
DESCRIPTION	REFER TO COVER SHEET	REFER TO COVER SHEET	REFER TO COVER SHEET	REFER TO COVERSHEET	-	-	-	-
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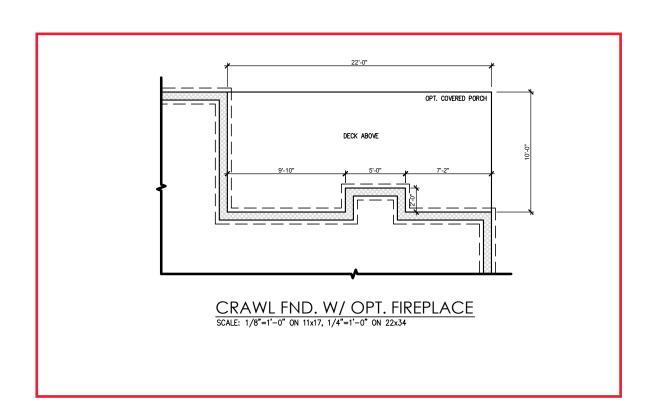
THE RALEIGH 9 **PLAN**


Sheet

South Designs ISSUE DATE: 7/1/2021 CURRENT REVISION DATE:

1/8" = 1'-0'



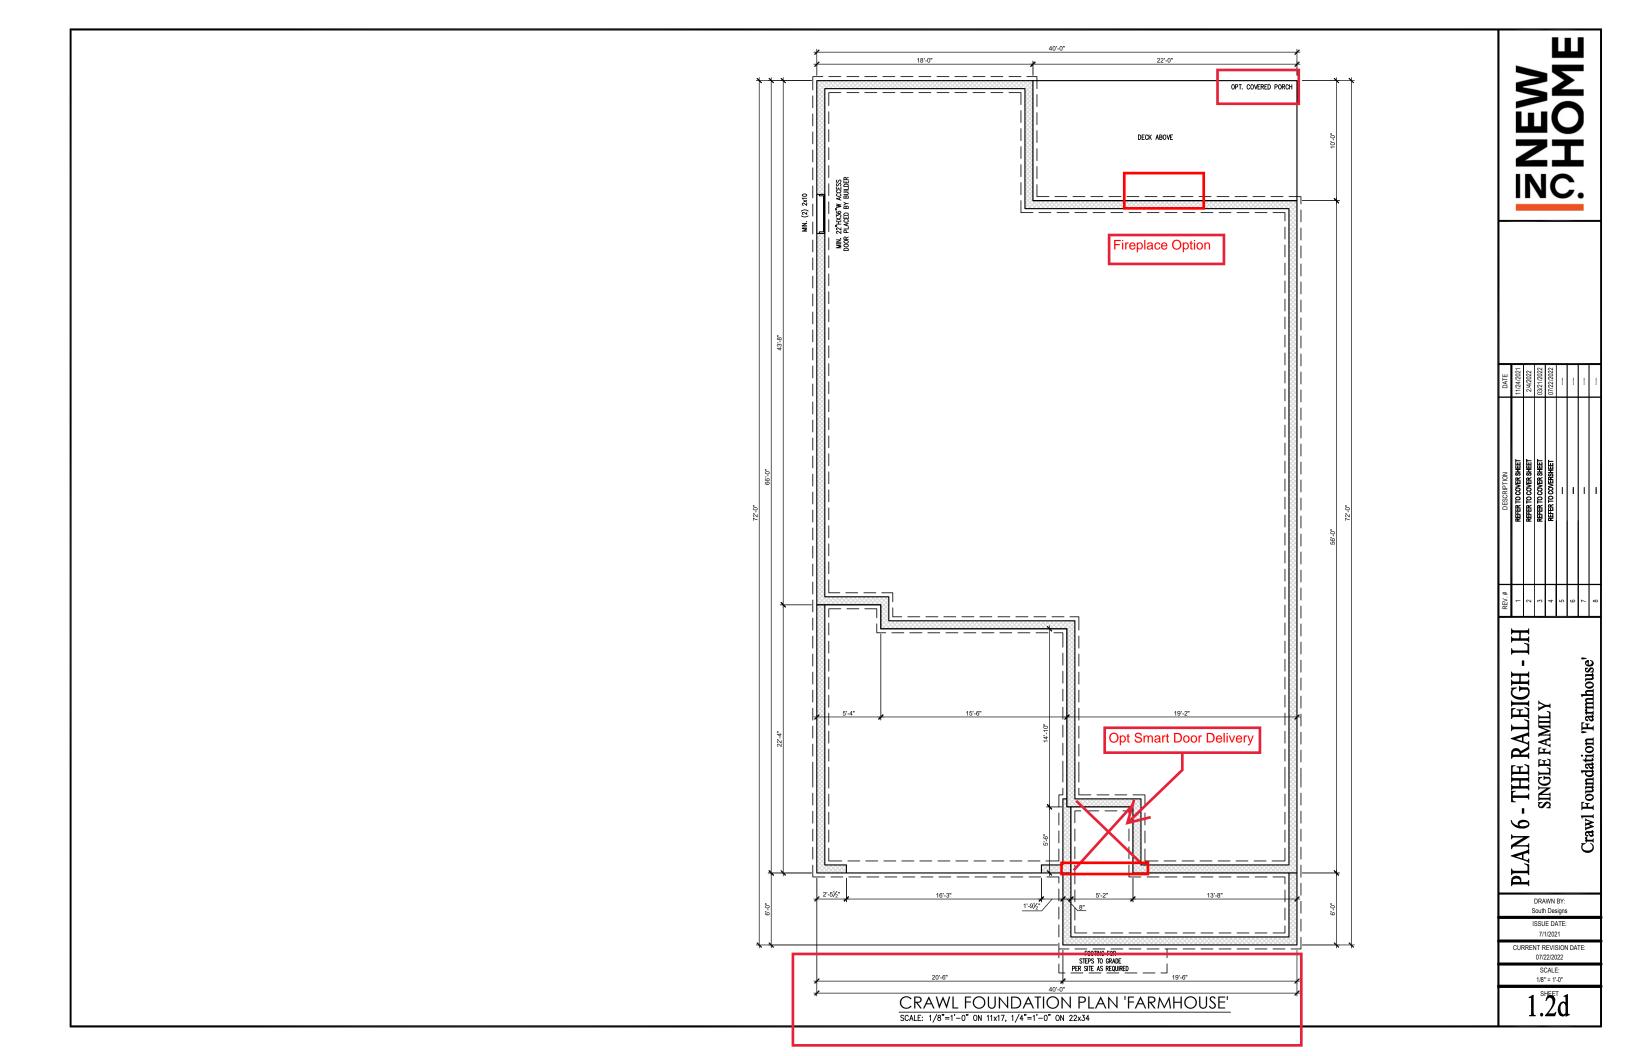

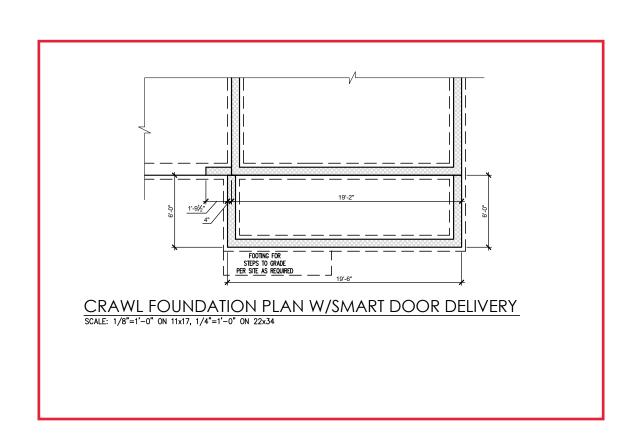



DATE	11/24/2021	2/4/2022	03/21/2022	07/22/2022				-
DESCRIPTION	REFER TO COVER SHEET	REFER TO COVER SHEET	REFER TO COVER SHEET	REFER TO COVERSHEET	-	-	-	1
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PLAN 6 - THE RALEIGH - LH
SINGLE FAMILY
Crawl Foundation Options 'Farmhouse'


DRAWN BY: South Designs

South Designs
ISSUE DATE:
7/1/2021

CURRENT REVISION DATE: 07/22/2022

SCALE: 1/8" = 1'-0"


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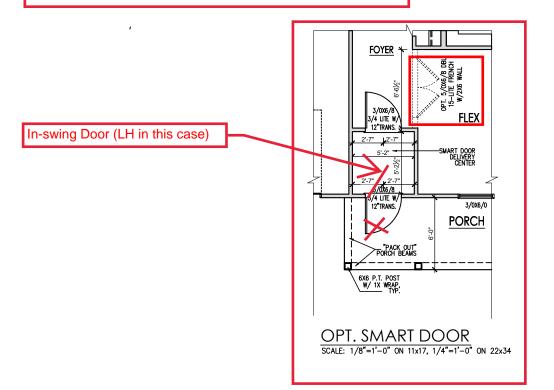


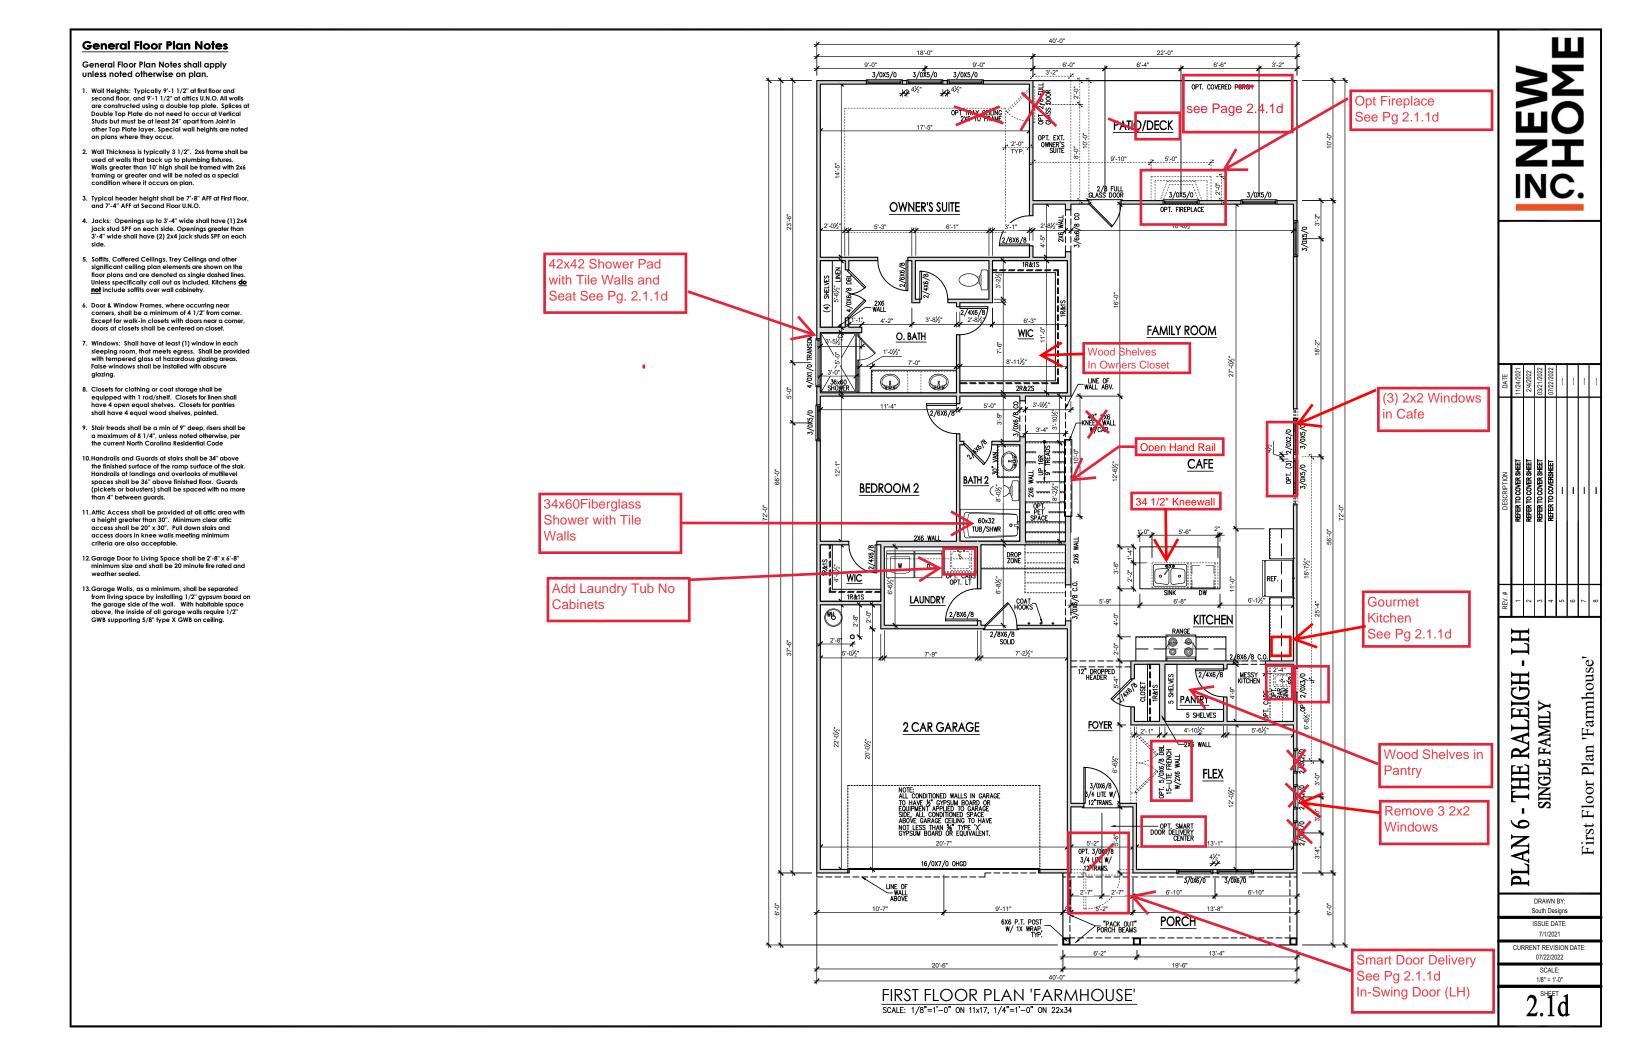General Floor Plan Notes

General Floor Plan Notes shall apply unless noted otherwise on plan.

- Wall Heights: Typically 9'-1 1/2" at first floor and second floor, and 9'-1 1/2" at attics U.N.O. All walls are constructed using a double top plate. Splices at Double Top Plate do not need to occur at Vertical Studs but must be at least 24" apart from Joint in other Top Plate layer. Special wall heights are noted on plans where they occur.
- Wall Thickness is typically 3 1/2". 2x6 frame shall be used at walls that back up to plumbing fixtures.
 Walls greater than 10' high shall be framed with 2x6 framing or greater and will be noted as a special condition where it occurs on plan.
- 3. Typical header height shall be 7'-8" AFF at First Floor, and 7'-4" AFF at Second Floor U.N.O.
- Jacks: Openings up to 3'-4" wide shall have (1) 2x4 jack stud SPF on each side. Openings greater than 3'-4" wide shall have (2) 2x4 jack studs SPF on each side.
- 5. Soffits, Coffered Ceilings, Trey Ceilings and other significant ceiling plan elements are shown on the floor plans and are denoted as single dashed lines. Unless specifically call out as included, Kitchens do not include soffits over wall cabinetry.
- Door & Window Frames, where occurring near corners, shall be a minimum of 4 1/2" from corner. Except for walk-in closets with doors near a corner, doors at closets shall be centered on closet.
- Windows: Shall have at least (1) window in each sleeping room, that meets egress. Shall be provided with tempered glass at hazardous glazing areas. False windows shall be installed with obscure glazing.
- Closets for clothing or coat storage shall be equipped with 1 rod/shelf. Closets for linen shall have 4 open equal shelves. Closets for pantries shall have 4 equal wood shelves, painted.
- Stair treads shall be a min of 9" deep, risers shall be a maximum of 8 1/4", unless noted otherwise, per the current North Carolina Residential Code
- 10. Handrails and Guards at stairs shall be 34" above the finished surface of the ramp surface of the stair. Handrails at landings and overlooks of multilevel spaces shall be 36" above finished floor. Guards (pickets or balusters) shall be spaced with no more than 4" between guards.
- 11. Affic Access shall be provided at all affic area with a height greater than 30". Minimum clear affic access shall be 20" x 30". Pull down stairs and access doors in knee walls meeting minimum criteria are also acceptable.
- 12. Garage Door to Living Space shall be 2'-8" x 6'-8" minimum size and shall be 20 minute fire rated and weather sealed.
- 13. Garage Walls, as a minimum, shall be separated from living space by installing 1/2" gypsum board on the garage side of the wall. With habitable space above, the inside of all garage walls require 1/2" GWB supporting 5/8" type X GWB on ceiling.



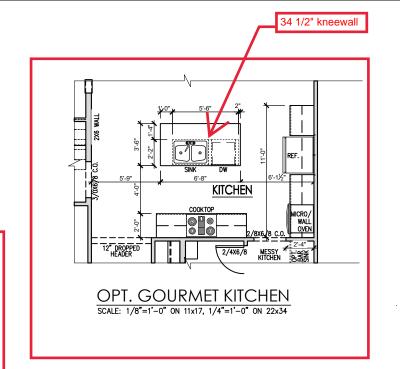

4'-0"

FIREPLACE 42"X39" R.O.

18'-6½"

SCALE: 1/8"=1'-0" ON 11x17, 1/4"=1'-0" ON 22x34

3'-10"

OPT. FIREPLACE


PATIO/

DECK

1R&1S

3'-2"

3/0x5/0

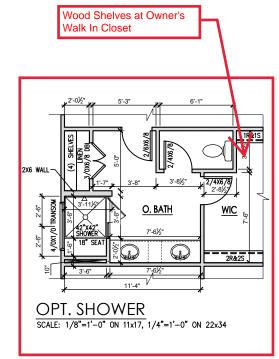



REV.#	DESCRIPTION	DATE
1	REFER TO COVER SHEET	11/24/20;
2	REFER TO COVER SHEET	2/4/202
3	REFER TO COVER SHEET	03/17/50
4	REFER TO COVERSHEET	02/22/20
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PLAN 6 - THE RALEIGH - SINGLE FAMILY
First Floor Options 'Farmhouse'

DRAWN BY: South Designs

ISSUE DATE: 7/1/2021


CURRENT REVISION DATE: 07/22/2022 SCALE: 1/8" = 1'-0"

2.1.1d

General Floor Plan Notes

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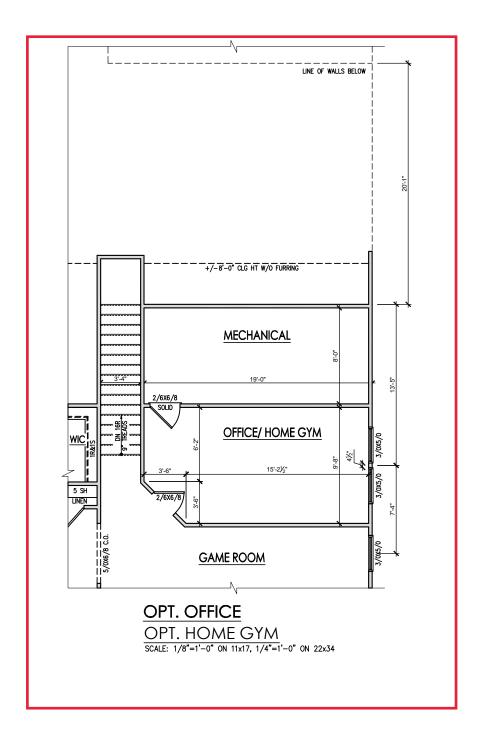
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- 12. Garage Door to Living Space shall be 2'-8" x 6'-8" minimum size and shall be 20 minute fire rated and weather sealed.
- 13. Garage Walls, as a minimum, shall be separated from living space by installing 1/2" gypsum board on the garage side of the wall. With habitable space above, the inside of all garage walls require 1/2" GWB supporting 5/8" type X GWB on ceiling.

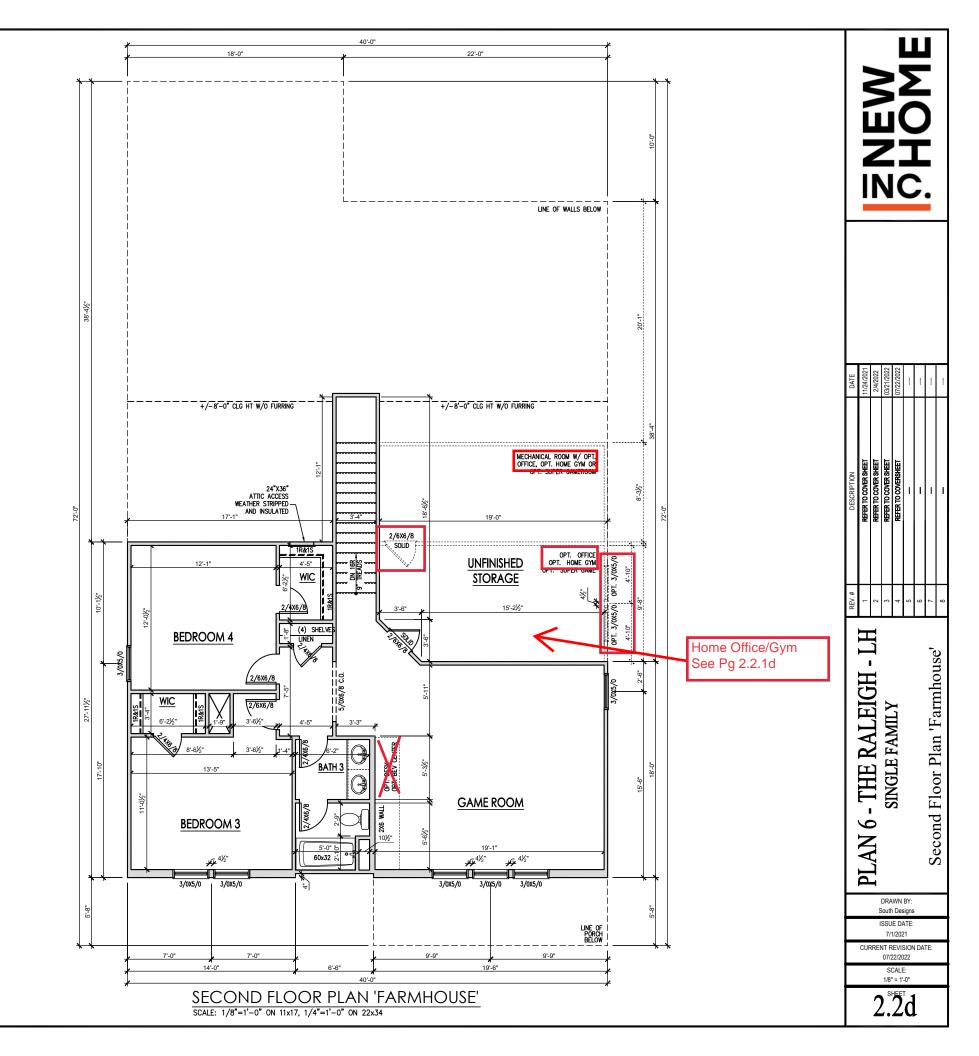

General Floor Plan Notes

General Floor Plan Notes shall apply unless noted otherwise on plan.

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- Stair treads shall be a min of 9" deep, risers shall be a maximum of 8 1/4", unless noted otherwise, per the current North Carolina Residential Code
- 10. Handrails and Guards at stairs shall be 34" above the finished surface of the ramp surface of the stair. Handrails at landings and overlooks of multilevel spaces shall be 36" above finished floor. Guards (pickets or balusters) shall be spaced with no more than 4" between guards.
- 11. Attic Access shall be provided at all attic area with a height greater than 30". Minimum clear attic access shall be 20" x 30". Pull down stairs and access doors in knee walls meeting minimum criteria are also acceptable.
- 12. Garage Door to Living Space shall be 2'-8" x 6'-8" minimum size and shall be 20 minute fire rated and weather sealed.
- 13. Garage Walls, as a minimum, shall be separated from living space by installing 1/2" gypsum board on the garage side of the wall. With habitable space above, the inside of all garage walls require 1/2" GWB supporting 5/8" type X GWB on ceiling.





PLAN 6 - THE RALEIGH - LH SINGLE FAMILY

Options 'Farmhouse'

Second Floor Plan


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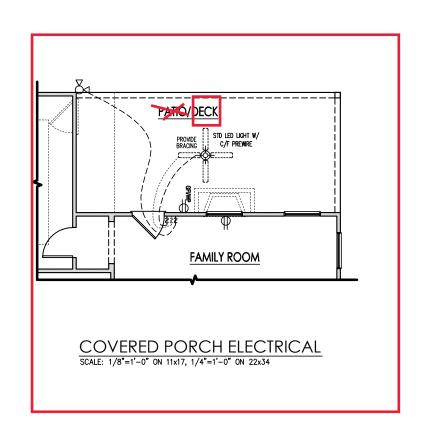
ISSUE DATE: 7/1/2021


CURRENT REVISION DATE: 07/22/2022

> SCALE: 1/8" = 1'-0"

2.2.1d



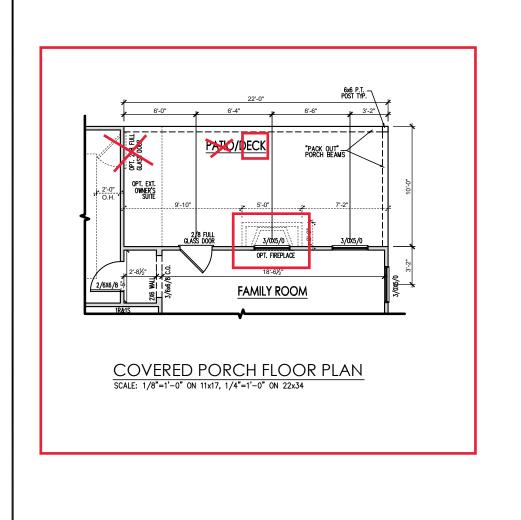

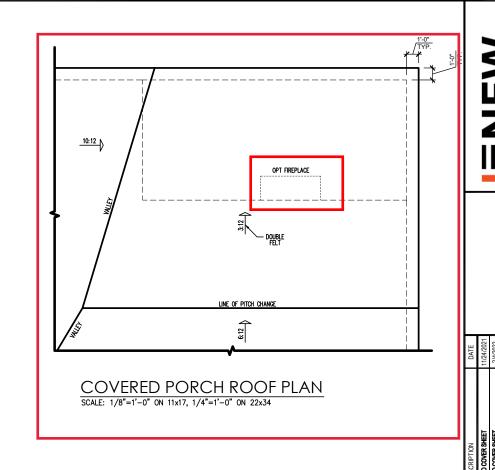

- THE RALEIGH - LH

PLAN 6

ISSUE DATE:


7/1/2021

CURRENT REVISION DATE:

SCALE: 1/8" = 1'-0"

2.4.1d

SINGLE FAMILY
Covered Porch Plans & Elev (Crawl or Stem Wall)
'Farmhouse'

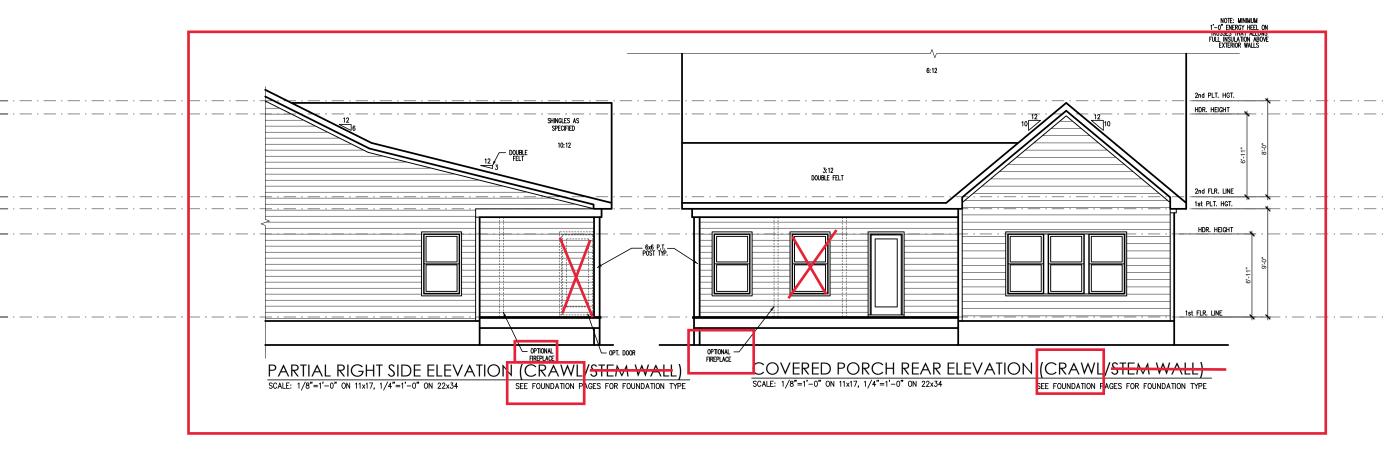

General Elevation Notes

General Elevation Notes shall apply unless noted otherwise on plan.

- Roof shall be finished with architectural composition shingles with slopes as noted on plan.
- Ridge Vent shall be provided and installed on all ridges greater than 6' in length per manufacturer's specifications.
- 3. Soffit Vent shall be continuous soffit vent
- House Wrap, "tyvek" or approved equal shall be installed over entire exterior wall per manufacturer's specifications and recommendations.
- Flashing shall be provided above all door and window openings, above finish wall material changes and at wall surfaces where lower roof areas abut vertical wall surfaces.
- Porch Railings shall be provided at all porch walking surfaces greater than 30" above adjacent finished grade. It shall be 36" high with guards spaced no more than 4" apart. Consult community specifications for material.
- Finish Wall Material shall be as noted on elevation drawings.
- 8. Brick Veneer, if included on elevation shall be fied to wall surface with galvanized corrugated metal fies at a rate of 24" oc horizontally and 16" oc vertically so that no more than 2.67st of brick is supported by (1) fie. Space between face of wall and back face of brick shall be limited to a maximum of 1". Rashing shall be provided behind brick above all wall openings and at base of brick wall. Rashing shall be a minimum of 6-mil poly or other corrosion resistant material and shall be installed so that it laps under the house wrop material a minimum of 2".

 Weepholes shall be provided at a rate of 48" oc and shall not be less than 3/16" in diameter and shall be located immediately above flashing.
- Brick Veneer Support Lintels shall be provided if brick veneer is included on elevation. Lintels shall be provided as listed in the following schedule and shall have a minimum bearing length of 6". Masonry Lintels shall be provided so that deflection is limited to L/600.

Masonry Opening Lintel Schedule

Opening Size Angle

 up to 4'-0"
 3-1/2" x 3-1/2" x 5/16"


 4'-1" to 5'-6"
 4" x 3-1/2" x 5/16" LLV

 5'-7" to 6'-6"
 5" x 3-1/2" x 5/16" LLV

 6'-7" to 8'-4"
 6" x 3-1/2" x 5/16" LLV

 8'-5" to 16'-4"
 7" x 4" x 3/8" LLV



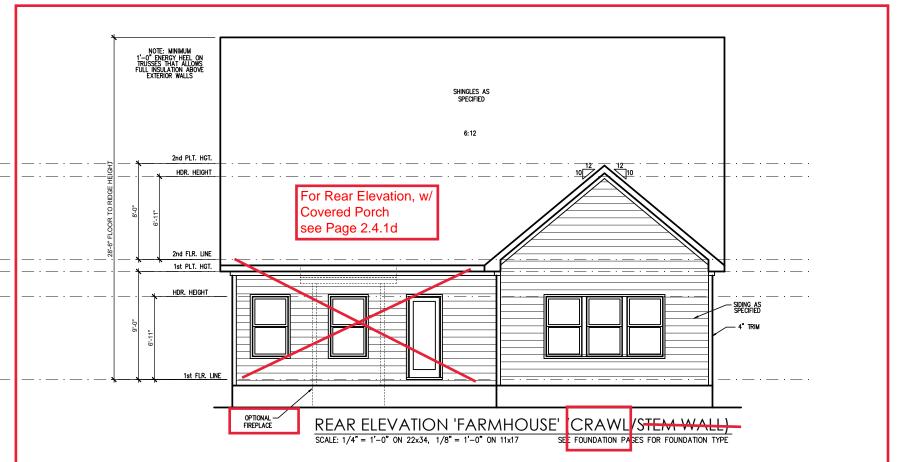



DATE	11/24/2021	2/4/2022	03/21/2022	07/22/2022	-	-	!	1
DESCRIPTION	REFER TO COVER SHEET	REFER TO COVER SHEET	REFER TO COVER SHEET	REFER TO COVERSHEET		—	-	-
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PLAN 6 - THE RALEIGH - LE SINGLE FAMILY
Front & Rear Elevations (Crawl or Stem Wall)
'Farmhouse'

DRAWN BY: South Designs ISSUE DATE:

7/1/2021

CURRENT REVISION DATE:

SCALE: 1/8" = 1'-0"

3.1.10


General Elevation Notes


General Elevation Notes shall apply unless noted otherwise on plan.

- Roof shall be finished with architectural composition shingles with slopes as noted on plan.
- Ridge Vent shall be provided and installed on all ridges greater than 6' in length per manufacturer's specifications.
- 3. Soffit Vent shall be continuous soffit vent
- House Wrap, "tyvek" or approved equal shall be installed over entire exterior wall per manufacturer's specifications and recommendations.
- Flashing shall be provided above all door and window openings, above finish wall material changes and at wall surfaces where lower roof areas abut vertical wall surfaces.
- Porch Railings shall be provided at all porch walking surfaces greater than 30" above adjacent finished grade. It shall be 36" high with guards spaced no more than 4" apart. Consult community specifications for material.
- Finish Wall Material shall be as noted on elevation drawings.
- 8. Brick Veneer, if included on elevation shall be tied to wall surface with galvanized corrugated metal ties at a rate of 24" oc horizontally and 16" oc vertically so that no more than 2.67sf of brick is supported by (1) tie. Space between face of wall and back face of brick shall be limited to a maximum of 1". Flashing shall be provided behind brick above all wall openings and at base of brick wall. Flashing shall be a minimum of 6-mil poly or other corrosion resistant material and shall be installed so that it laps under the house wrap material a minimum of 2".
 Weepholes shall be provided at a rate of 48" oc and shall not be less than 3/16" in diameter and shall be located immediately above flashing.
- Brick Veneer Support Lintels shall be provided if brick veneer is included on elevation. Lintels shall be provided as listed in the following schedule and shall have a minimum bearing length of 6". Masonry Lintels shall be provided so that deflection is limited to L/600.

Masonry Opening Lintel Schedule

3-1/2" x 3-1/2" x 5/16"
4" x 3-1/2" x 5/16" LLV
5" x 3-1/2" x 5/16" LLV
6" x 3-1/2" x 5/16" LLV
7" x 4" x 3/8" LLV

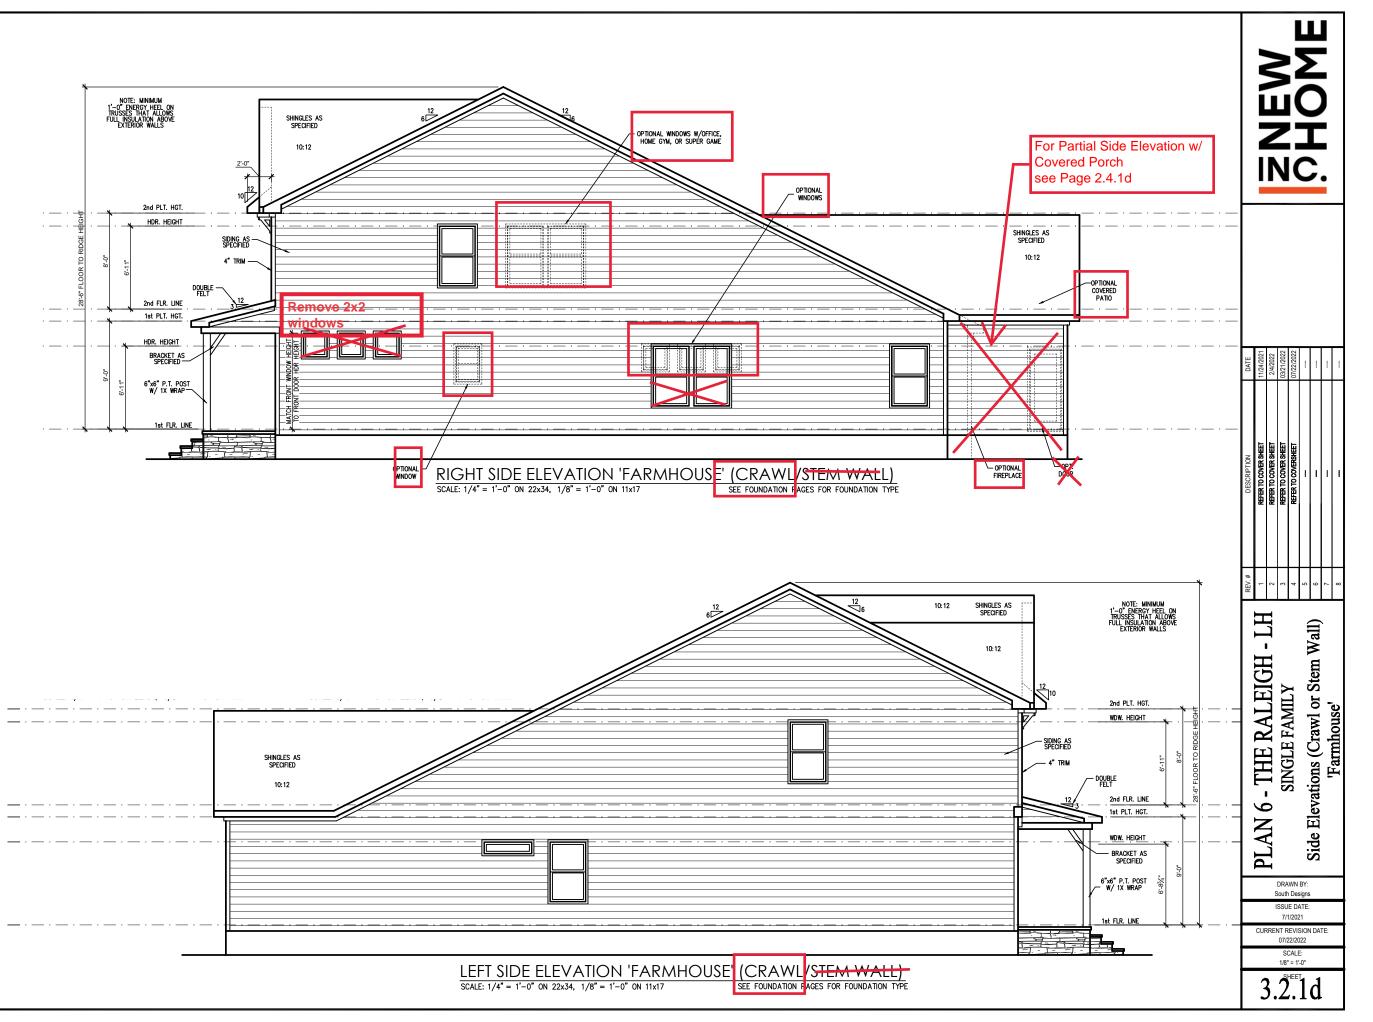

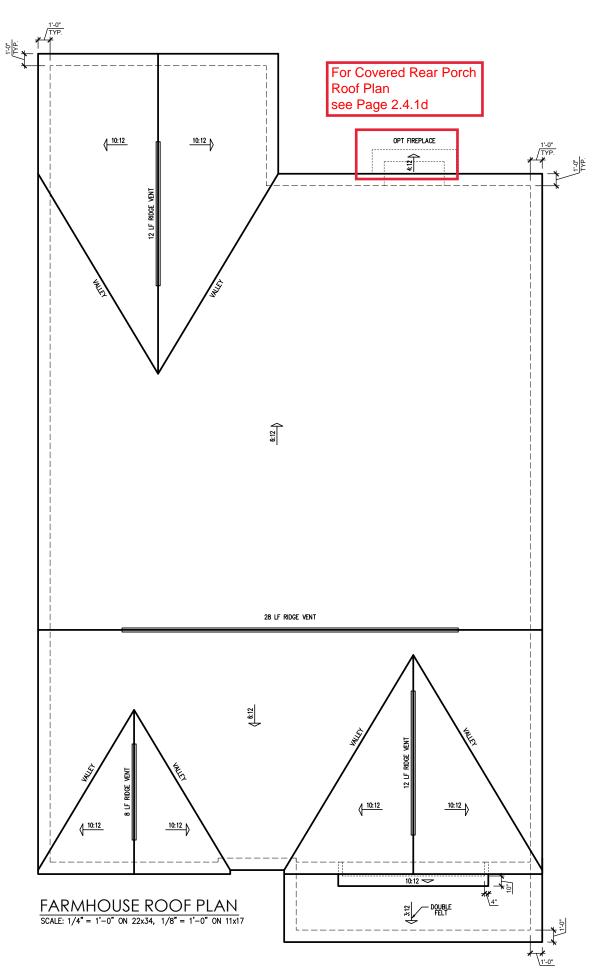

	ATTIC VENT SCHEDULE												
FARMHOUSE													
MAIN HOUSE SQ FTG 2431 AT / NEAR RIDGE AT / NEAR EAVE													
VENT TYPE	SQ. REQU		SQ. FT.	PERCENT OF TOTAL	POT LARGE (SQ. FT. EACH)	POT SMALL (SQ. FT. EACH)	RIDGE VENT (SQ. FT. PER LF)	EAVE VENT (SQ. IN. EACH)	CONT. VENT (SQ. IN. PER LF)				
721111112	RAN		SUPPLIED	SUPPLIED	0.4236	0.2778	0.125	0.1944	0.0625				
RIDGE VENT	3.24	4.05	7.50	72.29	0	0	60.00						
SOFFIT VENTS	4.86	4.05	2.88	27.71	0 46.00								
TOTAL (MIN)	8.10	8.10	10.38	100.00	POT VENTS MAY BE	E REQUIRED IF THERE	: IS INSUFFICIENT RID	GE AVAILABLE					

* SCHEDULE HAS BEEN CALCULATED ASSUMING EAVE VENTILATION AT 50-60% OF TOTAL AND RIDGE AT 40-50% OF TOTAL REQUIRED VENTILATION

NEW C.

DATE	11/24/2021	2/4/2022	03/21/2022	07/22/2022			-	I
DESCRIPTION	REFER TO COVER SHEET	REFER TO COVER SHEET	REFER TO COVER SHEET	REFER TO COVERSHEET	· · · · · · · · · · · · · · · · · · ·	-		-
REV.#	-	2	3	4	2	9	7	8

PLAN 6 - THE RALEIGH - LH SINGLE FAMILY Roof Plan 'Farmhouse'

> DRAWN BY: South Designs

ISSUE DATE: 7/1/2021

CURRENT REVISION DATE: 07/22/2022 SCALE: 1/8" = 1'-0"

3.3d

WOOD I-JOISTS

(SHALL BE ONE OF THE FOLLOWING):

• TJI 210 BY TRUS JOIST

- LPI 20 PLUS BY LP
- BCI 5000c I & BY B
- ALL WOOD I-JOISTS SHALL BE INSTALLED ACCORDING TO MANUFACTURER'S SPECIFICATIONS.
- INSTALL SQUASH BLOCKS, MEB STIFFENERS, ETC.
 AS REQUIRED BY AND ACCORDING TO THE I-JOIST MANUFACTURER'S SPECIFICATIONS AND INSTRUCTIONS.

 INSTRUCTIONS.
- HANGERS FOR I-JOISTS ARE THE RESPONSIBILITY OF THE I-JOIST SUPPLIER.
- FLOOR TRUSSES BY MANUFACTURER MAY BE SUBSTITUTED FOR I-JOISTS.

TRUSS SYSTEM REQUIREMENTS NC (2018 NGRC): Wind: 115-120 mph

- I. TRUSS SYSTEM LAYOUTS (PLACEMENT PLANS)
 SHALL BE DESIGNED IN ACCORDANCE WITH SEALED
 STRUCTURAL PLANS, ANY NEED TO CHANGE
- TRUSSES SHALL BE COORDINATED WITH SOUTHERN ENGINEERS.

 2. TRUSS SCHEMATICS (PROFILES) SHALL BE

PREPARED AND SEALED BY TRUSS MANUFACTURER.

- ALL TRUSSES SHALL BE DESIGNED FOR BEARING ON SPF #2 OR #3 PLATES OR LEDGERS (UNO).
- ALL REQUIRED ANCHORS FOR TRUSSES DUE TO UPLIFT OR BEARING SHALL MEET THE REQUIREMENTS AS SPECIFIED ON THE TRUSS SCHEMATICS.

FOUNDATION STRUCTURAL NOTES NC (2018 NCRC): Wind: 115-120 mph - CRAWL

- (3)2xIO SYP#2 OR SPF#2 GIRDER, TYPICAL UNO.

•• I6xI6 UP TO 64"

•• 24x24 UP TO 96" • WITH 30" x 30" x IO" CONCRETE FOOTING, UNO.

UP TO 12'-0"

√3 WALL FOOTING AS FOLLOWS

DEPTH: 8" - UP TO 2 STORY

ONLY

| 10" - 3 STORY • WIDTH: • SIDING: 16" - UP TO 2 STORY

•• SIDING: 16" - UP 10 2 510" 20" - 3 5TORY •• BRICK: 16" - 1 STORY

20" - 2 STORY 20" - 3 STORY 24" - 3 STORY

- FOR FOUNDATION WALL HEIGHT AND BACKFILL REQUIREMENTS, REFER TO CODE TABLE R404.I.I (I THRU 4) NOTE: ASSUMED SOIL BEARING CAPACITY = 2000 PSF. CONTRACTOR MUST VERIFY SITE CONDITIONS AND CONTACT SOILS ENGINEER IF MARGINAL OR UNSTABLE SOILS ARE ENCOUNTERED.
- (4) 2xIO SPF #2 OR SYP #2 GIRDER
- (5) (2) 1.75x9.25 LVL OR LSL GIRDER
- (3) 1.75x9.25 LVL OR LSL GIRDER
- """ DESIGNATES A SIGNIFICANT POINT LOAD TO HAVE SOLID BLOCKING TO PIER. SOLID BLOCK ALL BEAM BEARING POINTS NOTED TO HAVE THREE OR MORE STUDS TO FIND, TYPICAL.
- . ABBREVIATIONS:
- "SJ" = SINGLE JOIST"DJ" = DOUBLE JOIST
- "TJ" = TRIPLE JOIST
- ADJUST SUBFLOOR THICKNESS OR JOIST SPACING AS REQ'D FOR FLOOR FINISH MATERIALS.




16"x16" SOLID FILLED MASONRY PIER ON A 38"x38"x12" CONC. FTG.





24"x24" SOLID FILLED MASONRY PIER ON A 54"x54"x12" CONC. FTG. REINFORCED WITH #5 BAR ● II" O.C. IN EACH DIRECTION. SET BAR AT 3" FROM BOTTOM OF FTG. ATTACH IO'x10"x34" STEEL BASE PLATE FOR COLUMN ABOVE TO PIER WITH (4) ½" ANCHORS WITH 4" EMBEDMENT.





I6" SOLID FILLED MASONRY ON A:
42" x42" x12" CONC. FTG.
REINFORCED WITH #5 BAR AT II"
O.C. IN EACH DIRECTION, SET BAR
AT 3" FROM BOTTOM OF FTG.
ATTACH STEEL BASE PLATE OF
COLUMN WITH (2) SIMPSON
SOMSSOSODIS SCREWS ON EACH
SIDE OF COLUMN, PROVIDE 24"
(MIN) LENGTH OF 5.25" WIDE
LVL.LS. BILOCKING BELOW COLUMN.

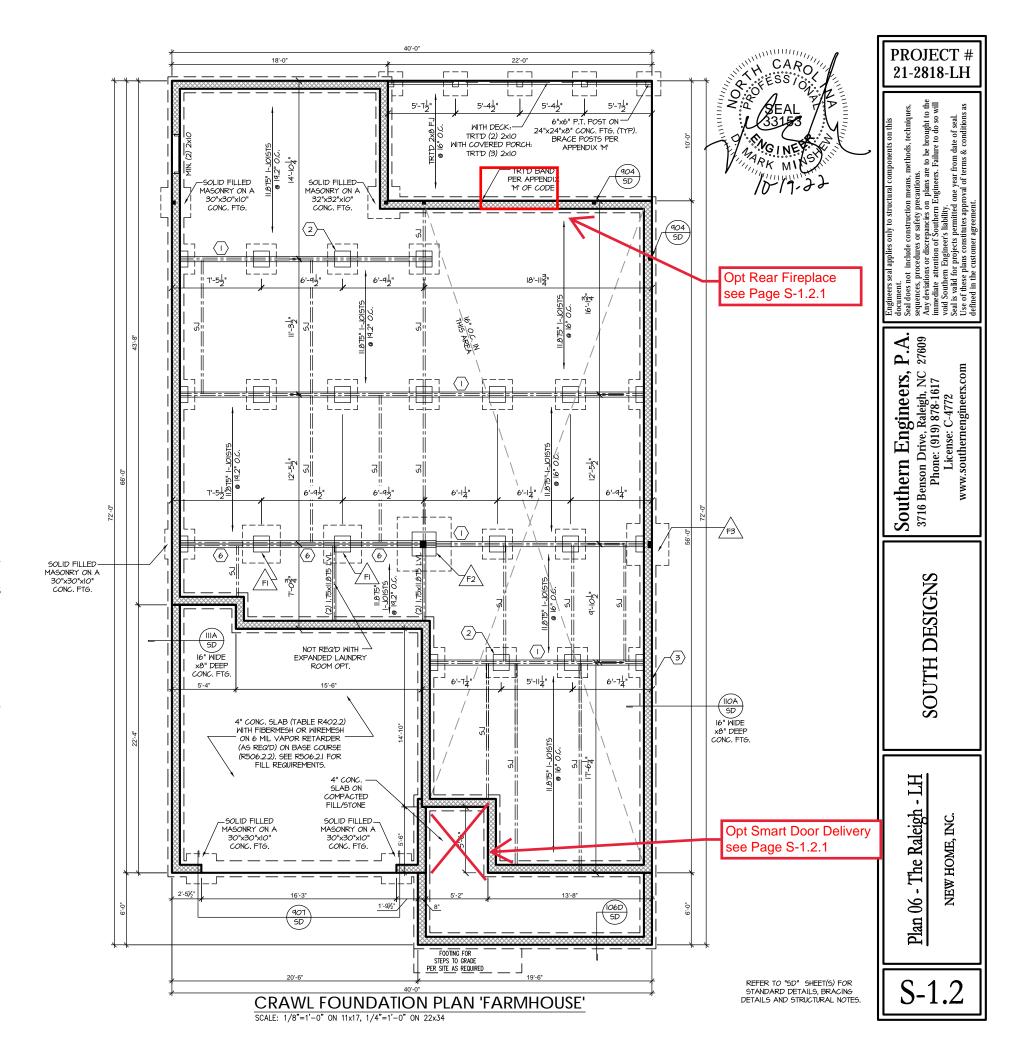

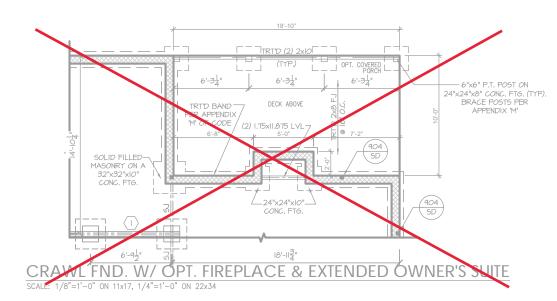

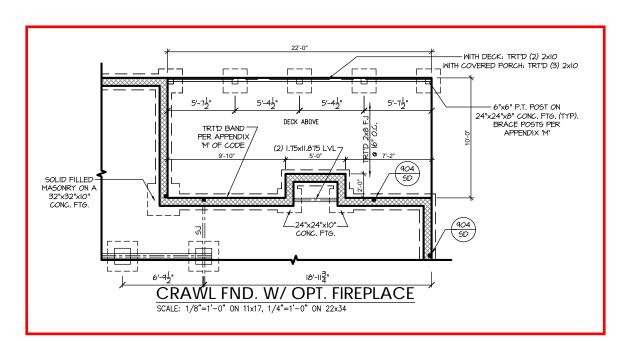

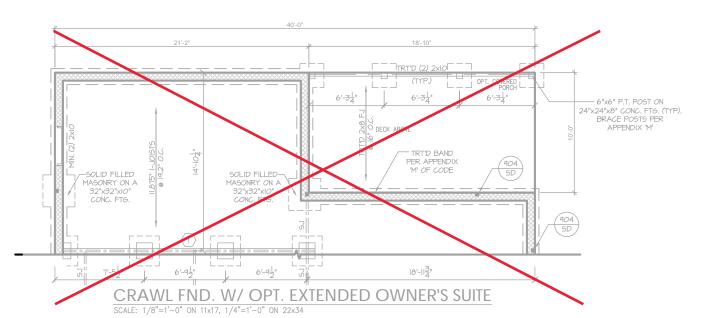

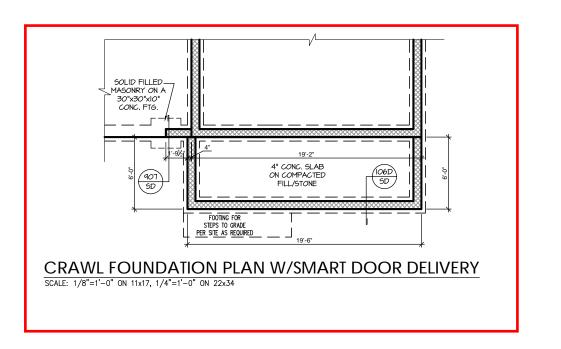

REFER TO "5D" SHEET(5) FOR STANDARD DETAILS, BRACING DETAILS AND STRUCTURAL NOTES. PROJECT # 21-2818-LH

Engineers seal applies only to structural components on this document.

Journal Advances and include construction means, methods, techniques, sequences, procedures or safety precautions.

Any deviations or discrepancies on plans are to be brought to the immediate attention of Southern Engineers. Failure to do so will void Southem Engineers's lability.

Seal is vald for projects permitted one year from date of seal.

Use of these plans constitutes approval of terms & conditions as defined in the customer agreement.

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SOUTH DESIGNS

Plan 06 - The Raleigh - LH
NEW HOME, INC.

S-1.2.

MOOD I-JOISTS

(SHALL BE ONE OF THE FOLLOWING):

TJI 210 BY TRUS JOIST

- LPI 20 PLUS BY LP
- ALL MOOD I-JOISTS SHALL BE INSTALLED ACCORDING TO MANUFACTURER'S SPECIFICATIONS.
- INSTALL SQUASH BLOCKS, WEB STIFFENERS, ETC.
 AS REQUIRED BY AND ACCORDING TO THE I-JOIST MANUFACTURER'S SPECIFICATIONS AND
- HANGERS FOR I-JOISTS ARE THE RESPONSIBILITY OF THE I-JOIST SUPPLIER.
- FLOOR TRUSSES BY MANUFACTURER MAY BE SUBSTITUTED FOR I-JOISTS

TRUSS SYSTEM REQUIREMENTS

NC (2018 NCRC): Wind: 115-120 mph

- TRUSS SYSTEM LAYOUTS (PLACEMENT PLANS) SHALL BE DESIGNED IN ACCORDANCE WITH SEALED TRUSSES SHALL BE COORDINATED WITH SOUTHERN
- TRUSS SCHEMATICS (PROFILES) SHALL BE 2. PREPARED AND SEALED BY TRUSS MANUFACTURER.
- ALL TRUSSES SHALL BE DESIGNED FOR BEARING ON SPF #2 OR #3 PLATES OR LEDGERS (UNO).
- ALL REQUIRED ANCHORS FOR TRUSSES DUE TO UPLIFT OR BEARING SHALL MEET THE REQUIREMENTS AS SPECIFIED ON THE TRUSS SCHEMATICS.

PORCH POST NOTES:

4"x4" (6"x6") TRT'D POST (OR EQUAL) ATTACH TRUSSES (RAFTERS) AT PORCH WITH

3. POST BASE: SIMPSON ABU44 (ABU66).

HIGH WIND ONLY)

HURRICANE CONNECTORS.
POST CAP: SIMPSON AC4-MAX (AC6-MAX) POST CAP AT CORNER: (2) SIMPSON LCE4
(MITER HEADER AT CORNER). HIGH WIND; ADD (I)

MONO: %" ANCHOR (EMBED 7")

CMU: %" ANCHOR (EXTEND TO FOOTING -

EACH POST (UPPER AND LOWER) OR TO GIRDER NOTE: EQUIVALENT POST CAP AND BASE ACCEPTABLE.

4. POST BASE: WOOD FOUNDATION: (2) SIMPSON CSI6 STRAPS AT POSTS. EXTEND 12" ONTO

ALL EXTERIOR AND LOAD BEARING HEADERS SHALL BE MIN. (2)2x6 (4" WALL) OR (3)2x6 (6" WALL) WITH (1) SUPPORT STUD, UNLESS NOTED OTHERWISE

HEADER/BEAM & COLUMN NOTES


- 2. THE NUMBER SHOWN AT BEAM AND HEADER SUPPORTS INDICATES THE NUMBER OF SUPPORT STUDS REQUIRED IN STUD POCKET OR COLUMN. THE NUMBER OF KING STUDS AT EACH END OF HEADERS IN EXTERIOR WALLS SHALL BE ACCORDING TO ITEM "d" IN TABLE R602.3(5) OR AS BELOW PER NCDOI COMMENTARY "KING STUDS AT WALL OPENINGS" REVISED 1-9-2020:
- UP TO 3' SPAN: (I) KING STUD
- OVER 3' UP TO 6' SPAN: (2) KING STUDS
- OVER 6' UP TO 9' SPAN: (3) KING STUDS OVER 9' UP TO 12' SPAN: (4) KING STUDS
- OVER 12' UP TO 15' SPAN: (5) KING STUDS

FRAMING NOTES

NC (2018 NCRC): Wind: 115-120 mph

- BRACING METHOD AND TYPE: CONTINUOUSLY SHEATHED WSP: CS-MEP. NOTE THAT THE WALL BRACING AMOUNT PROVIDED ON THE PLANS (DETAILS AND SPECIFICATIONS) IS GREATER THAN THE AMOUNT OF WALL BRACING REQUIRED BY SECTION R602.10 OF THE CODE. SEE NOTES BELOW FOR DETAILS AND SPECIFICATIONS FOR WALL BRACING AND WALL FRAMING
- 2. EXTERIOR WALL SHEATHING: WALLS SHALL BE BRACED BY SHEATHING WALLS ON ALL STORIES WITH WOOD STRUCTURAL PANEL SHEATHING (WSP) (EXPOSURE B: 7/16". EXPOSURE C: 15/32"). SHEATHING SHALL BE ATTACHED WITH 8d NAILS AT A 6"/12" NAILING PATTERN (6" OC AT PANEL EDGES AND 12" OC AT INTERMEDIATE SUPPORTS). INSTALL BLOCKING AT ALL PANEL EDGES.
- 3. WSP SHEATHING SHALL EXTEND TO THE UPPERMOST DOUBLE BEARING PLATE. BLOCK AT ROOF PER SECTION R602.10.4.5 AND ATTACH BRACED WALLS PER CODE. WSP SHEATHING BETWEEN FLOORS SHALL BE SPLICED ALONG CONTINUOUS BAND OR THE WSF SHEATHING MAY BE SPLICED ACROSS STUDS (CONTINUOUS ACROSS FLOOR SYSTEM) WITH BLOCKING AT PANEL EDGES. (MINIMUM 12" BEYOND FLOOR BREAK) OR OTHER APPROVED METHOD.
- 4. "HD" = HOLDOWN: HOLD-DOWN DEVICE (NOTED AS "HD" ON PLANS) SHALL BE AN 800 POUND CAPACITY ASSEMBLY AS NOTED ON
- PLANS. SEE DETAILS FOR HD ASSEMBLY.

 **GROUND/FIRST FLOOR: USE "HD HOLD-DOWN DETAIL" ON SD
- **UPPER FLOORS: ATTACH BASE OF KING STUD WITH A SIMPSON C522 STRAP DOWN ACROSS THE BAND AND DOWN TO A STUD BELOW OR HEADER BELOW. EXTEND STRAP 7" MIN ALONG EACH STUD (OR HEADER) AND ATTACH EACH END W/ (7) 8d NAILS.
- 5. INTERIOR BRACED WALL: (NOTED AS "IBM" ON PLANS) ATTACH I/2" GYPSUM BOARD (6B) ON EACH SIDE OF WALL WITH A MIN. OF 5d COOLER NAILS OR #6 SCREWS @ 7" O.C. ALONG THE EDGES AND AT
- 6. INTERIOR BRACED WALL-WOOD STRUCTURAL PANEL: (NOTED AS "IBW-MSP" ON PLANS). ATTACH ONE SIDE WITH %" MSP SHEATHING WITH & NAILS AT A 6"/12" NAILING PATTERN (6" OC AT PANEL EDGES AND 12" OC AT INTERMEDIATE SUPPORTS), INSTALL BLOCKING AT ALL PANEL EDGES, ATTACH OB OVER MSP AS REQUIRED, ATTACH OPPOSITE SIDE WITH 1/2" OB WITH A MIN, OF 5d COOLER NAILS OR #6 SCREWS @ 7" OC ALONG THE EDGES AND AT INTERMEDIATE SUPPORTS.

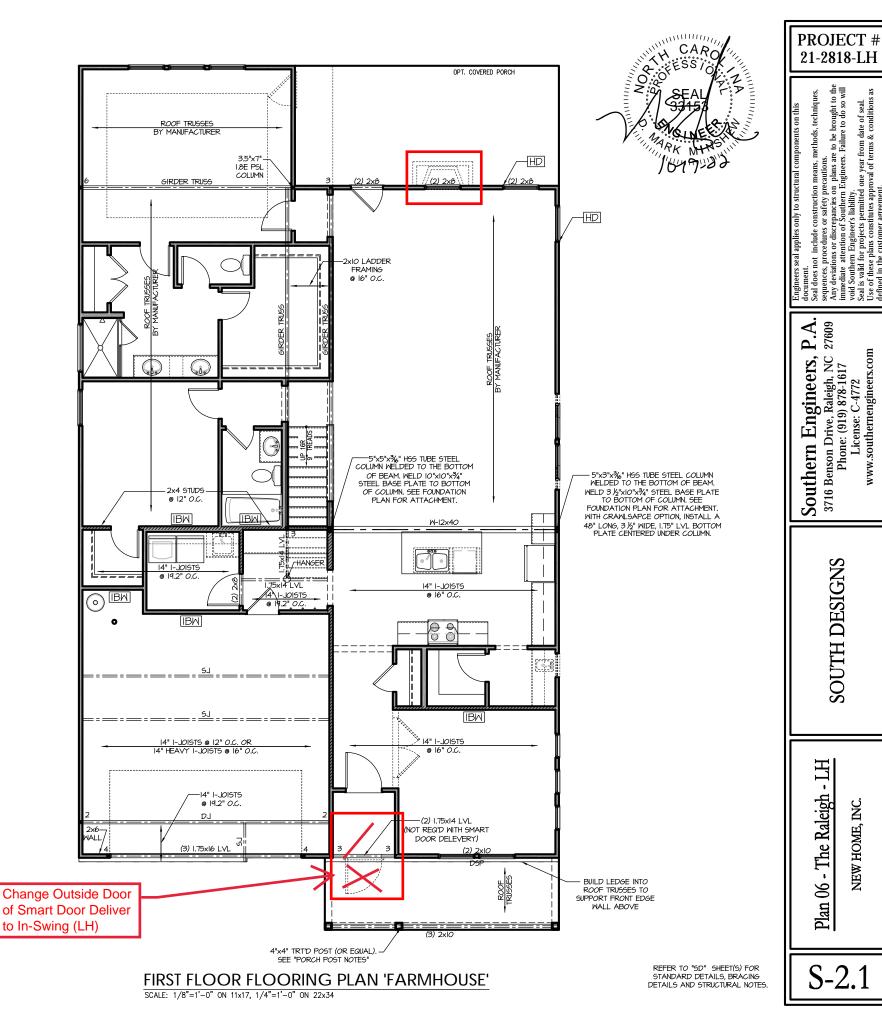

to be brought to t Failure to do so wi

SOUTH DESIGNS


Raleigh

The

Plan


HOME,


one year from date of seal.

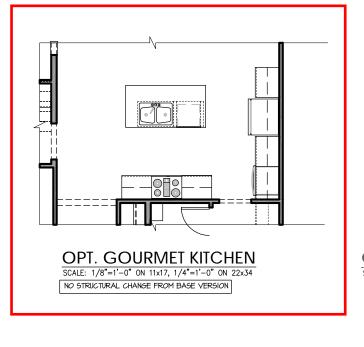


Change outside door


of Smart Door Deliver to In-swing (LH)

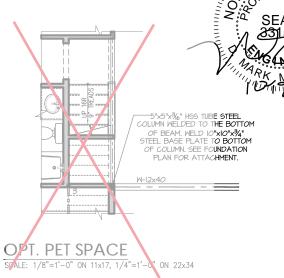

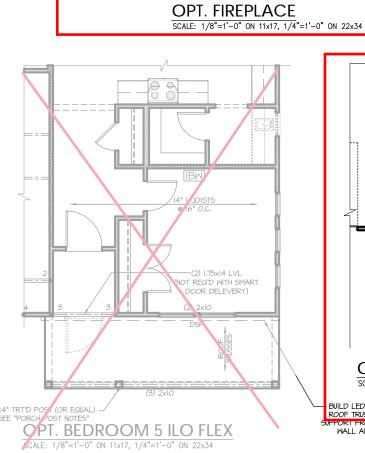

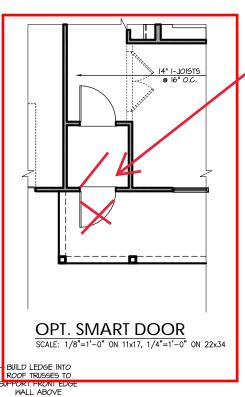



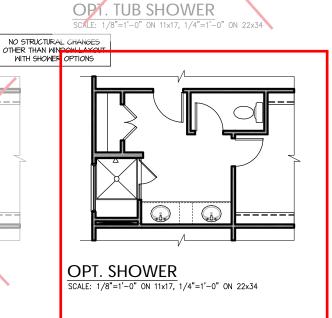

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PROJECT # 21-2818-LH

SOUTH DESIGNS

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S-2.1.1

REFER TO "5D" SHEET(5) FOR STANDARD DETAILS, BRACING DETAILS AND STRUCTURAL NOTES.

TRUSS SYSTEM REQUIREMENTS

NC (2018 NCRC): Wind: 115-120 mph

- TRUSS SYSTEM LAYOUTS (PLACEMENT PLANS) SHALL BE DESIGNED IN ACCORDANCE WITH SEALED STRUCTURAL PLANS. ANY NEED TO CHANGE TRUSSES SHALL BE COORDINATED WITH SOUTHERN
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HEADER/BEAM & COLUMN NOTES


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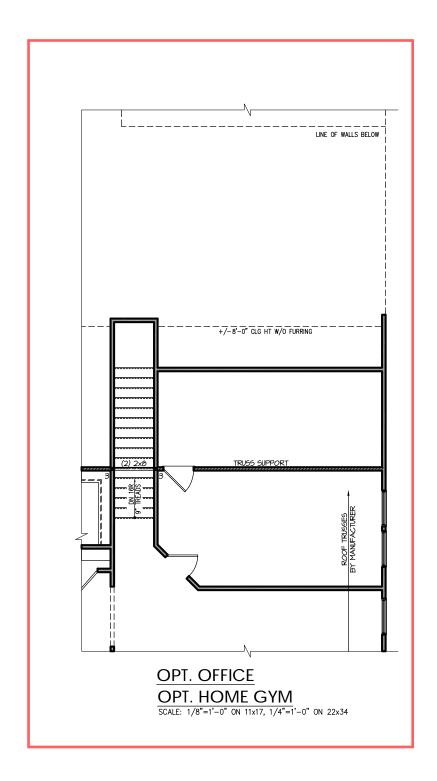
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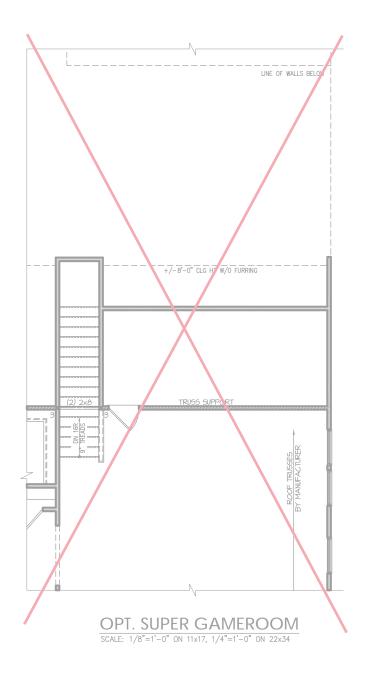
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Raleigh





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REFER TO "SD" SHEET(S) FOR STANDARD DETAILS, BRACING DETAILS AND STRUCTURAL NOTES.


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	ATTIC VENT SCHEDULE											
FARMHOUSE												
MAIN HOUSE SQ FTG 2431 AT / NEAR RIDGE AT / NEAR EAVE												
VENT TYPE		. FT. SQ. FT.		PERCENT OF TOTAL	POT LARGE (SQ. FT. EACH)	POT SMALL (SQ. FT. EACH)	RIDGE VENT (SQ. FT. PER LF)	EAVE VENT (SQ. IN. EACH)	CONT. VENT (SQ. IN. PER LF)			
	RAN	IGE	SUPPLIED	SUPPLIED	0.4236	0.2778	0.125	0.1944	0.0625			
			_									
RIDGE VENT	3.24	4.05	7.50	72.29	0	0	60.00					
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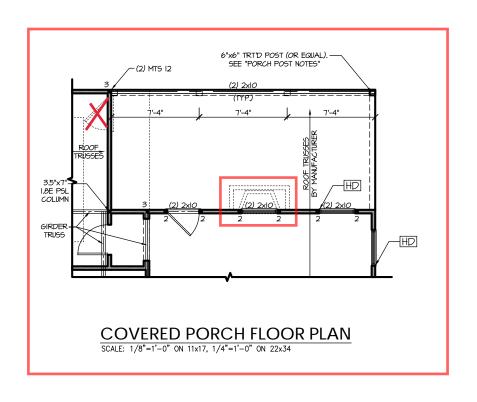
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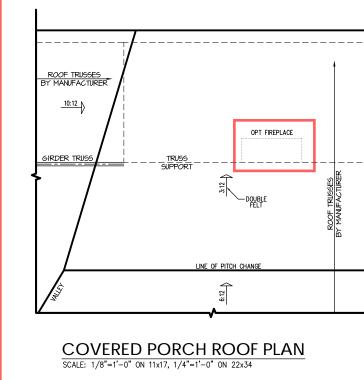
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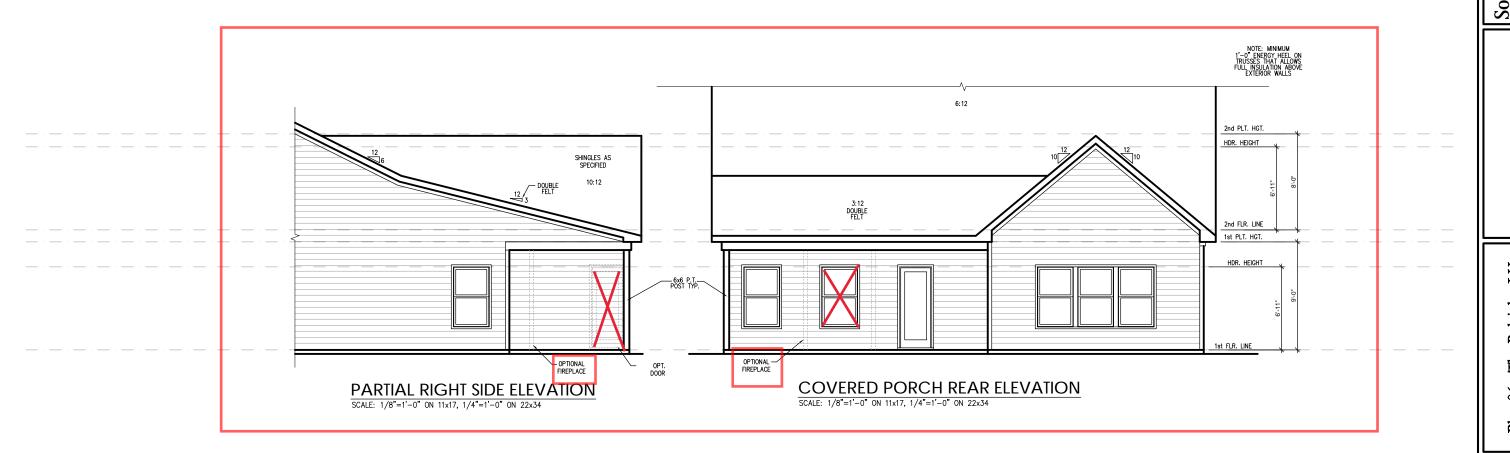
Raleigh

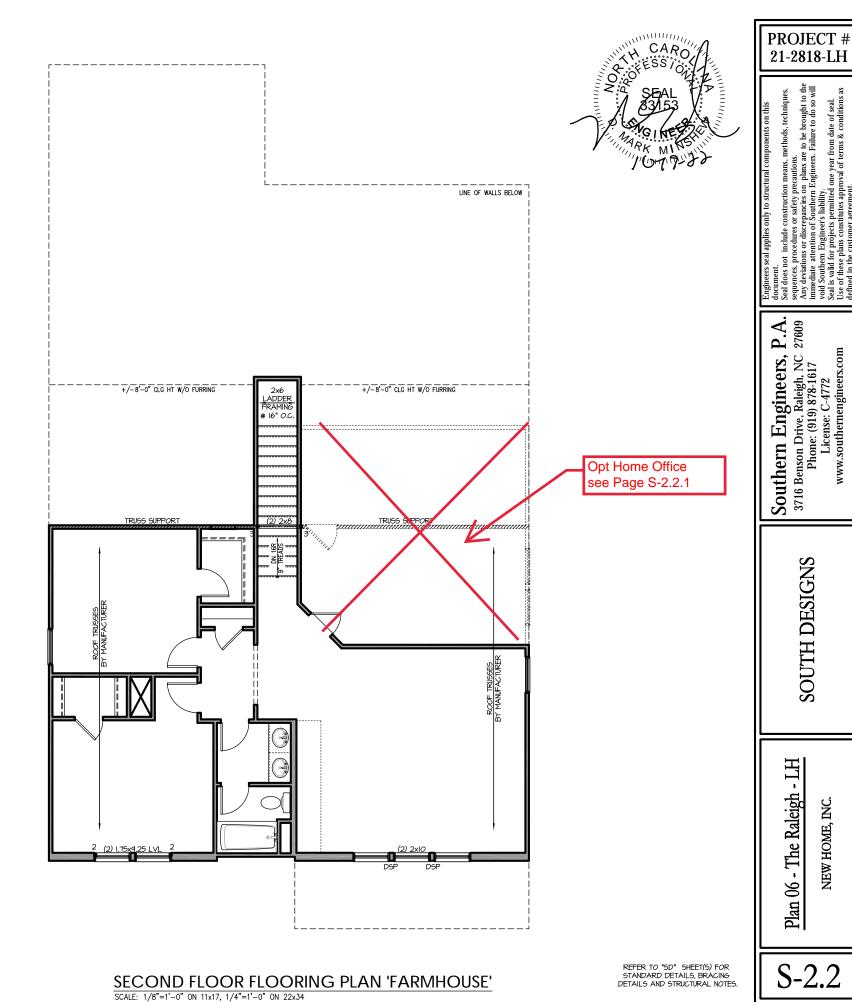





P.A. 27609

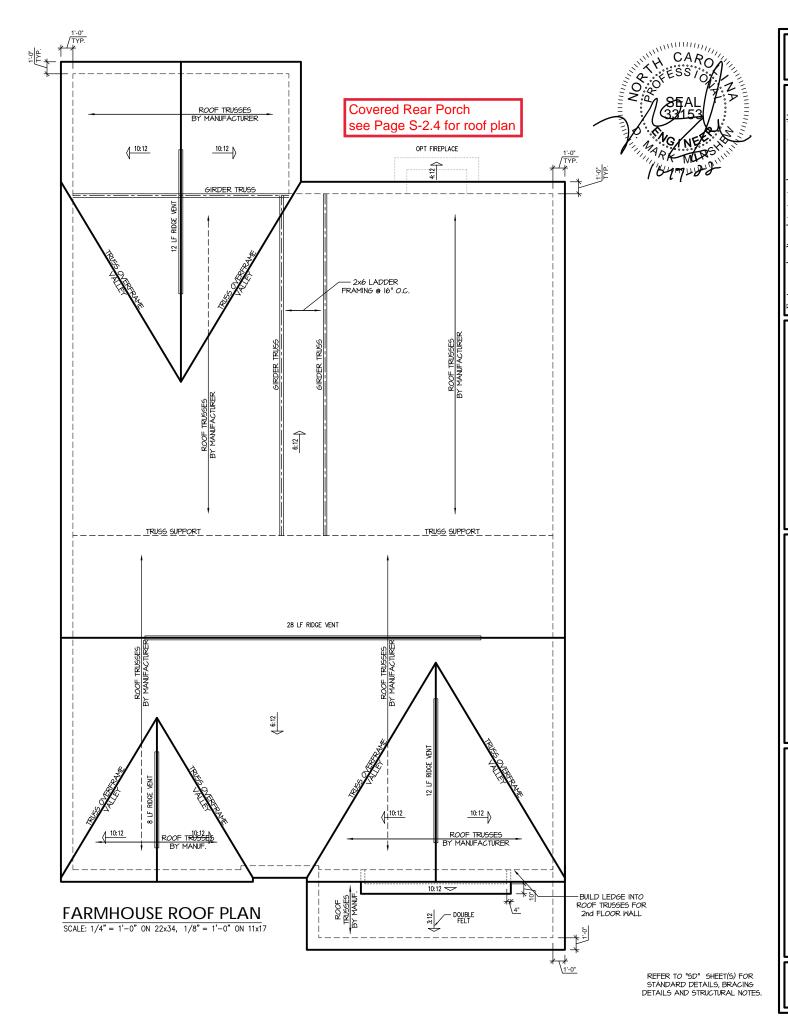

TRUSS SYSTEM REQUIREMENTS NC (2018 NCRC): Wind: 115-120 mph

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SOUTH DESIGNS

The Raleigh NEW HOME, INC. Plan 06