

# ATTIC VENTILATION

### 2360 = 7.86 sq. ft. REQD. 3*00* \* ( ) -BASE, / VENTS = \* ( ) -BASE, / VENTS = \* (74') - RIDGE VENT @ 9 sq.in./ft. = 4.62 SQ. FT. <u>TOTAL</u> = 4.62 SQ. FT.

\*\* PROVIDE CONTINUOUS SOFFIT VENT SUUROUND TO EQUAL OR EXCEED 3.93 SQ. FT. \*\*\* (OPT.) PROVIDE THEMOSTATICALLY CONTROLLED POWER VENT TO EQUAL OR EXCEED 3.93 SQ. FT.

#### CODE INFORMATION \* ZONE: (CHECK ONE) ZONE 7 ZONE 8 ZONE \* GLAZING U-FACTOR \* R-VALUES CEILING R-38 FLOOR BSMNT, WALL SLAB PERIMETER CRAWL SPACE WALL MEAN ROOF HEIGHT 20'-7" WALL AND ROOF CLADDING DESIGN VALUE: (MEAN ROOF HGT. 30 ft. OR LESS) CRAWL SPACE WALL +18.0, -24.1

EXPOSURE ADJUSTMENT

ROOF PITCH 0/12 TO 2.25/12 +10.0, -45.4 ROOF PITCH 2.25/12 TO 7/12 +10.4,-34.8 ROOF PITCH 7/12 TO 12/12 +16.5,-21.0

8 

S

ボ 女 元 (万 公 元)

MURPHY GARNOW DESIGN GROUP

CARY, NORTH CAROLINA 27511 919) 481-9115 FAX; (919) 481-69

ALL DIMENSIONS, SITE

CONDITIONS & CODES ARE TO

BE VERIFIED BEFORE CONSTR.

BEGINS. ONCE CONSTR. HAS

BEGUN MURPHY GARNOW

DESIGN CONSTR. HIS.

DESIGN GROUP, INC. WILL NOT ASSUME ANY LIABILITY FOR ANY EXPENSES ASSOCIATED

WITH ERRORS & OMISSIONS.

DRAWN BY: TWG 2-22-10

FILE NAME: 157-2-2625 REVISIONS

7-6-11 TWG PLAN

4-3-14 TWG PLAN

1-23-15 TWG ELEV.

2-4-15 TWG ELEV.

1-11-23 TWG ELEV.


© COPYRIGHT 2023 MURPHY GARNOW DESIGN GROUP, INC. ALL RIGHTS RESERVED

HOUSE NAME:

HOUSE NUMBER:


PAGE NUMBER:

THESE PLANS MEET THE REQUIREMENTS OF THE INTERNATIONALRESIDENTIAL CODE '2015' EDITION NORTH CAROLINA RESIDENTIAL CODE '2018' EDITION.

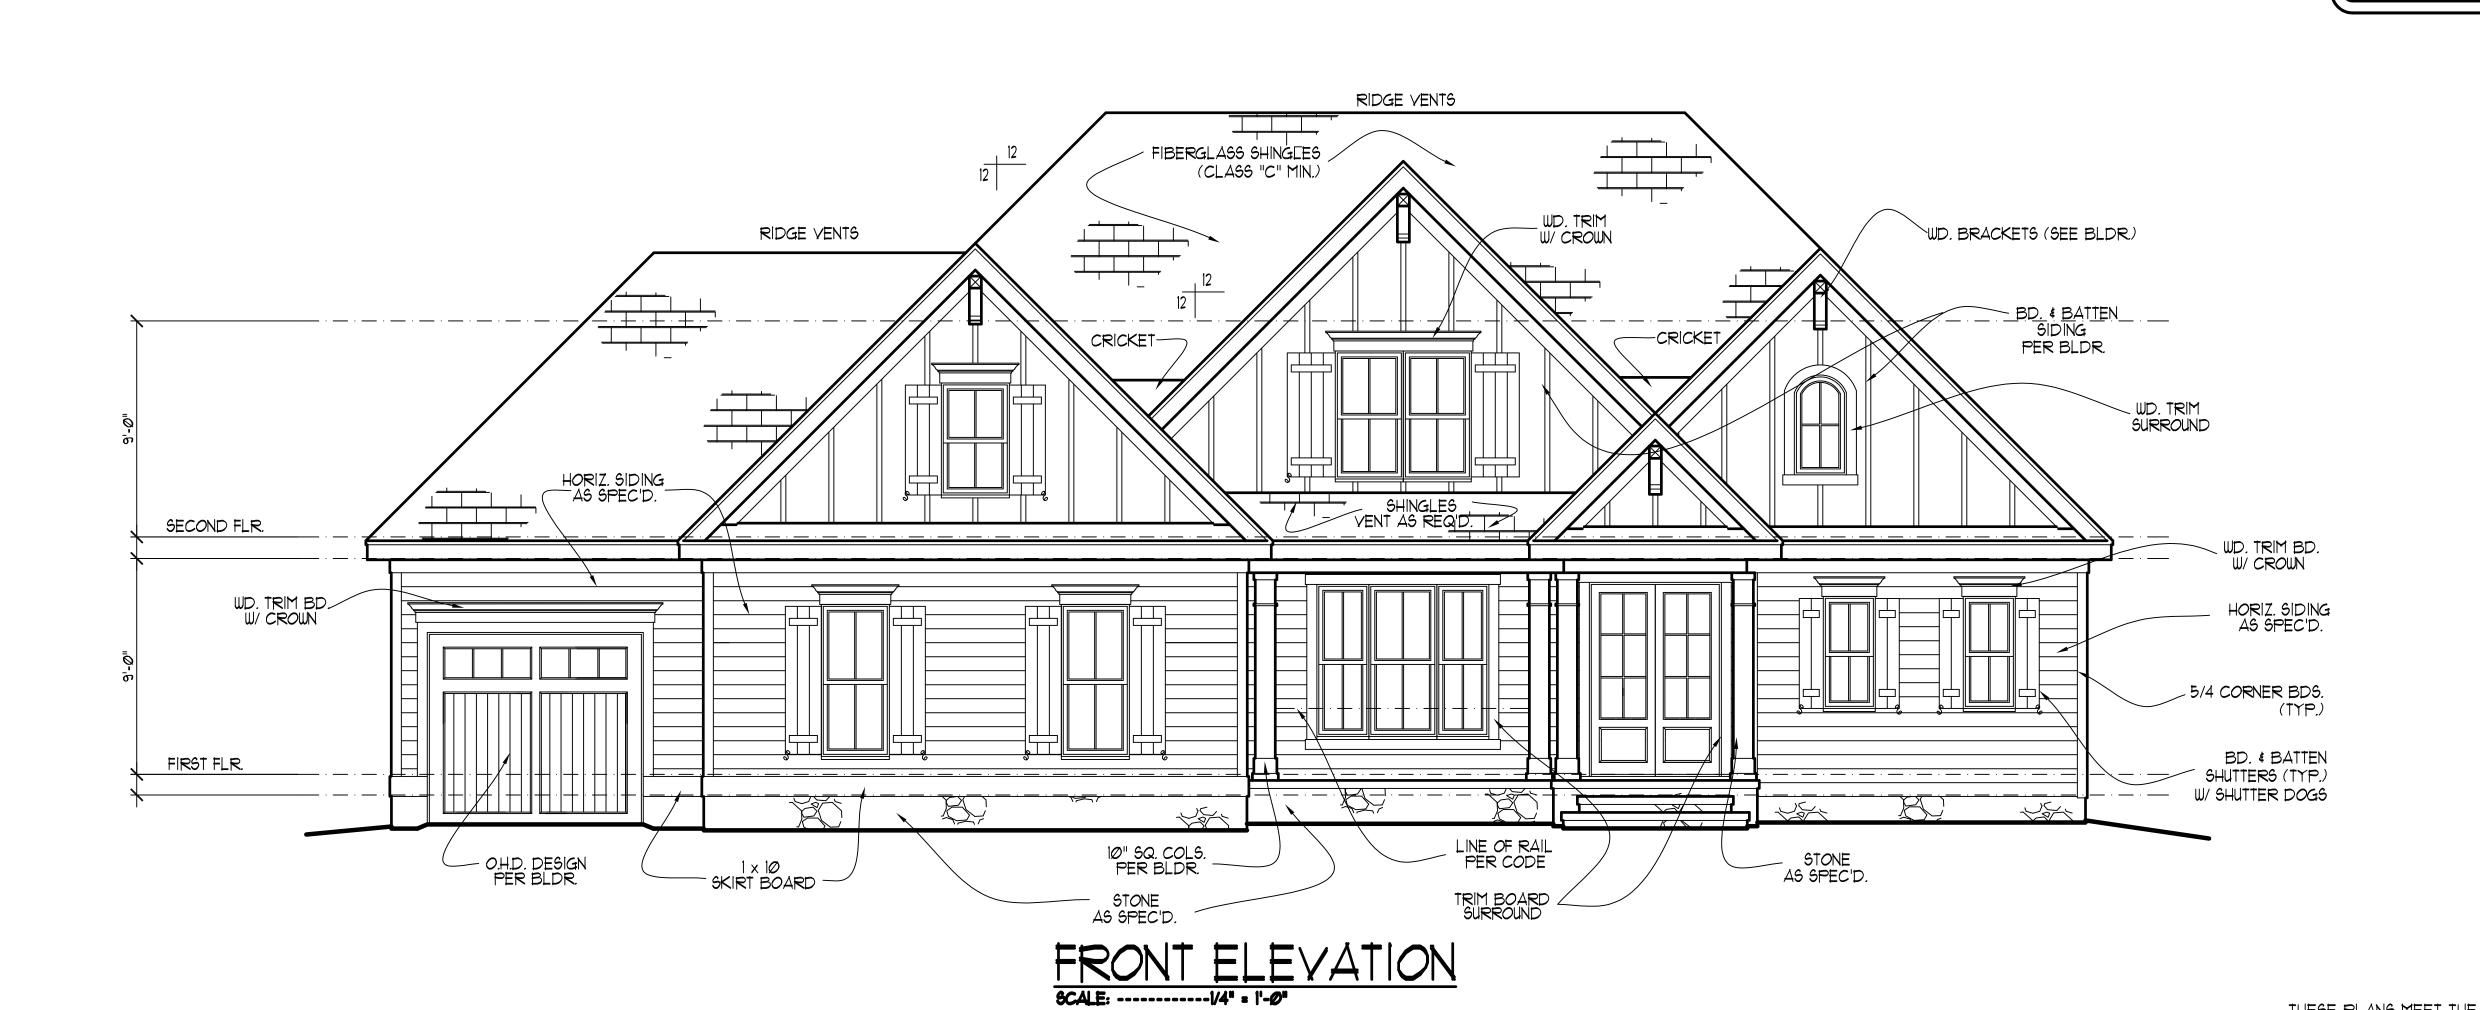

SCALE: -----1/4" = 1'-0"

# 

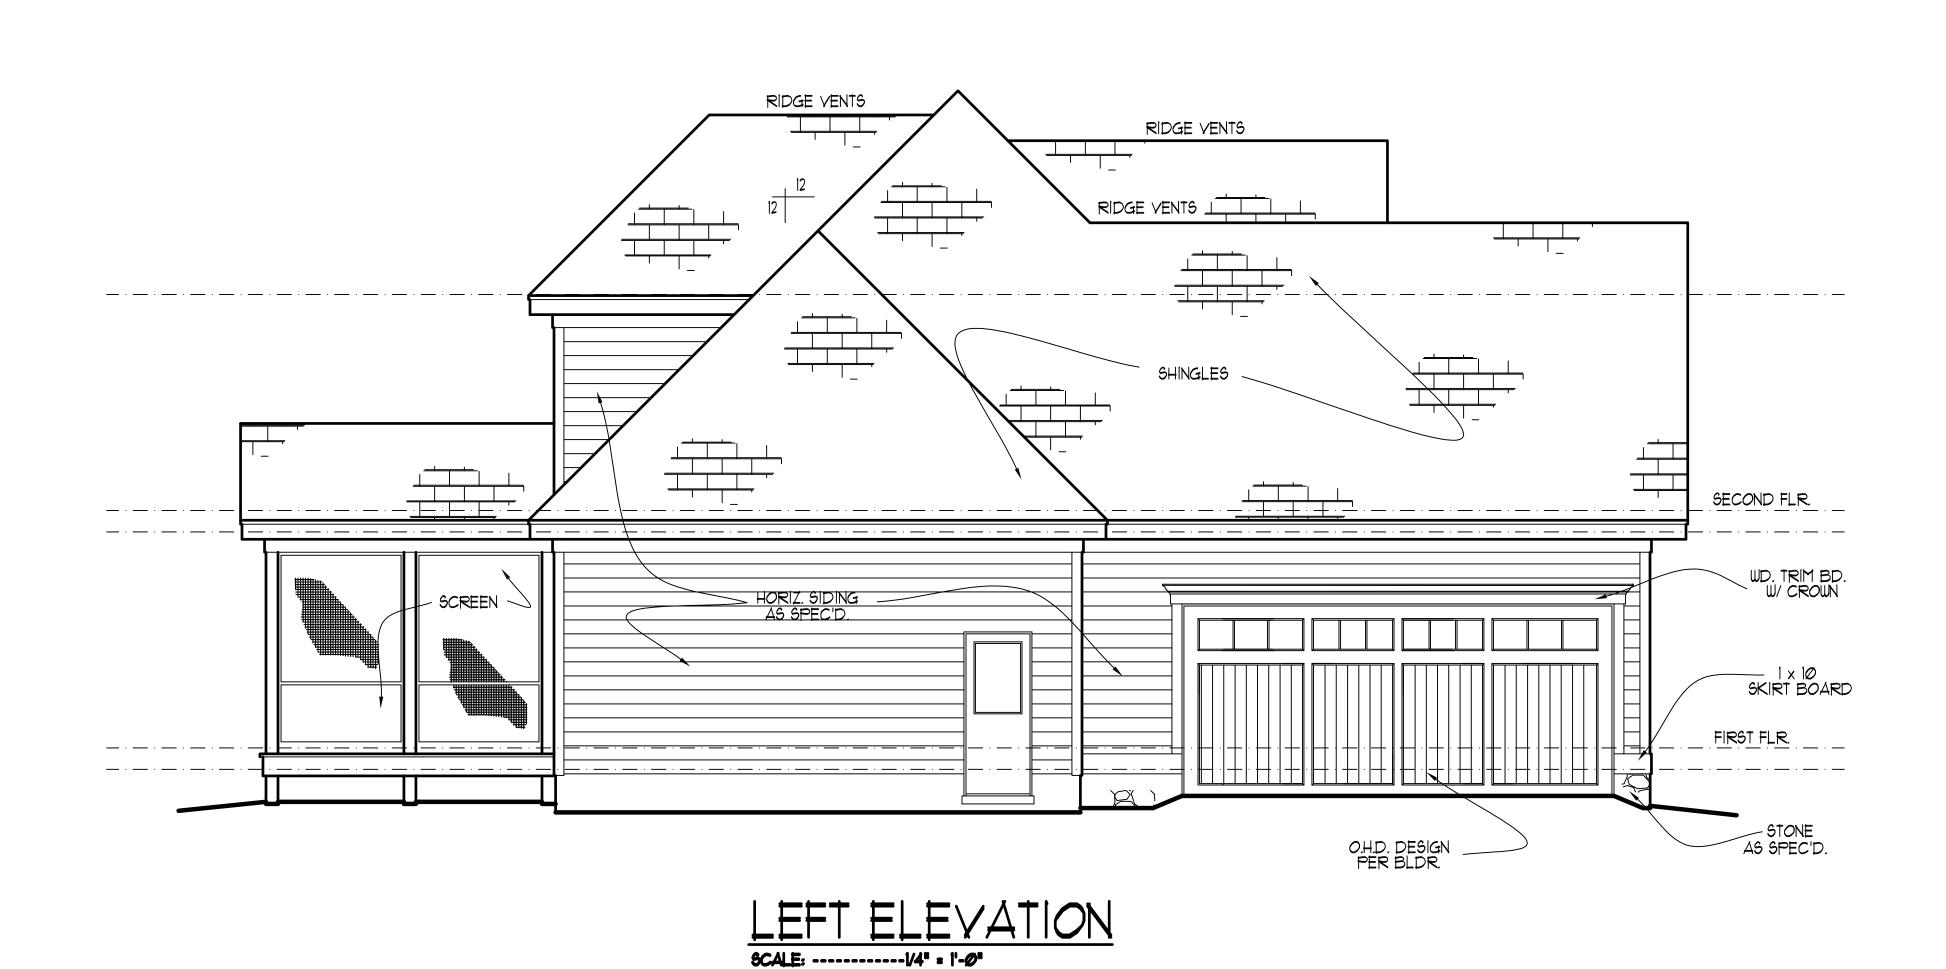

NOTE

MURPHY GARNOW DESIGN GROUP, INC.
HEREBY EXPRESSLY RESERVES ITS COPYRIGHT AND
OTHER PROPERTY RIGHTS TO THESE PLANS. THESE
PLANS ARE TO BE USED FOR THE CONSTRUCTION OF
(ONE) RESIDENCE ONLY, ANY OTHER USE, CHANGE
AND/OR REPRODUCTION IN ANY FORM WILL RENDER
THESE PLANS FRAUDULENT.

ALL DIMENSIONS, SITE
CONDITIONS & CODES ARE TO
BE VERIFIED BEFORE CONSTR.
BEGINS. ONCE CONSTR. HAS
BEGUN MURPHY GARNOW
DESIGN GROUP, INC. WILL NOT
ASSUME ANY LIABILITY FOR
ANY EXPENSES ASSOCIATED
WITH ERRORS & OMISSIONS.

CORS & OMISS

MURPHY GARNOW DESIGN GROUP, INC 1140-300 KILDAIKE FARM ROAD CARY NORTH CAROLINA 27511

1140-300 KILDAIRE P CARY, NORTH CAROL (919) 481-9115 FAX; (9

HALCYON HOMES
COTTON FARM
LOT #58

DRAWN BY: **TWG**DATE: **2-22-10**FILE NAME: **151-2-2625** 

REVISIONS

7-6-11 TWG PLAN

4-3-14 TWG PLAN

1-23-15 TWG ELEV.

2-4-15 TWG ELEV.

1-11-23 TWG ELEV.


© COPYRIGHT 2023 MURPHY GARNOW DESIGN GROUP, INC. ALL RIGHTS RESERVED

HOUSE NAME:

HOUSE NUMBER:

PAGE NUMBER:

2 OF 8

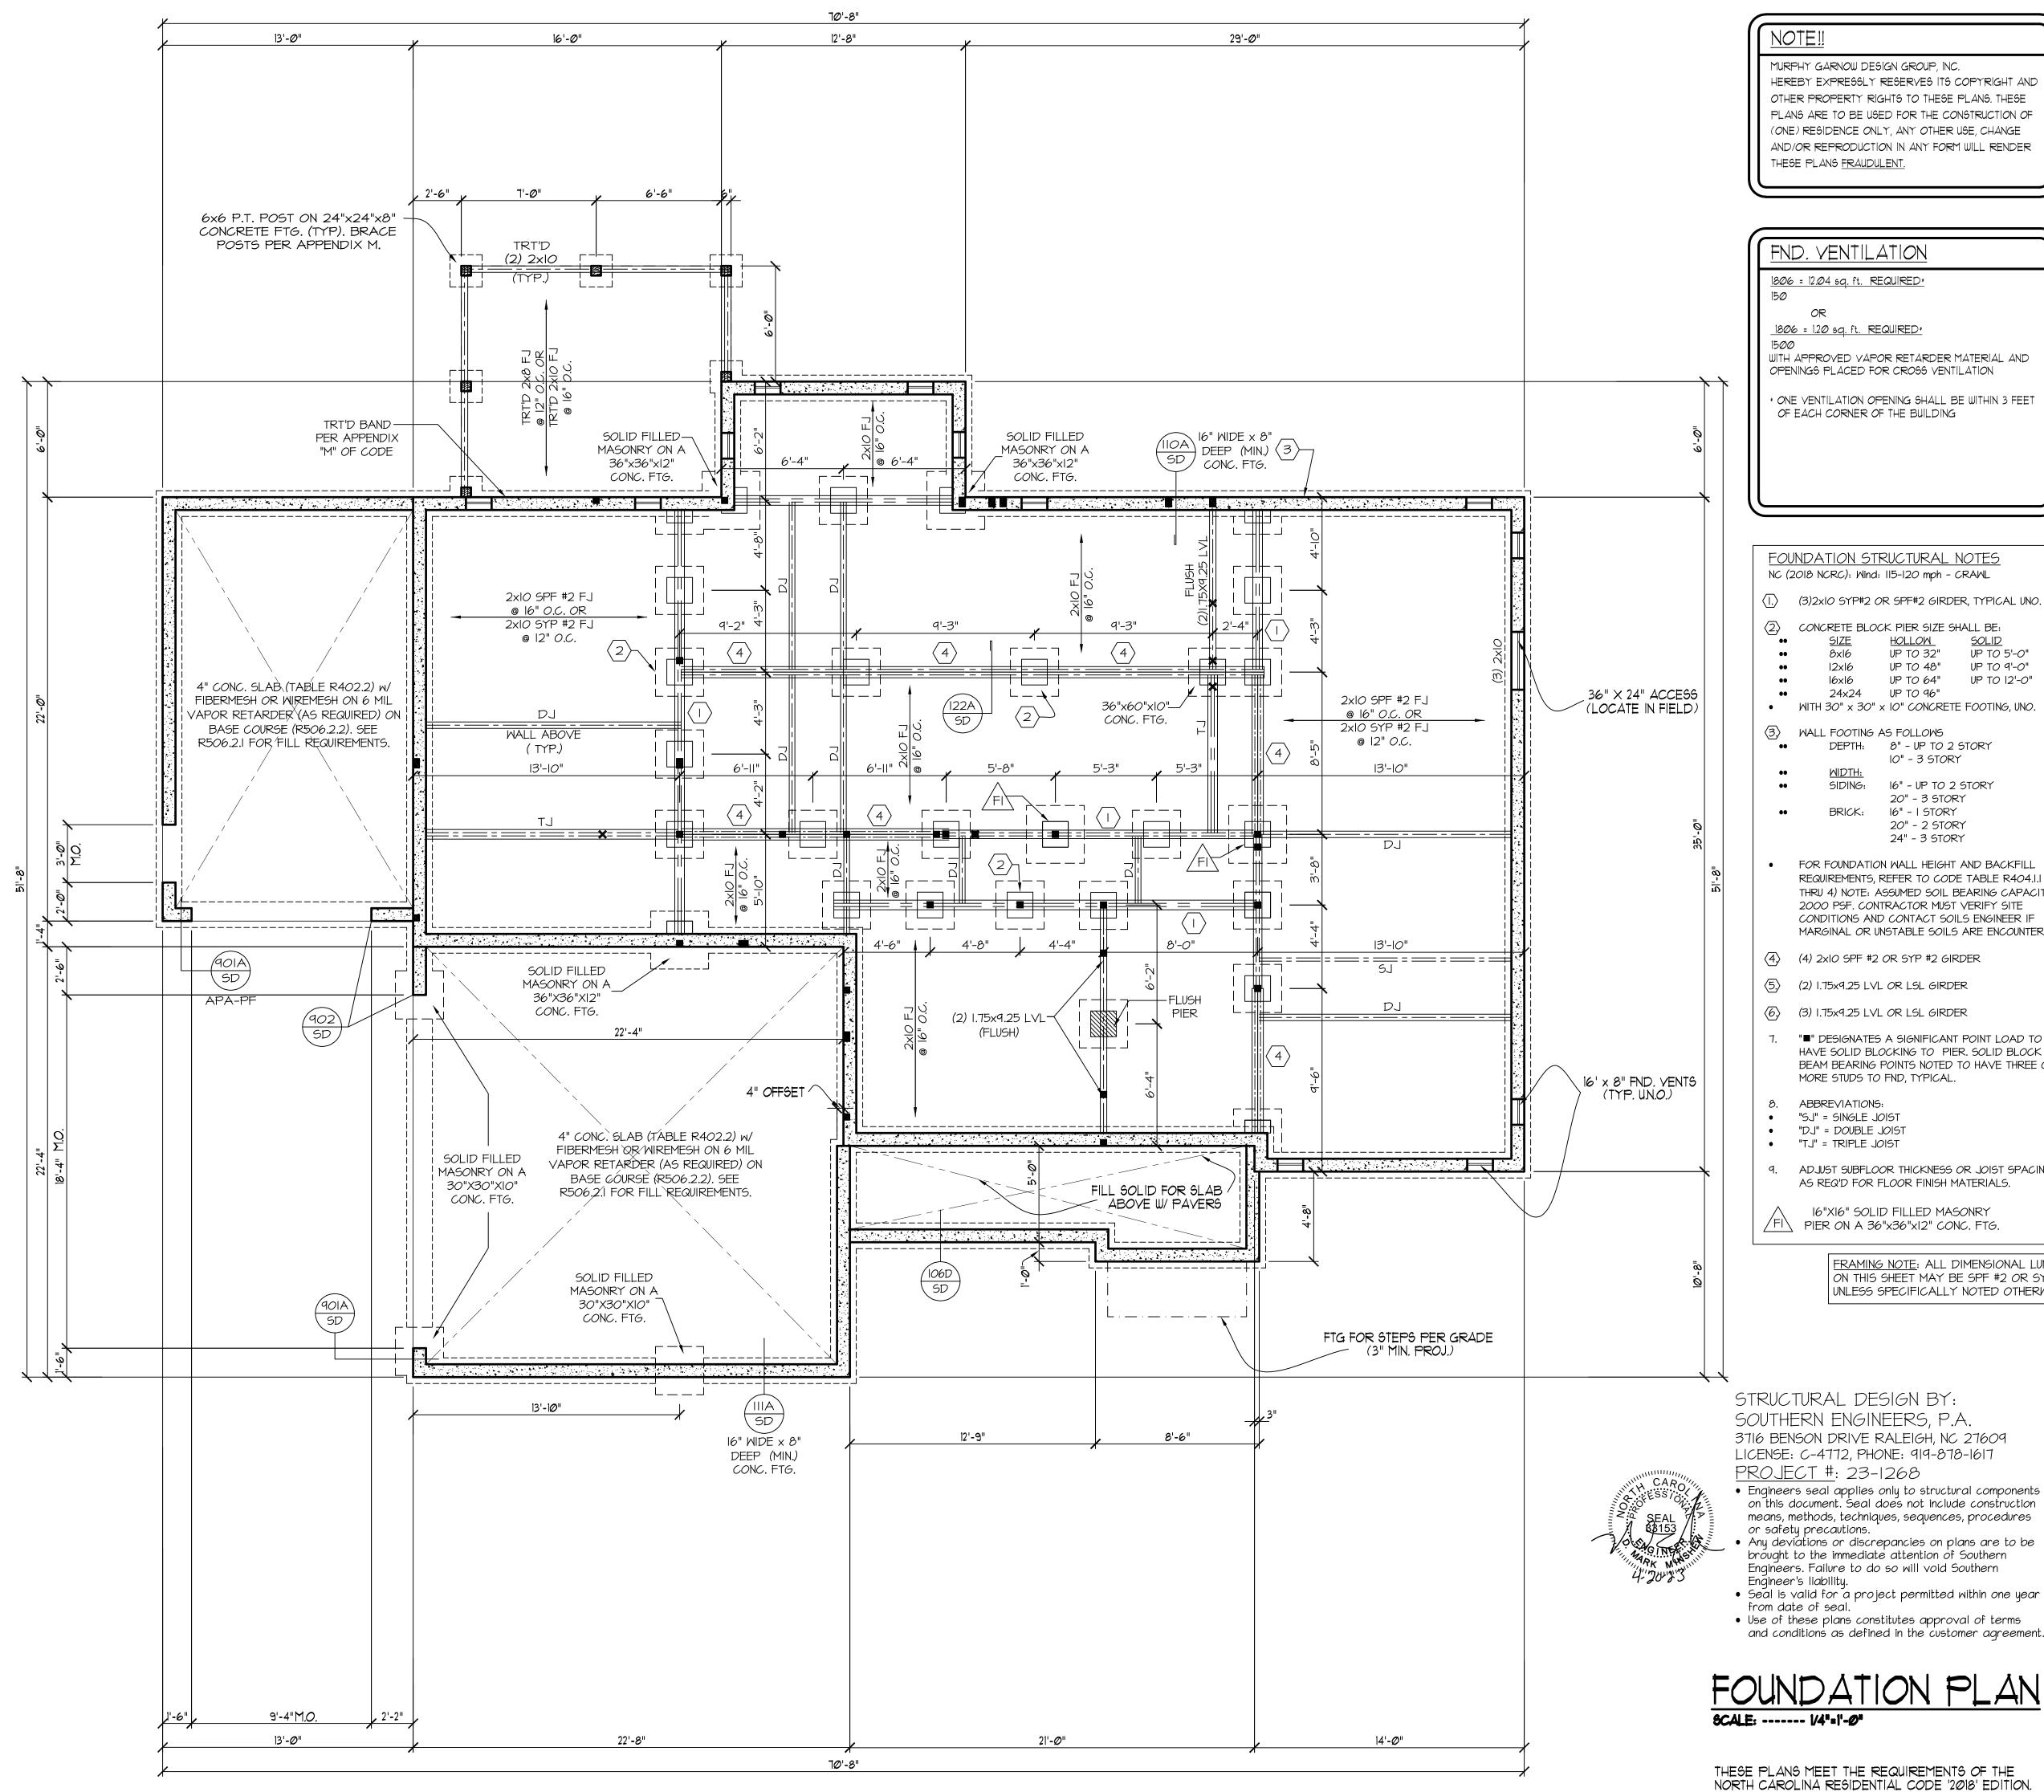

ALL DIMENSIONS, SITE CONDITIONS & CODES ARE TO BE VERIFIED BEFORE CONSTR. BEGINS. ONCE CONSTR. HAS BEGUN MURPHY GARNOW DESIGN GROUP, INC. WILL NOT ASSUME ANY LIABILITY FOR ANY EXPENSES ASSOCIATED

WITH ERRORS & OMISSIONS.

GARNOW

MURPHY

1806 = 1.20 sq. ft. REQUIRED\*

WITH APPROVED VAPOR RETARDER MATERIAL AND OPENINGS PLACED FOR CROSS VENTILATION

\* ONE VENTILATION OPENING SHALL BE WITHIN 3 FEET OF EACH CORNER OF THE BUILDING

FOUNDATION STRUCTURAL NOTES NC (2018 NCRC): Wind: 115-120 mph - CRAWL

(3)2xIO SYP#2 OR SPF#2 GIRDER, TYPICAL UNO.

CONCRETE BLOCK PIER SIZE SHALL BE:

UP TO 32" UP TO 5'-0" UP TO 48" UP TO 9'-0" UP TO 64" UP TO 12'-0"

24×24 UP TO 96" • WITH 30" x 30" x 10" CONCRETE FOOTING, UNO.

(3) WALL FOOTING AS FOLLOWS DEPTH: 8" - UP TO 2 STORY 10" - 3 STORY

16" - UP TO 2 STORY SIDING: 20" - 3 STORY 16" - I STORY BRICK: 20" - 2 STORY 24" - 3 STORY

FOR FOUNDATION WALL HEIGHT AND BACKFILL REQUIREMENTS, REFER TO CODE TABLE R404.I.I (I THRU 4) NOTE: ASSUMED SOIL BEARING CAPACITY = 2000 PSF. CONTRACTOR MUST VERIFY SITE CONDITIONS AND CONTACT SOILS ENGINEER IF MARGINAL OR UNSTABLE SOILS ARE ENCOUNTERED.

(4) 2xIO SPF #2 OR SYP #2 GIRDER

(5) (2) 1.75x9.25 LVL OR LSL GIRDER

(6) (3) 1.75x9.25 LVL OR LSL GIRDER

"■" DESIGNATES A SIGNIFICANT POINT LOAD TO HAVE SOLID BLOCKING TO PIER. SOLID BLOCK ALL BEAM BEARING POINTS NOTED TO HAVE THREE OR MORE STUDS TO FND, TYPICAL.

ABBREVIATIONS: "SJ" = SINGLE JOIST

9. ADJUST SUBFLOOR THICKNESS OR JOIST SPACING AS REQ'D FOR FLOOR FINISH MATERIALS.

16"X16" SOLID FILLED MASONRY PIER ON A 36"x36"x12" CONC. FTG.

> FRAMING NOTE: ALL DIMENSIONAL LUMBER ON THIS SHEET MAY BE SPF #2 OR SYP #2, UNLESS SPECIFICALLY NOTED OTHERWISE.

SOUTHERN ENGINEERS, P.A. 3716 BENSON DRIVE RALEIGH, NC 27609

LICENSE: C-4772, PHONE: 919-878-1617 PROJECT #: 23-1268

• Engineers seal applies only to structural components on this document. Seal does not include construction means, methods, techniques, sequences, procedures or safety precautions.

• Seal is valid for a project permitted within one year from date of seal.

 Use of these plans constitutes approval of terms and conditions as defined in the customer agreement.

FOUNDATION PLAN

THESE PLANS MEET THE REQUIREMENTS OF THE NORTH CAROLINA RESIDENTIAL CODE '2018' EDITION. Q 

DRAWN BY: TWG

2-22-10 FILE NAME: **157-2-2625** 

REVISIONS

1-6-11 TWG PLAN

4-3-14 TWG PLAN


1-23-15 TWG ELEY.

2-4-15 TWG ELEY. 1-11-23 TWG ELEY.

© COPYRIGHT 2023 MURPHY GARNOW DESIGN GROUP, INC. ALL RIGHTS RESERVED

HOUSE NAME:

HOUSE NUMBER:

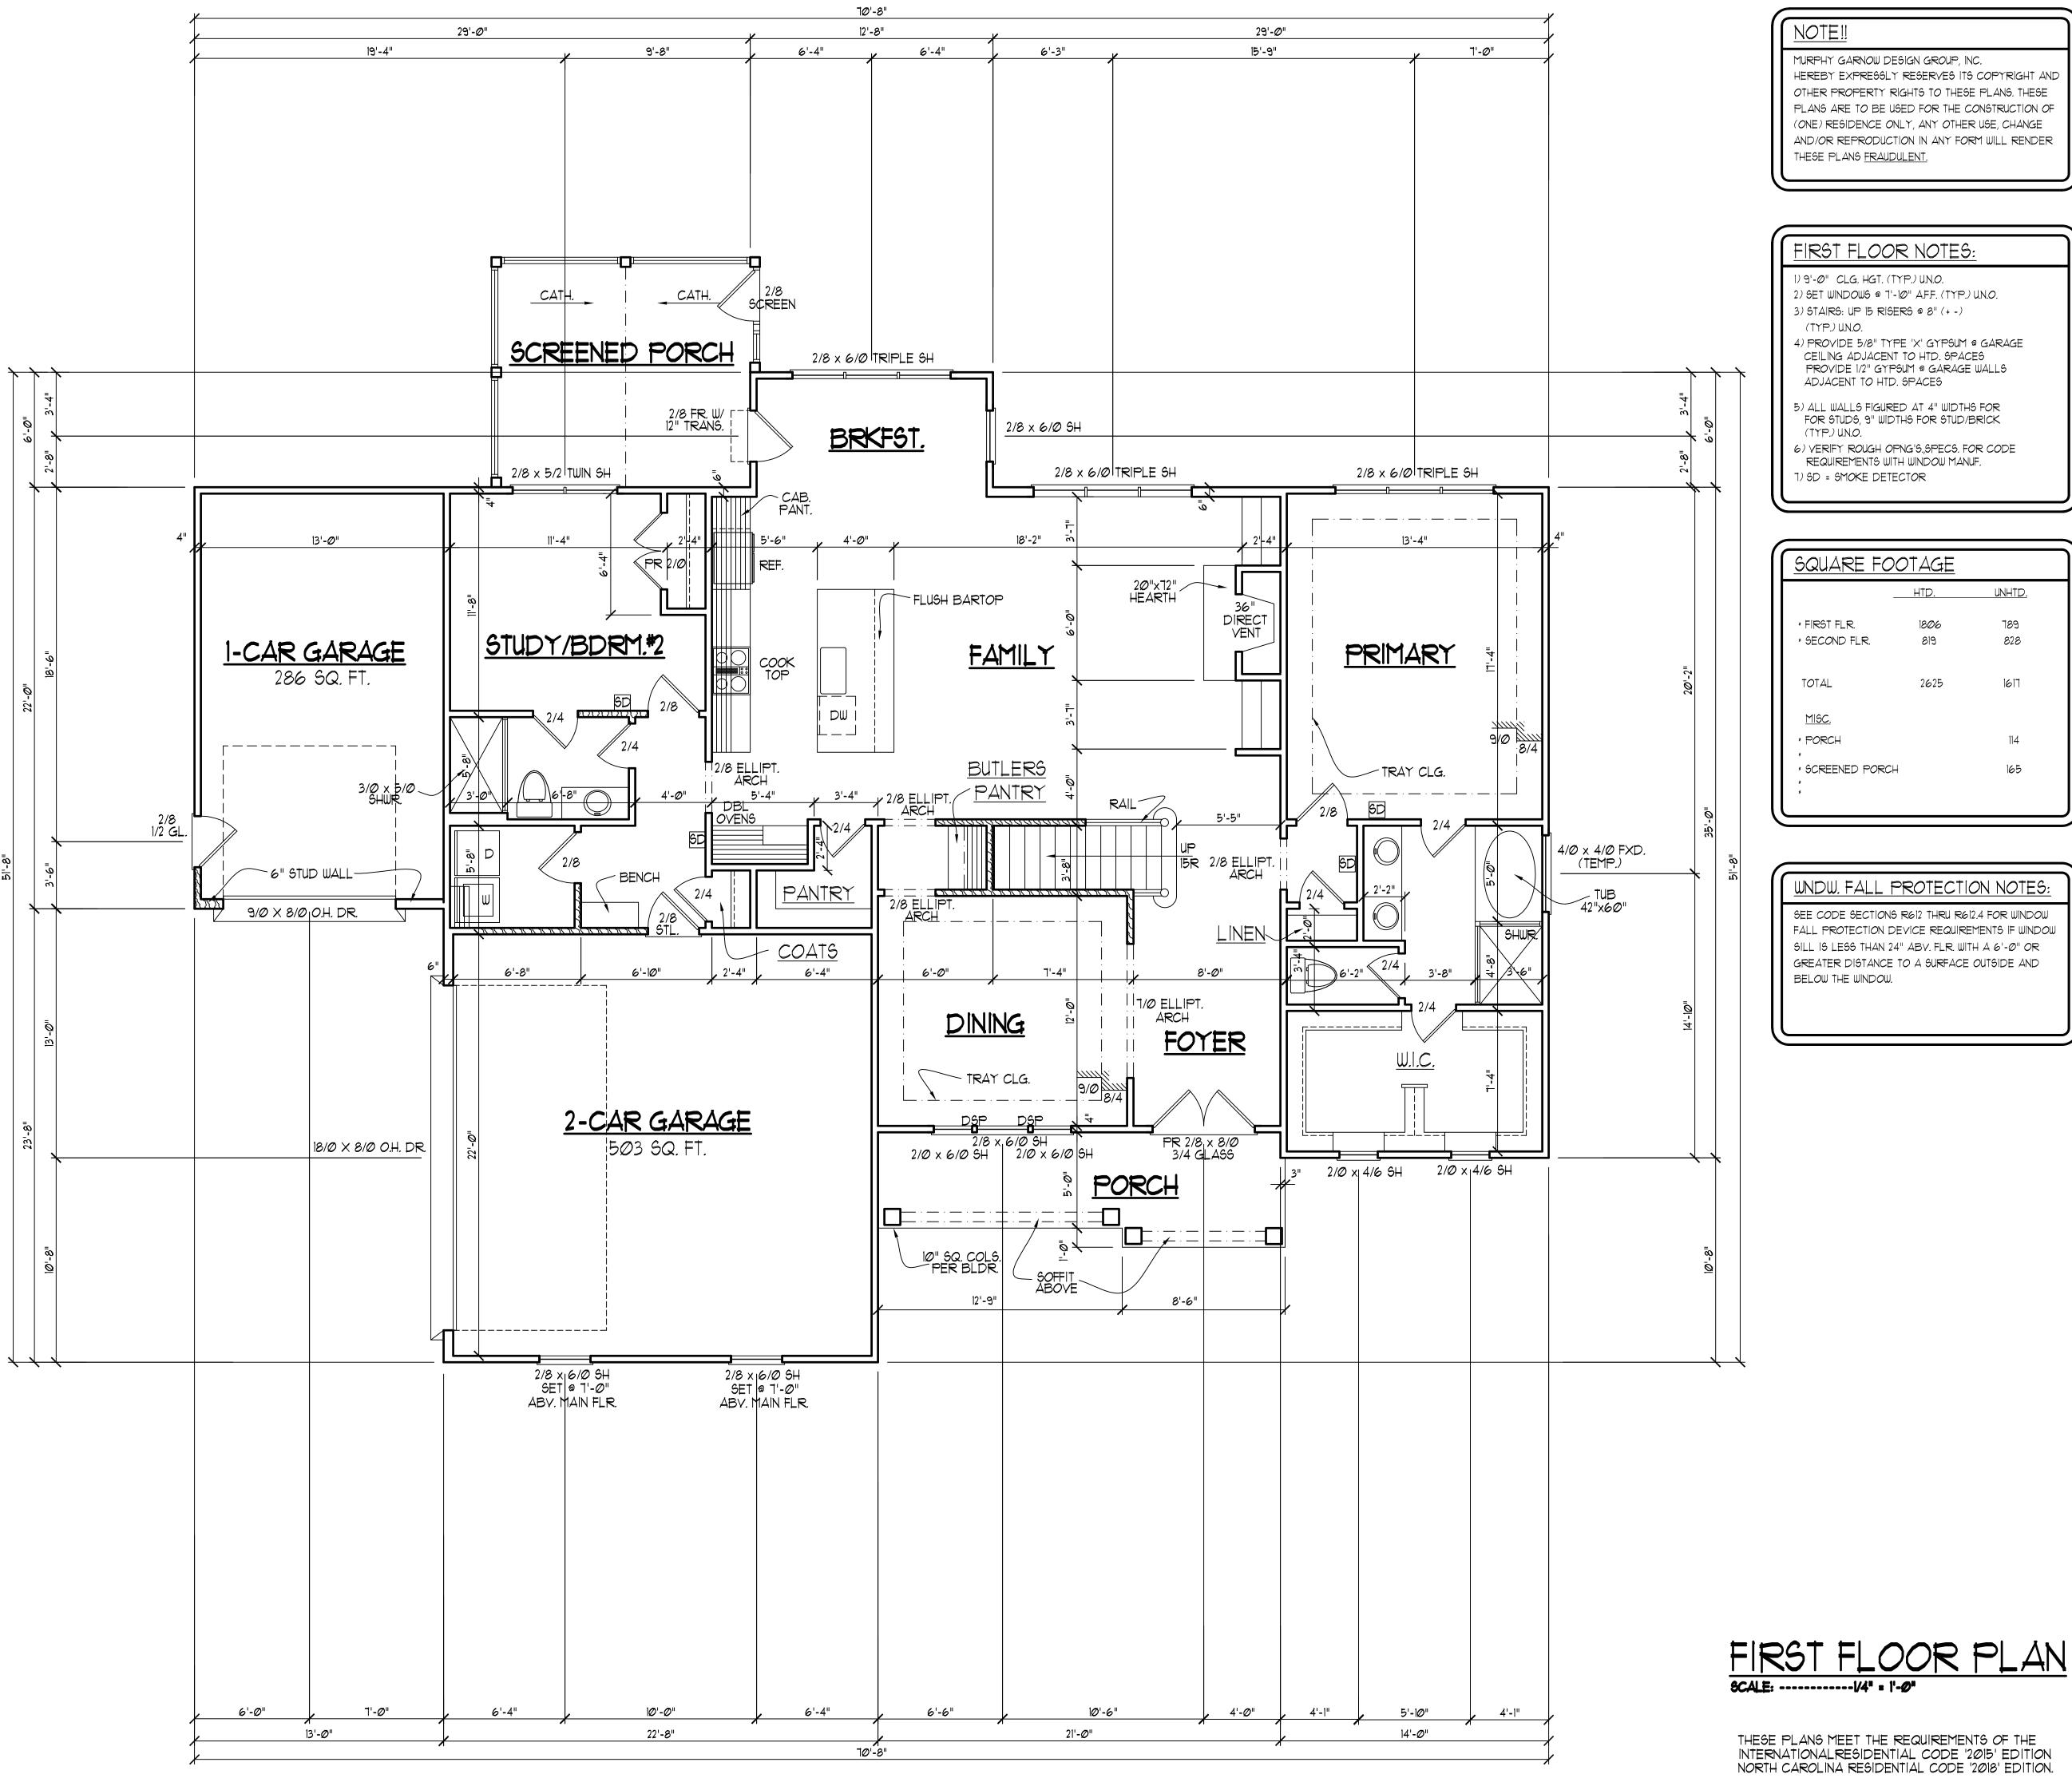

# FIRST FLOOR NOTES:

- 1) 9'-0" CLG. HGT. (TYP.) U.N.O. 2) SET WINDOWS @ 7'-10" A.F.F. (TYP.) U.N.O.
- 3) STAIRS: UP 15 RISERS @ 8" (+ -)
- 4) PROVIDE 5/8" TYPE 'X' GYPSUM @ GARAGE CEILING ADJACENT TO HTD. SPACES PROVIDE 1/2" GYPSUM @ GARAGE WALLS ADJACENT TO HTD. SPACES
- 5) ALL WALLS FIGURED AT 4" WIDTHS FOR FOR STUDS, 9" WIDTHS FOR STUD/BRICK
- 6) VERIFY ROUGH OPNG'S, SPECS. FOR CODE
- REQUIREMENTS WITH WINDOW MANUF.
- 1) SD = SMOKE DETECTOR

QUARE	FOOTAGE	

<u> </u>			
_	HTD.	UNHTD.	
* FIRST FLR. * SECOND FLR.	1806 813	789 828	
TOTAL	2625	1617	
MISC.			
* PORCH		114	
* * SCREENED PORCH *	+	165	
*			

# WNDW. FALL PROTECTION NOTES:

SEE CODE SECTIONS R612 THRU R612.4 FOR WINDOW SILL IS LESS THAN 24" ABV. FLR. WITH A 6'-0" OR GREATER DISTANCE TO A SURFACE OUTSIDE AND

DESIGN GROUP, INC. WILL NOT ASSUME ANY LIABILITY FOR ANY EXPENSES ASSOCIATED WITH ERRORS & OMISSIONS.

GARNOW DESIGN GROUP

MURPHY

**>** 

9

 $\frac{1}{4}$ 

DRAWN BY: TWG 2-22-10

FILE NAME: 157-2-2625 REVISIONS

1-6-11 TWG PLAN

4-3-14 TWG PLAN


1-23-15 TWG ELEY.

2-4-15 TWG ELEY.

1-11-23 TWG ELEY.

© COPYRIGHT 2023
MURPHY GARNOW DESIGN
GROUP, INC.
ALL RIGHTS RESERVED

HOUSE NAME:

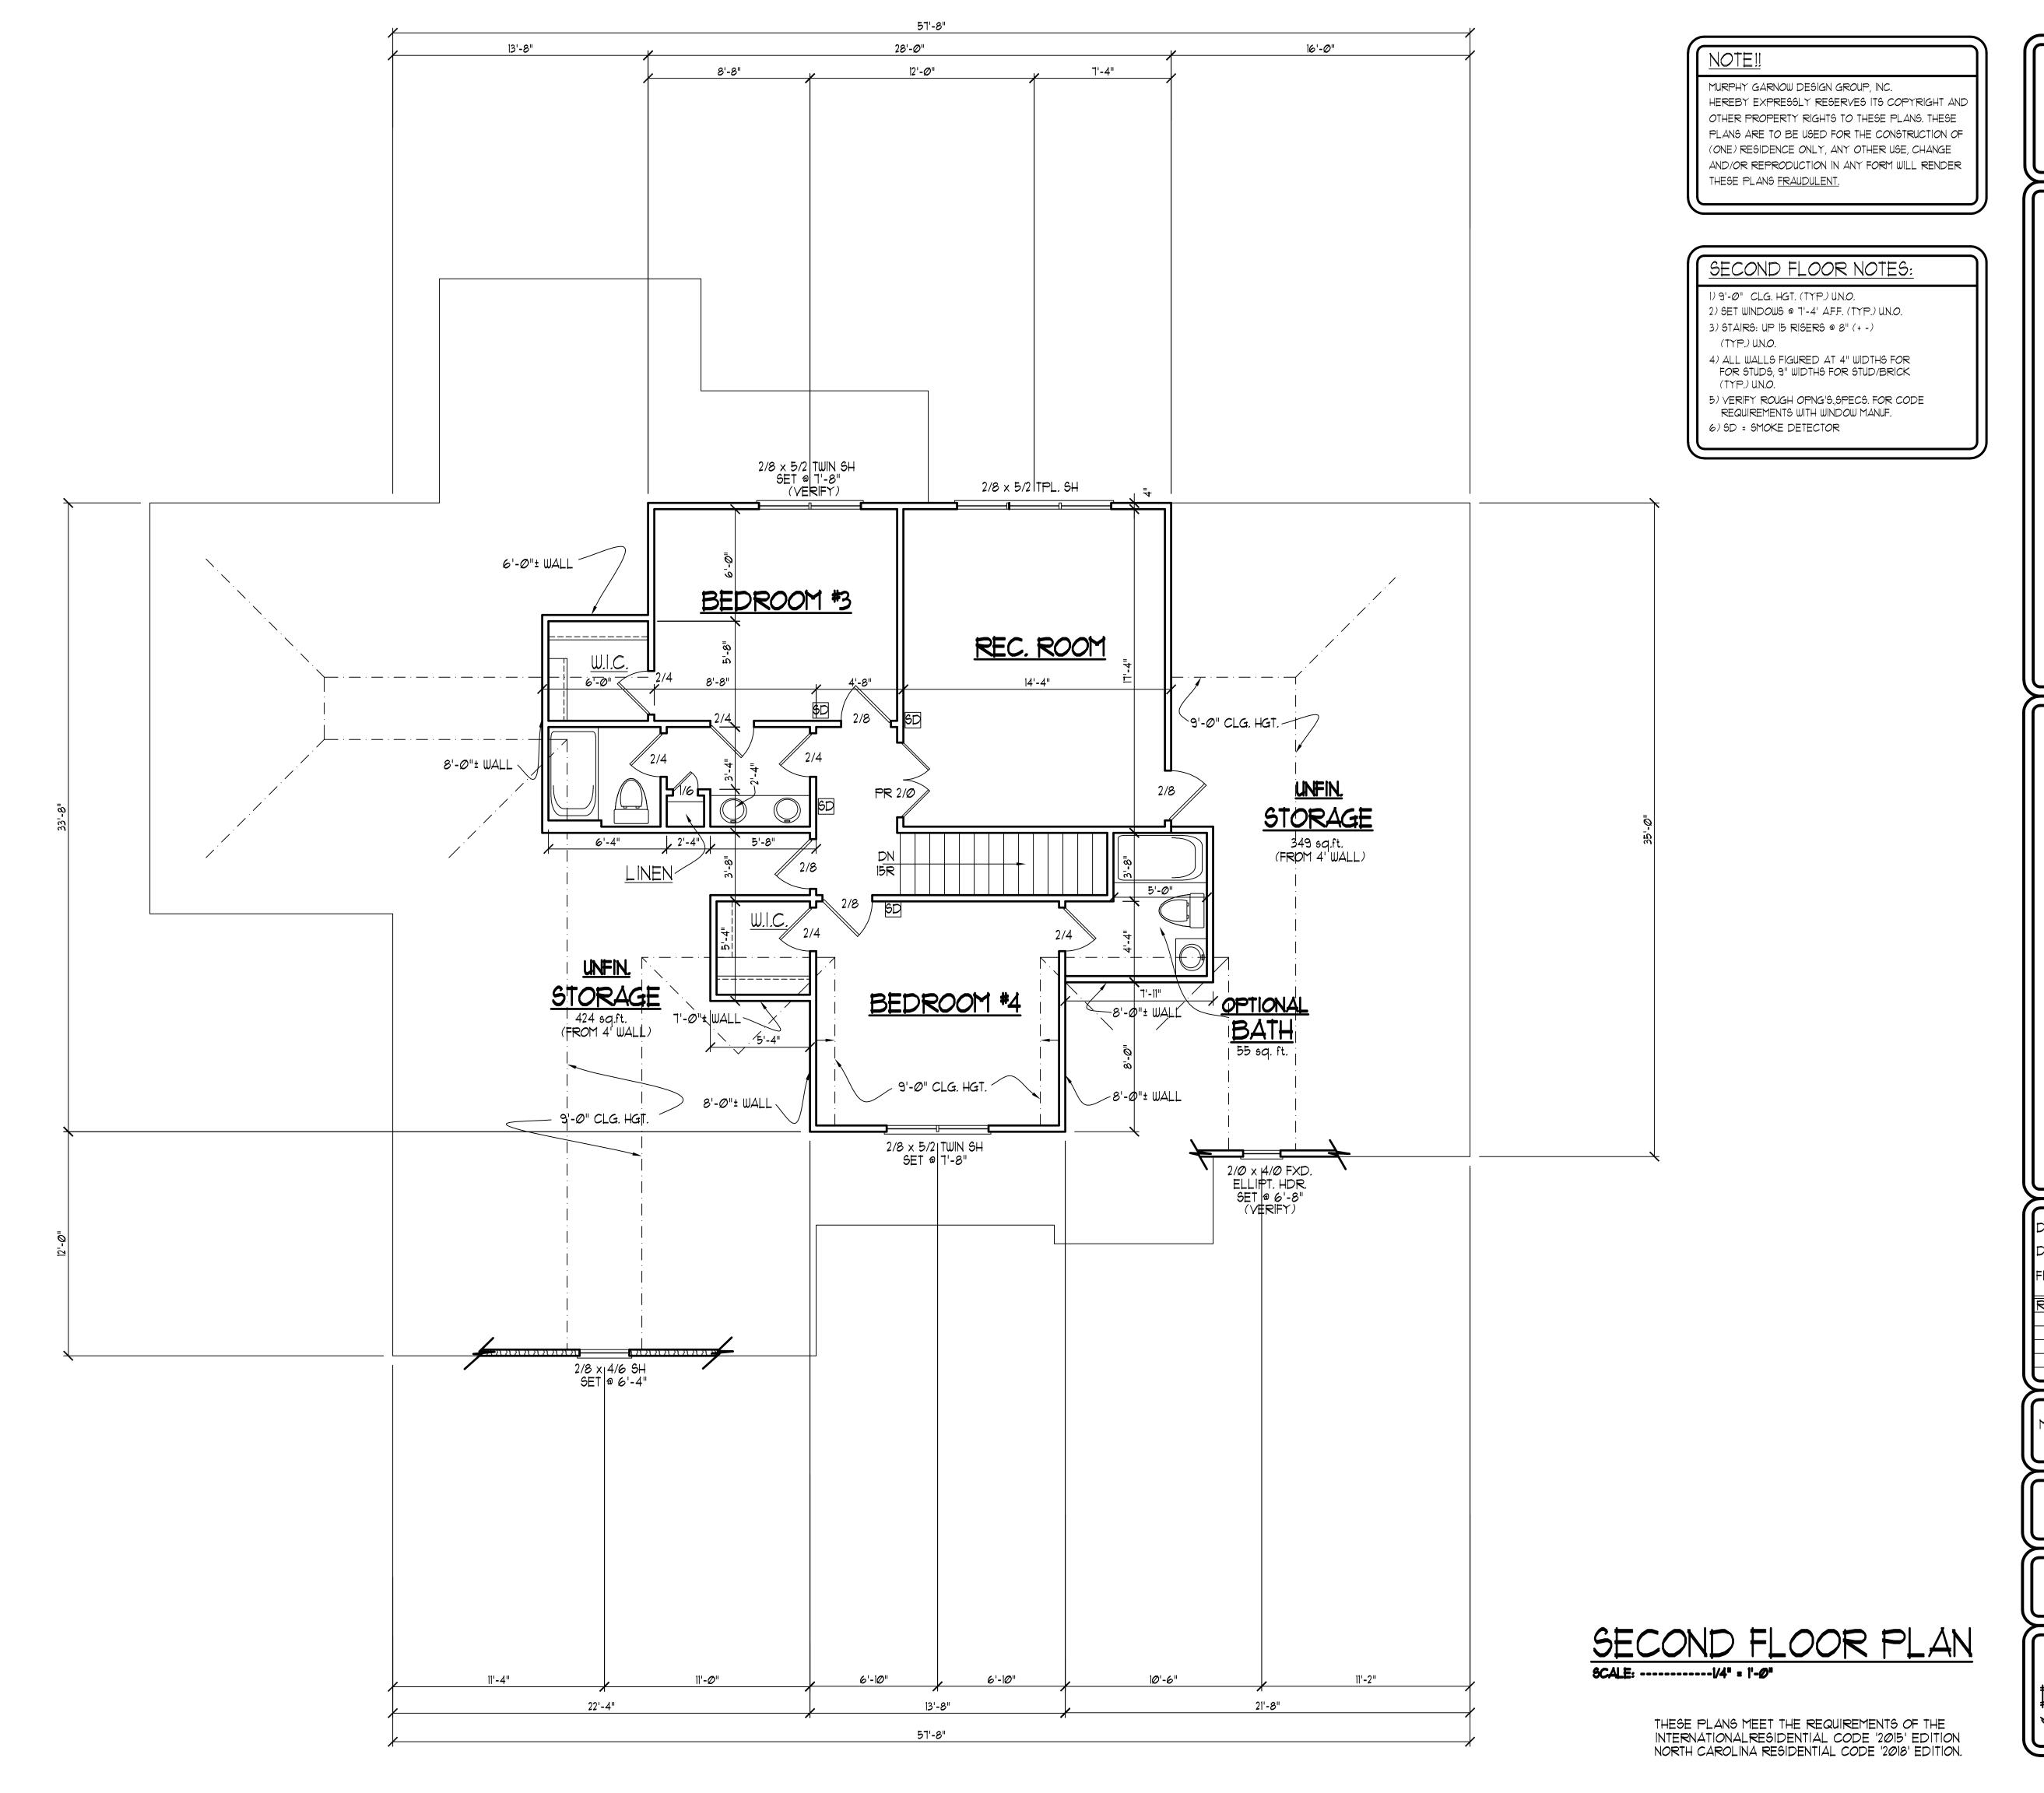

ALL DIMENSIONS, SITE
CONDITIONS & CODES ARE TO
BE VERIFIED BEFORE CONSTR.
BEGINS. ONCE CONSTR. HAS
BEGUN MURPHY GARNOW
DESIGN GROUP, INC. WILL NOT
ASSUME ANY LIABILITY FOR
ANY EXPENSES ASSOCIATED
WITH ERRORS & OMISSIONS.

MURPHY GARNOW DESIGN GROUP

二〇大川の大田の N N 

DRAWN BY: TWG 2-22-10

FILE NAME: 157-2-2625

REVISIONS

1-6-11 TWG PLAN

4-3-14 TWG PLAN

1-23-15 TWG ELEV.

2-4-15 TWG ELEV.

1-11-23 TWG ELEV.

© COPYRIGHT 2023
MURPHY GARNOW DESIGN
GROUP, INC.
ALL RIGHTS RESERVED

HOUSE NAME:

13'-10"

NOTE!

MURPHY GARNOW DESIGN GROUP, INC.
HEREBY EXPRESSLY RESERVES ITS COPYRIGHT AND
OTHER PROPERTY RIGHTS TO THESE PLANS. THESE
PLANS ARE TO BE USED FOR THE CONSTRUCTION OF
(ONE) RESIDENCE ONLY, ANY OTHER USE, CHANGE

AND/OR REPRODUCTION IN ANY FORM WILL RENDER THESE PLANS FRAUDULENT.

FRAMING NOTES

NC (2018 NCRC): Wind: 115-120 mph

- BRACING METHOD AND TYPE: CONTINUOUSLY SHEATHED WSP: CS-WSP. NOTE THAT THE WALL BRACING AMOUNT PROVIDED ON THE PLANS (DETAILS AND SPECIFICATIONS) IS GREATER THAN THE AMOUNT OF WALL BRACING REQUIRED BY SECTION R602.10 OF THE CODE. SEE NOTES BELOW FOR DETAILS AND SPECIFICATIONS FOR WALL BRACING AND WALL FRAMING.
- 2. EXTERIOR WALL SHEATHING: WALLS SHALL BE BRACED BY SHEATHING WALLS ON ALL STORIES WITH WOOD STRUCTURAL PANEL SHEATHING (WSP) (EXPOSURE B: 1/16". EXPOSURE C: 15/32"). SHEATHING SHALL BE ATTACHED WITH & NAILS AT A 6"/12" NAILING PATTERN (6" OC AT PANEL EDGES AND 12" OC AT INTERMEDIATE SUPPORTS). INSTALL BLOCKING AT ALL PANEL EDGES.
- 3. WSP SHEATHING SHALL EXTEND TO THE UPPERMOST DOUBLE BEARING PLATE. BLOCK AT ROOF PER SECTION R602.IO.4.5 AND ATTACH BRACED WALLS PER CODE. WSP SHEATHING BETWEEN FLOORS SHALL BE SPLICED ALONG CONTINUOUS BAND OR THE WSP SHEATHING MAY BE SPLICED ACROSS STUDS (CONTINUOUS ACROSS FLOOR SYSTEM) WITH BLOCKING AT PANEL EDGES. (MINIMUM 12" BEYOND FLOOR BREAK) OR OTHER APPROVED METHOD.
- 4. "HD" = HOLDOWN: HOLD-DOWN DEVICE (NOTED AS "HD" ON PLANS)
  SHALL BE AN 800 POUND CAPACITY ASSEMBLY AS NOTED ON PLANS.
  SEE DETAILS FOR HD ASSEMBLY.
- \*\*GROUND/FIRST FLOOR: USE "HD HOLD-DOWN DETAIL" ON SD SHEET (OR EQUIV.)

  \*\*USET FLOOR: A TTACH BASE OF KING STIP WITH A SIMPLE A SIMPLE OF KING STIP WITH A SIMPLE OF WITH A SIMPLE OF
- \*\*UPPER FLOORS: ATTACH BASE OF KING STUD WITH A SIMPSON
  CS20 OR CSHP20 STRAP DOWN ACROSS THE BAND AND DOWN TO A
  STUD BELOW OR HEADER BELOW. EXTEND STRAP 7" MIN ALONG EACH
  STUD (OR HEADER) AND ATTACH EACH END W (1) 8d NAILS.
- 5. INTERIOR BRACED WALL: (NOTED AS "IBW" ON PLANS) ATTACH I/2" GYPSUM BOARD (GB) ON EACH SIDE OF WALL WITH A MIN. OF 5d COOLER NAILS OR #6 SCREWS @ 7" O.C. ALONG THE EDGES AND AT INTERMEDIATE SUPPORTS.
- 6. INTERIOR BRACED WALL-WOOD STRUCTURAL PANEL: (NOTED AS "IBM-WSP" ON PLANS). ATTACH ONE SIDE WITH 76" WSP SHEATHING WITH 8d NAILS AT A 6"/12" NAILING PATTERN (6" OC AT PANEL EDGES AND 12" OC AT INTERMEDIATE SUPPORTS). INSTALL BLOCKING AT ALL PANEL EDGES. ATTACH 6B OVER WSP AS REQUIRED. ATTACH OPPOSITE SIDE WITH 1/2" 6B WITH A MIN. OF 5d COOLER NAILS OR #6 SCREWS @ 7" OC ALONG THE EDGES AND AT INTERMEDIATE SUPPORTS.

#### HEADER/BEAM & COLUMN NOTES

- I. ALL EXTERIOR AND LOAD BEARING HEADERS SHALL BE MIN. (2)2x6 (4" WALL) OR (3)2x6 (6" WALL) WITH (I) SUPPORT STUD, UNLESS NOTED OTHERWISE.
- 2. THE NUMBER SHOWN AT BEAM AND HEADER SUPPORTS INDICATES THE NUMBER OF SUPPORT STUDS REQUIRED IN STUD POCKET OR COLUMN. THE NUMBER OF KING STUDS AT EACH END OF HEADERS IN EXTERIOR WALLS SHALL BE ACCORDING TO ITEM "d" IN TABLE R602.3(5) OR AS BELOW PER NCDOI COMMENTARY "KING STUDS AT WALL OPENINGS" REVISED I-9-2020:
- UP TO 3' SPAN: (I) KING STUD

   OVER 3' UP TO 6' SPAN: (2) KING STUDS
- OVER 6' UP TO 9' SPAN: (3) KING STUDS OVER 9' UP TO 12' SPAN: (4) KING STUDS OVER 12' UP TO 15' SPAN: (5) KING STUDS
- PORCH POST NOTES:
- 4X4 (6x6) TRT'D POST (OR EQUAL).

   ATTACH TRUSSES (RAFTERS) AT PORCH WITH HURRICANE CONNECTORS.
- POST CAP: SIMPSON AC4-MAX (AC6-MAX)
   POST CAP AT CORNER: (2) SIMPSON LCE4 (MITER HEADER AT CORNER). HIGH WIND; ADD (I) SIMPSON H6.
- 3. POST BASE: SIMPSON ABU44 (ABU66).
  3.I. MONO: 5/8" ANCHOR (EMBED 7")
  3.2. CMU: 5/8" ANCHOR (EXTEND TO FOOTING HIGH WIND ONLY)
- POST BASE: WOOD FOUNDATION: (2) SIMPSON
  CSI6 STRAPS AT POSTS. EXTEND 12" ONTO
  EACH POST (UPPER AND LOWER) OR TO GIRDER.
- NOTE: EQUIVALENT POST CAP AND BASE ACCEPTABLE.

FRAMING NOTE: ALL DIMENSIONAL LUMBER ON THIS SHEET MAY BE SPF #2 OR SYP #2, UNLESS SPECIFICALLY NOTED OTHERWISE.

STRUCTURAL DESIGN BY:
SOUTHERN ENGINEERS, P.A.
3716 BENSON DRIVE RALEIGH, NC 27609
LICENSE: C-4772, PHONE: 919-878-1617
PROJECT #: 23-1268

- Engineers seal applies only to structural components on this document. Seal does not include construction means, methods, techniques, sequences, procedures
- or safety precautions.
  Any deviations or discrepancies on plans are to be brought to the immediate attention of Southern Engineers. Failure to do so will void Southern
- Engineer's liability.Seal is valid for a project permitted within one year from date of seal.
- Use of these plans constitutes approval of terms and conditions as defined in the customer agreement.



THESE PLANS MEET THE REQUIREMENTS OF THE NORTH CAROLINA RESIDENTIAL CODE '2018' EDITION.

ALL DIMENSIONS, SITE
CONDITIONS & CODES ARE TO
BE VERIFIED BEFORE CONSTR.
BEGINS. ONCE CONSTR. HAS
BEGUN MURPHY GARNOW
DESIGN GROUP, INC. WILL NOT
ASSUME ANY LIABILITY FOR
ANY EXPENSES ASSOCIATED
WITH ERRORS & OMISSIONS.

ES ASSOCIA SS & OMISSIC

1 ROAD 27511 181-6970

aroup,

GARNOW

MURPHY

10-500 KILDAIKE PARM KUAN 7ARY, NORTH CAROLINA 27511 1481-9115 FAX; (919) 481-69

CARY, NORTH CARY,

TTON FARM

9

DRAWN BY: TWG DATE: 2-22-10

FILE NAME: 151-2-2625

REVISIONS
1-6-11 TWG PLAN
4-3-14 TWG PLAN
1-23-15 TWG ELEY.

2-4-15 TWG ELEY.
1-11-23 TWG ELEY.

© COPYRIGHT 2023
MURPHY GARNOW DESIGN
GROUP, INC.

ALL RIGHTS RESERVED

HOUSE NAME:

HOUSE NUMBER:

FRAMING NOTES

NC (2018 NCRC): Wind: 115-120 mph

- BRACING METHOD AND TYPE: CONTINUOUSLY SHEATHED WSP: CS-WSP. NOTE THAT THE WALL BRACING AMOUNT PROVIDED ON THE PLANS (DETAILS AND SPECIFICATIONS) IS GREATER THAN THE AMOUNT OF WALL BRACING REQUIRED BY SECTION R602.10 OF THE CODE. SEE NOTES BELOW FOR DETAILS AND SPECIFICATIONS FOR WALL BRACING AND WALL FRAMING.
- EXTERIOR WALL SHEATHING: WALLS SHALL BE BRACED BY SHEATHING WALLS ON ALL STORIES WITH WOOD STRUCTURAL PANEL SHEATHING (MSP) (EXPOSURE B: 7/16". EXPOSURE C: 15/32"). SHEATHING SHALL BE ATTACHED WITH 8d NAILS AT A 6"/12" NAILING PATTERN (6" OC AT PANEL EDGES AND 12" OC AT INTERMEDIATE SUPPORTS). INSTALL BLOCKING AT ALL PANEL EDGES.
- WSP SHEATHING SHALL EXTEND TO THE UPPERMOST DOUBLE BEARING PLATE. BLOCK AT ROOF PER SECTION R602.10.4.5 AND ATTACH BRACED WALLS PER CODE. WSP SHEATHING BETWEEN FLOORS SHALL BE SPLICED ALONG CONTINUOUS BAND OR THE WSP SHEATHING MAY BE SPLICED ACROSS STUDS (CONTINUOUS ACROSS FLOOR SYSTEM) WITH BLOCKING AT PANEL EDGES. (MINIMUM 12" BEYOND FLOOR BREAK) OR OTHER APPROVED METHOD.
- SHALL BE AN 800 POUND CAPACITY ASSEMBLY AS NOTED ON PLANS. SEE DETAILS FOR HD ASSEMBLY.

"HD" = HOLDOWN: HOLD-DOWN DEVICE (NOTED AS "HD" ON PLANS)

- \*\*GROUND/FIRST FLOOR: USE "HD HOLD-DOWN DETAIL" ON SD SHEET (OR EQUIV.) \*\*UPPER FLOORS: ATTACH BASE OF KING STUD WITH A SIMPSON
- CS20 OR CSHP20 STRAP DOWN ACROSS THE BAND AND DOWN TO A STUD BELOW OR HEADER BELOW. EXTEND STRAP 7" MIN ALONG EACH STUD (OR HEADER) AND ATTACH EACH END W (7) 8d NAILS.
- INTERIOR BRACED WALL: (NOTED AS "IBW" ON PLANS) ATTACH I/2" GYPSUM BOARD (GB) ON EACH SIDE OF WALL WITH A MIN. OF 5d COOLER NAILS OR #6 SCREWS @ 7" O.C. ALONG THE EDGES AND AT INTERMEDIATE SUPPORTS.
- INTERIOR BRACED WALL-WOOD STRUCTURAL PANEL: (NOTED AS "IBW-WSP" ON PLANS). ATTACH ONE SIDE WITH 1/6" WSP SHEATHING WITH 8d NAILS AT A 6"/12" NAILING PATTERN (6" OC AT PANEL EDGES AND 12" OC AT INTERMEDIATE SUPPORTS). INSTALL BLOCKING AT ALL PANEL EDGES. ATTACH GB OVER WSP AS REQUIRED. ATTACH OPPOSITE SIDE WITH 1/2" GB WITH A MIN. OF 5d COOLER NAILS OR #6 SCREWS @ 7" OC ALONG THE EDGES AND AT INTERMEDIATE SUPPORTS.

#### HEADER/BEAM & COLUMN NOTES

- ALL EXTERIOR AND LOAD BEARING HEADERS SHALL BE MIN. (2)2x6 (4" WALL) OR (3)2x6 (6" WALL) WITH (I) SUPPORT STUD, UNLESS NOTED OTHERWISE.
- THE NUMBER SHOWN AT BEAM AND HEADER SUPPORTS INDICATES THE NUMBER OF SUPPORT STUDS REQUIRED IN STUD POCKET OR COLUMN. THE NUMBER OF KING STUDS AT EACH END OF HEADERS IN EXTERIOR WALLS SHALL BE ACCORDING TO ITEM "d" IN TABLE R602.3(5) OR AS BELOW PER NCDOI COMMENTARY "KING STUDS AT WALL OPENINGS" REVISED 1-9-2020:
- •• UP TO 3' SPAN: (I) KING STUD OVER 3' UP TO 6' SPAN: (2) KING STUDS OVER 6' UP TO 9' SPAN: (3) KING STUDS
- OVER 9' UP TO 12' SPAN: (4) KING STUDS OVER 12' UP TO 15' SPAN: (5) KING STUDS

FRAMING NOTE: ALL DIMENSIONAL LUMBER ON THIS SHEET MAY BE SPF #2 OR SYP #2, UNLESS SPECIFICALLY NOTED OTHERWISE.

STRUCTURAL DESIGN BY: SOUTHERN ENGINEERS, P.A. 3716 BENSON DRIVE RALEIGH, NC 27609

PROJECT #: 23-1268

LICENSE: C-4772, PHONE: 919-878-1617

- Engineers seal applies only to structural components on this document. Seal does not include construction
- on this accument. Seal ages not include construction means, methods, techniques, sequences, procedures or safety precautions.
  Any deviations or discrepancies on plans are to be brought to the immediate attention of Southern Engineers. Failure to do so will void Southern Engineer's liability.
- Seal is valid for a project permitted within one year from date of seal.
- Use of these plans constitutes approval of terms and conditions as defined in the customer agreement.



THESE PLANS MEET THE REQUIREMENTS OF THE NORTH CAROLINA RESIDENTIAL CODE '2018' EDITION.

ALL DIMENSIONS, SITE CONDITIONS & CODES ARE TO BE VERIFIED BEFORE CONSTR. BEGINS. ONCE CONSTR. HAS BEGUN MURPHY GARNOW DESIGN GROUP, INC. WILL NOT ASSUME ANY LIABILITY FOR ANY EXPENSES ASSOCIATED WITH ERRORS & OMISSIONS.

7, NORTH CAROLINA 1-9115 FAX; (919) 4

aroup,

GARNOW

MURPHY

Q

DRAWN BY: TWG 2-22-10

FILE NAME: **157-2-2625** REVISIONS

1-6-11 TWG PLAN

4-3-14 TWG PLAN

1-23-15 TWG ELEY.


2-4-15 TWG ELEY.

1-11-23 TWG ELEY. © COPYRIGHT 2023 MURPHY GARNOW DESIGN GROUP, INC.

ALL RIGHTS RESERVED

HOUSE NAME:

HOUSE NUMBER:

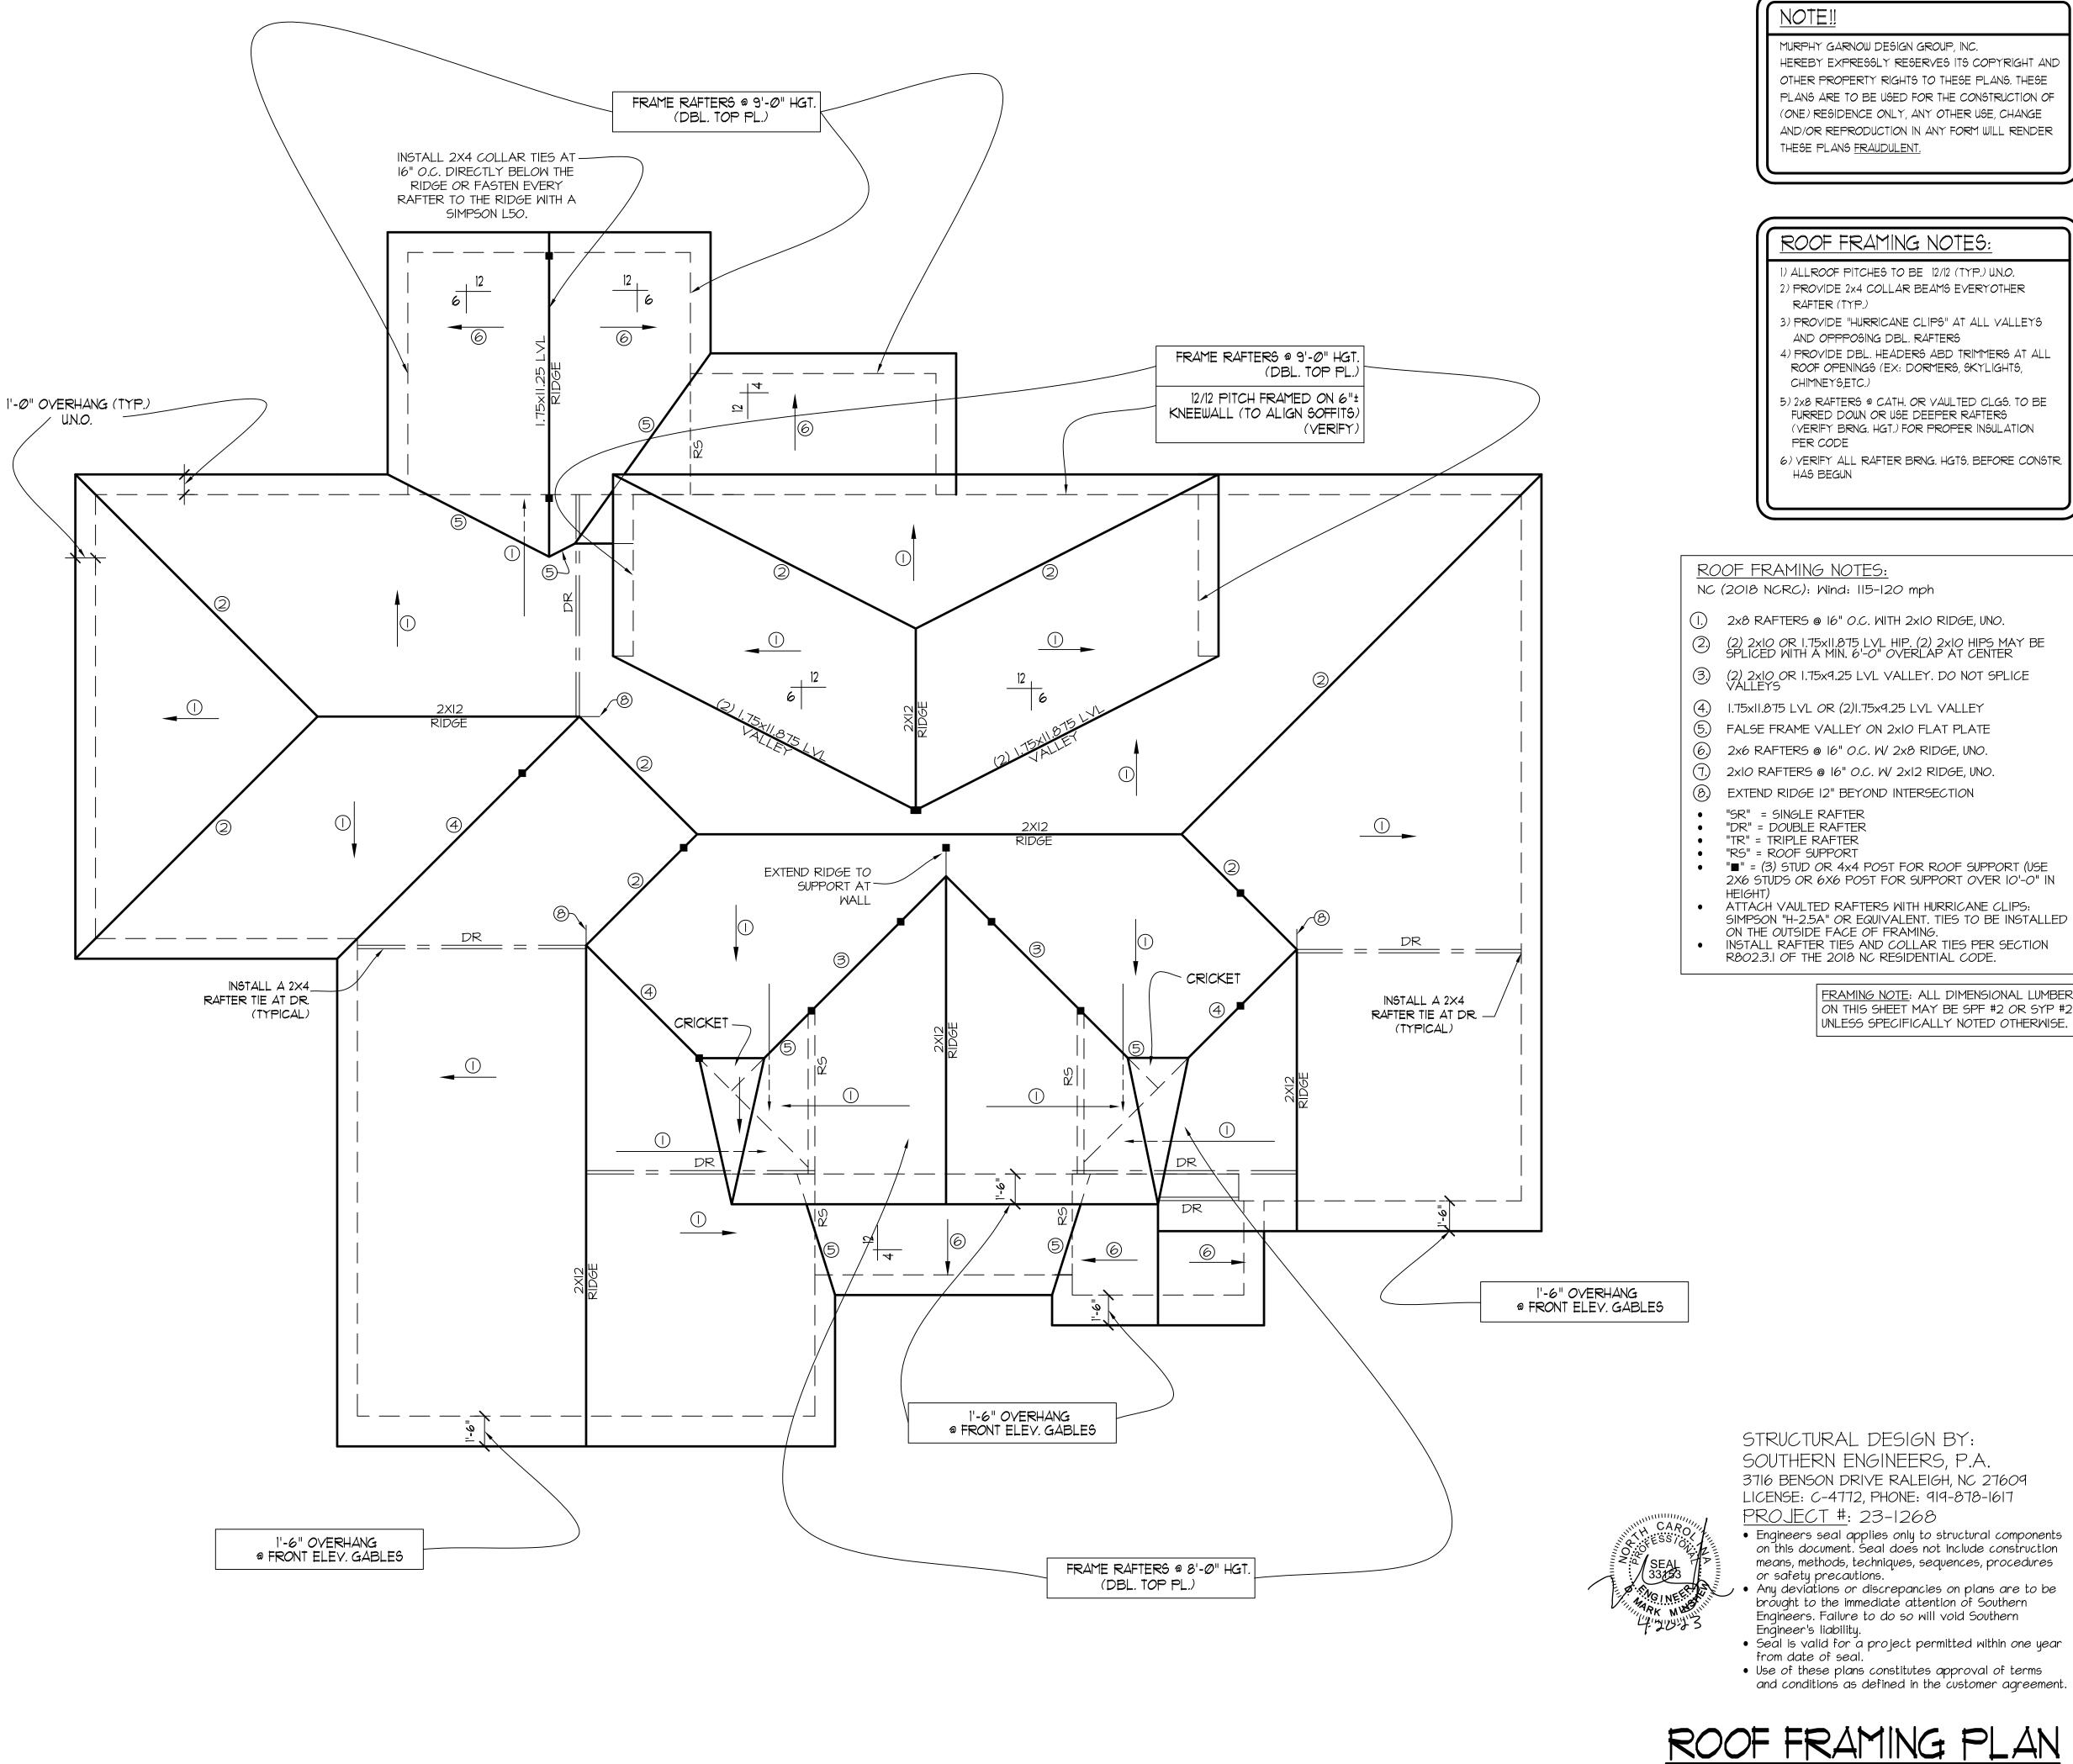

## ROOF FRAMING NOTES:

- 1) ALLROOF PITCHES TO BE 12/12 (TYP.) U.N.O. 2) PROVIDE 2x4 COLLAR BEAMS EVERYOTHER
- 3) PROVIDE "HURRICANE CLIPS" AT ALL VALLEYS
- AND OPPPOSING DBL. RAFTERS
- 4) PROVIDE DBL. HEADERS ABD TRIMMERS AT ALL ROOF OPENINGS (EX: DORMERS, SKYLIGHTS,
- 5) 2x8 RAFTERS @ CATH. OR YAULTED CLGS. TO BE FURRED DOWN OR USE DEEPER RAFTERS (VERIFY BRNG. HGT.) FOR PROPER INSULATION
- 6) VERIFY ALL RAFTER BRNG. HGTS. BEFORE CONSTR.

NC (2018 NCRC): Wind: 115-120 mph

- (I.) 2x8 RAFTERS @ 16" O.C. WITH 2x10 RIDGE, UNO.
- (2) 2xIO OR 1.75xII.875 LVL HIP. (2) 2xIO HIPS MAY BE SPLICED WITH A MIN. 6'-O" OVERLAP AT CENTER
- (3) (2) 2xIO OR I.75x9.25 LVL VALLEY. DO NOT SPLICE VALLEYS
- (4) 1.75x11.875 LVL OR (2)1.75x9.25 LVL VALLEY
- (5.) FALSE FRAME VALLEY ON 2x10 FLAT PLATE
- (6) 2x6 RAFTERS @ 16" O.C. W/ 2x8 RIDGE, UNO.
- (7) 2xIO RAFTERS @ I6" O.C. W/ 2xI2 RIDGE, UNO.
- (8) EXTEND RIDGE 12" BEYOND INTERSECTION
- "■" = (3) STUD OR 4x4 POST FOR ROOF SUPPORT (USE 2X6 STUDS OR 6X6 POST FOR SUPPORT OVER 10'-0" IN
- ATTACH VAULTED RAFTERS WITH HURRICANE CLIPS: SIMPSON "H-2.5A" OR EQUIVALENT. TIES TO BE INSTALLED ON THE OUTSIDE FACE OF FRAMING.
- INSTALL RAFTER TIES AND COLLAR TIES PER SECTION R802.3.1 OF THE 2018 NC RESIDENTIAL CODE.

FRAMING NOTE: ALL DIMENSIONAL LUMBER ON THIS SHEET MAY BE SPF #2 OR SYP #2, UNLESS SPECIFICALLY NOTED OTHERWISE.

STRUCTURAL DESIGN BY: SOUTHERN ENGINEERS, P.A. 3716 BENSON DRIVE RALEIGH, NC 27609

- Seal is valid for a project permitted within one year
- Use of these plans constitutes approval of terms and conditions as defined in the customer agreement.



THESE PLANS MEET THE REQUIREMENTS OF THE NORTH CAROLINA RESIDENTIAL CODE '2018' EDITION.

ALL DIMENSIONS, SITE CONDITIONS & CODES ARE TO BE VERIFIED BEFORE CONSTR. BEGINS. ONCE CONSTR. HAS BEGUN MURPHY GARNOW DESIGN GROUP, INC. WILL NOT ASSUME ANY LIABILITY FOR ANY EXPENSES ASSOCIATED WITH ERRORS & OMISSIONS.

aroup, GARNOW

MURPHY

DRAWN BY: TWG 2-22-10

9

₹

FILE NAME: 157-2-2625

REVISIONS

7-6-11 TWG PLAN

4-3-14 TWG PLAN

1-23-15 TWG ELEV.


2-4-15 TWG ELEV.


1-11-23 TWG ELEV.


© COPYRIGHT 2023 MURPHY GARNOW DESIGN GROUP, INC. ALL RIGHTS RESERVED


HOUSE NAME:


HOUSE NUMBER:

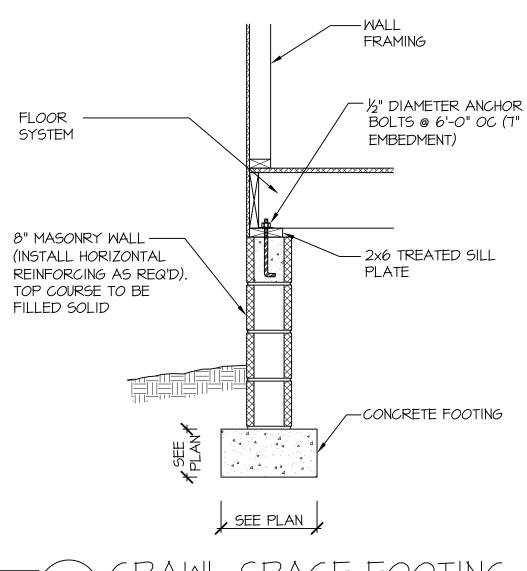


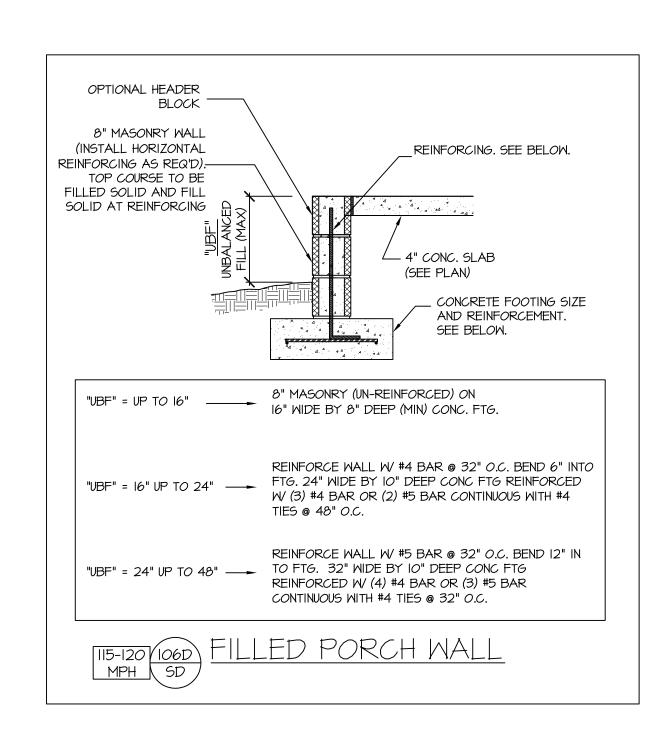

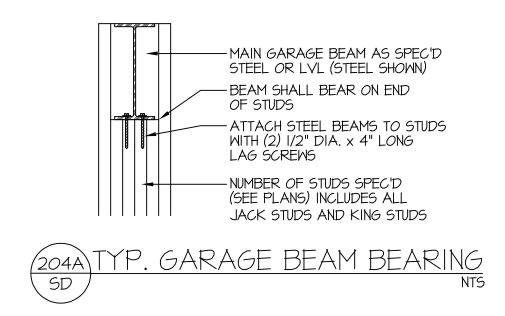

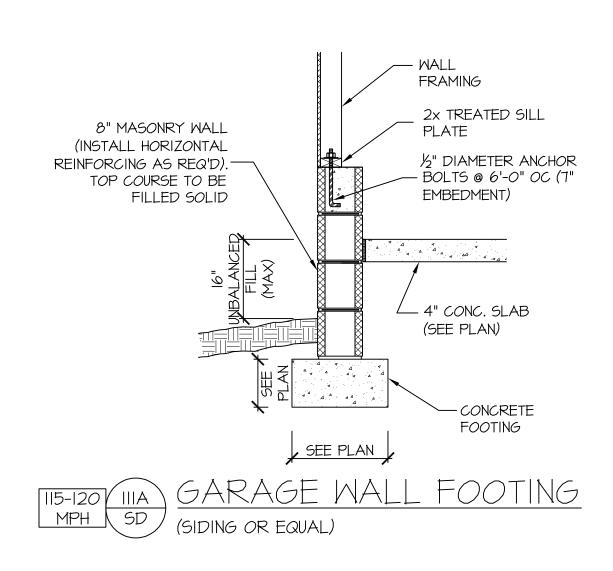


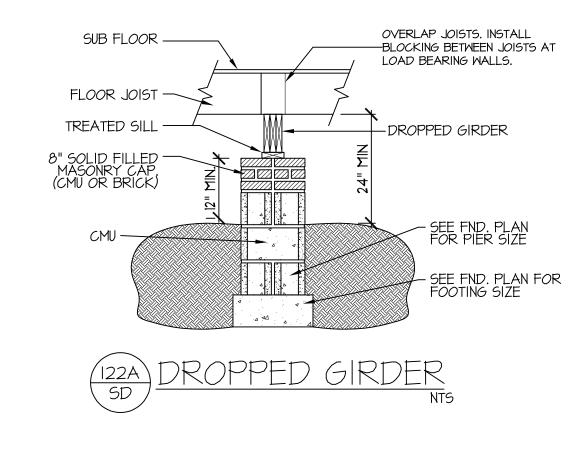


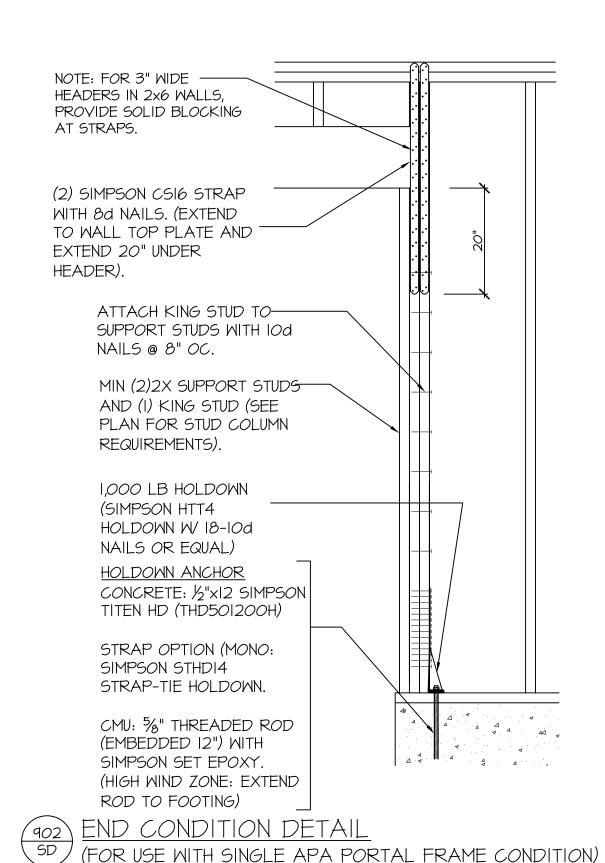

DETAIL AND APPLICATION BASED ON APA TT-100F WITH USE OF

TABLE I FOR APA PORTAL FRAME WITH HOLD-DOWN CAPACITIES.

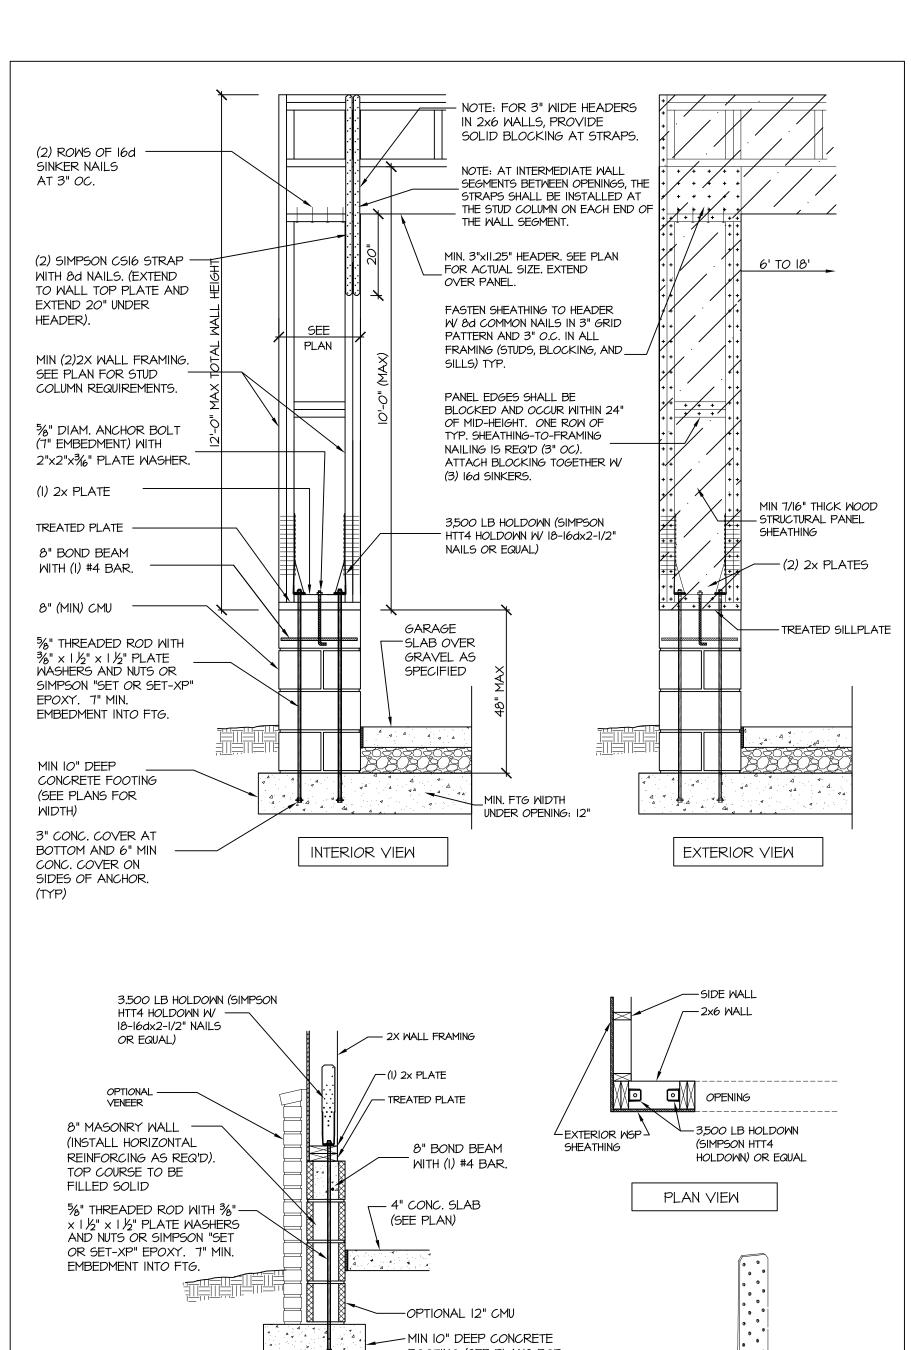

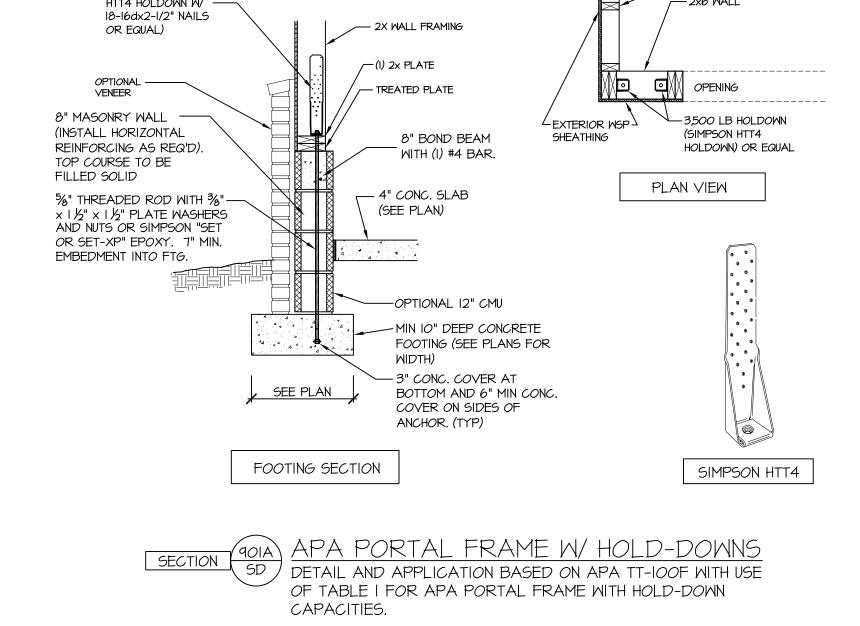

STRUCTURAL NOTES NC (2018 NCRC): Wind: 115-120 mph

I. ENGINEER'S SEAL APPLIES ONLY TO STRUCTURAL COMPONENTS INCLUDING ROOF RAFTERS, HIPS, VALLEYS, RIDGES, FLOORS, WALLS, BEAMS AND HEADERS, COLUMNS, CANTILEVERS, OFFSET LOAD BEARING WALLS, PIER & GIRDER SYSTEM, FOOTING, AND PILING SYSTEM. ENGINEER'S SEAL DOES NOT CERTIFY DIMENSIONAL ACCURACY OR ARCHITECTURAL LAYOUT INCLUDING ROOF SYSTEM. ALL REQUIREMENTS FOR PROFESSIONAL CERTIFICATION SHALL BE PROVIDED BY THE APPROPRIATE PROFESSIONAL. SOUTHERN ENGINEERS, P.A. CERTIFIES ONLY THE STRUCTURAL COMPONENTS AS SPECIFICALLY STATED.

2. ALL CONSTRUCTION SHALL CONFORM TO THE LATEST REQUIREMENTS OF THE 2018 NC RESIDENTIAL CODE, PLUS ALL LOCAL CODES AND REGULATIONS. THE STRUCTURAL ENGINEER IS NOT RESPONSIBLE FOR, AND WILL NOT HAVE CONTROL OF, CONSTRUCTION MEANS, METHODS, TECHNIQUES, SEQUENCES OR PROCEDURES, OR FOR SAFETY PRECAUTIONS AND PROGRAMS IN CONNECTION WITH THE CONSTRUCTION WORK, NOR WILL THE ENGINEER BE RESPONSIBLE FOR THE CONTRACTOR'S FAILURE TO CARRY OUT THE CONSTRUCTION WORK IN ACCORDANCE WITH THE CONTRACT DOCUMENTS. "CONSTRUCTION REVIEW" SERVICES ARE NOT PART OF OUR CONTRACT. ALL MEMBERS SHALL BE FRAMED ANCHORED, TIED AND BRACED IN ACCORDANCE WITH GOOD CONSTRUCTION PRACTICE AND THE BUILDING CODE.

3. DESIGN LOADS (LISTED AS: LIVE LOAD, DEAD LOAD, DEFLECTION)

 ROOMS OTHER THAN SLEEPING ROOMS: (40 PSF, IO PSF, L/360) SLEEPING ROOMS: (30 PSF, IO PSF, L/360)

 ATTIC WITH PERMANENT STAIR: (40 PSF, IO PSF, L/360) ATTIC WITHOUT PERMANENT STAIR: (20 PSF, IO PSF, L/360)

ATTIC WITHOUT STORAGE: (10 PSF, 10 PSF, L/240)

STAIRS: (40 PSF, IO PSF, L/360)

 DECKS AND EXTERIOR BALCONIES: (40 PSF, IO PSF, L/360) PASSENGER VEHICLE GARAGES: (50 PSF, IO PSF, L/360)

SNOW: (20 PSF)

4. WALLS SHALL BE BRACED BY SHEATHING WALLS ON ALL STORIES WITH WOOD STRUCTURAL PANELS. SEE FRAMING NOTES FOR THICKNESS AND NAILING REQUIREMENTS.

5. SEE APPENDIX M (DCA6) FOR EXTERIOR DECK REQUIREMENTS INCLUDING ATTACHMENTS FOR LATERAL LOADS.

6. CONCRETE SHALL HAVE A MINIMUM 28 DAY STRENGTH OF 3000 PSI AND A MAXIMUM SLUMP OF 5 INCHES UNLESS NOTED OTHERWISE (UNO). AIR ENTRAINED PER TABLE 402.2. ALL CONCRETE SHALL BE PROPORTIONED, MIXED, HANDLED, SAMPLED, TESTED, AND PLACED IN ACCORDANCE WITH ACI STANDARDS. ALL SAMPLES FOR PUMPING SHALL BE TAKEN FROM THE EXIT END OF THE PUMP. CONTROL JOINTS IN SLABS SHALL BE SPACED ON A GRID OF +-30 TIMES THE DEPTH (D). CONTROL JOINTS SHALL BE SAWCUT TO A DEPTH OF I/D. (I.E. 4" CONCRETE SLABS SHALL HAVE 1/4" DEEP CONTROL JOINTS SAWCUT IN SLAB ON A +-IO'-O" x +-IO'-O" GRID).

7. ALLOWABLE SOIL BEARING PRESSURE ASSUMED TO BE 2000 PSF. THE CONTRACTOR MUST CONTACT A GEOTECHNICAL ENGINEER AND THE STRUCTURAL ENGINEER IF UNSATISFACTORY SUBSURFACE CONDITIONS ARE ENCOUNTERED. THE SURFACE AREA ADJACENT TO THE FOUNDATION WALL SHALL BE PROVIDED WITH ADEQUATE DRAINAGE, AND SHALL BE GRADED SO AS TO DRAIN SURFACE WATER AWAY FROM FOUNDATION WALLS.

8. ALL FRAMING LUMBER SHALL BE SPF #2 (Fb = 875 PSI) UNLESS NOTED OTHERWISE (UNO). ALL TREATED LUMBER SHALL BE SYP # 2. PLATE MATERIAL MAY BE SPF # 3 OR SYP #3 (Fc(perp) =

9. L.V.L. SHALL BE LAMINATED VENEER LUMBER: Fb=2600 PSI, Fv=285 PSI, E=I.9xI0 PSI.

9.1. P.S.L. SHALL BE PARALLEL STRAND LUMBER: Fb=2900 PSI, Fv=290 PSI, E=2.0x10 PSI. 9.2. L.S.L. SHALL BE LAMINATED STRAND LUMBER: Fb=2250 PSI, Fv=400 PSI, E=1.55xI0 PSI. INSTALL ALL CONNECTIONS PER MANUFACTURERS INSTRUCTIONS.

IO. ALL ROOF TRUSS AND I-JOIST LAYOUTS SHALL BE PREPARED IN ACCORDANCE WITH THE SEALED STRUCTURAL DRAWINGS. TRUSSES AND I-JOISTS SHALL BE INSTALLED ACCORDING TO THE MANUFACTURE'S SPECIFICATIONS. ANY CHANGE IN TRUSS OR I-JOIST LAYOUT SHALL BE COORDINATED WITH SOUTHERN ENGINEERS.

II. ALL STRUCTURAL STEEL SHALL BE ASTM A-36. STEEL BEAMS SHALL BE SUPPORTED AT EACH END WITH A MINIMUM BEARING LENGTH OF 3 1/2" INCHES AND FULL FLANGE WIDTH. PROVIDE SOLID BEARING FROM BEAM SUPPORT TO FOUNDATION. BEAMS SHALL BE ATTACHED TO EACH SUPPORT WITH TWO LAG SCREWS (1/2" DIAMETER x 4" LONG). LATERAL SUPPORT IS CONSIDERED ADEQUATE PROVIDING THE JOIST ARE TOE NAILED TO THE SOLE PLATE, AND SOLE PLATE IS NAILED OR BOLTED TO THE BEAM FLANGE @ 48" O.C. ALL STEEL TUBING SHALL BE ASTM A500.

12. REBAR SHALL BE DEFORMED STEEL, ASTM615, GRADE 60. LAP ALL REBAR SPLICES 30 BAR

13. FLITCH BEAMS SHALL BE BOLTED TOGETHER USING (2) ROWS OF 1/2" DIAMETER BOLTS (ASTM A325) WITH WASHERS PLACED UNDER THE THREADED END OF BOLT. BOLTS SHALL BE SPACED AT 24" O.C. (MAX), AND STAGGERED AT THE TOP AND BOTTOM OF BEAM (2" EDGE DISTANCE), WITH 2 BOLTS LOCATED AT 6" FROM EACH END.

14. BRICK LINTELS (WHEN REQUIRED) SHALL BE 3 1/2"x3 1/2"x1/4" STEEL ANGLE FOR UP TO 6'-0" SPAN AND 6"x4"x5/16" STEEL ANGLE WITH 6" LEG VERTICAL FOR SPANS UP TO 9'-O". SEE PLANS FOR SPANS OVER 9'-O". SEE ALSO SECTION R703.8.3 LINTELS.

ALL DIMENSIONS, SITE CONDITIONS & CODES ARE TO BE VERIFIED BEFORE CONSTR. BEGINS. ONCE CONSTR. HAS BEGUN MURPHY GARNOW DESIGN GROUP, INC. WILL NOT ASSUME ANY LIABILITY FOR ANY EXPENSES ASSOCIATED

WITH ERRORS & OMISSIONS.

GROUP

 $\bigotimes_{i}$ **GARNOW** MURPHY

Q

DRAWN BY: TWG 2-22-10

FILE NAME: **157-2-2625** 

REVISIONS


7-6-11 | TWG | PLAN 4-3-14 TWG PLAN 1-23-15 TWG ELEY. 2-4-15 TWG ELEY. 1-11-23 TWG ELEV.

© COPYRIGHT 2023 MURPHY GARNOW DESIGN GROUP, INC. ALL RIGHTS RESERVED

HOUSE NAME:

HOUSE NUMBER:

PAGE NUMBER:

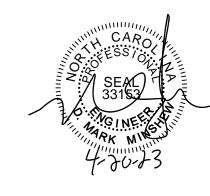

STRUCTURAL DESIGN BY: SOUTHERN ENGINEERS, P.A. 3716 BENSON DRIVE RALEIGH, NC 27609 LICENSE: C-4772, PHONE: 919-878-1617 PROJECT #: 23-1268

 Engineers seal applies only to structural components on this document. Seal does not include construction means, methods, techniques, sequences, procedures or safety precautions.

Any deviations or discrepancies on plans are to be brought to the immediate attention of Southern Engineers. Failure to do so will void Southern

Engineer's liability. • Seal is valid for a project permitted within one year from date of seal.

 Use of these plans constitutes approval of terms and conditions as defined in the customer agreement.