# CUSTOM HOUSE PLAN BM2085



#### DRAWING LIST:

Label **COVER PAGE EXTERIOR ELEVATIONS EXTERIOR ELEVATIONS** FIRST FLOOR PLAN SECOND FLOOR PLAN FOUNDATION PLAN PLUMBING LAYOUT **ROOF PLAN** ROOF FRAMING PLAN

**EXTERIOR WALL FRAMING PLAN** FIRST & SECOND FLOOR FRAMING PLAN

**SECTION VIEW** 

FIRST FLOOR ELECTRICAL PLAN SECOND FLOOR ELECTRICAL PLAN FIRST FLOOR PLUMBING PLAN SECOND FLOOR PLUMBING PLAN

## SQUARE FOOTAGE

FIRST FLOOR: 1882 350 **SECOND FLOOR: BONUS**: 764 558 PORCHES: 1584 **GARAGE**: TOTAL LIVING: 3012 5154 TOTAL AREA:





Contact: tony@buildmax.com

CLIENT: Refer to the name on the onetime build license

PROJECT TITLE:

COPYRIGHT:

BuildMax.com copyright 2021 Architectural works are protected by U.S. copyright law, specifically by 17 U.S. Code § 102(8).

CONTRACTOR SHALL CHECK AND VERIFY ALL DIMENSIONS BEFORE BEGINNING **CONSTRUCTION AND** CORRECTIONS OR REVISIONS ASSUME NO LIABILITY FOR ANY ERRORS ONCE THE CONSTRUCTION BEGINS.

**REVISION TABLE** 


SHEET NUN
COVER

**FILE NUMBER: BM2085** 

DATE: 12/2/2022


**SCALE:** WHEN PRINTED 24X36 1/4" = 1'-0"

SHEET NO.

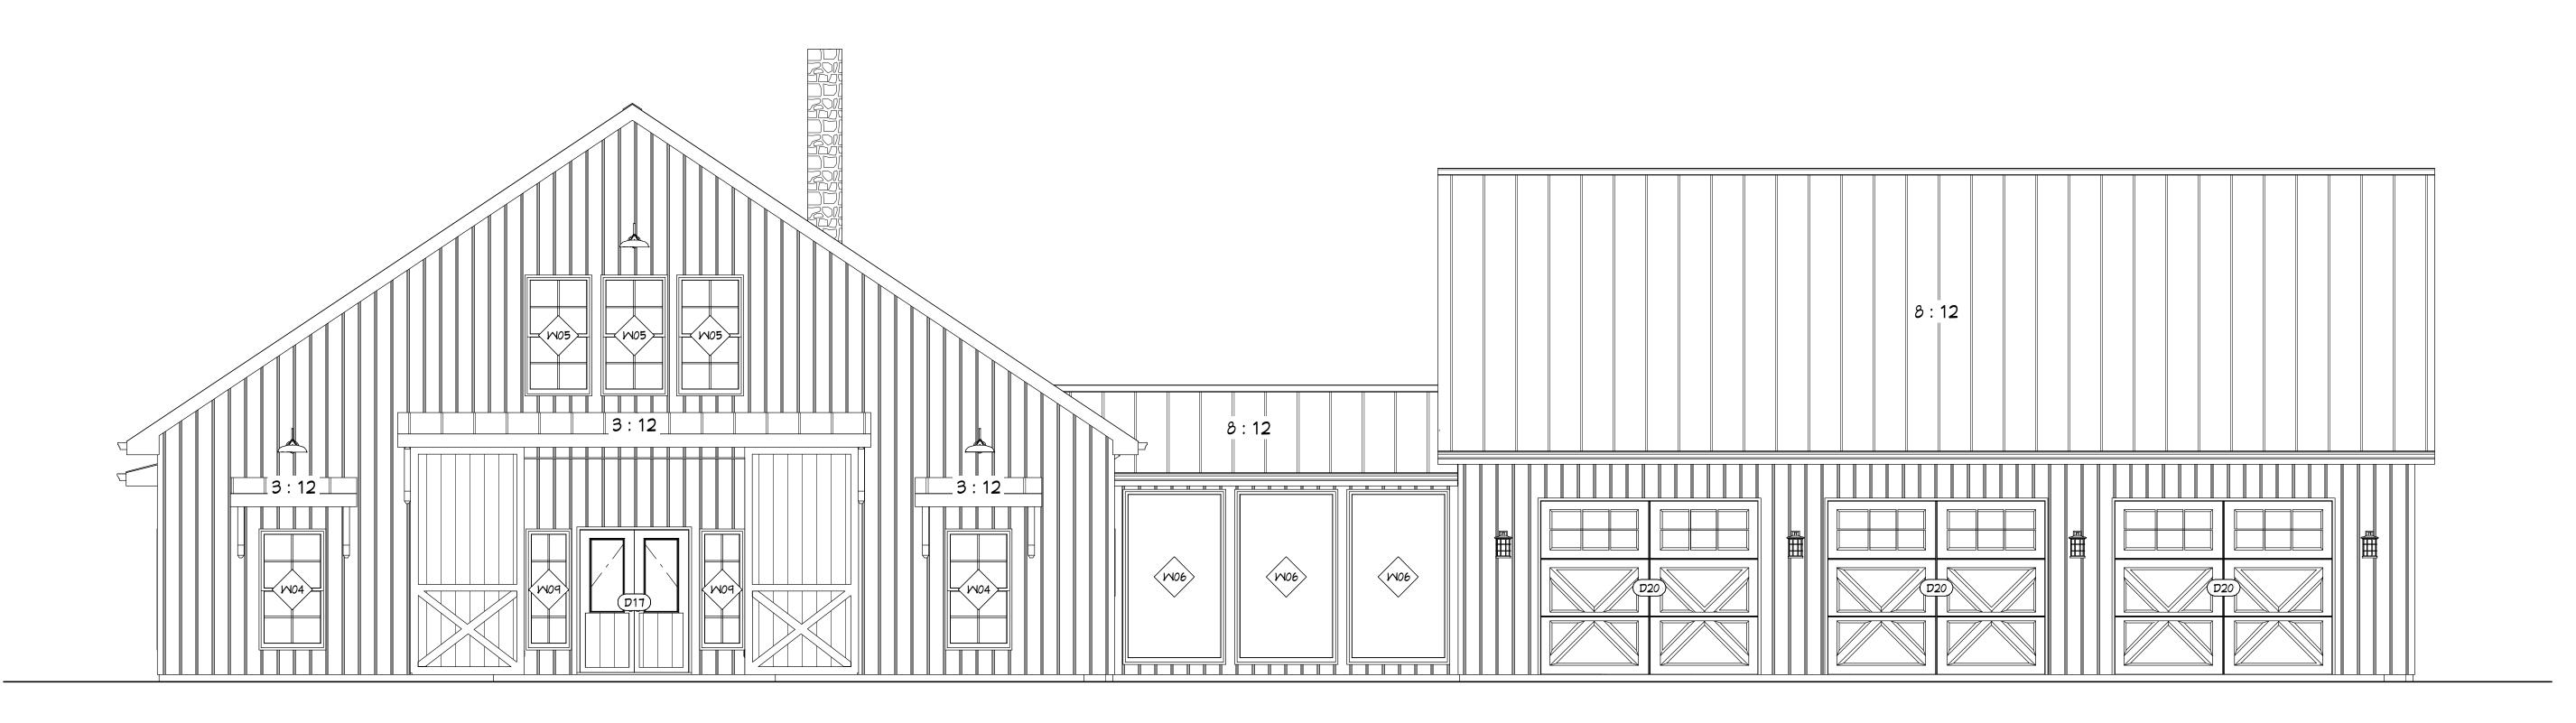

# FRONT ELEVATION

# ENGINEER VALIDATES ONLY DWELLING PORTION OF THIS PLAN

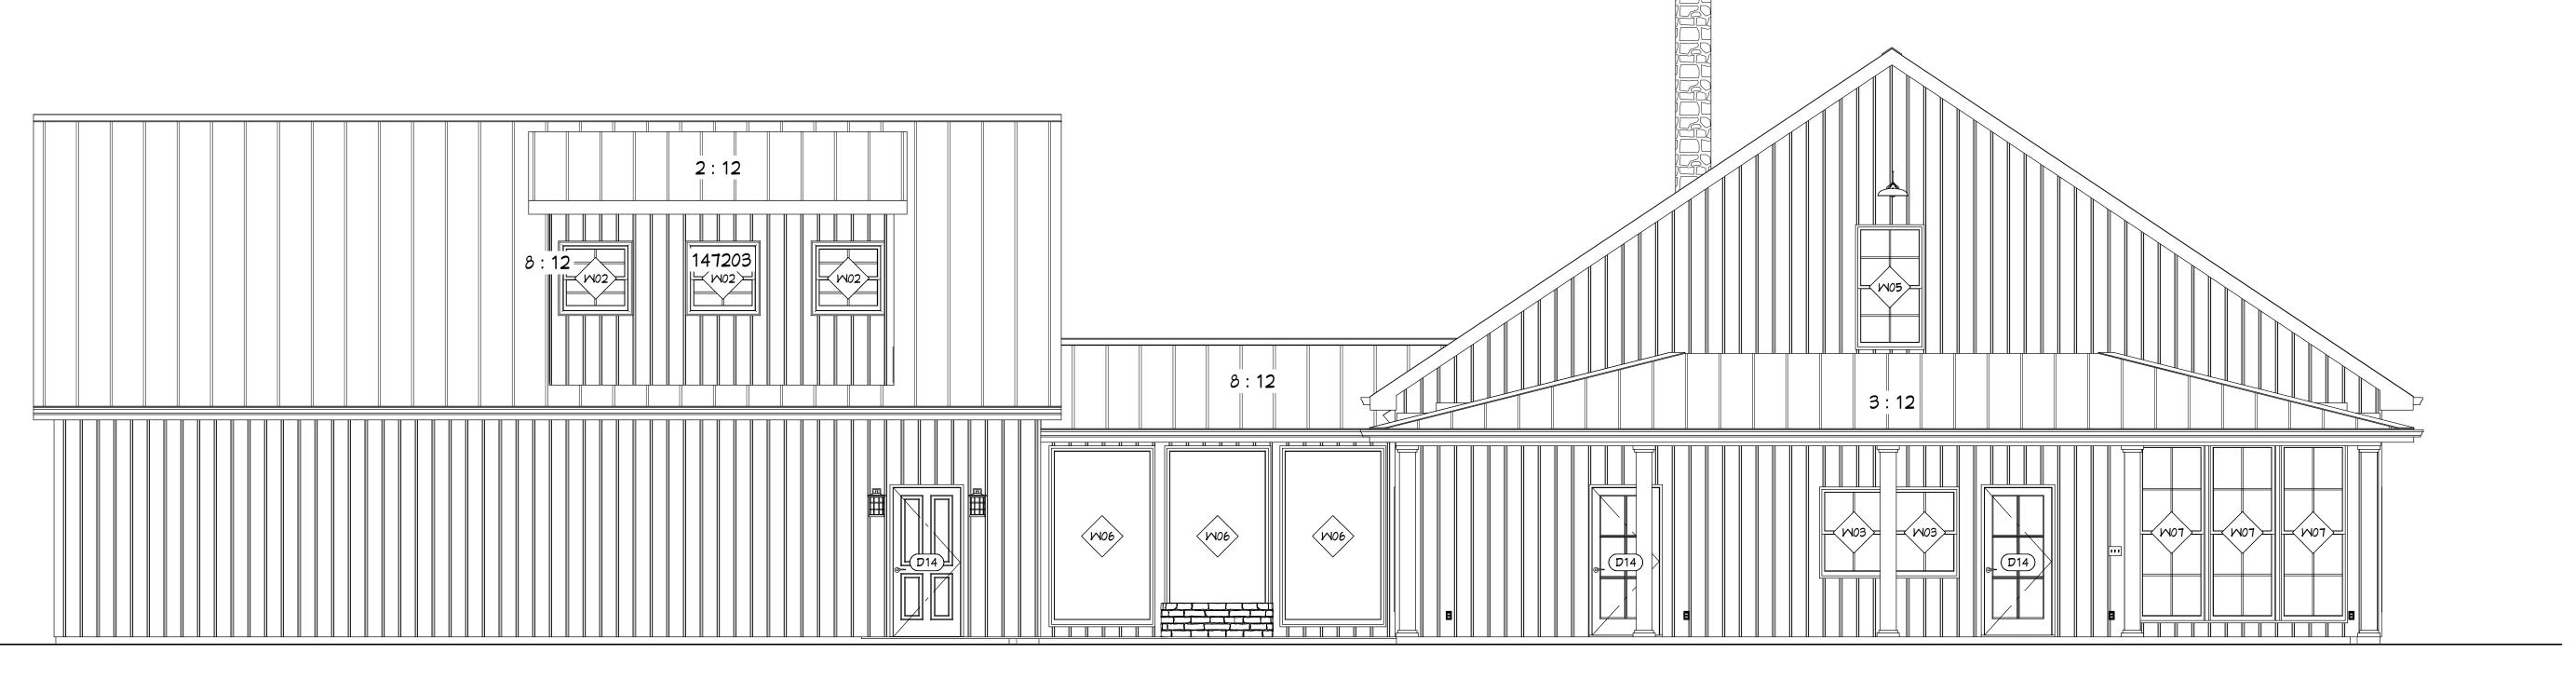

REAR ELEVATION



BuildMax Contact: tony@buildmax.com

CLIENT:
Refer to the name on the one-time build license

PROJECT TITLE:

COPYRIGHT:

BuildMax.com copyright 2021 Architectural works are protected by U.S. copyright law, specifically by 17 U.S. Code § 102(8).

#### NOTES:

CONTRACTOR SHALL CHECK
AND VERIFY ALL DIMENSIONS
BEFORE BEGINNING
CONSTRUCTION AND
COORDINATE ANY
CORRECTIONS OR REVISIONS
WITH THE OWNER AND
DESIGNER. BUILDMAX WILL
ASSUME NO LIABILITY FOR
ANY ERRORS ONCE THE
CONSTRUCTION BEGINS.

REVISION TABLE
NO. DATE DESCRIPTION

MBER CONTRACTIONS


FILE NUMBER: BM2085

DATE: 12/2/2022


SCALE: WHEN PRINTED 24X36

1/4" = 1'-0"

SHEET NO.

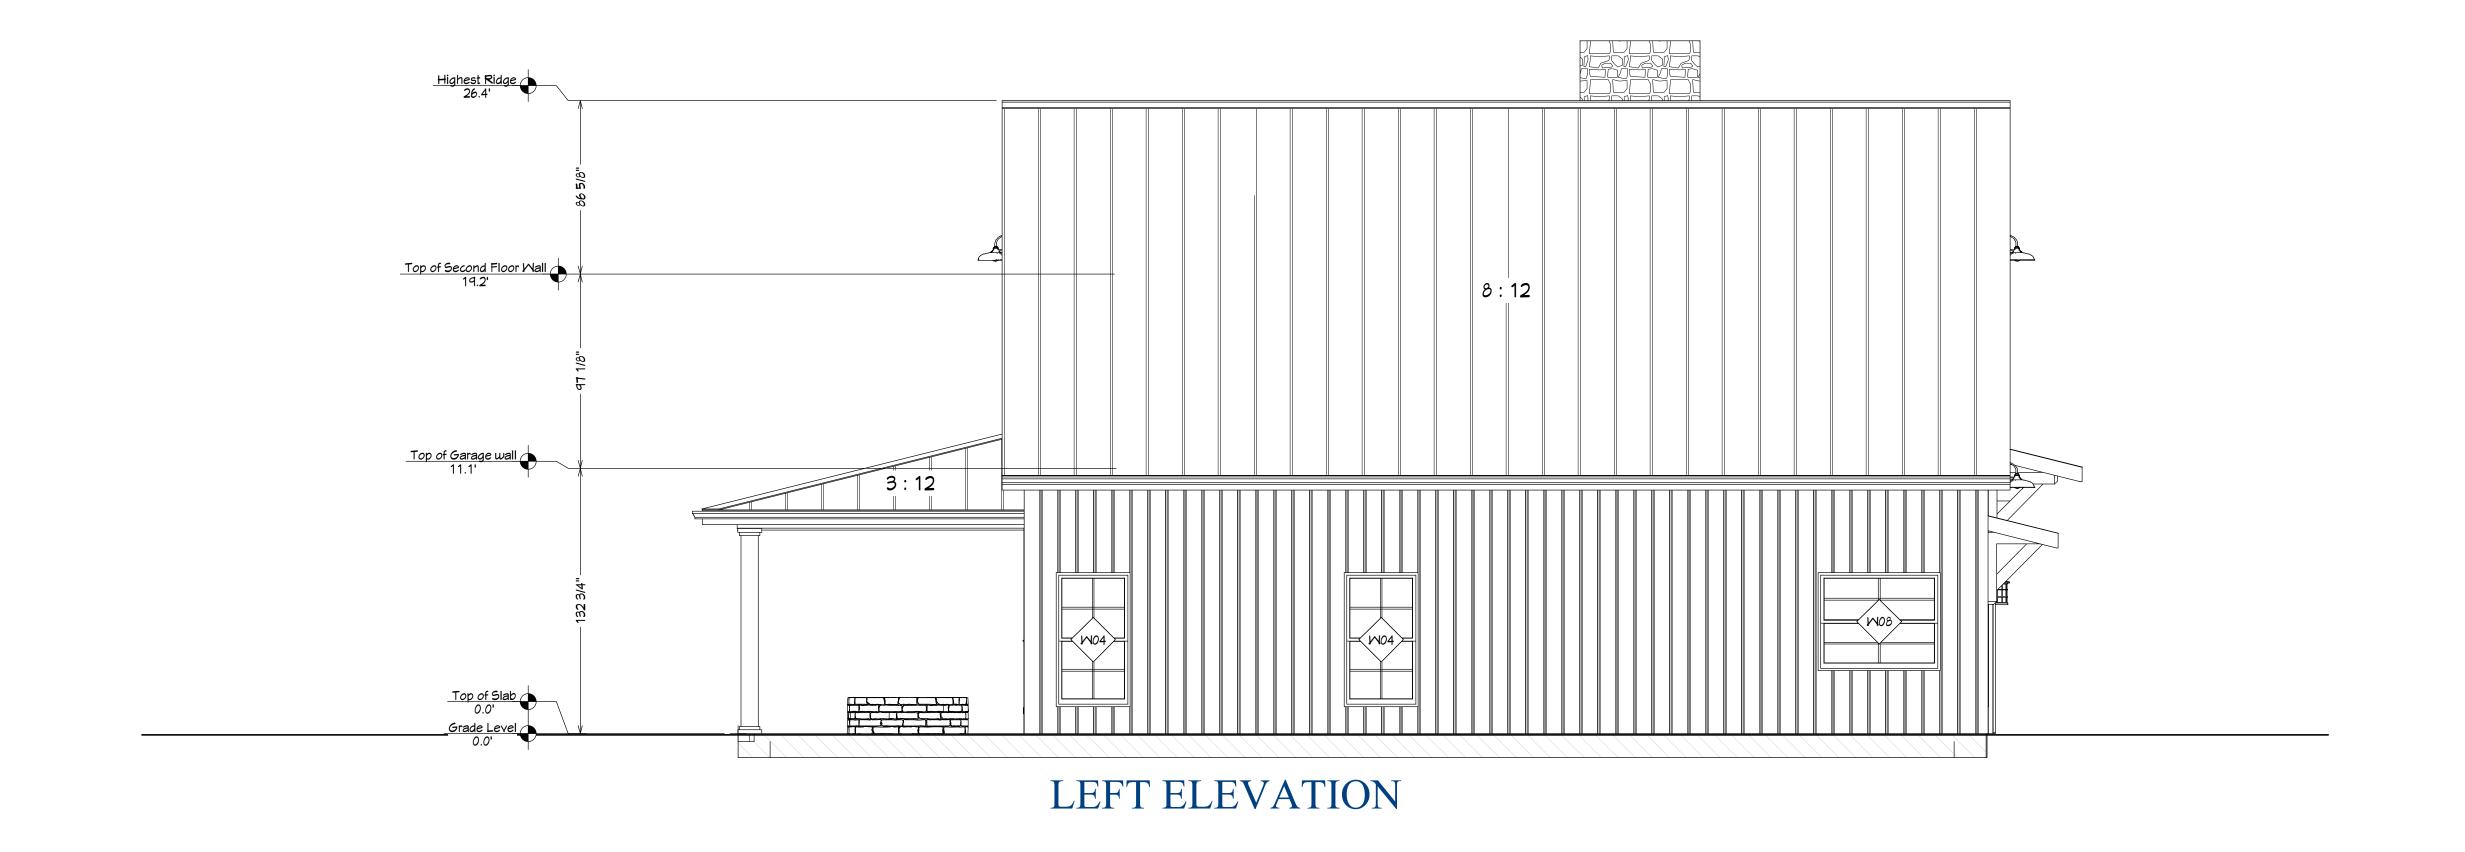

# ENGINEER VALIDATES ONLY DWELLING PORTION OF THIS PLAN

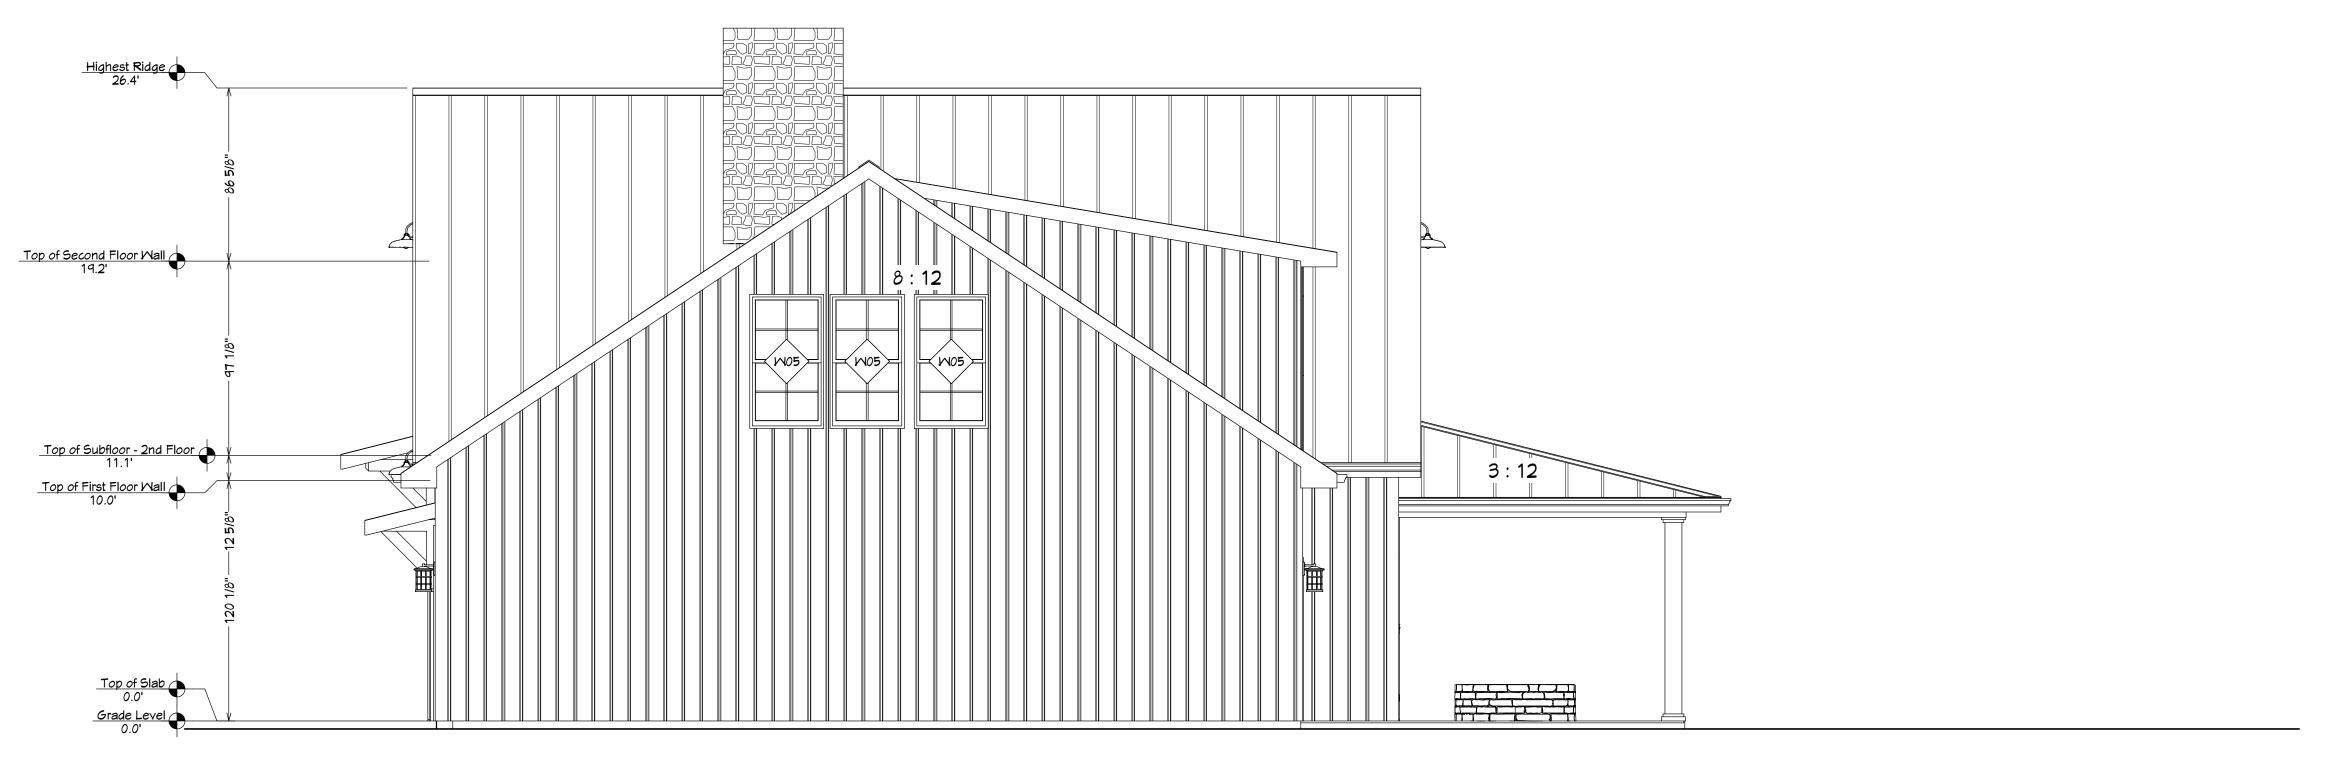

RIGHT ELEVATION

EXTERIOR ELEVATIONS 1/4"=1'-0"



BuildMax
Contact: tony@buildmax.com

CLIENT:
Refer to the name on the one-time build license

PROJECT TITLE:

COPYRIGHT:

BuildMax.com copyright 2021 Architectural works are protected by U.S. copyright law, specifically by 17 U.S. Code § 102(8).

#### NOTES:

CONTRACTOR SHALL CHECK
AND VERIFY ALL DIMENSIONS
BEFORE BEGINNING
CONSTRUCTION AND
COORDINATE ANY
CORRECTIONS OR REVISIONS
WITH THE OWNER AND
DESIGNER. BUILDMAX WILL
ASSUME NO LIABILITY FOR
ANY ERRORS ONCE THE
CONSTRUCTION BEGINS.

REVISION TABLE
NO. DATE DESCRIPTION

FILE NUMBER:

BM2085

DATE: 12/2/2022

SCALE: WHEN PRINTED 24X36

1/4" = 1'-0"

SHEET NO.

Door Schedule									
Number	Label	Qty	Floor	Size	Midth	Height	R/O	Header	Thickness
D01	2468	3	1	2468 L IN	28 "	80 "	30"x82 1/2"	2×10×33" (2)	1 3/8"
D02	2668	3	2	2668 R IN	30 "	80 "	32"×82 1/2"	2×10×35" (2)	1 3/8"
D04	2468	1	1	2468 R	<b>2</b> 8 "	80 "	45"×82 1/2"	2×10×48" (2)	1 3/8"
D05	2668	3	1	2668 R IN	30 "	80 "	32"x82 1/2"	2×10×35" (2)	1 3/8"
D06	2468	1	2	2468 L IN	28 "	80 "	30"x82 1/2"	2×10×33" (2)	1 3/8"
D07	2468	1	2	2468 R IN	28 "	80 "	30"x82 1/2"	2×10×33" (2)	1 3/8"
D10	2668	2	1	2668 L IN	30 "	80 "	32"x82 1/2"	2×10×35" (2)	1 3/8"
D11	3068	1	1	3068 L EX	36 "	80 "	38"×83"	2×10×41" (2)	1 3/4"
D12	3068	1	1	3068 L IN	36 "	80 "	38"×82 1/2"	2×10×41" (2)	1 3/8"
D13	3068	2	1	3068 R	36 "	80 "	57"×82 1/2"	2×10×60" (2)	1 3/8"
D14	3068	4	1	3068 R EX	36 "	80 "	38"×83"	2×10×41" (2)	1 3/4"
D15	3068	1	2	3068 L	36 "	80 "	38"x82 1/2"	2×10×41" (2)	1 3/8"
D17	5068	1	1	5068 L/R EX	60 "	80 "	62"×83"	2×10×65" (2)	1 3/4"
D18	4068	1	1	4068 L/R	48 "	80 "	50"×82 1/2"	2×10×53" (2)	1 3/8"
D19	2668	1	1	2668 R	30 "	80 "	30"×80"		1/2"
D20	10080	3	1	10080	120 "	96 "	123"×99"	1 3/4×11 7/8×129" (2)	1 3/4"
D21	2668	1	1	2668 R IN	29 1/2 "	80 "	31 1/2"×82 1/2"	2×10×34 1/2" (2)	1 3/8"
D22	3068	1	2	3068 L EX	36 "	80 "	38"×83"	2×10×38" (2)	1 3/4"

 Window Schedule

 Number
 Label
 Qty
 Floor
 Size
 Width
 Height
 R/O
 Header

 W01
 2030DH
 1
 1
 2030DH
 24 "
 36 "
 25"x37"
 2x6x28" (2)

 W02
 3030DH
 3
 2
 3030DH
 36 "
 37"x37"
 2x6x40" (2)

 W03
 3040DH
 2
 1
 3040DH
 36 "
 48 "
 37"x49"
 2x6x40" (2)

 W04
 3056DH
 5
 1
 3056DH
 36 "
 66 "
 37"x67"
 2x6x40" (2)

 W05
 3056DH
 10
 2
 3056DH
 36 "
 66 "
 37"x67"
 2x6x40" (2)

 W06
 4880FX
 6
 1
 4880FX
 56 "
 96 "
 57"x97"
 2x6x40" (2)

 W07
 3080DH
 3
 1
 3080DH
 36 "
 96 "
 37"x97"
 2x6x40" (2)

 W08
 5040DH
 1
 1
 5040DH
 60 "
 48 "
 61"x49"
 2x6x64" (2)<

These Architectural Sheets are part of the required plan set needed for construction. The total set includes Architectural Sheets (Labeled A1 – A14) and Structural Sheets (Labeled S1 – S6). Some information on the Architectural sheets has been revised by the Structure sheets to allow for proper structural support locations and requirements. Because of these requirements, some dimensions and locations have changed on the Architectural sheets. The correct (FOR USE) dimensions and Layout are found on the Structure sheets (S1 – S6) included in this set. Any dimensions or information not found on the Structure Sheets may be found on the Architectural Sheets.

Plans provided by Architect include a breezeway and attached garage. For the purposes of the project, only the MAIN DWELLING is being constructed. The attached Structure Plans (S1-S6) reflect only the main dwelling. Any structural requirements pertaining to the Breezeway or Garage are not valid on this plan set and should not be used for future construction. Engineer's coverage by licensed seal is also not valid for Breezeway and Garage Construction.

Engineer validates only the Dwelling portion of these plans. Acceptance of these plans acknowledges and agrees to these conditions and engineer is not held liable for any information regarding the breezeway and Garage construction.

John Oerter, PE 2720 Quail Point Dr. Raleigh, NC 27602 oerterjohn@gmail.com





Contact: tony@buildmax.com

#### **ENGINEER VALIDATES ONLY DWELLING PORTION OF THIS PLAN**

CLIENT:
Refer to the name on the onetime build license

PROJECT TITLE:

COPYRIGHT:

BuildMax.com copyright 2021 Architectural works are protected by U.S. copyright law, specifically by 17 U.S. Code § 102(8).

**NOTES:** 

CONTRACTOR SHALL CHECK
AND VERIFY ALL DIMENSIONS
BEFORE BEGINNING
CONSTRUCTION AND
COORDINATE ANY
CORRECTIONS OR REVISIONS
WITH THE OWNER AND
DESIGNER. BUILDMAX WILL
ASSUME NO LIABILITY FOR
ANY ERRORS ONCE THE
CONSTRUCTION BEGINS.

REVISION TABLE

NO. DATE DESCRIPTION

	_		
SHEET NUMBER			
FIRST FLOOR PLAN			


FILE NUMBER: BM2085


DATE: 12/2/2022

SCALE: WHEN PRINTED 24X36


1/4" = 1'-0"

SHEET NO.

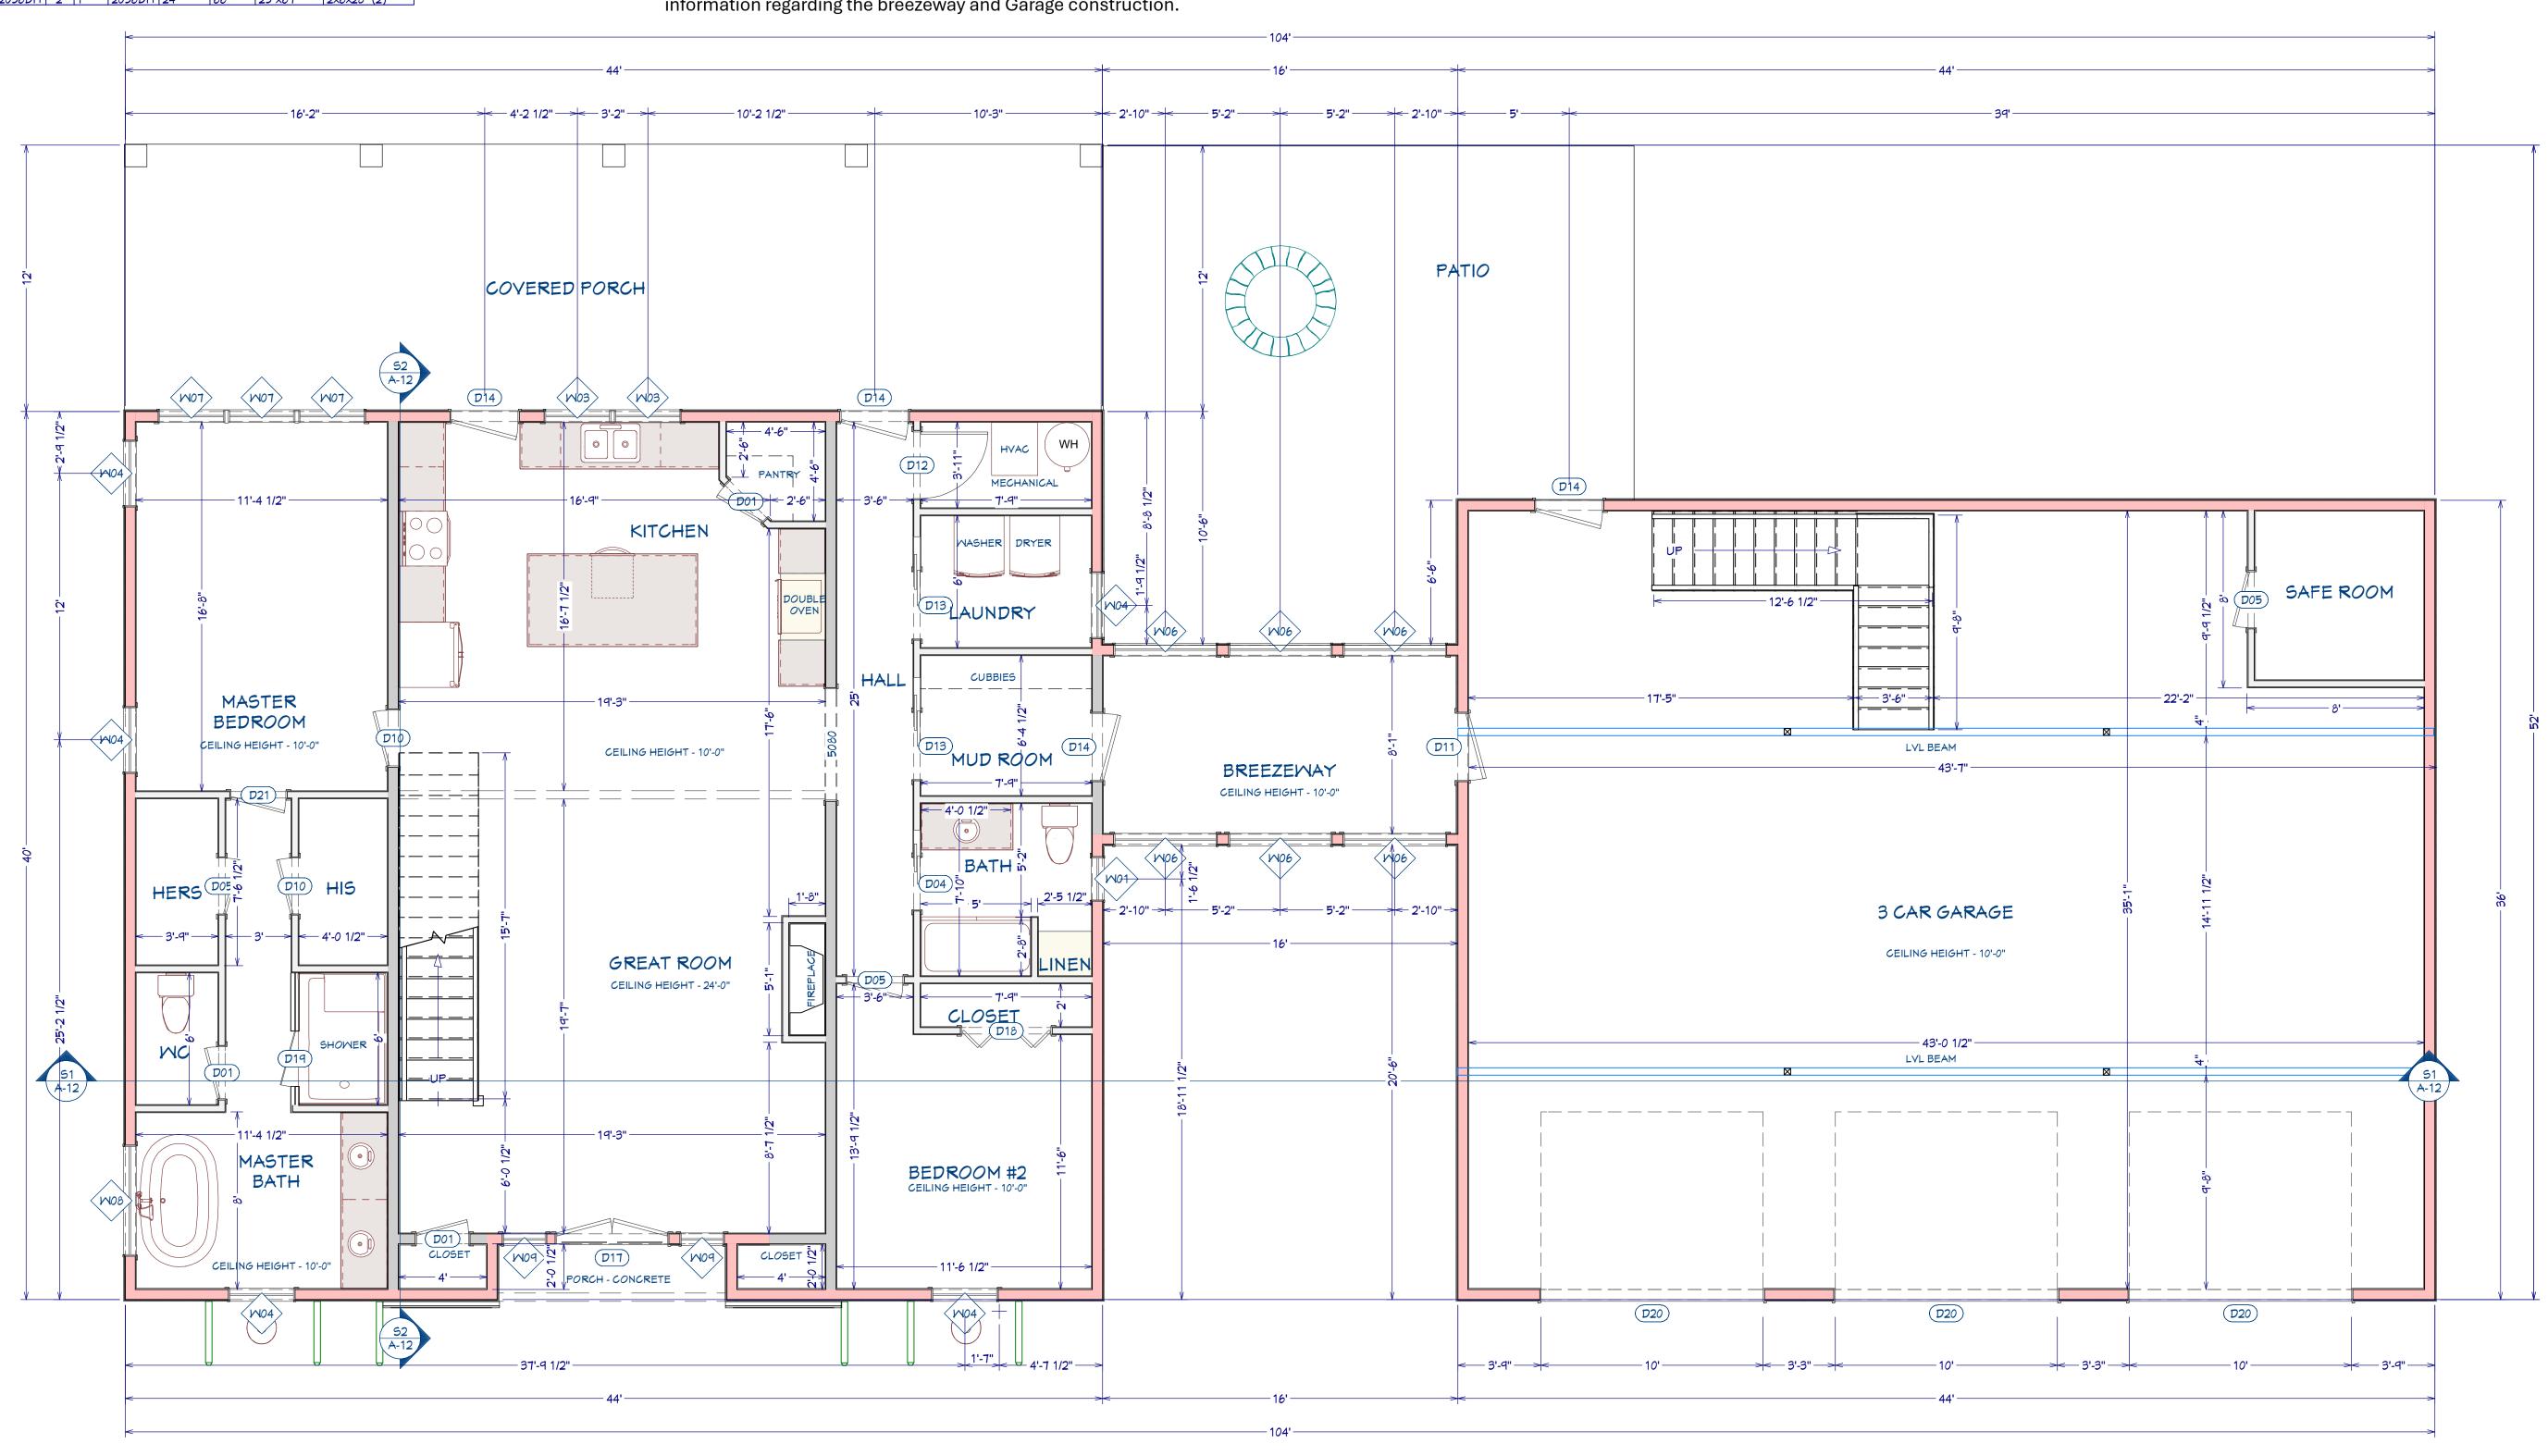

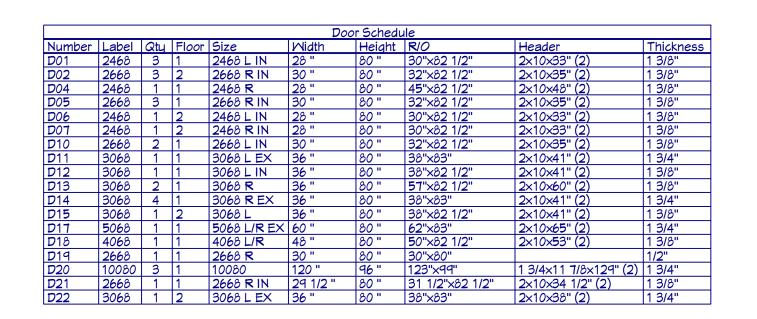

Mindow Schedule									
Number	Label	Qty	Floor	Size	Midth	Height	R/0	Header	
M01	2030DH	1	1	2030DH	24 "	36 "	25"×37"	2×6×28" (2)	
M02	3030DH	3	2	3030DH	36 "	36 "	37"×37"	2×6×40" (2)	
M03	3040DH	2	1	3040DH	36 "	48 "	37"×49"	2×6×40" (2)	
M04	3056DH	5	1	3056DH	36 "	66 "	37"×67"	2×6×40" (2)	
M05	3056DH	10	2	3056DH	36 "	66 "	37"×67"	2×6×40" (2)	
M06	4880FX	6	1	4880FX	56 "	96 "	57"×97"	2×6×60" (2)	
M07	3080DH	3	1	3080DH	36 "	96 "	37"×97"	2×6×40" (2)	
M08	5040DH	1	1	5040DH	60 "	48 "	61"×49"	2×6×64" (2)	
M09	2056DH	2	1	2056DH	24 "	66 "	25"×67"	2×6×28" (2)	

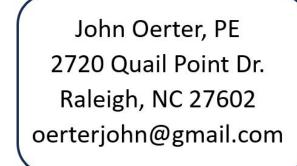



# BuildMax Contact: tony@buildmax.com

#### ENGINEER VALIDATES ONLY DWELLING PORTION OF THIS PLAN

CLIENT:
Refer to the name on the onetime build license

PROJECT TITLE:

COPYRIGHT:

BuildMax.com copyright 2021 Architectural works are protected by U.S. copyright law, specifically by 17 U.S. Code § 102(8).

#### NOTES:

CONTRACTOR SHALL CHECK
AND VERIFY ALL DIMENSIONS
BEFORE BEGINNING
CONSTRUCTION AND
COORDINATE ANY
CORRECTIONS OR REVISIONS
WITH THE OWNER AND
DESIGNER. BUILDMAX WILL
ASSUME NO LIABILITY FOR
ANY ERRORS ONCE THE
CONSTRUCTION BEGINS.

REVISION TABLE
NO. DATE DESCRIPTION

COND FLOOR PLAN


FILE NUMBER: BM2085

DATE: 12/2/2022

SCALE: WHEN PRINTED 24X36

1/4" = 1'-0"


SHEET NO.

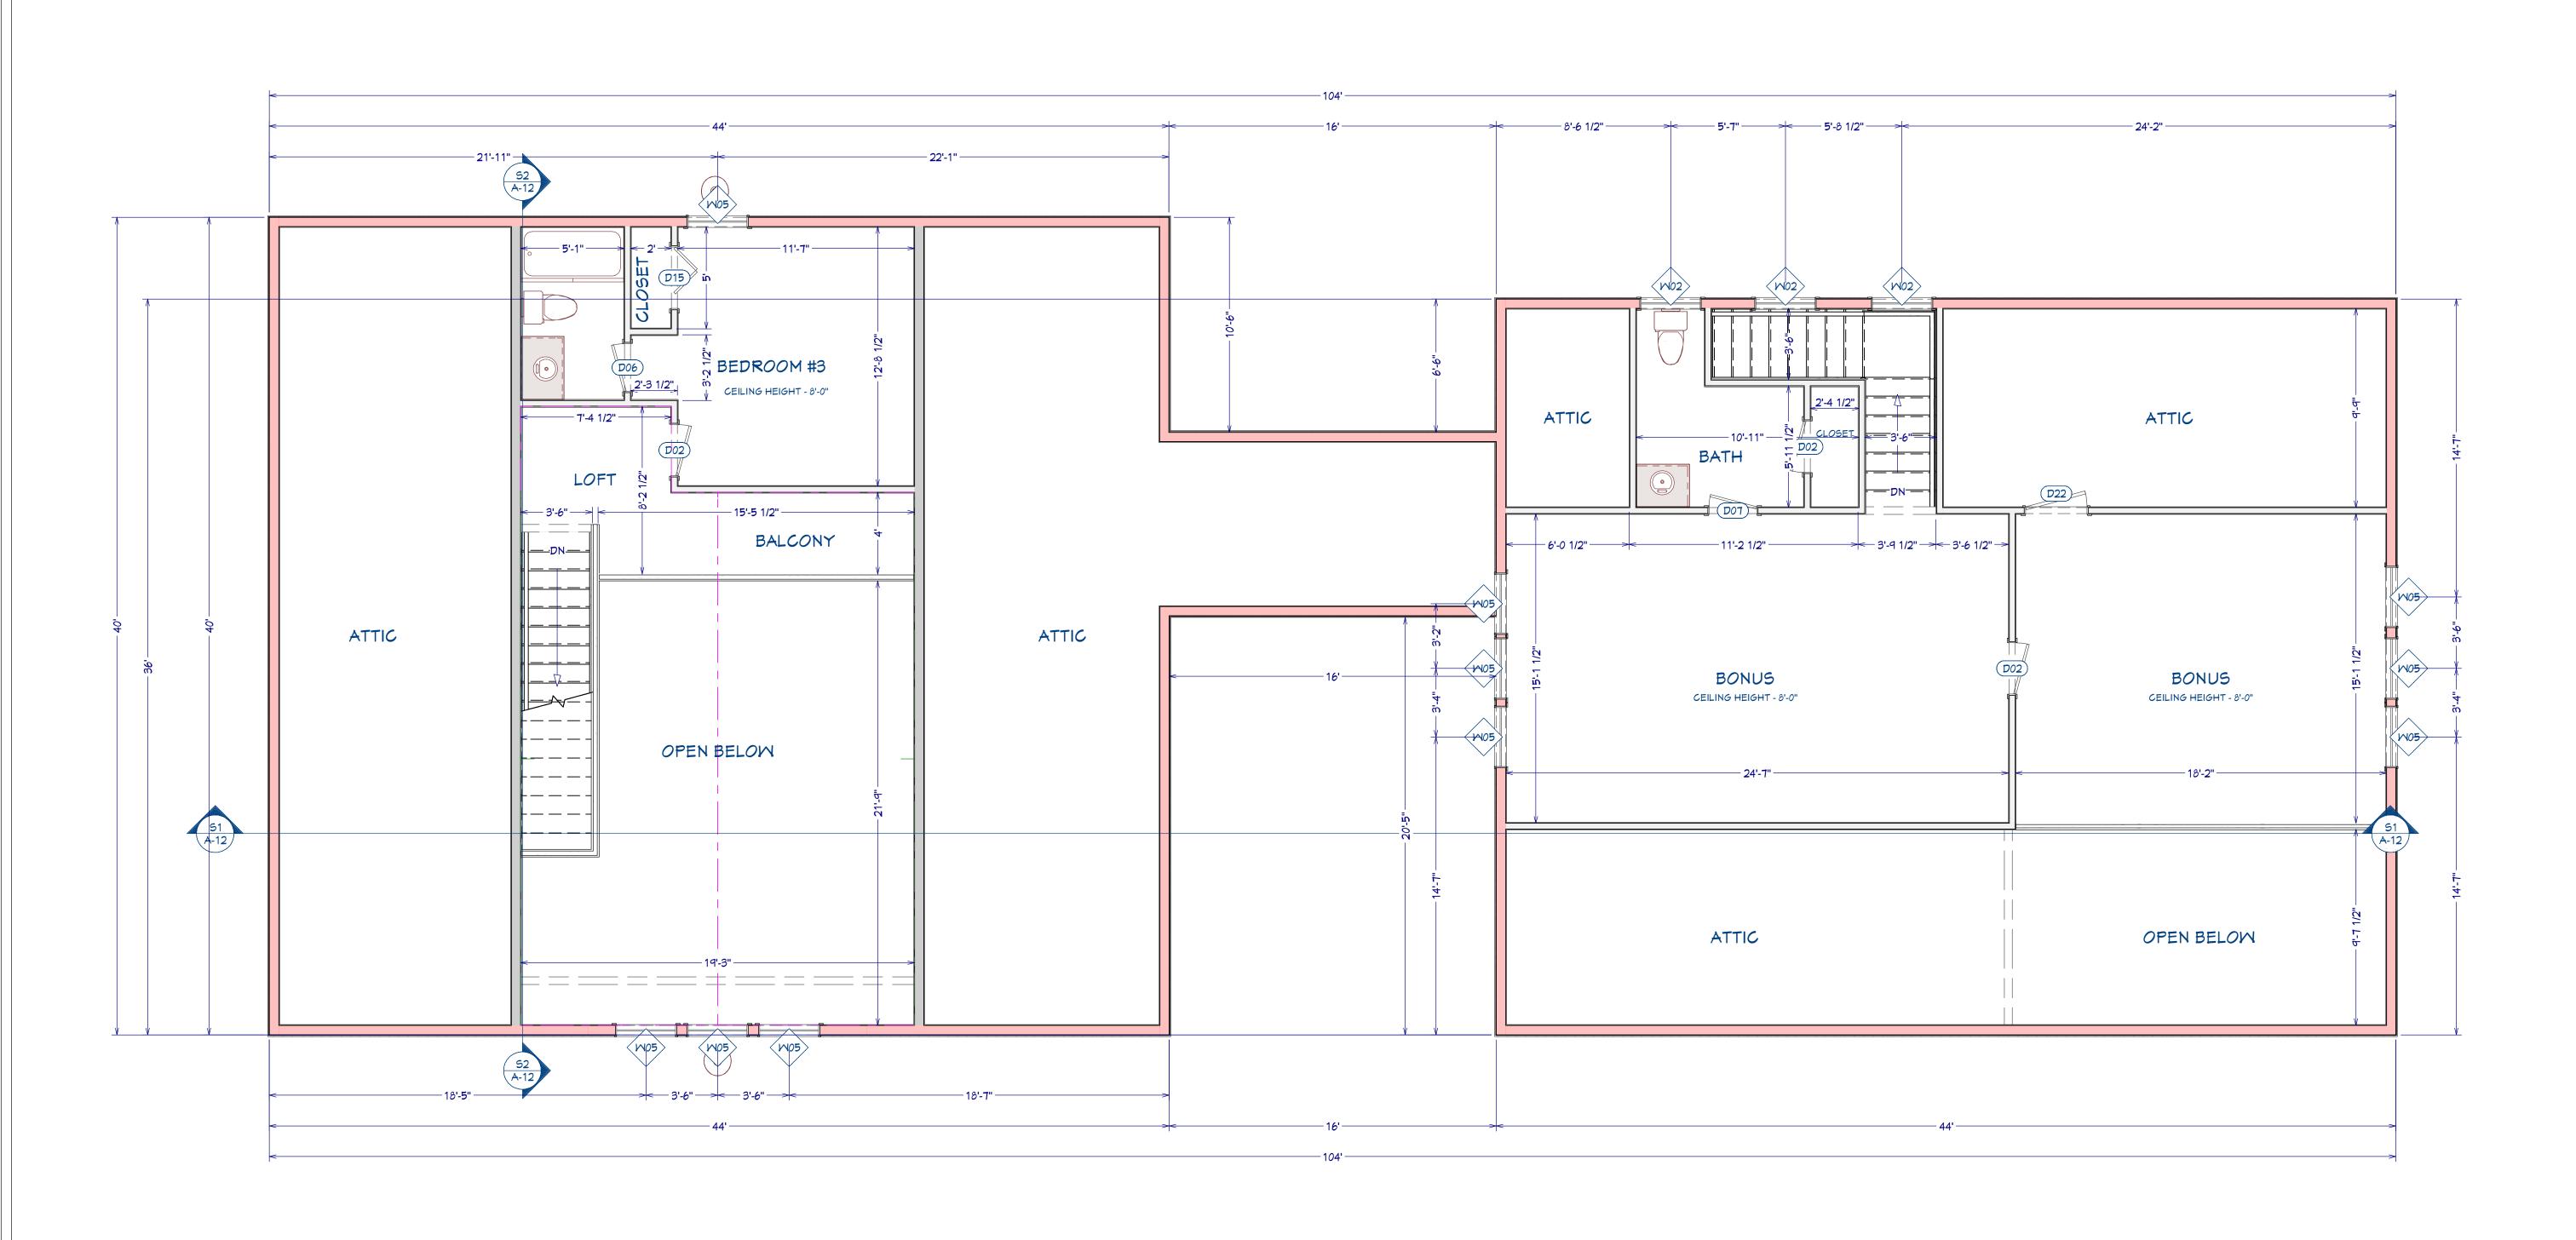

John Oerter, PE 2720 Quail Point Dr. Raleigh, NC 27602 oerterjohn@gmail.com





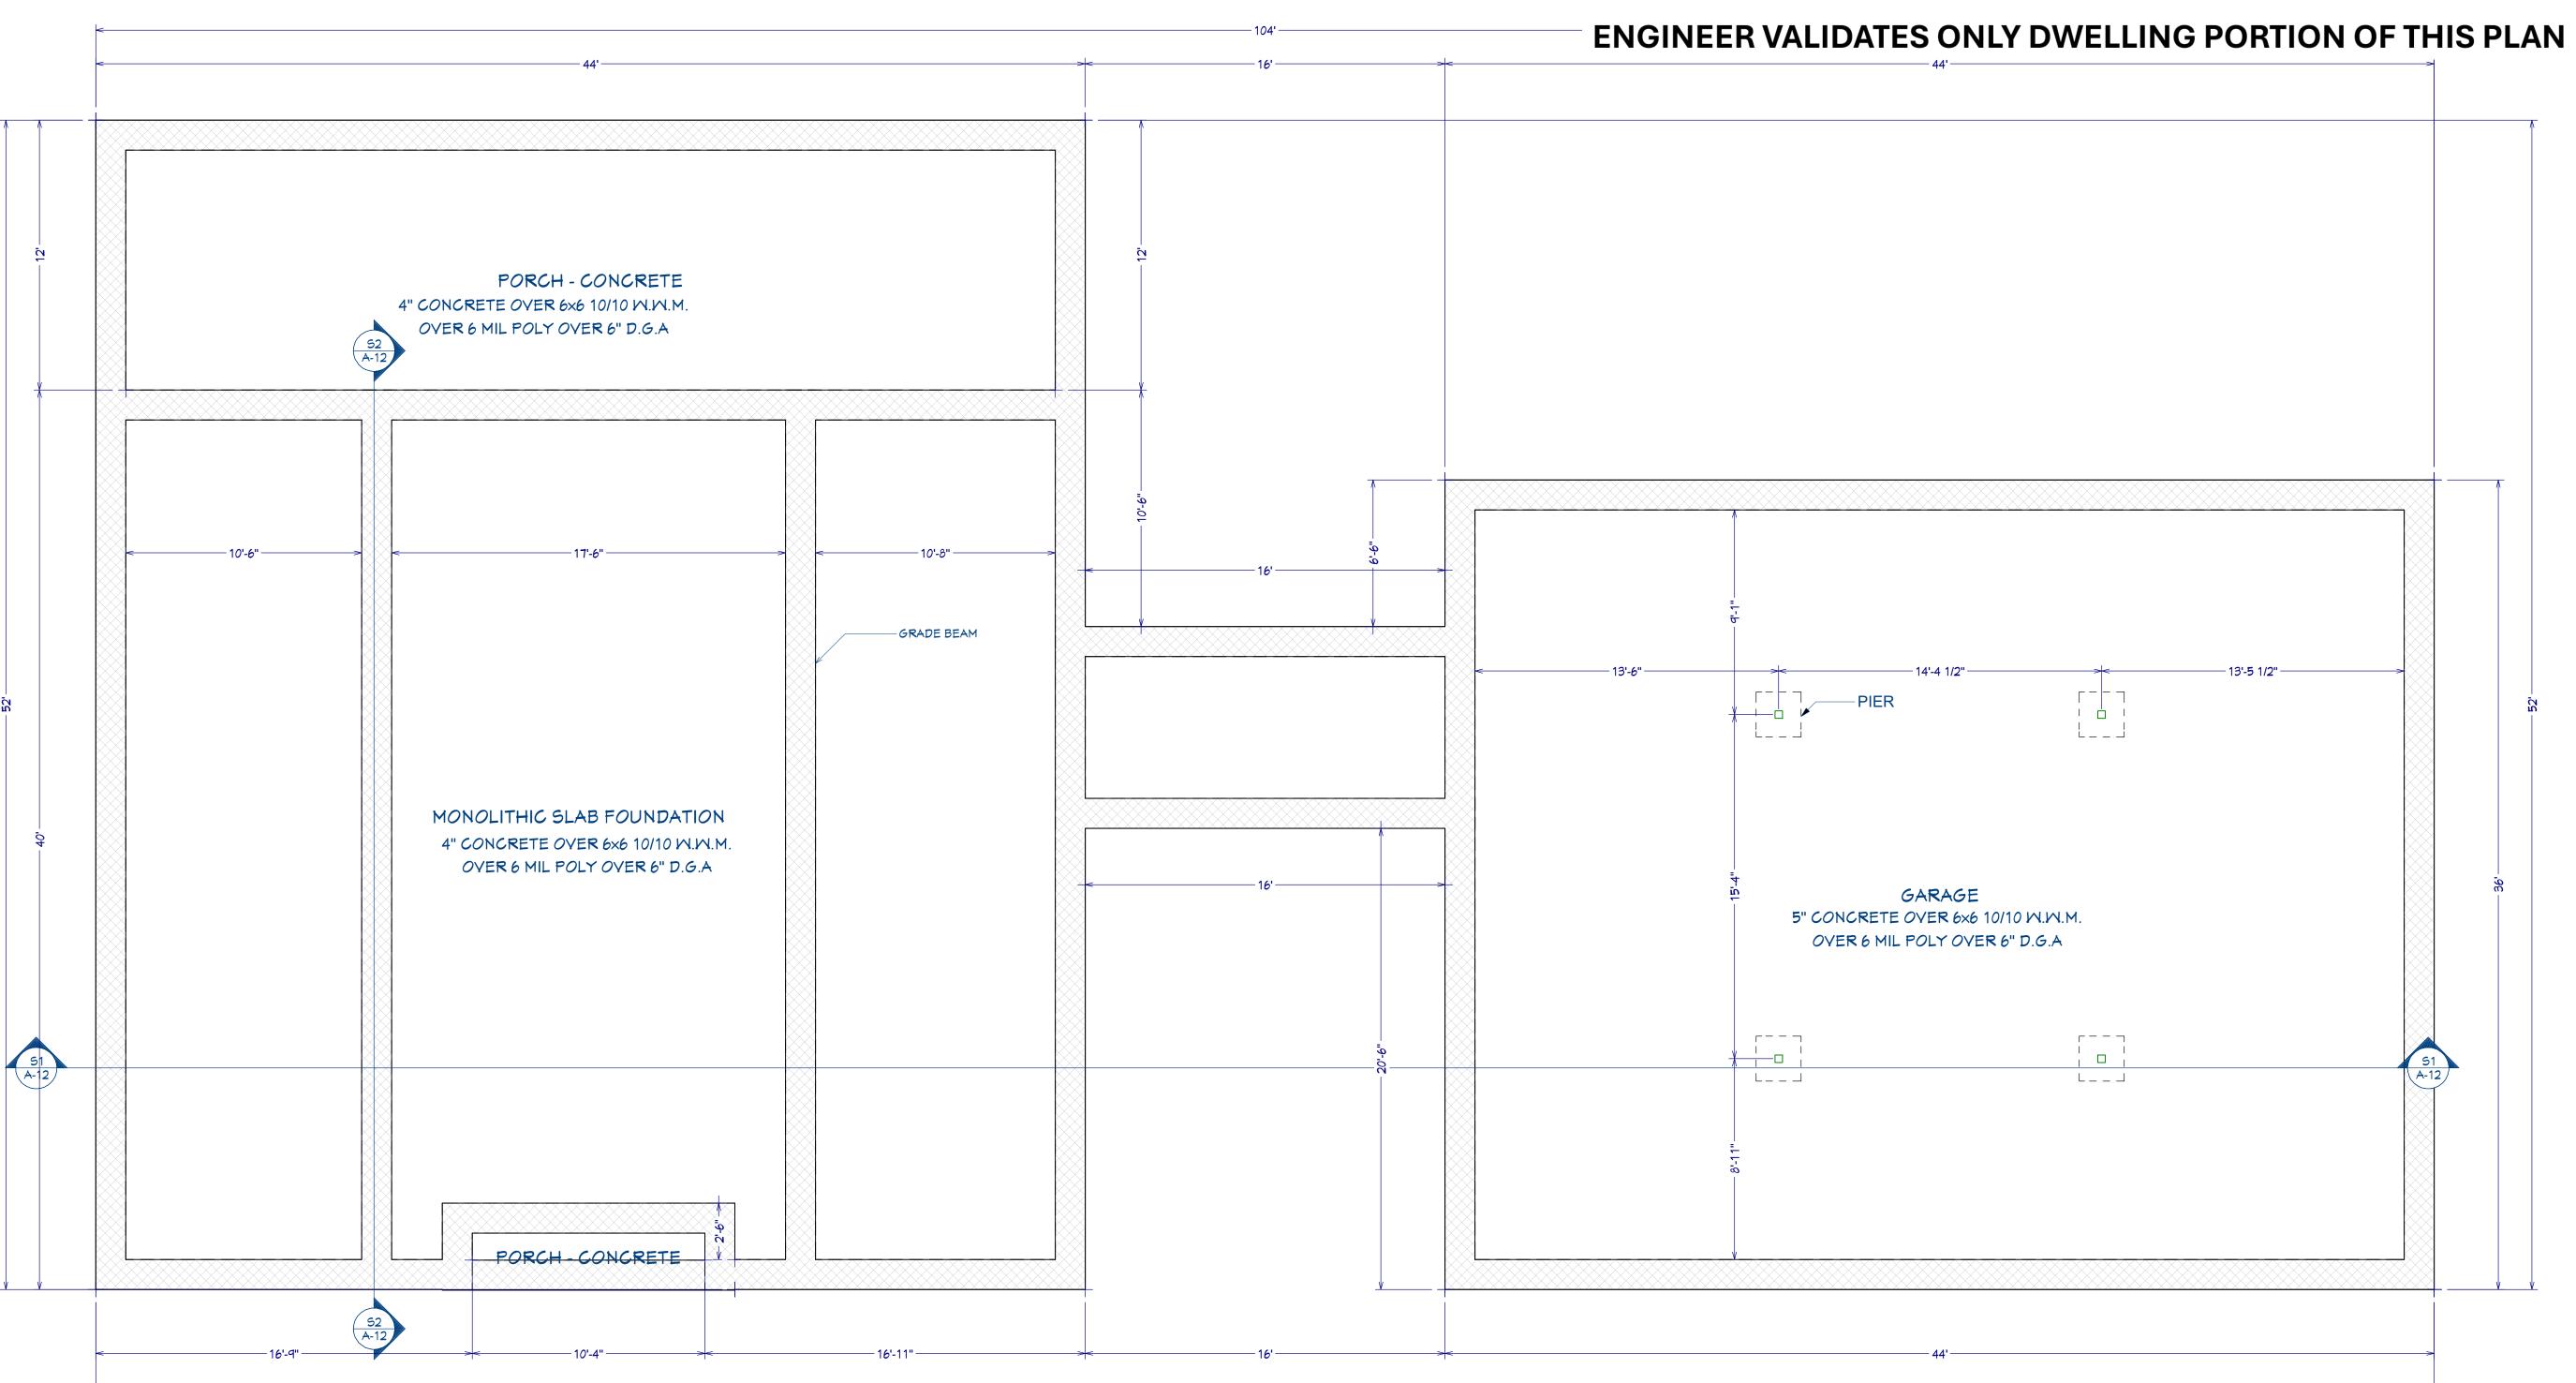

#### SITE DRAINAGE:

IT IS RECOMMENDED THAT SHE DRAINAGE BE WELL DEVELOPED. SURFACE WATER SHOULD BE DIRECTED AWAY FROM THE FOUNDATION SOILS. (USE A MINIMUM SLOPE OF 2% WITHIN 10 FEET OF THE FOUNDATION. NO PONDING OF SURFACE WATER SHALL BE ALLOWED NEAR THE STRUCTURE DURING OR AFTER COMPLETION OF THE CONSTRUCTION AND THE LANDSCAPING. THE BUILDER SHALL ADVISE THE OWNER OF THE SITE DRAINAGE REQUIREMENTS.

#### SPECIFICATION NOTES

- 1. REINFORCED CONCRETE SHALL CONFORM TO APPLICABLE REQUIREMENTS OF THE 2018 I.R.C. AND ALL LOCAL CITY OR COUNTY
- 2. ALL CONCRETE USED IN THE FOUNDATIONS AND SLABS ON GRADE SHALL HAVE A 28 DAY COMPRESSIVE STRENGTH OF NOT LESS THAN 3,000 PSI.
- 3. THE MAXIMUM SLUMP SHALL NOT EXCEED 4 INCHES.
- 4. PROVIDE CONTROL JOINTS IN ALL EXPOSED SLABS ON GRADE. THE MAXIMUM SPACING OF CONTROL JOINTS SHALL BE 20" O.G.,

UNLESS OTHERWISE NOTED.

5. A CIVIL ENGINEER SHOULD BE CONSULTED TO VERIFY FOUNDATION PLANS AND DETAILS. SITE DRAINAGE: IT IS RECOMMENDED THAT SHE DRAINAGE BE WELL DEVELOPED.

FOUNDATION PLAN

1/4"=1'-0"

CLIENT:
Refer to the name on the onetime build license

PROJECT TITLE:

COPYRIGHT:

BuildMax.com copyright 2021 Architectural works are protected by U.S. copyright law, specifically by 17 U.S. Code § 102(8).

#### **NOTES:**

CONTRACTOR SHALL CHECK AND VERIFY ALL DIMENSIONS BEFORE BEGINNING CONSTRUCTION AND **COORDINATE ANY** CORRECTIONS OR REVISIONS WITH THE OWNER AND DESIGNER. BUILDMAX WILL ASSUME NO LIABILITY FOR ANY ERRORS ONCE THE CONSTRUCTION BEGINS.

REVISION TABLE NO. DATE DESCRIPTION

**FILE NUMBER: BM2085** 

DATE:

12/2/2022

**SCALE:** WHEN PRINTED 24X36 1/4" = 1'-0"


SHEET NO.

John Oerter, PE 2720 Quail Point Dr. Raleigh, NC 27602 oerterjohn@gmail.com



# BuildMax Contact: tony@buildmax.com

## **ENGINEER VALIDATES ONLY DWELLING PORTION OF THIS PLAN**

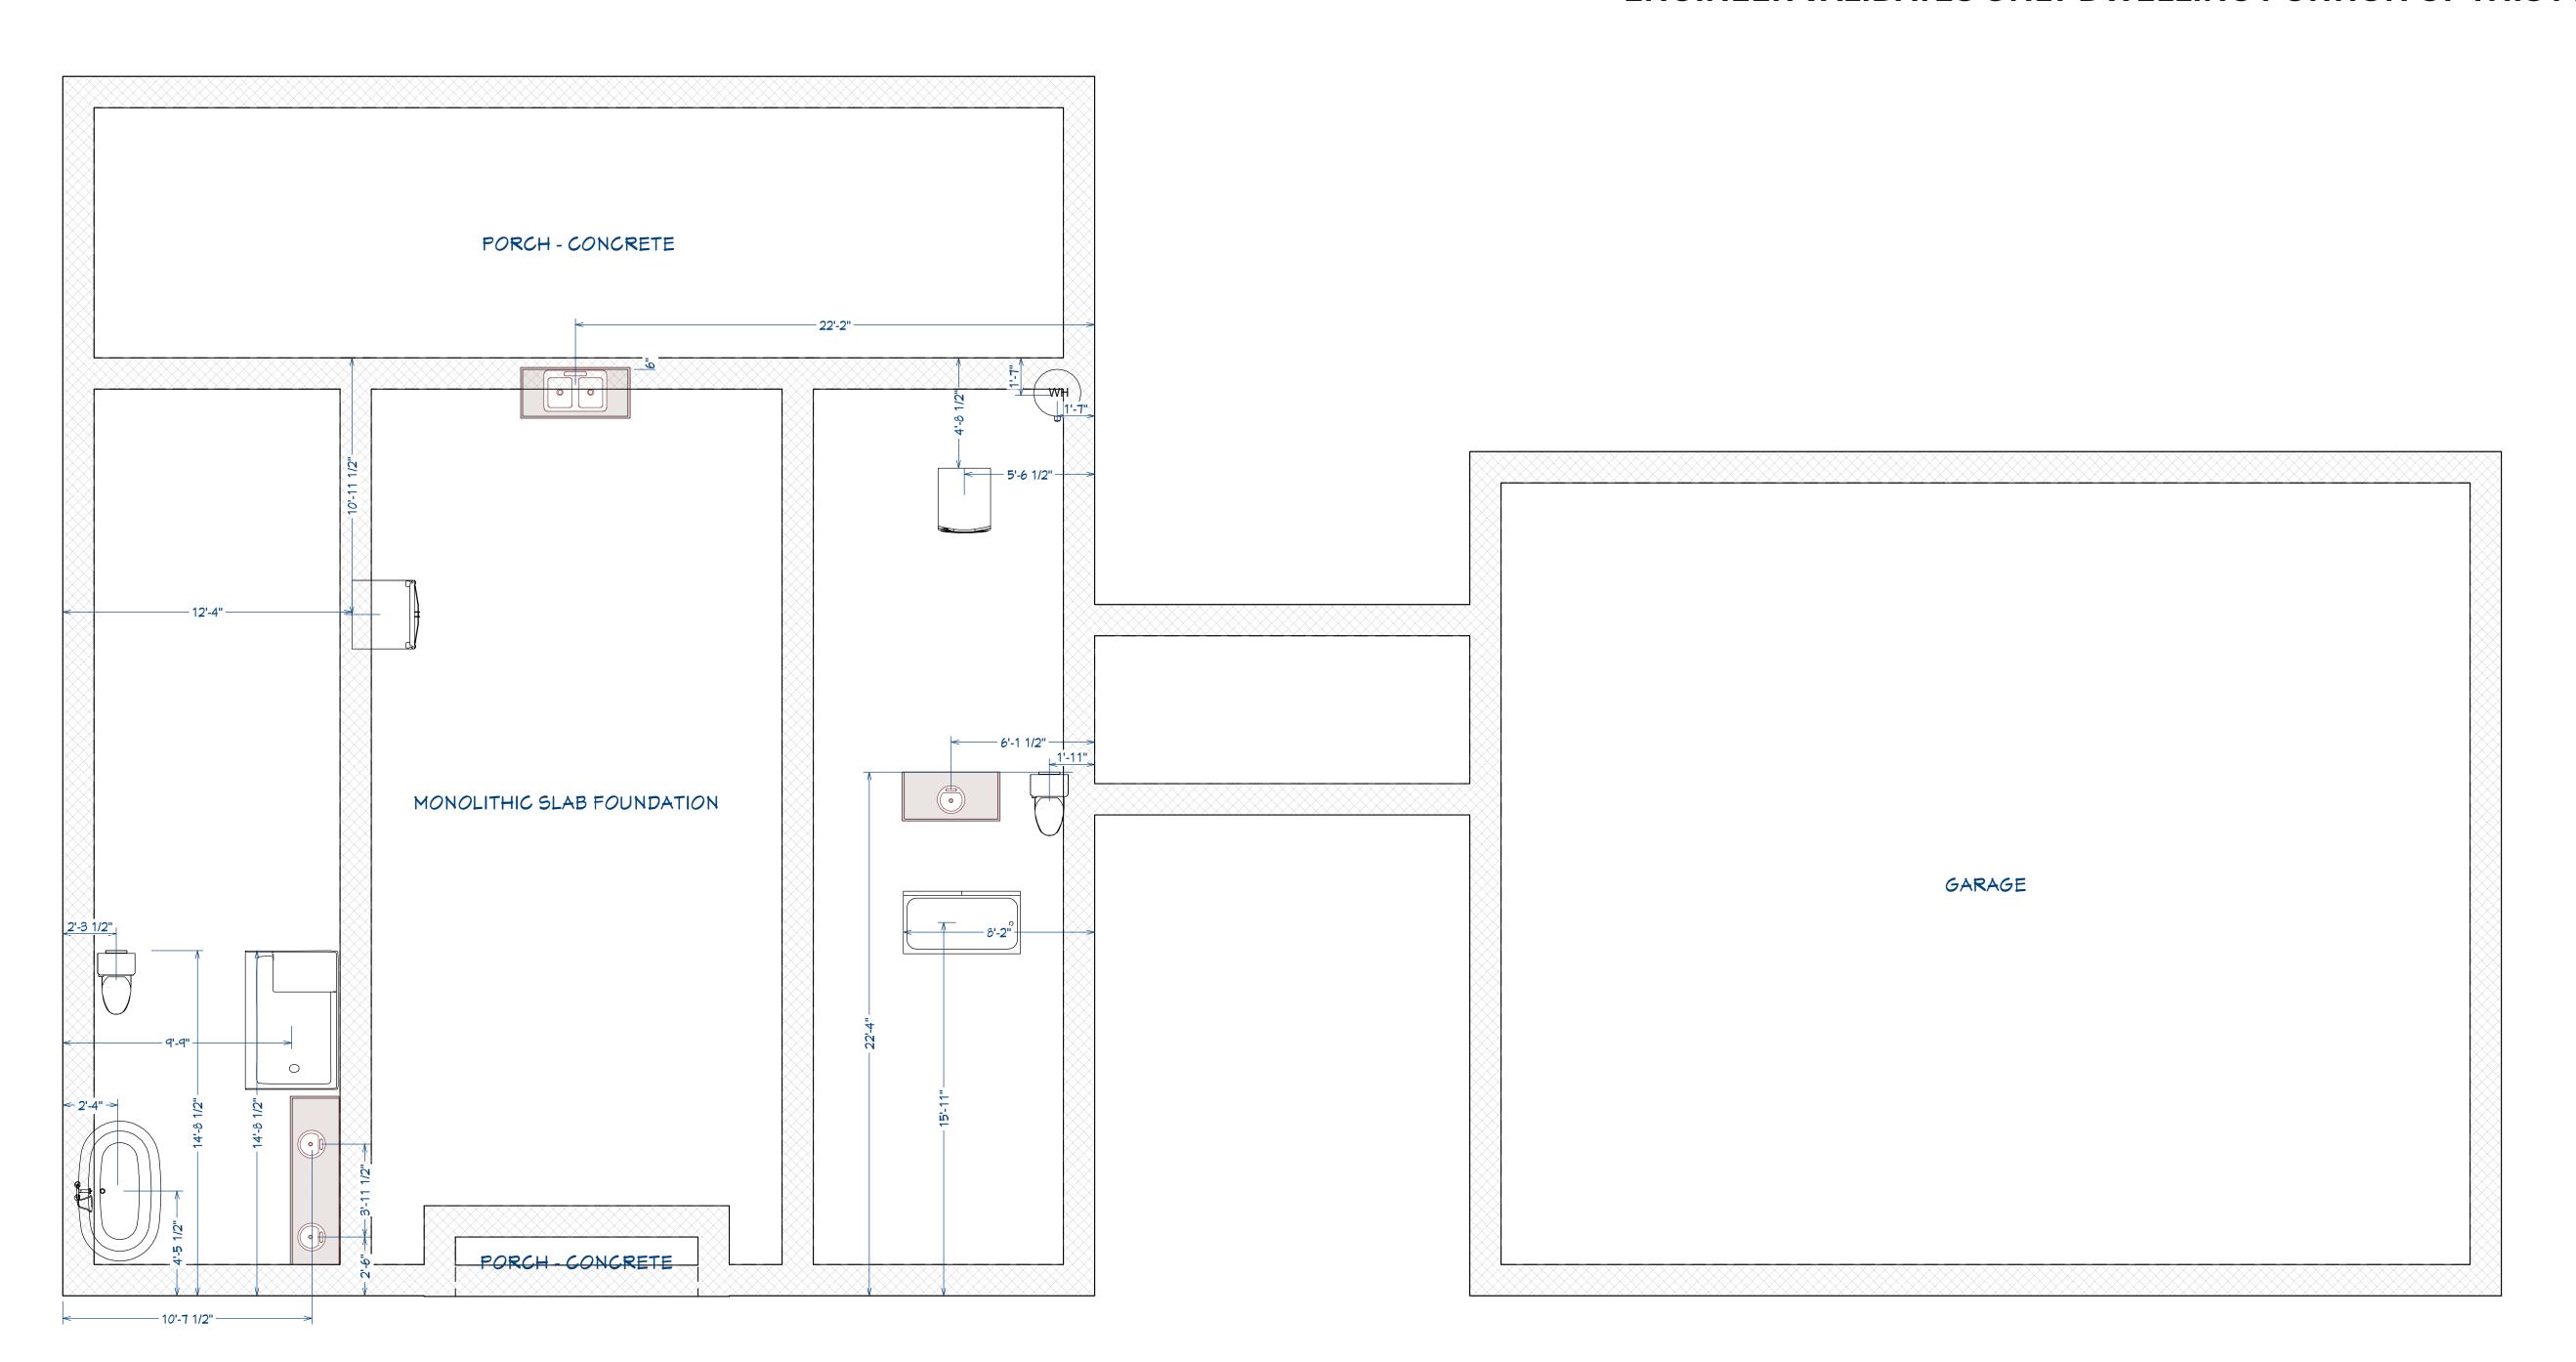

CLIENT:
Refer to the name on the one-time build license

PROJECT TITLE:

COPYRIGHT:

BuildMax.com copyright 2021 Architectural works are protected by U.S. copyright law, specifically by 17 U.S. Code § 102(8).

CONTRACTOR SHALL CHECK
AND VERIFY ALL DIMENSIONS
BEFORE BEGINNING
CONSTRUCTION AND
COORDINATE ANY
CORRECTIONS OR REVISIONS
WITH THE OWNER AND
DESIGNER. BUILDMAX WILL
ASSUME NO LIABILITY FOR
ANY ERRORS ONCE THE
CONSTRUCTION BEGINS.

REVISION TABLE
NO. DATE DESCRIPTION

ET NUMBER


FILE NUMBER: BM2085

DATE: 12/2/2022

SCALE: WHEN PRINTED 24X36

1/4" = 1'-0"

SHEET NO.

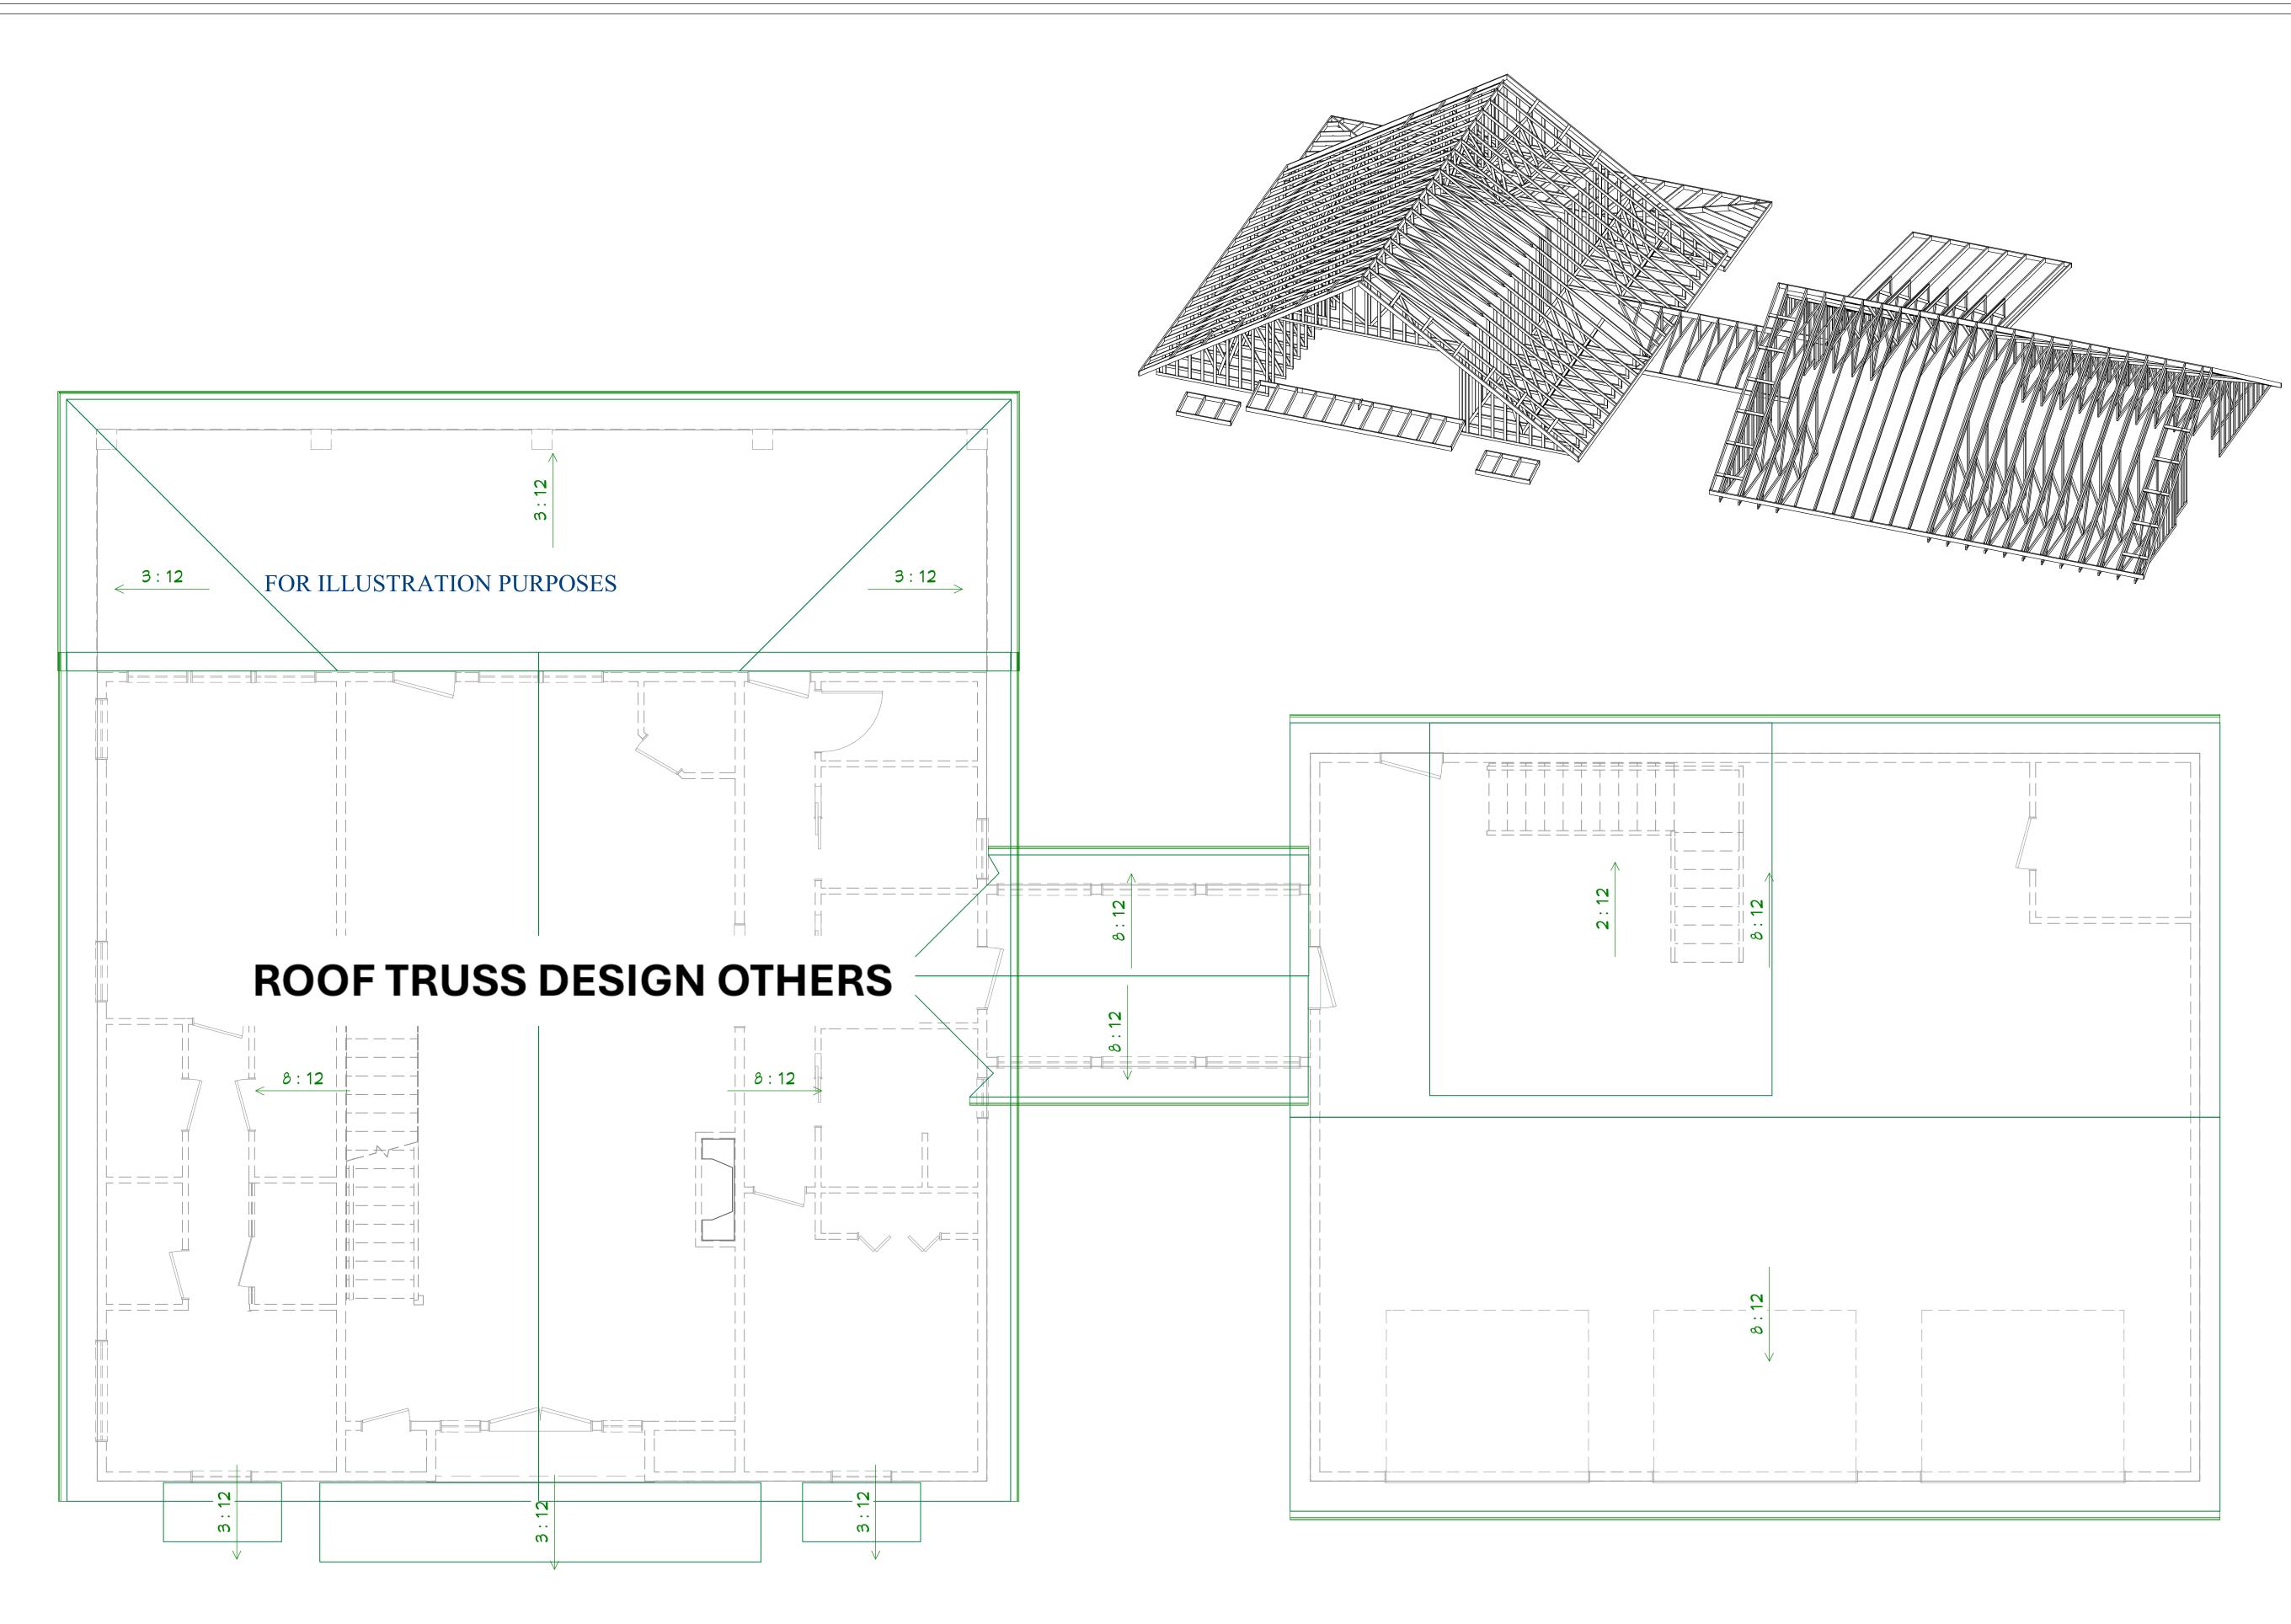

#### ROOF & FRAMING NOTES:

- 1. ROOF FRAMING AND ROOF TRUSS LAYOUT IS FOR ILLUSTRATION ONLY. ALL FRAMING SHALL BE INSTALLED & BRACED TO
- MANUFACTURER'S DRAWINGS & SPECIFICATIONS.
- 2. ALL TRUSSES OR TJI'S SHALL CARRY MANUFACTURER'S STAMP 3. TRUSSES OR TJI'S SHALL NOT BE FIELD ALTERED WITHOUT PRIOR ENGINEERING APPROVAL BY TRUSS MANUFACTURER.
- 4. ALL TRUSSES OR TJI'S SHALL HAVE DESIGN DETAILS & DRAWINGS ON SITE FOR FRAMING INSPECTION.
- 5. ALL CONNECTIONS OF RAFTERS, JACK OR HIP TRUSSES TO MAIN GIRDER TO BE PROVIDED BY TRUSS MANUFACTURER.

**ROOF PLAN** 

1/4"=1'-0"



BuildMax Contact: tony@buildmax.com

CLIENT: Refer to the name on the onetime build license

PROJECT TITLE:

COPYRIGHT:

BuildMax.com copyright 2021 Architectural works are protected by U.S. copyright law, specifically by 17 U.S. Code § 102(8).

#### NOTES:

CONTRACTOR SHALL CHECK AND VERIFY ALL DIMENSIONS BEFORE BEGINNING CONSTRUCTION AND COORDINATE ANY CORRECTIONS OR REVISIONS WITH THE OWNER AND DESIGNER. BUILDMAX WILL ASSUME NO LIABILITY FOR ANY ERRORS ONCE THE CONSTRUCTION BEGINS.


REVISION TABLE NO. DATE DESCRIPTION


FILE NUMBER: BM2085


DATE: 12/2/2022


**SCALE:** WHEN PRINTED 24X36 1/4" = 1'-0"

SHEET NO.

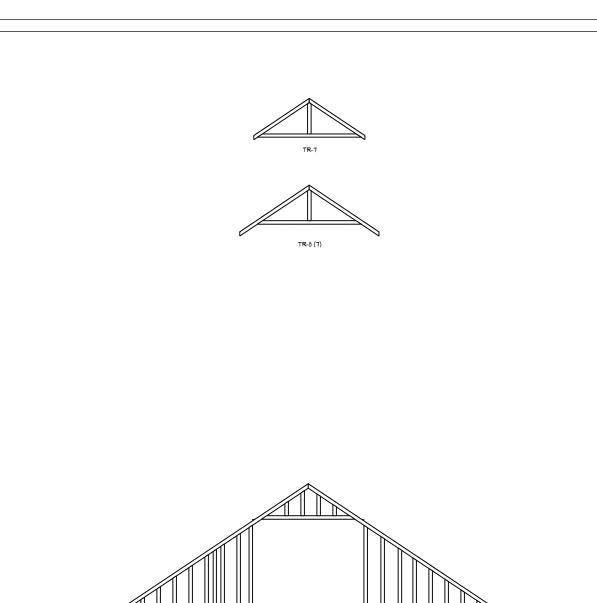


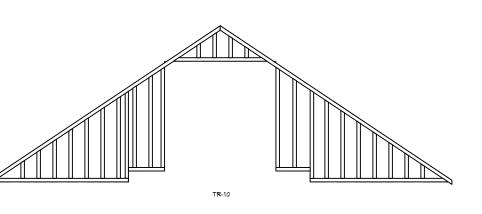

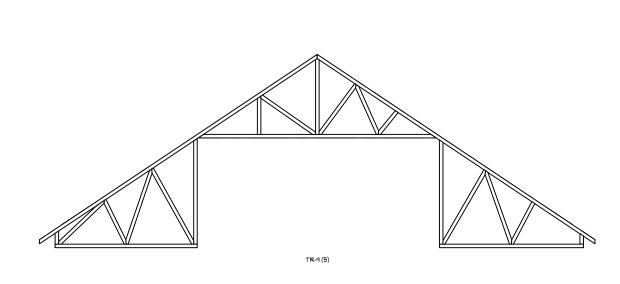


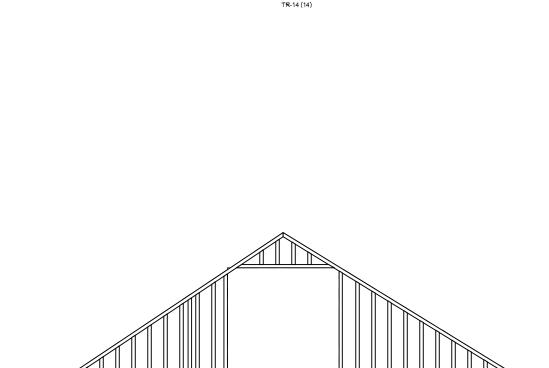

TRUSS DETAIL FOR ILLUSTRATION PURPOSES

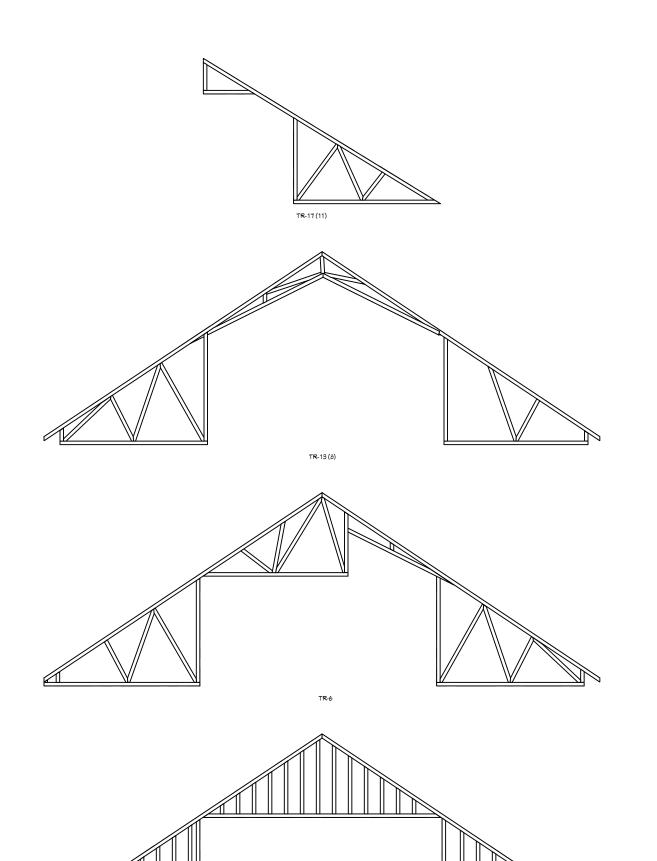

# **ROOF TRUSS DESIGN OTHERS**

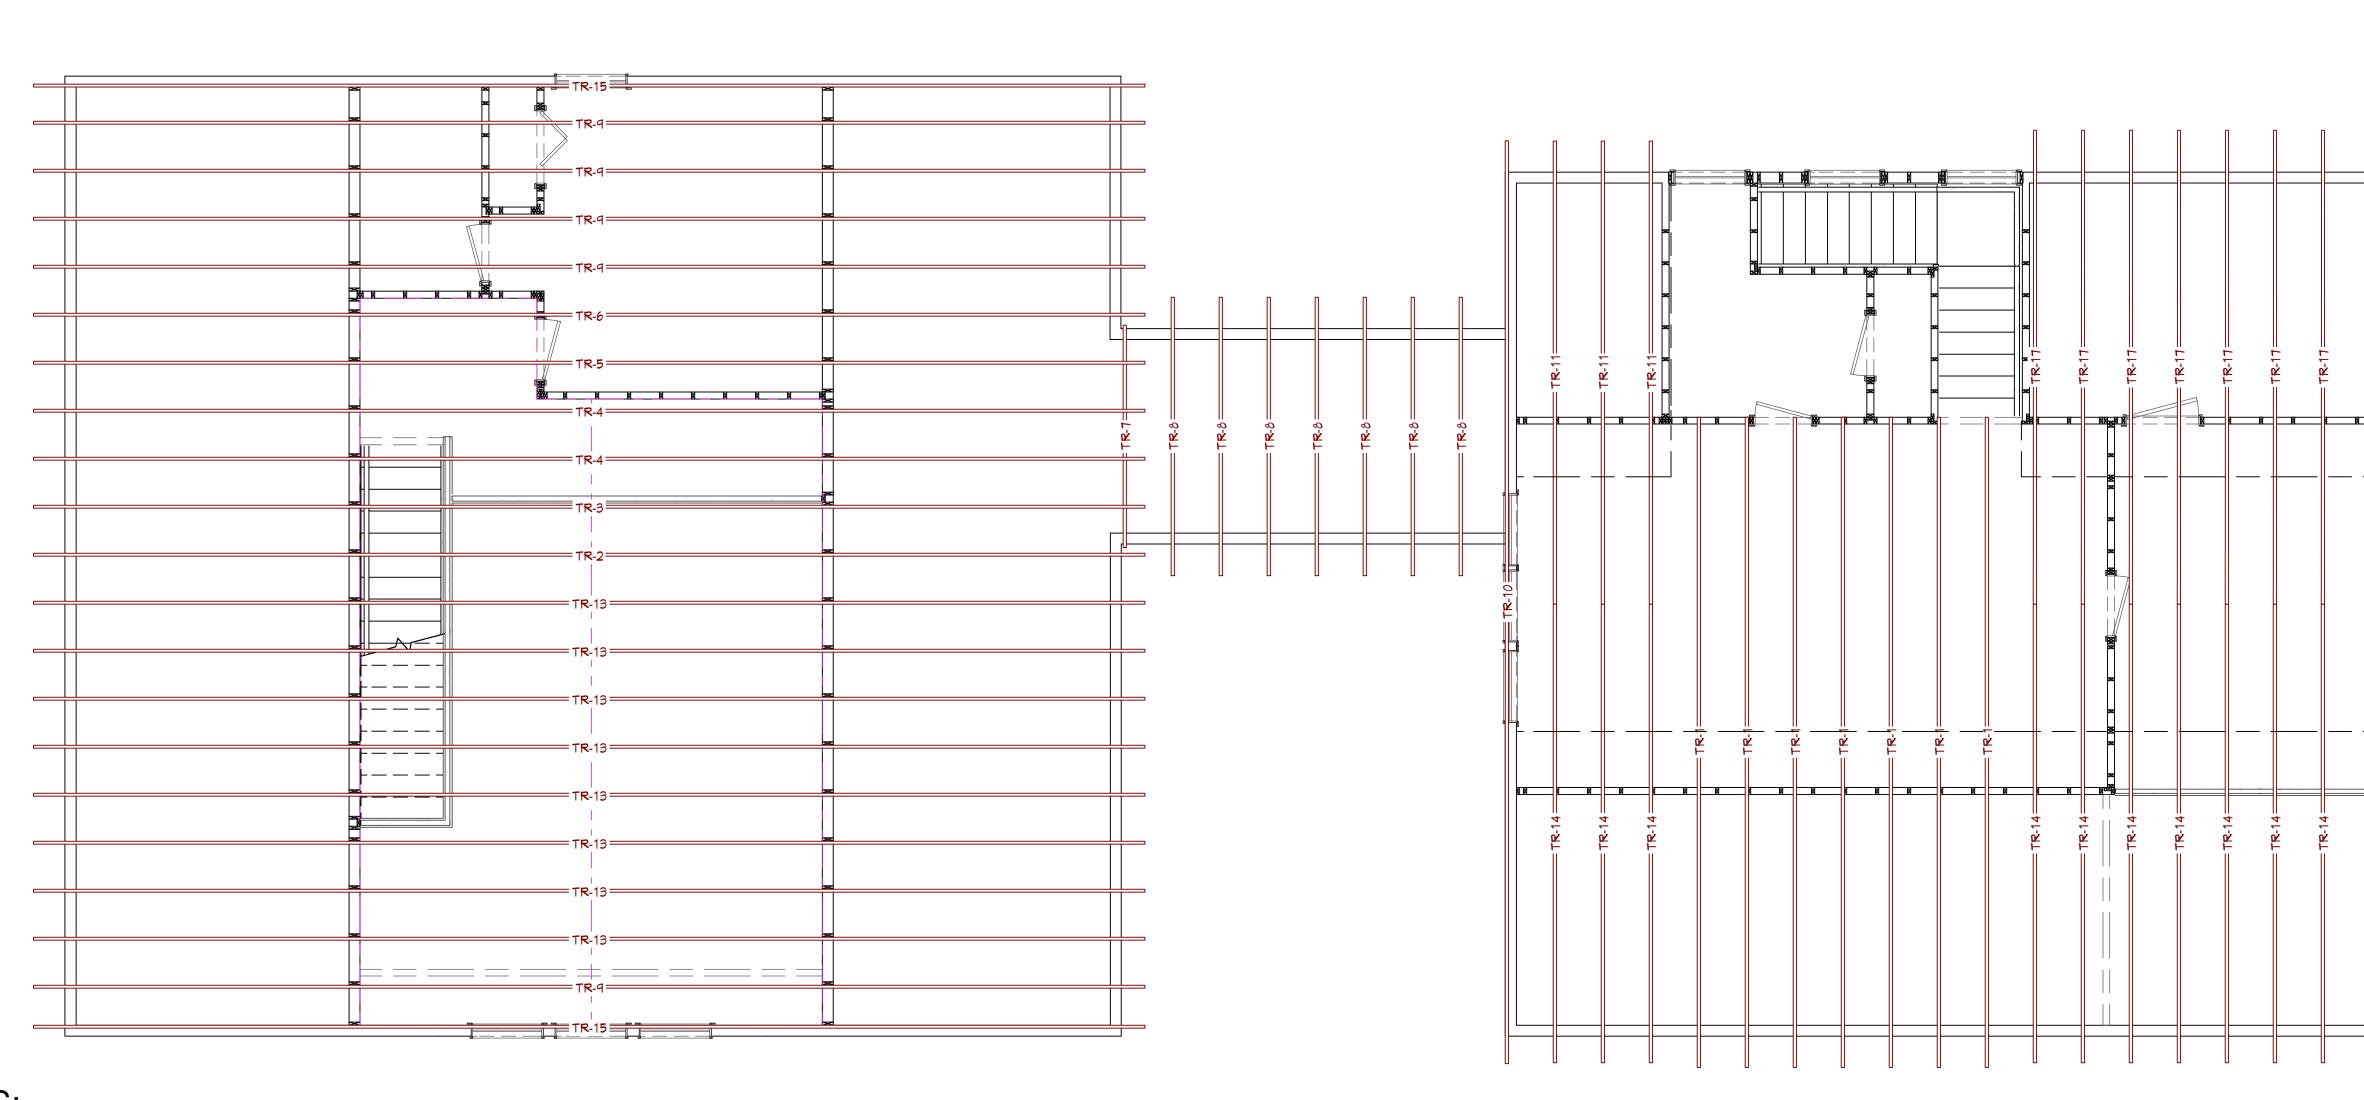

#### ROOF & FRAMING NOTES:

- 1. ROOF FRAMING AND ROOF TRUSS LAYOUT IS FOR ILLUSTRATION ONLY. ALL FRAMING SHALL BE INSTALLED & BRACED TO
- MANUFACTURER'S DRAWINGS & SPECIFICATIONS.
- 2. ALL TRUSSES OR TJI'S SHALL CARRY MANUFACTURER'S STAMP 3. TRUSSES OR TJI'S SHALL NOT BE FIELD ALTERED WITHOUT PRIOR ENGINEERING APPROVAL BY TRUSS MANUFACTURER.
- 4. ALL TRUSSES OR TJI'S SHALL HAVE DESIGN DETAILS & DRAWINGS ON SITE FOR FRAMING INSPECTION.
- 5. ALL CONNECTIONS OF RAFTERS, JACK OR HIP TRUSSES TO MAIN GIRDER TO BE PROVIDED BY TRUSS MANUFACTURER.

**ROOF PLAN** 

1/4"=1'-0"



BuildMax Contact: tony@buildmax.com

CLIENT: Refer to the name on the onetime build license

PROJECT TITLE:

COPYRIGHT:

BuildMax.com copyright 2021 Architectural works are protected by U.S. copyright law, specifically by 17 U.S. Code § 102(8).

NOTES: CONTRACTOR SHALL CHECK AND VERIFY ALL DIMENSIONS
BEFORE BEGINNING CONSTRUCTION AND
COORDINATE ANY
CORRECTIONS OR REVISIONS
WITH THE OWNER AND
DESIGNER. BUILDMAX WILL
ASSUME NO LIABILITY FOR
ANY ERRORS ONCE THE
CONSTRUCTION BEGINS.

REVISION TABLE
NO. DATE DESCRIPTION


**FILE NUMBER: BM2085** 

DATE: 12/2/2022

**SCALE:** WHEN PRINTED 24X36 1/4" = 1'-0"

SHEET NO.

# FRONT VIEW OF FRAMING

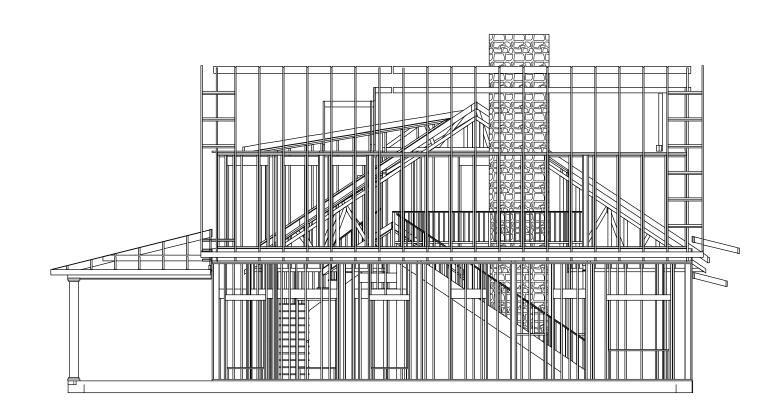

## LEFT VIEW OF FRAMING

#### **GENERAL NOTES:**

- 1) THESE DRAWINGS ARE DIAGRAMMATIC ONLY, FOR ESTABLISHING RELATIONSHIP AND DIMENSIONAL INTENTS. EACH
- ) THE GENERAL CONTRACTOR SHALL BE RESPONSIBLE FOR FOLLOWING ALL BUILDING CODE & LOCAL ORDINANC
- 2) THE GENERAL CONTRACTOR SHALL BE RESPONSIBLE FOR FOLLOWING ALL BUILDING CODE & LOCAL ORDINANCES.
  3) THESE DRAWINGS ARE THE GRAPHIC AND PICTORIAL TOOL FOR ASSISTING THE GENERAL CONTRACTOR IN HIS BIDDING
  PROCESS BUT DOES NOT ASSUME RESPONSIBILITY FOR ERRORS AND/OR OMISSIONS IN THE GENERAL CONTRACTORS BID. IT
  IS THE RESPONSIBILITY OF THE GENERAL CONTRACTOR TO PERFORM AN ON-SITE INSPECTION TO COVER ANY ITEMS NOT
  INDICATED ON THESE DRAWINGS.
- 4) THE GENERAL CONTRACTOR SHALL VERIFY ALL DIMENSIONS AND CONDITIONS IN THE FILE FOR ANY DISCREPANCIES BETWEE
  THE ACTUAL CONDITIONS AND DRAWINGS. IF IN THE COURSE OF CONSTRUCTION, A CONDITION EXISTS WHICH DISAGREES
  WITH THAT AS INDICATED ON THESE PLANS, THE GENERAL CONTRACTOR SHALL MAKE CHANGES THAT COMPLY WITH I.R.C.
- 5) THE DESIGNER SHALL NOT BE HELD RESPONSIBLE FOR ANY MATERIALS, WORKMANSHIP, MEANS OR METHODS OF
- 6) THE DESIGNER SHALL NOT BE HELD RESPONSIBLE FOR THOSE SUPERVISION OF CONSTRUCTION, AND IS NOT RESPONSIBLE

FOR ANY CHANGES WITHOUT PRIOR NOTIFICATION.
7) ALL BEAM SIZES AND ROOF TRUSSES TO BE VERIFIED BY STRUCTURAL ENGINEE

# EXTERIOR WALL FRAMING PLAN 1

# uildMax

BuildMax Contact: tony@buildmax.com

CLIENT:
Refer to the name on the one-time build license

PROJECT TITLE:

COPYRIGHT:

BuildMax.com copyright 2021 Architectural works are protected by U.S. copyright law, specifically by 17 U.S. Code § 102(8).

#### NOTES:

CONTRACTOR SHALL CHECK
AND VERIFY ALL DIMENSIONS
BEFORE BEGINNING
CONSTRUCTION AND
COORDINATE ANY
CORRECTIONS OR REVISIONS
WITH THE OWNER AND
DESIGNER. BUILDMAX WILL
ASSUME NO LIABILITY FOR
ANY ERRORS ONCE THE
CONSTRUCTION BEGINS.

REVISION TABLE
NO. DATE DESCRIPTION

EET NUMBER
KTERIOR WALL FRAMING

FILE NUMBER: BM2085

DATE: 12/2/2022


SCALE: WHEN PRINTED 24X36

1/8' = 1'-0"


SHEET NO.

**A-10** 


#### **ENGINEER VALIDATES ONLY DWELLING PORTION OF THIS PLAN**

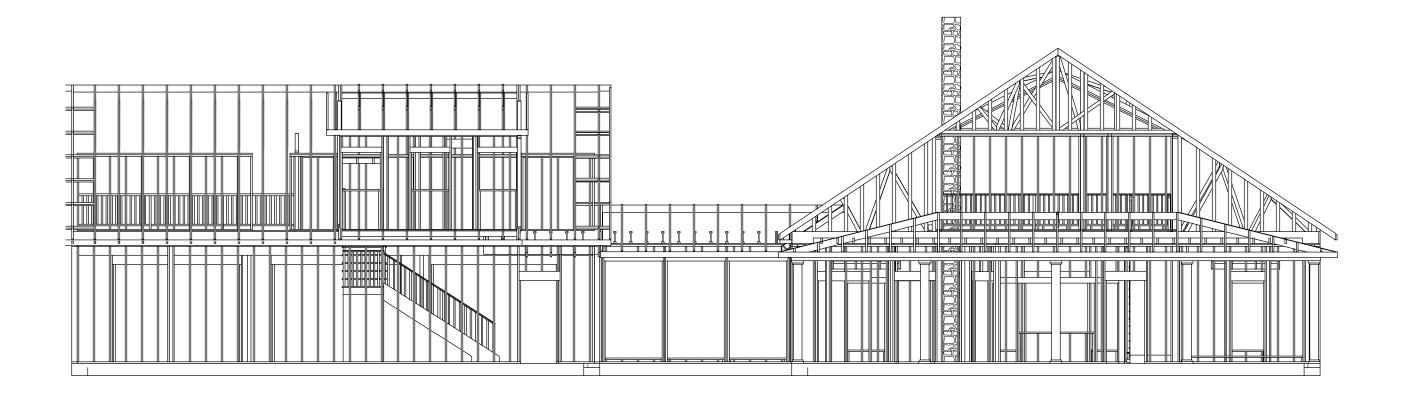


# REAR VIEW OF FRAMING

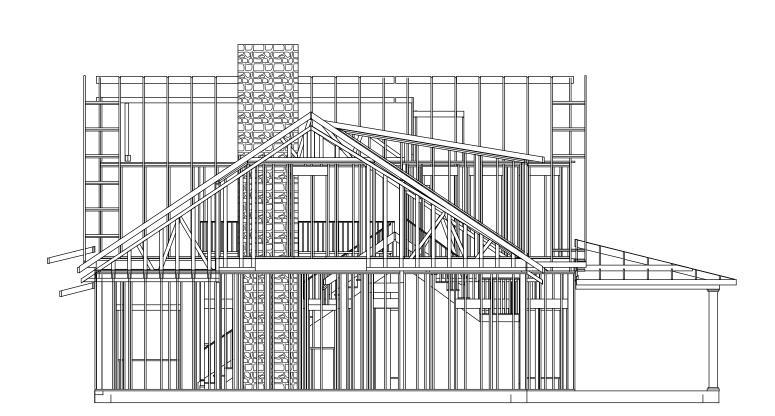

RIGHT VIEW OF FRAMING

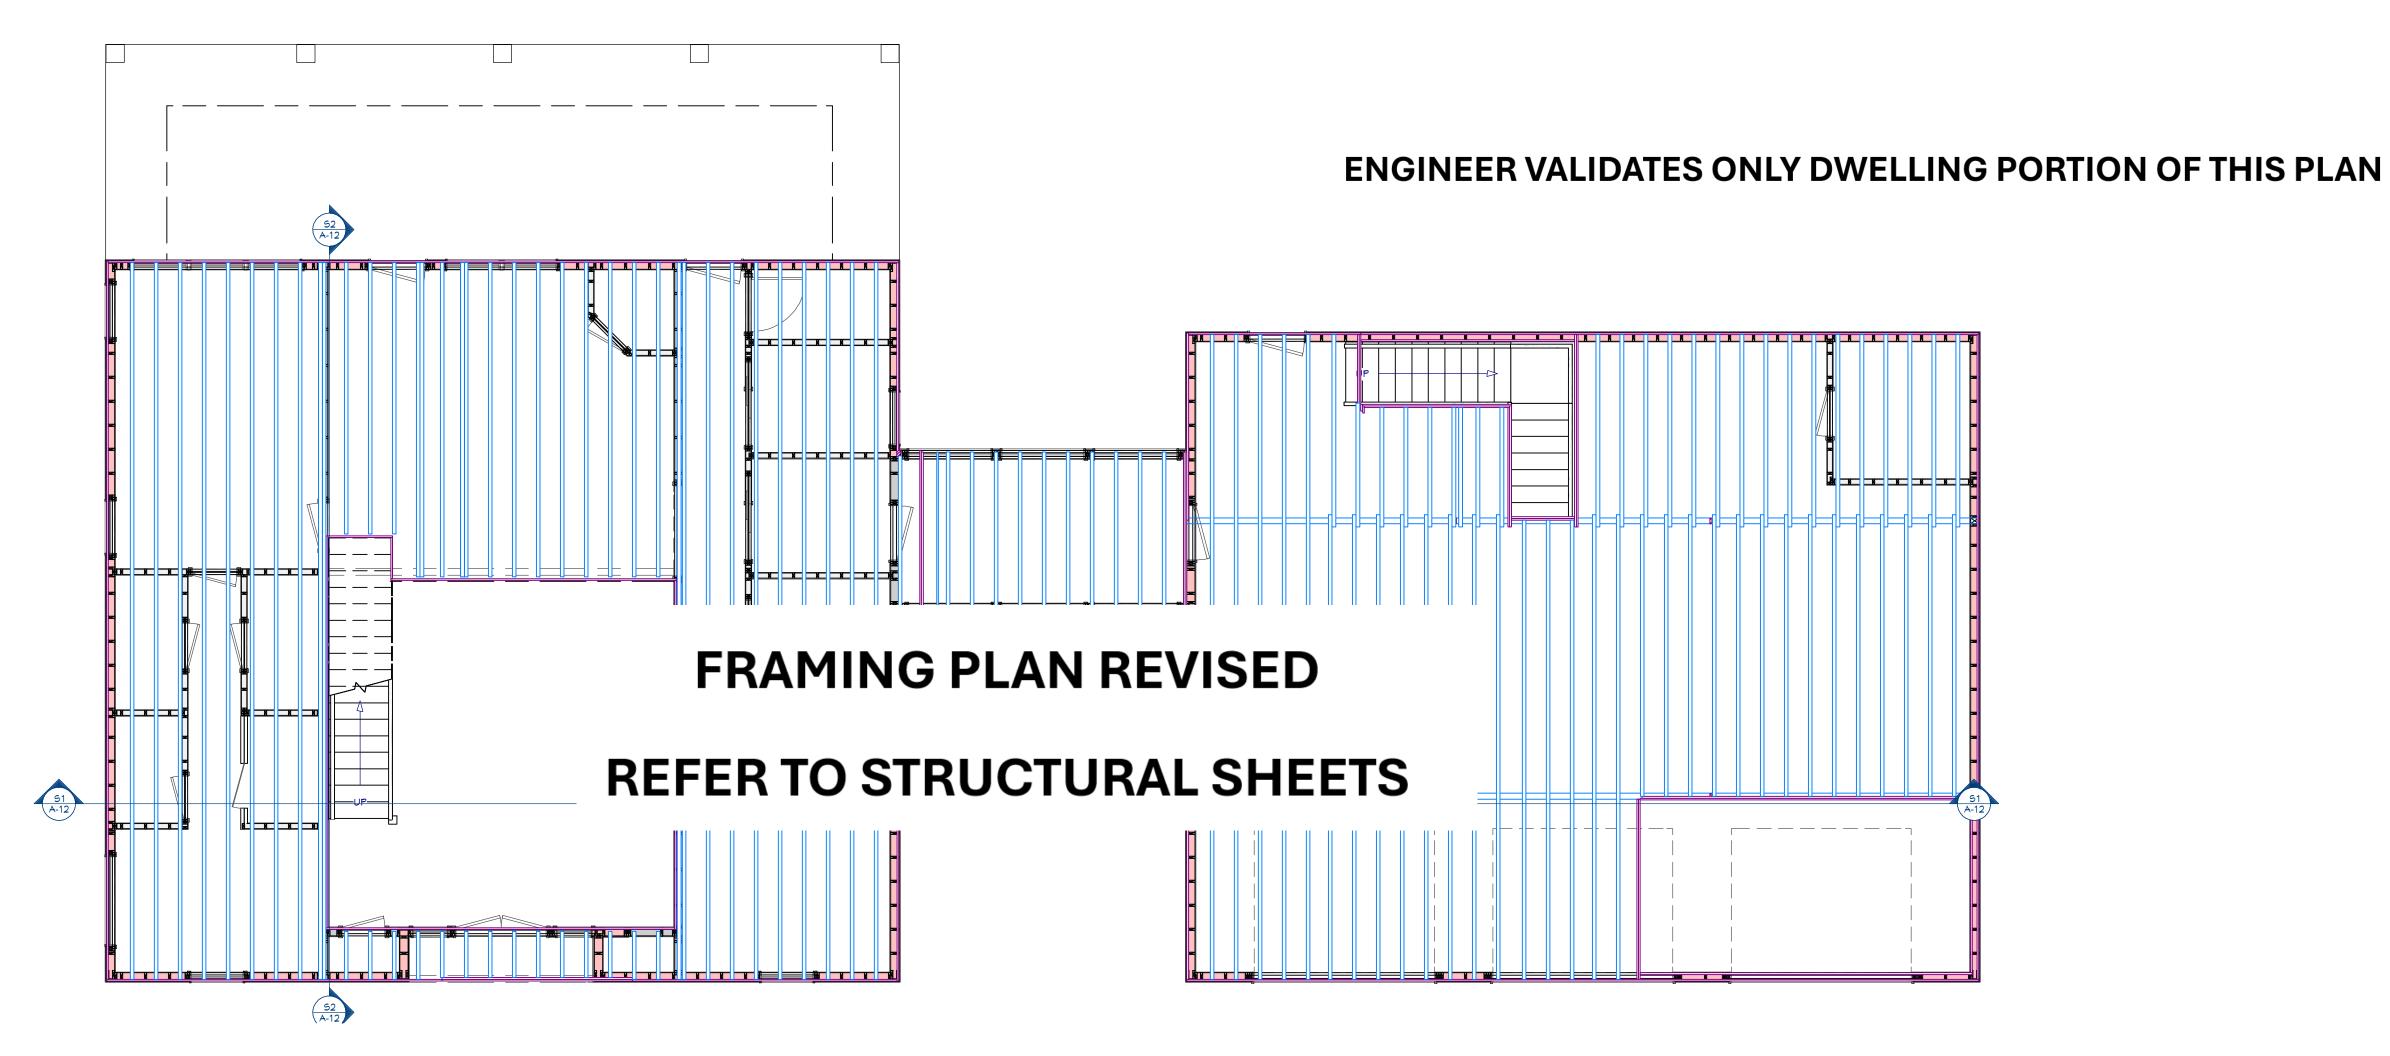

## FIRST FLOOR FRAMING PLAN

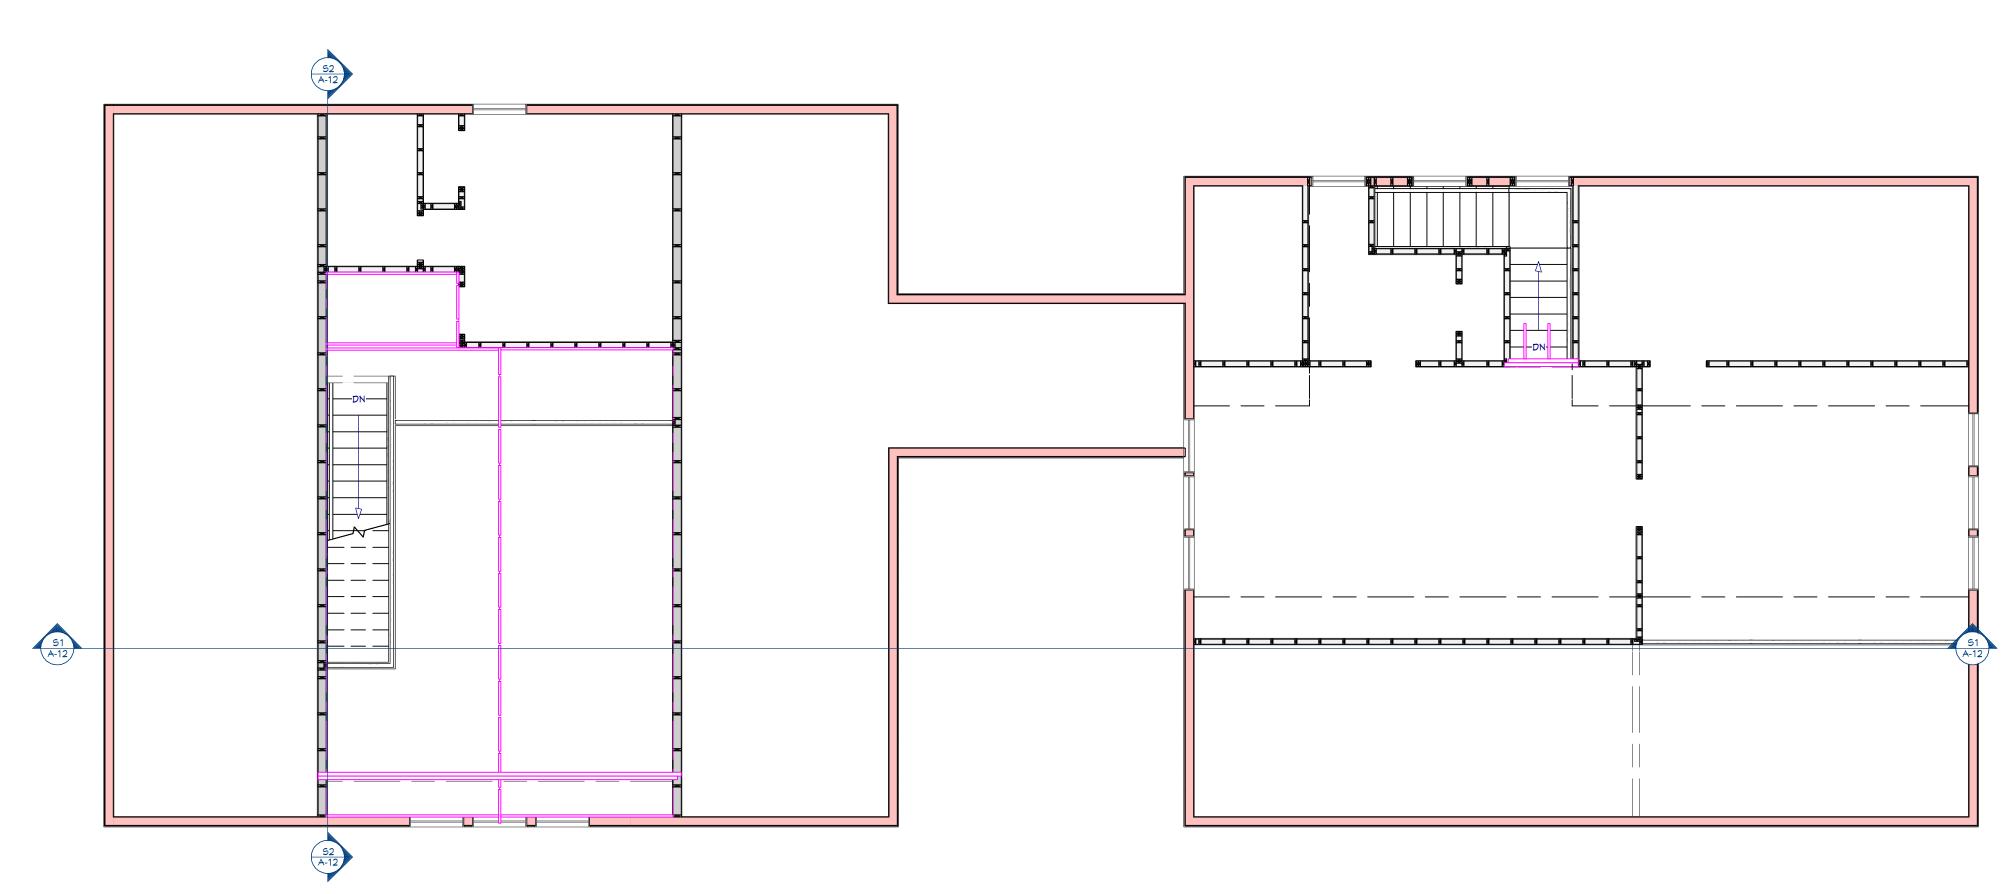

#### I-JOIST LAYOUT

- 1. I-JOIST LAYOUT IS FOR ILLUSTRATION ONLY AND A STRUCTURAL ENGINEER OR I-JOIST/FLOOR TRUSS MANUFACTURER MUST BE HIRED TO LAY OUT THE I-JOIST AND BEAM CONFIGURATION ACCORDING TO CODE.
- 2. HOMEOWNER SHALL HIRE THE REQUIRED STRUCTURAL ENGINEERING FIRM LVL BEAM MANUFACTURER TO DESIGN THE LVL BEAM TO HOLD THE SECOND FLOOR JOISTS.
- 3. LVL BEAM IS NOT INDICATED ON THE PLAN.
- 4. DESIGNER SHALL NOT BE HELD RESPONSIBLE FOR ANY ERRORS IN THE FLOOR JOIST LAYOUT OR BEAM CONFIGURATION THE PLAN. LVL BEAM MUST BE DESIGNED AND CONFIGURED BY A STRUCTURAL ENGINEER OR LVL MANUFACTURER ACCORDING TO LOCAL CODE

SECOND FLOOR FRAMING PLAN

FIRST & SECOND FLOOR FRAMING PLAN 3/16"=1'-0"



Contact: tony@buildmax.com

CLIENT: Refer to the name on the onetime build license

PROJECT TITLE:

COPYRIGHT:

BuildMax.com copyright 2021 Architectural works are protected by U.S. copyright law, specifically by 17 U.S. Code § 102(8).

**NOTES:** 

CONTRACTOR SHALL CHECK AND VERIFY ALL DIMENSIONS BEFORE BEGINNING CONSTRUCTION AND COORDINATE ANY CORRECTIONS OR REVISIONS WITH THE OWNER AND DESIGNER. BUILDMAX WILL ASSUME NO LIABILITY FOR ANY ERRORS ONCE THE CONSTRUCTION BEGINS.


**REVISION TABLE** NO. DATE DESCRIPTION


**FILE NUMBER: BM2085** 


DATE: 12/2/2022

**SCALE:** WHEN PRINTED 24X36 3/16" = 1'-0"

SHEET NO.

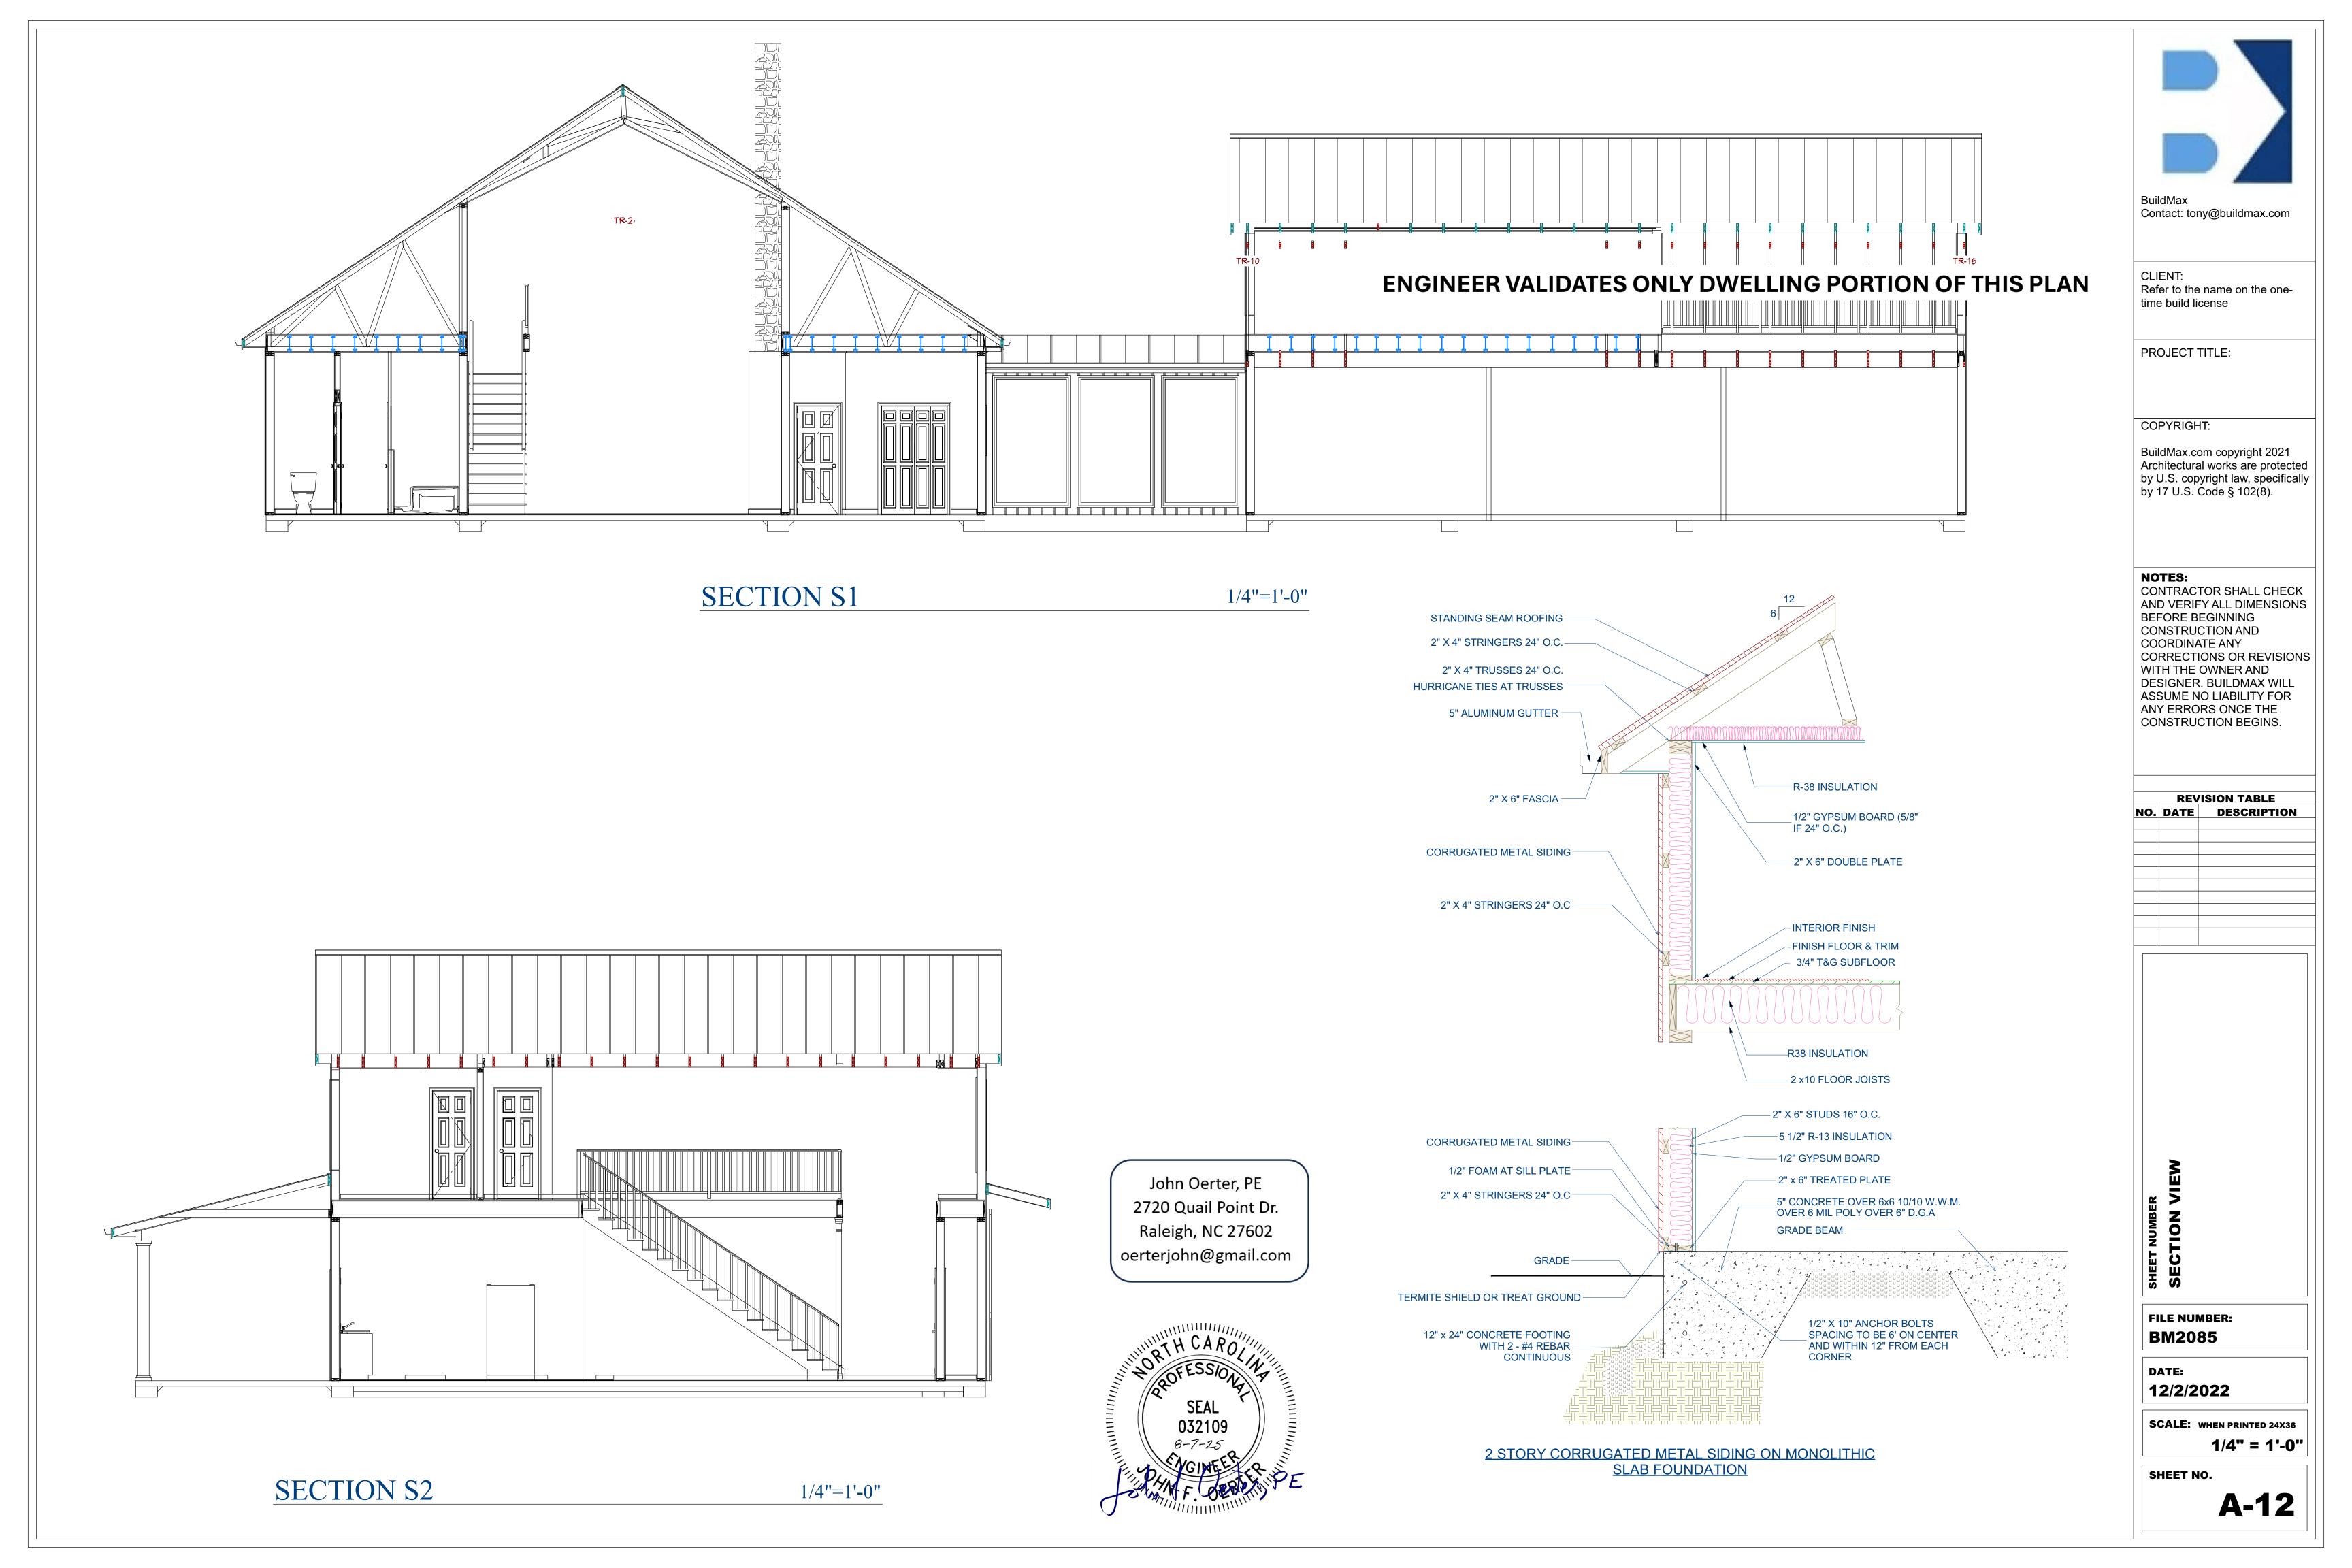

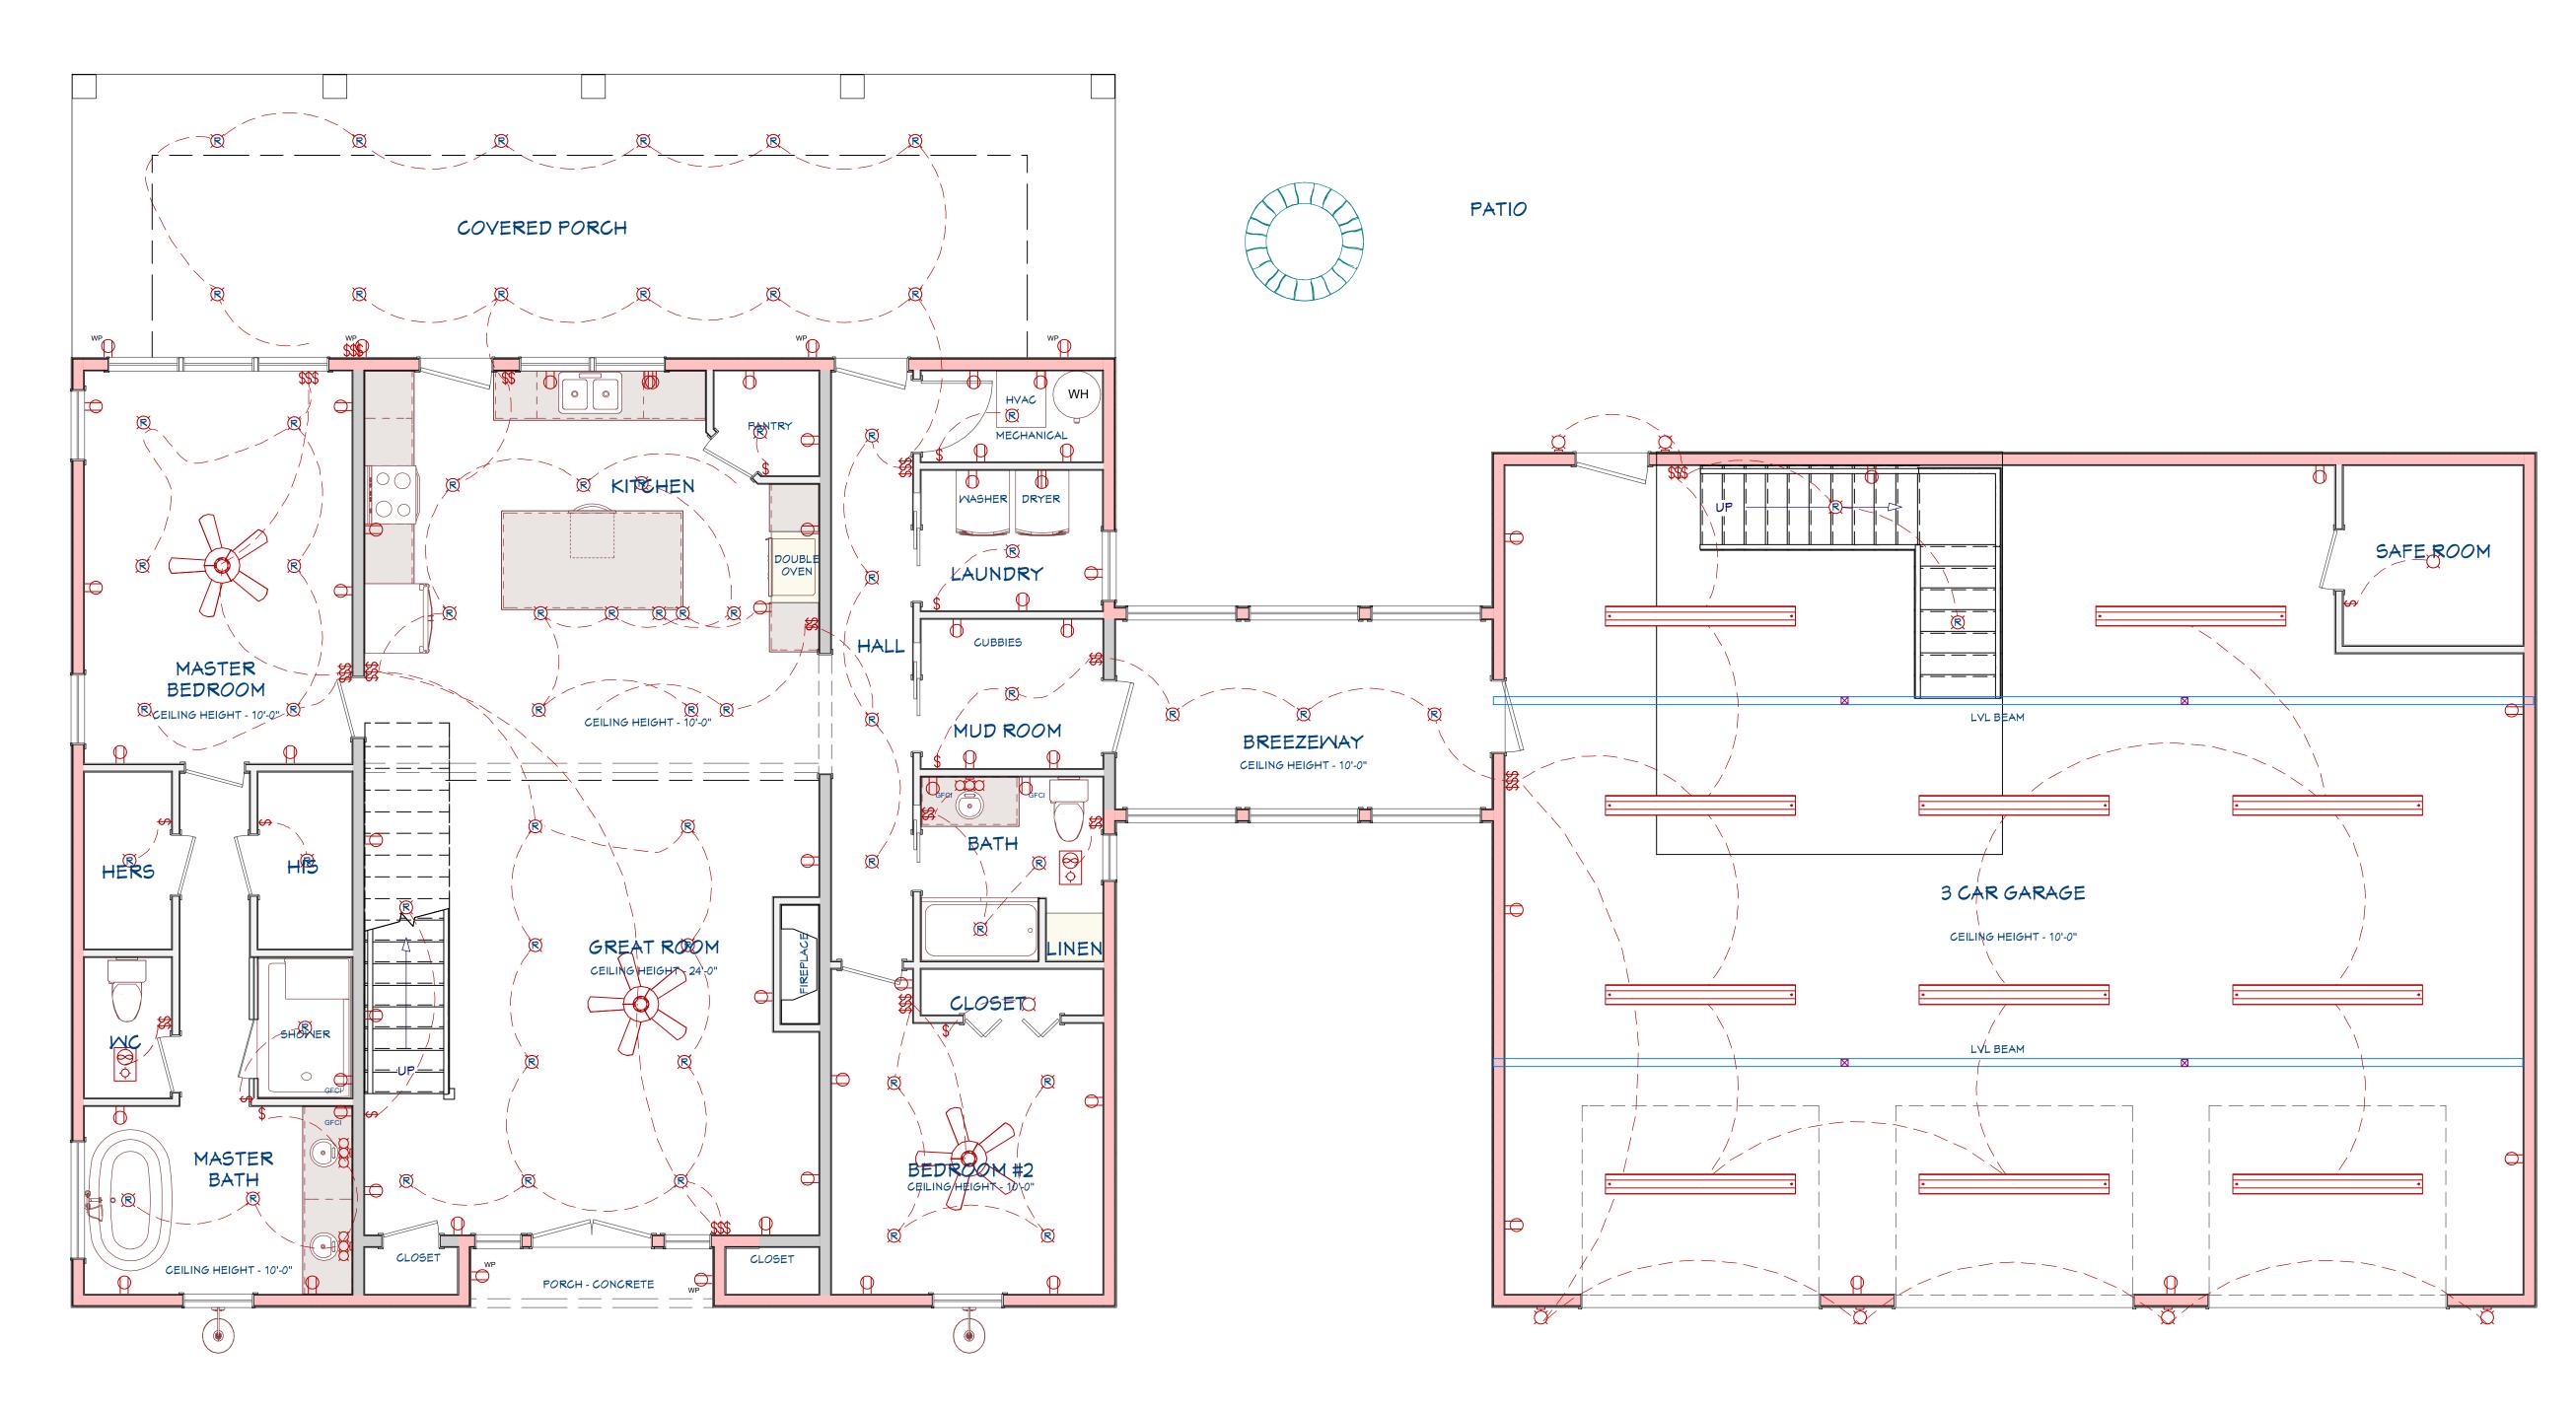

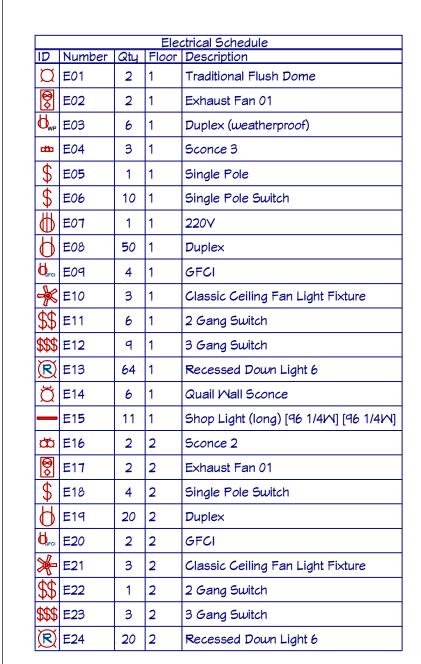

#### **Electrical Notes:**

(ELECTRICAL LAYOUT IS FOR ILLUSTRATION PURPOSES ONLY AND A LOCAL PROFESSIONAL SHALL BE HIRED TO CONFIRM

THE LAYOUT OR PROVIDE A LAYOUT THAT MEETS LOCAL CODE)

1. All work shall be done in conformance with all governing codes, including amendments, bulletins, etc. as well as standards of installation for buildings, and equipment and requirements of the Owner. 2. Coordinate all work with other trades to ensure installation is made in accordance with the contract documents. 3. Exact locations and mounting heights of all lighting fixtures, wall outlets, etc. shall be in accordance with local code and the professional on the ground shall make changes as needed.

ELECTRICAL PLAN

1/4" = 1'-0"



BuildMax Contact: tony@buildmax.com

CLIENT: Refer to the name on the onetime build license

PROJECT TITLE:

COPYRIGHT:

BuildMax.com copyright 2021 Architectural works are protected by U.S. copyright law, specifically by 17 U.S. Code § 102(8).

#### **NOTES:**

CONTRACTOR SHALL CHECK AND VERIFY ALL DIMENSIONS BEFORE BEGINNING CONSTRUCTION AND COORDINATE ANY CORRECTIONS OR REVISIONS WITH THE OWNER AND DESIGNER. BUILDMAX WILL ASSUME NO LIABILITY FOR ANY ERRORS ONCE THE CONSTRUCTION BEGINS.

REVISION TABLE NO. DATE DESCRIPTION


**FILE NUMBER:** BM2085

DATE:

12/2/2022

**SCALE:** WHEN PRINTED 24X36 1/4" = 1'-0"

SHEET NO.

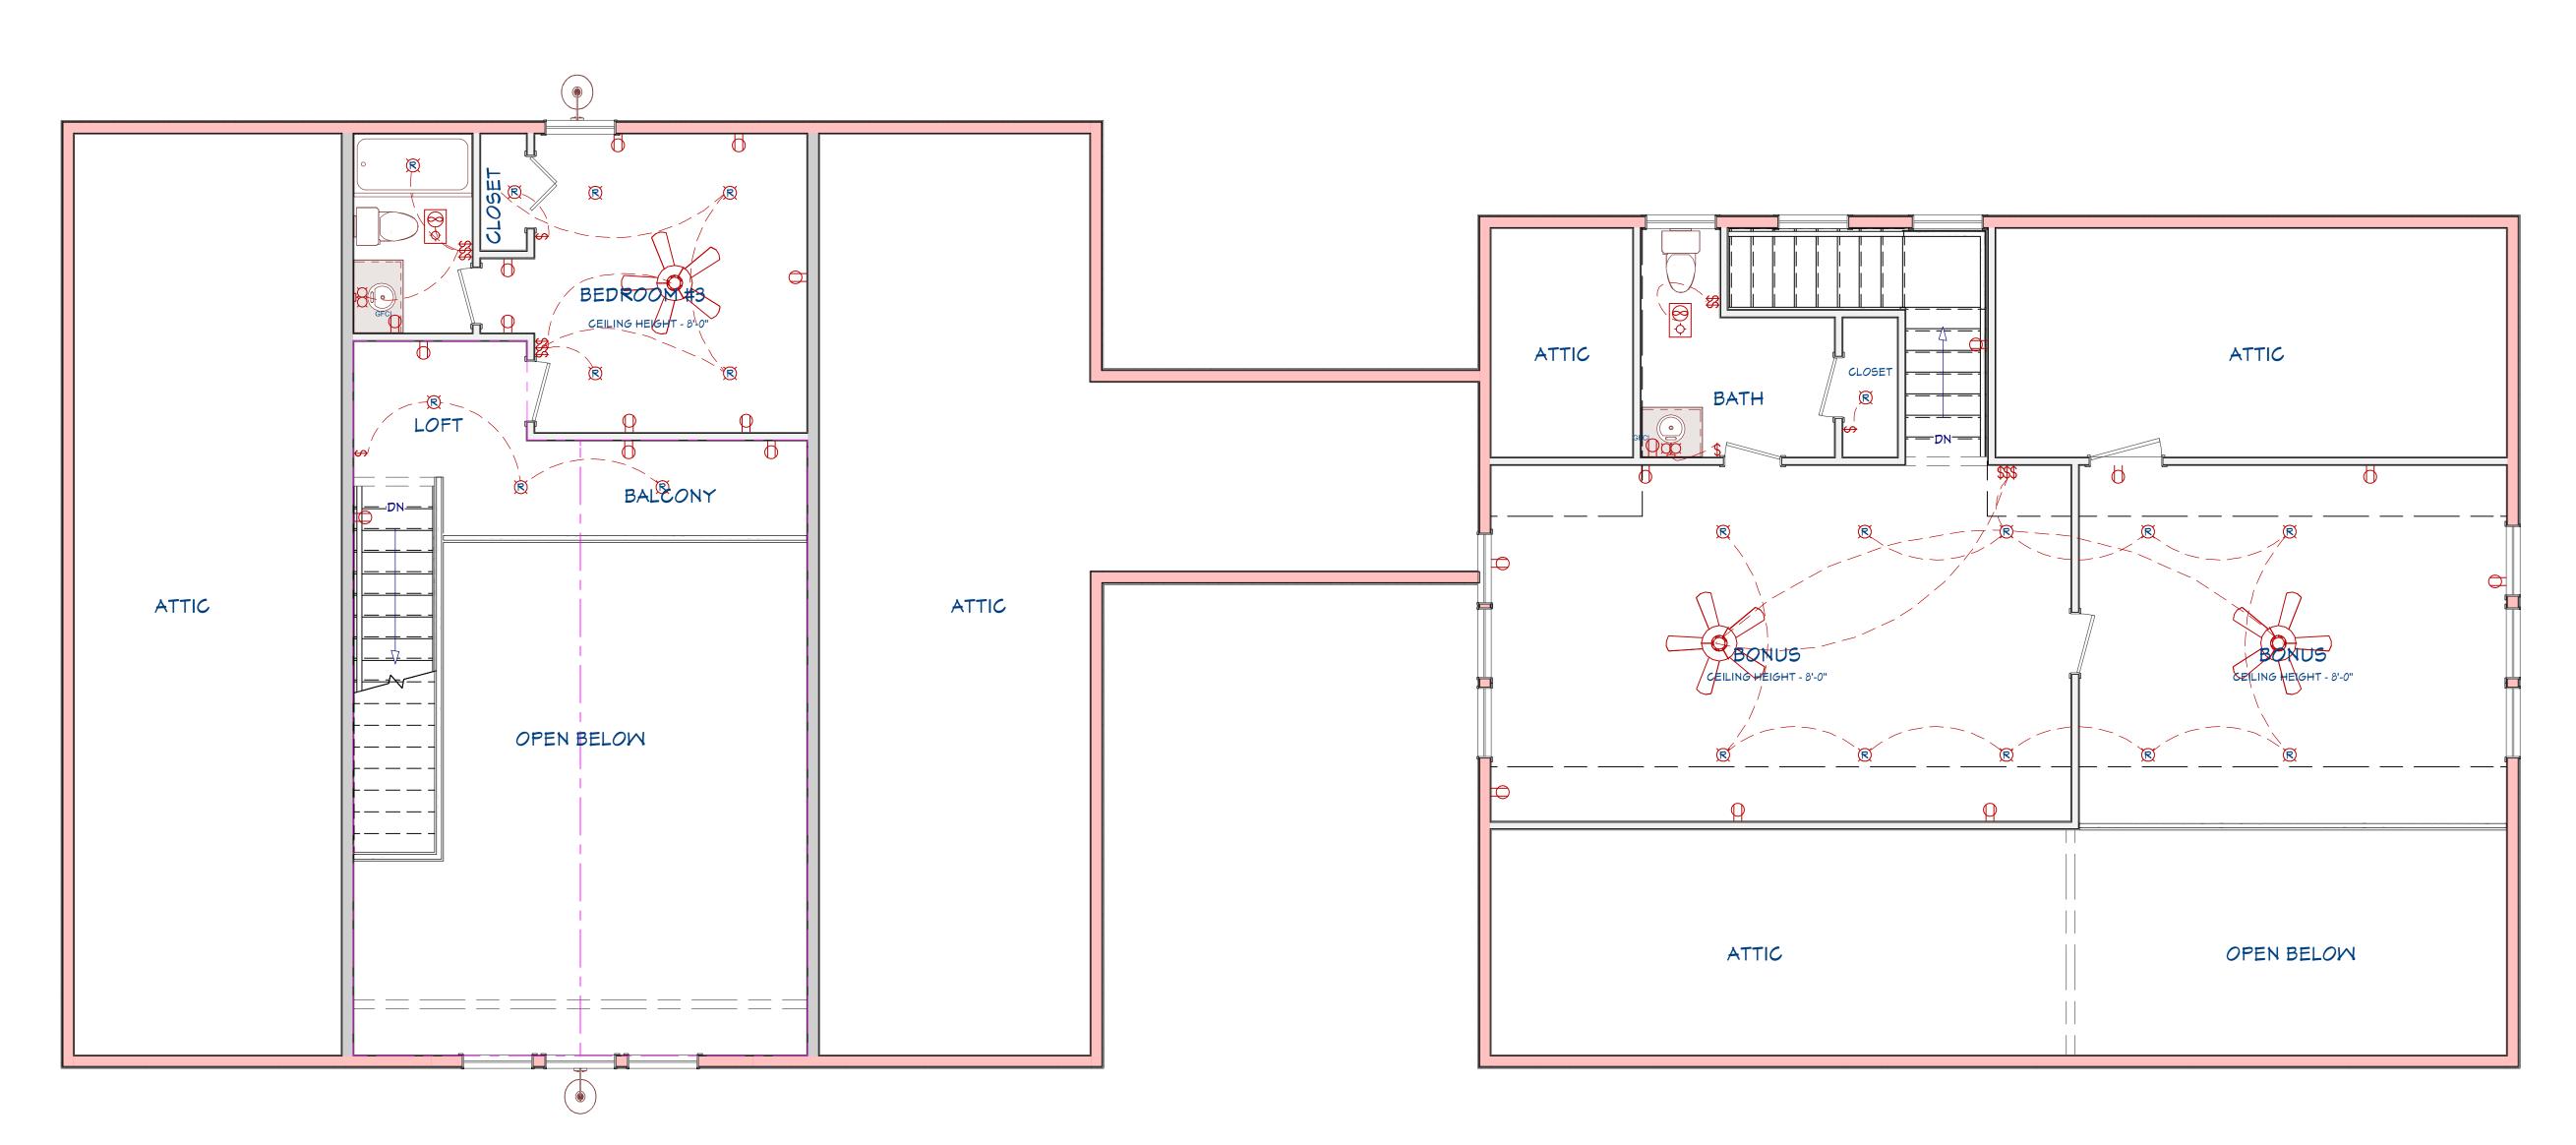



#### **Electrical Notes:**

(ELECTRICAL LAYOUT IS FOR ILLUSTRATION PURPOSES ONLY AND A LOCAL PROFESSIONAL SHALL BE HIRED TO CONFIRM

THE LAYOUT OR PROVIDE A LAYOUT THAT MEETS LOCAL CODE)

1. All work shall be done in conformance with all governing codes, including amendments, bulletins, etc. as well as standards of installation for buildings, and equipment and requirements of the Owner. 2. Coordinate all work with other trades to ensure installation is made in accordance with the contract documents. 3. Exact locations and mounting heights of all lighting fixtures, wall outlets, etc. shall be in accordance with local code and the professional on the ground shall make changes as needed.

ELECTRICAL PLAN

1/4" = 1'-0"



BuildMax Contact: tony@buildmax.com

CLIENT: Refer to the name on the onetime build license

PROJECT TITLE:

COPYRIGHT:

BuildMax.com copyright 2021 Architectural works are protected by U.S. copyright law, specifically by 17 U.S. Code § 102(8).

#### **NOTES:**

CONTRACTOR SHALL CHECK AND VERIFY ALL DIMENSIONS BEFORE BEGINNING CONSTRUCTION AND COORDINATE ANY CORRECTIONS OR REVISIONS WITH THE OWNER AND DESIGNER. BUILDMAX WILL ASSUME NO LIABILITY FOR ANY ERRORS ONCE THE CONSTRUCTION BEGINS.

**REVISION TABLE** NO. DATE DESCRIPTION


SHEET NUMBI SECOND PLAN

**FILE NUMBER:** BM2085

DATE: 12/2/2022

**SCALE:** WHEN PRINTED 24X36 1/4" = 1'-0"

SHEET NO.

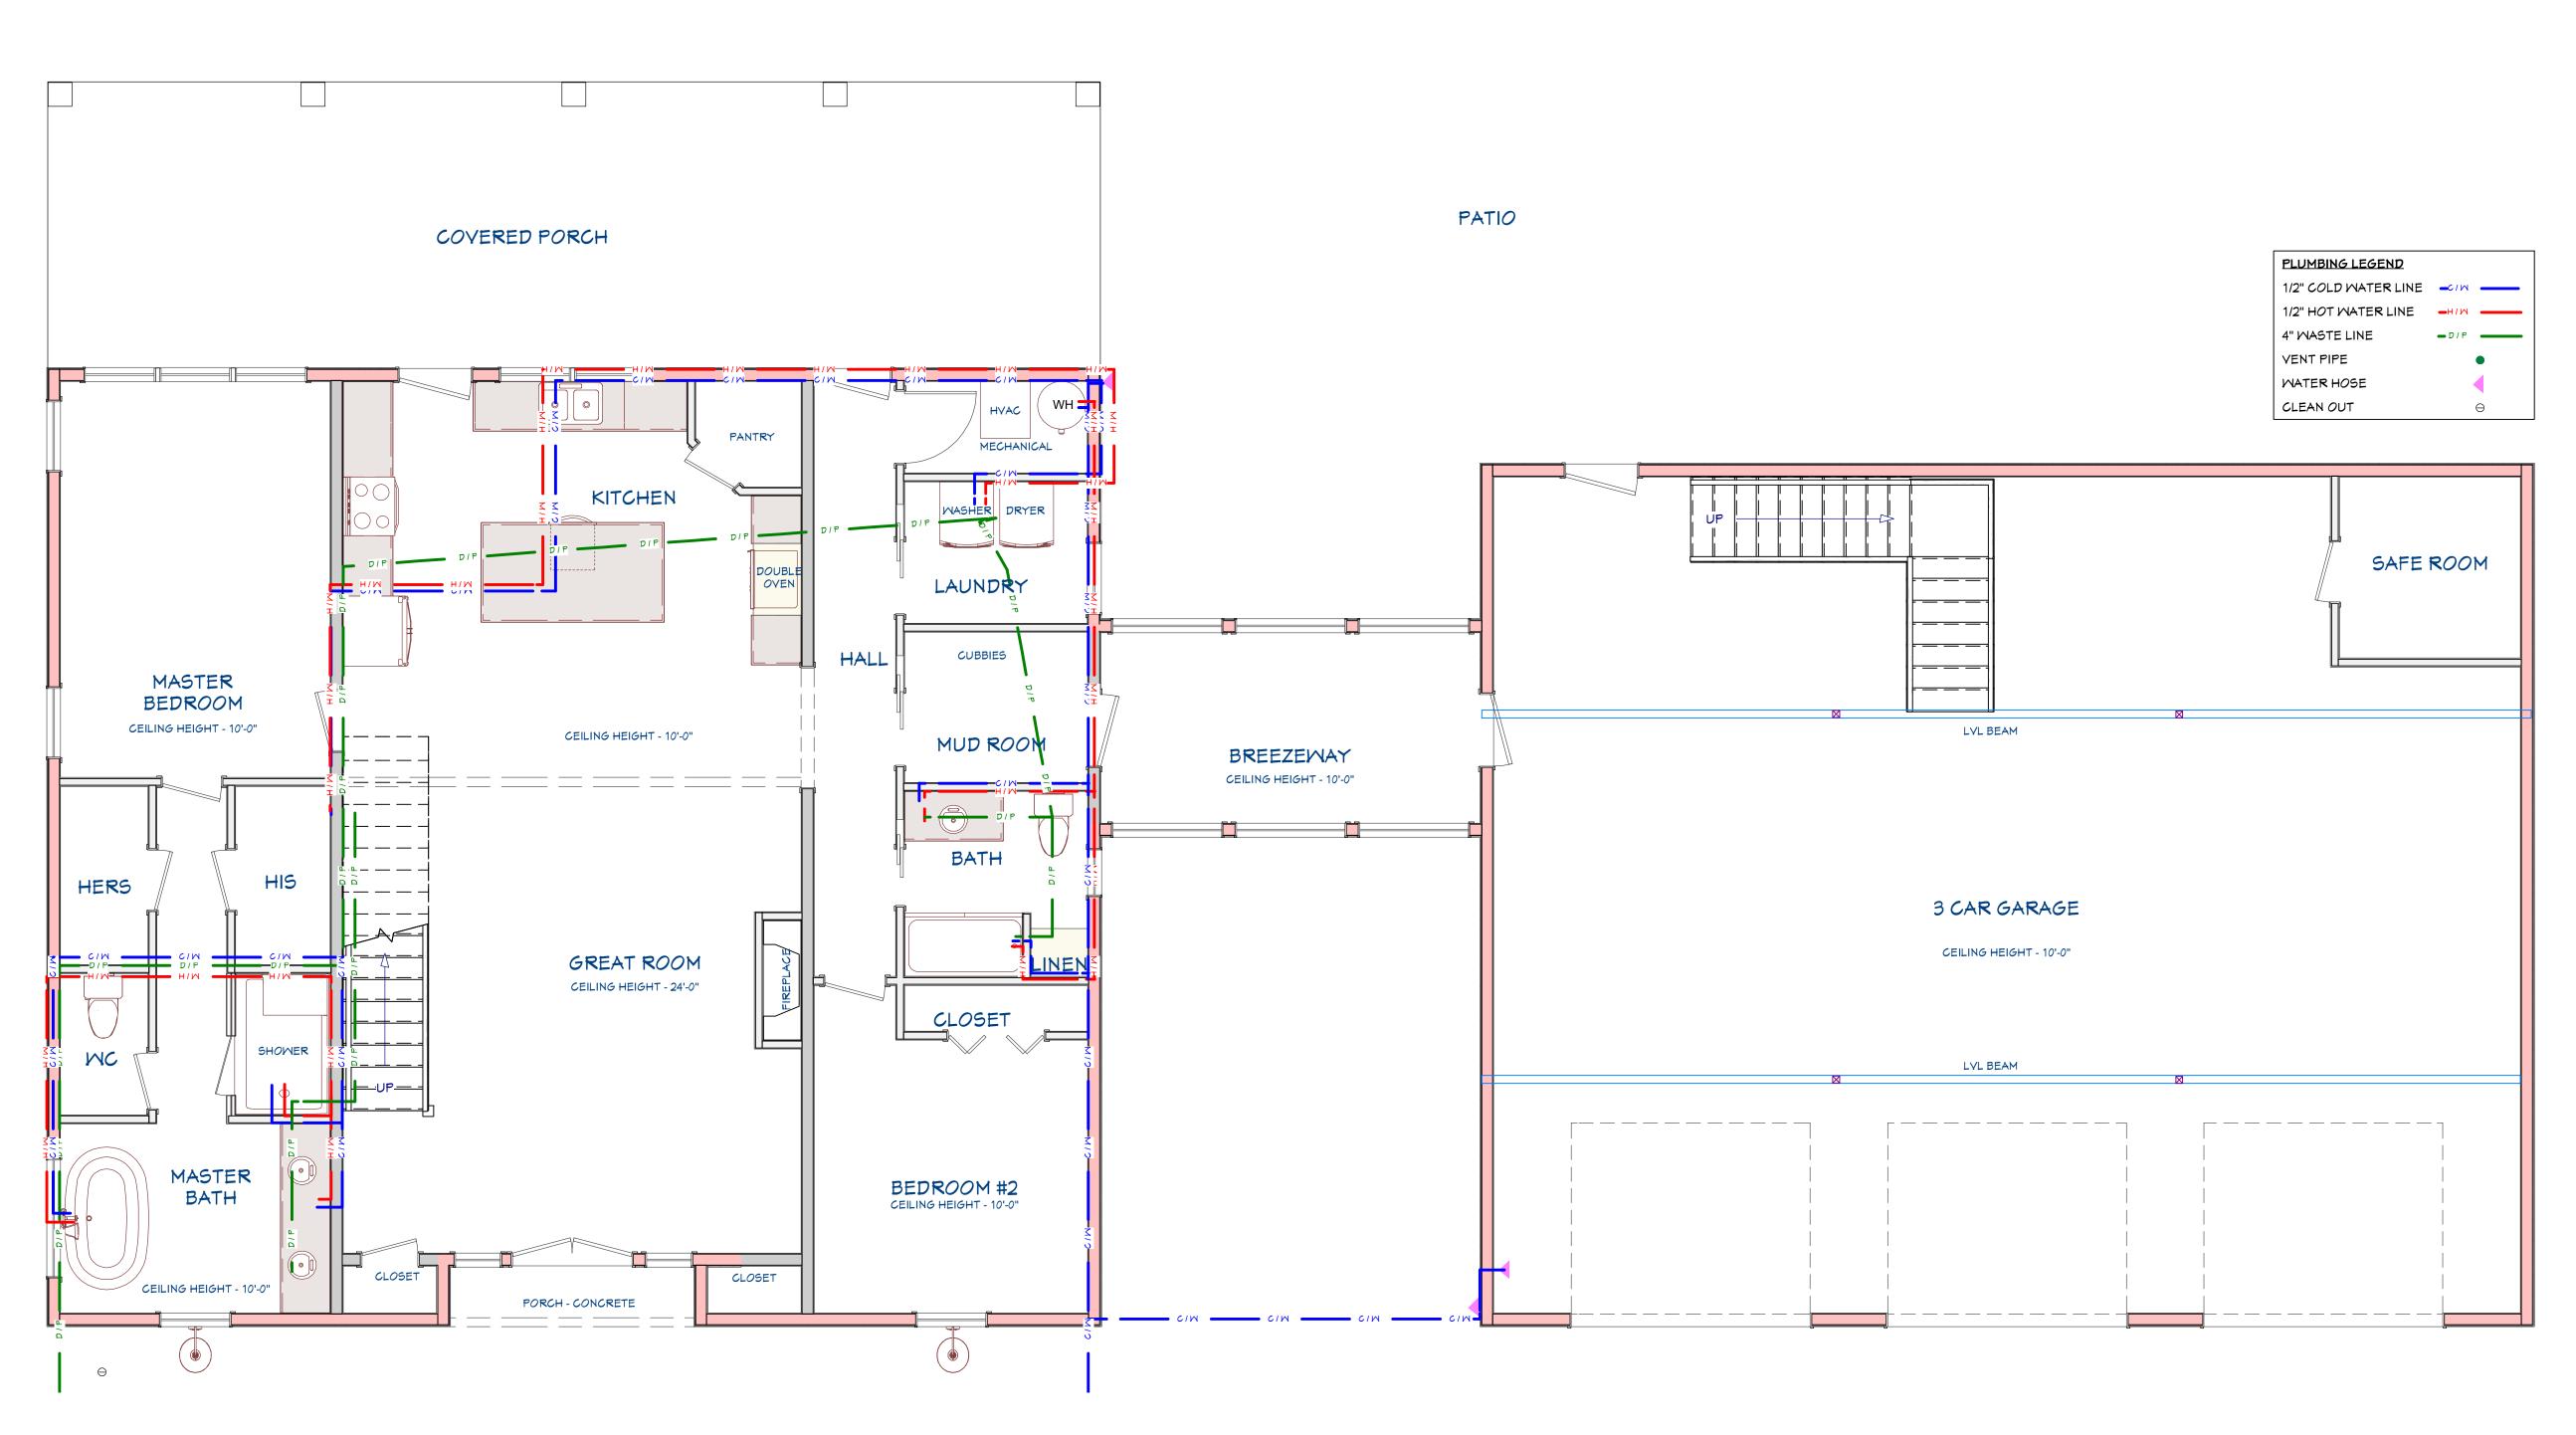

PLUMBING NOTES:

(PLUMBING LAYOUT IS FOR ILLUSTRATION PURPOSES ONLY AND A LOCAL PROFESSIONAL SHALL BE HIRED TO CONFIRM THE LAYOUT OR PROVIDE A LAYOUT THAT MEETS LOCAL CODE)

1)All work shall be done in conformance with all governing codes, including amendments, bulletins, etc. as well as standards of installation for residential buildings, and equipment and requirements of the Owner.



BuildMax Contact: tony@buildmax.com

CLIENT:
Refer to the name on the one-time build license

PROJECT TITLE:

COPYRIGHT:

BuildMax.com copyright 2021 Architectural works are protected by U.S. copyright law, specifically by 17 U.S. Code § 102(8).

NOTES:

CONTRACTOR SHALL CHECK
AND VERIFY ALL DIMENSIONS
BEFORE BEGINNING
CONSTRUCTION AND
COORDINATE ANY
CORRECTIONS OR REVISIONS
WITH THE OWNER AND
DESIGNER. BUILDMAX WILL
ASSUME NO LIABILITY FOR
ANY ERRORS ONCE THE
CONSTRUCTION BEGINS.

REVISION TABLE
NO. DATE DESCRIPTION

MBER

SHEET NUMBER
FIRST FLOOR


FILE NUMBER: BM2085

DATE: 12/2/2022

SCALE: WHEN PRINTED 24X36

3/16" = 1'-0"

SHEET NO.

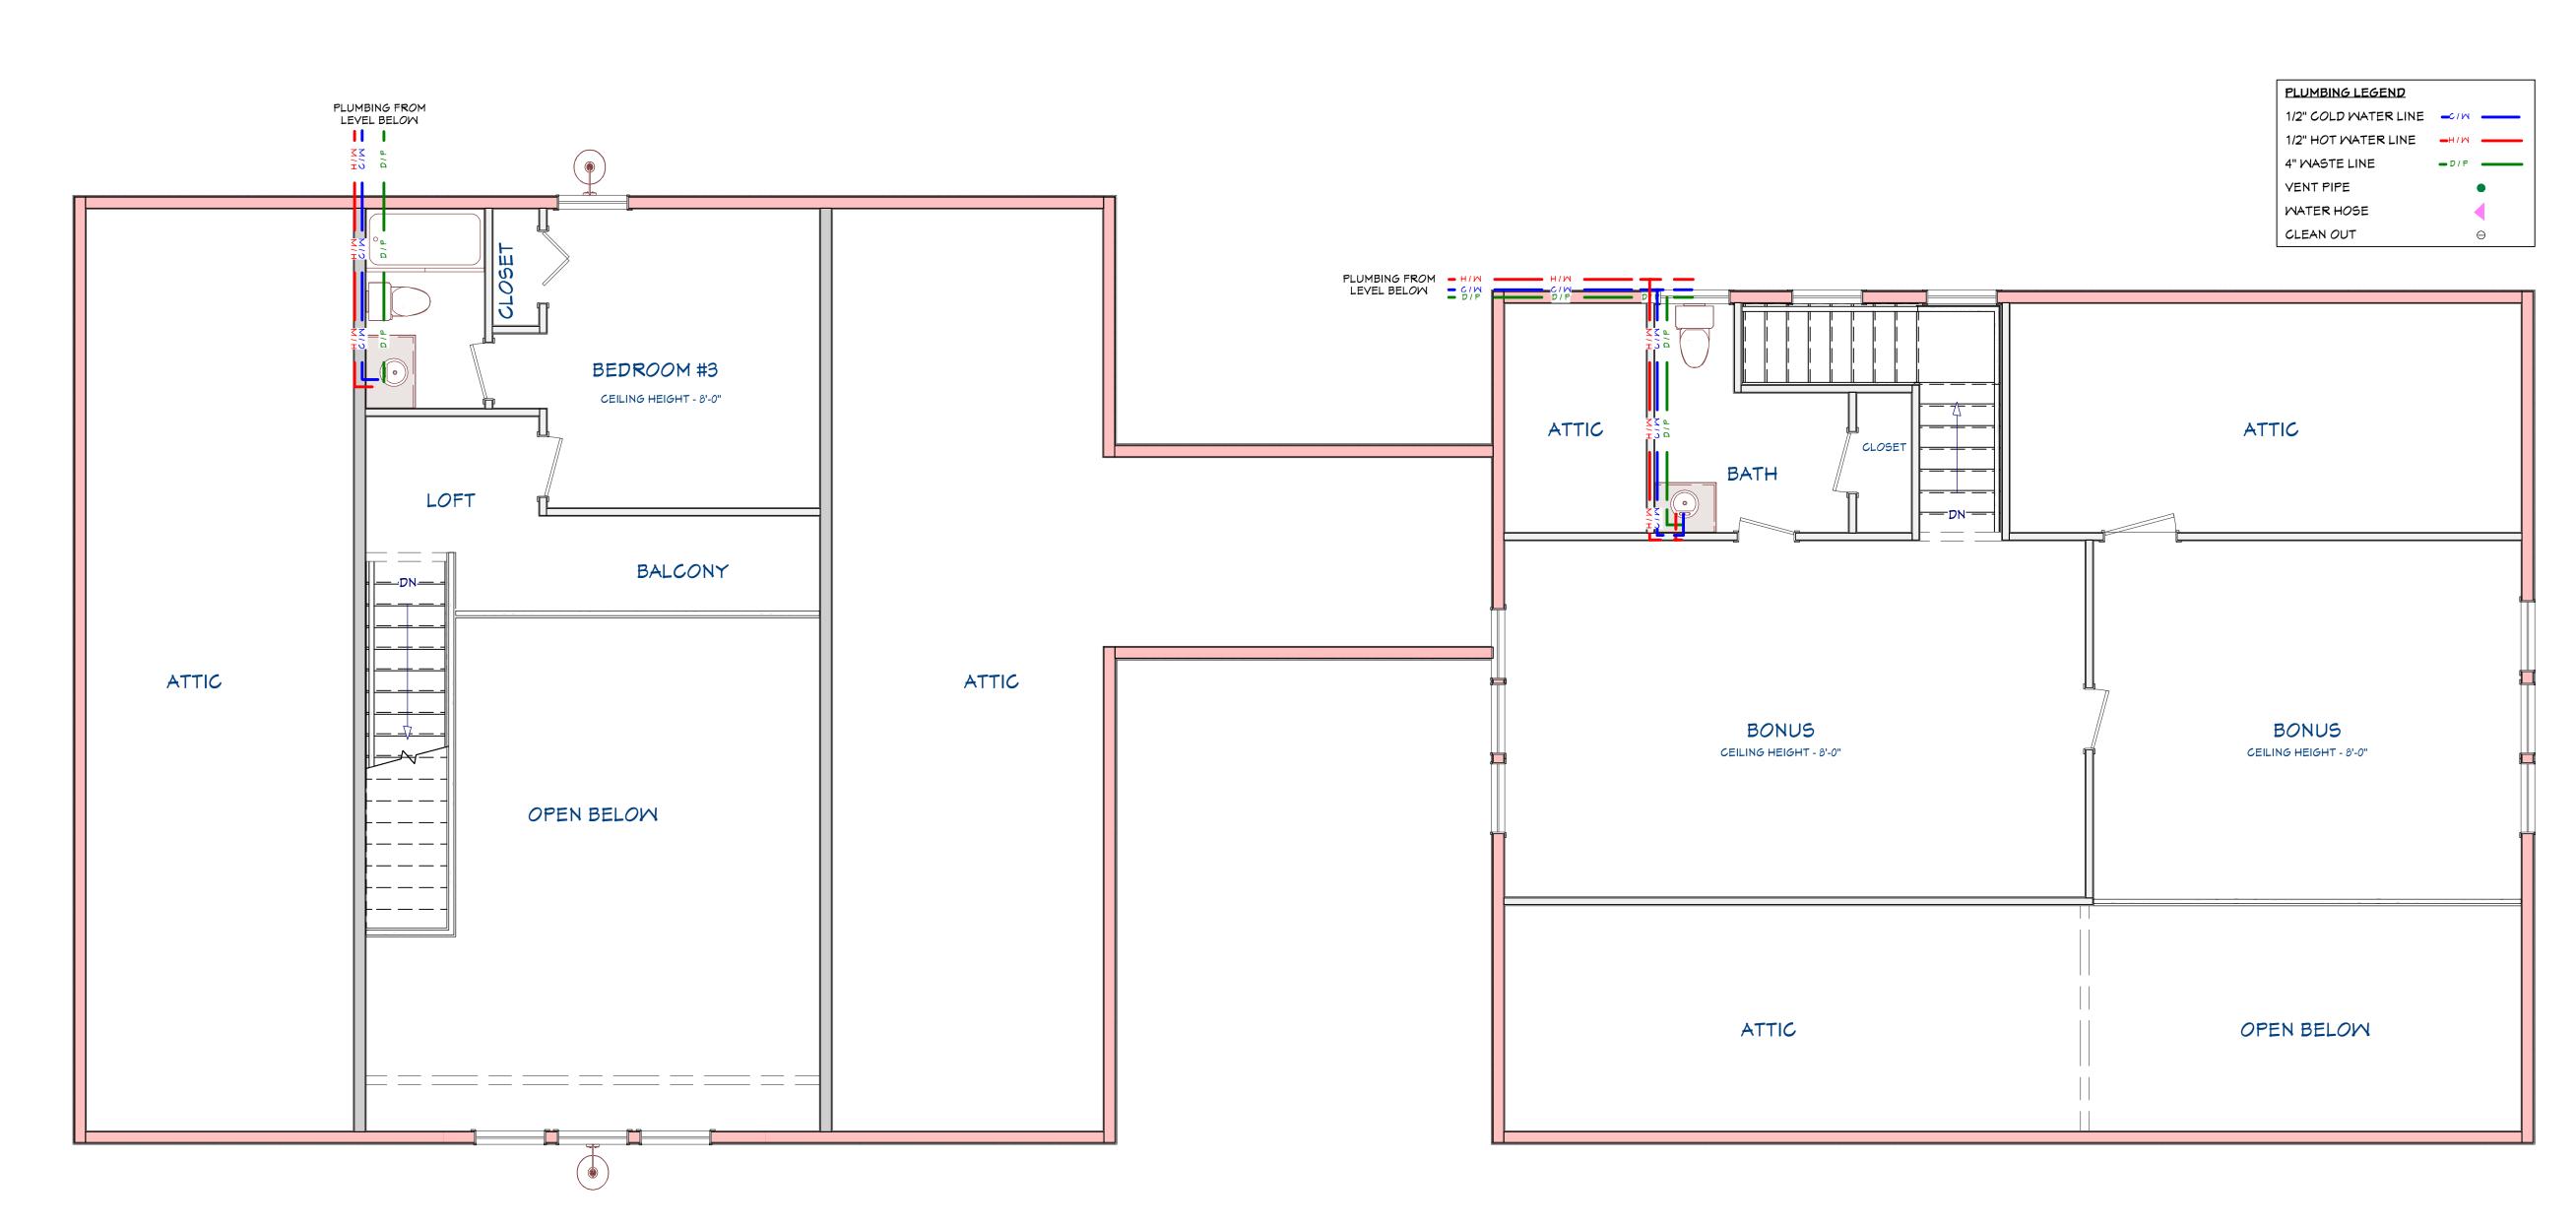

# PLUMBING NOTES:

(PLUMBING LAYOUT IS FOR ILLUSTRATION PURPOSES ONLY AND A LOCAL PROFESSIONAL SHALL BE HIRED TO CONFIRM THE LAYOUT OR PROVIDE A LAYOUT THAT MEETS LOCAL CODE)

1)All work shall be done in conformance with all governing codes, including amendments, bulletins, etc. as well as standards of installation for residential buildings, and equipment and requirements of the Owner.



BuildMax Contact: tony@buildmax.com

CLIENT:
Refer to the name on the one-time build license

PROJECT TITLE:

COPYRIGHT:

BuildMax.com copyright 2021 Architectural works are protected by U.S. copyright law, specifically by 17 U.S. Code § 102(8).

NOTES:

CONTRACTOR SHALL CHECK
AND VERIFY ALL DIMENSIONS
BEFORE BEGINNING
CONSTRUCTION AND
COORDINATE ANY
CORRECTIONS OR REVISIONS
WITH THE OWNER AND
DESIGNER. BUILDMAX WILL
ASSUME NO LIABILITY FOR
ANY ERRORS ONCE THE
CONSTRUCTION BEGINS.

REVISION TABLE
NO. DATE DESCRIPTION

ET NUMBER
COND FLOOR PLUMBING
AN


FILE NUMBER: BM2085

DATE: 12/2/2022

SCALE: WHEN PRINTED 24X36

1/4" = 1'-0"

SHEET NO.

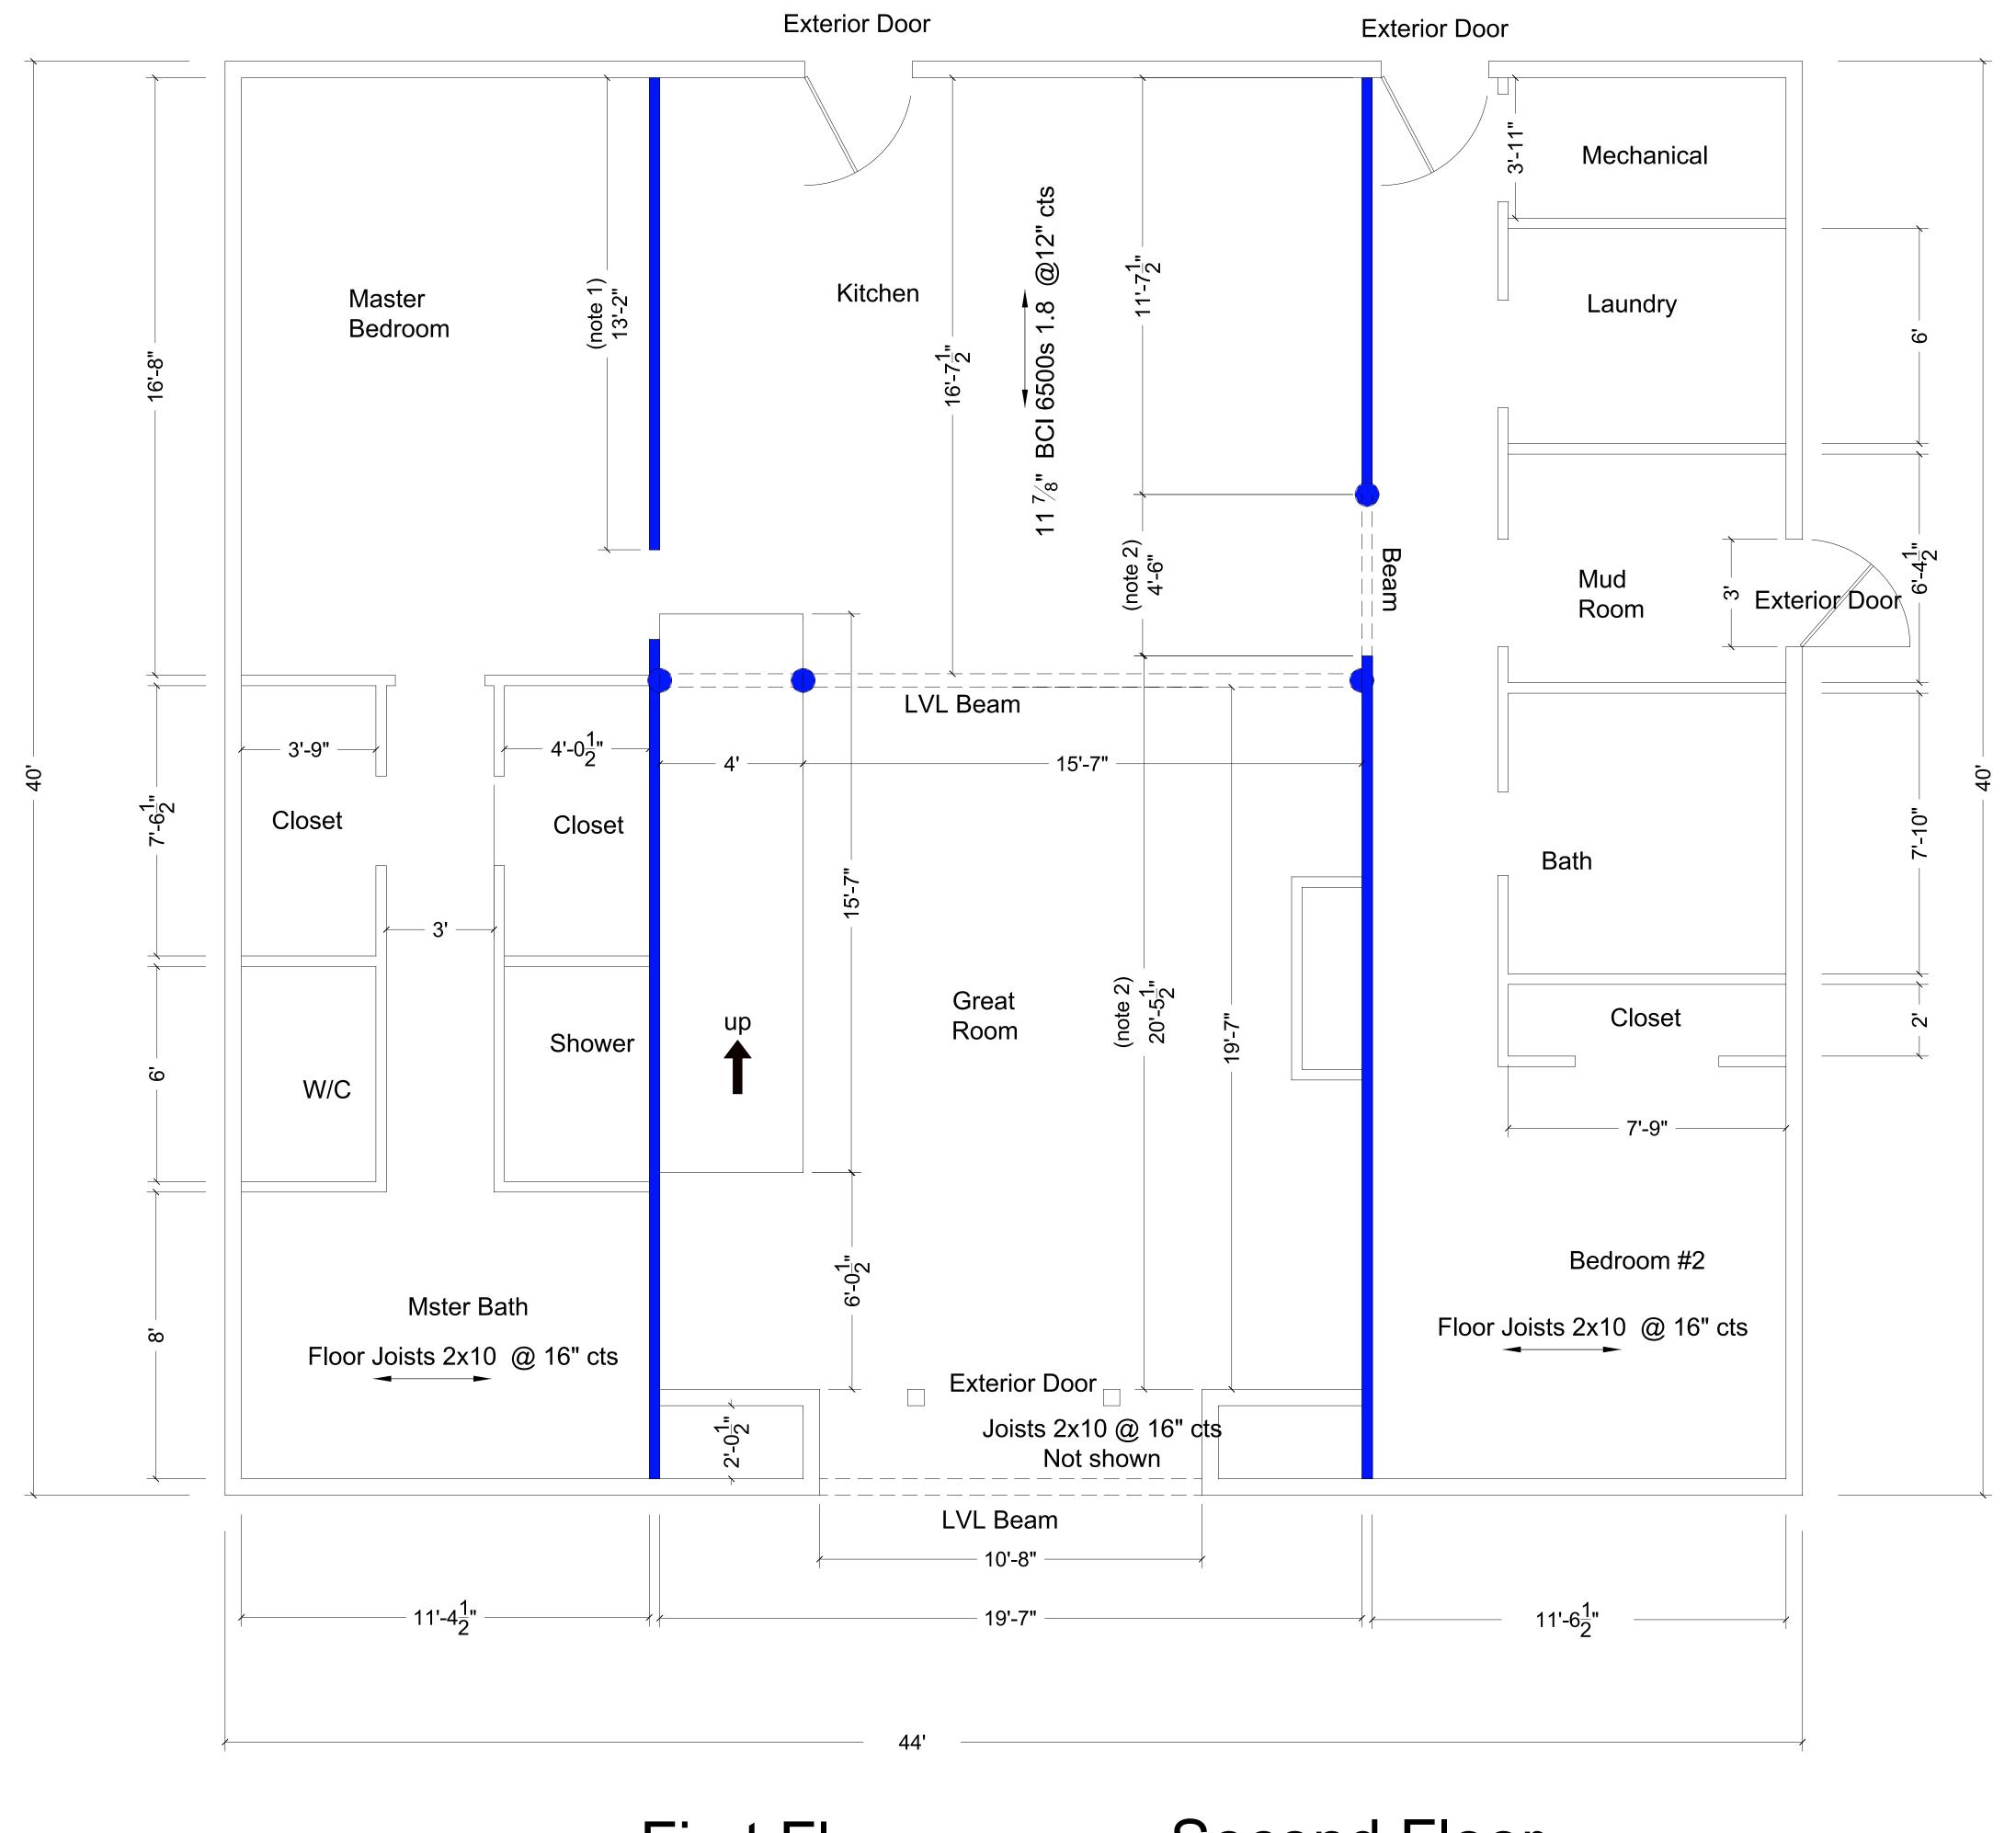

This plan takes precidence over other Framing and Floor Plan sheets provided by the Architect included in this plan set. This is required to make certain of load bearing locations. Any dimensions not shown on this sheet may be found on Sheet A-4 & A-5 and may be used.

Window & Door Locations not shown.

Refer to Sheet A-4 valid location dimensions and sizes.

(note 1) - Dimension not given on Original Plan set. This dimension is necessary for structural support locations.

(note 2) - This dimension extended to provide location form beam support. Cased opening changed to 4'-6" (Original Plans show 5'-0").

Load PointsInterior Load Bearing Wall

Care should be taken to adjust beam support height to reflect the difference between 2x10 Floor joists (actual 9  $\frac{1}{4}$ " deep vs. Engineered floor joist measuring 11  $\frac{7}{8}$ "

Header Schedule shown on Sheet A-4 May be used except where specific beams/Headers are listed on Structure Sheets S1-S6

First Floor Floor Plan

Second Floor
Floor Framing Layout


INTERIOR WALL DRAWN AT 3 \( \frac{1}{2} \) "


Will White

370 Ausley Rd. Fuquay-Varina, NC 27526 John Oerter, PE
Engineer Design Consultant, Permit Drawings
919-210-2798

Date 8-6-25

Contractor
Durham Building and Electric
4567 Little Creek Chirch Rd.
Clayton NC, 27520

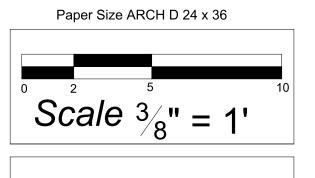

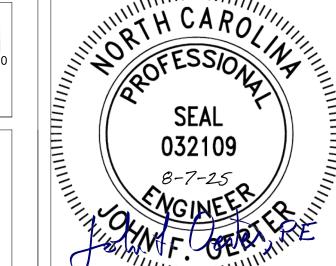

Sheet S1

**Exterior Door Exterior Door** (4) 2x4 Packed Stud Column Exterior Door (3) 1.75" x 14" 2.0E LVL (5) 2x4 Packed Stud Column Steps Floor Joists 2x10 @ 16" cts Floor Joists 2x10 @ 16" cts 10'-8" (4) 2x4 Packed Stud <u>Column</u> (2) 2x10 Joists Exterior Door 2x10 @ 16" cts (2) 1.75" x 9  $\frac{1}{2}$ " 2.0E LVL (4) 2x6 Packed Stud Column  $11'-4\frac{1}{2}$ "  $11'-6\frac{1}{2}$ "

This plan takes precidence over other Framing and Floor Plan sheets provided by the Architect included in this plan set. This is required to make certain of load bearing locations. Any dimensions not shown on this sheet may be found on Sheet A-4 & A-5 and may be used.

Engineered Joists - Connection to Exterior Wall

Rest Joists on Double top plate of wall, Blocking is required between joists. May use Structural lumber.

Engineered Joists - Connection to Beam Options May rest Engineered Joist on LVL causing a deeper dropped beam below.

May hang Engineered Joists using Simpson Strong-Tie providing a shalowler dropped beam appearance. Hanger Options

> ITS2.56/11.88 (single Joist - Top Flange Hanger) or IUS2.56/11.88 (Single Joist - Face Mount Hanger)

Stairs and Handrail built to Code requirements. Stair Height requirements determine on site at time of construction.

For all Door openings not shown specifically on this sheet, use: INTERIOR (2) 2x4 Jack Studs, (1) 2x4 King (2) 2x10 Header EXTERIOR (3) 2x6 Jack Studs (1) 2x6 King (2) 2x10 Header with Plywood Insert

Load Bearing Walls - 2x4 @ 16" centers with Double Top Plate

Second Floor Joist Layout & Framing

Contractor **Durham Building and Electric** 4567 Little Creek Chirch Rd. Clayton NC, 27520

INTERIOR WALL DRAWN AT 3 ½ "

Will White


370 Ausley Rd. Fuquay-Varina, NC 27526 Engineer Design Consultant, Permit Drawings 919-210-2798

Date 8-6-25

Sheet S2

Scale 3/8" = 1'



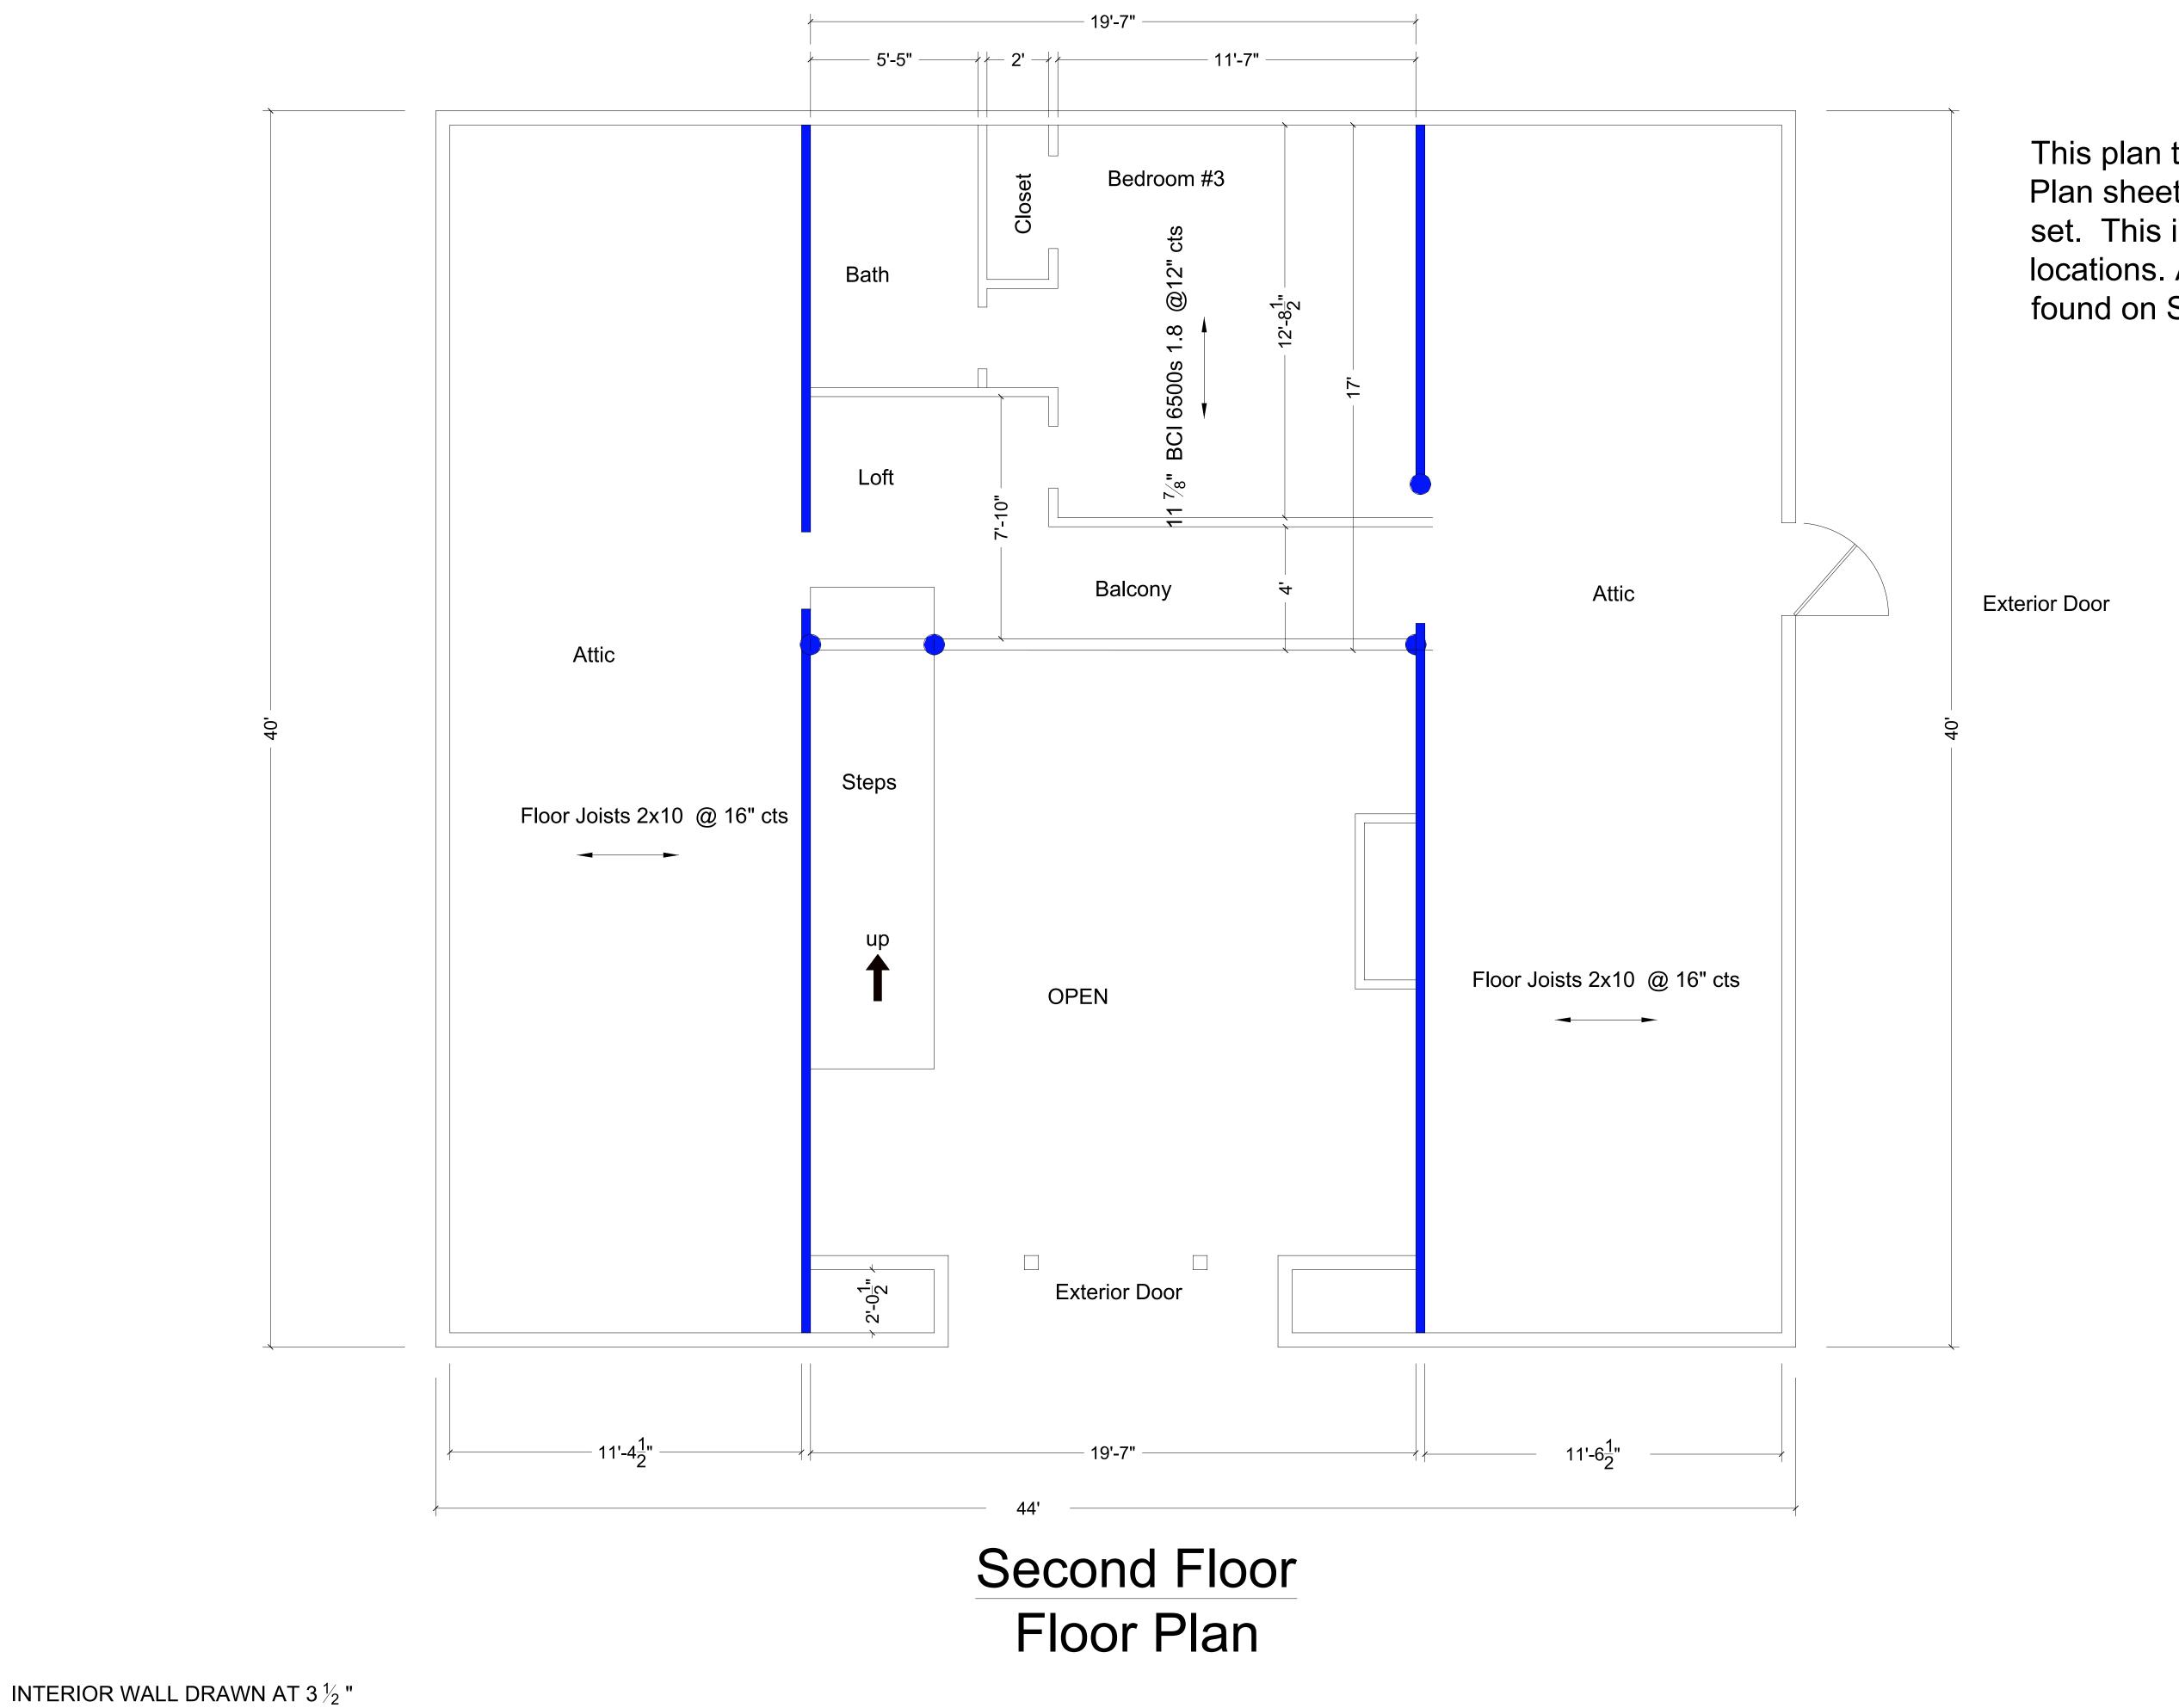

This plan takes precidence over other Framing and Floor Plan sheets provided by the Architect included in this plan set. This is required to make certain of load bearing locations. Any dimensions not shown on this sheet may be found on Sheet A-4 & A-5 and may be used.

> Contractor **Durham Building and Electric** 4567 Little Creek Chirch Rd. Clayton NC, 27520

Scale 3/8" = 1'


Will White

370 Ausley Rd. Fuquay-Varina, NC 27526

John Oerter, PE Engineer Design Consultant, Permit Drawings 919-210-2798

Date 8-6-25

Sheet S3

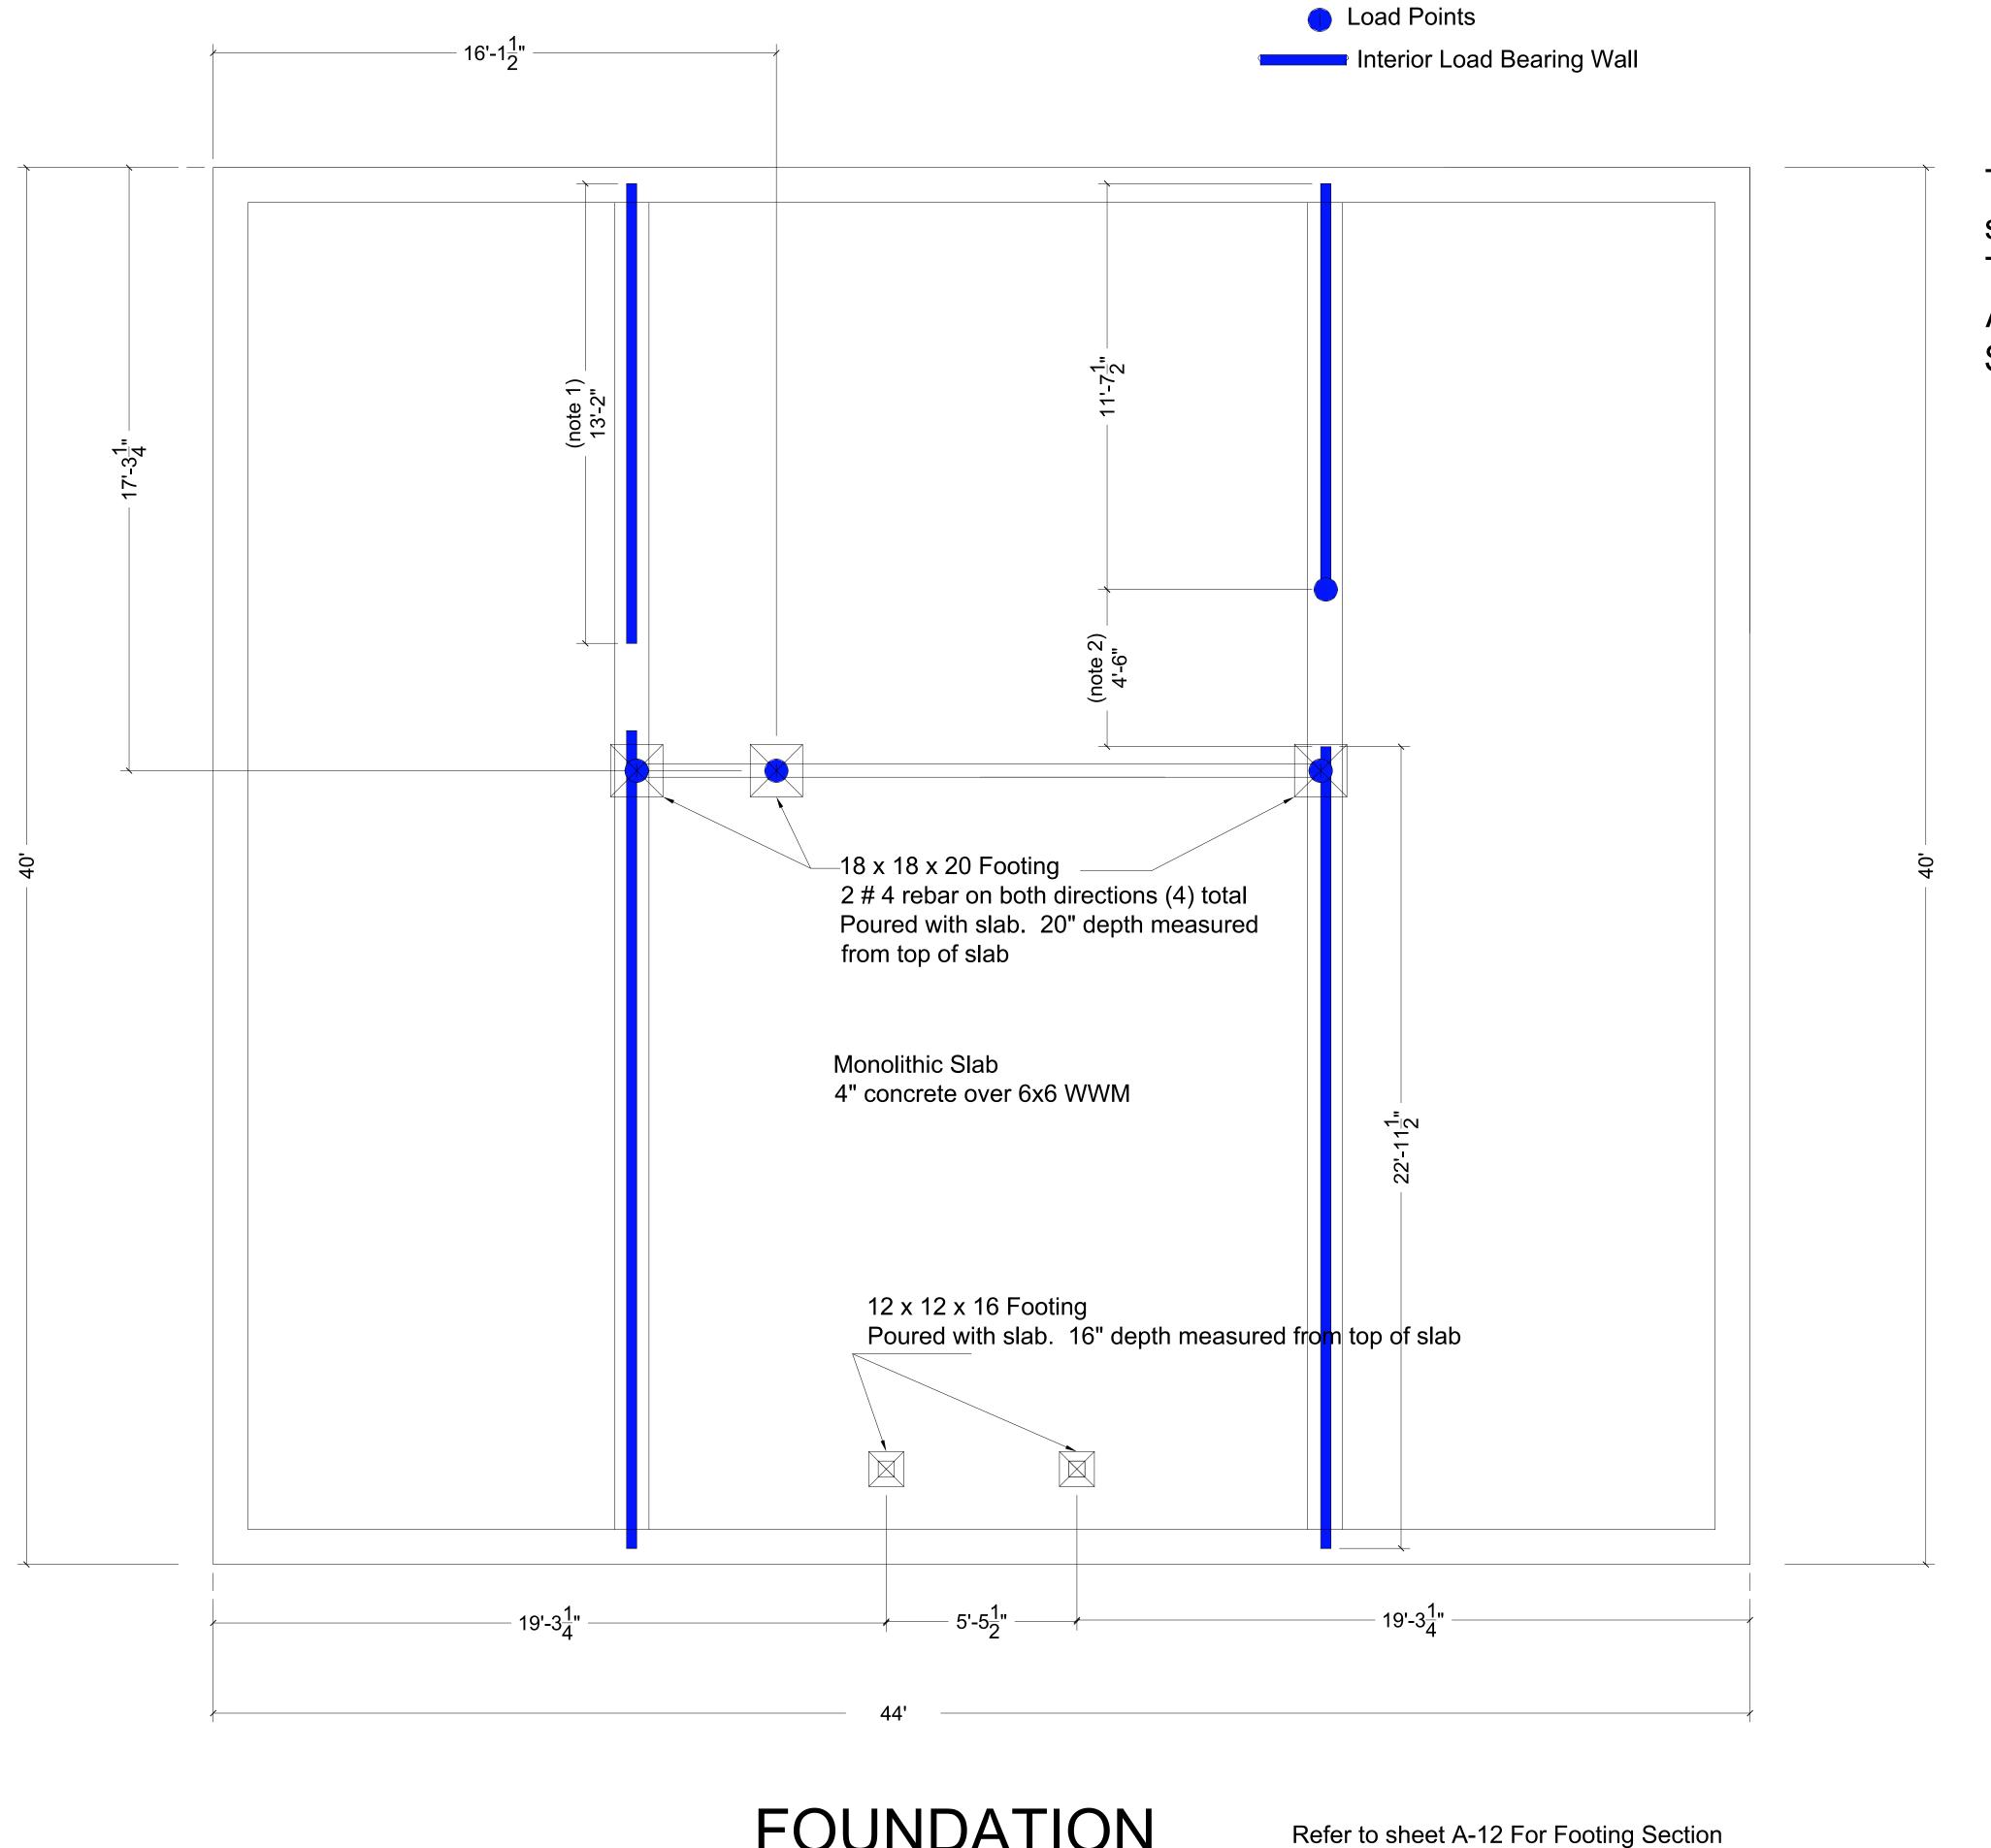

This plan takes precidence over other Foundation Plan sheets provided by the Architect included in this plan set. This is required to make certain of load bearing locations. Any dimensions not shown on this sheet may be found on Sheet A-6 and may be used.

> Contractor **Durham Building and Electric** 4567 Little Creek Chirch Rd. Clayton NC, 27520

FOUNDATION Modified from sheet A-6

Scale 3/8" = 1'

Sheet S4


Will White

370 Ausley Rd. Fuquay-Varina, NC 27526

John Oerter, PE Engineer Design Consultant, Permit Drawings 919-210-2798

Date 8-6-25

# LVL Beam Attachment for Built Up LVL

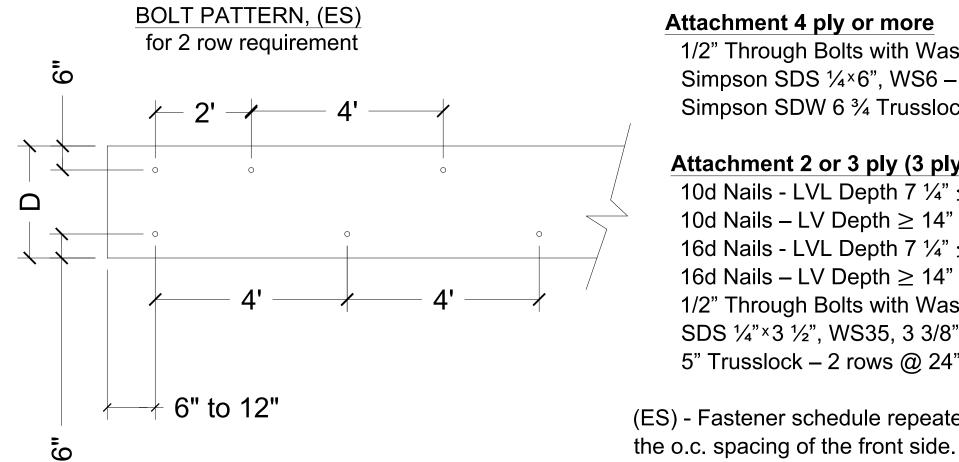

#### Attachment 4 ply or more

1/2" Through Bolts with Washers and nuts 2 rows @ 24" o.c. Simpson SDS 1/4×6", WS6 – 2 rows @ 24" o.c. (ES) Simpson SDW 6 3/4 Trusslock


#### Attachment 2 or 3 ply (3 ply ES)

- 10d Nails LVL Depth 7  $\frac{1}{4}$ "  $\leq$  d < 14" 3 rows @ 12" o.c. (ES 3 ply)
- 10d Nails LV Depth ≥ 14" 4 rows @ 12" o.c. (ES 3 ply)
- 16d Nails LVL Depth 7  $\frac{1}{4}$ "  $\leq$  d < 14" 2 rows @ 12" o.c. (ES 3 ply)
- 16d Nails LV Depth ≥ 14" 3 rows @ 12" o.c. (ES 3 ply)
- 1/2" Through Bolts with Washers and nuts 2 rows @ 24" o.c.
- SDS 1/4" × 3 1/2", WS35, 3 3/8" Trusslock 2 rows @ 24" o.c. (ES 3 ply) 5" Trusslock – 2 rows @ 24" o.c


(ES) - Fastener schedule repeated on opposite side offset up to one-half


LVL Beam Hole Details / Limits Minimum 2 x diameter of larger hole 1 foot  $\frac{1}{2}$  beam Area B Area B Area A depth 1/3 span length 1/3 span length 1/3 span length Clear span Not to scale **NOTES:** 1. These guidelines apply to uniform loaded beams. For all other applications, such as beams with concentrated loads, please contact manufacturer, Allowable Hole Sizes 2. Round holes can be drilled anywhere in "Area A" provided that: no more than four holes are cut, with the minimum spacing described in the diagram. The Maximum Round Beam Depth maximum hole size is 1-1/2" for depths up to 9-1/4" and 2" for depths greater Hole Diameter than 9-1/4". 3. Rectangle holes are not allowed. 3 1/2" - 7" 4. DO NOT drill holes in cantilevers without prior approval from the project 7 1/4" - 9 1/4" 1 1/2" 5. Other hole sizes and configurations MAY be possible with further engineering analysis. Contact Manufacturer for more information. 9 1/2" - 16" 6. Up to three 3/4" holes may be drilled in "Area B" to accommodate wiring and/or water lines. These holes shall be at least 12" apart. The holes shall be deeper than 16" located in the middle third of the depth or a minimum of 3" from the bottom and top of the beam. For beams shallower than 9-1/4", locate holes at mid depth. 7. Protect plumbing holes from moisture.

# 11 <sup>7</sup>/<sub>8</sub>" BCI 6500s Engineered Joist Allowable Hole Placement

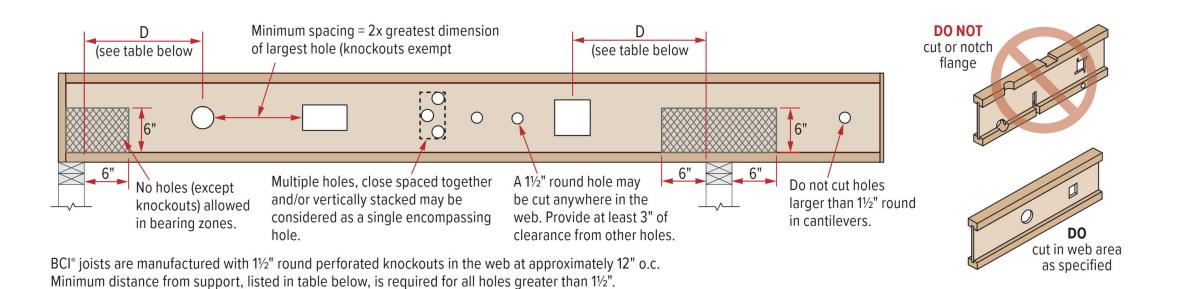

Contractor Durham Building and Electric 4567 Little Creek Chirch Rd. Clayton NC, 27520

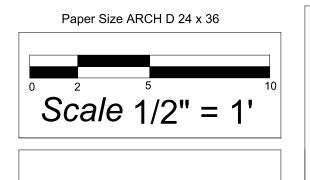

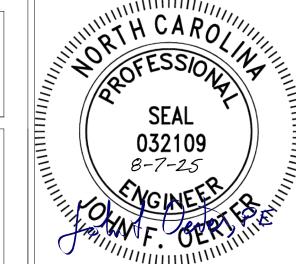

370 Ausley Rd. Fuquay-Varina, NC 27526

John Oerter, PE Engineer Design Consultant, Permit Drawings 919-210-2798

Date 8-6-25

Sheet S5

#### STRUCTURAL NOTES

- 1. All construction shall conform to the latest requirements of the North Carolina Building Code, in addition to all local codes and regulations.
- 2. Design Loads:

		DEAD LOAD (psf)	DEFLECTION				
DESIGN LOADS	LIVE LOAD (psf)		LL	TL			
ALL FLOORS	40	10	L/360	L/240			
ATTIC (w/ Walk Up stairs)	30	10	L/360	L/240			
ATTIC (Pull Down Acess)	20	10	L/240	L/180			
ATTIC (No acess)	10	5	L/240	L/180			
EXTERNAL BALCONY	40	10	L/360	L/240			
ROOF	20	10	L/240	L/180			
ROOF TRUSS	20	20	L/240	L/180			
WIND LOAD	BASED ON !@) MPF (Exposure B)						
SEISMIC	SEISMIC ZONES A< B< & C						

- 3. Minimum allowable soil pressure bearing pressure = 2000 psf
- 4. Concrete shall have a minimum 28 day strength of 3000 psi and a maximum slump of 5 inches unless noted otherwise.
- 5. Maximum depth of unbalanced fill against foundation walls to be less than 4'-0" without using sufficient wall bracing. Refer to section R404 of 2018 NC Residential Building Code for backfill limitations based on wall height, wall thickness, soil type, and unbalanced backfill.
- 6. All framing lumber shall be SYP #2 (Fb = 800 psi). All framing lumber exposed to the elements shall be treated material.

All LVL Lumber to be 1.75" wide nominal. Each single member Fb - 2600 psi, E = 1.9M psi (UNO) All LSL lumber to be 3.5" wide nominal. Each single member Fb - 2325 psi, E = 1.6M psi (UNO) All PSL lumber to be 3.5" wide nominal. Each single member Fb - 2400 psi, E = 1.8M psi (UNO) PSL columns desiged with a MAXIMUM height of 9'-0".

- 7. All load bearing headers shall be (2) 2x10 unless otherwise noted. All window headers shall be supported by(1) jack stud and (1) king stud at each end unless otherwise noted. All other beams shall be supported by 2 studs or the amount of studs required for full bearing at each end unless otherwise noted. Point loads shall consist of 2 studs unless otherwise noted. All supports of 2 studs or more shall be transferred through each floor to the foundation. Refer to table R602.7(1) & (2) for Jack Stud requirements for header spans for interior and exterior load conditionsunless specifically noted on plans.
- 8. All exterior wall to be sheathed with 7/16" wood structural panels fastned with 8D nails at 6" O.C. at edges and 12" O.C at interior supports. Blocking shall be installed if less than 50 percent of the wall length is sheathed. Where blocking is required, all panels shall be fastened at 3" O.C. at edges and 6" O.C. at interior supports. Refer to section R602.3 for framing of all walls over 10'-0" in height.

# Wall Bracing NCBC R602.3(3)

Required Wall Bracing Method and Connections - CS-WSP (Wood Structural Panel). Min Thickness  $\frac{3}{8}$  " 6d Common Nails @ 6" O.C> along Panel Edges. 6d Common Nealis @ 12" cts at Intermediate Supports.

- 9. All structural steel shall be ASTM A-36. All structural Steel W-Shapes (I-Beams) shall be ASTM A992 Grade 50. All steel angles, plates and C-Channels shall be ASTM A36. All Steel Pipe sall be ASTM A53 Grade B. Steel beams shall be supported at each end with a minimum bearing length of 3-1/2" and full flange width. Provide solid bearing from beam support to foundation. Beams shall be attached to each support with two lag screws (1/2" diameter and 4" long). Lateral support is considered adequate providing the joists are toe nailed to the sole plates and the sole plates are nailed or bolted to the beam flanges at a maximum spacing of 48" O.C.
- 10. Provide Anchor bolt Placement per section R403.1.6. ½" diameter Anchor bolts spaced at 6'-0" O.C. and placed 12" from the end of each plate section. Anchor bolts shall be placed at 3'-0" O.C. for basements. Anchor bolts shall extend 7 inches into concrete or masonry. The bolt shall be located in the middle third of the width of the plate. There shall be a minimum two anchor bolts per plate section.
- 11. Foundation drainage/damp proofing or water proofing per section 405 and 406 of 1018 NC Residential Building Code.
- 12. Uplift loads greater tan 500 lbs. sall be continuously anchored to the foundation.
- 13. Provide a minimum of 500 lbs. uplift & laterial connection at top and bottom of porch columns (UNO)
- 14. Maximum masonty pier height shall not exceed four times it least horizontal dimension.
- 15. Wall and Roof cladding values:

Wall cladding shall be designed for a 28.0 pounds per square foot or greater positive and negative pressure. Roof values both positive and negative shall be as follows:

- 45.5 lbs/sqft for roof pitches 0/12 to 2.25/12
- 34.8 lbs/sqft for roof pitches 2.25/12 to 7/12
- 21.0 lbs/sqft for roof pitches 7/12 to 12/12
- \*\* Mean roof height 30' or less.
- 13. For roof slopes from 2/12 through 4/12, Builder to install 2 layers of 15# felt paper.
- 14. It is the contractors responsibility to verify all dimensions and square footage prior to construction.
- 15. The structure is adequate to withstand uplift forces on an open structure with a flat sloped roof from ASCE 7-16, Risk Category II wind speeds of 115 mph. The attachment of the roof is to include hurricane clips (Simpson) or straps placed at all rafters and roof supports.

#### **GENERAL NOTES**

- 1. It is the contractor's responsibility that all dimensions, roof pitches, and square footage are correct prior to construction. Engineer sealing plans is not responsible for any dimensioning, roof pitch, or square footage errors once construction begins.
- 2. All walls shown on the floor plans are drawn at 5" unless noted otherwise.
- 3. Stud wall design shall conform to North Carolina State Building Code requirements.
- 4. DO NOT SCALE PLANS. Drawing scale may be distorted due to copier imperfections.
- 5. All construction shall be in accordance with NORTH CAROLINA RESIDENTIAL STATE BUILDING CODE, 2018 edition.

Contractor
Durham Building and Electric
4567 Little Creek Chirch Rd.
Clayton NC, 27520

Paper Size ARCH D 24 x 36

Scale 1/2" = 1'

SEAL 032109
8-7-25
VGINEER

Will White

370 Ausley Rd. Fuquay-Varina, NC 27526 John Oerter, PE Engineer Design Consultant, Permit Drawings 919-210-2798

Date 8-6-25

Sheet S6