#### **REVISION LOG**

6x6 @ COVERED PORCH. PACK OUT BEAM.

CHANGE WALL BETWEEN PANTRY/ COAT CLOSET TO A 2X6 WALL NOTE 3/0 C.O. "3/0X6/8 C.O.".

DATE: 11/24/21

- 4. CHANGE WALL BETWEEN KITCHEN COUNTER & MESSY KITCHEN TO 28" LENGTH.
- 4. CHANGE WALL BETWEEN KITCHEN COUNTER & MESSY KITCHEN TO 28" LENGTH.
  LOCATE 2/80K/8 C.O. @ END OF THE WALL.

  5. ADD (3) OPT 2/0X2/0 © CAFE, CENTERED © 21'-4" FRONT REAR WALL.

  6. CHANGE 1ST FLOOR STAIR RAIL AND WALL FROM A 2X4 WALL TO A 2X6 WALL.

  SLIDE BATH #2 WALL 2" TO MAINTAIN 3'-4" STAIR WIDTH. ADJUSTED WALL AND
  STAIR ON THE 2ND FLOOR.

  7. END STAIR RAIL 10'-0" FROM WIC WALL.

  8. REMOVE WIDE WALL BEHIND BATH #2 TUB.

  9. CHANGE BATH #2 WIDTH TO 5'-0" & ADD ROOM TO BED #2.

  10. CHANGE WALL BEHIND THE OWNER'S TOILET WALL FROM A 2X6 WALL TO A 2X4
  WALL & MOVE WALL INTO WIC TO INCREASE DEPTH THE TOILET TO 6'-1". REVISE
  ALL OWNER'S BATH -0PTONS TO MATCH.

- ALL OWNER'S BATH OPTIONS TO MATCH.

  11. ADD GOURMET KITCHEN W/ WALL OVEN AND 36" COOKTOP.

- 11. ADD GUDYME! RICHEN W/ WALL OVEN AND 36 COURTOP.

  12. ADD 24"X36" ATTIC ACCESS TO BED #4 WIC.

  13. CHANGE 2ND FLOOR 3/0 C.O. TO A 5/0X6/8 C.O.

  14. CHANGE DOOR SIZES FROM 2/6X6/8 TO 2/4X6/8 @ FOYER CLOSET, BATH #2, WIC

  @ BED #2, BATH #3, LINEN, WIC @ BED #3 & WIC @ BED #4.

  15. FLIP DOOR SWING INTO OPT. OFFICE/HOME GYM.

  16. ADD 8"-0" DEEP MECHANICAL RM TO REAR OF OPT. SUPER GAMEROOM/ HOME
- GYM / OFFICE
- 17. 2X10 BEAM UNDER TOP PLATES @ FRONT PORCHES.

  18. ALIGN (3) 2/0X2/0 WINDOW HEADER HT @ FLEX ROOM W/ FRONT DOOR HEADER

- HT.

  ADD PARTIAL FOR OPT FIREPLACE.

  20. ADD PARTIAL ELEVATIONS FOR OWNER'S BATH OPTIONS.

  21. ADD PARTIAL FOR OPT SMART DELIVERY DOOR.
- 22. 4 3" DSP BETWEEN WINDOWS & DIMENSION TO THE CENTER.
  23. DIMENSION WIDTH OF HIPS

#### REVISION:002 DATE: 2/4/2022

- DIMENSION TRIPLE STUD POCKETS (4.5")
   RELOCATED & RESIZE KITCHEN ISLAND PER REDLINES, & REMOVE UNDER-COUNTER WALL TO THE RIGHT OF KITCHEN SINK.
   SHOW FULL HEIGHT WALL AT STANDARD MASTER BATH SHOWER.
- CHANGE MASTER BATH LINEN CLOSET DOOR TO 4/0X6/8 DOUBLE DOOR.
- CALL OUT ALL LINEN CLOSETS AS (4) SHELVES.
  REMOVE SHELF/ROD BEHIND WATER CLOSET & ADJACENT TO DOOR IN MASTER WIC CALL OUT FRONT PORCH COLUMNS AS 6X6 P.T. POST W/ 1X WRAP. LABEL 12" DROPPED HEADER.
- REMOVE THE OWNER'S ENTRY OPTION.
- 10. RESIZE/RELOCATE/REMOVE UNDER-COUNTER WALL IN KITCHEN ISLAND PER BASE
- PLAN.

  11. SHOW 42X42 SHOWER W/ 18" SEAT FOR TUB SHOWER COMBO PER REVISION

- REDLINES.

  2. SHOW OPT. STANDALONE 42X42 W/ 18" SEAT.

  13. LOCATE SHOWER VALVE ON HALF WALL FOR SUPER SHOWER OPT.

  14. LABEL OPT DOOR TO FLEX ROOM AS 15-UITE FRENCH DOORS

  15. SWING DOOR AT GAMEROOM INTO UNIFIN ATTIC STORAGE.

  16. REMOVE FAUX SHUTTER FROM FARMHOUSE PLAN SINCE IT IS NOT SHOWING ON
- 17. UPDATE ROOF HEIGHT FOR REAR OPTIONS TO REFLECT STANDARD HEEL HEIGHT.
  18. REMOVED HALF WALLS AT KITCHEN ISLAND AND UPDATED PER CABINET PROVIDER
  20. EXTEND PORCH SLAB 4" AT FRONT AND EXTEND AROUND CORNER 20" TO SUPPORT STONE
- 21. REMOVED HALF WALLS AT KITCHEN ISLAND AND UPDATED PER CABINET PROVIDER
- 22. CHANGED THE BASE OWNER'S BATH WINDOW TO 4010
  23. CHANGED THE OWNER'S BATH OPTION SHOWER WINDOW TO 4010
- 24. CHANGED THE OWNER'S BATH OPTION SUPER SHOWER WINDOWS TO (2)3010

#### REVISION: 003

1. ADD ELECTRICAL PLANS

#### REVISION: 004

Revised 8-18-23 SF

#### DATE: 7/22/2022

- ADD STEM WALL SLAB FOUNDATION SHEETS
  ADD "STEM WALL" TO CRAWL ELEVATION TITLES AND NOTE "SEE FOUNDATION PAGES
  FOR FOUNDATION TYPE". UPDATE SHEET TITLES.

# **≥HOME** Lot 16 Woodbridge South 57 Avents Creek Way Fuquay Varina, NC 27540



	<u>AGE</u>
LOW C	OUNTRY
UNHEATED	HEATED
0	1955
0	945
147	0
437	0
220	0
-004-	2900
3:	704
PTIONS	
UNHEATED S.F	. HEATED S.F.
	. HEATED S.F.
unheated s.f	1
UNHEATED S.F	0
UNHEATED S.F	+32
UNHEATED S.F	0 +32 +165
0 0 0	0 +32 +183
0 0 0 0 0	0 +32 +165 +183 +100
	UNHEATED  0 0 147 437 200

2011 4 DE EQ OT 4 OF

Screened Covered Deck

# PLAN 6 The Raleigh - LH

## **'LOW COUNTRY' ELEVATION**

A DOLUTEOTUDA L DDA MINIOC

heet No.	Sheet Description
0.0	Cover Sheet
0.0	Foundation (Slab)
1.1.1	Foundation Options (Slab)
1.1.2	Foundation Options (Slab)
1.2	Foundation (Crawl)
1.2.1	Foundation Options (Crawl)
1.2.2	Foundation Options (Crawl)
1.3	Foundation (Stem Wall Slab)
1.3.1	Foundation Options (Stem Wall Slab)
1.3.2	Foundation Options (Stem Wall Slab)
2.1	First Floor Plan
2.1.1	First Floor Plan Options
2.2	Second Floor Plan
2.2.1	Second Floor Plan Options
2.4	Covered Porch Plans & Elevations (Slab)
2.4.1	Covered Porch Plans & Elevations (Crawl/Stem Wall)
2.5	Extended Owner's Suite Plans & Elevations (Slab)
2.5.1	Extended Owner's Suite Plans & Elevations (Crawl/ Stem Wall)
2.6	Ext. Owner's Suite W/Cov. Porch Plans & Elevations (Slab)
2.6.1	Ext. Owner's Suite W/Cov. Porch Plans & Elevations (Crawl/Stem Wall)
2.7	2-Car Sideload Garage Plans
2.7.1	2-Car Sideload Garage Elevations
2.8	3-Car Garage Plans
2.8.1	3-Car Garage Elevations (Crawl/ Stem Wall)
2.8.2	3-Car Garage Elevations (Slab)
3.1	Front & Rear Elevations (Slab)
3.1.1	Front & Rear Elevations (Crawl/Stem Wall)
3.2	Side Elevations (Slab)
3.2.1	Side Elevations (Crawl/ Stem Wall)
3.3	Roof Plan
5.1	First Floor Electrical Plan
5.1.1	First Floor Options Electrical Plan
5.2	Second Floor Electrical Plan
5.2.1	Second Floor Options Electrical Plan

### **DESIGN CRITERIA:**

THIS PLAN IS TO BE BUILT IN CONFORMANCE WITH THE 2018 NORTH CAROLINA STATE BUILDING CODE: RESIDENTIAL CODE

DIMENSIONS SHALL GOVERN OVER SCALE, AND CODE SHALL GOVERN OVER DIMENSIONS.

PLAN ISSUE DATE 7/1/2021

.

THE RALEIGH


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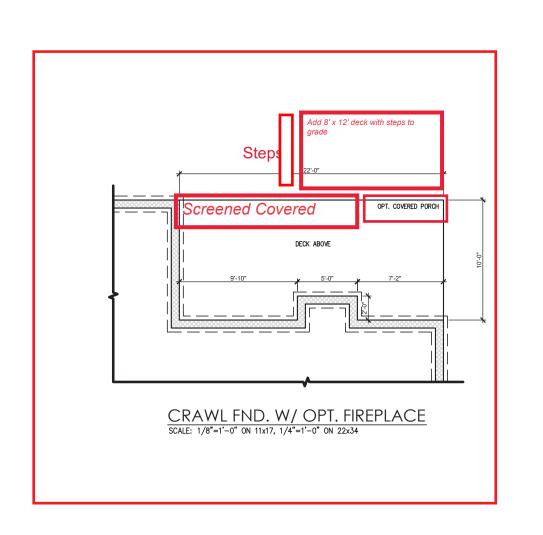
Country'

Low

Sheet

CURRENT REVISION DATE: 1/8" = 1'-0"



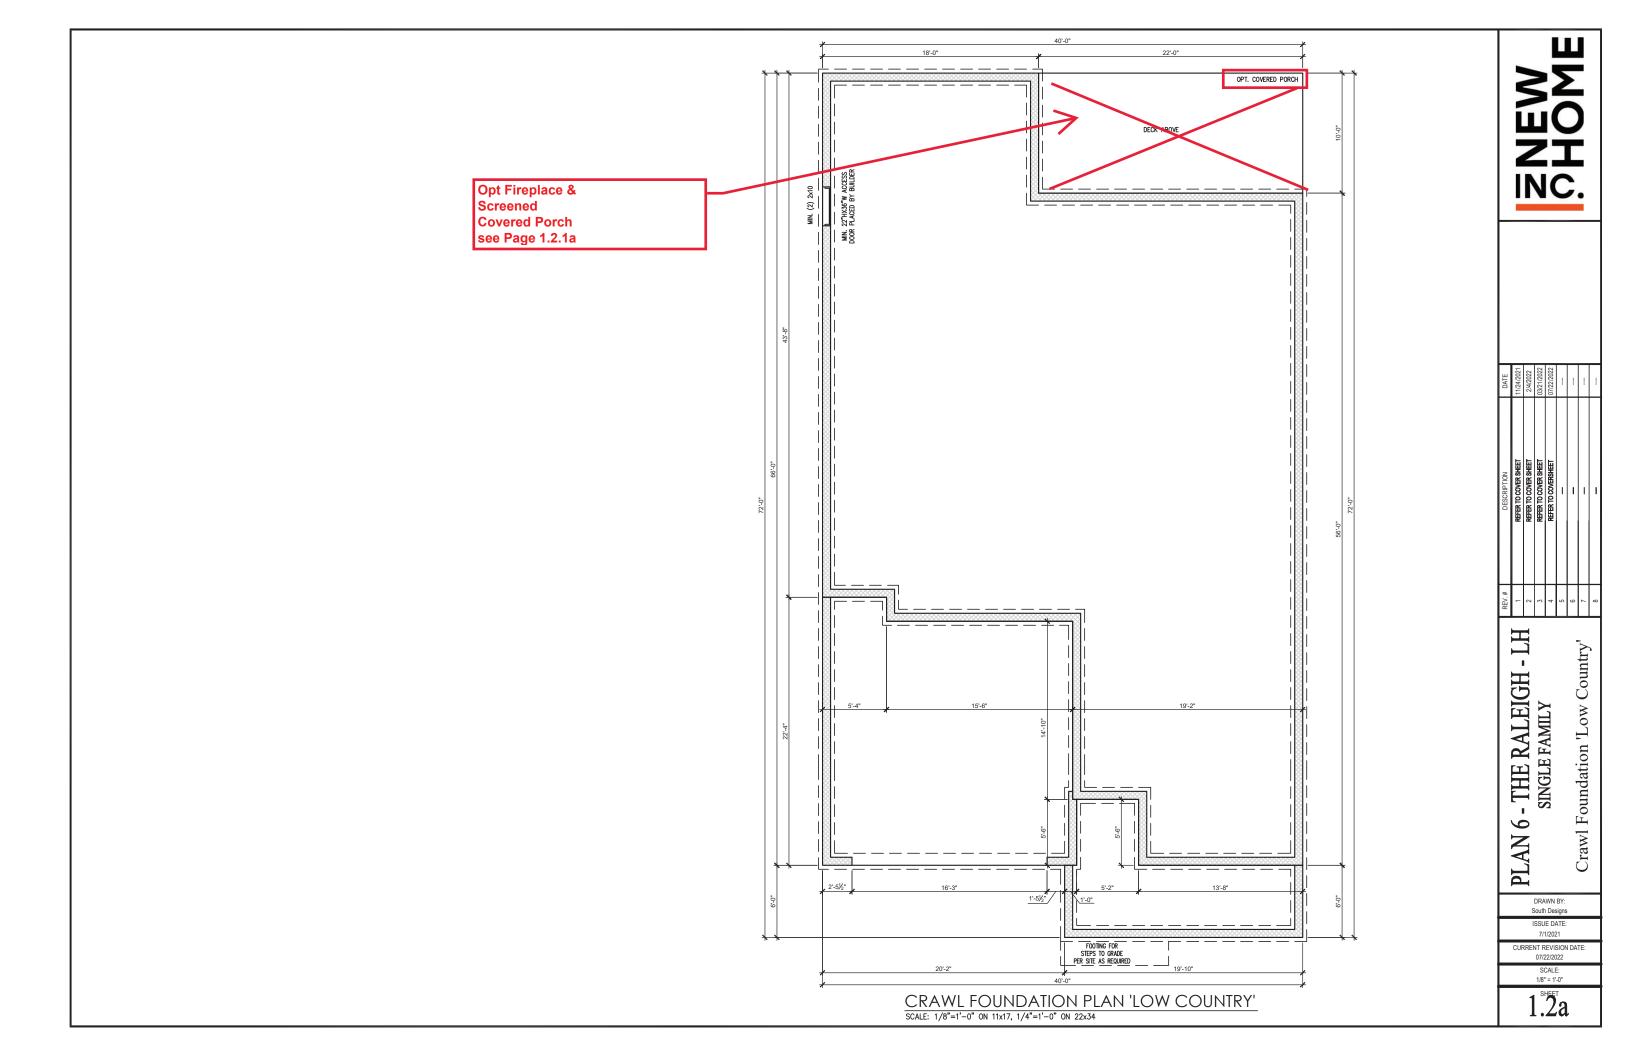




	REV.#	DESCRIPTION	DATE
	1	REFER TO COVER SHEET	11/24/2021
	2	REFER TO COVER SHEET	2/4/2022
CINCI E EAMIT V	3	REFER TO COVER SHEET	03/21/2022
	4	REFER TO COVERSHEET	07/22/2022
	9	am.	
	9	-	
Crawl Foundation Ontions I ow Country!	7	cama	
	8		-

ISSUE DATE: 7/1/2021


CURRENT REVISION DATE: 07/22/2022 SCALE: 1/8" = 1'-0"

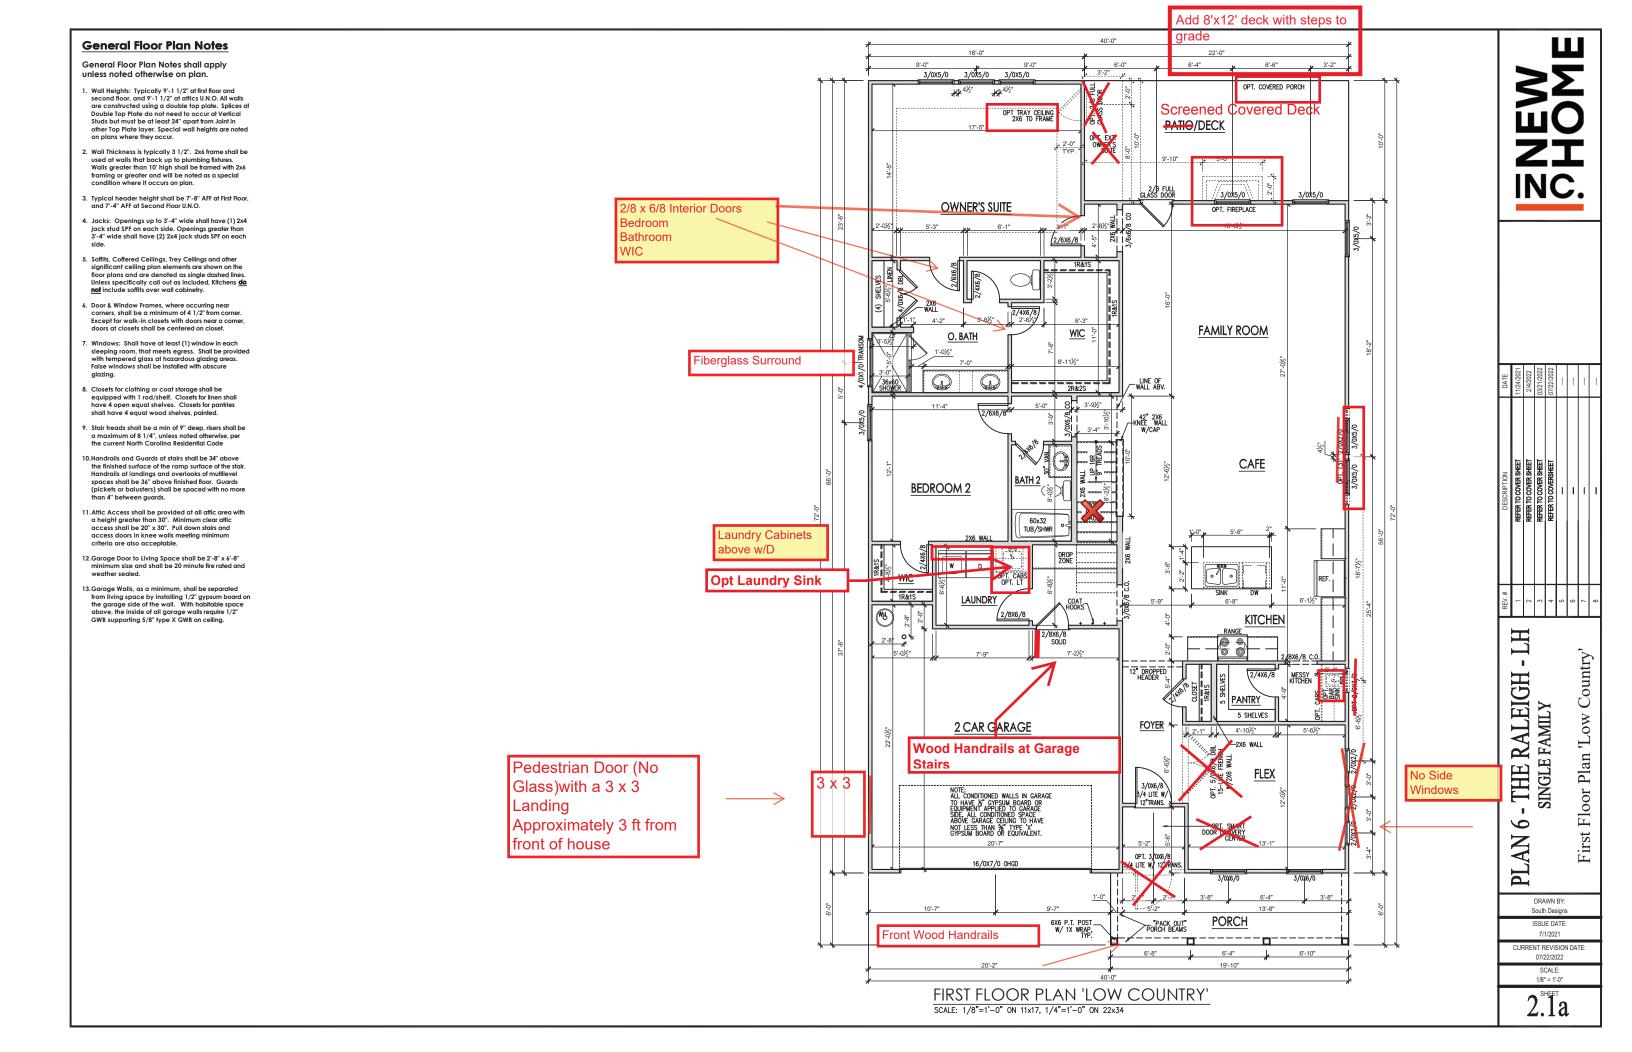

#### **General Floor Plan Notes**

General Floor Plan Notes shall apply unless noted otherwise on plan.

- Wall Heights: Typically 9'-1 1/2" at first floor and second floor, and 9'-1 1/2" at attics U.N.O. All walls are constructed using a double top plate. Splices at Double Top Plate do not need to occur at Vertical Studs but must be at least 24" apart from Joint in other Top Plate layer. Special wall heights are noted on plans where they occur.
- Wall Thickness is typically 3 1/2". 2x6 frame shall be used at walls that back up to plumbing fixtures.
   Walls greater than 10' high shall be framed with 2x6 framing or greater and will be noted as a special condition where it occurs on plan.
- Typical header height shall be 7'-8" AFF at First Floor, and 7'-4" AFF at Second Floor U.N.O.
- Jacks: Openings up to 3'-4" wide shall have (1) 2x4 jack stud SPF on each side. Openings greater than 3'-4" wide shall have (2) 2x4 jack studs SPF on each side.
- 5. Soffits, Coffered Ceilings, Trey Ceilings and other significant ceiling plan elements are shown on the floor plans and are denoted as single dashed lines. Unless specifically call out as included, Kitchens <u>do</u> <u>not</u> include soffits over wall cabinetry.
- Door & Window Frames, where occurring near corners, shall be a minimum of 4 1/2" from corner. Except for walk-in closets with doors near a corner, doors at closets shall be centered on closet.
- Windows: Shall have at least (1) window in each sleeping room, that meets egress. Shall be provided with tempered glass at hazardous glazing areas. False windows shall be installed with obscure glazing.
- Closets for clothing or coat storage shall be equipped with 1 rod/shelf. Closets for linen shall have 4 open equal shelves. Closets for pantries shall have 4 equal wood shelves, painted.
- Stair treads shall be a min of 9" deep, risers shall be a maximum of 8 1/4", unless noted otherwise, per the current North Carolina Residential Code
- 10. Handrails and Guards at stairs shall be 34" above the finished surface of the ramp surface of the stair. Handrails at landings and overlooks of multilevel spaces shall be 36" above finished floor. Guards (pickets or balusters) shall be spaced with no more than 4" between guards.
- 11. Attic Access shall be provided at all attic area with a height greater than 30". Minimum clear attic access shall be 20" x 30". Pull down stairs and access doors in knee walls meeting minimum criteria are also acceptable.
- 12. Garage Door to Living Space shall be 2'-8" x 6'-8" minimum size and shall be 20 minute fire rated and weather sealed.
- 13. Garage Walls, as a minimum, shall be separated from living space by installing 1/2" gypsum board on the garage side of the wall. With habitable space above, the inside of all garage walls require 1/2" GWB supporting 5/8" type X GWB on ceiling.

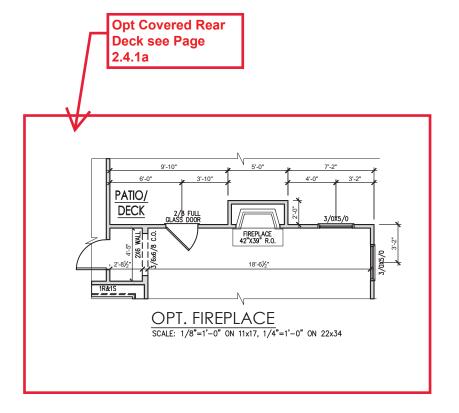

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DATE	11/24/2021	2/4/2022	03/21/2022	07/22/2022			-	-
DESCRIPTION	REFER TO COVER SHEET	REFER TO COVER SHEET	REFER TO COVER SHEET	REFER TO COVERSHEET		_		
REV.#	-	2	3	4	5	9	7	8

PLAN 6 - THE RALEIGH SINGLE FAMILY First Floor Options 'Low Country'

- LH

DRAWN BY: South Designs

ISSUE DATE: 7/1/2021

CURRENT REVISION DATE: 07/22/2022

> SCALE: 1/8" = 1'-0"

2.1.1s

## 40'-0" **General Floor Plan Notes** 22'-0" General Floor Plan Notes shall apply unless noted otherwise on plan. Wall Heights: Typically 9°-1 1/2" at first floor and second floor, and 9°-1 1/2" at affics U.N.O. All walls are constructed using a double top plate. Splices at Double Top Plate do not need to occur at Vertical Studs but must be at least 24" apart from Joint in other Top Plate layer. Special wall heights are noted on plans where they occur. 2. Wall Thickness is typically 3 1/2". 2x6 frame shall be used at walls that back up to plumbing fixtures. Walls greater than 10' high shall be framed with 2x6 framing or greater and will be noted as a special condition where it occurs on plan. 3. Typical header height shall be 7'-8" AFF at First Floor, and 7'-4" AFF at Second Floor U.N.O. LINE OF WALLS BELOW Jacks: Openings up to 3'-4" wide shall have (1) 2x4 jack stud SPF on each side. Openings greater than 3'-4" wide shall have (2) 2x4 jack studs SPF on each 5. Soffits, Coffered Ceilings, Trey Ceilings and other significant ceiling plan elements are shown on the floor plans and are denoted as single dashed lines. Unless specifically call out as included, Kitchens do not include soffits over wall cabinetry. Door & Window Frames, where occurring near corners, shall be a minimum of 4 1/2" from corner. Except for walk-in closets with doors near a corner, doors at closets shall be centered on closet. 7. Windows: Shall have at least (1) window in each willdows. Shall have a reast (1) will own leaden sleeping room, that meets egress. Shall be provided with tempered glass at hazardous glazing areas. False windows shall be installed with obscure Closets for clothing or coat storage shall be equipped with 1 rod/shelf. Closets for linen shall have 4 open equal shelves. Closets for pantries shall have 4 equal wood shelves, painted. +/-8'-0" CLG HT W/O FURRING +/-8'-0" CLG HT W/O FURRING 9. Stair treads shall be a min of 9" deep, risers shall be a maximum of 8 1/4", unless noted otherwise, per the current North Carolina Residential Code Opt Office/Home MECHANICAL ROOM 11/ OPT. OFFICE, OPT. HOME GYM OR OPT. SUPER GAMEROOM 10. Handrails and Guards at stairs shall be 34" above the finished surface of the ramp surface of the stair. Gym & Mechanical Handralis at landings and overlooks of multilevel spaces shall be 36" above finished floor. Guards (pickets or balusters) shall be spaced with no more than 4" between guards. Room see Page 24"X36" ATTIC ACCESS WEATHER STRIPPED – AND INCULATED 2.2.1a 11. Attic Access shall be provided at all attic area with a height greater than 30". Minimum clear attic access shall be 20" x 30". Pull down stairs and access doors in knee walls meeting minimum criteria are also acceptable OPT. OFFICE PT. HOME GYM SUPER GAME 12.Garage Door to Living Space shall be 2'-8" x 6'-8" UNFINISHED minimum size and shall be 20 minute fire rated and weather sealed. WIC STORAGE 13. Garage Walls, as a minimum, shall be separated from living space by installing 1/2" gypsum board on the garage side of the wall. With habitable space above, the inside of all garage walls require 1/2" GWB supporting 5/8" type X GWB on ceiling. (4) SHELVE HT-BEDROOM 4 - THE RALEIGH BATH 3 **GAME ROOM** BEDROOM 3 9 PLAN 60x32 5 FALSE | SHUTTERS CURRENT REVISION DATE

7'-0"

3'-1"

SECOND FLOOR PLAN 'LOW COUNTRY'

3'-1"

SCALE: 1/8"=1'-0" ON 11x17, 1/4"=1'-0" ON 22x34

3'-8"

6'-4"

Country'

Floor Plan 'Low

Second ]

South Designs ISSUE DATE: 7/1/2021


> SCALE: 1/8" = 1'-0"

2.2a

#### **General Floor Plan Notes**

General Floor Plan Notes shall apply unless noted otherwise on plan.

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- Windows: Shall have at least (1) window in each sleeping room, that meets egress. Shall be provided with tempered glass at hazardous glazing areas. False windows shall be installed with obscure glazing.
- Closets for clothing or coat storage shall be equipped with 1 rod/shelf. Closets for linen shall have 4 open equal shelves. Closets for pantries shall have 4 equal wood shelves, painted.
- Stair treads shall be a min of 9" deep, risers shall be a maximum of 8 1/4", unless noted otherwise, per the current North Carolina Residential Code
- 10. Handrails and Guards at stairs shall be 34" above the finished surface of the ramp surface of the stair. Handrails at landings and overlooks of multilevel spaces shall be 36" above finished floor. Guards (pickets or balusters) shall be spaced with no more than 4" between guards.
- 11.Attic Access shall be provided at all attic area with a height greater than 30". Minimum clear attic access shall be 20" x 30". Pull down stairs and access doors in knee walls meeting minimum criteria are also acceptable.
- 12. Garage Door to Living Space shall be 2'-8" x 6'-8" minimum size and shall be 20 minute fire rated and weather sealed.
- 13. Garage Walls, as a minimum, shall be separated from living space by installing 1/2" gypsum board on the garage side of the wall. With habitable space above, the inside of all garage walls require 1/2" GWB supporting 5/8" type X GWB on ceiling.

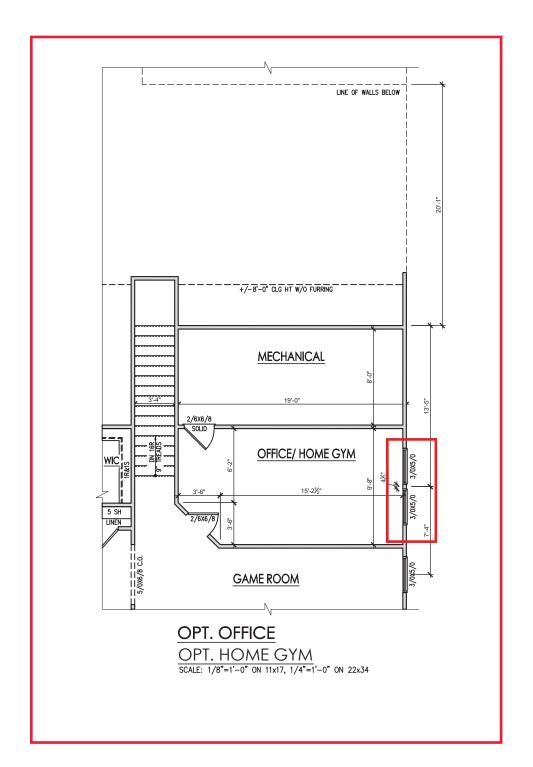



1   REFER TO COVER SHEET   1/24/2021   1/24/2021   1/24/2021   2   REFER TO COVER SHEET   2/4/2021   2/4/202
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PLAN 6 - THE RALEIGH - LH SINGLE FAMILY

Second Floor Plan Options 'Low Country'


DRAWN BY: South Designs

ISSUE DATE: 7/1/2021


CURRENT REVISION DATE:

SCALE: 1/8" = 1'-0"


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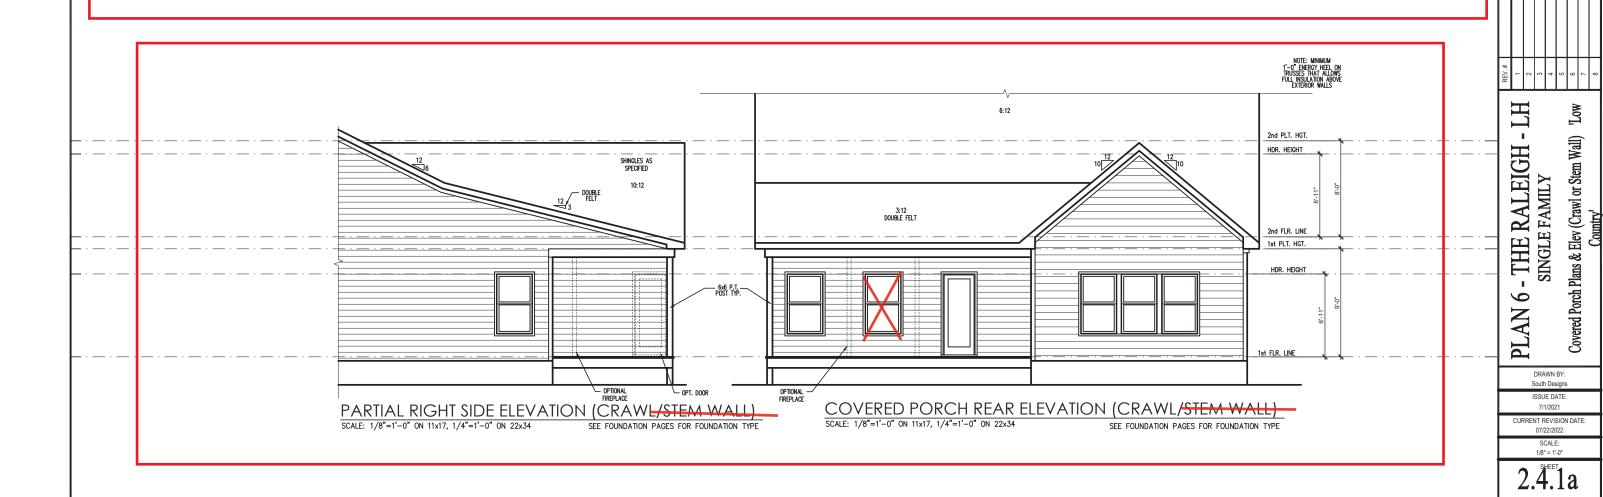


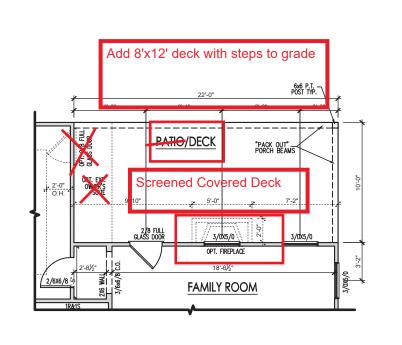COVERED PORCH FLOOR PLAN
SCALE: 1/8"=1'-0" ON 11x17, 1/4"=1'-0" ON 22x34

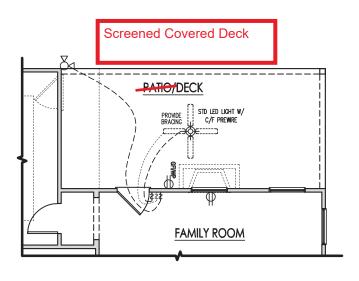

COVERED PORCH ELECTRICAL SCALE: 1/8"=1'-0" ON 11x17, 1/4"=1'-0" ON 22x34



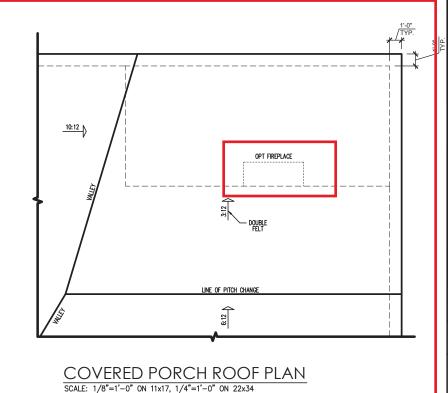


#### **General Elevation Notes**

General Elevation Notes shall apply unless noted otherwise on plan.

- Roof shall be finished with architectural composition shingles with slopes as noted on plan.
- Ridge Vent shall be provided and installed on all ridges greater than 6' in length per manufacturer's specifications.
- Soffit Vent shall be continuous soffit vent
- House Wrap, "tyvek" or approved equal shall be installed over entire exterior wall per manufacturer's specifications and recommendations.
- Flashing shall be provided above all door and window openings, above finish wall material changes and at wall surfaces where lower roof areas abut vertical wall surfaces.
- Porch Railings shall be provided at all porch walking surfaces greater than 30" above adjacent finished grade. It shall be 36" high with guards spaced no more than 4" apart. Consult community specifications for material.
- Finish Wall Material shall be as noted on elevation drawings.
- 8. Brick Veneer, if included on elevation shall be fied to wall surface with galvanized corrugated metal ties at a rate of 24" oc horizontally and 16" oc vertically so that no more than 2.67sf of brick is supported by (1) fle. Space between face of wall and back face of brick shall be limited to a maximum of 1". Flashing shall be provided behind brick above all wall openings and at base of brick wall. Rashing shall be a minimum of 6-mil poly or other corrosion resistant material and shall be installed so that it laps under the house wrap material a minimum of 2".
  Weepholes shall be provided at a rate of 48" oc and shall not be less than 3/16" in diameter and shall be located immediately above flashing.
- Brick Veneer Support Lintels shall be provided if brick veneer is included on elevation. Lintels shall be provided as listed in the following schedule and shall have a minimum bearing length of 6". Masonry Lintels shall be provided so that deflection is limited to L/600.

#### Masonry Openina Lintel Schedule

Opening S	Size	Angle
up to 4'-0'		3-1/2" x 3-1/2" x 5/16"
4'-1" to	5'-6"	4" x 3-1/2" x 5/16" LLV
5'-7" to	6'-6"	5" x 3-1/2" x 5/16" LLV
6'-7" to	8'-4"	6" x 3-1/2" x 5/16" LLV
8'-5" to	16'-4"	7" v 4" v 3/8" IIV

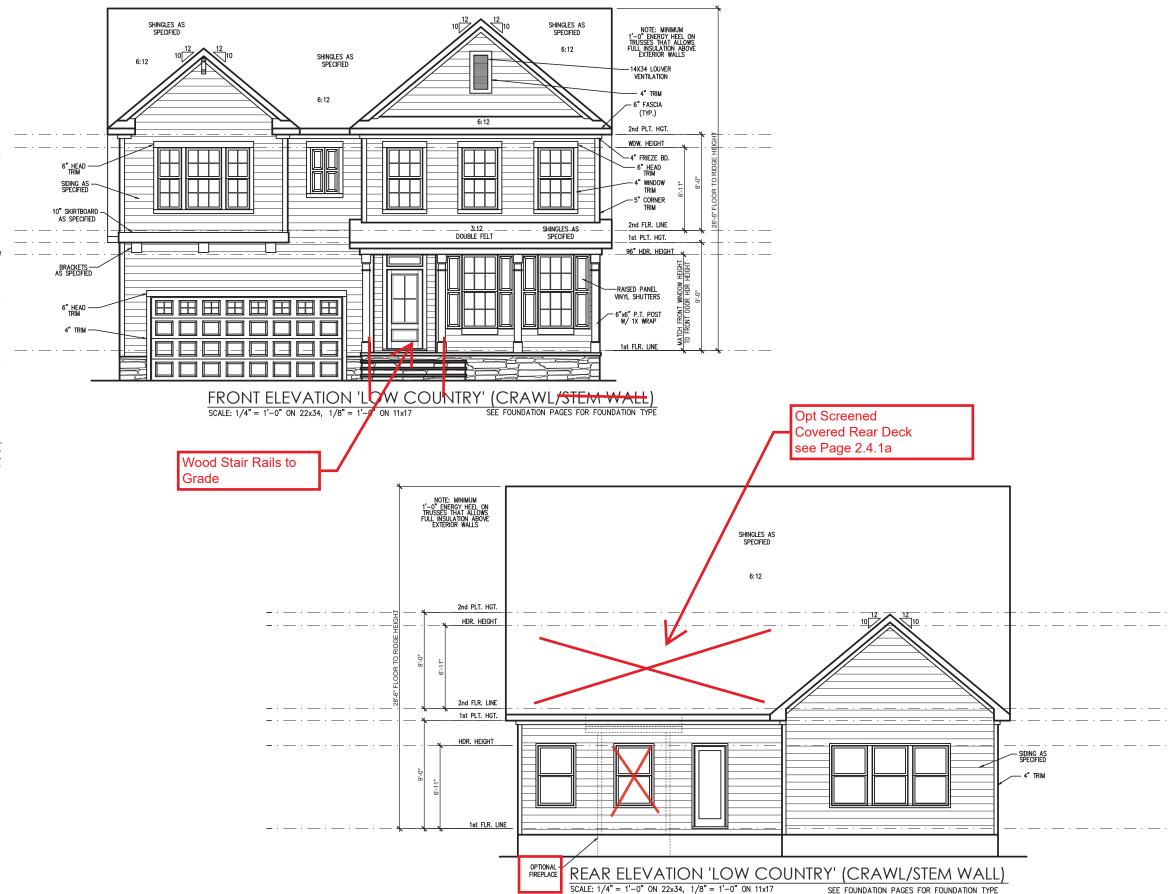



DESCRIPTION DATE	REFER TO COVER SHEET	REFER TO COVER SHEET 2/4/2022	REFER TO COVER SHEET 03/21/2022	REFER TO COVERSHEET		-		
REV.#	-	2	3	4	2	9	7	8
						>		

PLAN 6 - THE RALEIGH - LH SINGLE FAMILY Front & Rear Elev (Crawl or Stem Wall) 'Low Country'

> DRAWN BY: South Designs

ISSUE DATE: 7/1/2021

CURRENT REVISION DATE: 07/22/2022 SCALE: 1/8" = 1'-0"

3.1.1a

#### **General Elevation Notes**

General Elevation Notes shall apply unless noted otherwise on plan.

- Roof shall be finished with architectural composition shingles with slopes as noted on plan.
- 2. Ridge Vent shall be provided and installed on all ridges greater than  $\delta'$  in length per manufacturer's specifications.

NOTE: MINIMUM 1'-0" ENERGY HEEL ON TRUSSES THAT ALLOWS FULL INSULATION ABOVE EXTERIOR WALLS

2nd PLT. HGT.

WDW. HEIGHT

2nd FLR. LINE 1st PLT. HGT. SIDING AS -SPECIFIED

SHINGLES AS SPECIFIED

10:12


- 3. Soffit Vent shall be continuous soffit vent
- House Wrap, "tyvek" or approved equal shall be installed over entire exterior wall per manufacturer's specifications and recommendations.
- Flashing shall be provided above all door and window openings, above finish wall material changes and at wall surfaces where lower roof areas abut vertical wall surfaces.
- Porch Railings shall be provided at all porch walking surfaces greater than 30" above adjacent finished grade. It shall be 36" high with guards spaced no more than 4" apart. Consult community specifications for material.
- Finish Wall Material shall be as noted on elevation drawings.
- Brick Veneer, if included on elevation shall be fied to wall surface with galvanized corrugated metal fies at a rate of 24" oc horizontally and 16" oc vertically so that no more than 2.675 of brick is supported by (1) fie. Space between face of wall and back face of brick shall be limited to a maximum of 1". Flashing shall be provided behind brick above all wall openings and at base of brick wall. Flashing shall be a minimum of 6-mil poly or other cornsoin resistant material and shall be installed so that it laps under the house wrap material a minimum of 2".

material and shall be installed so that it laps under the house wrap material a minimum of 2".  Weepholes shall be provided at a rate of 48" oc and shall not be less than 3/16" in diameter and shall be located immediately above flashing.  9. Brick Veneer Support Lintels shall be provided as listed in the following schedule and shall have a minimum bearing length of 6". Masonry Lintels shall be provided as listed in the following schedule and shall have a minimum bearing length of 6". Masonry Lintels shall be provided so that deflection is limited to L/600.  Masonry Opening Lintel Schedule  Opening Size Angle  up to 4".0" 3-1/2" x 3-1/2" x 5/16" LLV 5".7" to 6".6" 5" x 3-1/2" x 5/16" LLV 6".7" to 8".4" 6" x 3-1/2" x 5/16" LLV 8".5" to 16".4" 7" x 4" x 3/8" LLV	OPTIONAL RIGHT SIDE ELEVATION 'LOW COUNTRY' (CRAWL/STEM WALL) SCALE: 1/4" = 1'-0" ON 22x34, 1/8" = 1'-0" ON 11x17  SEE FOLINDATION PAGES FOR FOLINDATION TYPE Opt Screened Covered Rear Deck see Page 2.4.1a	DESCRIPTION   DATE
Pedestrian Door No Glass with a 3 x 3 Landing Approximately 3 ft from front of house	SHOULD AND STORY OF THE MANAGE AS STORY OF TH	PLAN 6 - THE RALEIGH - LH  SINGLE FAMILY  SINGLE FAMILY  Side Elevations (Crawl or Stem Wall)  Low Country'  Salary  Low Country'
	LEFT SIDE ELEVATION 'LOW COUNTRY' (CRAWL/STEM WALL)  SCALE: 1/4" = 1'-0" ON 22x34, 1/8" = 1'-0" ON 11x17 SEE FOUNDATION PAGES FOR FOUNDATION TYPE	3.2.1a

- OPTIONAL WINDOWS W/OFFICE, HOME GYM, OR SUPER GAME

SHINGLES AS SPECIFIED

-OPTIONAL COVERED PATIO

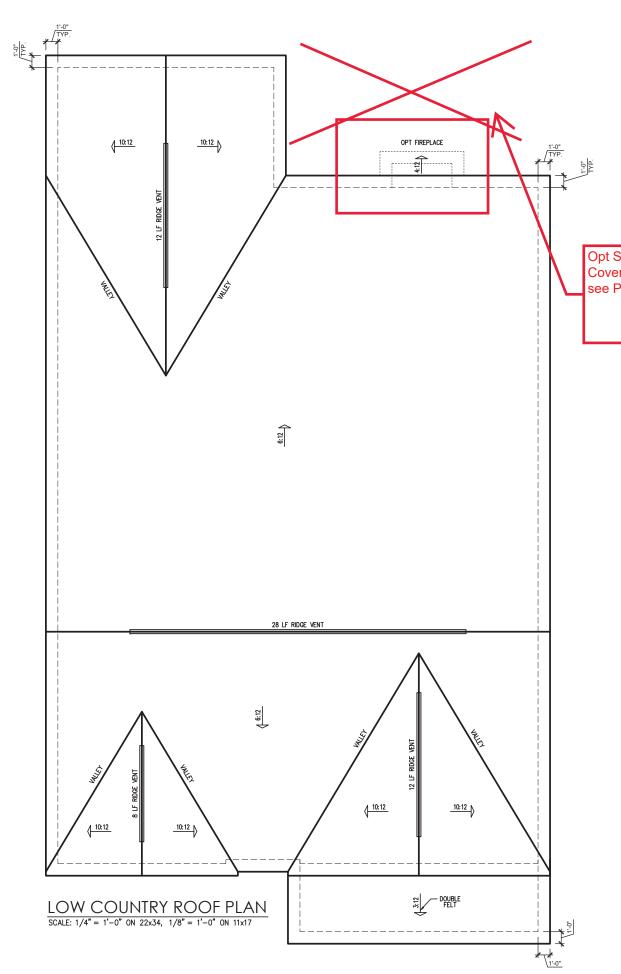

			A	TTIC '	VENT S	CHEDU	LE		
				L	OW COU	NTRY			
MAIN	HOUSE		SQ FTG	2431	AT	/ NEAR RID	AT / NEAR EAVE		
VENT TYPE	SQ. FT. REQUIRED		SQ. FT.	PERCENT OF TOTAL	POT LARGE (SQ. FT. EACH)	POT SMALL (SQ. FT. EACH)	RIDGE VENT (SQ. FT. PER LF)	EAVE VENT (SQ. IN. EACH)	CONT. VENT (SQ. IN. PERLE)
	RAN			SUPPLIED	0.4236	0.2778	0.125	0.1944	0.0625
RIDGE VENT	3.24	4.05	7.50	70.59	0	0	60.00		
SOFFIT VENTS	4.86	4.05	3.13	29.41				0	50.00
TOTAL (MIN)	8.10	8.10	10.63	100.00	POT VENTS MAY BE	REQUIRED IF THERE	IS INSUFFICIENT RID	GE AVAILABLE	

\* SCHEDULE HAS BEEN CALCULATED ASSUMING EAVE VENTILATION AT 50-60% OF TOTAL AND RIDGE AT 40-50% OF TOTAL REQUIRED VENTILATION

Opt Screened Covered Rear Deck see Page 2.4.1a NEW CONTRACT

DATE	11/24/2021	2/4/2022	03/21/2022	07/22/2022				
DESCRIPTION	REFER TO COVER SHEET	REFER TO COVER SHEET	REFER TO COVER SHEET	REFER TO COVERSHEET	comer .	_		
REV.#	-	2	3	4	5	9	7	8


PLAN 6 - THE RALEIGH - LE SINGLE FAMILY Roof Plan 'Low Country'

> DRAWN BY: South Designs

ISSUE DATE: 7/1/2021

CURRENT REVISION DATE: 07/22/2022 SCALE: 1/8" = 1'-0"

3.3a

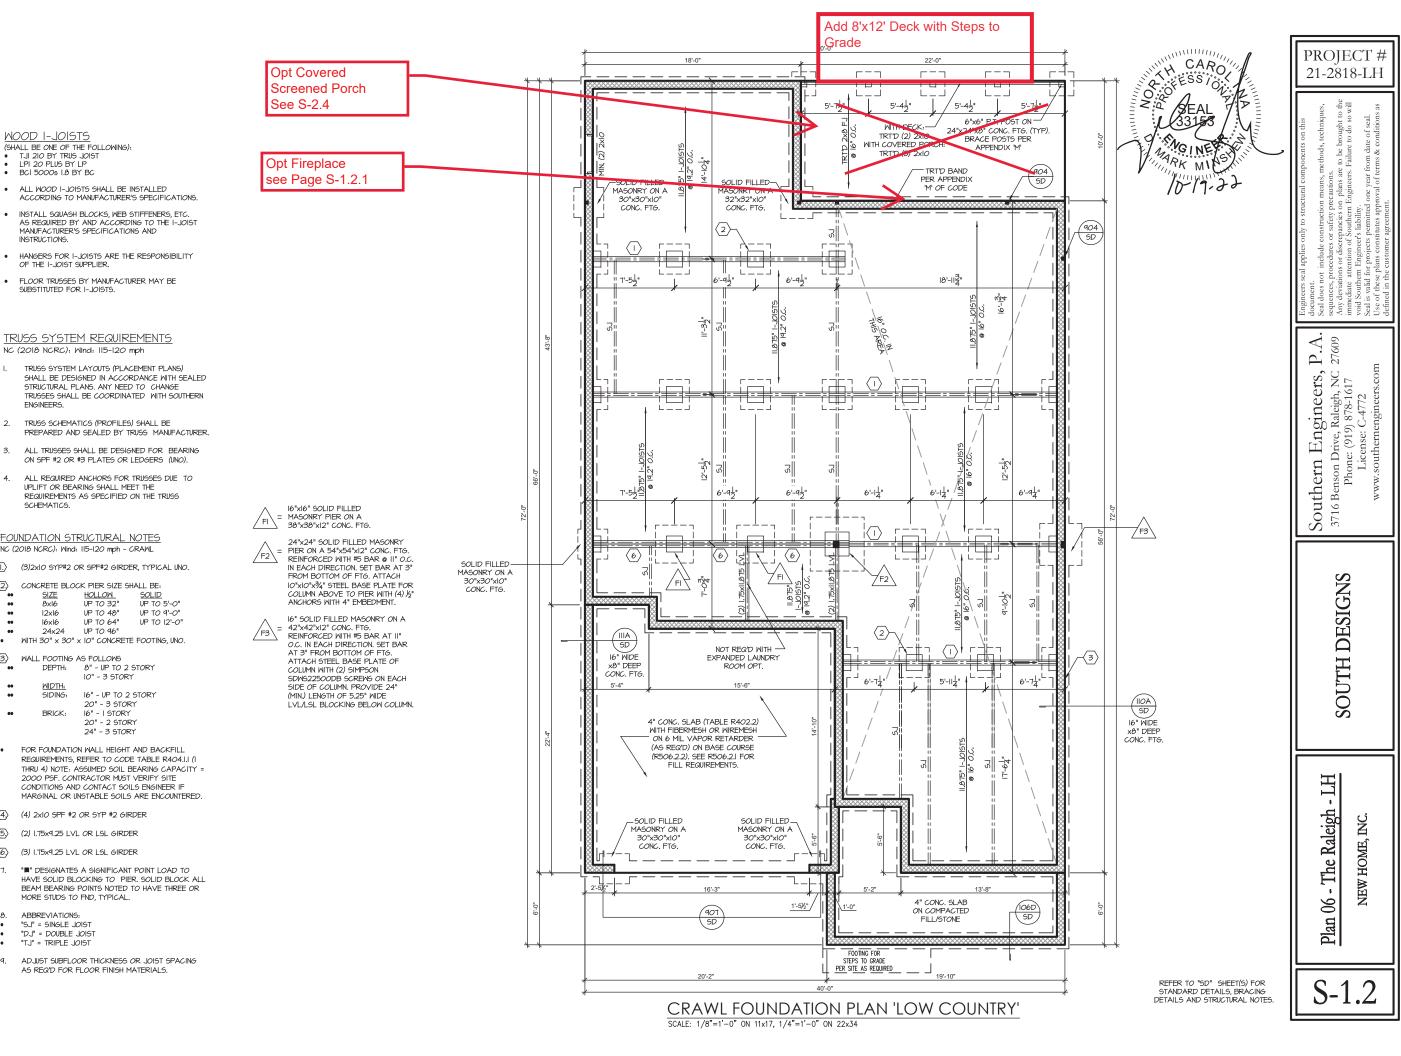

MOOD I-JOISTS

I PI 20 PI IIS BY I P

(SHALL BE ONE OF THE FOLLOWING):

• TJI 210 BY TRUS JOIST

MANUFACTURER'S SPECIFICATIONS AND

FLOOR TRUSSES BY MANUFACTURER MAY BE SUBSTITUTED FOR I-JOISTS.

TRUSS SYSTEM REQUIREMENTS NC (2018 NCRC): Wind: 115-120 mph

TRUSS SCHEMATICS (PROFILES) SHALL BE

UPLIFT OR BEARING SHALL MEET THE REQUIREMENTS AS SPECIFIED ON THE TRUSS

FOUNDATION STRUCTURAL NOTES

CONCRETE BLOCK PIER SIZE SHALL BE:

HOLLOW UP TO 32"

UP TO 64"

UP TO 96"

8" - UP TO 2 STORY

16" - UP TO 2 STORY

10" - 3 STORY

16" - I STORY

2000 PSF. CONTRACTOR MUST VERIFY SITE

20" - 2 STORY 24" - 3 STORY

SOLID UP TO 5'-O"

NC (2018 NCRC): Wind: 115-120 mph - CRAWL

SCHEMATICS

8xl6

24x24

DEPTH:

SIDING:

BRICK:

WALL FOOTING AS FOLLOWS

(4) 2xIO SPF #2 OR SYP #2 GIRDER

(2) 1.75×9.25 LVL OR LSL GIRDER

(3) 1.75×9.25 LVL OR LSL GIRDER

MORE STUDS TO FND, TYPICAL.

AS REQ'D FOR FLOOR FINISH MATERIALS.

ABBREVIATIONS: "SJ" = SINGLE JOIST "DJ" = DOUBLE JOIST "TJ" = TRIPLE JOIST

2


3

(5.)


(6)


Project #: 21-2818-B.1 (Lot 16) Page: 1 of 1 September 27, 2023 Plan 06 - The Raleigh, Low Country Lot 16, Woodbridge South RE: Added deck to rear of screened



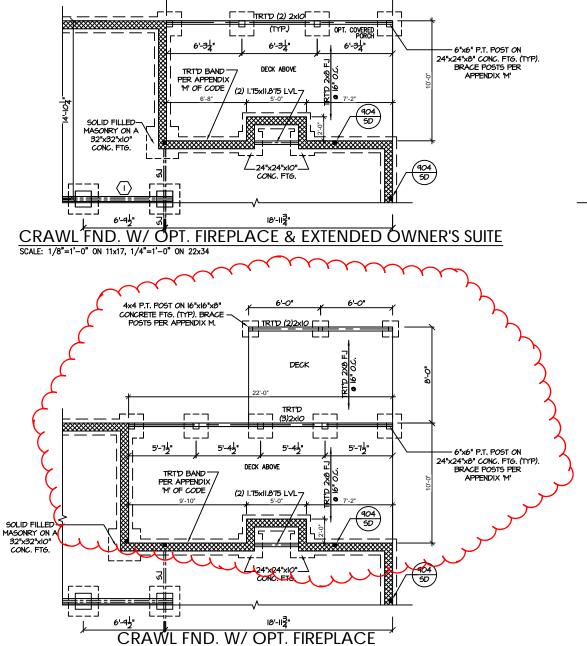

SCALE: 1/8"=1'-0" ON 11x17, 1/4"=1'-0" ON 22x34

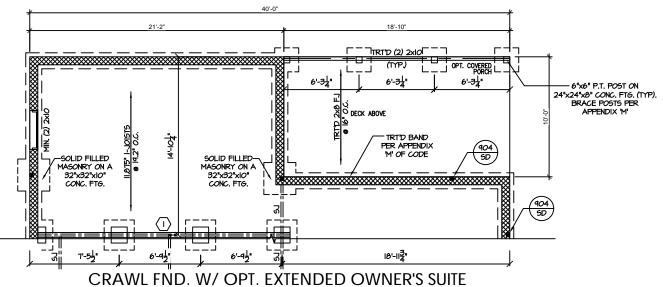

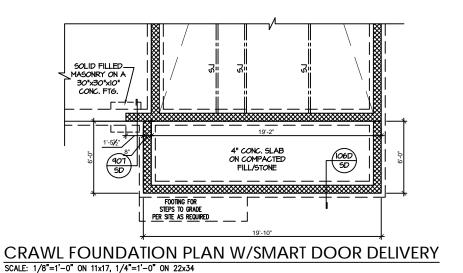


SCALE: 1/8"=1'-0" ON 11x17, 1/4"=1'-0" ON 22x34


REFER TO "SD" SHEET(S) FOR STANDARD DETAILS, BRACING DETAILS AND STRUCTURAL NOTES.

PROJECT # 21-2818-LH

P.A. 27609 Southern Engineers, P 3716 Benson Drive, Raleigh, NC 27 Phone: (919) 878-1617 License: C-4772

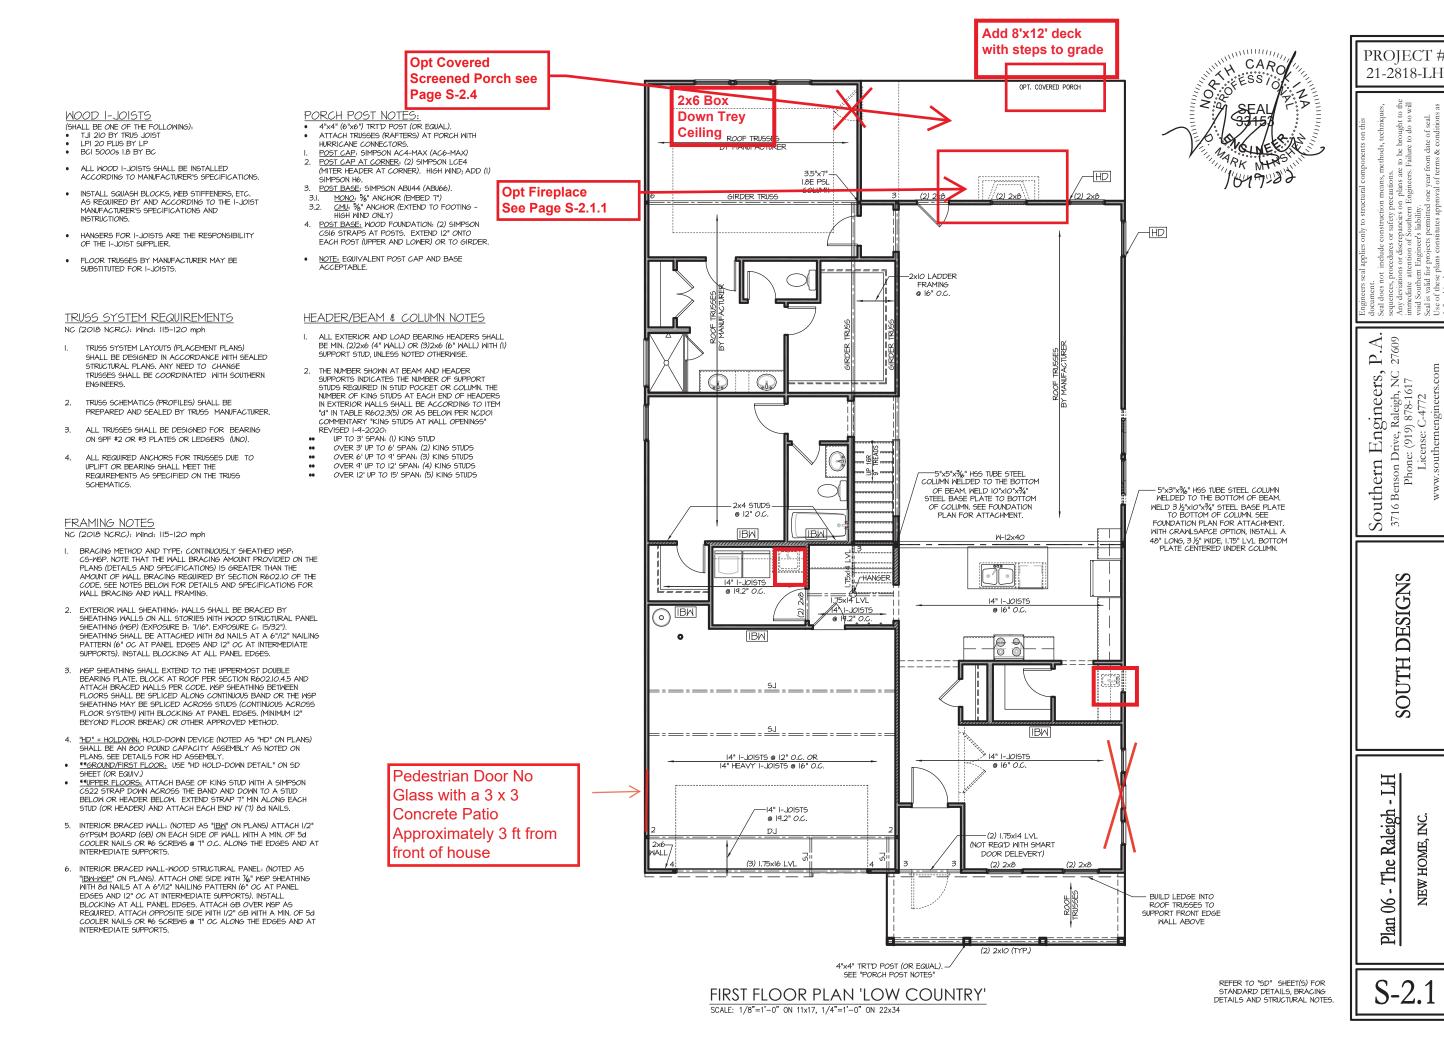

HOME,

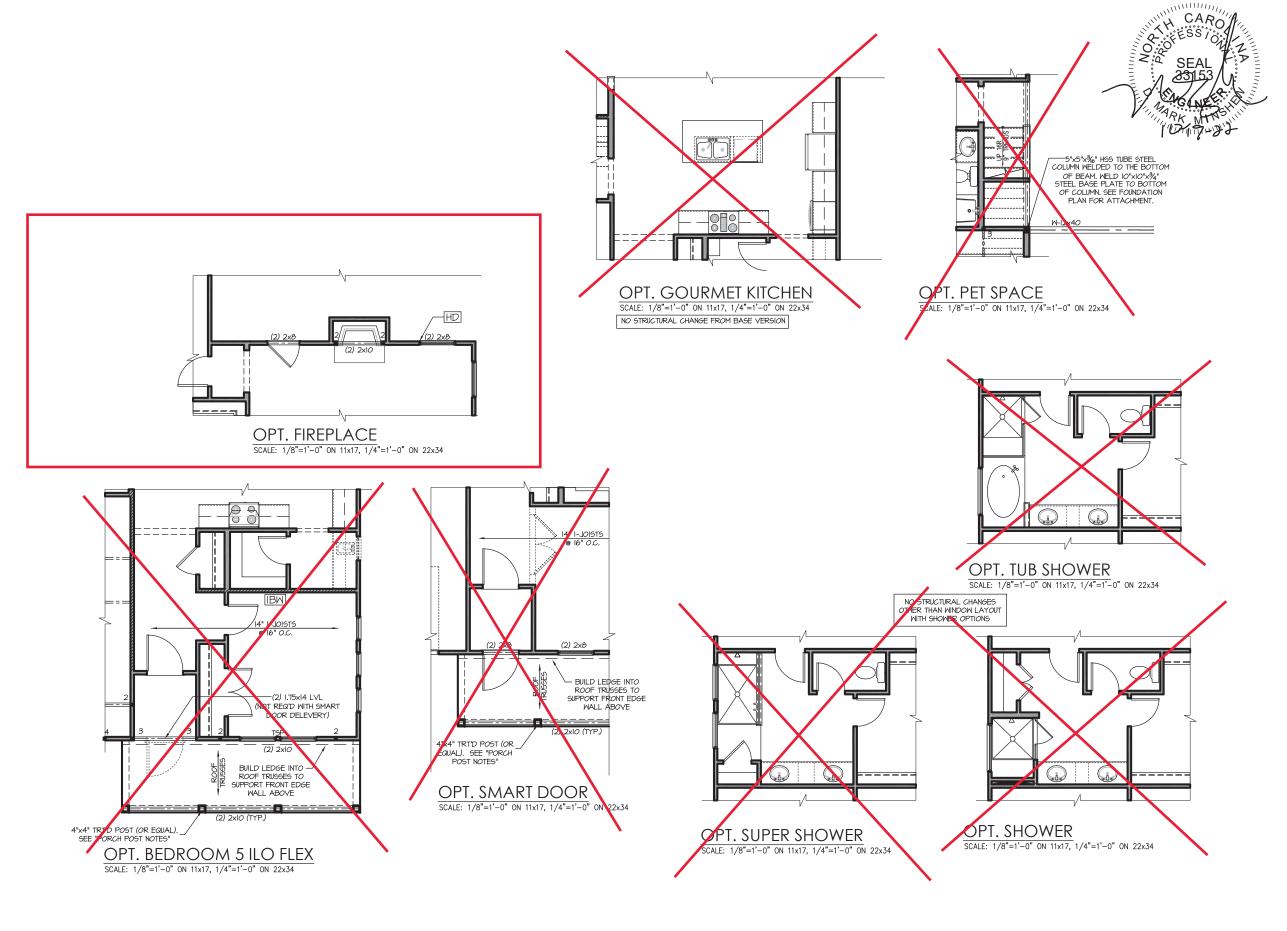

21-2818-LH

PROJECT #

Southern Engineers, P.A. 3716 Benson Drive, Raleigh, NC 27609 Phone: (919) 878-1617

SOUTH DESIGNS

Raleigh NEW HOME, The 90 Plan

REFER TO "SD" SHEET(S) FOR STANDARD DETAILS, BRACING DETAILS AND STRUCTURAL NOTES.

#### TRUSS SYSTEM REQUIREMENTS

NC (2018 NCRC): Wind: 115-120 mph

- I. TRUSS SYSTEM LAYOUTS (PLACEMENT PLANS)
  SHALL BE DESIGNED IN ACCORDANCE WITH SEALED
  STRUCTURAL PLANS, ANY NEED TO CHANGE
  TRUSSES SHALL BE COORDINATED WITH SOUTHERN
  ENGINEERS.
- TRUSS SCHEMATICS (PROFILES) SHALL BE
  PREPARED AND SEALED BY TRUSS MANUFACTURER.
- 3. ALL TRUSSES SHALL BE DESIGNED FOR BEARING ON SPF #2 OR #3 PLATES OR LEDGERS (UNO).
- ALL REQUIRED ANCHORS FOR TRUSSES DUE TO UPLIFT OR BEARING SHALL MEET THE REQUIREMENTS AS SPECIFIED ON THE TRUSS SCHEMATICS.

#### HEADER/BEAM & COLUMN NOTES

- ALL EXTERIOR AND LOAD BEARING HEADERS SHALL BE MIN. (2)2x6 (4" WALL) OR (3)2x6 (6" WALL) WITH (I) SUPPORT STUD, UNLESS NOTED OTHERWISE.
- 2. THE NUMBER SHOWN AT BEAM AND HEADER SUPPORTS INDICATES THE NUMBER OF SUPPORT STUDS REQUIRED IN STUD POCKET OR COLUMN, THE NUMBER OF KING STUDS AT EACH END OF HEADERS IN EXTERIOR WALLS SHALL BE ACCORDING TO ITEM "d" IN TABLE R602.3(5) OR AS BELOW PER NCDOI COMMENTARY "KING STUDS AT WALL OPENINGS" REVISED 1-4-2020;
- UP TO 3' SPAN: (I) KING STUD
- OVER 3' UP TO 6' SPAN: (2) KING STUDS
- OVER 6' UP TO 9' SPAN: (3) KING STUDS
  OVER 9' UP TO 12' SPAN: (4) KING STUDS
- OVER 9' UP TO 12' SPAN: (4) KING STUDS
  OVER 12' UP TO 15' SPAN: (5) KING STUDS


#### FRAMING NOTES

NC (2018 NCRC): Wind: 115-120 mph

- I. BRACING METHOD AND TYPE: CONTINUOUSLY SHEATHED WSP: C5-WSP, NOTE THAT THE WALL BRACING AMOUNT PROVIDED ON THE PLANG (DETAILS AND SPECIFICATIONS) IS GREATER THAN THE AMOUNT OF WALL BRACING REQUIRED BY SECTION R602.10 OF THE CODE, SEE NOTES BELOW FOR DETAILS AND SPECIFICATIONS FOR WALL BRACING AND WALL FRAMING
- 2. EXTERIOR WALL SHEATHING: WALLS SHALL BE BRACED BY SHEATHING WALLS ON ALL STORIES WITH WOOD STRUCTURAL PANEL SHEATHING (WGP) (EXPOSURE B: 71/6", EXPOSURE C: 15/32"). SHEATHING SHALL BE ATTACHED WITH 80 NAILS AT A 6"/12" NAILING PATTERN (6" OC AT PANEL EDGES AND 12" OC AT INTERMEDIATE SUPPORTS). INSTALL BLOCKING AT ALL PANEL EDGES.
- 3. WSP SHEATHING SHALL EXTEND TO THE UPPERMOST DOUBLE BEARING PLATE, BLOCK AT ROOF PER SECTION R602/10.4.5 AND ATTACH BRACED WALLS PER CODE, WSP SHEATHING BETWEEN FLOORS SHALL BE SPLICED ALONG CONTINUOUS BAND OR THE WSP SHEATHING MAY BE SPLICED ACROSS STUDS (CONTINUOUS ACROSS FLOOR SYSTEM) WITH BLOCKING AT PANEL EDGES. (MINIMUM 12" BEYOND FLOOR BREAK) OR OTHER APPROVED METHOD.
- 4. "HD" = HOLDOWN: HOLD-DOWN DEVICE (NOTED AS "HD" ON PLANS)
  SHALL BE AN 800 POUND CAPACITY ASSEMBLY AS NOTED ON
  PLANS, SEE DETAILS FOR HD ASSEMBLY.

   \*\*GROUND/EIRST FLOOR: USE "HD HOLD-DOWN DETAIL" ON SD
- SHEET (OR EQUIV.)

  \*\*UPPER FLOORS: ATTACH BASE OF KING STUD WITH A SIMPSON
- \*\*\*UPPER FLOORS: ATTACH BASE OF KING STUD WITH A SIMPSON CS22 STRAP DOWN ACROSS THE BAND AND DOWN TO A STUD BELOW OR HEADER BELOW. EXTEND STRAP T' MIN ALONG EACH STUD (OR HEADER) AND ATTACH EACH END W (1) 8d NAILS.
- INTERIOR BRACED WALL: (NOTED AS "IBW" ON PLANS) ATTACH I/2" GYPSIM BOARD (GB) ON EACH SIDE OF WALL WITH A MIN. OF 5d COOLER NAILS OR #6 SCREWS @ 1" O.C. ALONG THE EDGES AND AT INTERMEDIATE SUPPORTS.
- 6. INTERIOR BRACED WALL-WOOD STRUCTURAL PANEL: (NOTED AS "IBM-MSP" ON PLANS). ATTACH ONE SIDE WITH "%" WSP SHEATHING WITH 3d NAILS AT A 6"/12" NAILING PATTERN (6" OC AT PANEL EDGES AND 12" OC AT INTERMEDIATE SUPPORTS). INSTALL BLOCKING AT ALL PANEL EDGES. ATTACH 6B OVER WSP AS REQUIRED. ATTACH OPPOSITE SIDE WITH 1/2" 6B WITH A MIN. OF 5d COOLER NAILS OR "86 SCREWS @ 7" OC ALONG THE EDGES AND AT INTERMEDIATE SUPPORTS.

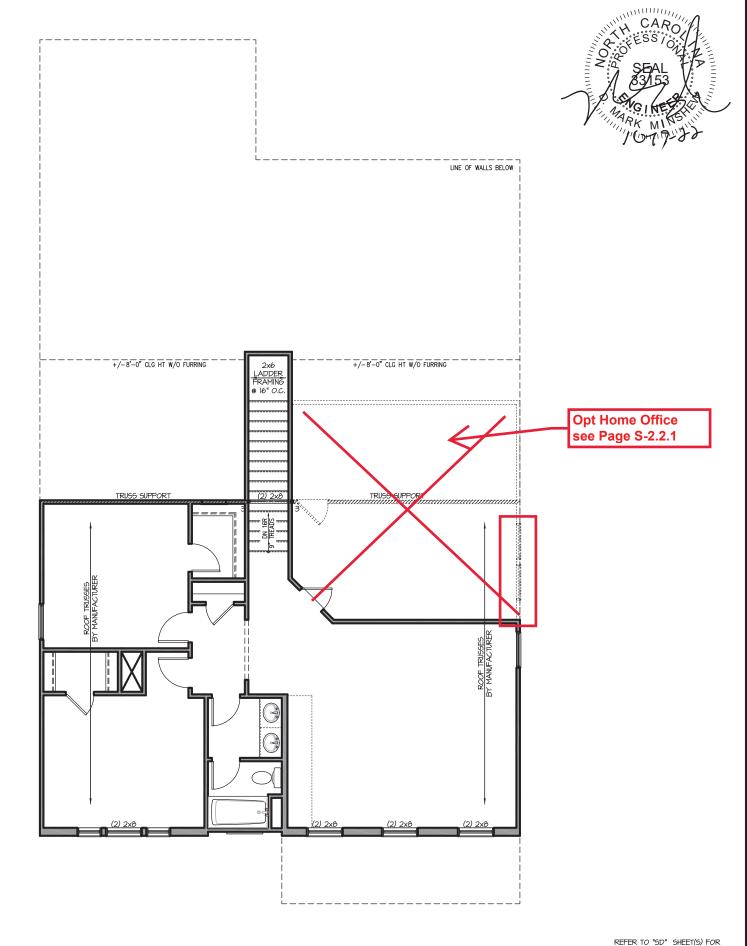

SECOND FLOOR PLAN 'LOW COUNTRY'
SCALE: 1/8"=1'-0" ON 11x17, 1/4"=1'-0" ON 22x34

STANDARD DETAILS, BRACING DETAILS AND STRUCTURAL NOTES. S-2.2

Raleigh


PROJECT # 21-2818-LH

L Engineers, Drive, Raleigh, NC ?

Southern

SOUTH DESIGNS

LINE OF WALLS BELOW +/-8'-0" CLG HT W/O FURRING ROOF TRUSSES BY MANUFACTURER OPT. OFFICE OPT. HOME GYM SCALE: 1/8"=1'-0" ON 11x17, 1/4"=1'-0" ON 22x34

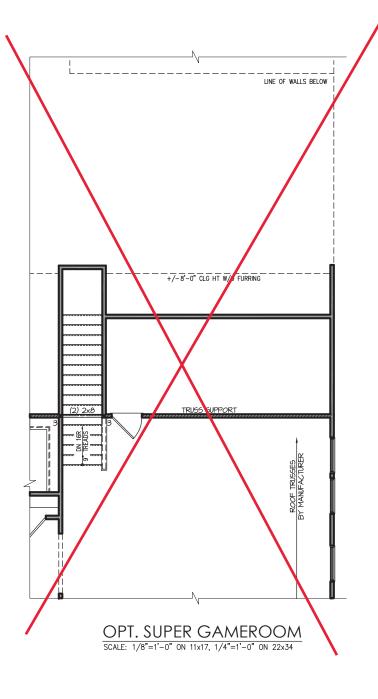


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PROJECT# 21-2818-LH

SOUTH DESIGNS

Plan 06 - The Raleigh - LH NEW HOME, INC.

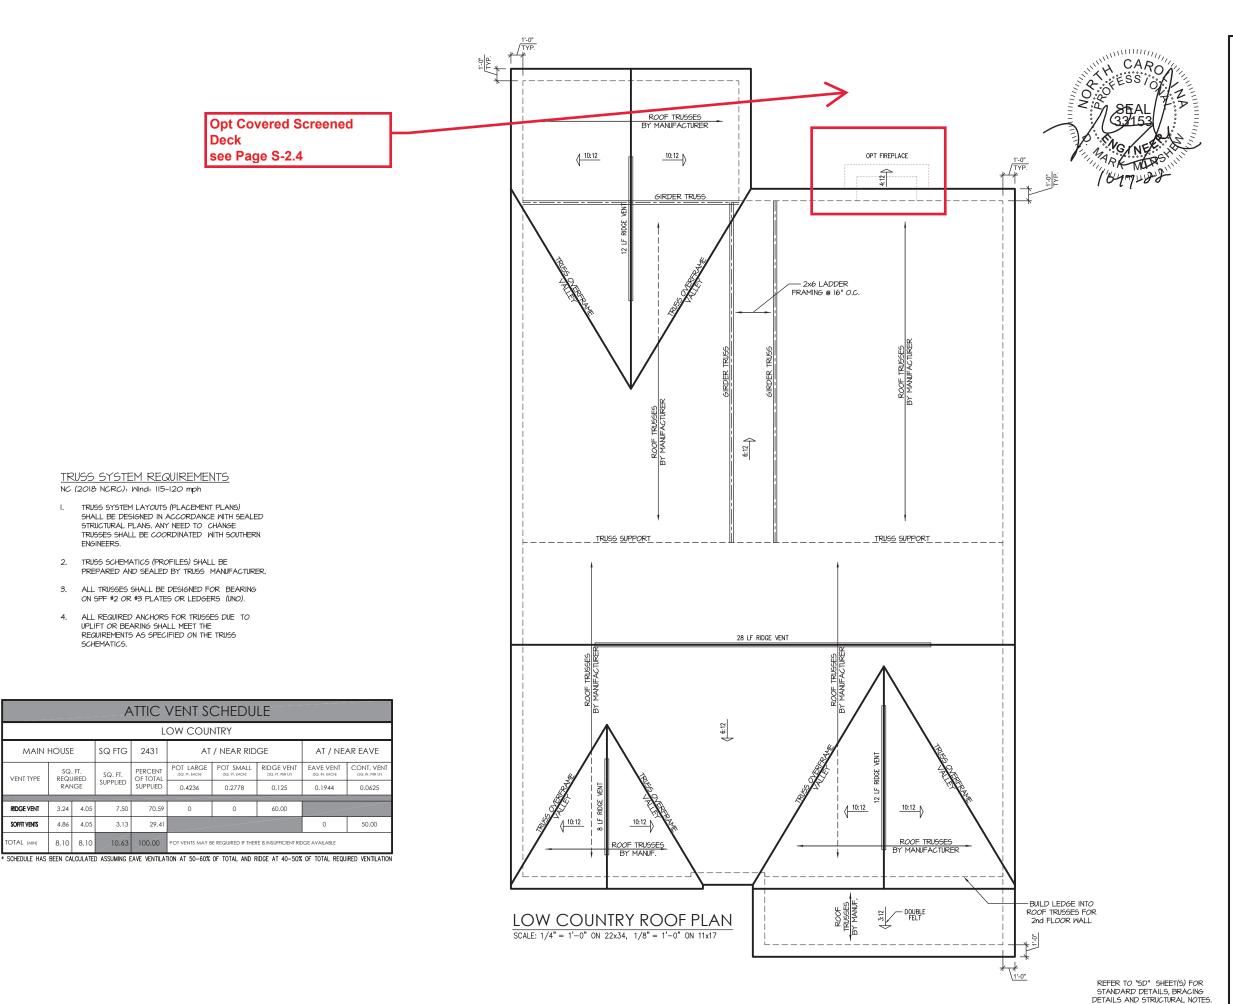

ENGINEERS.

SQ. FT. SUPPLIED

7.50

3.13

MAIN HOUSE

REQUIRED RANGE

3.24 4.05

4.86

VENT TYPE

RIDGE VENT

SOFFIT VENTS


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SOUTH DESIGNS


Raleigh NEW HOME, The 90

Plan



#### TRUSS SYSTEM REQUIREMENTS NC (2018 NCRC): Wind: 115-120 mph
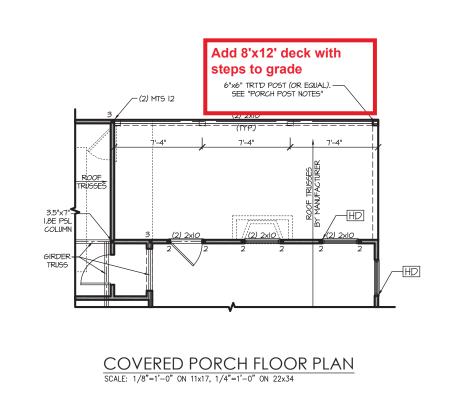
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COVERED PORCH ROOF PLAN SCALE: 1/8"=1'-0" ON 11x17, 1/4"=1'-0" ON 22x34

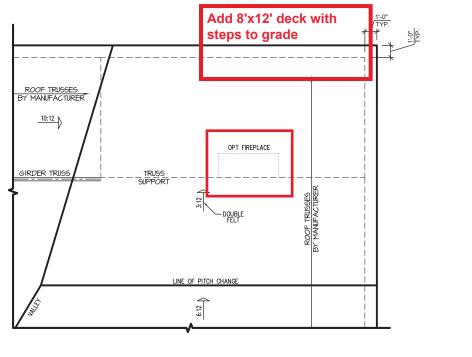Add 8' x 12' Deck with stairs to grade 6:12 2nd PLT. HGT. HDR. HEIGHT SHINGLES AS 3:12 DOUBLE FELT 1st PLT. HGT. HDR. HEIGHT OPTIONAL -FIREPLACE COVERED PORCH REAR ELEVATION PARTIAL RIGHT SIDE ELEVATION SCALE: 1/8"=1'-0" ON 11x17, 1/4"=1'-0" ON 22x34 SCALE: 1/8"=1'-0" ON 11x17, 1/4"=1'-0" ON 22x34

REFER TO "SD" SHEET(S) FOR STANDARD DETAILS, BRACING DETAILS AND STRUCTURAL NOTES.

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SOUTH DESIGNS

The Raleigh NEW HOME, INC. Plan 06