REVISION LOG

ADJUST OPTION SQUARE FOOTAGES TO ACCURATELY SHOW THE DIFFERENCES FROM THE BASE PLAN SQUARE FOOTAGE TOTALS.

ADJUST OPTION SQUARE FOOTAGES TO ACCURATELY SHOW THE DIFFERENCES FROM THE BASE PLAN SQUARE FOOTAGE TOTALS.

EXTENDED TRIM AT GARAGE DOOR DOWN TO BASE AND CUT STONE BACK ADJUSTED KITCHEN ISLAND
RESIZED THE FIREPLACE OPTION
RELOCATED THE WINDOW IN THE MESSY KITCHEN TO BEHIND THE OPT. SINK CHANGED MESSY KITCHEN WINDOW TO OPTIONAL

6. CHANGED MESSY KITCHEN WINDOW TO OPTIONAL

7. ADDED CHASE TO OWNER'S WIC

8. ADDED DIMS TO 0. BATH VANITY FOR CLARIFICATION

9. REMOVED OPT. DOOR TO LOFT

10. ADDED CHASE TO LOFT MC

11. RELOCATED LINEN IN THE 0. BATH OPTIONS

12. REMOVED THE OPT. SUPER SHOWER (ZERO ENTRY)

13. FLIPPED SMART DOOR DELIVERY DOOR HANDING

14. CHANGED ALL LINEN LOSETS TO HAVE ONLY 4 SHELVES

15. CHANGED SIZE OF BASE SHOWER TO 60X36

16. UPDATED OPTIONAL SQ. FTG. CHART

17. REMOVED HALF WALLS AT KITCHEN ISLAND AND UPDATED PER CABINET PROVIDER

18. EXTEND PORCH SLAB 4" AT FRONT AND EXTEND AROUND CONNER 20" TO SUPPORT STOKE VENEER

19. EXTEND PORCH SLAB 4" AROUND THE PERBILETER AT THE CRAFTISMA'S LEVAITON

19. EXTEND PORCH SLAB 4" AROUND THE PERIMETER AT THE 'CRAFTSMAN' ELEVATION

DATE: 3/30/2022

EXTEND PORCH SLAB 4" AROUND THE PERIMETER AT THE 'CRAFTSMAN' ELEVATION ADDED A COLUMN DETAIL FOR CLARITY ON THE 'CRAFTSMAN' ELEVATION ADDED A SEPARATE OPTION FOR THE POCKET OFFICE WITH THE SMART DELIVERY DOOR ADDED RECEIVED. ALL ALL SHEETS.

REVISION:004

DATE: 6/20/2022

1. ADD SIDE LOAD GARAGE.

REVISION:005 DATE: 7/22/2022

ADD STEM WALL SLAB FOUNDATION SHEETS
 CORRECT OPTIONAL SMART DELIVERY DOOR LOCATION ON FOUNDATION PLANS TO MATCH FLOOR PLAN.

SQUARE FOOTAGE							
	ENGLISH COUNTRY						
	UNHEATED HEATED						
FIRST FLOOR	0	872					
SECOND FLOOR	0	1337					
FRONT PORCH	127	0					
2 CAR GARAGE	437	0					
PATIO	-160-	0					
SUBTOTALS	724	2209					
TOTAL UNDER ROOF	2933						
OI	PTIONS						
	UNHEATED S.F.	HEATED S.F.					
EXTENDED PATIO	+148	0					
COVERED PATIO	160	0					
EXTENDED CAFE	0	+152					
REAR POCKET OFFICE	0	+60					
FRONT POCKET OFFICE	0	+39					
FRONT PORCH W/ FRONT POCKET OFFICE	142	0					
FRONT POCKET OFFICE	0	+61					
W/ SMART DOOR	·						

Lot 119 Duncan's Creek

54 Beacon Hill Road Lillington, NC 27546

NC.



PLAN 2 The Holly - LH **'ENGLISH COUNTRY' ELEVATION**

ARCHITECTURAL DRAWINGS 0.0 Cover Sheet 1.1 Foundation (Slab) 1.1.1 Foundation Options (Slab) 1.1.2 Foundation Options (Slab) 1.2 Foundation (Crawl) 1 2 1 Foundation Options (Craw 1.2.2 Foundation Options (Crawl) 1.3 Foundation (Stem Wall Slab) 1.3.1 Foundation Options (Stem Wall Slab) 1.3.2 Foundation Options (Stem Wall Slab) 2.1 First Floor Plan 2.1.1 First Floor Plan Option 2.2 Second Floor Plan 2.2.1 Second Floor Plan Options 2.4 Covered Porch Plans & Elevations (Slab) 2.4.1 Covered Porch Plans & Elevations (Crawl/Stem Wall) 2.5 Covered Porch w/ Extended Cafe Plans & Elevations (Slab) 2.5.1 Covered Porch w/ Extended Cafe Plans & Elevations (Crawl/ Stem Wall) Extended Cafe Plans & Elevations (Slab) 2.6.1 Extended Cafe Plans & Elevations (Crawl/ Stem Wall) 2.7 2-Car Sideload Garage Plans 2.7.1 2-Car Sideload Garage Elevations 3.1 Front & Rear Elevations (Slab) 3.1.1 Front & Rear Elevations (Crawl/ Stem Wall) 3.2 Side Elevations (Slab) 3.2.1 Side Elevations (Crawl/ Stem Wall) 3.3 Roof Plan 5.1 First Floor Electrical 5.1.1 First Floor Options Electrical

DESIGN CRITERIA:

5.2 Second Floor Electrical 5.2.1 Second Floor Options Electrical

THIS PLAN IS TO BE BUILT IN CONFORMANCE WITH THE 2018 NORTH CAROLINA STATE BUILDING CODE: RESIDENTIAL CODE

DIMENSIONS SHALL GOVERN OVER SCALE, AND CODE SHALL GOVERN OVER DIMENSIONS.

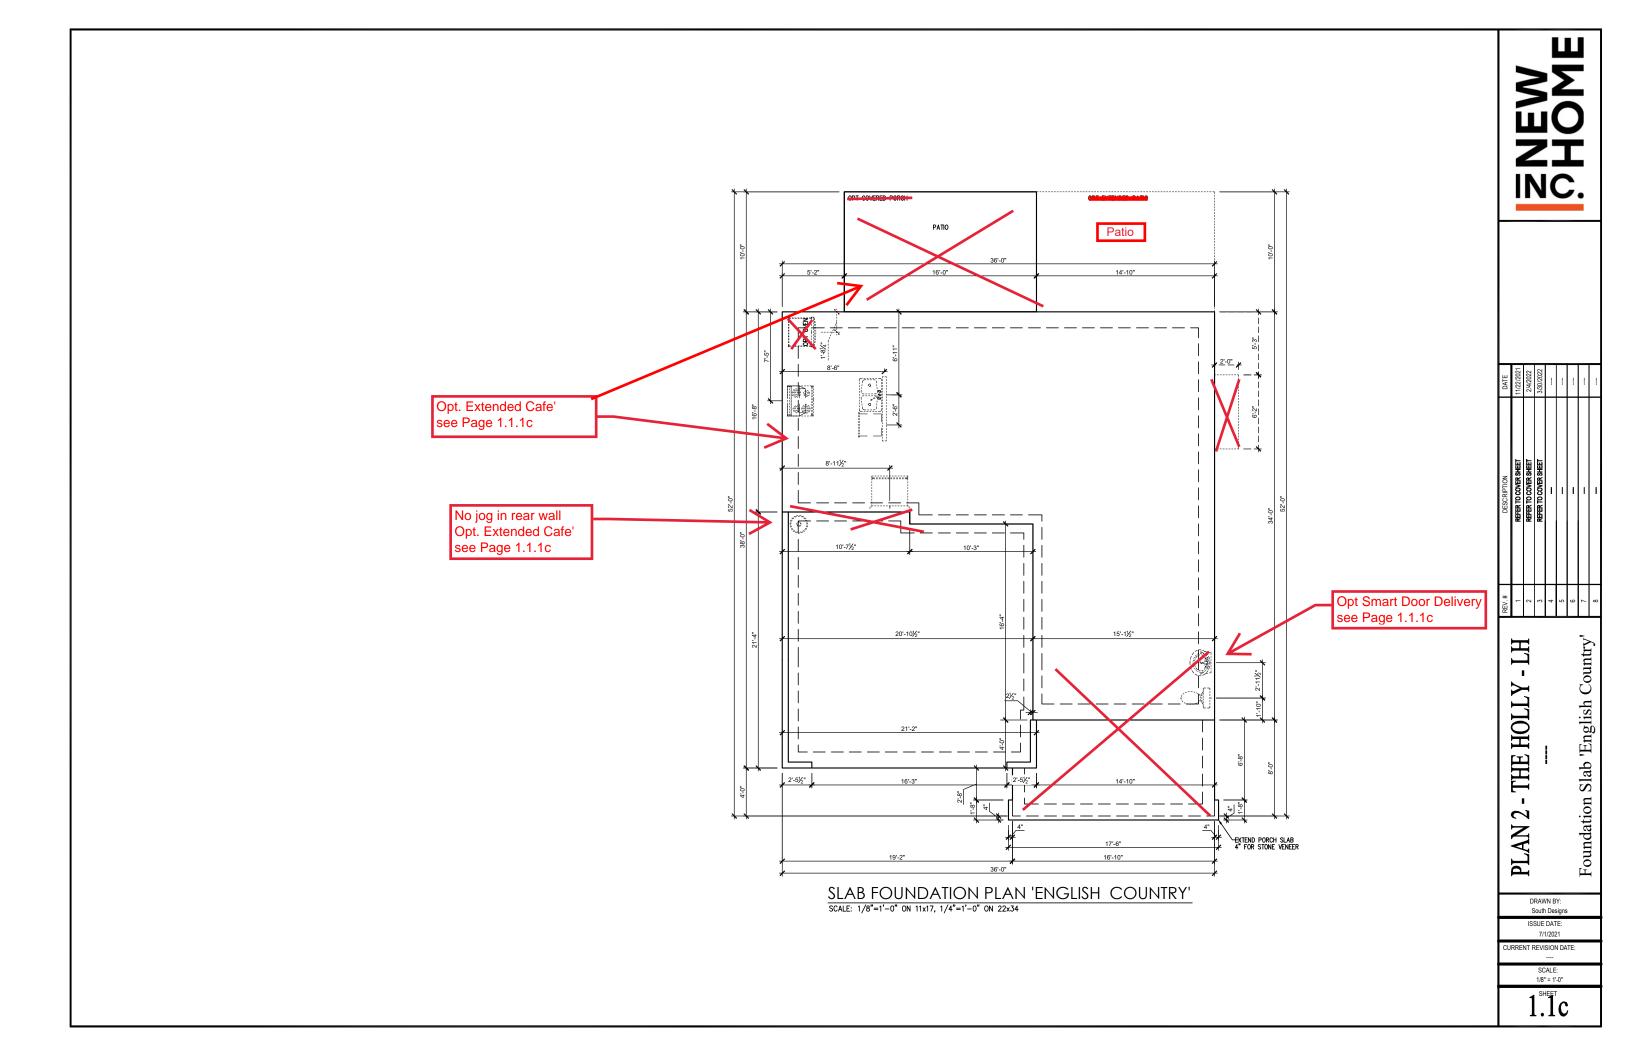
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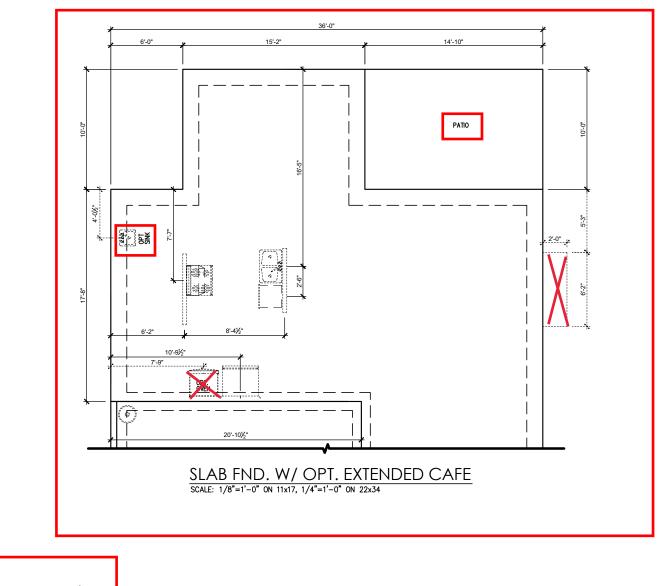
- THE HOLLY PLAN 2. Cover Sheet 'English Country


ISSUE DATE: 7/1/2021

URRENT REVISION DATE

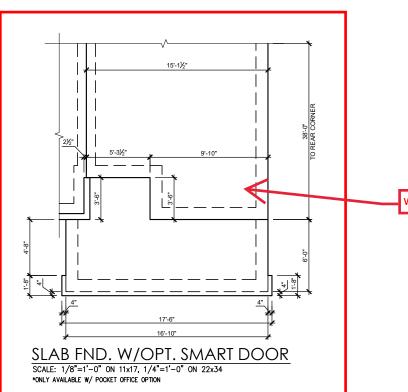1/8" = 1'-0"







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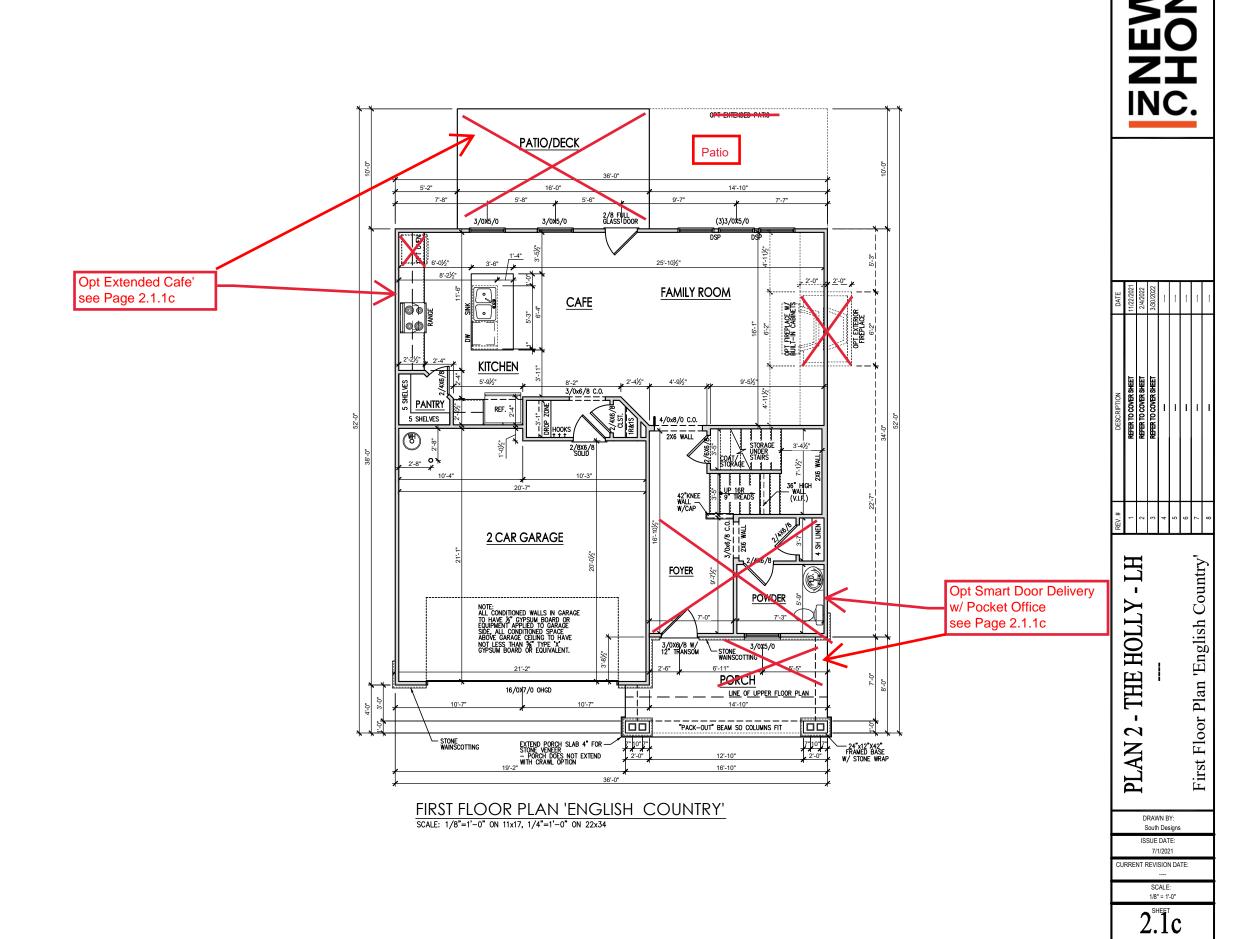
DRAWN BY:	
South Designs	
ISSUE DATE:	
7/4/2024	

ISSUE DATE:	
7/1/2021	

SCALE:	
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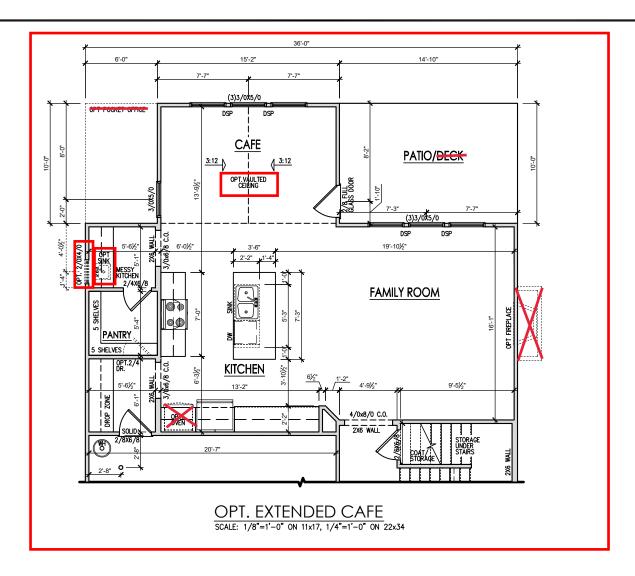
General Floor Plan Notes shall apply unless noted otherwise on plan.


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- Jacks: Openings up to 3'-4" wide shall have (1) 2x4 jack stud SPF on each side. Openings greater than 3'-4" wide shall have (2) 2x4 jack studs SPF on each side.
- Soffits, Coffered Ceilings, Trey Ceilings and other significant ceiling plan elements are shown on the floor plans and are denoted as single dashed lines. Unless specifically call out as included, Kitchens do not include soffits over wall cabinetry.
- Door & Window Frames, where occurring near corners, shall be a minimum of 4 1/2" from corner. Except for walk-in closets with doors near a corner, doors at closets shall be centered an closet.
- Windows: Shall have at least (1) window in each sleeping room, that meets egress. Shall be provided with tempered glass at hazardous glazing areas. False windows shall be installed with obscure alazina.
- Closets for clothing or coat storage shall be equipped with 1 rod/shelf. Closets for linen shall have 4 open equal shelves. Closets for pantries shall have 4 equal wood shelves, painted.
- Stair treads shall be a min of 9" deep, risers shall be a maximum of 8 1/4", unless noted otherwise, per the current North Carolina Residential Code
- 10. Handrails and Guards at stairs shall be 34" above the finished surface of the ramp surface of the stair. Handrails at landings and overlooks of multilevel spaces shall be 36" above finished floor. Guards (pickets or balusters) shall be spaced with no more than 4" between guards.
- 11.Attic Access shall be provided at all attic area with a height greater than 30". Minimum clear attic access shall be 20" x 30". Pull down stairs and access doors in knee walls meeting minimum criteria are also acceptable.
- 12.Garage Door to Living Space shall be 2'-8" x 6'-8" minimum size and shall be 20 minute fire rated and weather sealed.
- 13. Garage Walls, as a minimum, shall be separated from living space by installing 1/2" gypsum board on the garage side of the wall. With habitable space above, the inside of all garage walls require 1/2" GWB supporting 5/8" type X GWB on ceiling.



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PLAN 2 - THE HOLLY - LH
--First Floor Plan Options 'English Country'

DRAWN BY: South Designs

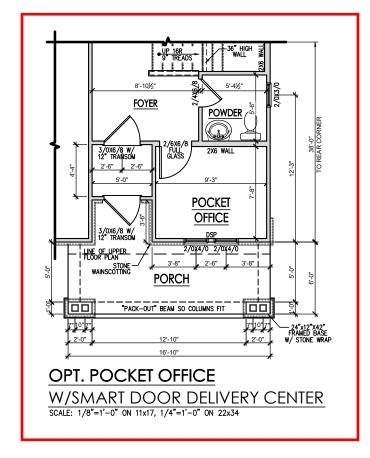
ISSUE DATE: 7/1/2021 CURRENT REVISION DATE:

> SCALE: 1/8" = 1'-0"

2.1.1

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SCALE: 1/8"=1'-0" ON 11x17, 1/4"=1'-0" ON 22x34

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PLAN 2 - THE HOLLY
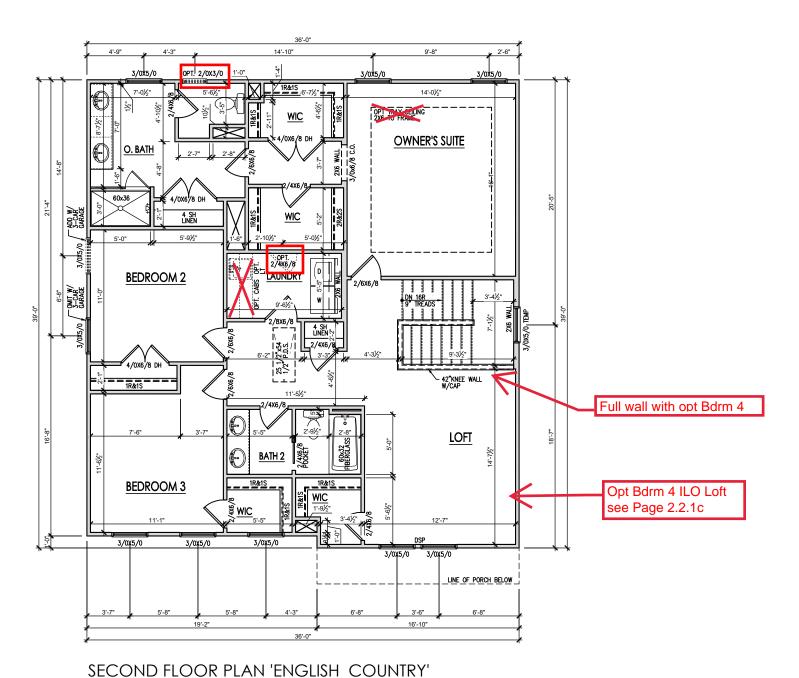
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Country'

Plan 'English

Second Floor

DRAWN BY: South Designs


ISSUE DATE: 7/1/2021 CURRENT REVISION DATE:

> SCALE: 1/8" = 1'-0"

2.2c

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PLAN 2 - THE HOLLY -

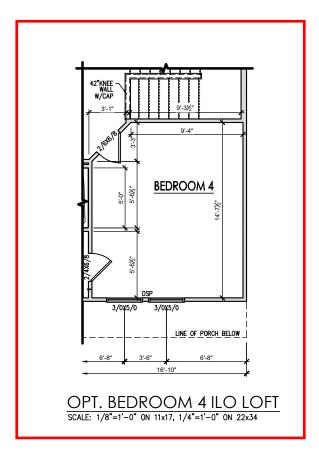
Second Floor Plan Options 'English Country'

DRAWN BY: South Designs

ISSUE DATE: 7/1/2021 CURRENT REVISION DATE:

> SCALE: 1/8" = 1'-0"

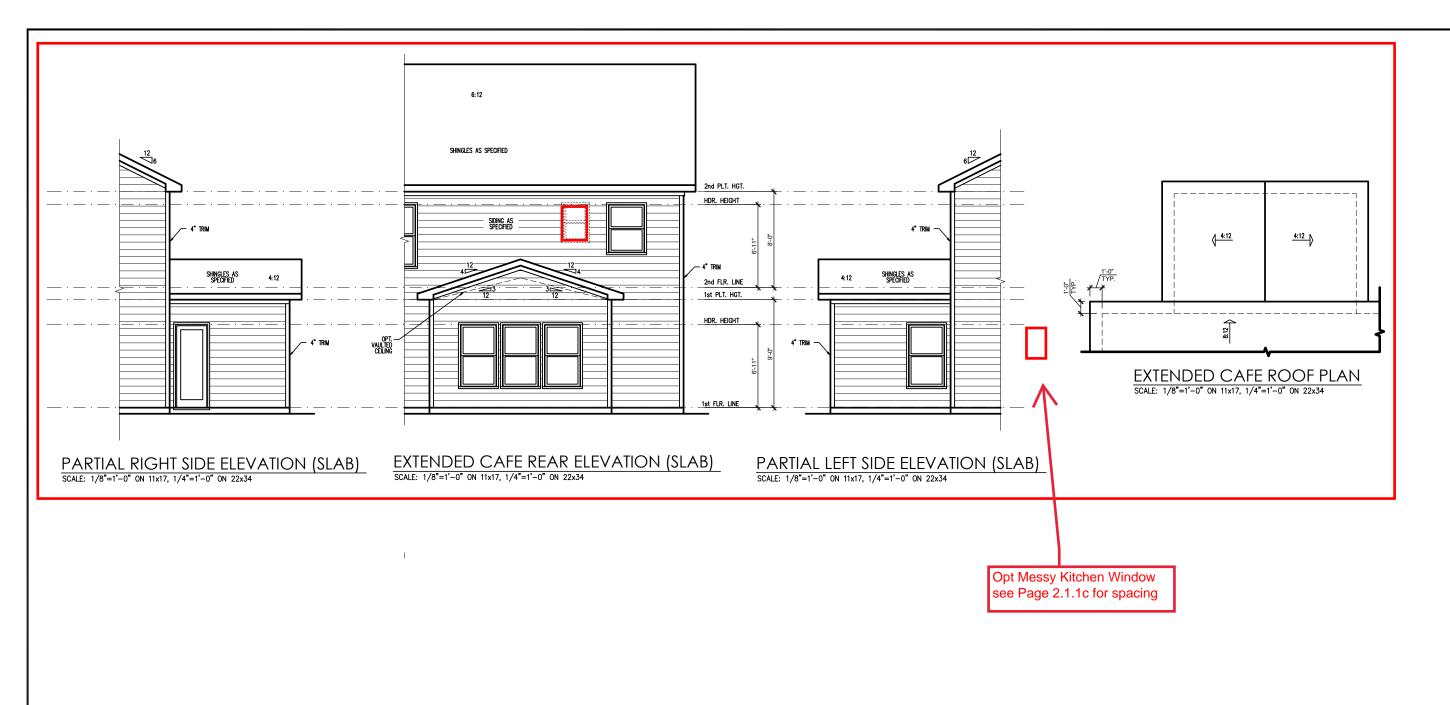2.2.1



BWEW PHOME

PLAN 2 - THE HOLLY - LH

Extended Cafe Plans & Elevations 'English Country' Slab

DRAWN BY: South Designs

ISSUE DATE: 7/1/2021 CURRENT REVISION DATE:

> SCALE: 1/8" = 1'-0"

2.6c

General Elevation Notes

General Elevation Notes shall apply unless noted otherwise on plan.


- Roof shall be finished with architectural composition shingles with slopes as noted on plan.
- Ridge Vent shall be provided and installed on all ridges greater than 6' in length per manufacturer's specifications.
- 3. Soffit Vent shall be continuous soffit vent
- House Wrap, "tyvek" or approved equal shall be installed over entire exterior wall per manufacturer's specifications and recommendations.
- Flashing shall be provided above all door and window openings, above finish wall material changes and at wall surfaces where lower roof areas abut vertical wall surfaces.
- Porch Railings shall be provided at all porch walking surfaces greater than 30" above adjacent finished grade. It shall be 36" high with guards spaced no more than 4" apart. Consult community specifications for material.
- Finish Wall Material shall be as noted on elevation drawings.
- 8. Brick Veneer, if included on elevation shall be fied to wall surface with galvanized corrugated metal fies at a rate of 24" oc horizontally and 16" oc vertically so that no more than 2.67st of brick is supported by (1) fie. Space between face of wall and back face of brick shall be limited to a maximum of 1". Risshing shall be provided behind brick above all wall openings and at base of brick wall. Flashing shall be a minimum of 6-mil poly or other corrosion resistant material and shall be installed so that if laps under the house wrap material a minimum of 2".


 Weepholes shall be provided at a rate of 48" oc and shall not be less than 3/16" in diameter and shall be located immediately above flashing.
- Brick Veneer Support Lintels shall be provided if brick veneer is included on elevation. Lintels shall be provided as listed in the following schedule and shall have a minimum bearing length of." Masony Lintels shall be provided so that deflection is limited

Masonry Opening Lintel Schedule

ning Size Angle

up to 4'-0"		3-1/2" x 3-1/2" x 5/16"
4'-1" to	5'-6"	4" x 3-1/2" x 5/16" LLV
5'-7" to	6'-6"	5" x 3-1/2" x 5/16" LLV
6'-7" to	8'-4"	6" x 3-1/2" x 5/16" LLV
8'-5" to	16'-4"	7" x 4" x 3/8" LLV

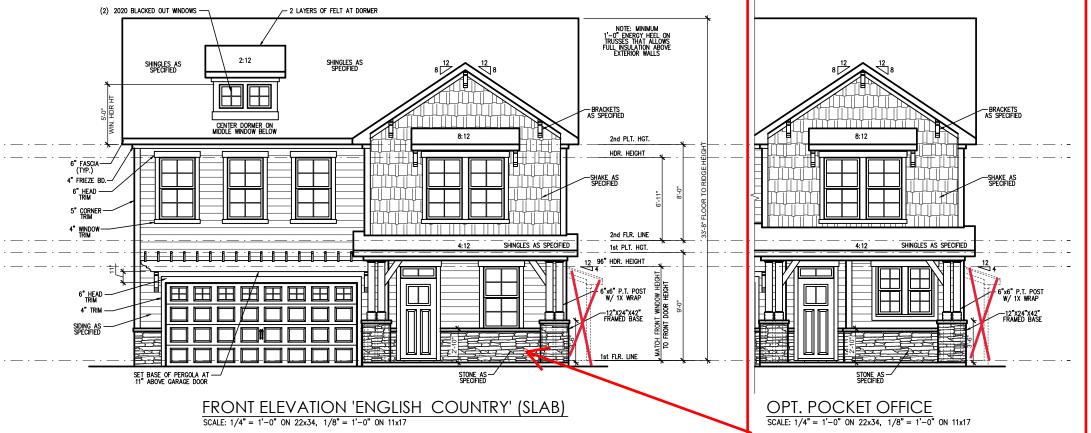

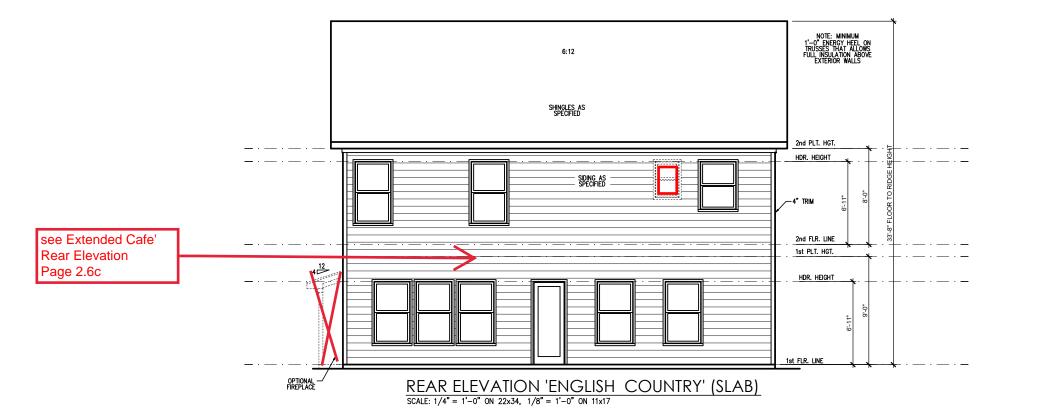



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PLAN 2 - THE HOLLY

Front & Rear Elevations 'English Country' Slab

DRAWN BY: South Designs

7/1/2021 CURRENT REVISION DATE:

> SCALE: 1/8" = 1'-0"

3.1c

General Elevation Notes


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- Roof shall be finished with architectural compositios shingles with slopes as noted on plan.
- Ridge Vent shall be provided and installed on all ridges greater than 6' in length per manufacturer's specifications.
- 3. Soffit Vent shall be continuous soffit vent
- House Wrap, "tyvek" or approved equal shall be installed over entire exterior wall per manufacturer's specifications and recommendations.
- Flashing shall be provided above all door and window openings, above finish wall material changes and at wall surfaces where lower roof areas abut vertical wall surfaces.
- Porch Railings shall be provided at all porch walking surfaces greater than 30" above adjacent finished grade. It shall be 34" high with guards spaced no more than 4" apart. Consult community specificates to metalize
- Finish Wall Material shall be as noted on elevation drawings.
- 8. Brick Veneer, if included on elevation shall be fled to wall surface with galvanized corrugated metal fles at a rate of 24" ac hotizontally and 16" oc vertically so that no more than 2.67sf of brick is supported by (1) fle. Space between face of wall and back face of brick shall be limited to a maximum of 1". Flashing shall be provided behind brick above all wall openings and at base of brick wall. Rashing shall be a minimum of 6-mil poly or other corrosion resistant material and shall be installed so that it laps under the house wrap material a minimum of 2". Weepholes shall be provided at a rate of 48" oc and shall not be less than 3/16" in diameter and shall be located immediately above flashing.
- Brick Veneer Support Lintels shall be provided if brick veneer is included on elevation. Lintels shall be provided as listed in the following schedule and shall have a minimum bearing length of 6". Masonry Lintels shall be provided so that deflection is limited to L/600.

Masonry Opening Lintel Schedule

Opening Size	Angle

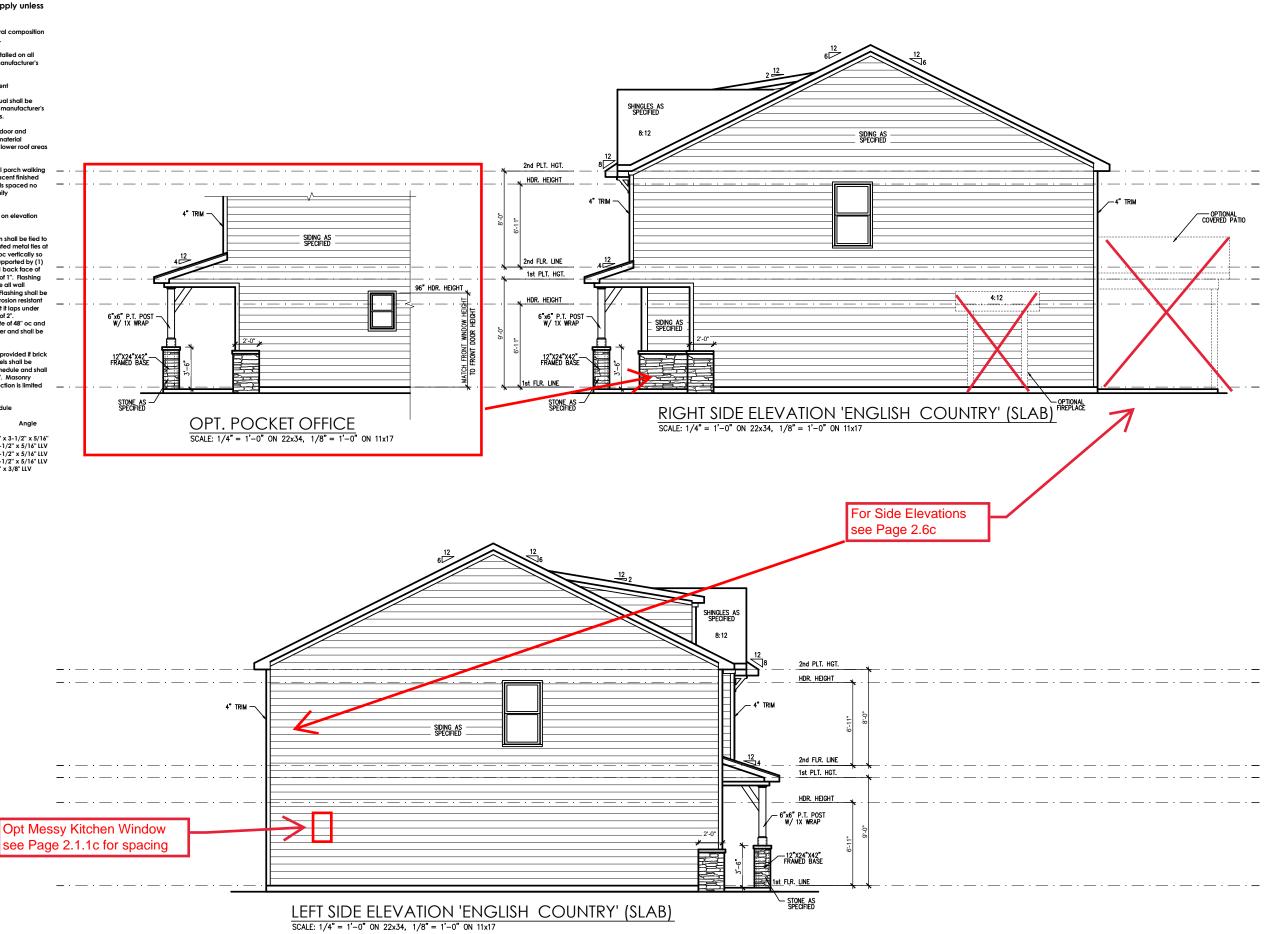up to 4'-0" 3-1/2" x 3-1/2" x 5/16" 4'-1" to 5'-6" 4" x 3-1/2" x 5/16" LLV 5'-7" to 6'-6" 5" x 3-1/2" x 5/16" LLV 8'-5" to 16'-4" 7" x 4" x 3/6" LLV





DATE	11/22/2021	2/4/2022	3/30/2022					-
DESCRIPTION	REFER TO COVER SHEET	REFER TO COVER SHEET	REFER TO COVER SHEET	-	1	_	-	ı
REV.#	-	2	3	4	2	9	7	8

PLAN 2 - THE HOLLY - LH
--Side Elevations 'English Country' Slab

DRAWN BY: South Designs


ISSUE DATE: 7/1/2021 JRRENT REVISION DATE:

SCALE: 1/8" = 1'-0"

3.2c

				TTIC '	VENT S	CHEDU	LE			
				EN	GLISH COI	UNTRY				
MAIN	HOUSE	Ī	SQ FTG	1393	AT / NEAR RIDGE			AT / NEAR EAVE		
VENT TYPE	SQ. FT. REQUIRED		SQ. FT.	PERCENT OF TOTAL	POT LARGE (SQ. FT. EACH)	POT SMALL (SQ. FT. EACH)	RIDGE VENT (SQ. FT. PER LF)	EAVE VENT (SQ. IN. EACH)	CONT. VEN	
VEINTTILE		NGE	SUPPLIED	SUPPLIED	0.4236	0.2778	0.125	0.1944	0.0625	
RIDGE VENT	1.86	2.32	3.00	44.44	0 0 24.00					
SOFFIT VENTS	2.79	2.32	3.75	55.56				0	60.00	
TOTAL (MIN)	4.64	4.64	6.75	100.00	POT VENTS MAY BE REQUIRED IF THERE IS INSUFFICIENT RIDGE AVAILABLE					
CULEDINE HYC	DEEN CA	LOUINTE	D VCCHMING	AVE VENTUA	TON AT 50_60%	OF TOTAL AND E	NDCE AT AO_509	OF TOTAL PEOL	IDEN VENTILAT	

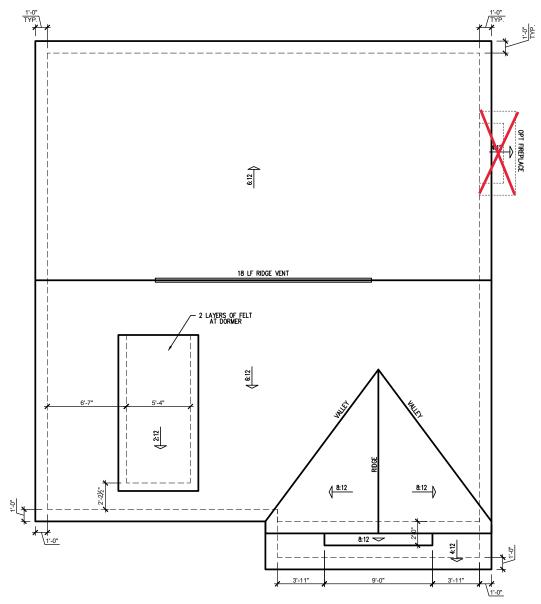schedule has been calculated assuming eave ventilation at 50–60% of total and ridge at 40–50% of total required ventilatio



ENGLISH COUNTRY ROOF PLAN SCALE: 1/4" = 1'-0" ON 22x34, 1/8" = 1'-0" ON 11x17

DATE	11/22/2021	2/4/2022	3/30/2022					!
DESCRIPTION	REFER TO COVER SHEET	REFER TO COVER SHEET	REFER TO COVER SHEET	-	-	-	-	-
REV.#	1	2	3	4	2	9	7	8

PLAN 2 - THE HOLLY - LH

Roof Plan 'English Country'

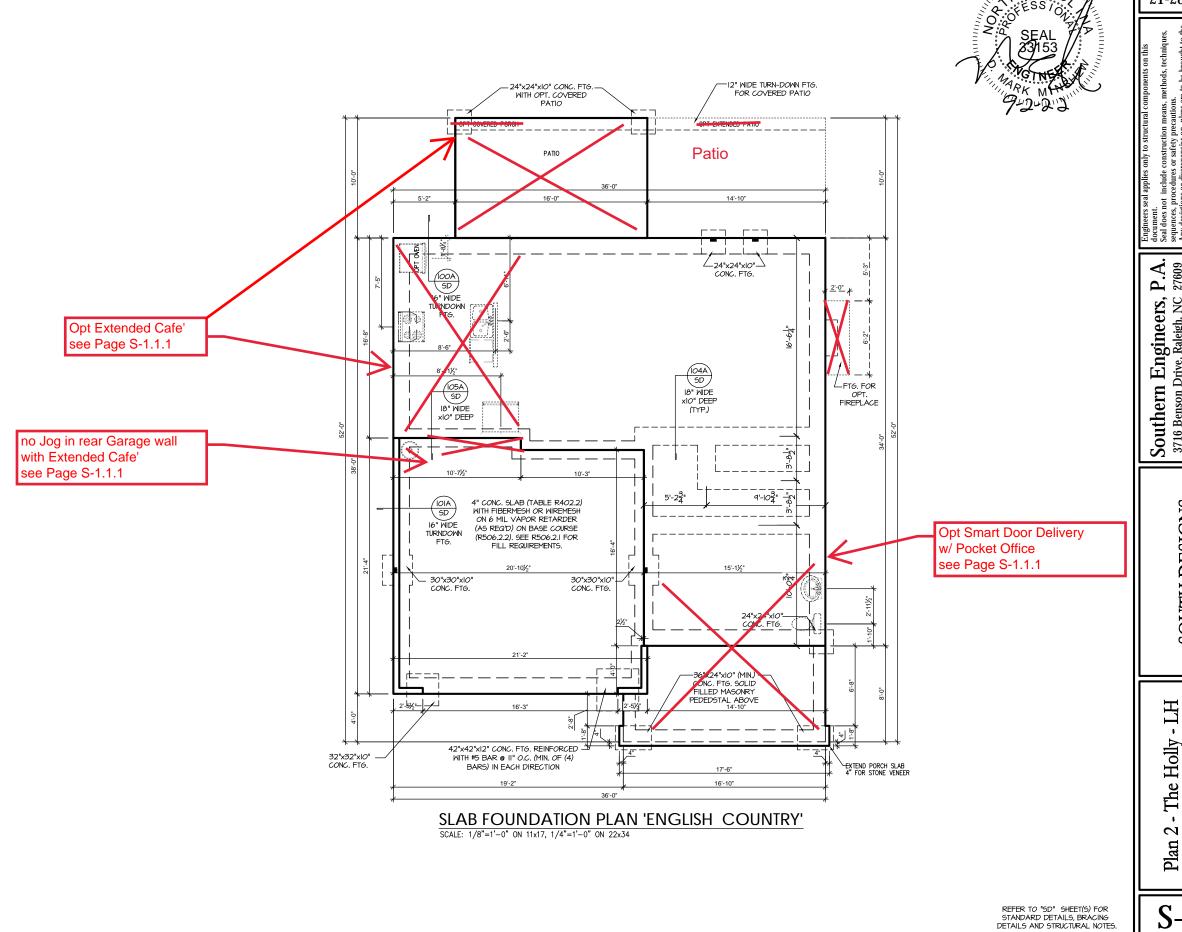
DRAWN BY: South Design ISSUE DATE:

ISSUE DATE:
7/1/2021

CURRENT REVISION DATE:

SCALE: 1/8" = 1'-0"

3.3c




PROJECT # 21-2816-LH

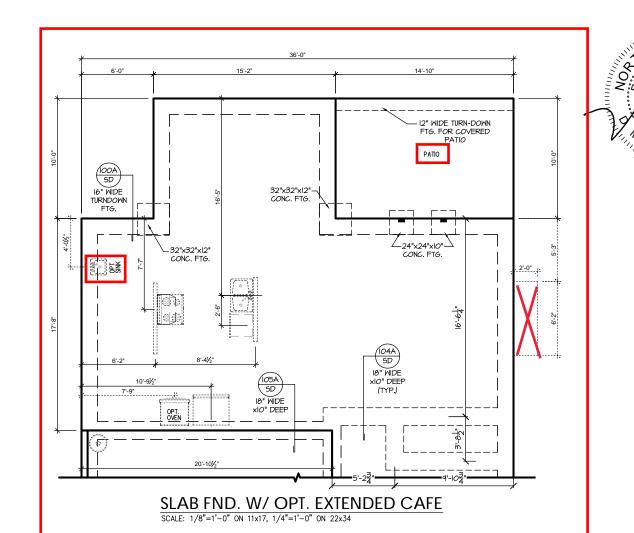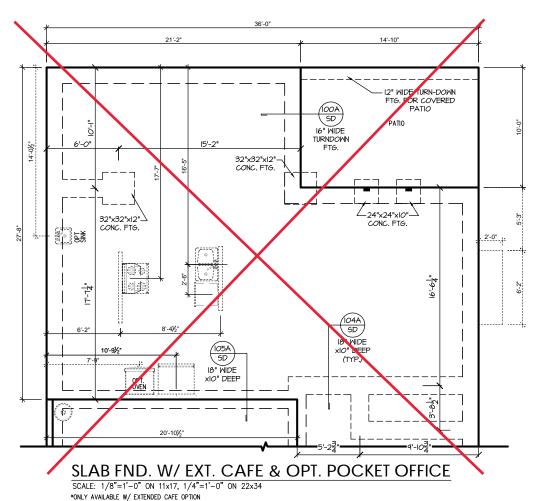
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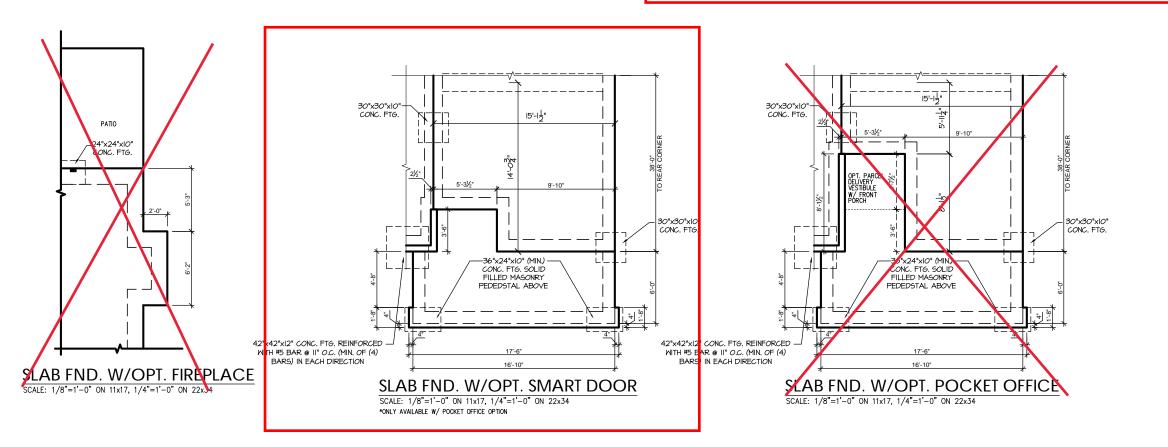
SOUTH DESIGNS

The Holly NEW HOME, INC.

S-1.1







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PROJECT # 21-2816-LH

SOUTH DESIGNS

The Holly NEW HOME, Plan

REFER TO "SD" SHEET(S) FOR STANDARD DETAILS, BRACING DETAILS AND STRUCTURAL NOTES.

TRUSS SYSTEM REQUIREMENTS NC (2018 NCRC): Wind: 115-120 mph

- TRUSS SYSTEM LAYOUTS (PLACEMENT PLANS) SHALL BE DESIGNED IN ACCORDANCE WITH SEALED STRUCTURAL PLANS ANY NEED TO CHANGE TRUSSES SHALL BE COORDINATED WITH SOUTHERN ENGINEERS.
- TRUSS SCHEMATICS (PROFILES) SHALL BE PREPARED AND SEALED BY TRUSS MANUFACTURER.
- ALL TRUSSES SHALL BE DESIGNED FOR BEARING ON SPF #2 OR #3 PLATES OR LEDGERS (UNO).
- ALL REQUIRED ANCHORS FOR TRUSSES DUE TO UPLIFT OR BEARING SHALL MEET THE REQUIREMENTS AS SPECIFIED ON THE TRUSS

HEADER/BEAM & COLUMN NOTES

- ALL EXTERIOR AND LOAD BEARING HEADERS SHALL BE MIN. (2)2x6 (4" WALL) OR (3)2x6 (6" WALL) WITH (I) SUPPORT STUD, UNLESS NOTED
- 2. THE NUMBER SHOWN AT BEAM AND HEADER SUPPORTS INDICATES THE NUMBER OF SUPPORT STUDS REQUIRED IN STUD POCKET OR COLUMN. THE NUMBER OF KING STUDS AT EACH END OF HEADERS IN EXTERIOR WALLS SHALL BE ACCORDING TO ITEM "d" IN TABLE R602.3(5)
 OR AS BELOW PER NCDO! COMMENTARY "KING STUDS AT WALL OPENINGS" REVISED I-9-2020: UP TO 3' SPAN: (I) KING STUD
- OVER 3' UP TO 6' SPAN: (2) KING STUDS OVER 6' UP TO 9' SPAN: (3) KING STUDS
- OVER 9' UP TO 12' SPAN: (4) KING STUDS
- OVER 12' UP TO 15' SPAN: (5) KING STUDS

WOOD "I" JOISTS

(SHALL BE ONE OF THE FOLLOWING):

• TJI 210 BY TRUS JOIST

- I PI 20 PI I/S BY I P
- ALL WOOD "I"JOISTS SHALL BE INSTALLED ACCORDING TO MANUFACTURER'S SPECIFICATIONS.
- INSTALL SQUASH BLOCKS, WEB STIFFENERS. ETC. AS REQUIRED BY AND ACCORDING TO THE 1-JOIST MANUFACTURER'S SPECIFICATIONS AND INSTRUCTIONS
- HANGERS FOR I-JOISTS ARE THE RESPONSIBILITY OF THE I-JOIST SUPPLIER.
- FLOOR TRUSSES BY MANUFACTURER MAY BE

- PORCH POST NOTES:

 4X4 (6x6) TRT'D POST (OR EQUAL).
- ATTACH TRUSSES (RAFTERS) AT PORCH WITH HURRIGANE CONNECTORS.
- POST CAP: SIMPSON AC4-MAX (AC6-MAX)
 POST CAP AT CORNER: (2) SIMPSON LCE4
 (MITER HEADER AT CORNER). HIGH WIND; ADD (1) SIMPSON H6.
- POST BASE: SIMPSON ABU44 (ABU66).
- MONO: 5%" ANCHOR (EMBED 7")

 CMJ: 5%" ANCHOR (EXTEND TO FOOTING HIGH WIND ONLY) POST BASE: WOOD FOUNDATION: (2) SIMPSON
- CSI6 STRAPS AT POSTS. EXTEND 12" ONTO EACH POST (UPPER AND LOWER) OR TO GIRDER

Opt Extended Cafe see Page S-2.1.1

NOTE: EQUIVALENT POST CAP AND BASE ACCEPTABLE.

FRAMING NOTES

NC (2018 NCRC): Wind: 115-120 mph


- BRACING METHOD AND TYPE: CONTINUOUSLY SHEATHED WSP: CS-WSP. NOTE THAT THE WALL BRACING AMOUNT PROVIDED ON THE PLANS (DETAILS AND SPECIFICATIONS) IS GREATER THAN THE AMOUNT OF WALL BRACING REQUIRED BY SECTION R602.10 OF THE CODE. SEE NOTES BELOW FOR DETAILS AND SPECIFICATIONS FOR WALL
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 SHALL BE AN 800 POUND CAPACITY ASSEMBLY AS NOTED ON PLANS.
 SEE DETAILS FOR HD ASSEMBLY.
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- (OR ECUIV.)

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 STRAP DOWN ACROSS THE BAND AND DOWN TO A STUD BELOW OR

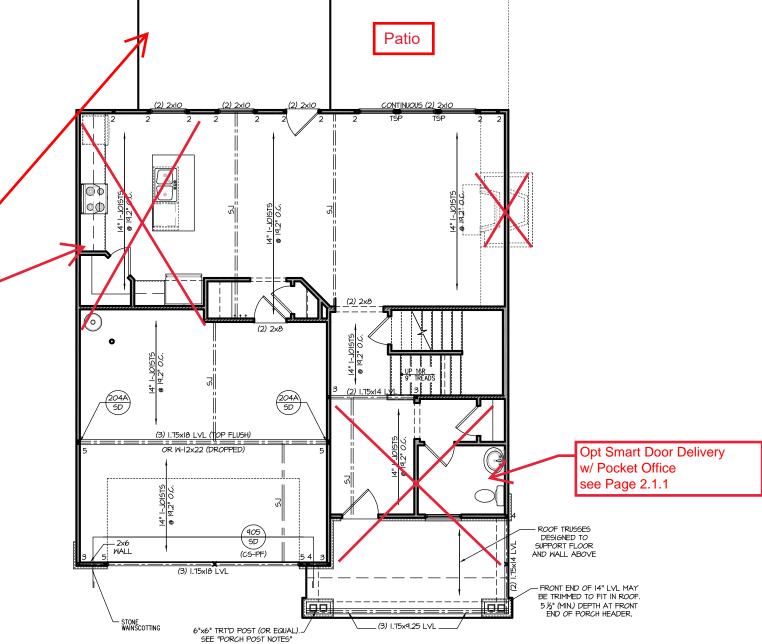 HEADER BELOW. EXTEND STRAP 7" MIN ALONG EACH STUD (OR HEADER) AND ATTACH EACH END W (7) 8d NAILS.
- 5. INTERIOR BRACED WALL: (NOTED AS "IBW" ON PLANS) ATTACH I/2" GYPSUM BOARD (GB) ON EACH SIDE OF WALL MITH A MIN. OF 5d COOLER NAILS OR #6 SCREWS @ 7" O.C. ALONG THE EDGES AND AT INTERMEDIATE SUPPORTS.
- 6. INTERIOR BRACED WALL-WOOD STRUCTURAL PANEL: (NOTED AS "I<u>BM-MSP</u>" ON PLANS). ATTACH ONE SIDE WITH 1/6" MSP SHEATHING MITH 8d NAILS AT A 6"/12" NAILING PATTERN (6" OC AT PANEL EDGES AND 12" OC AT INTERMEDIATE SUPPORTS). INSTALL BLOCKING AT ALL PANEL EDGES, ATTACH GB OVER WSP AS REQUIRED, ATTACH OPPOSITE SIDE WITH 1/2" GB WITH A MIN. OF 5d COOLER NAILS OR #6 SCREWS @ 7" OC ALONG THE EDGES AND AT INTERMEDIATE





FIRST FLOOR PLAN 'ENGLISH COUNTRY'

SCALE: 1/8"=1'-0" ON 11x17, 1/4"=1'-0" ON 22x34

21-2816-LH

PROJECT #

e to be brought to the . Failure to do so will

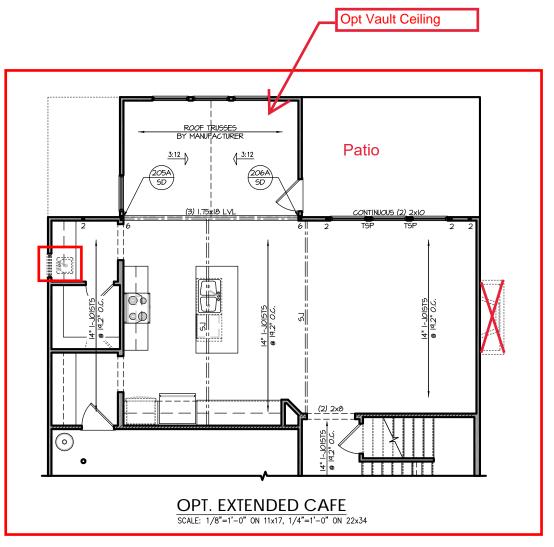
P.A. 27609 Engineers, Drive, Raleigh, NC Southern Engi 3716 Benson Drive, Ra Phone: (919) 8

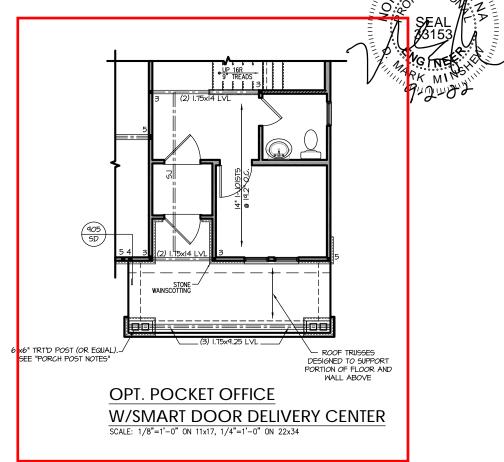
SOUTH DESIGNS

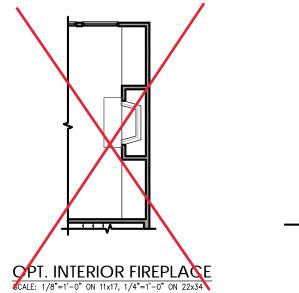
Holly HOME, The

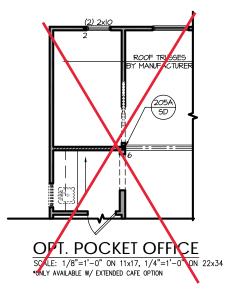
Plan

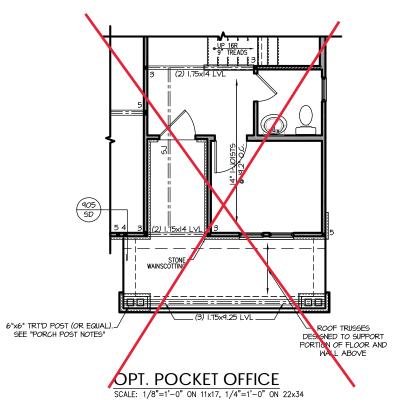
REFER TO "SD" SHEET(S) FOR STANDARD DETAILS BRACING DETAILS AND STRUCTURAL NOTES.











REFER TO "SD" SHEET(S) FOR STANDARD DETAILS, BRACING DETAILS AND STRUCTURAL NOTES.

PROJECT # 21-2816-LH

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SOUTH DESIGNS

The Holly NEW HOME, INC. Plan

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FRAMING NOTES

NC (2018 NCRC): Wind: 115-120 mph


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SECOND FLOOR PLAN 'ENGLISH COUNTRY'

SCALE: 1/8"=1'-0" ON 11x17, 1/4"=1'-0" ON 22x34

PROJECT # 21-2816-LH

e to be brought to the . Failure to do so will

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SOUTH DESIGNS

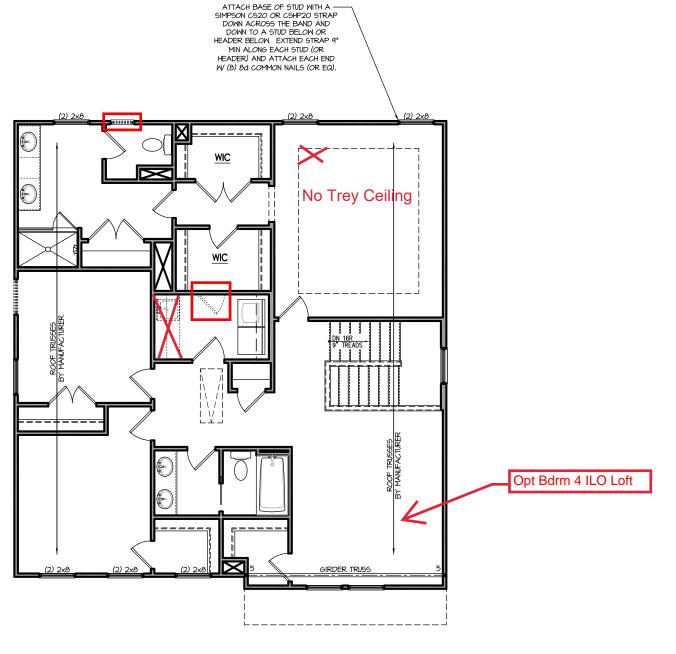
Holly HOME, The

Plan

REFER TO "SD" SHEET(S) FOR STANDARD DETAILS BRACING DETAILS AND STRUCTURAL NOTES.




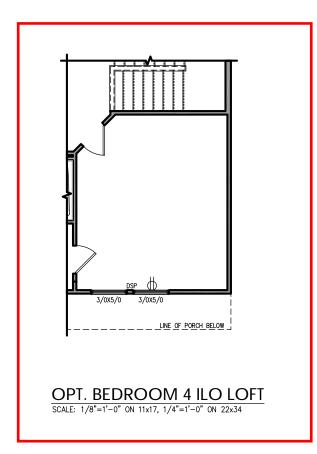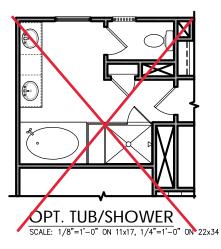NO STRUCTURAL CHANGES FROM BASE PLAN









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SOUTH DESIGNS

NEW HOME, INC.

The Holly Plan

S-2.2.


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ATTIC VENT SCHEDULE										
ENGLISH COUNTRY										
MAIN	HOUSE		SQ FTG	1393	AT / NEAR RIDGE			AT / NEAR EAVE		
VENT TYPE	SQ. FT.		SQ. FT.	PERCENT OF TOTAL	POT LARGE (SQ. FT. EACH)	POT SMALL (SQ. FT. EACH)	RIDGE VENT (SQ. FT. PER LF)	EAVE VENT (SQ. IN. EACH)	CONT. VENT (SQ. IN. PER LF)	
**********	RANGE		SUPPLIED	SUPPLIED	0.4236	0.2778	0.125	0.1944	0.0625	
RIDGE VENT	1.86	2.32	3.00	44.44	0	0	24.00			
SOFFIT VENTS	2.79	2.32	3.75	55.56			0	60.00		
TOTAL (MIN)	4.64	4.64	6.75	100.00	POT VENTS MAY BE REQUIRED IF THERE IS INSUFFICIENT RIDGE AVAILABLE					

^{*} SCHEDULE HAS BEEN CALCULATED ASSUMING EAVE VENTILATION AT 50-60% OF TOTAL AND RIDGE AT 40-50% OF TOTAL REQUIRED VENTILATION





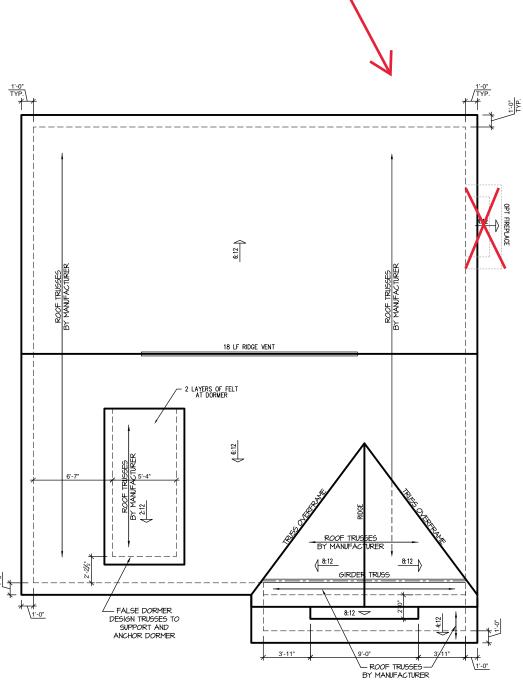Opt. Extended Cafe'

see Page S-6.2 for

Additional Roof Plan

ENGLISH COUNTRY ROOF PLAN SCALE: 1/4" = 1'-0" ON 22x34, 1/8" = 1'-0" ON 11x17


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PROJECT # 21-2816-LH

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SOUTH DESIGNS

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SOUTH DESIGNS

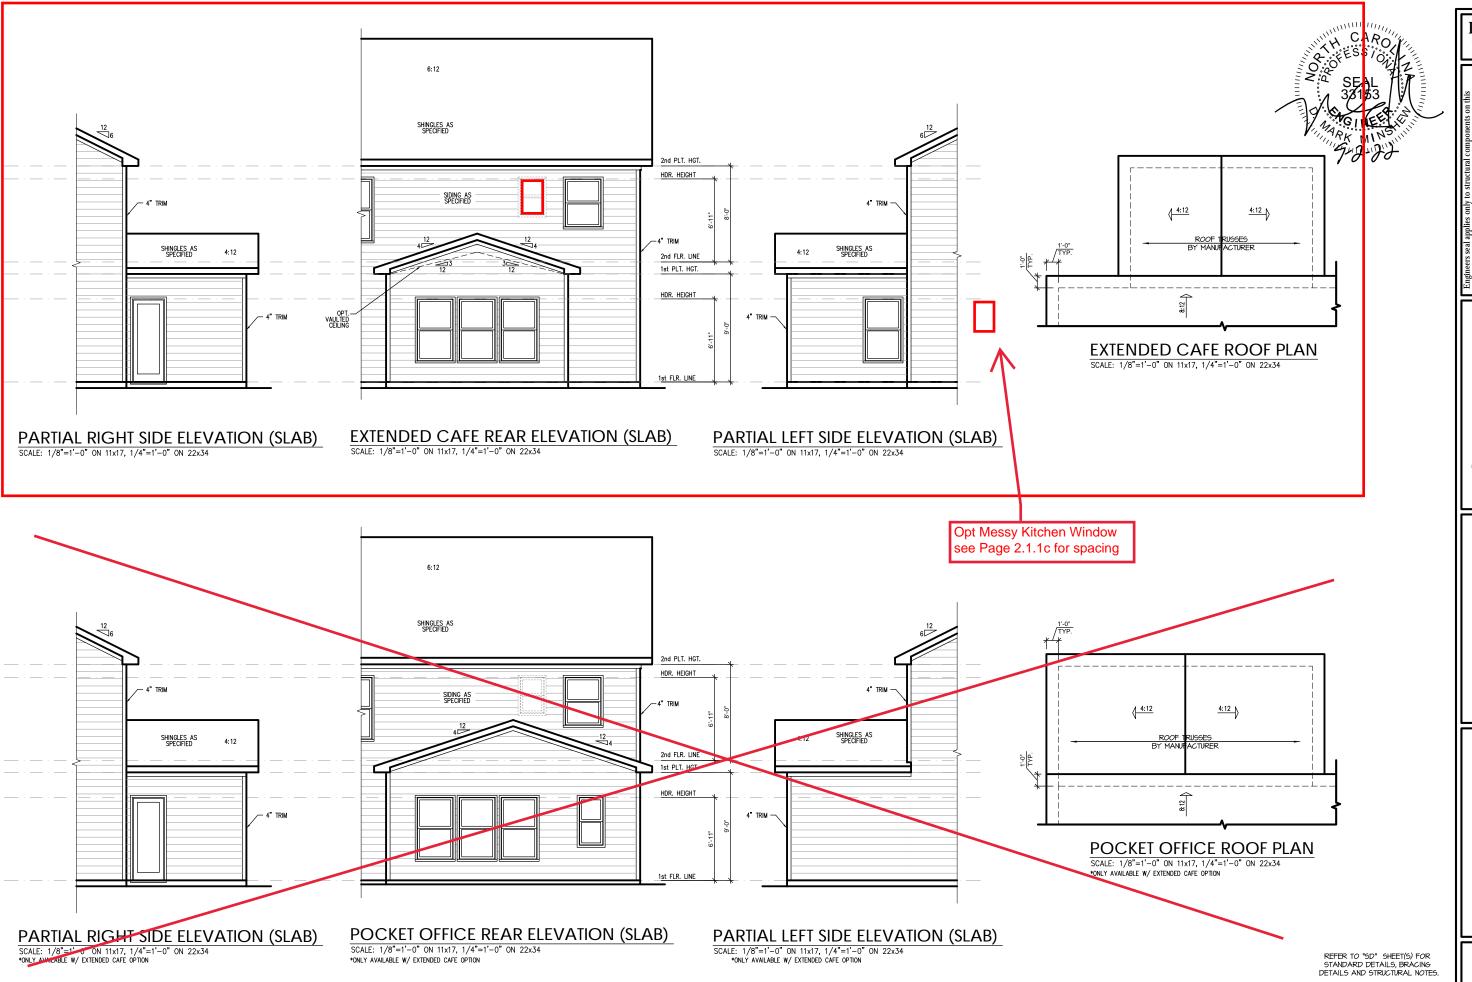The Holly Plan