LIST OF ABBREVIATIONS

CLG.: CEILING HGT.: HEIGHT D.O.: DOUBLE OVEN WD.: WOOD

CONT.:CONTINUOUS CONC.: CONCRETE COL.: COLUMN

ABV.: ABOVE C.O.: CASED OPENING REFG.: REFRIGERATOR D.W.: DISHWASHER T.B.D.: TO BE DETERMINED W.I.C.: WALK IN CLOSET W: WASHER

ELLIP.: ELLIPSE D: DRYER W/: WITH SHWR.: SHOWER TRANS.: TRANSOM DN.: DOWN K.S.: KNEE SPACE NOTE: PLANS DESIGNED UNDER 2018 NORTH CAROLINA RESIDENTIAL CODE.

NOTE: SEE ROOF PLAN FOR KNEEWALL HEIGHTS AND LOCATIONS.

GRADE LINES ARE ASSUMED. VERIFY WITH FINAL GRADING PLAN.

N/A

132

131

N/A

N/A

263

N/A

N/A

N/A

N/A

ACCESSORIES LEGEND PROVIDE BLOCKING FOR:

TB = TOWEL BAR

TP = TOILET PAPER

TR = TOWEL RING

AREA CALCULATIONS FIBERGLASS SHINGLES AS SPEC. (CLASS "C" MIN.) HEATED (SQ. FT.) UNHEATED (SQ. FT.) MR = MAGAZINE RACKTYP. MC = MEDICINE CABINET BASEMENT: N/A GARAGE: 1ST FLOOR: 1215 PATIO: 2ND FLOOR: PORCH: N/A STORAGE: / 1'-6" RND. VENT REC ROOM: N/A RIDGE VENT BRICK: ATTIC: N/A TOTAL: TOTAL: 1215 (HEATED) (UNHEATED) OVERALL DIMENSION UNFINISHED (SQ. FT.) WIDTH: BASEMENT: 41'-2" REC ROOM: DEPTH: 41'-0" ATTIC: STORAGE: O.H. TYP. → W/ CROWN 6-8" (U.N.O.) WINDOW HGT. SIDING AS SPEC. w/ ½" X 4" TRIM

FRONT ELEVATION

6" COLS.

TYP.

BRICK/

ROWLOCK TYP.

SCALE: 1/4"=1'-0"

GENERAL PLAN NOTES

- 1.) SEE CHAPTER 6 OF 2018 NCRC FOR WALL CONSTRUCTION.
- 2.) TEMPERED GLASS TO BE USED AT ALL SAFETY REQUIRED LOCATIONS ACCORDING TO 2018 NCRC SECTION R308.4.

BRICK FOUNDATION AS PER

OWNER / BUILDER SELECTION

- 3.) DWELLING/GARAGE FIRE SEPARATION SHALL PER TABLE 302.6 OF 2018 NCRC.
- 4.) ALL HABITABLE ROOMS SHALL MEET LIGHT/VENTILATION & EGRESS AS REQUIRED IN 2018 NCRC SECTIONS R303.1 AND R310
- 5.) ALL ANGLED WALLS ARE 45° UNLESS NOTED 9.) ALL CABINET DESIGNS/LAYOUTS TO BE OTHERWISE.
- 6.) VERIFY ALL WINDOW SIZES, RADIUS, AND DETAILS WITH CHOSEN MANUFACTURE.
- 7.) LOCATE DORMER FACE TO ALLOW 4" MIN. BELOW WINDOW FRAME.
- 8.) FLOOR PLAN NOTATIONS GOVERN OVER ELEVATION SCALE.
- VERIFIED WITH OWNER VIA SHOP DRAWINGS FROM CABINET MANUF.

SHAKE SIDING

AS SPEC. w/ $\frac{5}{4}$ "

X 4" TRIM BOARD TYP.

- 10.) ALL FLOOR COVERINGS AND FINISHES BY OWNER/ BLDR. COORDINATE HEIGHTS DUE TO THICKNESS CHANGES.
- 11.) ALL WINDOW GLAZING TO HAVE 0.32 U-FACTOR 14.) FINISHES OF ALL INTERIOR BASE BOARD, CLG. MIN. SEE TABLE E-4A, E-4B
- 12.) FINISHES OF SCREEN PORCH COLUMNS, RAILS, FLOORS, CEILINGS; SCREEN DOOR SYSTEM, AND DOOR TO PORCH BY BLDR. & OWNER, PER CONTRACT SPECIFICATIONS
- 13.) FINISHES FOR CLOSET SHELVING AND ROD BY BLDR. & OWNER, PER CONTRACT **SPECIFICATIONS**

BOARD TYP. RAISED PANEL SHUTTERS TYP.

-8" MIN MASONRY

FROM GRADE TO

SIDING (TYP)


DETAIL / MOLDING, OPENING DETAILS, PASS-THRUS, WAINSCOTTING DETAILS BY BLDR. & OWNER, PER CONTRACT SPECIFICATIONS

REVISIONS:

DATE: NAME:

> DRAWN BY: RKR/GES CHECKED BY: JCD DATE: 7-26-23

PLAN NO. 10-1215-DT

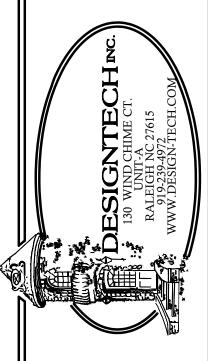


 \mathbb{R} 5-D 996 RED HILL 2 10-1

SHEET NO


NOTE: SEE ROOF PLAN FOR KNEEWALL HEIGHTS AND LOCATIONS.

GRADE LINES ARE ASSUMED. VERIFY WITH FINAL GRADING PLAN.

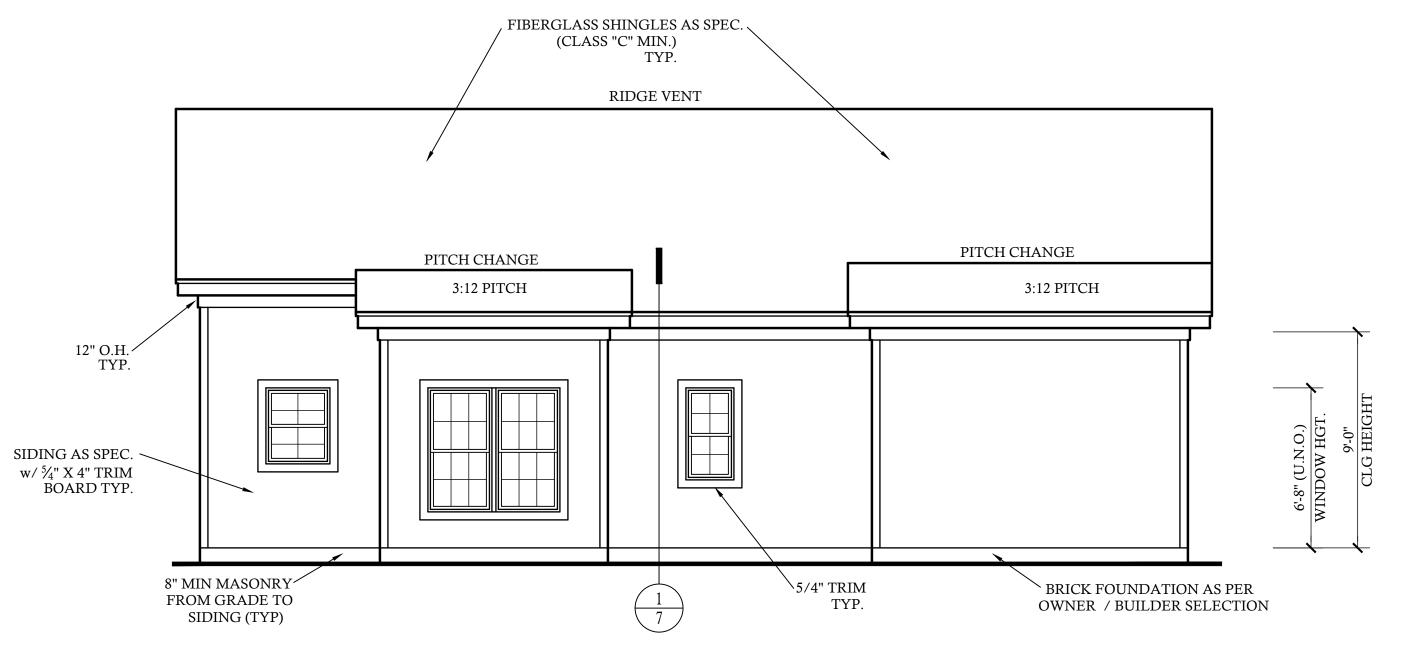



SCALE: 1/4"=1'-0"

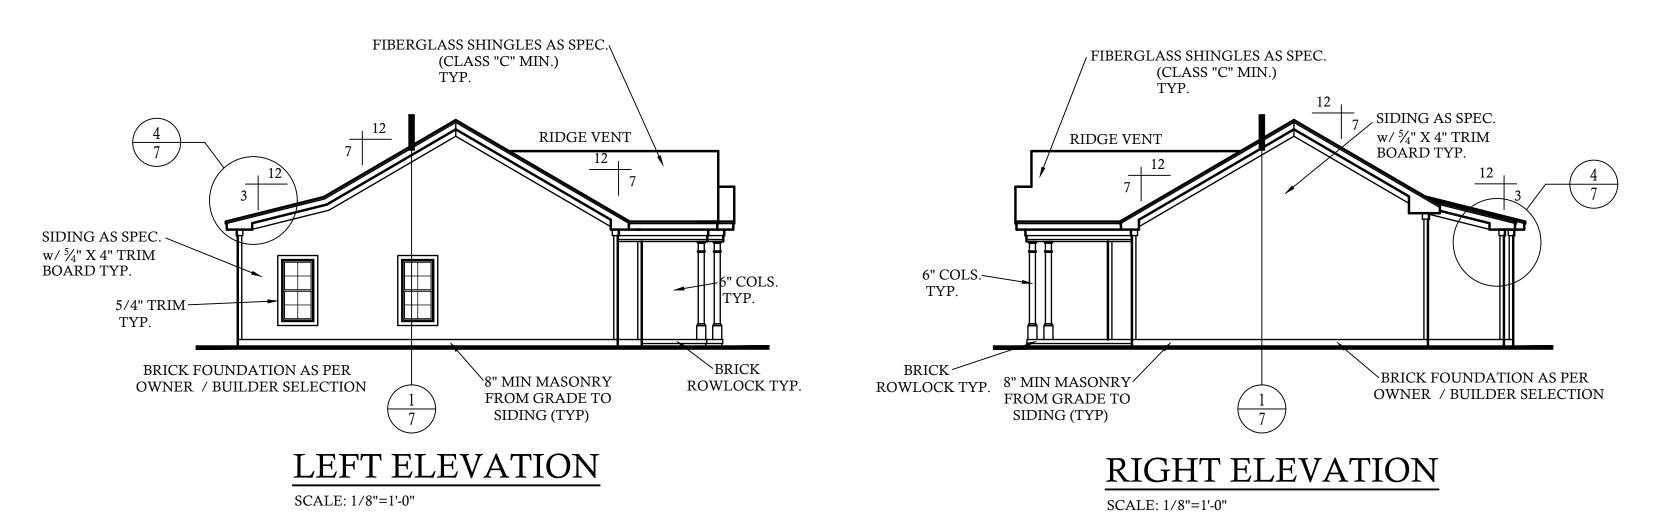


REVISIONS:

DATE: NAME:


> DRAWN BY: RKR/GES CHECKED BY:

JCD DATE: 7-26-23 PLAN NO. 10-1215-DT

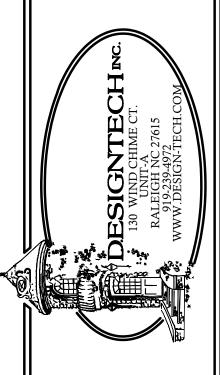

10-1215-DT 996 RED HILL RD

SHEET NO

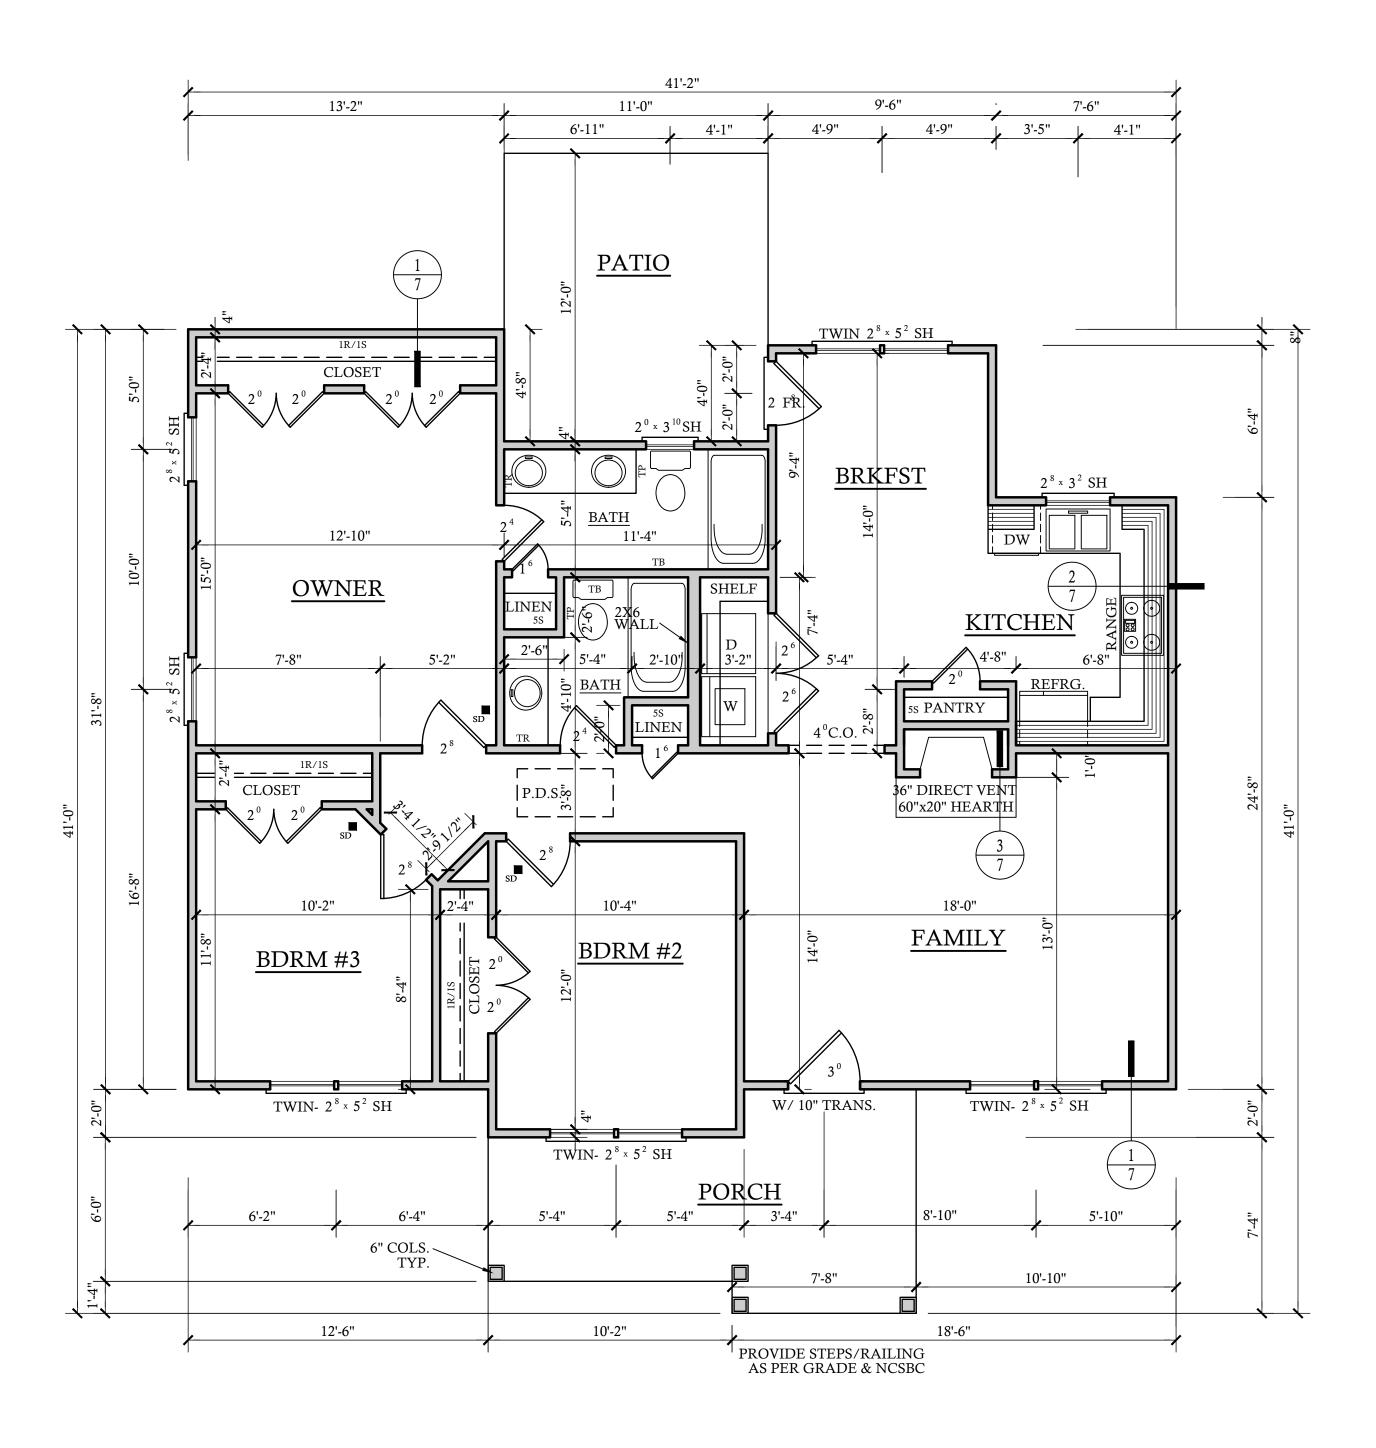


CEILING JOISTS PER TRUSS MANUF.


FIRST FLOOR PLAN

SCALE: 1/4"=1'-0"

9'-0" CLG. HGT. U.N.O. SET WINDOWS @ 6'-8" U.N.O. DATE: NAME: DRAWN BY: RKR/GES CHECKED BY: JCD DATE: 7-26-23 PLAN NO. 10-1215-DT 10-1215-DT 996 RED HILL RD

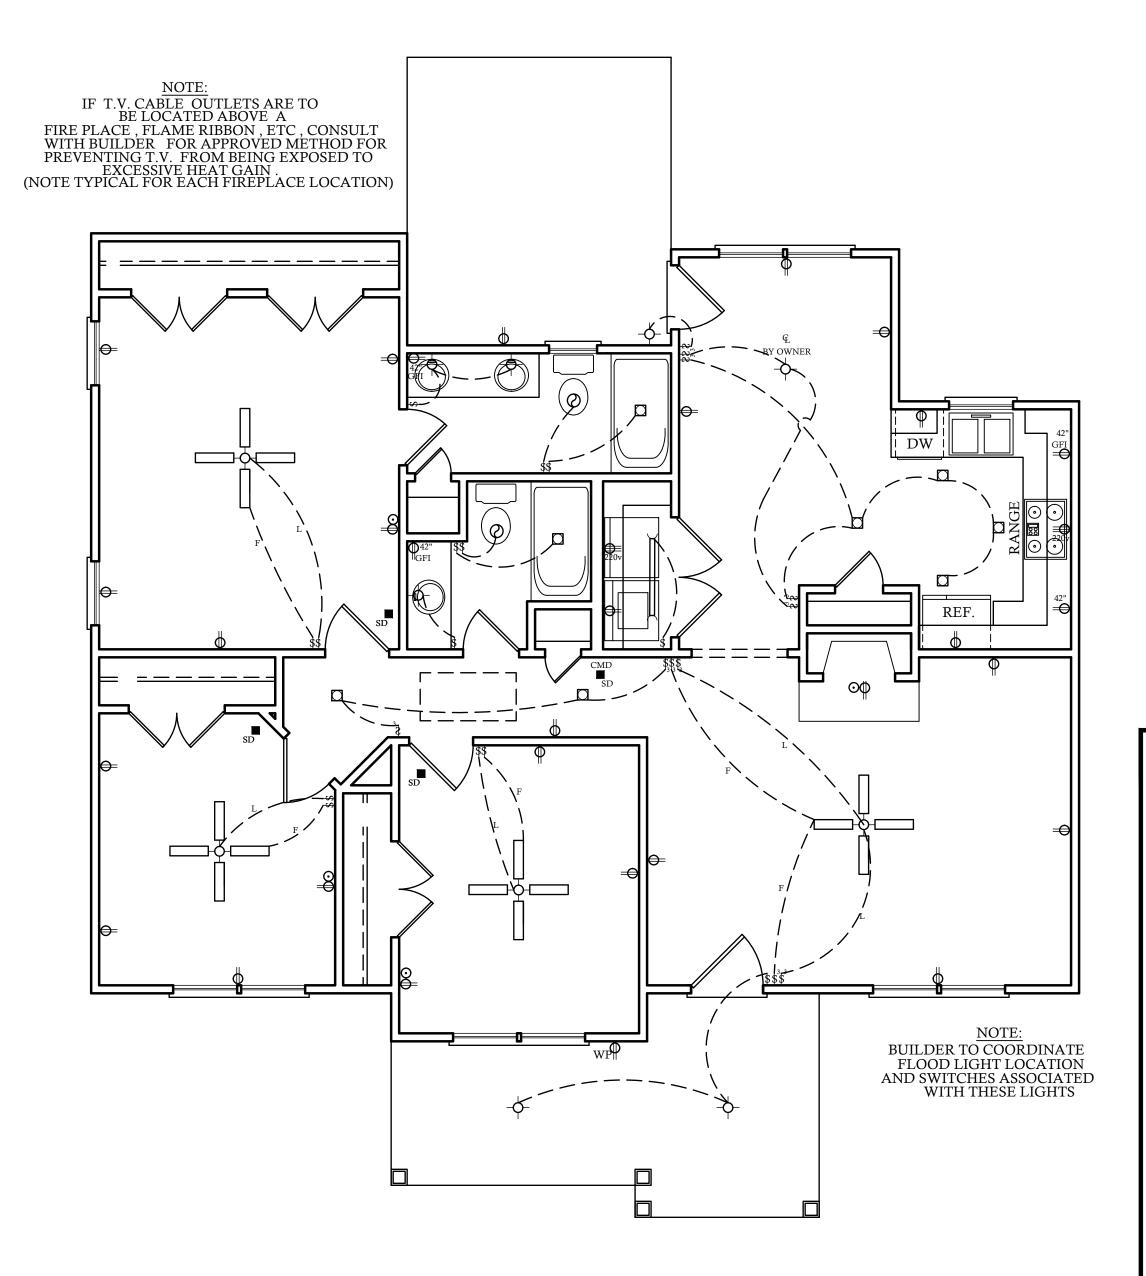


FIRST FLOOR ELECTRICAL PLAN

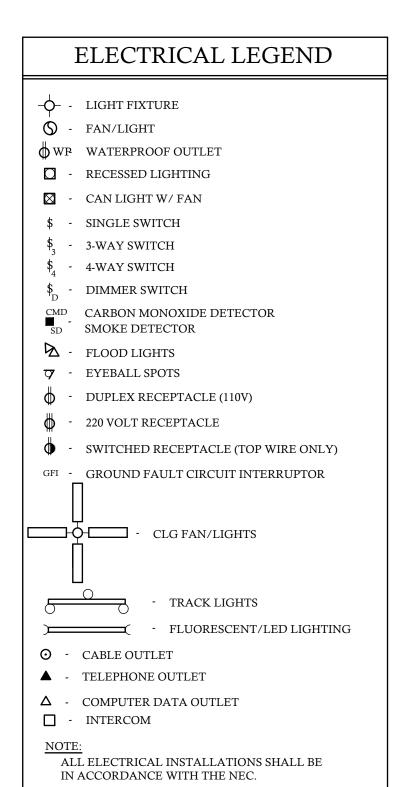

ELECTRICAL NOTES:

- 1. THE ELECTRICAL DIAGRAMS SHOWN ON THESE PLANS ARE TO BE USED AS A GUIDE. HOME OWNER AND BUILDER ARE REQUIRED TO REVIEW AND CONFIRM WITH LICENSED ELECTRICAL CONTRACTOR THESE CONTENTS PRIOR TO ROUGH-IN FOR CODE COMPLIANCE AND SPECIAL REQUIREMENTS BY THE HOME OWNER. ONCE CONSTRUCTION BEGINS, IT IS THE RESPONSIBILITY OF THE CONTRACTOR, NOT DESIGN TECH, INCORPORATED.
- 2. SEE ELECTRICIAN, BUILDER, AND OWNER FOR POSSIBLE GENERATOR LOCATION, SWITCHES, RECEPTACLES, AND ATTACHMENTS. COORDINATE SIZE AND MODEL OF GENERATOR TO HANDLE LOADS ADEQUATELY.
- 3. UNDER-CABINET COUNTER LIGHTING FOR KITCHEN IS OPTIONAL. PLEASE CONFIRM WITH CABINET MAKER AND ELECTRICIAN.
- 4. ELECTRICAL FOR EXTERIOR LANDSCAPE LIGHTING AND POOL EQUIPMENT BY BUILDER AS PER CODE.
- 5. IT IS AN OPTION FOR EVERY TOP RECEPTACLE AT FRONT WINDOWS TO BE ON ONE SWITCH LOCATED BY OWNER/BUILDER FOR WINDOW DECORATION LIGHTING.
- 6. CLOSET LIGHTING TO BE CONTROLLED BY SWITCH AS SHOWN OR IN-JAMB SWITCH WHICH WOULD ILLUMINATE LIGHT WHEN DOOR IS OPENED. SOME ELECTRICAL PLANS MAY OR MAY NOT SHOW CLOSET LIGHTING. SEE OWNER AND CONFIRM WITH BUILDER.
- 7. EXHAUST FANS ARE REQUIRED IN BATHROOMS WITHOUT NATURAL VENTILATION. OUR PLANS WILL ALWAYS SHOW EXHAUST FAN.
- 8. NO HEAT LAMPS OR HEATERS MAY BE SHOWN IN THIS DRAWING. PLEASE CONFIRM WITH BUILDER FOR PRESENCE AND LOCATION
- 9. ALL SLEEPING AREAS/BEDROOMS SHOULD CONTAIN SMOKE DETECTORS. SOME CORRIDORS ALSO REQUIRE SMOKE DETECTORS. PLEASE SEE LOCAL, STATE, AND FEDERAL BUILDING CODES TO CONFIRM THESE REQUIREMENTS.
- 10. PANEL BOX LOCATION BY ELECTRICIAN/BUILDER AS PER CODE.

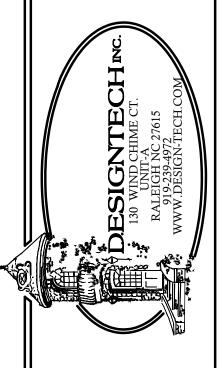

REVISIONS:

DATE:

NAME:

DRAWN BY: RKR/GES

CHECKED BY:

DATE: 7-26-23


PLAN NO. 10-1215-DT

>)-1215-DT % RED HILL RD

A I B D®

SHEET NO.

OF 7

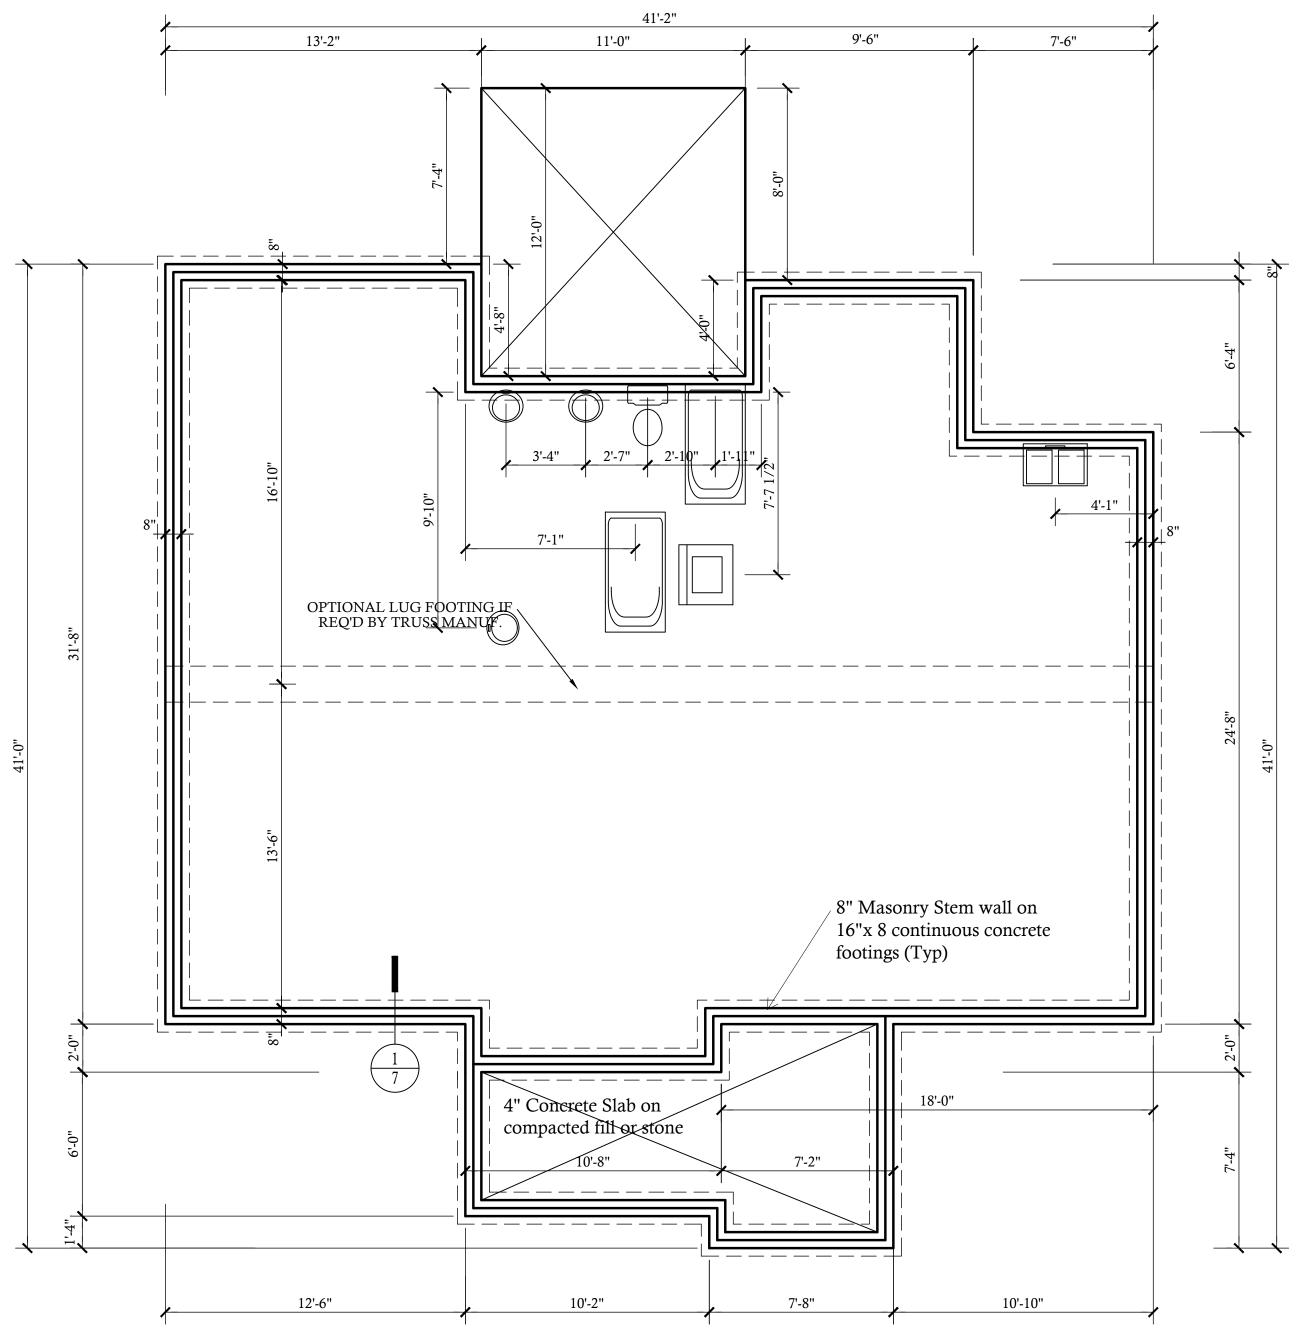

STEM WALL FOUNDATION PLAN

SCALE: 1/4"=1'-0"

STRUCTURAL EVALUATION BY: HOWERTON SERVICES, PLLC 3513 CATHEDRAL BELL ROAD RALEIGH, NC 27614 LICENSE P-1716

- * ENGINEER'S SEAL APPLIES ONLY TO STRUCTURAL COMPONENTS ON THIS DOCUMENT. SEAL DOES NOT INCLUDE CONSTRUCTION REVIEW,
- MEANS, METHODS, TECHNIQUES, SEQUENCES, PROCEDURES OR SAFETY PRECAUTIONS.
- * ANY DEVIATIONS OR DISCREPANCIES ON PLANS ARE TO BE BROUGHT TO IMMEDIATE ATTENTION OF THE ENGINEER. FAILURE TO DO SO WILL VOID ENGINEER'S LIABILITY.



08 25 2023

BRACED WALL NOTES:

- BRACED WAILS ARE REQUIRED PER SECTION R602.10.1 2018 NCBC RESIDENTIAL CODE
- 2. THE EXTERIOR WALL STRUCTURE SHALL BE CONTINUOUSLY SHEATHED, FULL HEIGHT WITH MIN. THICKNESS 7/16" OSB. THESE WAILS SHALL BE CONSTRUCTED IN CONFORMANCE TO TYPE CS-WSP DETAILS. REFER TO PLAN FOR LOCATION OF REQUIRED BRACING LABLED "CS BRACING" AND LENGTH OF WALL BRACING LABELED IN LINEAR FEET.
- 3. INTERIOR WALLS WHERE NOTED SHALL BE BRACED PER INDICATED METHOD IN REFERENCE TO NCBC-RESIDENTIAL CODE, TABLE R602.10.2.

LIB METHOD:
INSTALL 1X4 WOOD OR CONTINUOUS METAL STRAPPING AT 45 DEGREES TO 60 DEGREES FROM TOP PLATE TO BOTTOM PLATE ACROSS STUDS WITH MAXIMUM STUD SPACING OF 16" ON CENTER. CONNECT AS INDICATED IN CODE SECTION.

MINIMUM 1⁄2" GYPSUM BOARD TURNED VERTICALLY AND CONTINUOU FROM TOP PLATE TO BOTTOM PLATE. SCREW CONNECTION TO FRAMING USING SPACING CRITERIA AS INDICATED IN CODE TABLES.

- 4. SPECIAL BRACING DETAILS ARE ILLUSTRATED IN THE CODE AND ALLOWED WHERE WALLS DO NOT MEET THE **MINIMUM** REQUIREMENTS FOR SUPPORT.
- 5. SEE TABLE R602.7.5 FOR CORRECT NUMBER OF KING STUDS PER HEADER.

GENERAL FRAMING NOTES:

- THIS PLAN DESIGNED IN ACCORDANCE WITH NC RESIDENTIAL CODE. 2018
- 2. GLAZING AREAS SHOWN ON THESE DESIGN DRAWINGS DO NOT EXCEED 15% OF THE GROSS AREA OF THE EXTERIOR WALLS. THIS STRUCTURE MEETS THE REQUIREMENTS OF NI101.2.1, RESIDENTIAL BUILDING, TYPE A-1.
- 3. WALL CLADDING IS DESIGNED FOR A 24.1 #/SF OR GREATER
- POSITIVE/NEGATIVE PRESSURE.
- 4. ALL WALLS, FLOORS AND CEILINGS SHALL BE INSUIATED IN ACCORDANCE WITH CODE SÚMMARY.

DESIGN CRITERIA:	DEAD	LIV
PRIMARY FLOOR	10 PSF	40 PS
SECONDARY FLOOR	10 PSF	40 PS
SLEEPING AREAS	10 PSF	30 PS
ATTIC	10 PSF	20 PS
ROOF	10 PSF	20 PS
DEFLECTION LIMITS:		

FLOOR L/360{LIVE LOAD ONLY) ROOF


- 6. ALL HEADERS IN LOAD BEARING WALLS SHALL BE DOUBLE 2X10 U.O.N.
- 7. ALL WALLS ARE 2X4 @ 16" O.C. U.O.N.
- 8. PROVIDE DOUBLE FLOOR JOISTS UNDER WALLS ABOVE.
- 9. PROVIDE FOUNDATION VENT WITHIN 36" OF EACH CORNER.
- 10. ALL JOISTS TO BE SPF.

REVISIONS:

NAME: DATE:

> DRAWN BY: RKR/GES CHECKED BY:

DATE: 7-26-23 PLAN NO. 10-1215-DT

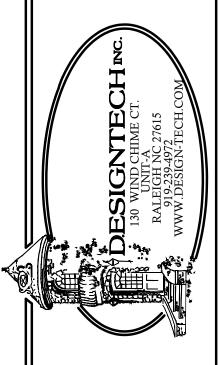

10-1215-DT

ROOF VENTILATING REQUIREMENTS

SQ.FT. OF AREA 1307 VENTILATED 150 (144) = 1254.7 TOTAL SQ. IN. OF ATTIC VENTILATION REQ'D


NOTE: FIGURE BASED ON SECTION R-806.2 OF THE 2018 NCRC .

TO BE REDUCED TO 1 TO 300 WHEN CONDITIONS ARE MET AS PER SECTION R806.2 OF THE 2018 NCRC

INLET:

 $\underline{1254.7}$ (.5) = $\underline{627.4}$ SQ. IN. OF INLET VENTING REQ'D

1254.7 (.5) = 627.4 SQ. IN. OF OUTLET VENTING REQ'D

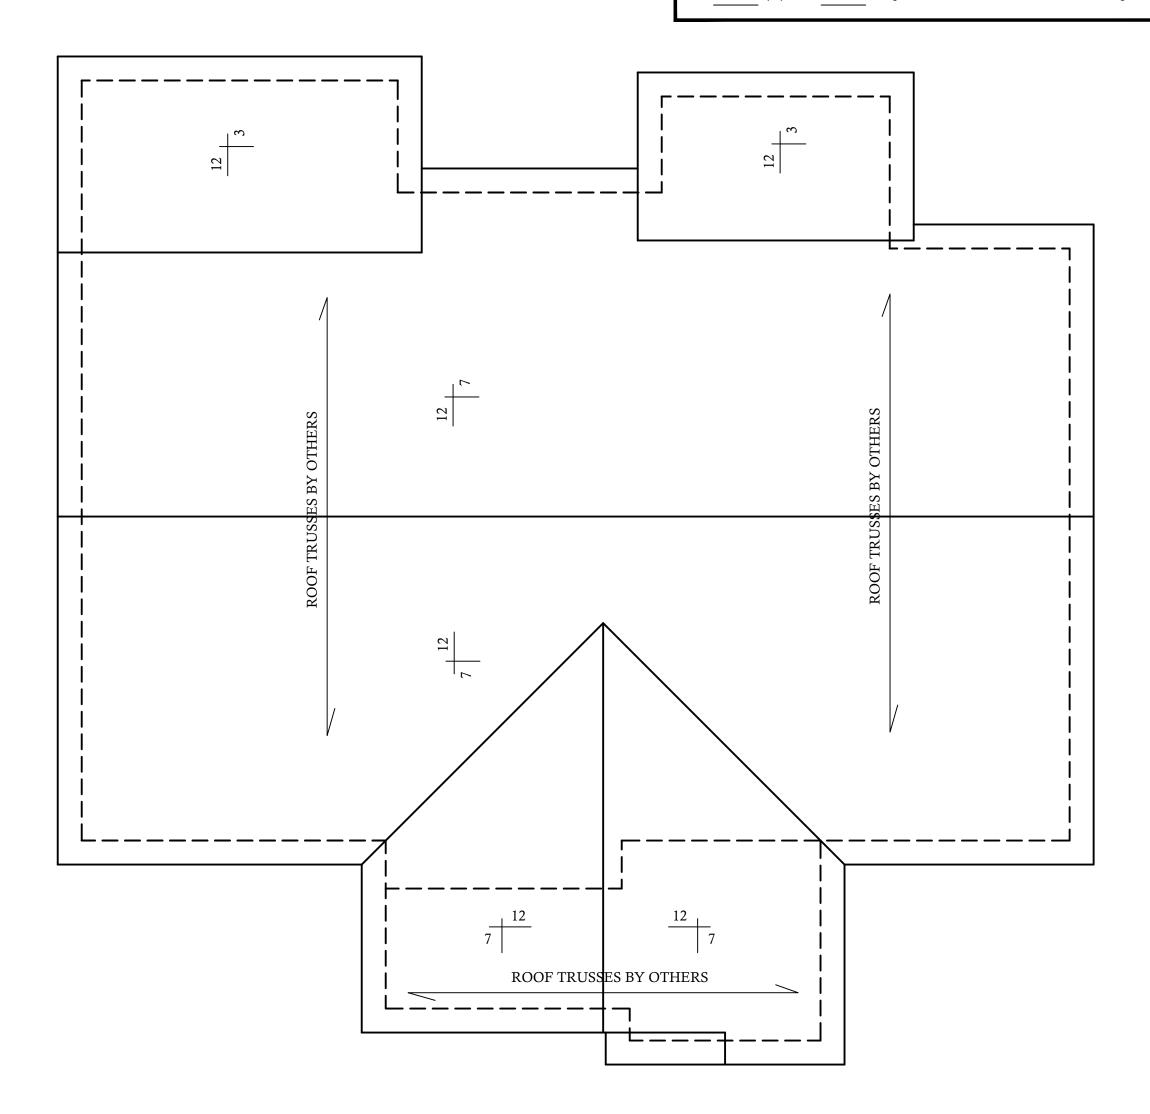

All Roof Members to be Trusses by Others

ROOF FRAMING PLAN


SCALE: 1/4"=1'-0"




NAME:


DRAWN BY: RKR/GES CHECKED BY: JCD

DATE: 7-26-23 PLAN NO. 10-1215-DT

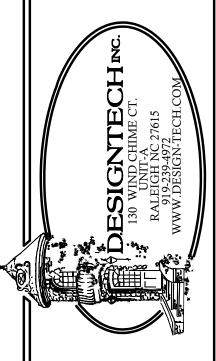

10-1215-DT

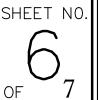

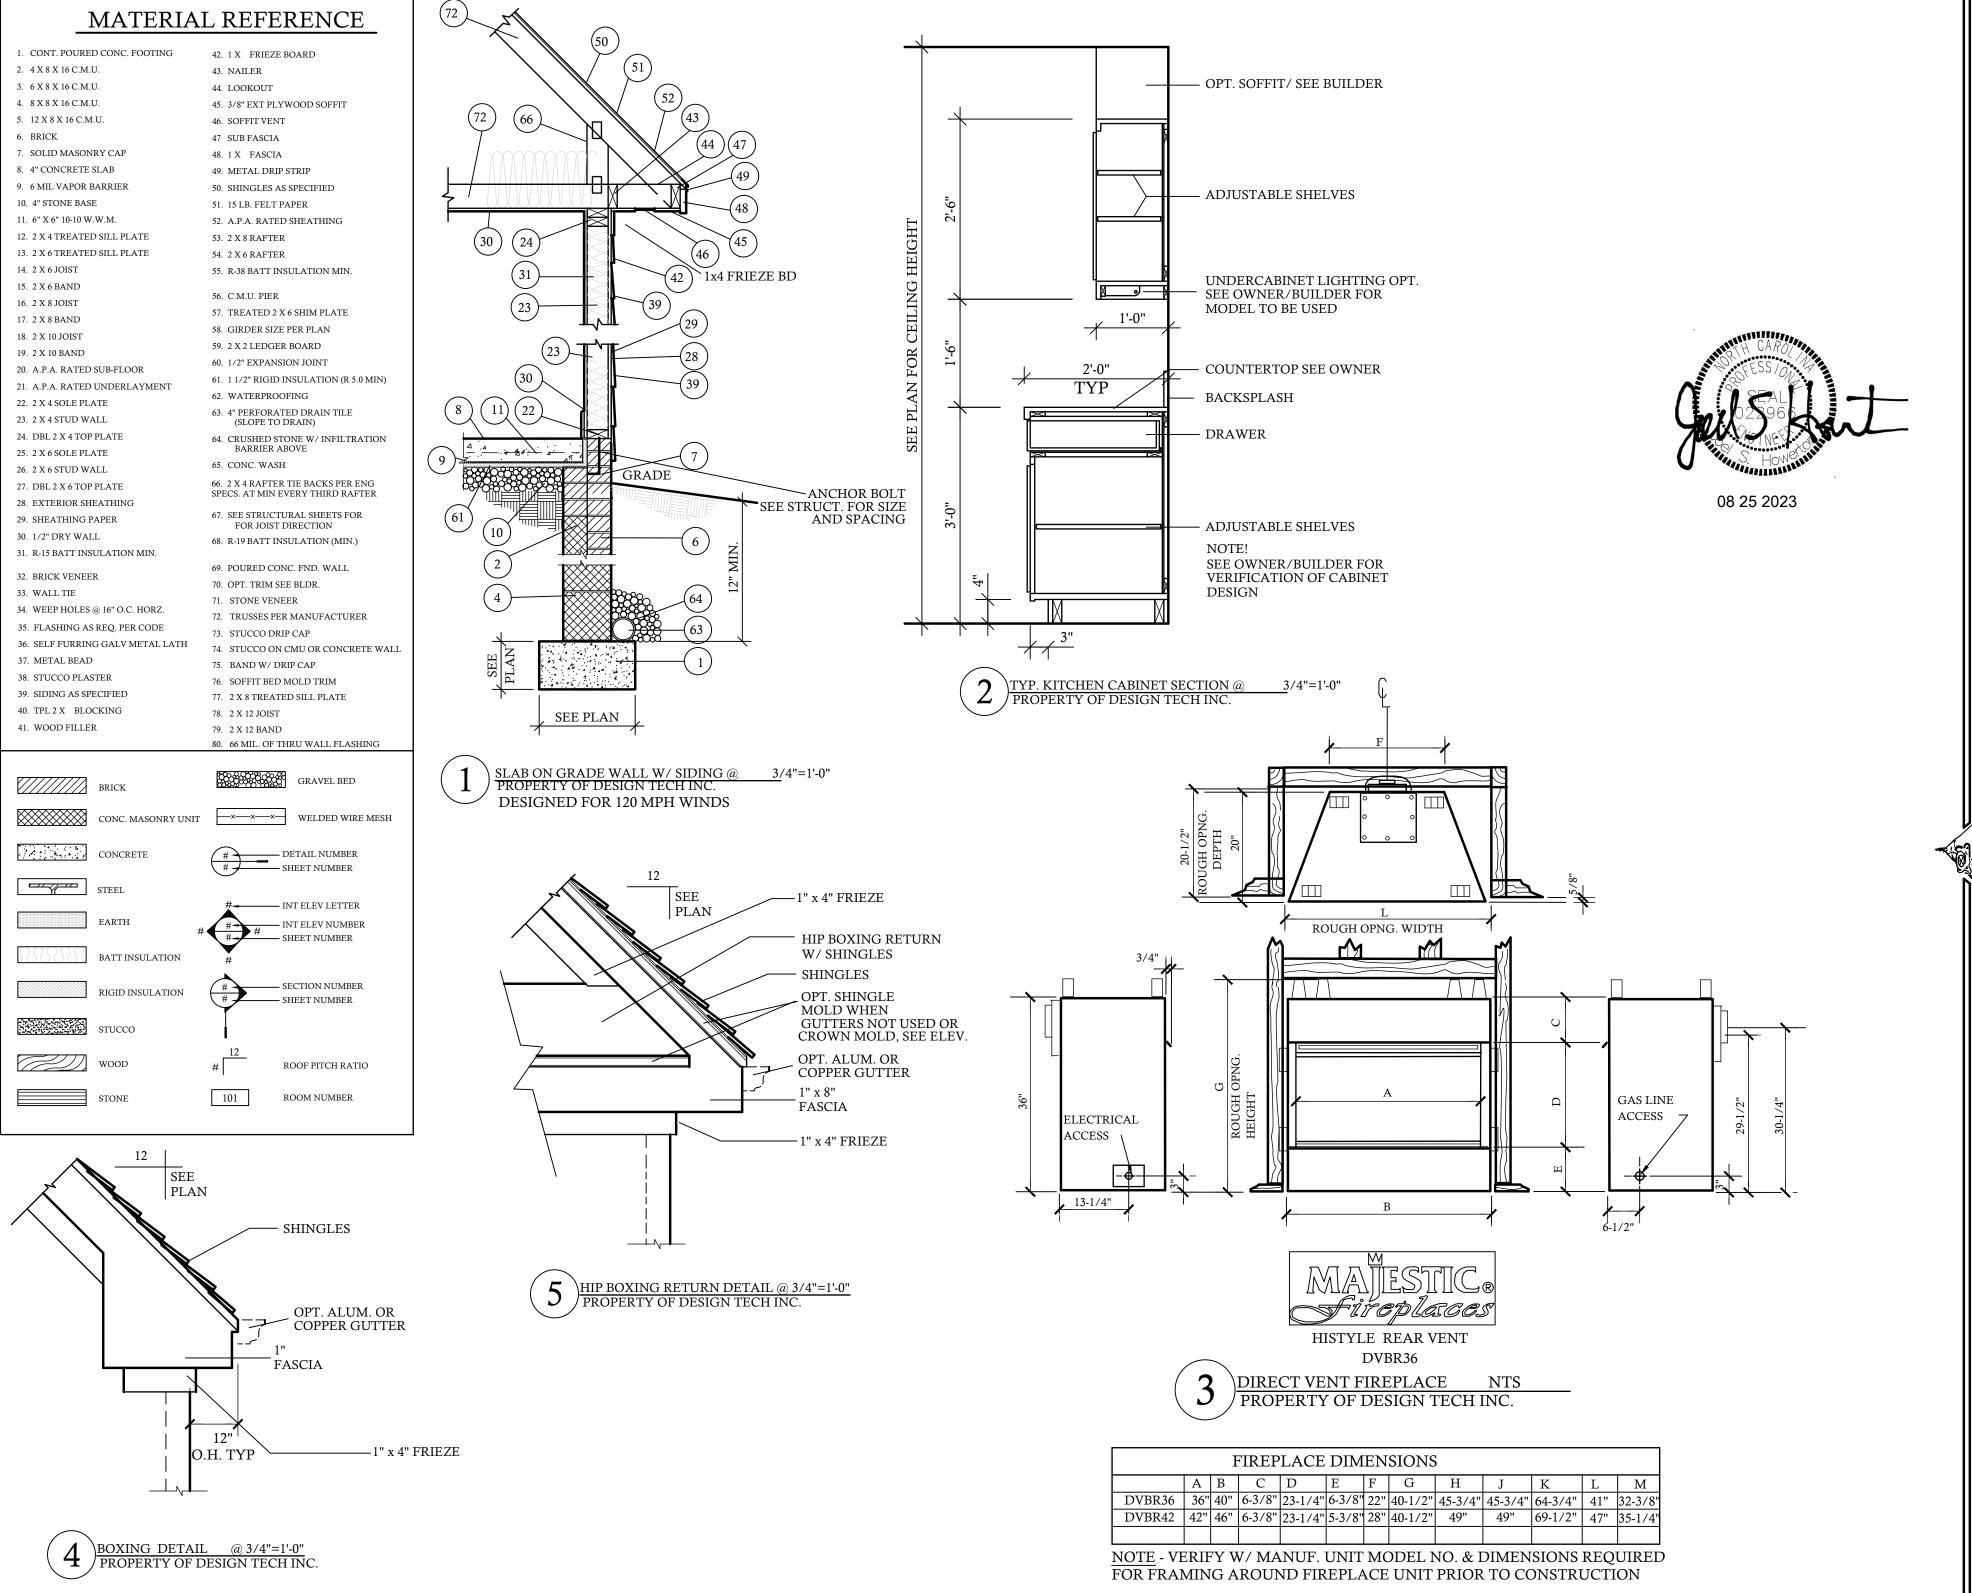

CONTRACTOR SHALL VERIFY ALL CONDITIONS

AND DIMENSIONS PRIOR TO CONSTRUCTION.

ANY ERROR OR OMISSIONS SHALL BE REPORTED

TO DESIGN TECH, INC. FOR CORRECTIONS OR

ZUSTIFICATION. CONTRACTOR MUST COMPLY

WITH ALL LOCAL BUILDING CODES WHERE
HOME IS TO BE BUILT. IF NO ENGINEERING
DRAWNINGS ARE PROVIDED. CONTRACTOR MUST
CONSULT WITH LOCAL ENGINEER FOR
STRUCTURAL DESIGN. ONCE CONSTRUCTION
HAS BEGUN, CONTRACTOR WILL ASSUME
ALL RESPONSIBILITY.
PLAN HAS BEEN DESIGNED TO COMPLY WITH

DRAWN BY:
RKR/GES
CHECKED BY:
JCD
DATE:
7-26-23
PLAN NO.

10-1215-DT

DESIGNTECH INC.

130 WIND CHIME CT.

UNIT-A
RALEIGH NC 27615
919-239-4972

WWW.DESIGN-TECH.COM

10-1215-DT 996 RED HILL RD

SHEET N