	Customer Plan Review Signature
1. XXX       1. XXX       1. XXX       1. XXX         2. XXX       2. XXX       2. XXX       2. XXX	I understand that my new Drees home will be built in general com plans, specifications, selections and the Purchase Agreement, all reviewed and approved. This set of plans may not reflect the elev for my house. Drees draws the standard plans complete with the options. The subcontractor's sets will show only the options I select selection sheets. I have reviewed the plot plan for my house and a there may be some field adjustments as to the exact location of the
3. XXX 3. XXX 3. XXX 3. XXX	In the they be some here a departments as to the early the early like where the advect to the early like where the early like where the maximum of the early like where early lik

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	0C.1 0N.1	Cover Sheet General Notes			
	0P.1	Plot Plan			
	1.01\$	Foundation Plan (Slab)			
	2.01F	First Floor Framing Plan			
	2.01S 2.02F	First Floor Structural Plan Second Floor Framing P			
	2.02\$	Second Floor Structural			
	2.03F	Third Floor Framing Plan			
	2.035	Third Floor Structural Pla Roof Plan	n		
	2.04 3.02	Second Floor Subfloor P	lan		
	4.01	First Floor Mechanical P			
d second floor area	4.02	Second Floor Mechanic			
	4.03	Third Floor Mechanical	Plan		
	5.01 6.01	Building Section Front Elevation			
	6.02	Garage Side Elevation			
	6.03	Rear Elevation			
	6.04 7.01	Side Elevation House Specific Details			
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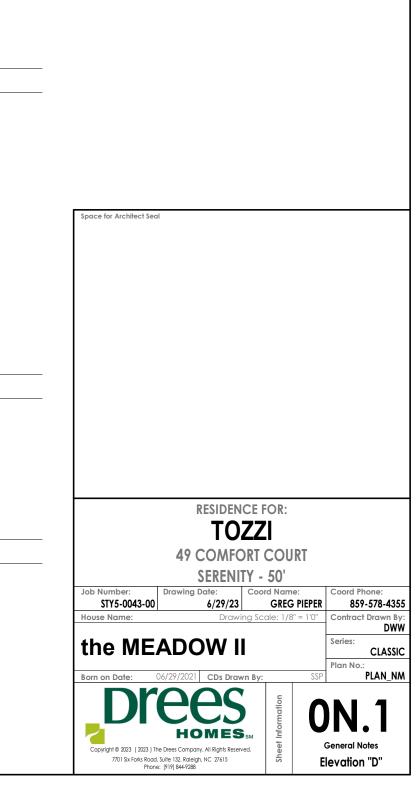
### **GENERAL NOTES - RALEIGH**


### FOUNDATION NOTES CRAWL SPACES: BASEMENTS SLOPE CONCRETE SLAB 4" MINIMUM TOWARDS GARAGE DOOR SLOPE CONCRETE SLAB 4" MINIMUM TOWARDS GARAGE DOOR EXTERIOR FLATWORK/GARAGES SHALL HAVE A MINIMUM CONCRETE SRENGTH OF 4,500 PSI - EXTERIOR FLATWORK/GARAGES SHALL HAVE A MINIMUM CONCRETE SRENGTH OF 4,500 PSI FOOTINGS TO A MINIMUM CONCRETE STRENGTH OF 2500 PSI, UNLESS OTHERWISE NOTED - FOOTINGS TO A MINIMUM CONCRETE STRENGTH OF 2500 PSI, UNLESS OTHERWISE NOTED- ALL FOUNDATION WALLS TO BE CAST IN PLACE CONCRETE 3000 PSI MIN. UNLESS OTHERWISE ASSUMED ALLOWABLE SOIL BEARING PRESSURE: 2,000 p.s.f. NOTED. WATERPROOF FOUNDATION WITH BITUMINOUS SPRAY. - BASEMENT WINDOW LOCATIONS MAY VARY FROM DRAWING DUE TO LOT CONDITIONS. WALL TIES EMBEDDED IN THE HORIZONTAL MORTAR JOINT SHALL BE 16" ON CENTER. TIES IN ALTERNATE COURSES SHALL BE STAGGERED. - BACKFILL ADJACENT TO FOUNDATION WALLS SHALL NOT BE PLACED UNTIL THE WALL HAS SUFFICIENT STRENGTH AND HAS BEEN ANCHORED TO THE FLOOR OR HAS BEEN SUFFICIENTLY THE MAXIMUM VERTICAL DISTANCE BETWEEN TIES SHALL NOT EXCEED 16" AND THE MAXIMUM HORIZONTAL DISTANCE SHALL NOT EXCEED BRACED TO PREVENT DAMAGE BY THE BACKELL 16" ADDITIONAL TIES SHALL BE PROVIDED AT ALL OPENINGS, AND WITHIN 12" OF THE OPENING. - ASSUMED ALLOWABLE SOIL BEARING PRESSURE: 2,000 p.s.f. CORE FILL ENTIRE BLOCK WALL WHEN THE WALL IS 4'-O" TALL OR HIGHER. INSTALL #4 REBAR IN EACH HOLLOW AREA OF EACH BLOCK WATERPROOF FOUNDATION WITH BITUMINOUS SPRAY. - VERTICAL CONTROL JOINTS IN BASEMENT FOUNDATION WALLS - STANDARD LOCATION GUIDELINES: FROM FOOTING TO TOP OF WALL. ON THE ENTIRE WALL PRIOR TO CORE FILLING IT. TOP COURSE OF BLOCK ON ALL WALLS WILL BE FILLED SOLID WITH MORTAR PLACING THE FOUNDATION STRAPS OR BOLTS IN THE MORTAR 1) PLACE A CONTROL JOINT IN ALL UNBRACED WALLS OVER 30' IN LENGTH. (NOTE: "T" WALLS AND CORNERS COUNT AS A BRACE). 5-0" ON CENTER, AND 12" FROM FACH CORNER 2) WINDOWS THAT ARE LARGER THAN THE STANDARD BASEMENT WINDOW REQUIRE A CONTROL JOINT. 12"x16" PIERS: HOLLOW MASONRY UP TO 48" HIGH, SOLID MASONRY UP TO 9'0" HIGH 3) CONTROL JOINTS ARE NOT REQUIRED AT EVERY WINDOW THAT IS STANDARD SIZE. 16"x16" PIERS: HOLLOW MASONRY UP TO 64" HIGH, SOLID MASONRY UP TO 12'0" HIGH 4) IF THERE IS A STANDARD WINDOW LOCATED IN A WALL SEGMENT THAT REQUIRES A CONTROL JOINT, THEN THE CONTROL JOINT SHOULD BE PLACED ON THE SIDE OF THE WINDOW BLOCK PIERS SHOULD BE PLACED DIRECTLY ON CONCRETE FOOTINGS PER PLAN. THEY SHOULD BE PLUMBED AND SQUARE WITHIN 1/4". THAT IS ADJACENT TO THE LONG SIDE OF THE WALL. IF THERE IS MORE THAN ONE WINDOW IN A WALL THEN ONLY ONE WINDOW SHOULD HAVE A CONTROL JOINT SILL PLATES TO BE A MINIMUM OF 2x4 NOMINAL LUMBER. 5) DOORS DO NOT GET CONTROL JOINTS. 6) CONTROL JOINTS SHOULD NOT BE LOCATED WITHIN 3' OF A BEAM POCKET. 7) CONTROL JOINTS ARE REQUIRED AT THE FIRST AND LAST STEP DOWN AT STEPPED BASEMENT FOUNDATION WALLS. . INTERIOR FLATWORK SHALL HAVE A MINIMUM CONCRETE STRENGTH OF 3,000 PSI. ALL VERTICAL STEEL AND ALL STEEL IN STRUCTURAL SLABS TO BE GRADE 60. ALL HORIZONTAL STEEL IN FOUNDATION WALLS AND FOOTERS TO BE GRADE 40 STEEL. FRAMING NOTES MECHANICAL/ELECTRICAL NOTES DESIGN LOADS: ANY GAS APPLIANCES MUST BE INSTALLED PER MANUFACTURER'S SPECIFICATIONS. SEISMIC: "A" & "B" FLOORS: 40 psf LIVE LOAD + 10 psf DEAD LOAD = 50 psf GARAGE FLOOR: 50 psf LIVE LOAD HOLD THE CENTERLINE OF ALL EXTERIOR LIGHT FIXTURES AT 5'-8" OFF BOTTOM OF DOOR OPENING. ROOF: 18 psf LIVE LOAD + 17psf DEAD LOAD = 35 psf WIND SPEED: 120 MPH ALL KITCHEN CABINET DIMENSIONS ARE CABINET TO CABINET. DESIGN DEFLECTION LIMITS (BASED ON LIVE LOAD, EXCEPT MASONRY): CABINET STYLES MAY VARY FROM INTERIOR ELEVATIONS DEPENDING ON STYLE, MANUFACTURER, ETC. FOR CABINET RAFTERS GREATER THAN 3:12 L/180 CEILINGS 1/240 DETAILS SEE SHOP DRAWINGS MASONRY VENEER L/600 CABINET SIZES MAY VARY WITH FULL-OVERLAY CABINETS. NOMINAL LUMBER FLOORS 1/360 GROUND FAULT INTERRUPTER (GFCI) OUTLETS TO BE INSTALLED PER NEC 2017, SECT. 210.8 MANUFACTURED WOOD FLOORS: DESIGNED TO MINIMUM PRO RATING OF 35 (OR EQUIVALENT). PROVIDE HOSE BIBS PER DIVISION SPEC. SHEET, EXACT LOCATION TO BE FIELD DETERMINED UNLESS OTHERWISE NOTED NO MORE THAN 8 POINT DIFFERENCE BETWEEN ADJACENT SPANS. ON THE PLANS L/480 FOR SPANS UP TO 16'-0" AND NO GREATER THAN 1/2" DEFLECTION - MIN. 50 C.F.M. FOR ALL EXHAUST FANS IN BATHROOMS L/600 FOR SPANS OVER 16'-0" IF SIMPLE SPAN AND NO GREATER THAN 1/2" DEFLECTION L/840 FOR SPANS OVER 16'-0" IF CONTINUOUS SPAN. AND NO GREATER THAN 1/2" DEFLECTION INSULATION DETAILS IOIST SPACING. 19.2" O.C. MAXIMUM SPACING R-15 EXTERIOR STUD WALL CAVITY: (2x4) DOUBLE EVERY OTHER FLOOR JOIST UNDER KITCHEN ISLANDS (2x6) R-19 INSTALL UNCOUPLING MEMBRANE IN TILE FLOOR AREAS IF 19.2" O.C. FLOOR JOIST SPACING FLOOR JOIST CAVITY AT STANDARD PERIMETER: R-19 GLUE AND MECHANICALLY FASTEN [SCREWS] WOOD FLOOR IF 19.2" o.c. FLOOR JOIST SPACING FLOOR JOIST CAVITY AT CANTILEVER: R-19 MANUFACTURED WOOD PRODUCTS (INCLUDING, BUT NOT LIMITED TO, STRUCTURAL WOOD BEAMS AND I-JOISTS) SHALL BE FABRICATED, (OVER HORIZONTAL SPACE) R-38 BLOWN OVER GARAGE HANDLED, AND INSTALLED IN ACCORDANCE WITH THE MANUFACTURER'S INSTRUCTIONS. (SLOPED AND VERTICAL SPACE) R-38 BATT JOISTS ARE NOT TO BE PLACED DIRECTLY OVER INTERIOR PARALLEL WALLS. (TO PREVENT UNEVEN FLOOR DEFLECTION FROM OCCURRING) ALL WOOD BEAMS/HEADERS: 2x6's TO BE SPF STUD GRADE OR BETTER/ 2x8 OR LARGER TO BE SYP #2 [ PER NDS 2012 ] OR BETTER, U.O.N. ALL HEADERS SHALL BE SUPPORTED BY (1) 2X JACK STUD AND (1) 2X KING STUD MINIMUM. THE NUMBER OF STUDS SPECIFIED AT A SUPPORT INDICATES THE NUMBER OF JACKS REQUIRED, U.N.O. AT FLUSH OR DROPPED BEAMS, THE NUMBER OF STUDS SPECIFIED INDICATES THE TOTAL NUMBER OF STUDS REQUIRED TO SUPPORT THE BEAM EXTERIOR WALLS TO BE 2x4 SPF STUD GRADE AT 16" o.c. UNLESS OTHERWISE NOTED (10'4-1/2" MAXIMUM WALL HEIGHT) ALL INTERIOR BEARING WALLS AND WALLS AT BASEMENT & FIRST FLOOR STAIRWELLS, KITCHEN, BATH, & GARAGE TO BE 2x4 SPF STUD GRADE @ 16" o.c.; ALL OTHER NON-BEARING INTERIOR WALLS TO BE 2x4 SPF STUD GRADE @ 24" o.c. U.O.N. ALL WALLS TO BE 3 1/2" UNLESS OTHERWISE NOTED. **ELEVATION NOTES** PROVIDE SOLID BEARING TO FOUNDATION OR BEAM BELOW FOR ALL BEAMS, HEADERS & GIRDER TRUSSES, PROVIDE BLOCKING BETWEEN JOISTS WINDOW STYLE AND MULLIONS MAY VARY FROM ELEVATION DEPENDING UPON MANUFACTURER. STYLE, PATTERN, TYPE, AS REQUIRED SEE SELECTION SHEET FOR SIZE AND STYLE OF FIREPLACE. SEE FIREPLACE ELEVATION DETAIL FOR ADDITIONAL FRAMING REQUIREMENTS, IF ANY. USE SECONDARY HEAT BARRIER ON ALL DIRECT VENT FIREPLACES 7' OR LESS ABOVE A WALKWAY. CHECK SELECTION SHEETS FOR FLOOR COVERING AT TOP AND BOTTOM OF STAIR RISERS AND ADJUST RISERS AS REQ'D. GRADE AWAY FROM FOUNDATION WALLS SHALL FALL A MINIMUM OF 6" WITHIN THE FIRST 10'. PROVIDE BLOCKING AT ALL HANDRAIL TERMINATION AND BRACKET LOCATIONS. PROVIDE TYVEK OR EQUIVALENT HOUSE WRAP BEHIND BRICK AND STONE VENEER OVER WOOD SHEATHING. 20-MINUTE FIRE RATED DOOR BETWEEN GARAGE AND LIVING AREA. PROVIDE BRICK WEEP HOLES AT 24" O.C. WITH BRICK VENEER AND MORTER NET BEHIND AND THROUGH WEEP HOLES. EXTERIOR WALL TO BE 2x4 SPF STUD G AT 16" o.c. UNLESS OTHERWISE NOTED (10'-0" MAXIMUM UNBRACED WALL HEIGHT). PROVIDE FLASHING AND WEEP HOLES ABOVE ALL BRICK ANGLE IRONS, BELOW ALL BRICK SILLS AND ABOVE SILL PLATE ALL EXTERIOR WALLS AND INTERIOR BEARING WALLS, FRAMED HIGHER THAN THE STANDARD PLATE HEIGHT. SHALL BE FRAMED WITH CONTINUOUS SEALERS FULL HEIGHT STUDS TO THE HIGHEST CEILING (I.E. NO INTERMEDIATE BREAKS) TO PREVENT LATERAL HINGE CONDITIONS. - EXTERIOR STEPS TO HAVE A MAXIMUM 8" RISER. WHEN VERTICAL RISE EXCEEDS 30" OR FOUR OR MORE CONTINUOUS IN THE GARAGE, PROVIDE 1/2" GYP. BOARD AT ALL WALLS COMMON TO LIVING SPACE AND ALL STRUCTURAL MEMBERS SUPPORTING RISERS, A HANDRAIL IS REQUIRED. FLOOR/CEILING ASSEMBLY. GARAGE CEILING TO BE 1/2" SAG RESISTANT GYP. BOARD WHEN THERE ARE NO HABITABLE SPACES ABOVE, OR 5/8" TYPE X GYP. BOARD WHEN HABITABLE SPACES ARE ABOVE. ALL EMERGENCY ESCAPE & RESCUE OPENINGS TO BE A MAXIMUM OF 44" OFF OF FINISHED FLOOR AND HAVE MINIMUM OPENING DIMENSIONS OF 24" IN HEIGHT, 20" IN WIDTH, & HAVE A MINIMUM OPENING AREA OF 5.7 S.F. **ROOF PLAN NOTES** ALL DOORS TO BE 6'-8" TALL UNLESS OTHERWISE NOTED. ALL GLASS IN INTERIOR AND EXTERIOR DOORS TO BE TEMPERED (INCLUDING SIDELITES AND TRANSOMS) ALL OVERHANGS TO HAVE (2) SOFFIT VENTS PER EACH 8' SOFFIT SECTION. ALL LUMBER CONTACTING CONCRETE TO BE PRESSURE TREATED. PROVIDE BAFFLES AT EXTERIOR TRUSS BEARING FOR VENTILATION. ALL FASTENERS, HANGERS, AND OTHER CONNECTORS TO BE USED WITH PRESSURE TREATED WOOD ARE TO HAVE ZMAX COATING (OR PROVIDE 15# FELT PAPER UNDER SHINGLES EQUIVALENT) HOT-DIPPED GALVANIZED OR STAINLESS STEEL. AT STAIR HANDRAIL, ON ONE SIDE ONLY, SHALL BE CONTINUOUS FOR THE ENTIRE LENGTH OF THE STAIRWAY, AND ENDS SHALL BE RETURNED TO A WALL OR POST. THE HANDRAIL MAY BE INTERRUPTED AT A NEWEL POST AT A TURN. ALL HANDRAIL GRIP PORTIONS SHALL NOT EXCEED 2-1/4" IN CROSS SECTIONAL DIMENSION. HANDRAILS SHALL BE INSTALLED ON ALL STAIRS WITH 2 OR MORE RISERS, HANDRAIL HEIGHTS SHALL BE A MINIMUM OF 34" AND A MAXIMUM OF 38". ALL STAIRS TO BE CONSTRUCTED SO AS NOT TO ALLOW A 4" SPHERE TO PASS THROUGH THE RISER.


GUARDRAILS MUST BE A MINIMUM OF 36" HIGH. GUARDRAILS AT THE OPEN SIDES OF STAIRS MUST BE A MINIMUM OF 34" HIGH MEASURED VERTICALLY


FROM THE NOSING AT THE TREADS. THE HORIZONTAL SPACING OF THE VERTICAL BALUSTERS SHALL BE 4" O.C.

GUARDRAIL DESIGN TO RESIST A MINIMUM OF 200 LBS LATERAL FORCE



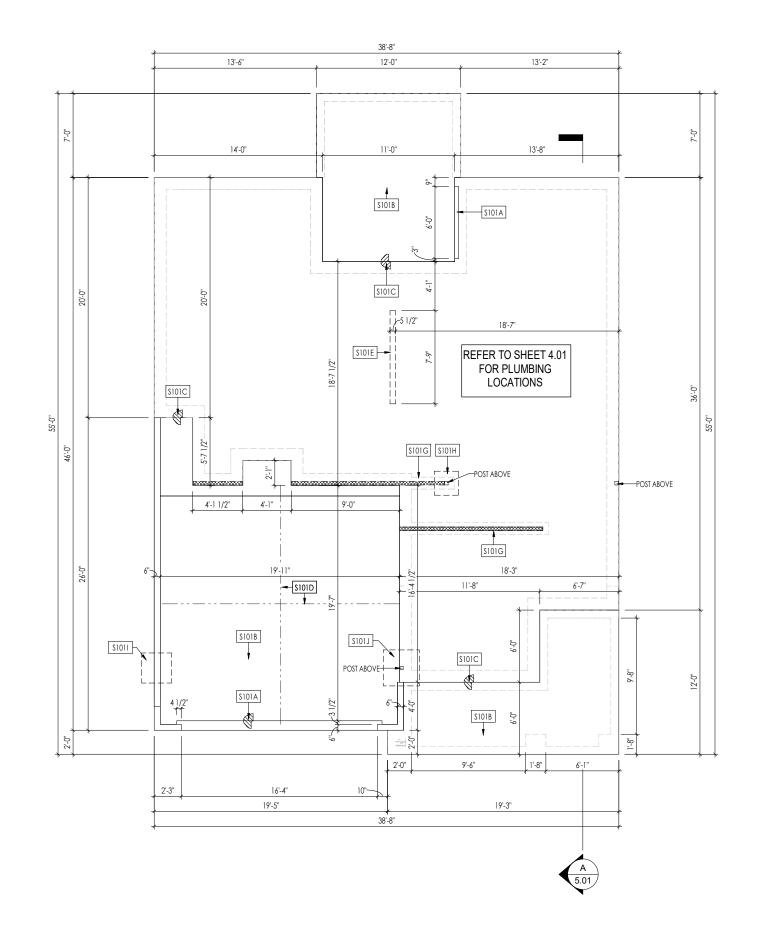

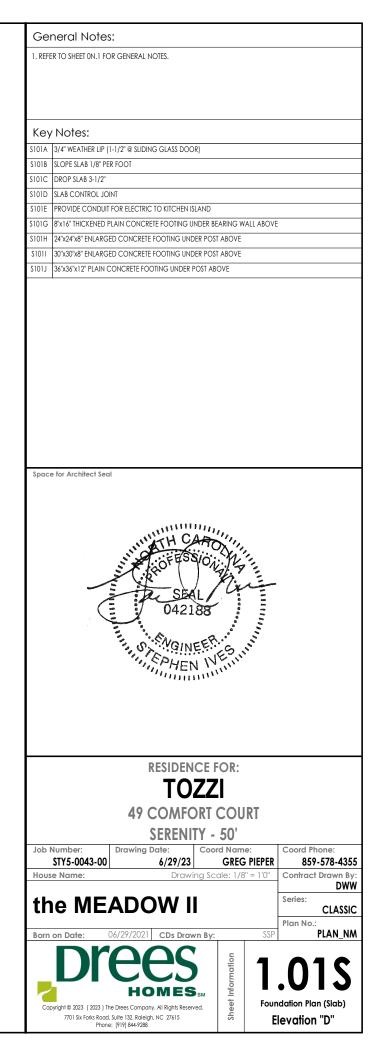

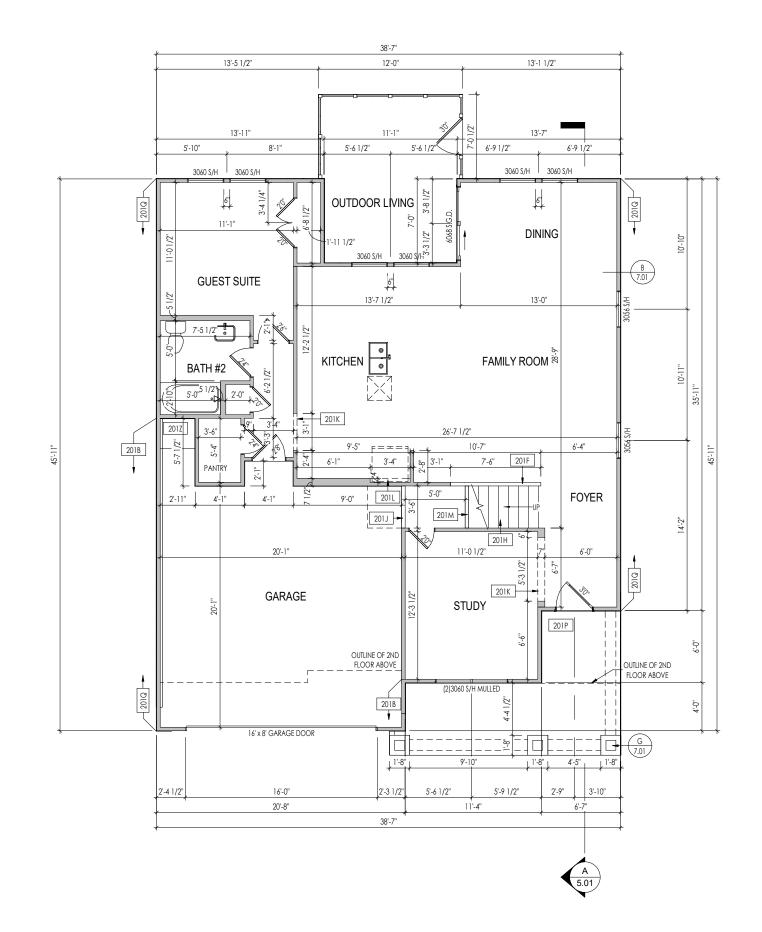

### General Notes:

. REFER TO SHEET ON.1 FOR GENERAL NOTES.

2. ALL FIRST FLOOR CEILINGS TO BE 9-1" ABOVE SUBFLOOR UNLESS OTHERWISE NOTED. 3. FRAME TOP OF ALL WINDOWS AT 1'0-1/4" BELOW TOP OF PLATE UNLESS OTHERWISE NOTED.


4. ALL DROPPED, INTERIOR HEADERS (FALSE AND BEARING) ARE DROPPED 1'-0" FROM CEILING.

5. REFER TO SELECTION SHEETS FOR FLOORING MATERIAL PRIOR TO CONSTRUCTING STAIRS TO DETERMINE

RISER HEIGHTS. 6. REFER TO SHEET 2.01S FOR STRUCTURAL INFORMATION.

Key	y Notes:
201B	FRAME GARAGE WALLS AT 10'-1" HIGH FROM TOP OF FOUNDATION WALL
201F	SLOPE WALL EVEN WITH TOP OF STAIR STRINGER, RAILING ABOVE
201H	SEE DETAIL F/7.01 FOR STAIR FRAMING DETAILS
201 J	+/-7'-1 1/2" HIGH WALL UNDER STAIRS ABOVE
201K	FRAME TOP OF OPENING AT HEIGHT SPECIFIED IN GENERAL NOTES ON THIS SHEET
201L	REFRIG. HEADER HELD TO 6'-6" A.F.F.
201M	APPROX. LOCATION OF 36" HIGH WALL UNDER STAIRS (FIELD VERIFY)
201P	CARPENTER TO DROP ELECTRICAL WIRE THROUGH PORCH CEILING FOR LIGHTS
201Q	PROVIDE 1/2" FIRE RATED PLYWOOD ON SIDE ELEVATIONS
201Z	18" HIGH WATER HEATER PLATFORM

Space for Architect Seal

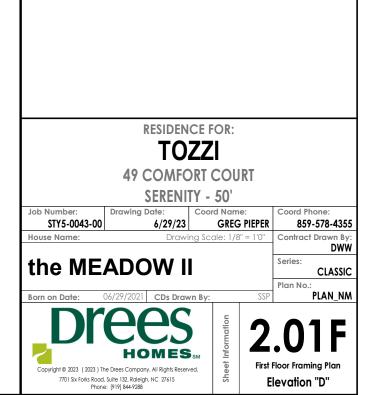

### LATERAL/WALL BRACING & WALL SHEATHING SPECIFICATIONS THIS MODEL HAS BEEN DESIGNED TO RESIST LATERAL FORCES RESULTING FROM: 120 MPH WIND IN 2018 NCSBC MAP (120 MPH WIND SPEED IN ASCE 7-10 WIND MAP, PER IRC R301.2.1.1)

EXP. B & SEISMIC CAT. A/B.

### EXT. WALL SHEATHING SPECIFICATION

• 7/16" OSB OR 15/32" PLYWOOD: FASTEN SHEATHING w/ 2-3/8"x 0.113 NAILS @ 6" O.C. AT EDGES & @ 12" O.C. IN THE PANEL FIELD. (TYP, U.N.O.)

ALL SHEATHING PANELS SHALL BE ORIENTED AND INSTALLED FULL HEIGHT OF SHEAR WALL OR 2x HORIZONTAL BLOCKING SHALL BE PROVIDED TO SUPPORT ALL UNSUPPORTED PANEL EDGES & EDGE

FASTENING. ALL EXT. WALLS SHALL BE CONTINUOUSLY SHEATHED AND ARE CONSIDERED SHEAR WALLS. • ALT. STAPLE CONNECTION SPEC: 1 3/4" 16 GA STAPLES


(7/6" CROWN) @ 3" O.C. AT EDGES & @ 6" O.C IN FIELD. <u>3" O.C. EDGE NAILING</u>

• AT DESIGNATED AREAS - FASTEN PANEL EDGES OF WOOD STRUCTURAL WALL SHEATHING TO FRAMING W/ 2-3/8"x 0.113 NAILS @ 3" O.C. NO STAPLE ALTERNATIVE AVAILABLE AT THIS SPEC . ALL SHEATHING PANELS SHALL BE ORIENTED AND INSTALLED FULL HEIGHT OF SHEAR WALL OR 2x HORIZONTAL BLOCKING SHALL BE PROVIDED TO SUPPORT UNSUPPORTED PANEL EDGES AND 3" O.C. EDGE FASTENING.

### NOTES

• SEE CONNECTION SPECIFICATIONS CHART FOR STANDARD SHEAR TRANSFER DETAILING. IF ADDITIONAL CAPACITY IS REQUIRED BY DESIGN, IT WILL BE SPECIFICALLY NOTED ON PLAN. • DESIGN ASSUMES 16" O.C MAX. STUD SPACING, U.N.O. • ALL STRUCTURAL PANELS ARE TO BE DIRECTLY APPLIED TO STUD FRAMING. • PRE-MANUFACTURED PANELIZED WALLS: FASTEN TOGETHER END STUDS OF WALL PANELS SHEATHED w/ OSB OR PLYWOOD w/ 10d NAILS @ 4" O.C. (THRU ONE SIDE ONLY) INDICATES EXTENT OF INT. OSB SHEARWALL. AND/OR 3" O.C. EDGE NAILING ► INDICATES HOLDOWN ★ INDICATES POST ABOVE (P.A.) PROVIDE SOLID BLOCKING UNDER POST OR JAMB

ABOVE.

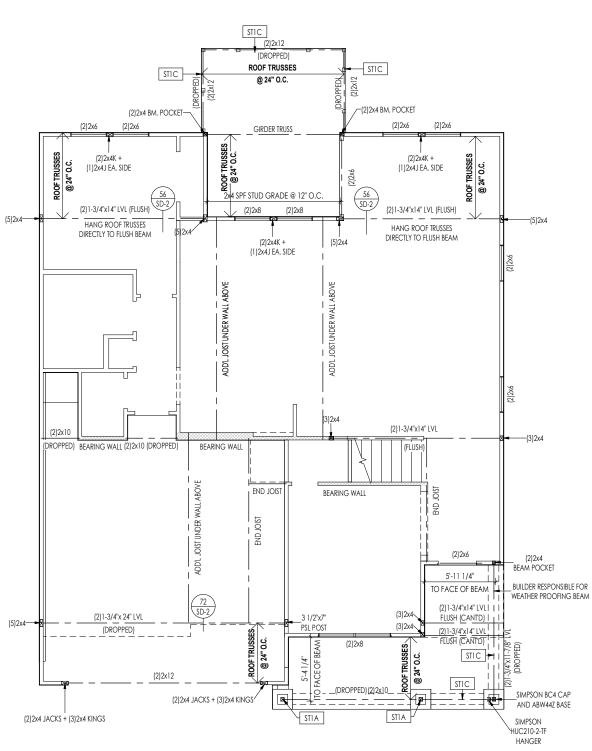

General Notes:

. REFER TO SHEET ON.1 FOR GENERAL NOTES.


Key Notes:

STIA 4x4 P.T. WOOD POST WITH SIMPSON ABW44Z POST BASE AND SIMPSON BCS2-2/4 CAP TIC FRAME TOP OF BEAM AT 9'-1" ABOVE FIRST FLOOR SUBFLOOR/SLAB

### CONNECTION SPECIFICATIONS (TYP. U.N.O.)

NOTE: 10d NAIL = 3" x 0.131" GUN NAIL				
JOIST TO SOLE PLATE	(3)10d TOENAILS			
SOLE PLATE TO JOIST/BLK'G.	10d NAILS @ 6" o.c.			
STUD TO SOLE PLATE	(3)10d TOENAILS			
TOP OR SOLE PLATE TO STUD	(3)10d NAILS			
RIM TO TOP PLATE	10d TOENAILS @ 6" o.c.			
BLK'G. BTWN. JOISTS TO TOP PL.	(3)10d TOENAILS			
RAFTER/TRUSS TO TOP PLATE	(3)10d TOENAILS + (1) SIMPSON H2.5A			
GAB. END TRUSS TO DBL. TOP PL.	10d TOENAILS @ 8" o.c.			
R.T. w/ HEEL HT. 9 ½" TO 12"	2x10 BLK EVERY 3RD BAY FASTENED TO DBL. TOP PLATE w/ 10d TOENAILS @ 6" O.C.			
R.T. w/ HEEL HT. 12" TO 16"	2x12 BLK EVERY 3RD BAY FASTENED TO DBL. TOP PLATE w/ 10d TOENAILS @ 6" O.C.			
R.T. w/ HEEL HT. UP TO 24"	LAP WALL SHTG. w/ DBL. TOP PL. & INSTALL ON TRUSS VERT FASTEN w/ 8d NAILS @ 6" O.C.			
R.T. w/ HEEL HT. 24" TO 48"	LAP WALL SHTG. w/ DBL. TOP PL. & INSTALL ON TRUSS VERT FASTEN w/ 8d NAILS @ 6" O.C. PROVIDE 2x BLK @ EA. BAY AT TOP OF HEEL			
DOUBLE STUD	10d NAILS @ 24" o.c.			
DOUBLE TOP PLATE	10d NAILS @ 24" o.c.			
DOUBLE TOP PLATE LAP SPLICE	(10)10d NAILS IN LAPPED AREA			
TOP PLATE LAP @ CORNERS & INTERSECTING WALLS	(2)10d NAILS			
WALL TO FOUNDATION	WALL SHTG. LAP w/ SILL PL. & FASTENED PER SHEAR WALL FASTENING SPEC.			

Space for Architect Seal

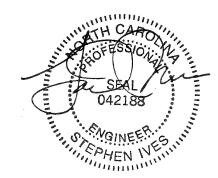


**RESIDENCE FOR:** TOZZI



Job Number Coord Name Coord Phone: Drawina Date STY5-0043-00 6/29/23 GREG PIEPER House Name: Drawing Scale: 1/8" = 1'0" Contract Drawn By

# the **MEADOW II**

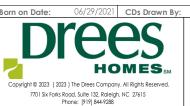


CLASSIC Plan No. PLAN NM First Floor Structural Plan Elevation "D"


Series


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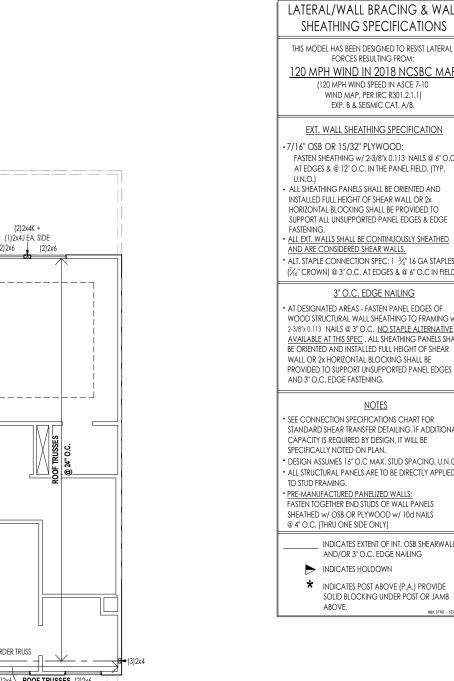
DWW

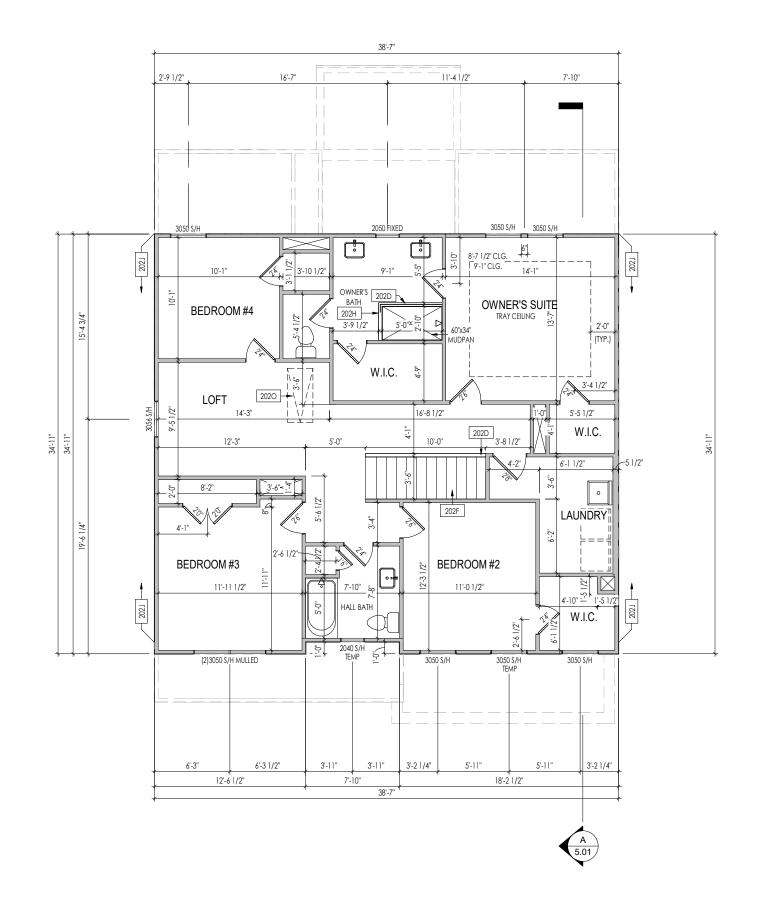


General Notes:




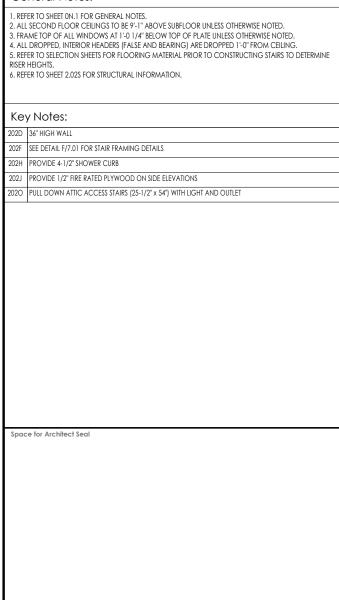

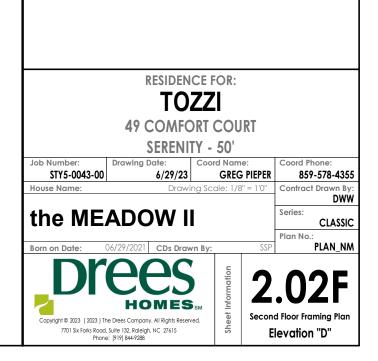

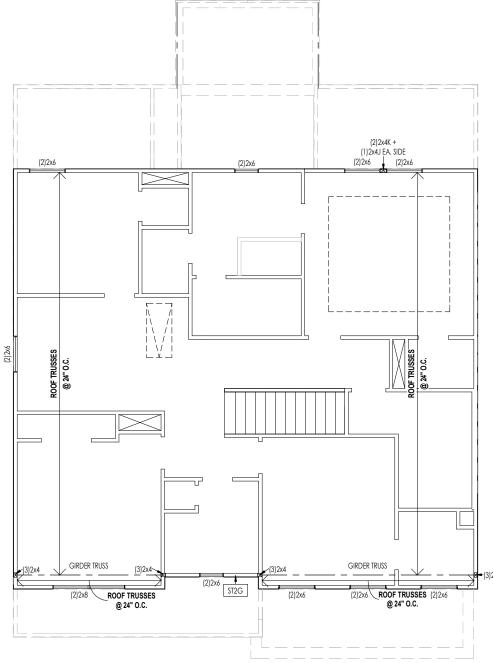

	General Notes:		
ALL S	1. REFER TO SHEET ON.1 FOR GENERAL	L NOTES.	
AL.	Key Notes:		
	ST2G PROVIDE CONT. SHTG, BEHIND L	OW ROOF TRUSSES DOWN TO SECON	D FLOOR SOLE PLATE (TYP.)
<u>AP</u>			
D.C.	CONNECTION SPE		YP. U.N.O.)
,	NOTE	E: 10d NAIL = 3" x 0.131" GUN NA	IL
	JOIST TO SOLE PLATE	(3)10d TOENAILS	
	SOLE PLATE TO JOIST/BLK'G. STUD TO SOLE PLATE	10d NAILS @ 6" o.c. (3)10d TOENAILS	
	TOP OR SOLE PLATE TO STUD	(3)10d NAILS	
	RIM TO TOP PLATE	10d TOENAILS @ 6" o.c.	
	BLK'G. BTWN. JOISTS TO TOP PL.	(3)10d TOENAILS	10.51
5	RAFTER/TRUSS TO TOP PLATE GAB. END TRUSS TO DBL. TOP PL.	(3)10d TOENAILS + (1) SIMPSON 10d TOENAILS @ 8" o.c.	H2.5A
D.	R.T. w/ HEEL HT. 9 1/4" TO 12"	2x10 BLK EVERY 3RD BAY FASTER w/ 10d TOENAILS @ 6" O.C.	NED TO DBL. TOP PLATE
	R.T. w/ HEEL HT. 12" TO 16"	2x12 BLK EVERY 3RD BAY FASTER w/ 10d TOENAILS @ 6" O.C.	NED TO DBL. TOP PLATE
w/ E	R.T. w/ HEEL HT. UP TO 24"	LAP WALL SHTG. w/ DBL. TOP PL FASTEN w/ 8d NAILS @ 6" O.C.	
IALL	R.T. w/ HEEL HT. 24" TO 48"	LAP WALL SHTG. w/ DBL. TOP PL FASTEN w/ 8d NAILS @ 6" O.C. F TOP OF HEEL	
	DOUBLE STUD	10d NAILS @ 24" o.c.	
S	DOUBLE TOP PLATE	10d NAILS @ 24" o.c.	
	DOUBLE TOP PLATE LAP SPLICE	(10)10d NAILS IN LAPPED AREA	
	TOP PLATE LAP @ CORNERS & INTERSECTING WALLS	(2)10d NAILS	
	WALL TO FOUNDATION	WALL SHTG. LAP w/ SILL PL. & F/	ASTENED PER SHEAR WALL
IAL	Space for Architect Seal	FASTENING SPEC.	
ser. 2014	AND	SEAL 042188	and an and an and an an and an
		RESIDENCE FOR: TOZZI COMFORT COUR SERENITY - 50'	
	STY5-0043-00 House Name:	6/29/23 GREG P Drawing Scale: 1/8" =	
	Born on Date: 06/29/202		Plan No.: SSP PLAN_NM
	Dre		2.02S

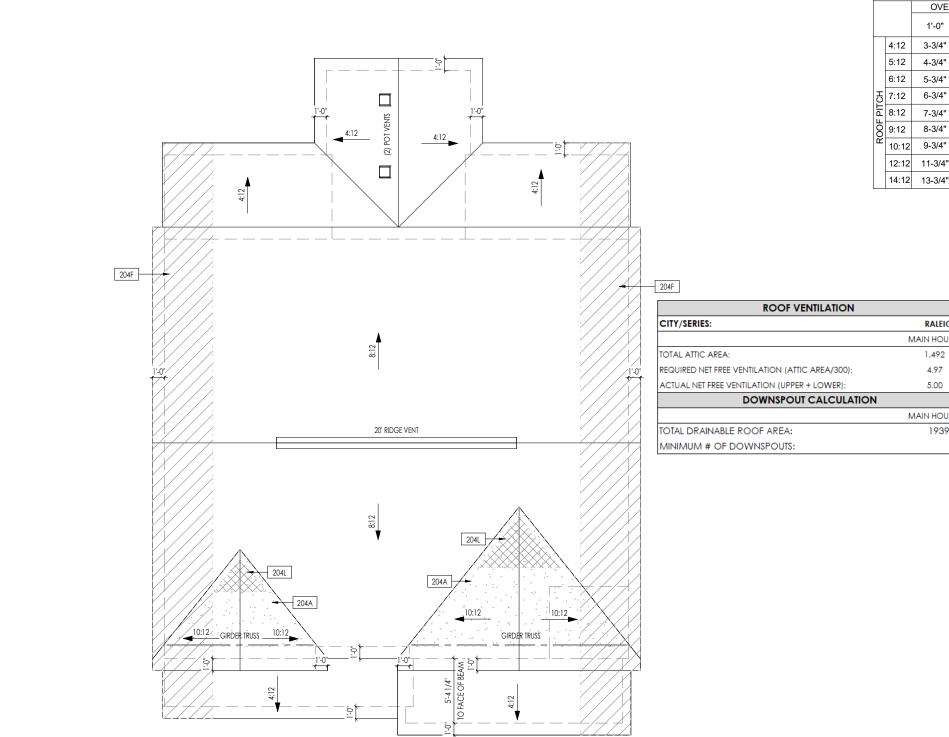

HEEL CUT STANDARDS				
OVERHANG				
1'-0"	2'-0"			
3-3/4"	7-3/4"			
4-3/4"	9-3/4"			
5-3/4"	11-3/4"			
6-3/4"	13-3/4"			
7-3/4"	N/A			
8-3/4"	N/A			
9-3/4"	N/A			
11-3/4"	N/A			
13-3/4"	N/A			
	OVERI 1'-0" 3-3/4" 4-3/4" 5-3/4" 6-3/4" 6-3/4" 8-3/4" 9-3/4" 11-3/4"			

. REFER TO SHEET ON.1 FOR GENERAL NOTES.

Key Notes:


 
 204A
 VALLEY TRUSS OVER FRAMING @ 24" O.C.


 204F
 4-0"(MIN.) OF FIRE RETARDENT TREATED ROOF SHEATHING. NO PENETRATION ALLOWED WITHEN 4' OF EXTERIOR WALL - SEE DETAIL H/7.01 FOR FIRE BLOCKING AT SOFFIT


204L NO ROOF DECKING UNDER OVERFRAMING IN THIS AREA TO ALLOW FOR PROPER ATTIC VENTILATION


CONNECTION SPE	CIFICATIONS (TYP. U.N.O.)
NOTE	: 10d NAIL = 3" x 0.131" GUN NAIL
JOIST TO SOLE PLATE	(3)10d TOENAILS
SOLE PLATE TO JOIST/BLK'G.	10d NAILS @ 6" o.c.
STUD TO SOLE PLATE	(3)10d TOENAILS
TOP OR SOLE PLATE TO STUD	(3)10d NAILS
RIM TO TOP PLATE	10d TOENAILS @ 6" o.c.
BLK'G. BTWN. JOISTS TO TOP PL.	(3)10d TOENAILS
RAFTER/TRUSS TO TOP PLATE	(3)10d TOENAILS + (1) SIMPSON H2.5A
GAB. END TRUSS TO DBL. TOP PL.	10d TOENAILS @ 8" o.c.
R.T. w/ HEEL HT. 9 ¼" TO 12"	2x10 BLK EVERY 3RD BAY FASTENED TO DBL. TOP PLATE w/ 10d TOENAILS @ 6" O.C.
R.T. w/ HEEL HT. 12" TO 16"	2x12 BLK EVERY 3RD BAY FASTENED TO DBL. TOP PLATE w/ 10d TOENAILS @ 6" O.C.
R.T. w/ HEEL HT. UP TO 24"	LAP WALL SHTG. w/ DBL. TOP PL. & INSTALL ON TRUSS VERT FASTEN w/ 8d NAILS @ 6" O.C.
R.T. w/ HEEL HT. 24" TO 48"	LAP WALL SHTG. W/ DBL. TOP PL. & INSTALL ON TRUSS VERT FASTEN W/ 8d NAILS @ 6" O.C. PROVIDE 2x BLK @ EA. BAY AT TOP OF HEEL
DOUBLE STUD	10d NAILS @ 24" o.c.
DOUBLE TOP PLATE	10d NAILS @ 24" o.c.
DOUBLE TOP PLATE LAP SPLICE	(10)10d NAILS IN LAPPED AREA
TOP PLATE LAP @ CORNERS & INTERSECTING WALLS	(2)10d NAILS
WALL TO FOUNDATION	WALL SHTG. LAP w/ SILL PL. & FASTENED PER SHEAR WALL FASTENING SPEC.
Space for Architect Seal	


LOWER
410
1.37
2.96
LOWER
533
1

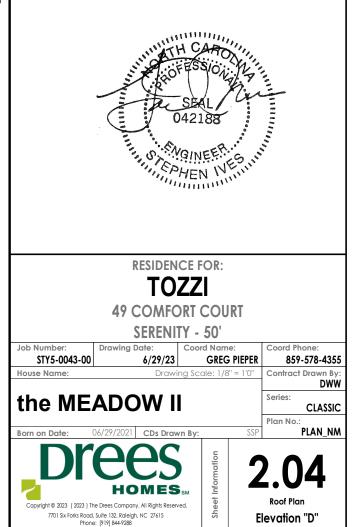


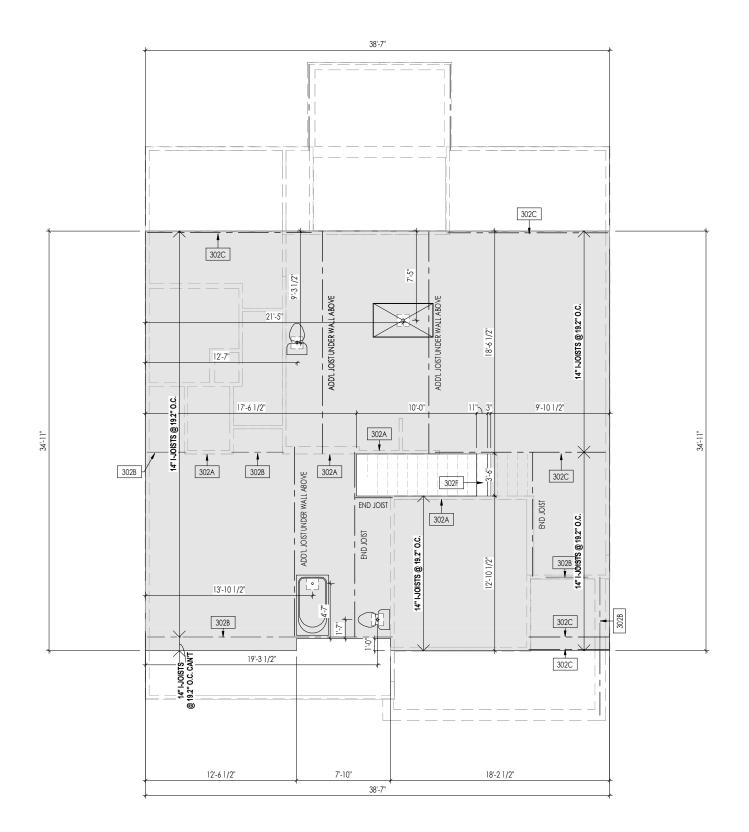


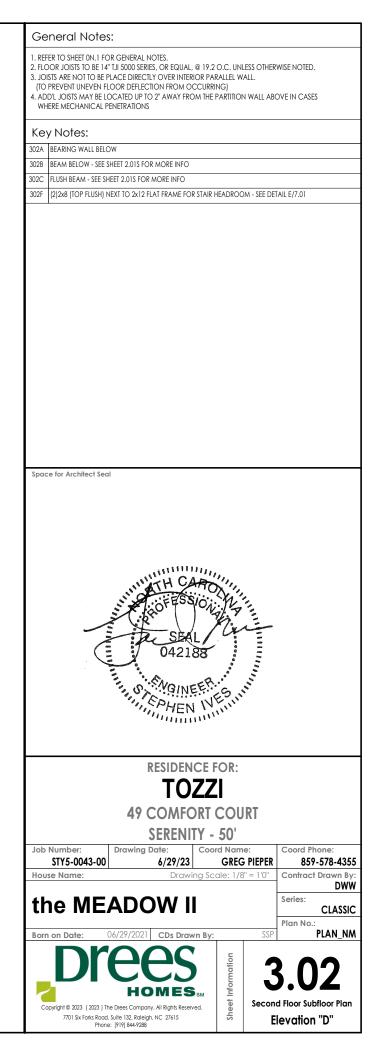

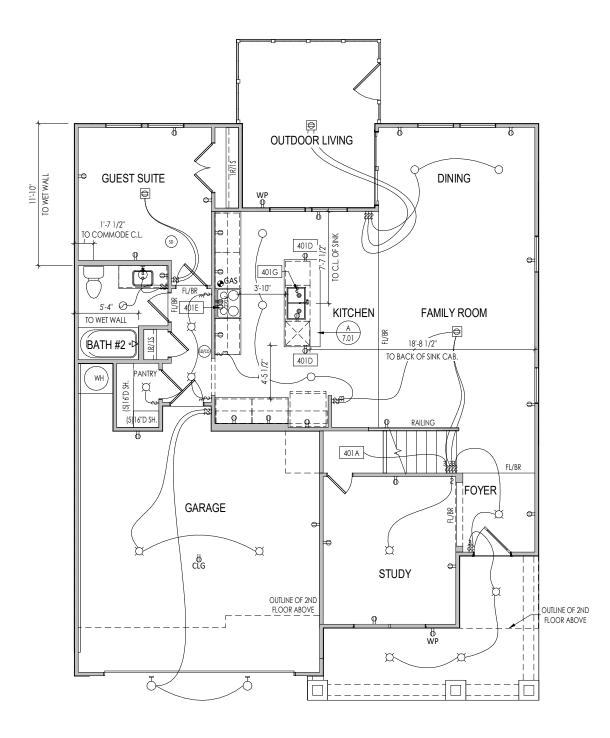

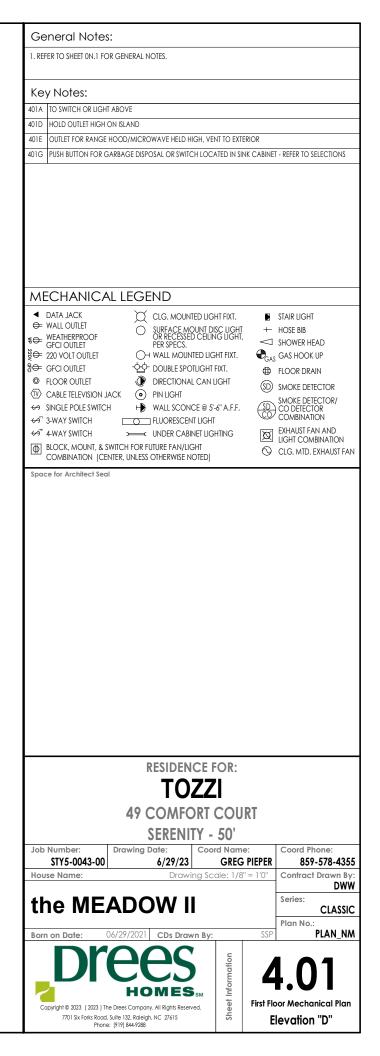

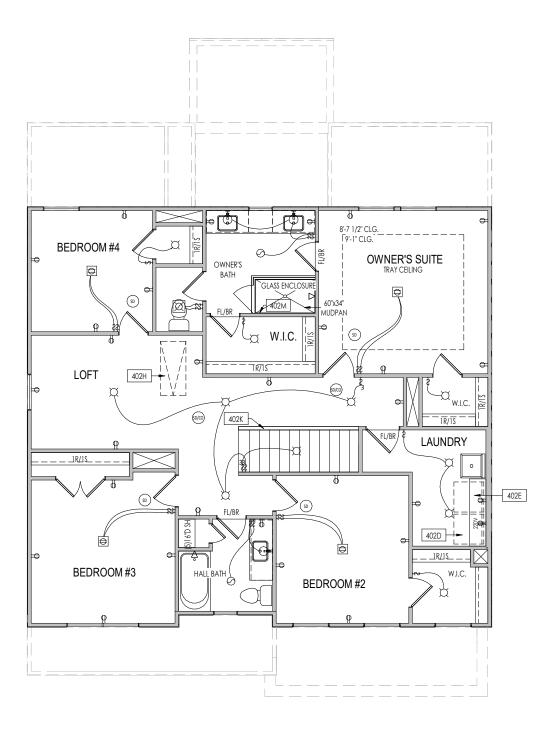

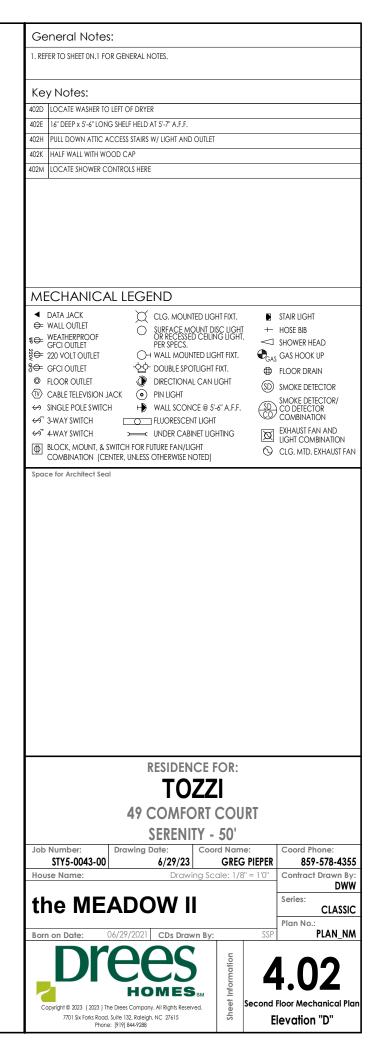



A	BUILDING SECTION THRU STAIRS
5.01	1/8" = 1'-0"

General Notes:	
1. REFER TO SHEET 0N.1 FOR GENERAL NOTES.	
Key Notes:	
Space for Architect Seal	
RESIDENCE FOR:	
TOZZI	
49 COMFORT COURT	
SERENITY - 50'	
Job Number:         Drawing Date:         Coord Name:           STY5-0043-00         6/29/23         GREG PIEPER	Coord Phone: 859-578-4355
House Name: Drawing Scale: 1/8" = 1'0"	Contract Drawn By:
the MEADOW II	Series:
	CLASSIC Plan No.:
Born on Date: 06/29/2021 CDs Drawn By: SSP	PLAN_NM
Copyright @ 2023 ( 2023 ) The Drees Company. All Rights Reserved. 700 Jix Forks Road, Suite 132, Roleigh, NC 2761 5	5.01
HOMES SM E Copyright © 2023 (2023) The Drees Company. All Rights Reserved.	uilding Section
7701 Six Forks Rood, Suife 132, Roleigh, NC 27615 Phone: [919] 844-9288	levation "D"



## **ELEVATION "D"**

### General Notes:

. REFER TO SHEET 0N.1 FOR GENERAL NOTES. 2. ROOFING MATERIAL PER SELECTIONS. 3. CONTACT M&K ENGINEERING FOR HEADER SIZE/BRICK SUPPORT IF GRADE DROPS AND THE AMOUNT OF BRICK OVER GARAGE DOOR SHOWN ON CURRENT ELEVATION IS NO LONGER ACCURATE

Key Notes:

## BRICK VENEER LINTEL SCHEDULE


SPAN	STEEL ANGLE SIZE	HEIGHT OF VENEER ABOVE LINTEL
Up to 3'-6"	L3-1/2 x3-1/2 x1/4	20 FT. MAX
Up to 6'-0"	L5x 3- 1/2x 5/16 (LLV)	20 FT. MAX
Up to 8'-0"	L6x 3- 1/2x 3/8 (LLV)	20 FT. MAX
9'-0''	L7x 4x 3/8 (LLV)	12 FT. MAX
*16'-0"	L7x 4x 3/8 (LLV)	3 FT. MAX
*16'-0"	L8x 4x 1/2 (LLV)	4-1/2 FT. MAX


ALL LINTELS <=6' SHALL HAVE 4" MINIMUM BEARING AT EACH END. ALL LINTELS >=6' SHALL HAVE 8" MINIMUM BEARING AT EACH END.

\* FASTENED TO HDR @ 1/3 SPAN POINTS THRU 1-1/2 "LONG VERTICALLY SLOTTED HOLES IN LINTEL w/ 1/2" DIA. x 3-1/2 " LONG LAG SCREWS. LOCATE LAG SCREWS @ MIDDLE OF SLOTTED HOLE & TIGHTEN SCREWS ENOUGH TO ALLOW MOVEMENT OF LINTEL.

\*\*ANY LINTEL CONDITION NOT SPECIFIED ABOVE SHALL BE DESIGNED

Space for Architect Seal

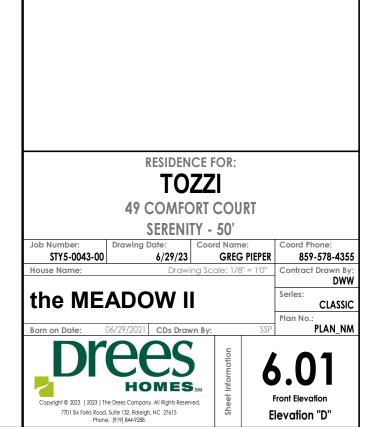


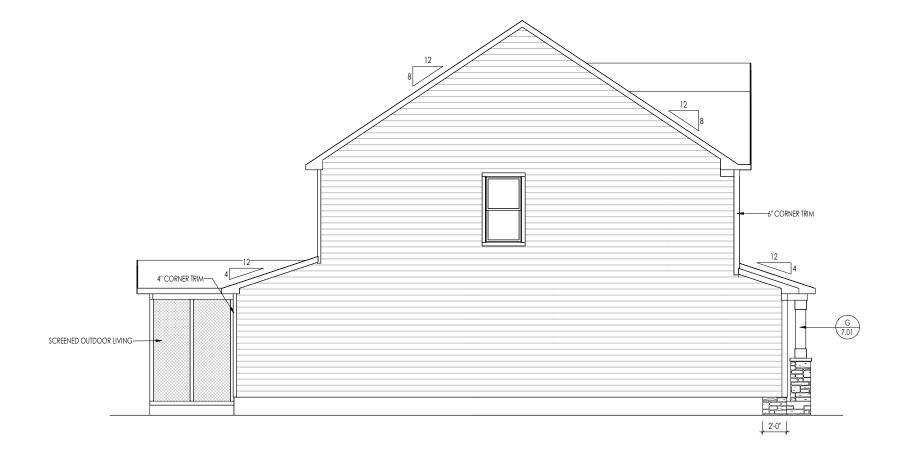


	General Notes:			
TRIM:	1. REFER TO SHEET ON.1 FOR C	GENERAL NOTES.		
	2. ROOFING MATERIAL PER SE 3. REFER TO LINTEL SCHEDULE		01.	
ZE HERWISE NOTED)	Key Notes:			
nerwise NOTED)				
	Space for Architect Seal			
		RESIDEN		
		TO		
		49 COMFC		
	Job Number: D	SERENI rawing Date:	<b>TY - 50'</b> Coord Name:	Coord Phone:
	STY5-0043-00	6/29/23	GREG PIEPER	859-578-4355
	House Name:		ng Scale: 1/8" = 1'0"	Contract Drawn By: DWW
	the MEA		l	Series: CLASSIC
		29/2021 CDs Draw		Plan No.: PLAN_NM
			matio	5.02
		HOMES	SM 드 Corr	
		e 132, Raleigh, NC 27615	red. 0 Gard	age Side Elevation
	Phone: 9	19] 844-9288		




General Notes:			
1. REFER TO SHEET ON.1 FOR G 2. ROOFING MATERIAL PER SEL			
3. REFER TO LINTEL SCHEDULE		1.	
Key Notes:			
Space for Architect Seal			
space for Architect sear			
	RESIDENC	CE FOR:	
	TO	ZZI	
	<b>TO2</b> 49 COMFO	<b>ZZI</b> RT COURT	
	TO2 49 COMFO SERENIT rawing Date:	<b>ZZI</b> RT COURT Y - 50' <sup>Coord Name:</sup>	Coord Phone: 859,578,435
Job Number: Dr STY5-0043-00 House Name:	49 COMFO SERENIT rawing Date: 6/29/23	<b>ZZI</b> RT COURT Y - 50'	859-578-435 Contract Drawn By
STY5-0043-00 House Name:	49 COMFO SERENIT rawing Date: 6/29/23 Drawin	ZZI RT COURT Y - 50' Coord Name: GREG PIEPER g Scale: 1/8" = 1'0"	859-578-435 Contract Drawn By DWV Series:
STY5-0043-00	49 COMFO SERENIT rawing Date: 6/29/23 Drawin	ZZI RT COURT Y - 50' Coord Name: GREG PIEPER g Scale: 1/8" = 1'0"	859-578-435 Contract Drawn By DWV Series: CLASSIC Plan No.:
STY5-0043-00 House Name:	49 COMFO SERENIT rawing Date: 6/29/23 Drawin	ZZI RT COURT Y - 50' Coord Name: <u>GREG PIEPER</u> g Scale: 1/8" = 1'0"	859-578-435 Contract Drawn By DWV Series: CLASSIC Plan No.:
STY5-0043-00 House Name: the MEA	49 COMFO SERENIT caving Date: 6/29/23 Drawin	ZZI RT COURT Y - 50' Coord Name: GREG PIEPER g Scale: 1/8" = 1'0"	859-578-435 Contract Drawn By DWV Series: CLASSIC Plan No.: PLAN_NA
STY5-0043-00 House Name: the MEA	49 COMFO SERENIT caving Date: 6/29/23 Drawin	ZZI RT COURT Y - 50' Coord Name: GREG PIEPER g Scale: 1/8" = 1'0"	859-578-435 Contract Drawn By DWV Series: CLASSIC Plan No.:
STY5-0043-00 House Name: the MEA	49 COMFO SERENIT awing Date: 6/29/23 Drawin DOW II 29/2021 CDs Drawin CDS Drawin CDS Drawin CDS Drawin CDS Drawin	ZZI RT COURT Y - 50' Coord Name: <u>GREG PIEPER</u> g Scale: 1/8" = 1'0" n By: SSF sm <u>i</u>	859-578-435 Contract Drawn By DWV Series: CLASSIC Plan No.: PLAN_NA

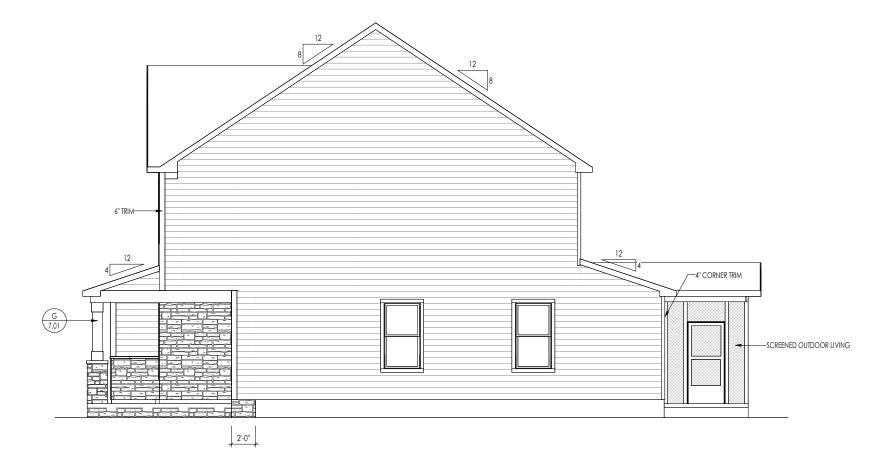

General Notes:			
1. REFER TO SHEET ON.1 FOR C 2. ROOFING MATERIAL PER SE			
3. REFER TO LINTEL SCHEDULE		)1.	
Key Notes:			
Space for Architect Seal			
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	<b>TO</b> 49 COMFO	ZZI PRT COURT	
Job Number: D	TO	ZZI PRT COURT	Coord Phone:
STY5-0043-00	TO2 49 COMFO SERENII Drawing Date: 6/29/23	ZZI PRT COURT Y - 50' Coord Name: GREG PIEPER	859-578-435
STY5-0043-00 House Name:	TO2 49 COMFO SERENII Drawing Date: 6/29/23 Drawin	ZZI PRT COURT Y - 50' Coord Name: GREG PIEPER ng Scale: 1/8" = 1'0"	859-578-435 Contract Drawn By DWV
STY5-0043-00	TO2 49 COMFO SERENII Drawing Date: 6/29/23 Drawin	ZZI PRT COURT Y - 50' Coord Name: GREG PIEPER ng Scale: 1/8" = 1'0"	859-578-435 Contract Drawn By DWV Series: CLASSIC
STY5-0043-00 House Name:	TO2 49 COMFO SERENII Drawing Date: 6/29/23 Drawin	ZZI PRT COURT TY - 50' Coord Name: <u>GREG PIEPER</u> ng Scale: 1/8" = 1'0"	859-578-435 Contract Drawn By DWV Series: CLASSIC Plan No.:
sty5-0043-00 House Name:	TO: 49 COMFO SERENII brawing Date: 6/29/23 Drawin Drawin	ZZI PRT COURT Y - 50' Coord Name: GREG PIEPER ng Scale: 1/8" = 1'0"	859-578-435 Contract Drawn By DWV Series: CLASSIC Plan No.: PLAN_NA
sty5-0043-00 House Name:	TO: 49 COMFO SERENII Drawing Date: 6/29/203 Drawin Drawin Drawin Drawin Drawin Drawin Drawin Drawin Drawin Drawin Drawin Drawin Drawin Drawin	ZZI PRT COURT Y - 50' Coord Name: GREG PIEPER ng Scale: 1/8" = 1'0"	859-578-435 Contract Drawn By DWV Series: CLASSIC Plan No.: PLAN_NA
STY5-0043-00 House Name:	TO 49 COMFO SERENII rawing Date: 6/29/23 Drawin Drawin (29/2021 CDs Draw COS Draw	ZZI PRT COURT Y - 50' Coord Name: <u>GREG PIEPER</u> ng Scale: 1/8" = 1'0" n By: SSP	859-578-435 Contract Drawn By DWV Series: CLASSIC Plan No.:

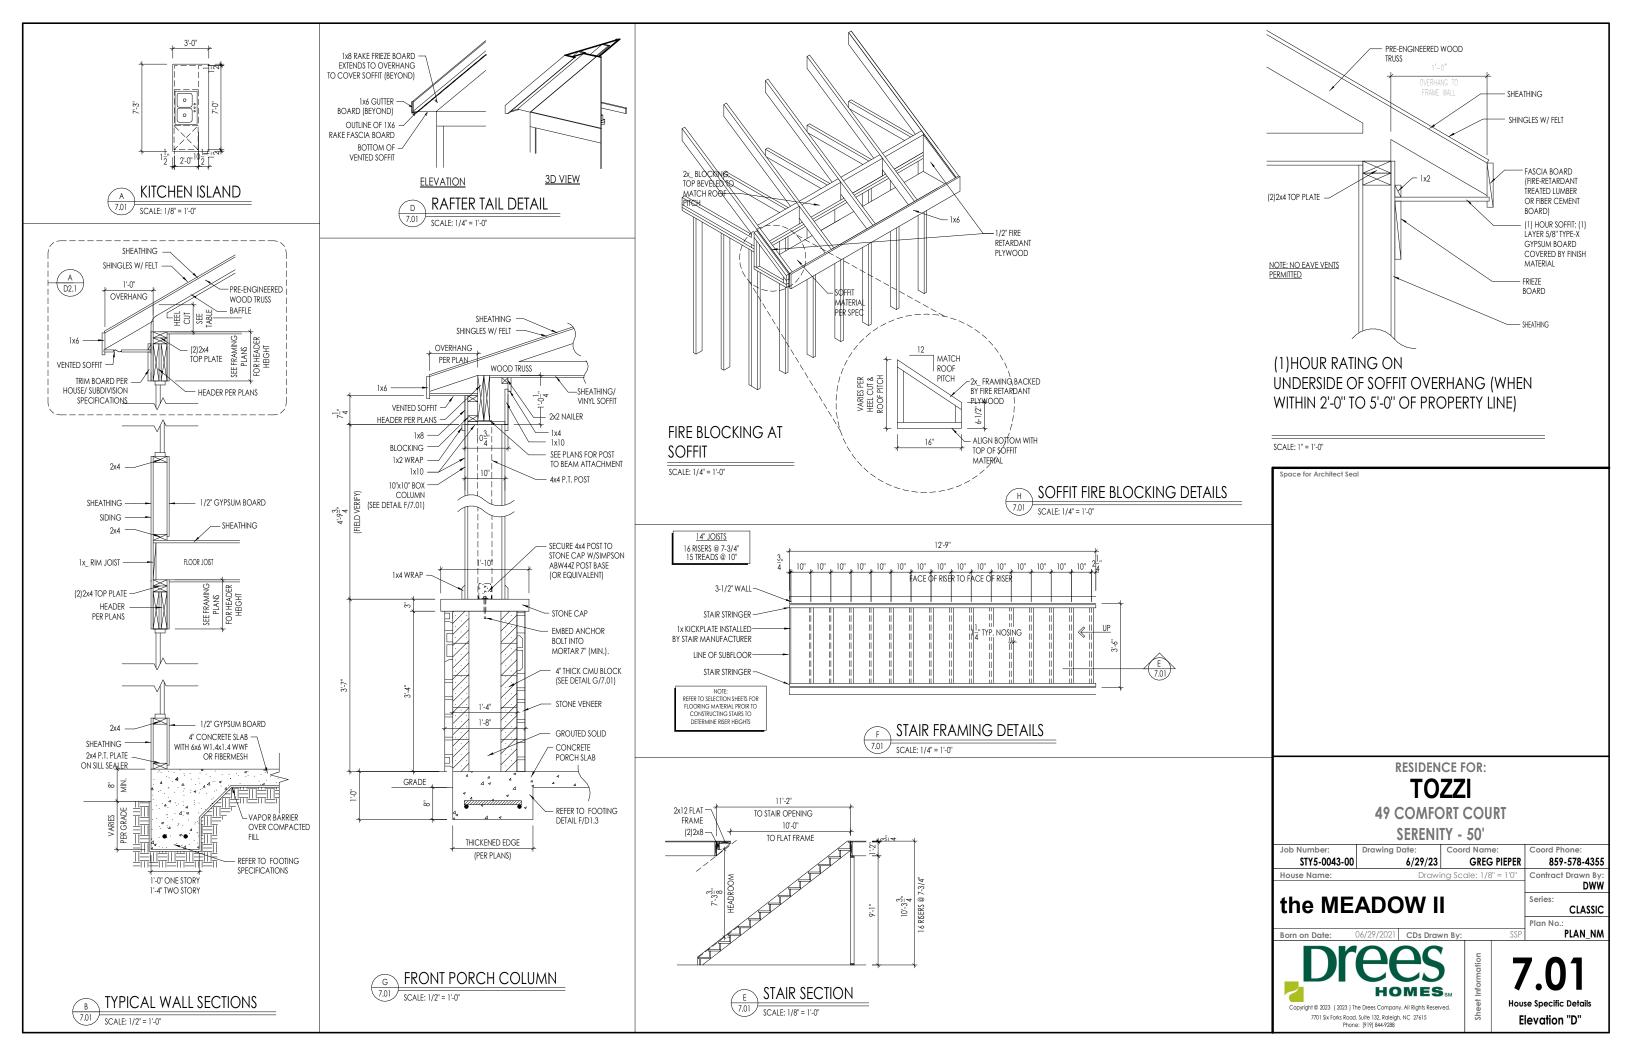

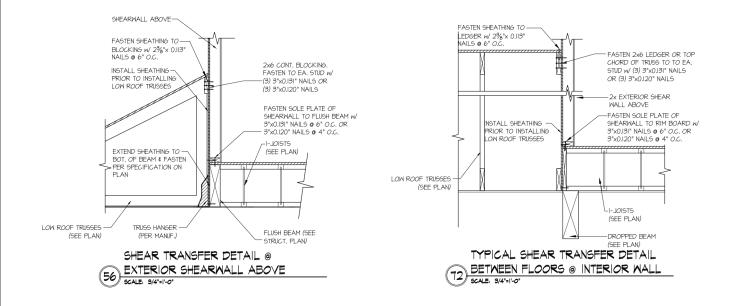

ATERAL DETAILS		REVISIONS: date:	project mgr: drawn by: issue date:		seal:
EADOW MODEL	MULHERN+KULP RESIDENTIAL STRUCTURAL ENGINEERING SEDEDALIA FURMAN, SAID (15 - AL) AURT. CA. 3022		lp project numbe	DREES HOMES	MULHEIN & KULP Structural Engineerin
	p 778-771-4074 = mulhamilup com	initial:	BSM CNV 8-12-22		ER. Constant

# RALEIGH WINDOW SCHEDULE

Drees General	Window Type	MI Windows Capitol				Drees General				
Callout	Window Type	Call No.	Rough Opening	Call No.	Rough Opening	Callout	Call No.	Rough Opening	Call No.	Rough Opening
660	SINGLE/DOUBLE HUNG	CW3500 1/8 x 6/0	20" x 60-1/4"							
670 860	SINGLE/DOUBLE HUNG SINGLE/DOUBLE HUNG	CW3500 1/8 x 7/0 CW3500 1/8 x 6/0	20" x 84"							
2030	SINGLE/DOUBLE HUNG	CW3500 2/0 x 3/0	24" x 36"							
040	SINGLE/DOUBLE HUNG	CW3500 2/0 x 4/0	24" x 48"							
050		CW3500 2/0 x 5/0 CW3500 2/0 x 6/0	24" x 60-1/4"							
060 070	SINGLE/DOUBLE HUNG SINGLE/DOUBLE HUNG	CW3500 2/0 x 6/0 CW3500 2/0 x 7/0	24 x 72 24" x 84"							
2430	SINGLE/DOUBLE HUNG	CW3500 2/4 x 3/0	28" x 36"							
2440	SINGLE/DOUBLE HUNG	CW3500 2/4 x 4/0	28" x 48"							
2450 2460	SINGLE/DOUBLE HUNG SINGLE/DOUBLE HUNG	CW3500 2/4 x 5/0 CW3500 2/4 x 6/0	28" x 60-1/4"							
2830	SINGLE/DOUBLE HUNG	CW3500 2/8 x 3/0	32" x 36"							
840	SINGLE/DOUBLE HUNG	CW3500 2/8 x 4/0	32" x 48"							
850 860	SINGLE/DOUBLE HUNG SINGLE/DOUBLE HUNG	CW3500 2/8 x 5/0 CW3500 2/8 x 6/0	<u>32" x 60-1/4"</u>							
030	SINGLE/DOUBLE HUNG	CW3500 2/8 x 8/0	<u>36-1/4" x 36"</u>							
3040	SINGLE/DOUBLE HUNG	CW3500 3/0 x 4/0	36-1/4" x 48"							
8050	SINGLE/DOUBLE HUNG	CW3500 3/0 × 5/0	36-1/4" x 60-1/4" 36-1/4" x 72"		L					
3060 3070	SINGLE/DOUBLE HUNG SINGLE/DOUBLE HUNG	CW3500 3/0 x 6/0	<u>36-1/4" x /2"</u>		·					
470	SINGLE/DOUBLE HUNG	CW3500 3/0 x 7/0	40" x 84"		<u>                                      </u>					
050 FIXED		910T 5/0 x 1/0	59-5/8" x 11-1/2"							
640 FIXED 020 FIXED		910T 4/0 x 1/8 CW3500 2/0 x 2/0	47-1/4" x 19-1/2"		<u>↓</u> ↓					
020 FIXED 030 FIXED		CW3500 2/0 x 2/0 CW3500SL 2/0 x 3/	<u>24 x 24</u> (0 24" x 36"		<u>+</u> ] ]-					
040 FIXED		CW3500SL 2/0 x 4/	′0 24" x 48"							
050 FIXED		CW3500SL 2/0 x 5/	<u>′0 24" x 60-1/4"</u>							
816 FIXED 860 FIXED		910TSL 2/6 x 1/8 CW3500 3/0 x 6/0	29-1/4" x 19-1/2" 36" x 72"							
016 FIXED		910TSL 3/0 x 1/8	35-1/4" x 19-1/2"							
020 FIXED		910TSL 3/0 x 2/0	35-1/4" x 19-1/2" 35-1/4" x 23-1/2"							
030 FIXED 040 FIXED		CW3500P 3/0 x 3/0 CW3500P 3/0 x 4/0	) 36-1/4" x 36"		<u> </u>					
050 FIXED		CW3500P 3/0 x 4/0	) 36-1/4" x 60-1/4"							
3060 FIXED		CW3500P 3/0 x 6/0	)   36-1/4" x 72"							
3070 FIXED		CW3500P 3/0 x 7/0	) <u>36-1/4" x 84"</u>							
4010 FIXED 4020 FIXED		910T 4/0 x 1/0 910T 4/0 x 2/0	47-1/4" x 11-1/2" 47-1/4" x 23-1/2"							
030 FIXED		CW3500P 4/0 x 3/0	) 48" x 36"							
1040 FIXED		CW3500P 4/0 x 4/0	) 48" x 48"							
4044 FIXED 4050 FIXED		CW3500P 4/0 x 4/4 CW3500P 4/0 x 5/0	1 48" x 52"							
4060 FIXED		CW3500P 4/0 x 5/0	) $48 \times 60^{-1/4}$							
4070 FIXED		CW3500P 4/0 x 7/0	) 48" x 84"							
030 FIXED		CW3500P 5/0 x 3/0	) 60" x 36"		L					
5040 FIXED 5060 FIXED		CW3500P 5/0 x 4/0 CW3500P 5/0 x 6/0	$0 60^{\circ} \times 48^{\circ}$							
5070 FIXED		CW3500P 5/0 x 7/0	) 60" x 84"							
020 FIXED		910T 6/0 x 2/0	71-5/8" x 23-1/2"							
050 FIXED 060 FIXED		CW3500P 6/0 x 5/0 CW3500P 6/0 x 6/0	) 72" x 60-1/4"							
-0" HALF ROUNE	)	CW3500P 6/0 X 6/0	36-1/4"		<u>                                      </u>					
	)	CW3500 3/0 HC	48"							
-0" HALF ROUNE	)	CW3500 3/0 HC	60" 24"		<u> </u>					
020 OCTAGON '-4" QUARTER RC	DUND	CW3500 2/0 OCT CW3500 2/4 QC	28"		<u>+                                    </u>					
-0" QUARTER RC	DUND	CW3500 2/4 QC	36-1/4"							
			+		<u>                                     </u>					
					<u>                                     </u>					
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			+		<u>+                                    </u>					
	<b>AA</b>	Drees Ho	nes l	Sheet Description:						Sheet N
Dre		7701 Six Forks Road, Suite 132, Raleigh, NC 27		WINDOW SC	CHEDULE					
$\boldsymbol{\nu}$ I $\boldsymbol{\vee}$	Copyright © 2	008, (2013) The Drees Company. All Rights Res any form or by any means, including photocopy	erved. No portion of this material may	be						SC-(
	IOMES <sub>SM</sub> of the Drees Co	any torm or by any means, incluaing photocopy ompany. The Drees Company will vigorously pros	my, mutout the express written permis	erial						

### \* MEETS EMERGENCY ESCAPE & RESCUE OPENING REQUIREMENTS

# MOULDED MILLWORK SCHEDULE

ARCHED HEADER D1 H8xxEF ARCHED HEADER D1K H8xxEF ARCHED HEADER D2 H8xxEF ARCHED HEADER D2 H8xxEF ARCHED HEADER D3 AH10x ARCHED HEADER D3 AH10x ARCHED HEADER D4 AR5xx ARCHED HEADER D4 AR5xx ARCHED HEADER D4 AR5xx ARCHED HEADER D5 AR10x ARCHED HEADER D5 AR10x ARCHED HEADER D6 AR10x ARCHED HEADER D6 AR10x ARCHED HEADER D7K H7xEF ARCHED HEADER D8 AR14x ARCHED HEADER D8 AR14x ARCHED HEADER D8 AR14x CROSSHEAD A1 H9xx CROSSHEAD A1 H9xx CROSSHEAD B1 H14xXB CROSSHEAD B1K H14xXB CROSSHEAD B1K H14xXB CROSSHEAD B2 H12xx CROSSHEAD B2 H12xx CROSSHEAD C1 H18xXB CROSSHEAD C2 H18xXB CROSSHEAD C2 H18xXB CROSSHEAD C2 H18xXB CROSSHEAD Z-E3-HDR Z-E3-HI CROSSHEAD Z-E3-HDR Z-W3 WINDOW HEADER C1 H9xxK WINDOW HEADER C3 H9xxK WINDOW HEADER C3 H9xxK WINDOW HEADER C4 H14xxB WINDOW HEADER C4 H14xxB WINDOW HEADER Z-W3 C-W3 WINDOW HEADER Z-W3 C-W3 WINDOW HEADER Z-W3 C-W3 WINDOW HEADER Z-W3 C-W3 WINDOW	KR N/A TR N/A TR N/A TKR N/A TKR N/A K WCHSEGxxX10 ARxxX6M ARxxX6M C ARxxX6MK C ARxxX6MK C ARxX6MK C ARxXX6METAR6C ARXX10MC C C ARXX10MC C C ARXX10MC C C ARXX10MC C ARXX10MC C C ARXX10MC C ARXX10MC C ARXX10MC C C ARXX10MC C ARXX10MC C ARXX10MC C ARXX10MC C ARXX10MC C C ARXX10MC C ARXX10MC C C ARXX10MC C C ARXX10MC C C ARXX10MC C C ARXX10MC C C ARXX10MC C C ARXX10MC C C ARXX10MC C C ARXX10MC C C ARXX10MC C C ARXX10MC C C ARXX10MC C C ARXX10MC C C ARXX10MC C ARXX10MC C C ARXX10MC ARXX10MC C ARXX10
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ARCHED HEADER D8AR14xxARCHED HEADER D8KAR14xxARCHED HEADER D9H9xxECROSSHEAD A1H9xxCROSSHEAD A1KH9xxKCROSSHEAD B1H14xxBCROSSHEAD B1H14xxBCROSSHEAD B1KH14xxBCROSSHEAD B2H12xxCROSSHEAD B2H12xxKCROSSHEAD C1H18xxBCROSSHEAD C2KH18xxBCROSSHEAD C2CH18xxBCROSSHEAD Z-E1-HDRZ-E2-HICROSSHEAD Z-E3-HDRZ-E3-CICROSSHEAD Z-E3-CLHDRZ-E3-CICROSSHEAD Z-E3-CLHDRZ-E3-CICROSSHEAD Z-E3-CLHDRZ-E3-CICROSSHEAD Z-E3-CLHDRZ-E3-CICROSSHEAD Z-E3-CLHDRZ-E3-CICROSSHEAD Z-E3-HDRZ-E3-CICROSSHEAD Z-E3-CLHDRZ-E3-CICROSSHEAD Z-E3-RDRZ-E3-CICROSSHEAD Z-C2H9xx2IWINDOW HEADER A1H6xxKWINDOW HEADER B1H9xx2IWINDOW HEADER C1H9xxKWINDOW HEADER C2H9xxTKWINDOW HEADER C2H9xxTF-WINDOW HEADER C3WINDOW HEADER C4H14xxBWINDOW HEADER C4H14xxBWINDOW HEADER C4H14xxBWINDOW HEADER C4H14xxB </td <td>ACCARxxX14MCACKARxxX14MCKWCHARSxx13WCHXX9NWCHXX9NWCHXX14BTTKWCHXX14BTTKWCHXX12WCHXX12WCHXX12KTWCHXX12KTWCHXX14BTTKWCHXX12KTWCHXX14BTTKWCHXX14BTTKWCHXX14BTTKWCHXX14BTTKWCHXX18TPALDCHXX18DRZ-E1-HDRDRZ-E3-HDRCRZ-E3-ARCHHDRJHDRZ-E3-ARCHDRDRZ-E5-HDRWCHXX66WCHXX66</td>	ACCARxxX14MCACKARxxX14MCKWCHARSxx13WCHXX9NWCHXX9NWCHXX14BTTKWCHXX14BTTKWCHXX12WCHXX12WCHXX12KTWCHXX12KTWCHXX14BTTKWCHXX12KTWCHXX14BTTKWCHXX14BTTKWCHXX14BTTKWCHXX14BTTKWCHXX18TPALDCHXX18DRZ-E1-HDRDRZ-E3-HDRCRZ-E3-ARCHHDRJHDRZ-E3-ARCHDRDRZ-E5-HDRWCHXX66WCHXX66
ARCHED HEADER D8KAR14xxARCHED HEADER D9H9xxECROSSHEAD A1H9xxECROSSHEAD A1KH9xxKCROSSHEAD B1H14xxBCROSSHEAD B1KH14xxBCROSSHEAD B2H12xxCROSSHEAD B2KH12xxKCROSSHEAD B2CH12xxKCROSSHEAD C1H18xxBCROSSHEAD C2H18xxBCROSSHEAD C2KH18xxBCROSSHEAD C2KH18xxBCROSSHEAD C2KH18xxBCROSSHEAD C2KH18xxBCROSSHEAD C2KH18xxBCROSSHEAD Z-E3-HDRZ-E3-H1CROSSHEAD Z-E3-HDRZ-E3-H1CROSSHEAD Z-E3-HDRZ-E3-A1CROSSHEAD Z-E3-HDRZ-E3-C1CROSSHEAD Z-E3-HDRZ-E3-M1CROSSHEAD Z-E3-HDRZ-E3-M2MINDOW HEADER B1H9xx2WINDOW HEADER C1H9xx5WINDOW HEADER C1H9xx5WINDOW HEADER C2H9xx1KWINDOW HEADER C3H12xxBWINDOW HEADER C3KH12xxBWINDOW HEADER C3KH12xxBWINDOW HEADER C3KH12xxBWINDOW HEADER C3KH12xxBWINDOW HEADER C3KH12xxBWINDOW HEADER C3K <t< td=""><td>KCK ARXX14MCK WCHARSxx13 WCHxX9N WCHxX29N T WCHxX14BT TK WCHxX14BT TK WCHxX14BT WCHxX12 WCHxX12K T WCHxX12K T WCHxX14BT TK WCHxX14BT TK UCHxX14BT TK UCHxX14BT TK UCHxX14BT TK Z-E1-HDR DR Z-E3-HDR DR Z-E3-HDR CR Z-E3-HDR DR Z-E3-ARCHHDR LHDR Z-E3-ARCHHDR DR Z-E5-HDR DR Z-E5-HDR DR Z-E5-HDR</td></t<>	KCK ARXX14MCK WCHARSxx13 WCHxX9N WCHxX29N T WCHxX14BT TK WCHxX14BT TK WCHxX14BT WCHxX12 WCHxX12K T WCHxX12K T WCHxX14BT TK WCHxX14BT TK UCHxX14BT TK UCHxX14BT TK UCHxX14BT TK Z-E1-HDR DR Z-E3-HDR DR Z-E3-HDR CR Z-E3-HDR DR Z-E3-ARCHHDR LHDR Z-E3-ARCHHDR DR Z-E5-HDR DR Z-E5-HDR DR Z-E5-HDR
ARCHED HEADER D9H9xxECROSSHEAD A1H9xxCROSSHEAD A1KH9xxKCROSSHEAD B1H14xxBCROSSHEAD B1KH14xxBCROSSHEAD B2H12xxCROSSHEAD B2H12xxCROSSHEAD B2KH12xxCROSSHEAD B2KH12xxCROSSHEAD C1H18xxBCROSSHEAD C2H18xxBCROSSHEAD C2KH18xxBCROSSHEAD C2EH18xxBCROSSHEAD C2F1-HDRZ-E1-HDRCROSSHEAD Z-E1-HDRZ-E3-HDRCROSSHEAD Z-E3-HDRZ-E3-HDRCROSSHEAD Z-E3-CLHDRZ-E3-HDRCROSSHEAD Z-E3-CLHDRZ-E3-CLCROSSHEAD Z-E3-CLHDRZ-E3-HDRCROSSHEAD Z-E3-CLHDRZ-E3-HDRCROSSHEAD Z-E3-CLHDRZ-E3-HDRCROSSHEAD Z-E3-CLHDRZ-E3-HDRCROSSHEAD Z-E3-HDRZ-E3-HDRCROSSHEAD Z-E3-HDRZ-E3-HDRCROSSHEAD Z-E3-HDRZ-E3-HDRCROSSHEAD Z-E3-HDRZ-E3-HDRCROSSHEAD Z-E3-HDRZ-E3-HDRCROSSHEAD Z-E3-RDRZ-E3-HDRCROSSHEAD Z-E3-RDRZ-E3-HDRCROSSHEAD Z-E3-RDRZ-E3-HDRCROSSHEAD Z-E3-RDRZ-E3-HDRCROSSHEAD Z-E3-RDRZ-E3-HDRCROSSHEAD Z-E3-RDRZ-E3-HDRCROSSHEAD Z-E3-RDRZ-W3TWINDOW HEADER C1H9xxEWINDOW HEADER C2KH9xxEWINDOW HEADER C2KH9xxEWINDOW HEADER C3KH12xxEWINDOW HEADER C3KH12xxEWINDOW HEADER C3KH12xxEWINDOW HEADER C3K	WCHARSxx13WCHxxX9NWCHxxX9NKTWCHxxX14BTTKWCHxx114BTWCHxx114BTWCHxx12WCHxx12KTWCHxx14BTTKWCHxxX14BTTKWCHxxX14BTTKWCHxxX14BTTKWCHxxX14BTTKCPALDCHxxX18TFPALDCHxxX18KDRZ-E3-HDRDRZ-E3-ARCHHDRLHDRZ-E5-HDRDRZ-E5-HDRWCHxxX6WCHxxX6
CROSSHEAD A1H9xxCROSSHEAD A1KH9xxKCROSSHEAD B1H14xxBCROSSHEAD B1KH14xxBCROSSHEAD B2CH12xxKCROSSHEAD B2CH12xxKCROSSHEAD B2CH12xxKCROSSHEAD B2CH12xxKCROSSHEAD C1H18xxBCROSSHEAD C1H18xxBCROSSHEAD C2CH18xxBCROSSHEAD C2CH18xxBCROSSHEAD C2CH18xxBCROSSHEAD C2CH18xxBCROSSHEAD C2CH18xxBCROSSHEAD Z-E1-HDRZ-E1-H1CROSSHEAD Z-E2-HDRZ-E3-C1CROSSHEAD Z-E3-ARCHHDRZ-E3-C1CROSSHEAD Z-E3-ARCHHDRZ-E3-C1CROSSHEAD Z-E3-CLHDRZ-E3-C1CROSSHEAD Z-E3-CLHDRZ-E3-C1CROSSHEAD Z-E3-CLHDRZ-E3-C1CROSSHEAD Z-E3-CLHDRZ-E3-C1CROSSHEAD Z-E3-CLHDRZ-E3-C1CROSSHEAD Z-E3-RCHHDRZ-E3-C1CROSSHEAD Z-E3-RCHHDRZ-E3-C1CROSSHEAD Z-E3-RCHHDRZ-E3-C1CROSSHEAD Z-E3-RCHHDRZ-E3-C1WINDOW HEADER B1H9xx2WINDOW HEADER B1KH9xx81WINDOW HEADER B2H9xx81WINDOW HEADER C1H9xx1WINDOW HEADER C2H9xx1WINDOW HEADER C2KH9xx1WINDOW HEADER C3KH12xx8WINDOW HEADER C3KH12xx8WINDOW HEADER C3KH12xx8WINDOW HEADER C3KH12xx8WINDOW HEADER C3KH12xx8WINDOW HEADER C3KH12xx8WINDOW HEADER C3KH12xx8 <td< td=""><td>WCHxxX9N           WCHxxX9NK           T           WCHxxX14BT           TK           WCHxxX14BT           WCHxxX14BT           WCHxxX12           WCHxxX12K           WCHxxX14BT           TK           WCHxxX14BT           TK           WCHxxX14BT           TK           WCHxxX14BT           TK           WCHxxX14BT           TK           WCHxxX14BT           TK           DCHxxX14BT           TK           WCHxxX18           TK-PA           LDCHxxX18K           DR           Z-E1-HDR           DR           Z-E3-HDR           CR           Z-E3-ARCHHDR           LHDR           Z-E3-CLHDR           DR           Z-E5-TDR           WCHxxX6</td></td<>	WCHxxX9N           WCHxxX9NK           T           WCHxxX14BT           TK           WCHxxX14BT           WCHxxX14BT           WCHxxX12           WCHxxX12K           WCHxxX14BT           TK           WCHxxX14BT           TK           WCHxxX14BT           TK           WCHxxX14BT           TK           WCHxxX14BT           TK           WCHxxX14BT           TK           DCHxxX14BT           TK           WCHxxX18           TK-PA           LDCHxxX18K           DR           Z-E1-HDR           DR           Z-E3-HDR           CR           Z-E3-ARCHHDR           LHDR           Z-E3-CLHDR           DR           Z-E5-TDR           WCHxxX6
CROSSHEAD A1KH9xxKCROSSHEAD B1H14xxBCROSSHEAD B1KH14xxBCROSSHEAD B2KH12xxCROSSHEAD B2KH12xxKCROSSHEAD B2KH12xxKCROSSHEAD C1H18xxBCROSSHEAD C2H18xxBCROSSHEAD C2KH18xxBCROSSHEAD C2KH18xxBCROSSHEAD C2KH18xxBCROSSHEAD Z-E1-HDRZ-E1-HICROSSHEAD Z-E2-HDRZ-E3-HICROSSHEAD Z-E3-HDRZ-E3-HICROSSHEAD Z-E3-CLHDRZ-E3-CICROSSHEAD Z-E3-CLHDRZ-E3-CICROSSHEAD Z-E5-HDRZ-E5-HIWINDOW HEADER A1KH6xxKWINDOW HEADER B1H9xx-2WINDOW HEADER B1KH9xx-2WINDOW HEADER B2H9xxB1WINDOW HEADER C1H9xxF1WINDOW HEADER C1H9xxTWINDOW HEADER C1H9xxTWINDOW HEADER C3KH12xxBWINDOW HEADER C3K <td>WCHxxX9NK           T         WCHxxX14BT           TK         WCHxxX14BT           WCHxxX14BT         WCHxxX14BTK           WCHxxX12         WCHxxX12K           T         WCHxxX12K           T         WCHxxX14BT           TK         WCHxXX14BT           TK         WCHxXX14BTK           T-PA         LDCHxXX18           TK-PA         LDCHxXX18K           DR         Z-E1-HDR           DR         Z-E3-HDR           RCHHDR         Z-E3-ARCHHDR           LHDR         Z-E3-CLHDR           DR         Z-E5-HDR           WCHxxX6         WCHxX6K</td>	WCHxxX9NK           T         WCHxxX14BT           TK         WCHxxX14BT           WCHxxX14BT         WCHxxX14BTK           WCHxxX12         WCHxxX12K           T         WCHxxX12K           T         WCHxxX14BT           TK         WCHxXX14BT           TK         WCHxXX14BTK           T-PA         LDCHxXX18           TK-PA         LDCHxXX18K           DR         Z-E1-HDR           DR         Z-E3-HDR           RCHHDR         Z-E3-ARCHHDR           LHDR         Z-E3-CLHDR           DR         Z-E5-HDR           WCHxxX6         WCHxX6K
CROSSHEAD B1H14xxBCROSSHEAD B1KH14xxBCROSSHEAD B2H12xxCROSSHEAD B2KH12xxKCROSSHEAD C1H18xxBCROSSHEAD C1KH18xxBCROSSHEAD C2H18xxBCROSSHEAD C2H18xxBCROSSHEAD C2H18xxBCROSSHEAD C2H18xxBCROSSHEAD C2CROSSHEAD C2CROSSHEAD C2H18xxBCROSSHEAD Z-E1-HDRZ-E1-HDCROSSHEAD Z-E3-HDRZ-E3-HDCROSSHEAD Z-E3-HDRZ-E3-CLCROSSHEAD Z-E3-CLHDRZ-E3-CLCROSSHEAD Z-E3-CLHDRZ-E3-CLCROSSHEAD Z-E3-CLHDRZ-E3-CLCROSSHEAD Z-E3-CLHDRZ-E3-CLCROSSHEAD Z-E3-CLHDRZ-E3-CLCROSSHEAD Z-E5-HDRZ-E3-CLWINDOW HEADER A1H6xxKWINDOW HEADER B1H9xx-2WINDOW HEADER B1H9xx-2WINDOW HEADER B1H9xx-2WINDOW HEADER B2H9xxB1WINDOW HEADER C1H9xxKWINDOW HEADER C2H9xxTKWINDOW HEADER C3H12xxBWINDOW HEADER C4H14xxBWINDOW HEADER C3H12xxBWINDOW HEADER C4H14xxBWINDOW HEADER C4H14xxBWINDOW HEADER C4H9xxK-WINDOW HEADER C4H9xxK-WINDOW HEADER C4H9xxK-WINDOW HEADER C4H9xxK-WINDOW HEADER C4H9xxK-WINDOW HEADER C4H9xxK-WINDOW HEADER Z-W3DZ-W33WINDOW HEADER Z-W3DZ-W34WINDOW HEADER Z-W3D <td>T         WCHxxX14BT           TK         WCHxxX14BTK           WCHxxX12         WCHxxX12           WCHxxX12         WCHxxX12           WCHxxX12         WCHxxX12           WCHxxX12         WCHxxX12           WCHxxX12         WCHxxX12           WCHxxX12         WCHxxX12           T         WCHxxX12           TK         WCHxxX14BT           TFA         LDCHxxX14BTK           T-PA         LDCHxxX18K           DR         Z-E1-HDR           DR         Z-E3-HDR           CHDR         Z-E3-ARCHHDR           HDR         Z-E3-CLHDR           DR         Z-E5-TDR           WCHxxX6         WCHxxX6K</td>	T         WCHxxX14BT           TK         WCHxxX14BTK           WCHxxX12         WCHxxX12           WCHxxX12         WCHxxX12           WCHxxX12         WCHxxX12           WCHxxX12         WCHxxX12           WCHxxX12         WCHxxX12           WCHxxX12         WCHxxX12           T         WCHxxX12           TK         WCHxxX14BT           TFA         LDCHxxX14BTK           T-PA         LDCHxxX18K           DR         Z-E1-HDR           DR         Z-E3-HDR           CHDR         Z-E3-ARCHHDR           HDR         Z-E3-CLHDR           DR         Z-E5-TDR           WCHxxX6         WCHxxX6K
CROSSHEAD B1KH14xxBCROSSHEAD B2H12xxCROSSHEAD B2KH12xxKCROSSHEAD C1H18xxBCROSSHEAD C1KH18xxBCROSSHEAD C2H18xxBCROSSHEAD C2KH18xxBCROSSHEAD C2KH18xxBCROSSHEAD Z-E1-HDRZ-E1-HICROSSHEAD Z-E2-HDRZ-E2-HICROSSHEAD Z-E3-ADRZ-E3-AICROSSHEAD Z-E3-ADRZ-E3-CICROSSHEAD Z-E3-CLHDRZ-E3-CICROSSHEAD Z-E3-CLHDRZ-E3-CICROSSHEAD Z-E5-HDRZ-E3-CICROSSHEAD Z-E5-HDRZ-E5-HIWINDOW HEADER A1H6xxKWINDOW HEADER B1H9xx-2WINDOW HEADER B1H9xx-2WINDOW HEADER B1H9xx-2WINDOW HEADER C1H9xxKWINDOW HEADER C2H9xxIKWINDOW HEADER C2H9xxIKWINDOW HEADER C3H12xxBWINDOW HEADER C3H12xxBWINDOW HEADER C4H14xxBWINDOW HEADER C3H12xxBWINDOW HEADER C4H14xxBWINDOW HEADER C4H14xxBWINDOW HEADER C4H14xxBWINDOW HEADER C4H14xxBWINDOW HEADER C4H14xxBWINDOW HEADER C4H9xxK-WINDOW HEADER C3Z-W3WINDOW HEADER C4H9xxK-WINDOW HEADER C4H9xxK-WINDOW HEADER C4H9xxK-WINDOW HEADER C4H9xxK-WINDOW HEADER C4H9xxK-WINDOW HEADER Z-W3DZ-W3WINDOW HEADER Z-W3DZ-W3WINDOW HEADER Z-W3D <td>TK         WCHxxX14BTK           WCHxxX12         WCHxxX12K           T         WCHxxX14BT           TK         WCHxxX14BT           TK         WCHxxX14BT           TK         UCHxX14BT           TK         WCHxX14BT           TK         WCHxX14BT           TK         WCHxX14BT           TK         WCHxX14BT           TR         UCHxX14BT           OR         Z-E1-HDR           DR         Z-E3-HDR           QR         Z-E3-HDR           DR         Z-E3-CLHDR           DR         Z-E5-TDR           WCHxxX6         WCHxxX6K</td>	TK         WCHxxX14BTK           WCHxxX12         WCHxxX12K           T         WCHxxX14BT           TK         WCHxxX14BT           TK         WCHxxX14BT           TK         UCHxX14BT           TK         WCHxX14BT           TK         WCHxX14BT           TK         WCHxX14BT           TK         WCHxX14BT           TR         UCHxX14BT           OR         Z-E1-HDR           DR         Z-E3-HDR           QR         Z-E3-HDR           DR         Z-E3-CLHDR           DR         Z-E5-TDR           WCHxxX6         WCHxxX6K
CROSSHEAD B2H12xxCROSSHEAD B2KH12xxKCROSSHEAD C1H18xxBCROSSHEAD C1KH18xxBCROSSHEAD C2CH18xxBCROSSHEAD C2KH18xxBCROSSHEAD C2KH18xxBCROSSHEAD C2CH18xxBCROSSHEAD C2KH18xxBCROSSHEAD Z-E1-HDRZ-E1-HICROSSHEAD Z-E3-HDRZ-E3-HIDRCROSSHEAD Z-E3-HDRZ-E3-AICCROSSHEAD Z-E3-ARCHHDRZ-E3-CLCROSSHEAD Z-E3-CLHDRZ-E3-CLCROSSHEAD Z-E5-HDRZ-E5-HIDRWINDOW HEADER A1H6xxKWINDOW HEADER B1H9xx-2WINDOW HEADER B1H9xx-2WINDOW HEADER B1H9xx-2WINDOW HEADER B1H9xx-2WINDOW HEADER C1H9xx8IWINDOW HEADER C2H9xx8IWINDOW HEADER C2H9xx1KWINDOW HEADER C3H12xxBWINDOW HEADER C3H12xxBWINDOW HEADER C4H14xxBWINDOW HEADER C3H12xxBWINDOW HEADER C4H14xxBWINDOW HEADER C4H14xxBWINDOW HEADER C4H9xxK-WINDOW HEADER C4 <t< td=""><td>WCHxxX12           WCHxxX12K           T         WCHxxX14BT           TK         WCHxxX14BTK           T-PA         LDCHxxX18           TK-PA         LDCHxxX18K           DR         Z-E1-HDR           DR         Z-E3-HDR           CHHDR         Z-E3-CLHDR           DR         Z-E5-HDR           DR         Z-E5-HDR           WCHxxX6         WCHxxX6K</td></t<>	WCHxxX12           WCHxxX12K           T         WCHxxX14BT           TK         WCHxxX14BTK           T-PA         LDCHxxX18           TK-PA         LDCHxxX18K           DR         Z-E1-HDR           DR         Z-E3-HDR           CHHDR         Z-E3-CLHDR           DR         Z-E5-HDR           DR         Z-E5-HDR           WCHxxX6         WCHxxX6K
CROSSHEAD C1H18xxBCROSSHEAD C1KH18xxBCROSSHEAD C2KH18xxBCROSSHEAD C2KH18xxBCROSSHEAD C2F1-HDRZ-E1-HDCROSSHEAD Z-E1-HDRZ-E2-HDRCROSSHEAD Z-E3-HDRZ-E3-AICROSSHEAD Z-E3-ARCHHDRZ-E3-AICROSSHEAD Z-E3-CLHDRZ-E3-CLCROSSHEAD Z-E3-HDRZ-E3-CLCROSSHEAD Z-E3-CLHDRZ-E3-CLCROSSHEAD Z-E3-CLHDRZ-E3-CLCROSSHEAD Z-E3-HDRZ-E3-CLWINDOW HEADER A1H6xxKWINDOW HEADER B1H9xx-2WINDOW HEADER B1H9xx-2WINDOW HEADER B1H9xx-2WINDOW HEADER B1H9xx-2WINDOW HEADER C1H9xxEWINDOW HEADER C2H9xxB1WINDOW HEADER C1H9xxKWINDOW HEADER C2H9xxTWINDOW HEADER C3H12xxBWINDOW HEADER C3H12xxBWINDOW HEADER C3H12xxBWINDOW HEADER C4H14xxBWINDOW HEADER C3H9xxK-WINDOW HEADER C4H14xxBWINDOW HEADER C4H14xxBWINDOW HEADER C4H9xxK-WINDOW HEADER C4H14xxBWINDOW HEADER C4H14xxBWINDOW HEADER C4H14xxB	T         WCHxxX14BT           TK         WCHxxX14BTK           T-PA         LDCHxxX18           TK-PA         LDCHxxX18K           DR         Z-E1-HDR           DR         Z-E3-HDR           DR         Z-E3-HDR           CR         Z-E3-ARCHHDR           JHDR         Z-E3-CHDR           DR         Z-E5-HDR           WCHxxX6         WCHxxX6K
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CROSSHEAD C2H18xxBCROSSHEAD C2KH18xxBCROSSHEAD Z-E1-HDRZ-E1-HICROSSHEAD Z-E2-HDRZ-E2-HICROSSHEAD Z-E3-HDRZ-E3-HICROSSHEAD Z-E3-ARCHHDRZ-E3-AICROSSHEAD Z-E3-CLHDRZ-E3-CICROSSHEAD Z-E3-CLHDRZ-E5-HIRWINDOW HEADER A1H6xxWINDOW HEADER A1H6xxKWINDOW HEADER B1H9xx-2WINDOW HEADER B1H9xx-2WINDOW HEADER B1H9xx-2WINDOW HEADER B1H9xx-2WINDOW HEADER C1H9xxTWINDOW HEADER C2H9xxTWINDOW HEADER C3H12xxBWINDOW HEADER C3H2xxF-MWINDOW HEADER C3H2xXF-MWINDOW HEADER C3Z-W3WINDOW HEADER Z-W3Z-W3WINDOW HEADER Z-W3DZ-W3WINDOW HEADER Z-W3DZ-W3WINDOW HEADER Z-W3DZ-W4 <td>T-PA LDCHxxX18 TK-PA LDCHxxX18K DR Z-E1-HDR DR Z-E2-HDR DR Z-E3-HDR RCHHDR Z-E3-ARCHHDR LHDR Z-E3-ARCHHDR DR Z-E5-HDR WCHxxX6 WCHxxX6K</td>	T-PA LDCHxxX18 TK-PA LDCHxxX18K DR Z-E1-HDR DR Z-E2-HDR DR Z-E3-HDR RCHHDR Z-E3-ARCHHDR LHDR Z-E3-ARCHHDR DR Z-E5-HDR WCHxxX6 WCHxxX6K
CROSSHEAD C2KH18xxBCROSSHEAD Z-E1-HDRZ-E1-HDRCROSSHEAD Z-E3-HDRZ-E3-HICROSSHEAD Z-E3-HDRZ-E3-HICROSSHEAD Z-E3-CLHDRZ-E3-AICROSSHEAD Z-E3-CLHDRZ-E3-CLCROSSHEAD Z-E3-CLHDRZ-E3-CLCROSSHEAD Z-E3-CLHDRZ-E3-CLCROSSHEAD Z-E3-HDRZ-E3-CLWINDOW HEADER A1H6xxWINDOW HEADER A1H6xxWINDOW HEADER A1H6xxWINDOW HEADER B1H9xx-2WINDOW HEADER B1H9xx-2WINDOW HEADER B1H9xx-2WINDOW HEADER B1H9xx-2WINDOW HEADER C1H9xxBTWINDOW HEADER C2H9xxKWINDOW HEADER C2H9xxKWINDOW HEADER C3H12xxBWINDOW HEADER C3H12xxBWINDOW HEADER C4H14xxBWINDOW HEADER D1H7xxF-4WINDOW HEADER D2KH9xxK-4WINDOW HEADER C4H14xxBWINDOW HEADER C4H9xxK-4WINDOW HEADER C4H9xxK-4WINDOW HEADER C4H9xxK-4WINDOW HEADER C4H9xxK-4WINDOW HEADER C4H9xxK-4WINDOW HEADER C4H7xxF-4WINDOW HEADER C4H9xxK-4WINDOW HEADER C4H9xxK-4WINDOW HEADER C4H9xxK-4WINDOW HEADER Z-W3Z-W3WINDOW HEADER Z-W3Z-W3WINDOW HEADER Z-W3Z-W3WINDOW HEADER Z-W3Z-W3	TK-PA         LDCHxxX18K           DR         Z-E1-HDR           DR         Z-E2-HDR           DR         Z-E3-HDR           CHHDR         Z-E3-ARCHHDR           LHDR         Z-E3-CLHDR           DR         Z-E5-HDR           WCHxxX6         WCHxxX6K
CROSSHEAD Z-E1-HDRZ-E1-HDRCROSSHEAD Z-E2-HDRZ-E2-HDRCROSSHEAD Z-E3-HDRZ-E3-HDRCROSSHEAD Z-E3-ARCHHDRZ-E3-AICROSSHEAD Z-E3-CLHDRZ-E3-CLCROSSHEAD Z-E5-HDRZ-E5-HDRWINDOW HEADER A1H6xxKWINDOW HEADER A1H6xxKWINDOW HEADER B1H9xx-2WINDOW HEADER B1H9xx-2WINDOW HEADER B1H9xx-2WINDOW HEADER B1H9xx-2WINDOW HEADER B1H9xx-2WINDOW HEADER C1H9xxB1WINDOW HEADER C2H9xxB1WINDOW HEADER C2H9xxTWINDOW HEADER C3H12xxBWINDOW HEADER C3H12xxBWINDOW HEADER C4H14xXBWINDOW HEADER D1H7xxF-4WINDOW HEADER D2KH9xxKWINDOW HEADER D1KH7xxF-4WINDOW HEADER C3Z-W3WINDOW HEADER C4H9xxKWINDOW HEADER C4H9xxKWINDOW HEADER C4H14xXBWINDOW HEADER C4H7xxF-4WINDOW HEADER C4H7xxF-4WINDOW HEADER C4H9xXKWINDOW HEADER C4H9xXKWINDOW HEADER Z-W3Z-W3WINDOW HEADER Z-W3Z-W3WINDOW HEADER Z-W3DZ-W3WINDOW HEADER Z-W3DZ-W3WINDOW HEADER Z-W4Z-W4	DR         Z-E1-HDR           DR         Z-E2-HDR           DR         Z-E3-HDR           CHHDR         Z-E3-ARCHHDR           LHDR         Z-E3-CLHDR           DR         Z-E3-HDR           WCHXXX6         WCHXXX6K
CROSSHEAD Z-E2-HDRZ-E2-HDRCROSSHEAD Z-E3-HDRZ-E3-HDRCROSSHEAD Z-E3-ARCHHDRZ-E3-AICROSSHEAD Z-E3-CLHDRZ-E3-CLCROSSHEAD Z-E5-HDRZ-E5-HDRWINDOW HEADER A1H6xxWINDOW HEADER A1H6xxWINDOW HEADER A1H6xxWINDOW HEADER B1H9xx-2WINDOW HEADER B1H9xx-2WINDOW HEADER B1H9xx-2WINDOW HEADER B2H9xxB1WINDOW HEADER B2H9xxB1WINDOW HEADER C1H9xxKWINDOW HEADER C2H9xxKWINDOW HEADER C2H9xxKWINDOW HEADER C3H12xxBWINDOW HEADER C3H12xxBWINDOW HEADER C4H14xxBWINDOW HEADER D1H7xxF-4WINDOW HEADER D2KH9xxKWINDOW HEADER D2KH9xxKWINDOW HEADER C3H12xxBWINDOW HEADER C4H14xxBWINDOW HEADER C3H12xxBWINDOW HEADER C4H7xxF-4WINDOW HEADER C4H7xxF-4WINDOW HEADER C4H9xxK-4WINDOW HEADER Z-W3Z-W3WINDOW HEADER Z-W3Z-W3WINDOW HEADER Z-W3DZ-W3DWINDOW HEADER Z-W3DZ-W34WINDOW HEADER Z-W3Z-W3	DR         Z-E2-HDR           DR         Z-E3-HDR           CHHDR         Z-E3-ARCHHDR           LHDR         Z-E3-CLHDR           DR         Z-E5-HDR           WCHxxX6         WCHxxX6K
CROSSHEAD Z-E3-HDRZ-E3-HDRCROSSHEAD Z-E3-ARCHHDRZ-E3-AICROSSHEAD Z-E3-CLHDRZ-E3-CLCROSSHEAD Z-E5-HDRZ-E5-HDRWINDOW HEADER A1H6xxWINDOW HEADER A1H6xxWINDOW HEADER A1H9xx-2WINDOW HEADER B1H9xx-2WINDOW HEADER B1H9xx-2WINDOW HEADER B1H9xx-2WINDOW HEADER B2H9xxB1WINDOW HEADER B2H9xxB1WINDOW HEADER C1H9xxCWINDOW HEADER C2H9xxKWINDOW HEADER C2H9xxTKWINDOW HEADER C3H12xxBWINDOW HEADER C3H12xxBWINDOW HEADER C4H14xxBWINDOW HEADER D1H7xxF-4WINDOW HEADER D1H7xxF-4WINDOW HEADER D2KH9xxKWINDOW HEADER C3W1Z-W13WINDOW HEADER C3W3Z-W33WINDOW HEADER Z-W3DZ-W3DWINDOW HEADER Z-W3DZ-W3DWINDOW HEADER Z-W3DZ-W34WINDOW HEADER Z-W3DZ-W34	DR         Z-E3-HDR           RCHHDR         Z-E3-ARCHHDR           LHDR         Z-E3-CLHDR           DR         Z-E5-HDR           WCHxxX6         WCHxxX6K
CROSSHEAD Z-E3-ARCHHDRZ-E3-AICROSSHEAD Z-E3-CLHDRZ-E3-CLCROSSHEAD Z-E5-HDRZ-E5-HDRWINDOW HEADER A1H6xxKWINDOW HEADER A1H6xxKWINDOW HEADER A1H6xxKWINDOW HEADER A1H9xx-2WINDOW HEADER B1H9xx-2WINDOW HEADER B1H9xx-2WINDOW HEADER B1H9xx-2WINDOW HEADER B2H9xxB1WINDOW HEADER B2H9xxB1WINDOW HEADER C1H9xxWINDOW HEADER C2H9xxTKWINDOW HEADER C2KH9xxTKWINDOW HEADER C3KH12xxBWINDOW HEADER C4H14xxBWINDOW HEADER D1H7xxFWINDOW HEADER D1KH7xxFWINDOW HEADER C2KH9xxK-WINDOW HEADER D1KH7xxFWINDOW HEADER C4H14xxBWINDOW HEADER C5H9xxK-WINDOW HEADER C4H14xxBWINDOW HEADER C4H14xxBWINDOW HEADER C4H2xXFWINDOW HEADER C4H2xXFWINDOW HEADER C4H2xXFWINDOW HEADER C5H9xXFWINDOW HEADER C4H9xXFWINDOW HEADER C4H2xXFWINDOW HEADER C4H2xXFWINDOW HEADER C4H2xXFWINDOW HEADER C4H2xXFWINDOW HEADER C4H2-W1WINDOW HEADER Z-W3Z-W3WINDOW HEADER Z-W3DZ-W3WINDOW HEADER Z-W3DZ-W4	RCHHDR         Z-E3-ARCHHDR           LHDR         Z-E3-CLHDR           DR         Z-E5-HDR           WCHxxX6         WCHxxX6K
CROSSHEAD Z-E3-CLHDRZ-E3-CLCROSSHEAD Z-E5-HDRZ-E5-HDRWINDOW HEADER A1H6xxWINDOW HEADER A1H6xxWINDOW HEADER A1H6xxWINDOW HEADER A1H6xxWINDOW HEADER B1H9xx-2WINDOW HEADER B1H9xx-2WINDOW HEADER B1H9xx-2WINDOW HEADER B1H9xx-2WINDOW HEADER B1H9xx-2WINDOW HEADER B2H9xxB1WINDOW HEADER B2H9xxB1WINDOW HEADER C1H9xxWINDOW HEADER C2H9xxTWINDOW HEADER C1KH9xxTWINDOW HEADER C2KH9xxTKWINDOW HEADER C3KH12xxBWINDOW HEADER C3KH12xxBWINDOW HEADER C4H14xXBWINDOW HEADER C1KH7xxF-4WINDOW HEADER D1H7xxF-4WINDOW HEADER D2KH9xxK-WINDOW HEADER Z-W3Z-W3WINDOW HEADER Z-W3DZ-W3DWINDOW HEADER Z-W3DZ-W3DWINDOW HEADER Z-W3DZ-W34WINDOW HEADER Z-W4Z-W4	HDR         Z-E3-CLHDR           DR         Z-E5-HDR           WCHxxX6         WCHxxX6K
CROSSHEAD Z-E5-HDRZ-E5-HDRWINDOW HEADER A1H6xxWINDOW HEADER A1KH6xxKWINDOW HEADER B1H9xx-2WINDOW HEADER B1H9xx-2WINDOW HEADER B1H9xx-2WINDOW HEADER B1KH9xx-2WINDOW HEADER B1KH9xx-2WINDOW HEADER B1KH9xx-2WINDOW HEADER B2H9xxB1WINDOW HEADER C1H9xxB1WINDOW HEADER C2H9xxTWINDOW HEADER C1KH9xxTWINDOW HEADER C2KH9xxTKWINDOW HEADER C3KH12xxBWINDOW HEADER C3KH12xxBWINDOW HEADER C4H14xxBWINDOW HEADER D1H7xxF-4WINDOW HEADER D2KH9xxK-WINDOW HEADER Z-W1Z-W1WINDOW HEADER Z-W3Z-W3WINDOW HEADER Z-W3DZ-W3DWINDOW HEADER Z-W3DZ-W3DWINDOW HEADER Z-W3DZ-W3DWINDOW HEADER Z-W3DZ-W4WINDOW HEADER Z-W4Z-W4	DR Z-E5-HDR WCHxxX6 WCHxxX6K
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WINDOW HEADER B1         H9xx-2           WINDOW HEADER B1K         H9xx-2           WINDOW HEADER B2         H9xxBT           WINDOW HEADER B2K         H9xxBT           WINDOW HEADER C1         H9xxBT           WINDOW HEADER C1         H9xxK           WINDOW HEADER C1         H9xxX           WINDOW HEADER C1         H9xxX           WINDOW HEADER C1K         H9xxK           WINDOW HEADER C2         H9xxT           WINDOW HEADER C2         H9xxT           WINDOW HEADER C2         H9xxT           WINDOW HEADER C3         H12xxB           WINDOW HEADER C3         H12xxB           WINDOW HEADER C3K         H12xxB           WINDOW HEADER C4         H14xxB           WINDOW HEADER D1K         H7xxF-           WINDOW HEADER D2K         H9xxK-           WINDOW HEADER Z-W3         Z-W3           WINDOW HEADER Z-W3         Z-W3           WINDOW HEADER Z-W3D         Z-W3D           WINDOW HEADER Z-W3D         Z-W3           WINDOW HEADER Z-W3D         Z-W3	
WINDOW HEADER B1KH9xx-2lWINDOW HEADER B2H9xxBTWINDOW HEADER C1H9xxBTWINDOW HEADER C1H9xxKWINDOW HEADER C1KH9xxKWINDOW HEADER C2H9xxTWINDOW HEADER C2KH9xxTKWINDOW HEADER C3H12xxBWINDOW HEADER C3H12xxBWINDOW HEADER C3H12xxBWINDOW HEADER C3H12xxBWINDOW HEADER C3KH12xxBWINDOW HEADER C4H14xxBWINDOW HEADER D1H7xxFWINDOW HEADER D2KH9xxK-WINDOW HEADER Z-W1Z-W1WINDOW HEADER Z-W3Z-W3BWINDOW HEADER Z-W3DZ-W3DWINDOW HEADER Z-W3DZ-W3DWINDOW HEADER Z-W3DZ-W3DWINDOW HEADER Z-W3DZ-W3DWINDOW HEADER Z-W4Z-W4	WCHxxX9N
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WINDOW HEADER C2         H9xxT           WINDOW HEADER C2K         H9xxTK           WINDOW HEADER C3         H12xxB           WINDOW HEADER C3K         H12xxB           WINDOW HEADER C4         H14xxB           WINDOW HEADER C4         H14xxB           WINDOW HEADER D1         H7xxF           WINDOW HEADER D1K         H7xxF           WINDOW HEADER D2K         H9xxK-           WINDOW HEADER Z-W1         Z-W1           WINDOW HEADER Z-W3K         Z-W3W           WINDOW HEADER Z-W3K         Z-W3K           WINDOW HEADER Z-W3K         Z-W3D           WINDOW HEADER Z-W3D         Z-W3D           WINDOW HEADER Z-W3A         Z-W3D           WINDOW HEADER Z-W3A         Z-W3D	CCAxxX10
WINDOW HEADER C2K         H9xxTK           WINDOW HEADER C3         H12xxB           WINDOW HEADER C3K         H12xxB           WINDOW HEADER C4         H14xxB           WINDOW HEADER D1         H7xxF-           WINDOW HEADER D1K         H7xxF-           WINDOW HEADER D2K         H9xxK-           WINDOW HEADER Z-W1         Z-W1           WINDOW HEADER Z-W3         Z-W3W           WINDOW HEADER Z-W3K         Z-W3K           WINDOW HEADER Z-W3D         Z-W3D           WINDOW HEADER Z-W3K         Z-W3W           WINDOW HEADER Z-W3W         Z-W3W           WINDOW HEADER Z-W4         Z-W4	CCAxxX10K
WINDOW HEADER C3         H12xxB           WINDOW HEADER C3K         H12xxB           WINDOW HEADER C4         H14xxB           WINDOW HEADER D1         H7xxF           WINDOW HEADER D1K         H7xxF           WINDOW HEADER D2K         H9xxK           WINDOW HEADER Z-W1         Z-W1           WINDOW HEADER Z-W3         Z-W3W           WINDOW HEADER Z-W3K         Z-W3K           WINDOW HEADER Z-W3D         Z-W3D           WINDOW HEADER Z-W3A         Z-W3W           WINDOW HEADER Z-W4         Z-W3W	WCHxxX9T
WINDOW HEADER C3KH12xxBWINDOW HEADER C4H14xxBWINDOW HEADER D1H7xxFWINDOW HEADER D1KH7xxFWINDOW HEADER D2KH9xxK-WINDOW HEADER Z-W1Z-W1WINDOW HEADER Z-W3Z-W3WWINDOW HEADER Z-W3KZ-W3KWINDOW HEADER Z-W3DZ-W3WWINDOW HEADER Z-W4Z-W4	
WINDOW HEADER C4         H14xxB           WINDOW HEADER D1         H7xxF-           WINDOW HEADER D1K         H7xxF-           WINDOW HEADER D2K         H9xxK-           WINDOW HEADER Z-W1         Z-W1           WINDOW HEADER Z-W3         Z-W3           WINDOW HEADER Z-W3K         Z-W3K           WINDOW HEADER Z-W3D         Z-W3D           WINDOW HEADER Z-W3A         Z-W3A	
WINDOW HEADER D1         H7xxF-/           WINDOW HEADER D1K         H7xxF-/           WINDOW HEADER D2K         H9xxK-           WINDOW HEADER Z-W1         Z-W1           WINDOW HEADER Z-W3         Z-W3           WINDOW HEADER Z-W3K         Z-W3K           WINDOW HEADER Z-W3K         Z-W3K           WINDOW HEADER Z-W3D         Z-W3D           WINDOW HEADER Z-W3A         Z-W3A	
WINDOW HEADER D1K         H7xxF-/           WINDOW HEADER D2K         H9xxK-           WINDOW HEADER Z-W1         Z-W1           WINDOW HEADER Z-W3         Z-W3           WINDOW HEADER Z-W3K         Z-W3K           WINDOW HEADER Z-W3K         Z-W3K           WINDOW HEADER Z-W3D         Z-W3D           WINDOW HEADER Z-W4         Z-W4	
WINDOW HEADER D2K         H9xxK-           WINDOW HEADER Z-W1         Z-W1           WINDOW HEADER Z-W3         Z-W3           WINDOW HEADER Z-W3K         Z-W3K           WINDOW HEADER Z-W3D         Z-W3D           WINDOW HEADER Z-W3D         Z-W3D           WINDOW HEADER Z-W3D         Z-W3D	•
WINDOW HEADER Z-W1         Z-W1           WINDOW HEADER Z-W3         Z-W3           WINDOW HEADER Z-W3K         Z-W3K           WINDOW HEADER Z-W3D         Z-W3D           WINDOW HEADER Z-W3D         Z-W3D           WINDOW HEADER Z-W4         Z-W4	•
WINDOW HEADER Z-W3 Z-W3 WINDOW HEADER Z-W3K Z-W3K WINDOW HEADER Z-W3D Z-W3D WINDOW HEADER Z-W4 Z-W4	Z-W1
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	7 14/00
WINDOW HEADER Z-W4K Z-W4K	Z-W3D
	Z-W4
	Z-W4

	PILASTERS			
Drees General Callout	Nuwood		Fypon	Drees Gene
FLUTED PILASTER A1	PL7xxF	PIL7Xxx		BAND MOULD [
FLUTED PILASTER B1	PL9xxF	PIL9Xxx		BAND MOULD D
FLUTED PILASTER C1	PL11xxFM	PIL11Xxx		BARGE MOULD
PANEL PILASTER A2	PL7xxP	PIL7XxxDP		CASE MOULD D
PANEL PILASTER B2	PL9xxP	PIL9XxxDP		CASE MOULD D
PANEL PILASTER C2	PL11xxPM	PIL11XxxDP		CROWN MOUL
PILASTER D1	M311-9	PIL10XxxA		DENTIL MOULD
PILASTER D2	M323-9	N/A		DENTIL MOULD
PILASTER Z-E1-PIL	Z-E1-PIL	Z-E1-PIL		HALF ROUND M
PILASTER Z-E2-PIL	Z-E2-PIL	Z-E2-PIL		PANEL MOULD
PILASTER Z-E3-PIL	Z-E3-PIL	Z-E3-PIL		
PILASTER Z-PIL-EXT	Z-PIL-EXT	Z-PIL-EXT		
PLAIN PILASTER A3	PL7xxS	PIL7XxxP		
PLAIN PILASTER B3	PL9xxS	PIL9XxxP		
PLAIN PILASTER C3	PL11xxS	PIL11XxxP		Drees Gene
PLINTH D1	PF10		END OF PILASTER	BROW COMBO
PLINTH D2	P14.5	N/A		PEAK PEDIMENT
	LOUVERS			PEAK PEDIMEN
	LOOVERS			PEAKED COMB
Drago Constal Callout	Numeral	Euroon		RAMS HEAD PE
Drees General Callout	Nuwood	Fypon	Mid-America	ROUND PEDIME
CATHEDRAL LOUVER D1	CLV1224	CLV12X24		SUNRISE COMB
CATHEDRAL LOUVER D1T	CLV1224TRIM4	CLV12X24X4F		VICTORIAN PED
CATHEDRAL LOUVER D2	CLV1432	CLV14X32		
CATHEDRAL LOUVER D2T	CLV1432TRIM4	CLV14X32X4F	00 44 1422	
CATHEDRAL LOUVER D3	CLV2232	CLV22X32		
CATHEDRAL LOUVER D3T	CLV2232TRIM4	CLV22X32X4F		Drees Gene
HALF CIRCLE LOUVER D1	HRLV32	HRLV32X16		
HALF CIRCLE LOUVER D1T	HRLV32TRIM4	HRLV32X4F		HALF CIRCLE SU
HALF CIRCLE LOUVER D2	HRLV36	HRLV36X18		PALLADIAN WIN
HALF CIRCLE LOUVER D2T	HRLV36TRIM4	HRLV36X4F	00 43 2234	PALLADIAN WIN
OCTAGONAL LOUVER D1	OLV24	OLV24		PALLADIAN WIN
OCTAGONAL LOUVER D12	OLV24TRIM4	OLV24X4F		
OVAL LOUVER D1	OLV2537	OLV37X25		PALLADIAN WIN
OVAL LOUVER DIT	OLV2537TRIM4	OLV37X25X4F		
	LV1224V	LV12X24		
RECTANGUAR LOUVER D1			00 45 1218	PEAKED CAP HE
RECTANGUAR LOUVER D1T	LV1224VTRIM4	LV12X24-4F	00 45 1218	PLAIN SEGMEN
RECTANGUAR LOUVER D2	LV1636V	LV16X36		SEGMENT SUNB
RECTANGUAR LOUVER D2T	LV1636VTRIM4	LV16X36-4F		
RECTANGUAR LOUVER D3	LV2436V	LV24X36		
RECTANGUAR LOUVER D3T	LV2436VTRIM4	LV24X36-4F		
RECTANGUAR LOUVER D4	LV2424V	LV24X24		
RECTANGUAR LOUVER D4T	LV2424VTRIM4	LV24X24-4F		Drees Gene
ROUND LOUVER D1	RLV18	RLV18		GABLE D1
ROUND LOUVER DIT	RLV18TRIM4	RLV18X4F		KEYSTONE D1
ROUND LOUVER D2	RLV22	RLV22		KEYSTONE D2
				WREATH D1
ROUND LOUVER D2T	RLV22TRIM4	RLV22X4F		WREATH DI
TRIANGULAR LOUVER D1		TRLVxxX36	00 47 0x0x	
	BRACKETS			
Droop Conoral Callout	Numerad		Fypon	
Drees General Callout	Nuwood			
EXTERIOR BRACKET D1	BR437	N/A		
EXTERIOR BRACKET D2	DB102	DTLB6X4X6		
EXTERIOR BRACKET D3	BR304 (7" WIDE)	BKT24X24X7	7	
EXTERIOR BRACKET D3	BR455	N/A		
	BR300-1	BKT12X12X6	<u>,                                     </u>	
EXTERIOR BRACKET D5			)	
EXTERIOR BRACKET D6	BR300	BKT12X12		
EXTERIOR BRACKET D7	BR409	BKT16X18X3	3	
EXTERIOR BRACKET D8	BR413	DTLB5X5X3		
EXTERIOR BRACKET D9	TBD	BKT11X20		
EXTERIOR BRACKET D10	TBD	BKT12X24X3	3	
EXTERIOR BRACKET D11	BR435	BKT25X27		
EXTERIOR BRACKET D12	BR404	BKT16X30X4	1	
EXTERIOR BRACKET D13	BR23.13x10.13x5.5	N/A	<u>.</u>	
	TBD			
GABLE BRACKET D1			R(OR L)PITCH	
GABLE BRACKET D2	BR423-x:12	BKT5X20		
GABLE BRACKET D3	BR424-x:12	<u> </u>	UT 2" PROJECTION)	



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Sheet Description:

MOULDED MILLWORK SCHEDULE

LAST REVISED 11/22/17

## MOULDINGS

Drees General Callout	Nuwood	Fypon
BAND MOULD D1	M210-16	MLD612-12
BAND MOULD D2	M301-16	MLD220-16
BARGE MOULD D1	WM210	WM210
CASE MOULD D1	M320-16	MLD226-16
CASE MOULD D2	N/A	MLD244-12
CROWN MOULD D1	M404-16	MLD572-16
DENTIL MOULD D1	M105-16	MLD310-16
DENTIL MOULD D2	M108-8	MLD353-8
HALF ROUND MOULD D1	N/A	MLD605-12
PANEL MOULD D1	M310-8 OR 16	MLD612-12

### PEDIMENTS / COMBO HEADERS

Drees General Callout	Nuwood	Fypon
BROW COMBO D1	BCxx	CSAPxx
PEAK PEDIMENT D1	Pxx-4 (6:12)	PCPxx
PEAK PEDIMENT Z-E1-PED	Z-E1-PED	Z-E1-PED
PEAKED COMBO D1	PCxx-4	СРСРхх
RAMS HEAD PEDIMENT D1	Rxx	RHPxx00
ROUND PEDIMENT D1	Bxx-4	PSPxx
SUNRISE COMBO D1	SCxx-4	CSPxx
VICTORIAN PEDIMENT D1	VPxx	DVPxx w/ SWDHxxXxx

WIN	DOW DECORATIO	N
Drees General Callout	Nuwood	Fypon
HALF CIRCLE SUNBURST D1	SPxxxx	SWDHxxXxx
PALLADIAN WINDOW D1	H9AR10-xx xx'' FL/FR	ARxxX10MFLxxx
PALLADIAN WINDOW D1K	H9AR10-xxK xx" FL/FR	ARxxX10MFLxxx with K10TM
PALLADIAN WINDOW D2	H9AR10SPxxxx	ARxxX10MFLxxx with
		SWDHxxXxx
PALLADIAN WINDOW D2K	H9AR10SPxxxxK	ARxxX10MFLxxx with
		SWDHxxXxx and K10TM
PEAKED CAP HEADER D1	N/A	CHPCxxX15
Plain Segment D1	SPxxxxP	PSPxx
SEGMENT SUNBURST D1	SPxxxx	SWDHxxXxx

	ACCESSORIES	
Drees General Callout	Nuwood	Fypon
GABLE D1	PGDx12	GPA (width X height)
(EYSTONE D1	KY14F-3	KY14
CEYSTONE D2	КҮНМ9F	K9M
WREATH D1	N/A	WAB34

Sheet No.

SC-02