
				Covered Front Porch       149 SF         Garage       445 SF         Outdoor Living       77 SF         671 SF       671 SF         square Foologe total may vay by 1 SF due to automated rounding of first and se         Rectraws         Plan Review: XX/XX/XX         Xoox
Architecture Plan Review: 🛛 No C	omments 🔲 See Comments Items draw	n on any drawings and not written in the contract selctions <u>WILL NOT</u> be included in	the site specific drawings.	Customer Plan Review Signature
Customer Request:	Design Solution:	Reason For Modification:	Comments:	I understand that my new Drees home will be built in general comfi plans, specifications, selections and the Purchase Agreement, all of
Customer Request: 1. XXX 2. XXX	Design Solution: 1. XXX 2. XXX	Reason For Modification: 1. XXX 2. XXX	Comments: 1. XXX 2. XXX	I understand that my new Drees home will be built in general comfi plans, specifications, selections and the Purchase Agreement, all of reviewed and approved. This sel of plans may not reflect the eleva for my house. Drees draws the standard plans complete with the m options. The subcontractor's sets will show only the options I selecter selection sheets. I have reviewed the plot plan for my house and un there may be some field adjustments as to the exact location of the lot. I further understand that my home will not be built exactly like a
ustomer Request:	Design Solution: 1. XXX	Reason For Modification:	Comments: 1. XXX	I understand that my new Drees home will be built in general comfi plans, specifications, selections and the Purchase Agreement, all of reviewed and approved. This set of plans may not reflect the eleva for my house. Drees draws the standard plans complete with the m options. The subcontractor's sets will show only the options I selected selection sheets. I have reviewed the plot plan for my house and u there may be some field adjustments as to the exact location of the

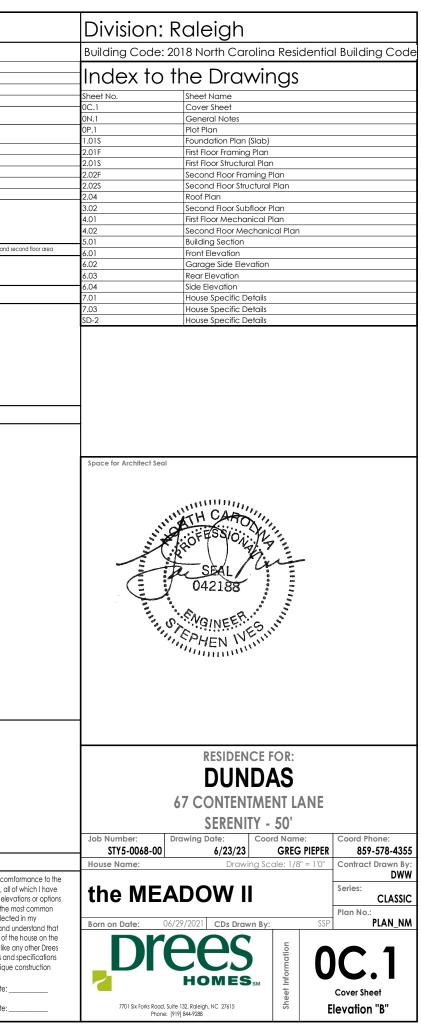



## GENERAL NOTES - RALEIGH


#### FOUNDATION NOTES

FOUNDATION NOTES	
CRAWL SPACES: - SLOPE CONCRETE SLAB 4" MINIMUM TOWARDS GARAGE DOOR - EXTERIOR FLATWORK/GARAGES SHALL HAVE A MINIMUM CONCRETE SRENGTH OF 4,500 PSI - FOOTINGS TO A MINIMUM CONCRETE STRENGTH OF 2500 PSI, UNLESS OTHERWISE NOTED - ASSUMED ALLOWABLE SOIL BEARING PRESSURE: 2,000 p.s.f. - WATERPROOF FOUNDATION WITH BITUMINOUS SPRAY. - WALL TIES EMBEDDED IN THE HORIZONTAL MORTAR JOINT SHALL BE 16" ON CENTER. TIES IN ALTERNATE COURSES SHALL BE STAGGERED. THE MAXIMUM VERTICAL DISTANCE BETWEEN TIES SHALL NOT EXCEED 16" AND THE MAXIMUM HORIZONTAL DISTANCE SHALL BC TEXCEED 16" ADDITIONAL TIES SHALL BE PROVIDED AT ALL OPENINGS, AND WITHIN 12" OF THE OPENING. - CORE FILL ENTIRE BLOCK WALL WHEN THE WALL S 4'-0" TALL OR HIGHER. INSTALL #4 REBAR IN EACH HOLLOW AREA OF EACH BLOCK RROM FOOTING TO TOP OF WALL, ON THE ENTIRE WALL PRIOR TO CORE FILLING IT. - TOP COURSE OF BLOCK ON ALL WALLS WILL BE FILLED SOLID WITH MORTAR PLACING THE FOUNDATION STRAPS OR BOLTS IN THE MORTAR 6'-0" ON CENTER, AND 12" FROM EACH CORNER. - 12'x16" PIERS: HOLLOW MASONRY UP TO 48" HIGH, SOLID MASONRY UP TO 90" HIGH - 16'x16" PIERS: HOLLOW MASONRY UP TO 44" HIGH, SOLID MASONRY UP TO 12'0" HIGH - 16'x16" PIERS: HOLLOW MASONRY UP TO 44" HIGH, SOLID MASONRY UP TO 12'0" HIGH - 16'x16" PIERS: HOLLOW MASONRY UP TO 44" HIGH, SOLID MASONRY UP TO 12'0" HIGH - 16'x16" PIERS: HOLLOW MASONRY UP TO 44" HIGH, SOLID MASONRY UP TO 12'0" HIGH - SILL PLATES TO BE A MINIMUM OF 2x4 NOMINAL LUMBER.	BASEMENTS: SLOPE CONCRETE SLAB 4" MINIMUM TOWARDS GARAGE DOOR EXTERIOR FLATWORK/GARAGES SHALL HAVE A MINIMUM CONCRETE SRENGTH OF 4,500 PSI FOOTINGS TO A MINIMUM CONCRETE STRENGTH OF 2500 PSI, UNLESS OTHERWISE NOTED- ALL FOUNDATION WALLS TO BE CAST IN PLACE CONCRETE 3000 PSI MIN. UNLESS OTHERWISE NOTED. BASEMENT WINDOW LOCATIONS MAY VARY FROM DRAWING DUE TO LOT CONDITIONS. BACKFILL ADJACENT TO FOUNDATION WALLS SHALL NOT BE PLACED UNTIL THE WALL HAS SUFFICIENT STRENGTH AND HAS BEEN ANCHORED TO THE FLOOR OR HAS BEEN SUFFICIENTLY BRACED TO PREVENT DAMAGE BY THE BACKFILL - ASSUMED ALLOWABLE SOIL BEARING PRESSURE: 2.000 p.s.f ASSUMED ALLOWABLE SOIL BEARING PRESSURE: 2.000 p.s.f WATERPROOF FOUNDATION WITH BITUMINOUS SPRAY VERTICAL CONTROL JOINTS IN BASEMENT FOUNDATION WALLS - STANDARD LOCATION GUIDELINES: 1) PLACE A CONTROL JOINT IN BASEMENT FOUNDATION WALLS - STANDARD LOCATION GUIDELINES: 2) WINDOWS THAT ARE LARGER THAN THE STANDARD BASEMENT WINDOW REQUIRE A CONTROL JOINT. 3) CONTROL JOINTS IN BASEMENT FOUNDATION WALLS - STANDARD LOCATION GUIDELINES: 4) IF THERE IS A STANDARD BUDDE THAN THE STANDARD BASEMENT WINDOW REQUIRE A CONTROL JOINT. 3) CONTROL JOINTS ARE NOT REQUIRED AT EVERY WINDOW THAT IS STANDARD SIZE. 4) IF THERE IS A STANDARD BUNDOW LOCATED IN A WALL SEGMENT THAT REQUIRES A CONTROL JOINT. THEN THE CONTROL JOINT SHOULD BE PLACED ON THE SIDE OF THE WINDOW THAT IS ADJACENT TO THE LONG SIDE OF THE WALL. IF THERE IS MORE THAN ONE WINDOW IN A WALL THEN ONLY ONE WINDOW SHOULD HAVE A CONTROL JOINT. 5) DOORS DO NOT GET CONTROL JOINTS. 6) CONTROL JOINTS SHOULD NOT BE LOCATED WITHIN 3' OF A BEAM POCKET. 7) CONTROL JOINTS KE REQUIRED AT THE FRIST AND LAST STEP DOWN AT STEPPED BASEMENT FOUNDATION WALLS INTERIOR FLATWORK SHALL HAVE A MINIMUM CONCRETE STRENGTH OF 9.0 ALL VERTICAL STREL AND ALL STEP DOWN AT STEPPED BASEMENT FOUNDATION WALLS INTERIOR FLATWORK SHALL HAVE A MINIMUM CONCRETE STRENGTH OF 9.0 ALL VERTICAL STREL AND ALL STRENGTH OF 9.0 ALL VERTICAL STREL AND ALL STRED FRENGTH OF 9.0
FRAMING NOTES	MECHANICAL/ELECTRICAL NOTES
DESIGN LOADS: FLOORS: 40 psf LIVE LOAD + 10 psf DEAD LOAD = 50 psf GARAGE FLOOR: 50 psf LIVE LOAD SEISMIC: "A" & "B" ROOF: 18 psf LIVE LOAD + 17 psf DEAD LOAD = 35 psf WIND SPEED: 120 MPH DESIGN DEFLECTION LIMITS (BASED ON LIVE LOAD, EXCEPT MASONRY): RAFTERS GREATER THAN 3:12 L/180 CEILINGS L/240 MASONRY VENEER L/600 NOMINAL LUMBER FLOORS: L/360 MANUFACTURED WOOD FLOORS: DESIGNED TO MINIMUM PRO RATING OF 35 (OR EQUIVALENT). NO MORE THAN 8 POINT DIFFERENCE BETWEEN ADJACENT SPANS. L/480 FOR SPANS UP TO 16-0" AND NO GREATER THAN 1/2" DEFLECTION L/600 FOR SPANS OVER 16-0" IF CONTINUOUS SPAN. AND NO GREATER THAN 1/2" DEFLECTION L/600 FOR SPANS OVER 16-0" IF CONTINUOUS SPAN. AND NO GREATER THAN 1/2" DEFLECTION L/600 FOR SPANS OVER 16-0" IF CONTINUOUS SPAN. AND NO GREATER THAN 1/2" DEFLECTION L/600 FOR SPANS OVER 16-0" IF CONTINUOUS SPAN. AND NO GREATER THAN 1/2" DEFLECTION L/600 FOR SPANS OVER 16-0" IF CONTINUOUS SPAN. AND NO GREATER THAN 1/2" DEFLECTION L/600 FOR SPANS OVER 16-0" IF CONTINUOUS SPAN. AND NO GREATER THAN 1/2" DEFLECTION L/600 FOR SPANS OVER 16-0" IF CONTINUOUS SPAN. AND NO GREATER THAN 1/2" DEFLECTION L/600 FOR SPANS OVER 16-0" IF CONTINUOUS SPAN. AND NO GREATER THAN 1/2" DEFLECTION L/600 FOR SPANS OVER 16-0" IF CONTINUOUS SPAN. AND NO GREATER THAN 1/2" DEFLECTION L/600 FOR SPANS OVER 16-0" IF CONTINUOUS SPAN. AND NO GREATER THAN 1/2" DEFLECTION L/600 FOR SPANS OVER 16-0" IF CONTINUOUS SPAN. AND NO GREATER THAN 1/2" DEFLECTION L/600 FOR SPANS OVER 16-0" IF CONTINUOUS SPAN. AND NO GREATER THAN 1/2" DEFLECTION L/600 FOR SPANS OVER 16-0" IF CONTINUOUS SPAN. AND NO GREATER THAN 1/2" DEFLECTION L/600 FOR SPANS OVER 16-0" IF CONTINUOUS SPAN. AND NO GREATER THAN 1/2" DEFLECTION SUBSTALL UNCOUPLING MEMBRANE IN TILE FLOOR AREAS IF 19.2" 0.C. FLOOR JOIST SPACING GUE AND MECHANICALLY FASTEN [SCREWS] WOOD FLOOR IF 19.2" 0.C. FLOOR JOIST SPACING - MANUFACTURED WOOD PRODUCTS (INCLUDING, BUT NOT LIMITED TO, STRUCTURAL WOOD BEAMS AND I-JOISTS) SHALL BE FABRICATED, HANDLED, AND INSTALLED IN	ANY GAS APPLIANCES MUST BE INSTALLED PER MANUFACTURER'S SPECIFICATIONS.     HOLD THE CENTERLINE OF ALL EXTERIOR LIGHT FIXTURES AT 5-8" OFF BOTTOM OF DOOR OPENING.     ALL KITCHEN CABINET DIMENSIONS ARE CABINET TO CABINET.     CABINET STILES MAY VARY FROM INTERIOR ELEVATIONS DEPENDING ON STYLE, MANUFACTURER, ETC. FOR CABINET DETAILS SEE SHOP DRAWINGS.     CABINET SIZES MAY VARY WITH FULL-OVERLAY CABINETS.     CABINET BIS PER DIVISION SPEC. SHEET. EXACT LOCATION TO BE FIELD DETERMINED UNLESS OTHERWISE NOTED ON THE PLANS.     MIN. 50 C.F.M. FOR ALL EXHAUST FANS IN BATHROOMS     INSULATION DETAILS     EXTERIOR STUD WALL CAVITY: (2x4)     R-15     (2x6) R-19     FLOOR JOIST CAVITY AT STAINDARD PERIMETER: R-19     FLOOR JOIST CAVITY AT STAINDARD PERIMETER: R-19     FLOOR JOIST CAVITY AT CAMILEVER: R-19     OVER GARAGE: (OVER HORIZONTAL SPACE) R-38 BLOWN     (SLOPED AND VERTICAL SPACE) R-38 BLOWN
- EXTERIOR WALLS TO BE 2x4 SPF STUD GRADE AT 16" o.C. UNLESS OTHERWISE NOTED (10'4-1/2" MAXIMUM WALL HEIGHT) - ALL INTERIOR BEARING WALLS AND WALLS AT BASEMENT & FIRST FLOOR STAIRWELLS, KITCHEN, BATH, & GARAGE TO BE 2x4 SPF STUD GRADE @ 16" o.C.; ALL OTHER NON-BEARING INTERIOR WALLS TO BE 2x4 SPF STUD GRADE @ 24" o.C. U.O.N.	
- ALL WALLS TO BE 3 1/2" UNLESS OTHERWISE NOTED. - PROVIDE SOLID BEARING TO FOUNDATION OR BEAM BELOW FOR ALL BEAMS, HEADERS & GIRDER TRUSSES. PROVIDE BLOCKING BETWEEN JOISTS	ELEVATION NOTES
AS REQUIRED. - SEE SELECTION SHEET FOR SIZE AND STYLE OF FIREPLACE. SEE FIREPLACE ELEVATION DETAIL FOR ADDITIONAL FRAMING REQUIREMENTS, IF ANY. - CHECK SELECTION SHEETS FOR FLOOR COVERING AT TOP AND BOTTOM OF STAIR RISERS AND ADJUST RISERS AS REQ'D. - PROVIDE BLOCKING AT ALL HANDRAIL TERMINATION AND BRACKET LOCATIONS. - 20-MINUTE FIRE RATED DOOR BETWEEN GARAGE AND LIVING AREA. - EXTERIOR WALL TO BE 2x4 SPF STUD G AT 16" o.c. UNLESS OTHERWISE NOTED (10'-0" MAXIMUM UNBRACED WALL HEIGHT). - ALL EXTERIOR WALLS AND INTERIOR BEARING WALLS, FRAMED HIGHER THAN THE STANDARD PLATE HEIGHT, SHALL BE FRAMED WITH CONTINUOUS FULL HEIGHT STUDS TO THE HIGHEST CEILING (I.E. NO INTERMEDIATE BREAKS) TO PREVENT LATERAL HINGE CONDITIONS. - IN THE GARAGE, PROVIDE 1/2" GYP. BOARD AT ALL WALLS COMMON TO LIVING SPACE AND ALL STRUCTURAL MEMBERS SUPPORTING FLOOR/CEILING ASSEMBLY. GARAGE CEILING TO BE 1/2" SAG RESISTANT GYP. BOARD WHEN THERE ARE NO HABITABLE SPACES ABOVE, OR 5/8" TYPE X GYP. BOARD WHEN HABITABLE SPACES ARE ABOVE. - ALL EMERGENCY ESCAPE & RESCUE OPENINGS TO BE A MAXIMUM OF 44" OFF OF FINISHED FLOOR AND HAVE MINIMUM OPENING DIMENSIONS	<ul> <li>WINDOW STYLE AND MULLIONS MAY VARY FROM ELEVATION DEPENDING UPON MANUFACTURER, STYLE, PATTERN, TYPE, ETC.</li> <li>USE SECONDARY HEAT BARRIER ON ALL DIRECT VENT FIREPLACES 7' OR LESS ABOVE A WALKWAY.</li> <li>GRADE AWAY FROM FOUNDATION WALLS SHALL FALL A MINIMUM OF 6' WITHIN THE FIRST 10.</li> <li>PROVIDE TYVEK OR EQUIVALENT HOUSE WRAP BEHIND BRICK AND STONE VENEER OVER WOOD SHEATHING.</li> <li>PROVIDE DRICK WEEP HOLES AT 24" O.C. WITH BRICK VENEER AND MORTER NET BEHIND AND THROUGH WEEP HOLES.</li> <li>PROVIDE FLASHING AND WEEP HOLES ABOVE ALL BRICK ANGLE IRONS, BELOW ALL BRICK SILLS AND ABOVE SILL PLATE SEALERS.</li> <li>EXTERIOR STEPS TO HAVE A MAXIMUM 8' RISER. WHEN VERTICAL RISE EXCEEDS 30'' OR FOUR OR MORE CONTINUOUS RISERS, A HANDRAIL IS REQUIRED.</li> </ul>
OF 24" IN HEIGHT, 20" IN WIDTH, & HAVE A MINIMUM OPENING AREA OF 5.7 S.F. ALL DOORS TO BE 6'-8" TALL UNLESS OTHERWISE NOTED.	ROOF PLAN NOTES
<ul> <li>ALL GLASS IN INTERIOR AND EXTERIOR DOORS TO BE TEMPERED (INCLUDING SIDELITES AND TRANSOMS)</li> <li>ALL LUMBER CONTACTING CONCRETE TO BE PRESSURE TREATED.</li> <li>ALL FASTENERS, HANGERS, AND OTHER CONNECTORS TO BE USED WITH PRESSURE TREATED WOOD ARE TO HAVE ZMAX COATING (OR EQUIVALENT) HOT-DIPPED GALVANIZED OR STAINLESS STEEL.</li> <li>AT STAIR HANDRAIL, ON ONE SIDE ONLY, SHALL BE CONTINUOUS FOR THE ENTIRE LENGTH OF THE STAIRWAY, AND ENDS SHALL BE RETURNED TO A WALL OR POST. THE HANDRAIL MAY BE INTERRUPTED AT A NEWEL POST AT A TURN.</li> <li>ALL HANDRAIL GRIP PORTIONS SHALL NOT EXCEED 2-1/4" IN CROSS SECTIONAL DIMENSION.</li> <li>HANDRAILS SHALL BE INSTALLED ON ALL STAIRS WITH 2 OR MORE RISERS, HANDRAIL HEIGHTS SHALL BE A MINIMUM OF 34" AND A MAXIMUM OF 38".</li> <li>ALL STAIRS TO BE CONSTRUCTED SO AS NOT TO ALLOW A 4" SPHERE TO PASS THROUGH THE RISER.</li> <li>GUARDRAILS MUST BE A MINIMUM OF 36 HIGH. GUARDRAILS AT THE OPEN SIDES OF STAIRS MUST BE A MINIMUM OF 34" HIGH MEASURED VERTICALLY FROM THE NOSING AT THE TREADS. THE HORIZONTAL SPACING OF THE VERTICAL BALUSTERS SHALL BE 4" O.C.</li> <li>GUARDRAIL DESIGN TO RESIST A MINIMUM OF 200 IDS I ATERAL FORCE</li> </ul>	- ALL OVERHANGS TO HAVE (2) SOFFIT VENTS PER EACH 8' SOFFIT SECTION. - PROVIDE BAFFLES AT EXTERIOR TRUSS BEARING FOR VENTILATION. - PROVIDE 15# FELT PAPER UNDER SHINGLES.


- GUARDRAIL DESIGN TO RESIST A MINIMUM OF 200 LBS LATERAL FORCE

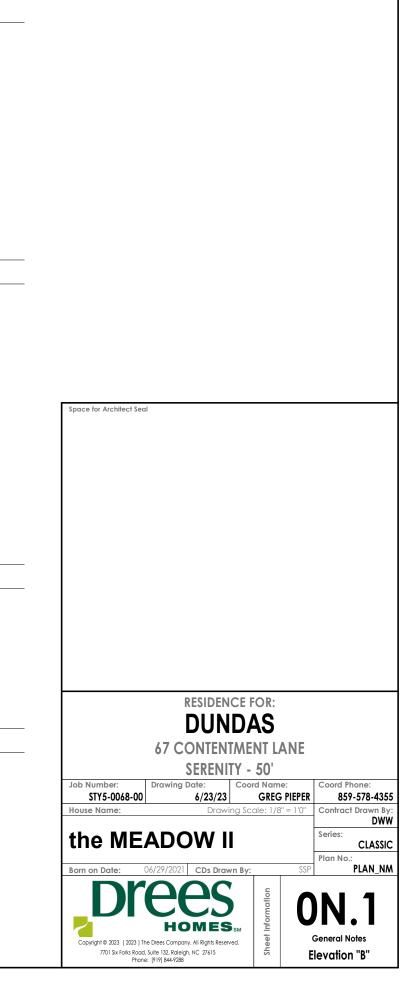

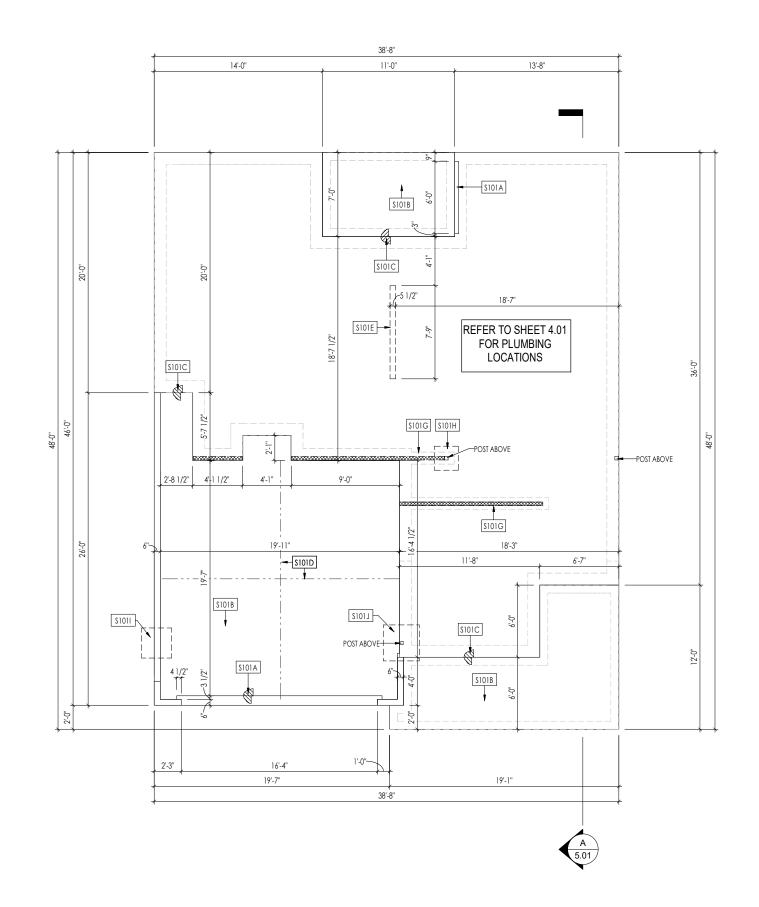

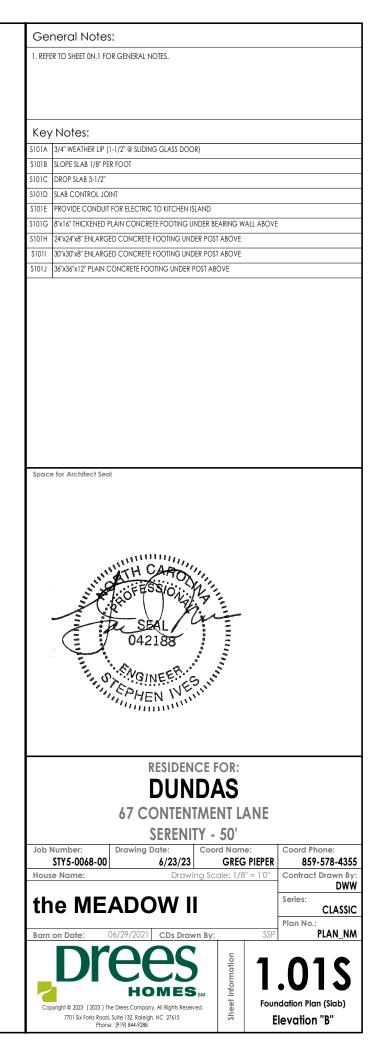

PROVIDE 8' TALL DO THROUGHOUT FIRST F U.N.O.

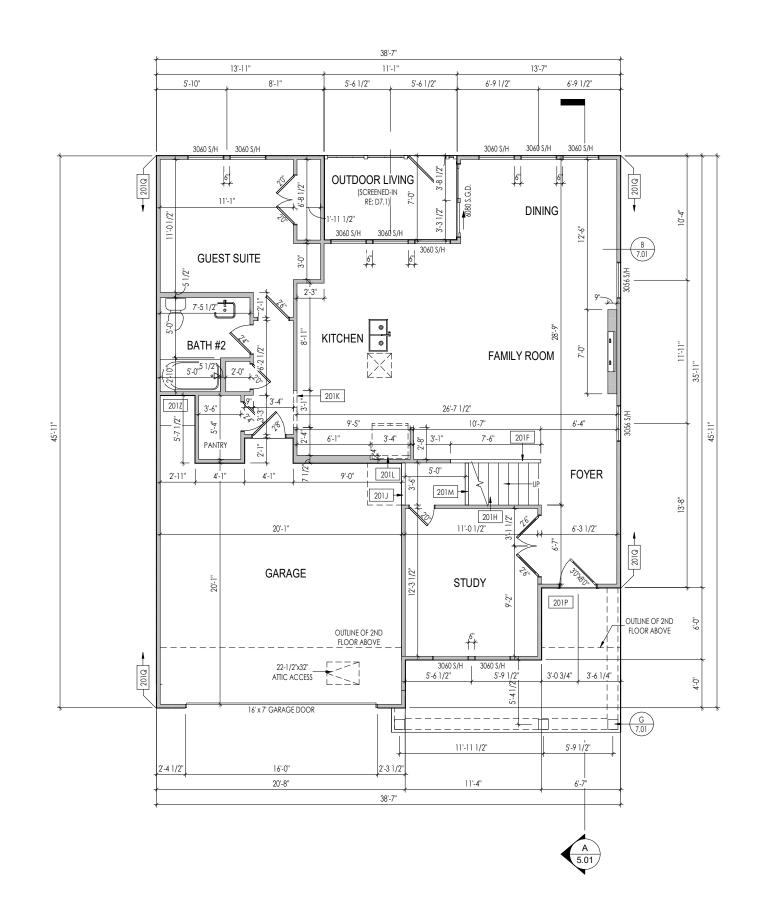


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## General Notes:

I. REFER TO SHEET ON.1 FOR GENERAL NOTES.
 2. ALL FIRST FLOOR CEILINGS TO BE 10°-1" ABOVE SUBFLOOR UNLESS OTHERWISE NOTED.
 3. FRAME TOP OF ALL WINDOWS AT 1°-10" BELOW TOP OF PLATE UNLESS OTHERWISE NOTED.
 4. ALL DROPPED, INTERIOR HEADERS (FALSE AND BEARING) ARE DROPPED 1°-3" FROM CEILING.
 5. REFER TO SELECTION SHEETS FOR FLOORING MATERIAL PRIOR TO CONSTRUCTING STAIRS TO DETERMINE
RISER HEIGHTS.
 6. REFER TO SHEET 2.01S FOR STRUCTURAL INFORMATION.

Key Notes:         2011       Spore MALL EVEN WITH TOP OF STAR STINNER; RAUNG ABOVE         2014       See Defail (F7.0) FOR STAR FRAMING Defails         2014       FARME TOP OF OPENING AT HIGHT SPECIFIED IN GENERAL NOTES ON THIS SHEET         2016       REFRIG: RADRE RIED TO 24 AF.F.         2010       RAPROX. LOCATION OF 36' HIGH WALL UNDER STARS /RELD VERIPY)         2017       CARPHITES TO BORP ELECTRICAL WISE INCOUGH PORCH CELING FOR LIGHTS         2019       PROVIDE 1/2' FIRE RATED PLYWOOD ON SIDE ELEVATIONS         2012       Is' HIGH WATER HEATER PLATFORM         RESIDENCE FOR: DUNDASS         OF Architect Seal         Space for Architect Seal         RESIDENCE FOR: DUNDASS         OF CONTENTION OF SERVICE SERVICE SERVICE SERVICE FOR:         DUNDASS         OF CONTENTION OF SERVICE SERVICE FOR:         DUNDASS         OF CONTENTMENT LANE         SERENITY - 50'         Job Number: BYS-0068-00         Drawing Date: 0/29/2021         Coord Name: 6/29/2021         Coord Name: Control Torwing Scale: 1/8'' = 10'         OF OWING Scale: 1/8'' = 10'         Drawing Scale: 1/8'' = 10' <th>UT NE</th> <th></th> <th></th>	UT NE		
2016       SLOPE WALL EVEN WITH TOP OF STARK STRINGER, RAUING ABOVE         2014       SEE DETAIL F/Z01 FOR STARK FRAMING DETAILS         2014       Y-71 1/Z HIGH WALL UNDER STARKS AROVE         2014       FRAME TOP OF OPENING AT HEIGHT SPECIPED IN GENERAL NOTES ON THIS SINEET         2014       FREME TOP OF OPENING AT HEIGHT SPECIPED IN GENERAL NOTES ON THIS SINEET         2014       FREME KHADE RHED TO G'F AF.F.         2014       PROXL LOCATION OF 36' HIGH WALL UNDER STARKS [PELD VERIPT)         2017       CARPENTER TO DROP ELECTRICAL WIRE THROUGH PORCH CELLING FOR LIGHTS         2010       PROVIDE 1/2' FIRE RATED PLYNOOD ON SIDE ELEVATIONS         2011       IP' HIGH WATER HEATER PLATFORM         Space for Architect Seal         Space for Architect Seal         RESIDENCE FOR: DUNDASS 67 CONTENTMENT LANE SERENTLY - 50'         Goord Name: 6/23/23         Coord Phone: 859-578-4355         Drowing Scale: 1/8' = 10'	Key	Notes:	
2014       SEE DEFAIL F/Z01 FOR STAR FRAMING DETAILS         2014       FY7-1 1/2* HIGH WALL UNDER STARS ADOVE         2014       FRAME TOP OF OPFINING AT HEIGH SPECIFICI IN GENERAL INOTES ON THIS SHEET         2014       REFRIG, HEADER HEID TO 4:4" A.F.F.         2010       PROVIDE 1/2" FIRE BATED PLYWOOD ON SIDE ELEVATIONS         2011       IF MIGH WATER HEATER PLATFORM         2012       IF MIGH WATER HEATER PLATFORM         2013       IF MIGH WATER HEATER PLATFORM         2014       IF MIGH WATER HEATER PLATFORM         2015       IF MIGH WATER HEATER PLATFORM         2016       RESIDENCE FOR:         DUNDDASS       6/7 CONTENTMENT LANE         Space for Archillect Seal       Sector Name:         2014       Drowing Date::       Coord Name:         2015       Drowing Date::       Coord Phone:         829:728-4355       Controct Drowing Brows:       Controct Drowing Wight = 10°			
2010       RAME TOP OF OPENING AT HEGHT SPECIFED IN GENERAL NOTES ON THIS SHEET         2011       REPRIC, IR-ADER HELD TO 6-6" A.F.F.         2014       CAPPROX, LOCATION OF 36" HIGH WALL UNDER STARS (FIELD VERFY)         2016       ROUDE (TERE ATED DEPOELCTERICAL WRE THROUGH PORCH CELUNG FOR LIGHTS         2010       REVIEW WOOD ON SIDE LELEVATIONS         2011       18" HIGH WATER HEATER PLATFORM         Space for Architect Seal         Space for Architect Seal         RESIDENCE FOR: DUNDASS 67 CONTENTMENT LANE SERENITY - 50'         Job Number: STYS-0068-00         Drawing Date: Drawing Scide: 1/8" = 10"         Coord Phone: 859-578-4355 Contract Drawing Scide: 1/8" = 10"         Drawing Date: Classic         Drawing Scide: 1/8" = 10"         Drawing Scide: 1/8" = 10"			
201       EFRIG. HEADER HELD 10 6*3" A.F.F.         201//       APPROX. LOCATION OF 36" HIGH WALL UNDER STAIRS (FIELD VERIFY)         201//       CARPENTER TO DROP ELECTRICAL WIE THROUGH PORCH CELLING FOR LIGHTS         201//       PROVIDE 1/2" FIRE RATED PLYWOOD ON SIDE ELEVATIONS         201//       IP HIGH WATER HEATER PLATFORM         Space for Architect Seal         Space for Architect Seal         RESIDENCE FOR: DUNDASS 67 CONTENTMENT LANE SERENITY - 50'         Job Number: STYS-50068-00         Strate Drawing Date: Drawing Scale: 1/8" = 10"         Coord Phone: 859-578-4355 House Name:         Drawing Scale: 1/8" = 10"	201 J	+/-7'-1 1/2" HIGH WALL UNDER STAIRS ABOVE	
2010       APPROX. LOCATION OF 35 HIGH WALL UNDER STARS (FIELD VERFY)         2017       CARPENTER TO DROP ELECTRICAL WIRE THROUGH PORCH CELLING FOR LIGHTS         2010       PROVIDE 1/2" FIRE RATED PLYWOOD ON SIDE ELEVATIONS         2012       18" HIGH WATER HEATER PLATFORM         Space for Architect Seal         Space for Architect Seal         RESIDENCE FOR: DUNDASS 67 CONTENTMENT LANE SERENTY - 50'         Job Number: STYS-0068-00         Drawing Date: Drawing Scale: 1/8" = 10"         Coord Phone: 859-578-8355 DOTAWING Scale: 1/8" = 10"         Drawing Scale: 1/8" = 10"	201K	FRAME TOP OF OPENING AT HEIGHT SPECIFIED IN GENERAL NOTES ON THIS SH	ET
201P       CARPENTER TO DROP ELECTRICAL WIRE THROUGH PORCH CELLING FOR LIGHTS         2012       PROVIDE 1/2" FIRE RATED PLYWOOD ON SIDE ELEVATIONS         2012       18" HIGH WATER HEATER PLATFORM         Space for Architect Seal         Space for Architect Seal         RESIDENCE FOR: DUNDASS 67 CONTENTMENT LANE SERENITY - 50'         Job Number: STY5-0068-00         Drawing Date: Orawing Scale: 1/8" = 10"         Coord Phone: 859-578-4355 Contract Provem Stry         MEEADOW II         Drawing Scale: 1/8" = 10"			
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RESIDENCE FOR: DUNDAS 67 CONTENTMENT LANE SERENITY - 50' Job Number: STY5-0068-00 House Name: Drawing Date: Coord Name: Coord Phone: B59-578-4355 GREG PIEPER B59-578-4355 GREG PIEPER B59-578-4355 Contract Drawn By: Drawing Scale: 1/8" = 10" Drawing Sca			
RESIDENCE FOR: DUNDAS 67 CONTENTMENT LANE SERENITY - 50'         Job Number: STY5-0068-00       Drawing Date: 6/23/23       Coord Name: GREG PIEPER       Coord Phone: 859-578-4355         House Name:       Drawing Date: 6/23/23       Coord Name: GREG PIEPER       Coord Phone: 859-578-4355         House Name:       Drawing Scale: 1/8" = 10"       Contract Drawn By: DWW         the MEADOW II       Classic Plan No.:			
RESIDENCE FOR: DUNDAS 67 CONTENTMENT LANE SERENITY - 50'         Job Number: STY5-0068-00       Drawing Date: 6/23/23       Coord Name: GREG PIEPER       Coord Phone: 859-578-4355         House Name:       Drawing Date: 6/23/23       Coord Name: GREG PIEPER       Coord Phone: 859-578-4355         House Name:       Drawing Scale: 1/8" = 10"       Contract Drawn By: DWW         the MEADOW II       Classic Plan No.:			
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DUNDAS 67 CONTENTMENT LANE SERENITY - 50'         Job Number: STY5-0068-00       Drawing Date: 6/23/23       Coord Name: GREG PIEPER       Coord Phone: 859-578-4355         House Name:       Drawing Scale: 1/8" = 1'0"       Contract Drawn By: DWW         the MEADOW II       Series: CLASSIC			
DUNDAS 67 CONTENTMENT LANE SERENITY - 50'         Job Number: STY5-0068-00       Drawing Date: 6/23/23       Coord Name: GREG PIEPER       Coord Phone: 859-578-4355         House Name:       Drawing Scale: 1/8" = 1'0"       Contract Drawn By: DWW         the MEADOW II       Series: CLASSIC			
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DUNDAS         67 CONTENTMENT LANE         SERENITY - 50'         Job Number:         STY5-0068-00         Coord Name:         Coord Name:         STY5-0068-00         Mouse Name:         Drawing Scale: 1/8" = 1'0"         Own         WWW         Series:         CLASSIC         Plan No.:			
DUNDAS 67 CONTENTMENT LANE SERENITY - 50'         Job Number: STY5-0068-00       Drawing Date: 6/23/23       Coord Name: GREG PIEPER       Coord Phone: 859-578-4355         House Name:       Drawing Scale: 1/8" = 1'0"       Contract Drawn By: DWW         the MEADOW II       Series: CLASSIC			
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DUNDAS         67 CONTENTMENT LANE         SERENITY - 50'         Job Number:         STY5-0068-00         Coord Name:         Coord Name:         STY5-0068-00         Mouse Name:         Drawing Scale: 1/8" = 1'0"         Own         WWW         Series:         CLASSIC         Plan No.:			
DUNDAS         67 CONTENTMENT LANE         SERENITY - 50'         Job Number:         STY5-0068-00         Coord Name:         Coord Name:         STY5-0068-00         Mouse Name:         Drawing Scale: 1/8" = 1'0"         Own         WWW         Series:         CLASSIC         Plan No.:			
DUNDAS         67 CONTENTMENT LANE         SERENITY - 50'         Job Number:         STY5-0068-00         Coord Name:         Coord Name:         STY5-0068-00         Mouse Name:         Drawing Scale: 1/8" = 1'0"         Own         WWW         Series:         CLASSIC         Plan No.:			
DUNDAS 67 CONTENTMENT LANE SERENITY - 50'         Job Number: STY5-0068-00       Drawing Date: 6/23/23       Coord Name: GREG PIEPER       Coord Phone: 859-578-4355         House Name:       Drawing Scale: 1/8" = 1'0"       Contract Drawn By: DWW         the MEADOW II       Series: CLASSIC			
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67 CONTENTMENT LANE SERENITY - 50'         Job Number: STY5-0068-00       Drawing Date: 6/23/23       Coord Name: GREG PIEPER       Coord Phone: 859-578-4355         House Name:       Drawing Scale: 1/8" = 1'0"       Contract Drawn By: DWW         the MEADOW II       Series: CLASSIC			
SERENITY - 50'           Job Number: STY5-0068-00         Drawing Date: 6/23/23         Coord Name: GREG PIEPER         Coord Phone: 859-578-4355           House Name:         Drawing Scale: 1/8" = 1'0"         Contract Drawn By: Drawing Scale: 1/8" = 1'0"         Contract Drawn By: DWW           the MEADOW II         Series: CLASSIC         CLASSIC			
Job Number: STY5-0068-00         Drawing Date: 6/23/23         Coord Name: GREG PIEPER         Coord Phone: 859-578-4355           House Name:         Drawing Scale: 1/8" = 1'0"         Contract Drawn By: Drawing Scale: 1/8" = 1'0"         Contract Drawn By: DWW           the MEADOW II         Series: CLASSIC         Classic		67 CONTENTMENT LANE	
Job Number: STY5-0068-00         Drawing Date: 6/23/23         Coord Name: GREG PIEPER         Coord Phone: 859-578-4355           House Name:         Drawing Scale: 1/8" = 1'0"         Contract Drawn By: Drawing Scale: 1/8" = 1'0"         Contract Drawn By: DWW           the MEADOW II         Series: CLASSIC         Classic		SERENITY - 50'	
STY5-0068-00         6/23/23         GREG PIEPER         859-578-4355           House Name:         Drawing Scale: 1/8" = 1'0"         Contract Drawn By: DWW           the MEADOW II         Series:           CLASSIC         Plan No.:	Job		Coord Phone:
the MEADOW II  Series: CLASSIC Plan No.:		STY5-0068-00 6/23/23 GREG PIEPER	
the MEADOW II Series: CLASSIC Plan No.:	Hou	<b>EXAMPLE</b> Drawing Scale: 1/8" = 1'0"	
	41-		
	tr		CLASSIC
DOILOU DUIC. UU/2//2021 CD3 DIUWIIDY. 331 ILAN_NM	Rom	on Date: 06/29/2021 CDs Drawn By: SSP	
	Dorn		
Copyright © 2023 (2023) The Drees Company. All Right Reserved. 701 Six Forks Rood, Suite 192, Religich, NC 27615			
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Copyright © 2023 (2023) The Drees Company. All Rights Reserved.	Co	pyright © 2023 (2023) The Drees Company. All Rights Reserved.	-
7701 Six Forks Road, Suite 132, Raleign, NC 27615 C Elevation "B"			ievation "B"

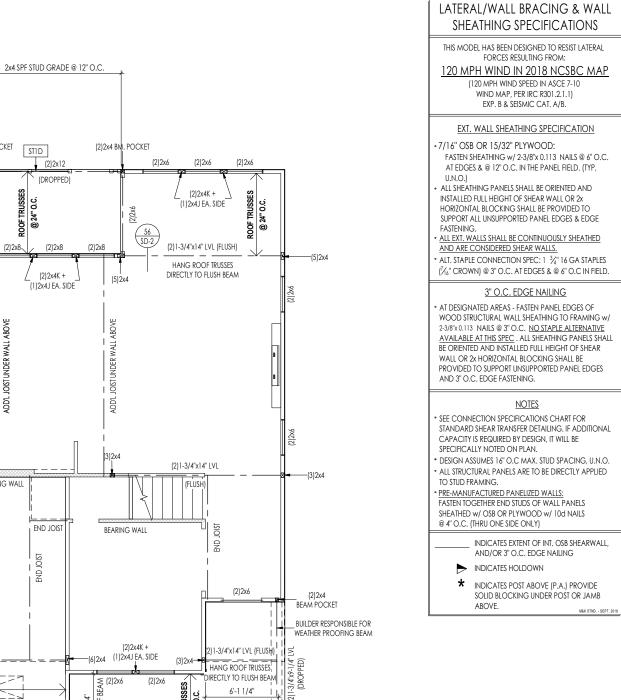

SIMPSON BC4 CAP

AND ABW44Z BASE

(1)2x4J EA. SIDE (2)1-3/4"x14" LVL (FLUSH) (2)2x8、 (2)2x8 (5)2x4<sup>.</sup> HANG ROOF TRUSSES DIRECTLY TO FLUSH BEAM (5)2x4 (2)2x4K + (1)2x4J EA. SIDE ABOVE INDER WALL 1.00 (2)2x10 (DROPPED) BEARING WALL (2)2x10 (DROPPED) BFARING WALL ABOVE END JOIST WALL IOIST JOIST UNDER 2 (72) SD-2) (2)1-3/4"x 24" LVL (5)2x4-(DROPPED) ROOF TRUSSES @ 24" 0.C. LIZJ TO FACE OF BEAM 9 <u>1</u> (2)2x12 STID 5'-6 ST1D (8) \_ (DROPPED)(2)2x10 <u>\_\_\_</u> 

(2)2x4 JACKS + (3)2x4 KINGS SIMPSON BCS2-2/4 CAP

AND ABW44Z BASE

(2)2x4 BM, POCKET STID


(2)2x4 JACKS + (3)2x4 KINGS

(2)2x6


(2)2x4K +

(2)2x6

1	General Notes:	
	1. REFER TO SHEET ON.1 FOR GENERAL NOTES.	
=		
	STID FRAME TOP OF BEAM AT 10'-1" ABOVE FIRST FLOOR SUBFLOOR/SLAB	
	CONNECTION SPECIFICATIONS (TYP. U.N.O.)	
	NOTE: 10d NAIL = 3" x 0.131" GUN NAIL	
	JOIST TO SOLE PLATE         (3)10d TOENAILS           SOLE PLATE TO JOIST/BLK'G.         10d NAILS @ 6" o.c.	
	STUD TO SOLE PLATE (3)10d TOENAILS	
	TOP OR SOLE PLATE TO STUD (3)10d NAILS	
	RIM TO TOP PLATE         10d TOENAILS @ 6" o.c.           BLK'G. BTWN. JOISTS TO TOP PL.         (3)10d TOENAILS	
	RAFTER/TRUSS TO TOP PLATE (3)10d TOENAILS + (1) SIMPSON H2.5A	
	GAB. END TRUSS TO DBL. TOP PL. 10d TOENAILS @ 8" o.c.	
	R.T. w/ HEEL HT. 9 ¼" TO 12" 2x10 BLK EVERY 3RD BAY FASTENED TO DBL. TOP PLATE w/ 10d TOENAILS @ 6" O.C.	
	R.T. w/ HEEL HT. 12" TO 16" 2x12 BLK EVERY 3RD BAY FASTENED TO DBL. TOP PLATE w/ 10d TOENAILS @ 6" O.C.	
	R.T. w/ HEEL HT. UP TO 24" LAP WALL SHTG. w/ DBL. TOP PL. & INSTALL ON TRUSS VERT FASTEN w/ 8d NAILS @ 6" O.C. LAP WALL SHTG. w/ DBL. TOP PL. & INSTALL ON TRUSS VERT	
	R.T. w/ HEEL HT. 24" TO 48" LAP WALL SHID. W DEL. TO FL & INSTALL ON IROSS VERT - FASTER W/ 8d NAILS @ 6" O.C. PROVIDE 2x BLK @ EA. BAY AT TOP OF HEEL	
	DOUBLE STUD 10d NAILS @ 24" o.c.	
	DOUBLE TOP PLATE 10d NAILS @ 24" o.c. DOUBLE TOP PLATE LAP SPLICE (10)10d NAILS IN LAPPED AREA	
	TOP PLATE LAP @ CORNERS & (2)10d NAILS	
	INTERSECTING WALLS WALL TO FOUNDATION WALL SHTG. LAP w/ SILL PL. & FASTENED PER SHEAR WALL	
	FASTENING SPEC. Space for Architect Seal	
	TH CARO	
	SEAL 042188	
	RESIDENCE FOR: DUNDAS 67 CONTENTMENT LANE SERENITY - 50'	
	RESIDENCE FOR: DUNDAS 67 CONTENTMENT LANE SERENITY - 50' Job Number: STY5-0068-00 6/23/23 GREG PIEPER Coord Phone: 859-578-4:	
	RESIDENCE FOR: DUNDAS 67 CONTENTMENT LANE SERENITY - 50' Job Number: STY5-0068-00 Drawing Date: Coord Name: Coord Phone: 859-578-4: House Name: Drawing Scale: 1/8" = 10"	
	RESIDENCE FOR: DUNDAS 67 CONTENTMENT LANE SERENITY - 50' Job Number: STY5-0068-00 6/23/23 House Name: Drawing Date: STY5-0068-00 6/23/23 Coord Name: Coord Phone: 859-578-42 Contract Drawing Scale: 1/8" = 10" Contract Drawing Scale: 1/8" = 10" Contract Drawing Scale: 1/8" = 10" Contract Drawing Scale: 1/8" = 10" Contract Drawing Series: CLAS	By: NW
	RESIDENCE FOR: DUNDAS 67 CONTENTMENT LANE SERENITY - 50' Job Number: STY5-0068-00 6/23/23 Drawing Date: Coord Name: Coord Phone: 859-578-43 Contract Drawing Scale: 1/8" = 10" Contract Drawing Scale: 1/8" = 10" Contract Drawing Scale: 1/8" = 10" Series:	By: NW
	RESIDENCE FOR: DUNDAS 67 CONTENTMENT LANE STY5-0068-00 6/23/23 GREG PIEPER STY5-0068-00 6/23/23 GREG PIEPER STY5-0068-00 6/23/23 GREG PIEPER STY5-0068-00 6/23/23 GREG PIEPER STY5-0068-00 6/23/23 GREG PIEPER STY5-0068-00 Contract Drawn Drawing Scale: 1/8" = 10" Contract Drawn Contract Drawn Cont	
	RESIDENCE FOR: DUNDAS 67 CONTENTMENT LANE STY5-0068-00 6/23/23 Cord Name: STY5-0068-00 6/23/23 Cord Name: Coord Phone: STY5-0068-00 6/23/23 Coord Name: Coord Phone: STY5-0068-00 Contract Drawn Drawing Scale: 1/8" = 10" Contract Drawn Drawing Scale: 1/8" = 10" Contract Drawn Drawing Scale: 1/8" = 10" Contract Drawn Drawn Series: CLAS: Plan No.: Plan No.:	

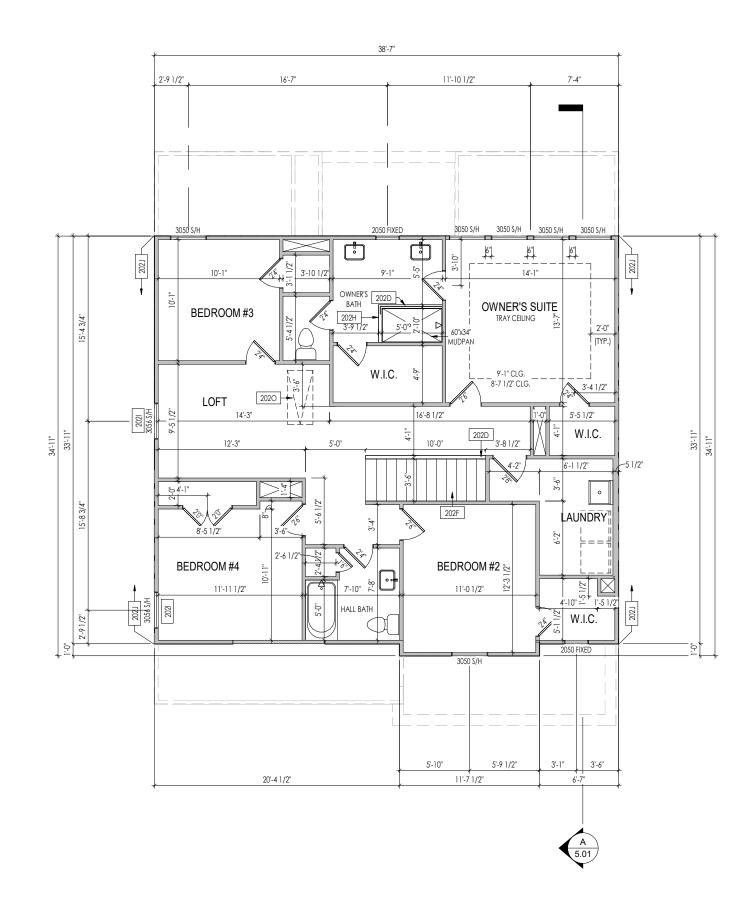


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Ge	neral Notes:		
	1, REFER TO SHEET 0N,1 FOR GENERAL NOTES.		
2. ALL SECOND FLOOR CEILINGS TO BE 9'-1" ABOVE SUBFLOOR UNLESS OTHERWISE NOTED.			
	<ol> <li>FRAME TOP OF ALL WINDOWS AT 1'-0 1/4" BELOW TOP OF PLATE UNLESS OTHERWISE NOTED.</li> <li>ALL DROPPED, INTERIOR HEADERS (FALSE AND BEARING) ARE DROPPED 1'-0" FROM CEILING.</li> </ol>		
5. REF	ER TO SELECTION SHEETS FOR FLOORING MATERIAL PRIOR TO CONSTRUCT		
	HEIGHTS. ER TO SHEET 2.02S FOR STRUCTURAL INFORMATION.		
Key	y Notes:		
202D	36" HIGH WALL		
202F	SEE DETAIL F/7.01 FOR STAIR FRAMING DETAILS		
202H	PROVIDE 4-1/2" SHOWER CURB		
2021	FRAME TOP OF WINDOWS AT 0'6-1/2" BELOW TOP OF PLATE		
202J	PROVIDE 1/2" FIRE RATED PLYWOOD ON SIDE ELEVATIONS		
2020	PULL DOWN ATTIC ACCESS STAIRS (25-1/2" x 54") WITH LIGHT AND OUTLET		
I			
Spac	e for Architect Seal		
	RESIDENCE FOR:		
	DUNDAS		
	67 CONTENTMENT LANE		
I	SERENITY - 50'		
	· · · · · · · · · · · · · · · · · · ·	Coord Dir - 1	
Jop	Number:         Drawing Date:         Coord Name:           STY5-0068-00         6/23/23         GREG PIEPER	Coord Phone: 859-578-4355	
Нои	SITS-0000-00         6/23/23         GREG FIELEN           se Name:         Drawing Scale: 1/8" = 1'0"	Contract Drawn By:	
		DWW	
+  -	ne MEADOW II	Series:	
lu		CLASSIC	
Borr	on Date: 06/29/2021 CDs Drawn By: SSF	Plan No.: PLAN_NM	
BOLL	on Date: 06/29/2021 CDs Drawn By: SSF	I LAN_NM	
I			
I		<b>02</b> F	
	pright © 2023 (2023 ) The Drees Company. All Rights Reserved. 7701 Six Forks Road, Suite 132, Reliedin, NC 27615	nd Floor Framing Plan	
Co	pyright © 2023 (2023 ) The Drees Company. All Rights Reserved. 7701 Six Forks Road, Suite 132, Raleigh, NC 27615	Elevation "B"	
1	Phone: [919] 844-9288		

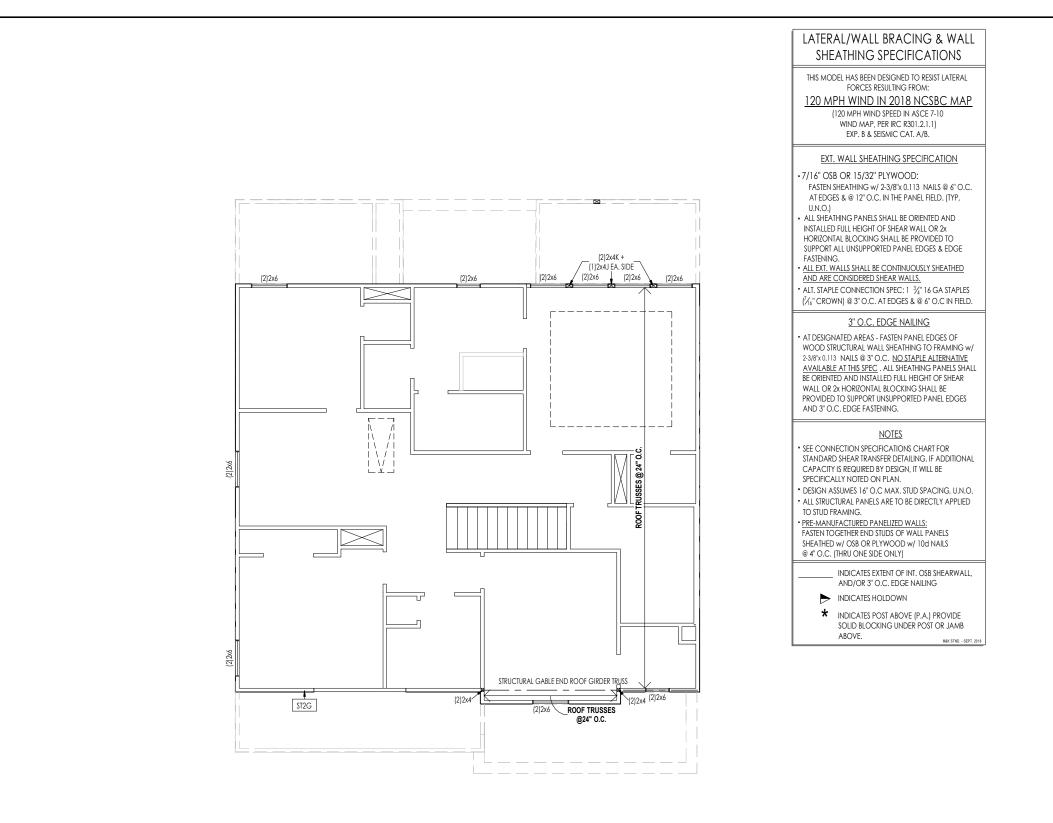

General Notes:		
1. REFER TO SHEET ON.1 FOR GENERAL NOTES.		
Key Notes:		
	LOW ROOF TRUSSES DOWN TO SECOND FLOOR SOLE PLATE (TYP.)	
CONNECTION SPE		
	E: 10d NAIL = 3" x 0.131" GUN NAIL	
JOIST TO SOLE PLATE SOLE PLATE TO JOIST/BLK'G.	(3)10d TOENAILS 10d NAILS @ 6" o.c.	
STUD TO SOLE PLATE	(3)10d TOENAILS	
TOP OR SOLE PLATE TO STUD	(3)10d NAILS	
RIM TO TOP PLATE	10d TOENAILS @ 6" o.c.	
BLK'G. BTWN. JOISTS TO TOP PL.	(3)10d TOENAILS	
RAFTER/TRUSS TO TOP PLATE	(3)10d TOENAILS + (1) SIMPSON H2.5A	
GAB. END TRUSS TO DBL. TOP PL.	10d TOENAILS @ 8" o.c.	
R.T. w/ HEEL HT. 9 ½" TO 12"	2x10 BLK EVERY 3RD BAY FASTENED TO DBL. TOP PLATE w/ 10d TOENAILS @ 6" O.C.	
R.T. w/ HEEL HT. 12" TO 16"	2x12 BLK EVERY 3RD BAY FASTENED TO DBL. TOP PLATE w/ 10d TOENAILS @ 6" O.C.	
R.T. w/ HEEL HT. UP TO 24"	LAP WALL SHTG. w/ DBL. TOP PL. & INSTALL ON TRUSS VERT FASTEN w/ 8d NAILS @ 6" O.C.	
R.T. w/ HEEL HT. 24" TO 48"	LAP WALL SHTG. w/ DBL. TOP PL. & INSTALL ON TRUSS VERT FASTEN w/ 8d NAILS @ 6" O.C. PROVIDE 2x BLK @ EA. BAY AT TOP OF HEEL	
DOUBLE STUD	10d NAILS @ 24" o.c.	
DOUBLE TOP PLATE	10d NAILS @ 24" o.c.	
DOUBLE TOP PLATE LAP SPLICE	(10)10d NAILS IN LAPPED AREA	
TOP PLATE LAP @ CORNERS & INTERSECTING WALLS	(2)10d NAILS	
WALL TO FOUNDATION	WALL SHTG. LAP W/ SILL PL. & FASTENED PER SHEAR WALL FASTENING SPEC.	
Space for Architect Seal	TH CARO	
	SEAL 042188	



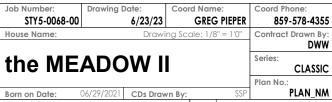


Second Floor Structural Plan

Elevation "B"

HOMES

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HEEL CUT STANDARDS			
OVERHANG			
		1'-0"	2'-0"
	4:12	3-3/4"	7-3/4"
	5:12	4-3/4"	9-3/4"
	6:12	5-3/4"	11-3/4"
F	7:12	6-3/4"	13-3/4"
ROOF PITCH	8:12	7-3/4"	N/A
	9:12	8-3/4"	N/A
	10:12	9-3/4"	N/A
	12:12	11-3/4"	N/A
	14:12	13-3/4"	N/A

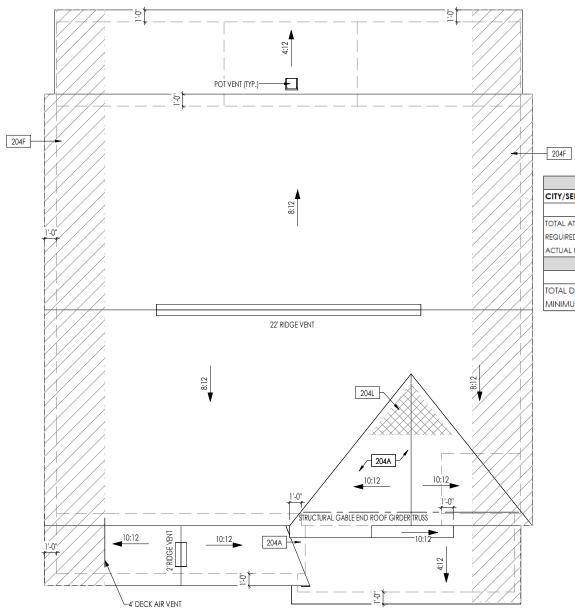

ROOF VENTILATION			
CITY/SERIES:	RALEIGH		
	MAIN HOUSE	LOWER	GARAGE
TOTAL ATTIC AREA:	1,478	310	123
REQUIRED NET FREE VENTILATION (ATTIC AREA/300):	4.93	1.03	0.41
ACTUAL NET FREE VENTILATION (UPPER + LOWER):	5.44	3.46	0.57
DOWNSPOUT CALCULATION			
	MAIN HOUSE	LOWER	GARAGE
TOTAL DRAINABLE ROOF AREA:	1921.4	403	159.9
MINIMUM # OF DOWNSPOUTS:	4	1	1


. REFER TO SHEET 0N.1 FOR GENERAL NOTES.


Key Notes:


204A VALLEY TRUSS OVER FRAMING @ 24" O.C.


204F 4'-0"(MIN.) OF FIRE RETARDENT TREATED ROOF SHEATHING. NO PENETRATION ALLOWED WITHEN 4' OF EXTERIOR WALL - SEE DETAIL A/7.03 FOR FIRE BLOCKING AT SOFFIT 204L NO ROOF DECKING UNDER OVERFRAMING IN THIS AREA TO ALLOW FOR PROPER ATTIC VENTILATION


CONNECTION SPEC	CIFICATIONS (TYP. U.N.O.)			
NOTE: 10d NAIL = 3" x 0.131" GUN NAIL				
JOIST TO SOLE PLATE	(3)10d TOENAILS			
SOLE PLATE TO JOIST/BLK'G.	10d NAILS @ 6" o.c.			
STUD TO SOLE PLATE	(3)10d TOENAILS			
TOP OR SOLE PLATE TO STUD	(3)10d NAILS			
RIM TO TOP PLATE	10d TOENAILS @ 6" o.c.			
BLK'G. BTWN. JOISTS TO TOP PL.	(3)10d TOENAILS			
RAFTER/TRUSS TO TOP PLATE	(3)10d TOENAILS + (1) SIMPSON H2.5A			
GAB. END TRUSS TO DBL. TOP PL.	10d TOENAILS @ 8" o.c.			
R.T. w/ HEEL HT. 9 ½" TO 12"	2x10 BLK EVERY 3RD BAY FASTENED TO DBL. TOP PLATE w/ 10d TOENAILS @ 6" O.C.			
R.T. w/ HEEL HT. 12" TO 16"	2x12 BLK EVERY 3RD BAY FASTENED TO DBL. TOP PLATE w/ 10d TOENAILS @ 6" O.C.			
R.T. w/ HEEL HT. UP TO 24"	LAP WALL SHTG. W/ DBL. TOP PL. & INSTALL ON TRUSS VERT FASTEN W/ 8d NAILS @ 6" O.C.			
R.T. w/ HEEL HT. 24" TO 48"	LAP WALL SHTG. w/ DBL. TOP PL. & INSTALL ON TRUSS VERT FASTEN w/ 8d NAILS @ 6" O.C. PROVIDE 2x BLK @ EA. BAY AT TOP OF HEEL			
DOUBLE STUD	10d NAILS @ 24" o.c.			
DOUBLE TOP PLATE	10d NAILS @ 24" o.c.			
DOUBLE TOP PLATE LAP SPLICE	(10)10d NAILS IN LAPPED AREA			
TOP PLATE LAP @ CORNERS & INTERSECTING WALLS	(2)10d NAILS			
WALL TO FOUNDATION	WALL SHTG. LAP W/ SILL PL. & FASTENED PER SHEAR WALL FASTENING SPEC.			
Space for Architect Seal				

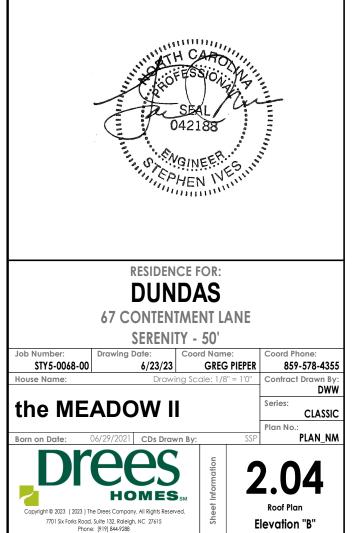


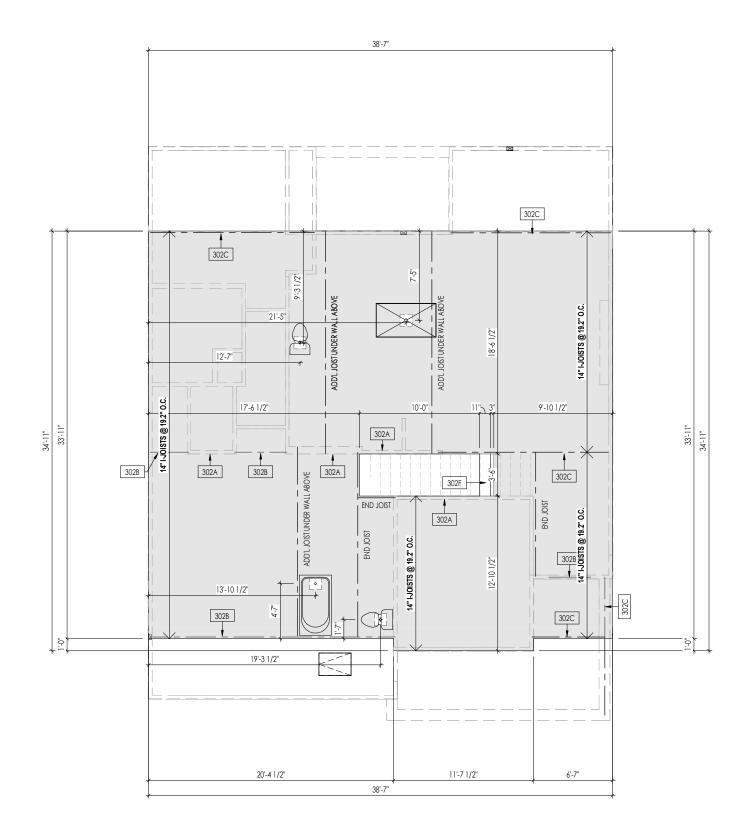


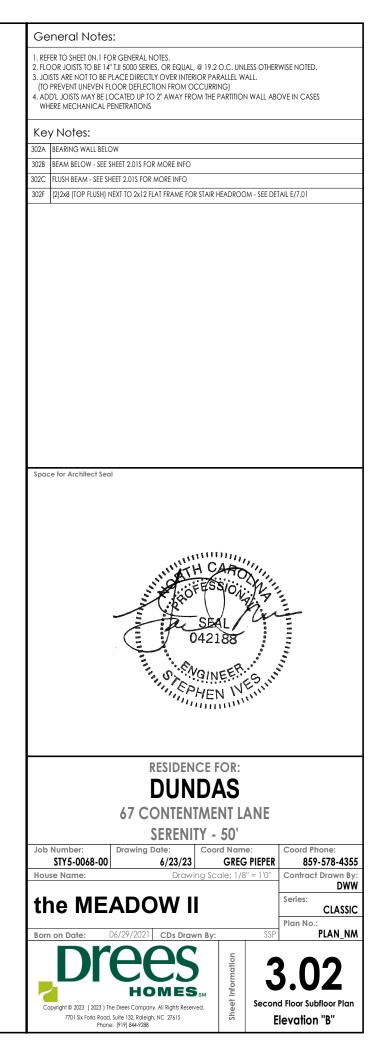

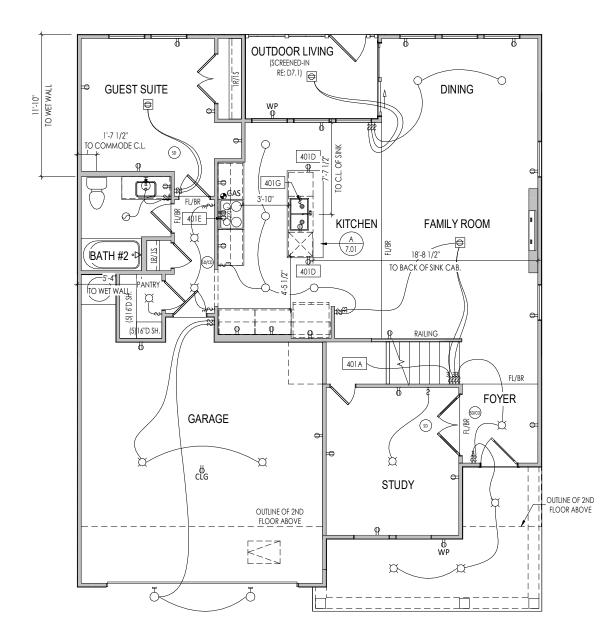

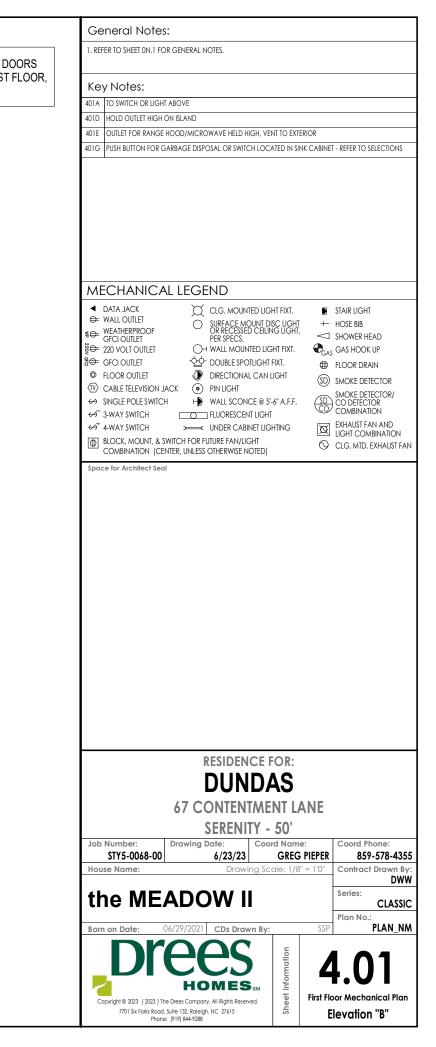

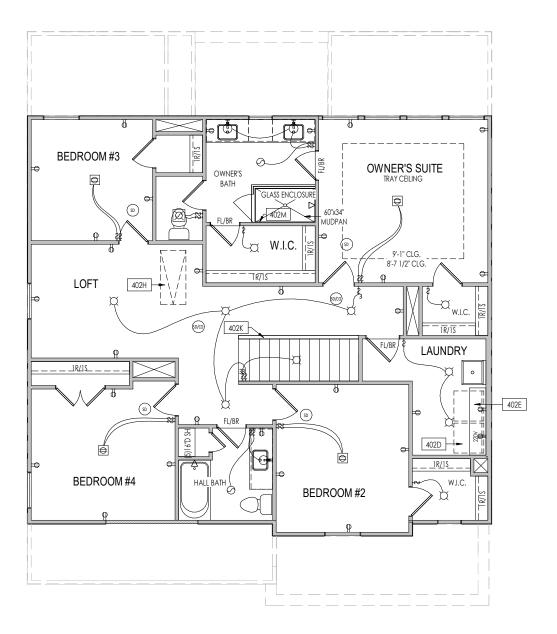

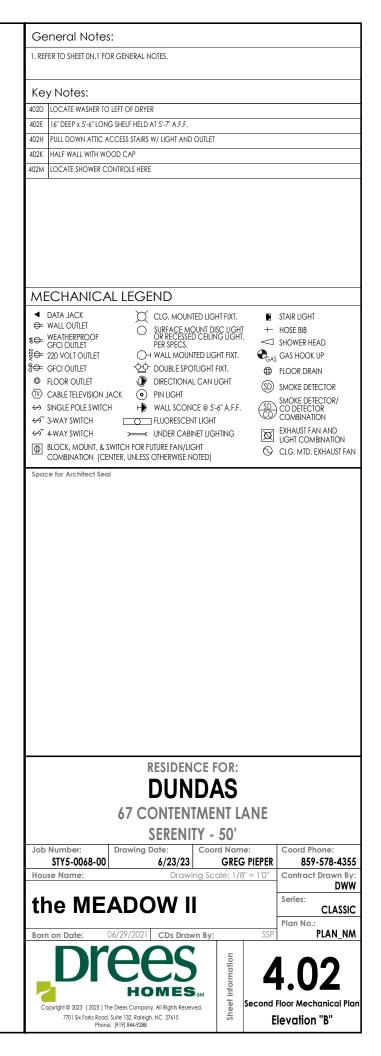





General Notes:
1. REFER TO SHEET ON.1 FOR GENERAL NOTES.
Key Notes:
Space for Architect Seal
RESIDENCE FOR:
DUNDAS
67 CONTENTMENT LANE

SERENITY - 50' Coord Name: Coord Phone: Job Number: Drawing Date: STY5-0068-00 GREG PIEPER 859-578-4355 6/23/23 Drawing Scale: 1/8" = 1'0" Contract Drawn By: House Name: the **MEADOW** II Series: CLASSIC Plan No.: PLAN\_NM Born on Date: 06/29/2021 CDs Drawn By: SSP 5.0 2 HOMES **Building Section** 

Sh

Elevation "B"

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ELEVATION "A"

### General Notes:

. REFER TO SHEET 0N.1 FOR GENERAL NOTES. 2. ROOFING MATERIAL PER SELECTIONS. 3. CONTACT M&K ENGINEERING FOR HEADER SIZE/BRICK SUPPORT IF GRADE DROPS AND THE AMOUNT OF BRICK OVER GARAGE DOOR SHOWN ON CURRENT ELEVATION IS NO LONGER ACCURATE

Key Notes:

## BRICK VENEER LINTEL SCHEDULE


SPAN	STEEL ANGLE SIZE	HEIGHT OF VENEER ABOVE LINTEL
Up to 3'-6"	L3-1/2 x3-1/2 x1/4	20 FT. MAX
Up to 6'-0"	L5x 3- 1/2x 5/16 (LLV)	20 FT. MAX
Up to 8'-0"	L6x 3- 1/2x 3/8 (LLV)	20 FT. MAX
9'-0''	L7x 4x 3/8 (LLV)	12 FT. MAX
*16'-0"	L7x 4x 3/8 (LLV)	3 FT. MAX
*16'-0"	L8x 4x 1/2 (LLV)	4-1/2 FT. MAX

ALL LINTELS <=6' SHALL HAVE 4" MINIMUM BEARING AT EACH END. ALL LINTELS >=6' SHALL HAVE 8" MINIMUM BEARING AT EACH END.

\* FASTENED TO HDR @ 1/3 SPAN POINTS THRU 1-1/2 "LONG VERTICALLY SLOTTED HOLES IN LINTEL w/ 1/2" DIA. x 3-1/2 " LONG LAG SCREWS. LOCATE LAG SCREWS @ MIDDLE OF SLOTTED HOLE & TIGHTEN SCREWS ENOUGH TO ALLOW MOVEMENT OF LINTEL.

\*\*ANY LINTEL CONDITION NOT SPECIFIED ABOVE SHALL BE DESIGNED

Space for Architect Seal

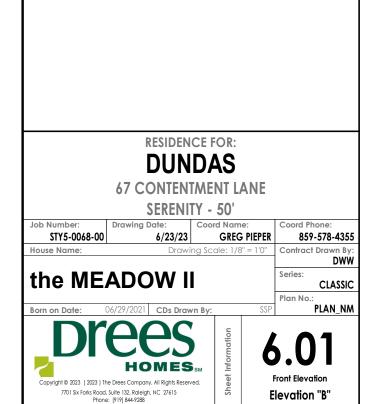





	General Notes:	
_	1. REFER TO SHEET ON.1 FOR GENERAL NOTES. 2. ROOFING MATERIAL PER SELECTIONS.	
	3. REFER TO LINTEL SCHEDULE AS NEEDED ON SHEET 6.01. Key Notes:	
TED)		
	Space for Architect Seal	
	RESIDENCE FOR:	
	residence for: <b>DUNDAS</b>	
	DUNDAS 67 CONTENTMENT LANE	
	DUNDAS	e:
	DUNDAS 67 CONTENTMENT LANE SERENITY - 50' Job Number: Drawing Date: Coord Name: Coord Phon STY5-0068-00 6/23/23 GREG PIEPER 859-57	/8-4355
	DUNDAS         67 CONTENTMENT LANE         SERENITY - 50'         Job Number:       Drawing Date:       Coord Name:       Coord Phon         STY5-0068-00       6/23/23       GREG PIEPER       859-57         House Name:       Drawing Scale: 1/8" = 1'0"       Contract Drawing Scale: 1/8" = 1'0"	/8-4355
	DUNDAS         67 CONTENTMENT LANE         SERENITY - 50'         Job Number:       Drawing Date:       Coord Name:       Coord Phon         STY5-0068-00       6/23/23       GREG PIEPER       859-57         House Name:       Drawing Scale: 1/8" = 10"       Contract Drawing Scale: 1/8" = 10"         the MEADOW II       Series:       Correct Drawing Scale: 1/8" = 10"	78-4355 awn By: DWW
	DUNDAS 67 CONTENTMENT LANE SERENITY - 50'         Job Number: STY5-0068-00       Drawing Date: 6/23/23       Coord Name: GREG PIEPER       Coord Phon 859-57         House Name:       Drawing Date: 6/23/23       Coord Name: GREG PIEPER       Coord Phon 859-57         House Name:       Drawing Scale: 1/8" = 1'0"       Contract Drawing Scale: 1/8" = 1'0"         the MEADOW II       Series:       C         Born on Date:       06/29/2021       CDs Drawn By:       SSP       PL	78-4355 awn By: DWW
	DUNDAS 67 CONTENTMENT LANE SERENITY - 50'         Job Number: STY5-0068-00       Drawing Date: 6/23/23       Coord Name: GREG PIEPER       Coord Phon 859-57         House Name:       Drawing Date: 6/23/23       Coord Name: GREG PIEPER       Coord Phon 859-57         House Name:       Drawing Scale: 1/8" = 1'0"       Contract Drawing Scale: 1/8" = 1'0"         the MEADOW II       Series:       C         Born on Date:       06/29/2021       CDs Drawn By:       SSP       PL	28-4355 awn By: DWW LASSIC
	DUNDAS         67 CONTENTMENT LANE         SERENITY - 50'         Job Number:       Drawing Date:       Coord Name:       Coord Phon         STY5-0068-00       6/23/23       GREG PIEPER       859-57         House Name:       Drawing Scale: 1/8" = 1'0"       Contract Drawing Scale: 1/8" = 1'0"         the MEADOW II       Series:       Cord Plan No.:	28-4355 awn By: DWW LASSIC AN_NM





<b>N</b> :	General Notes:
<u></u>	1. REFER TO SHEET ON.1 FOR GENERAL NOTES. 2. ROOFING MATERIAL PER SELECTIONS. 3. REFER TO LINTEL SCHEDULE AS NEEDED ON SHEET 6.01.
NOTED)	Key Notes:
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	Space for Architect Seal
	RESIDENCE FOR:
	DUNDAS
	67 CONTENTMENT LANE
	67 CONTENTMENT LANE SERENITY - 50' Job Number: Drawing Date: Coord Name: Coord Phone:
	67 CONTENTMENT LANE           SERENITY - 50'           Job Number:         Drawing Date:         Coord Name:         Coord Phone:           STY5-0068-00         6/23/23         GREG PIEPER         859-578-433           House Name:         Drawing Scale: 1/8" = 1'0"         Contract Drawn B
	67 CONTENTMENT LANE SERENITY - 50'         Job Number: STY5-0068-00       Drawing Date: 6/23/23       Coord Name: GREG PIEPER       Coord Phone: 859-578-433         House Name:       Drawing Scale: 1/8" = 10"       Contract Drawn B DW         thouse Name:       Drawing Scale: 1/8" = 10"       Contract Drawn B DW
	67 CONTENTMENT LANE       SERENITY     - 50'       Job Number:     Drawing Date:     Coord Name:     Coord Phone:       STY5-0068-00     6/23/23     GREG PIEPER     859-578-433       House Name:     Drawing Scale: 1/8" = 1'0"     Contract Drawn B
	67 CONTENTMENT LANE SERENITY - 50'         Job Number: STY5-0068-00       Drawing Date: 6/23/23       Coord Name: GREG PIEPER       Coord Phone: 859-578-435         House Name:       Drawing Scale: 1/8" = 1'0"       Contract Drawn By: Drawing Scale: 1/8" = 1'0"       Contract Drawn By: Drawing Scale: 1/8" = 1'0"       Contract Drawn By: Drawing Scale: 1/8" = 1'0"         the MEADOW II       Series: CLASSI         Born on Date:       06/29/2021       CDs Drawn By:       SSP
	67 CONTENTMENT LANE SERENITY - 50'         Job Number: STY5-0068-00       Drawing Date: 6/23/23       Coord Name: GREG PIEPER       Coord Phone: 859-578-435         House Name:       Drawing Scale: 1/8" = 1'0"       Contract Drawn By: Drawing Scale: 1/8" = 1'0"       Contract Drawn By: Drawing Scale: 1/8" = 1'0"       Contract Drawn By: Drawing Scale: 1/8" = 1'0"         the MEADOW II       Series: CLASSI         Born on Date:       06/29/2021       CDs Drawn By:       SSP
	67 CONTENTMENT LANE SERENITY - 50'         Job Number: STY5-0068-00       Drawing Date: 6/23/23       Coord Name: GREG PIEPER       Coord Phone: 859-578-432         House Name:       Drawing Scale: 1/8" = 10"       Contract Drawn B DW       Contract Drawn B DW         the MEADOW II       Series: CLASSI       CLASSI         Born on Date:       06/29/2021       CDs Drawn By:       SSP

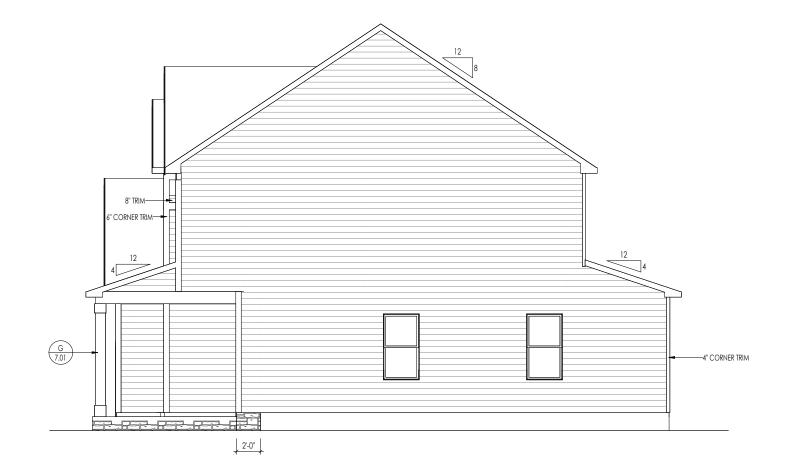

И:	General Notes:	
<u></u>	1. REFER TO SHEET 0N.1 FOR GENERAL NOTES. 2. ROOFING MATERIAL PER SELECTIONS. 3. REFER TO LINTEL SCHEDULE AS NEEDED ON SHEET 6.01.	
NOTED)	Key Notes:	
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	Space for Architect Seal	
	space for Architect seal	
	DUNDAS	
	DUNDAS 67 CONTENTMENT LANE SERENITY - 50' Job Number: Drawing Date: Coord Name: Coord Phone: STY5-0068-00 6/23/23 GREG PIEPER 859-578-43	
	Job Number:       Drawing Date:       Coord Name:       Coord Phone:         STY5-0068-00       6/23/23       GREG PIEPER       859-578-43         House Name:       Drawing Scale: 1/8" = 1'0"       Contract Drawn I	By:
	DUNDAS         67 CONTENTMENT LANE         SERENITY - 50'         Job Number:       Drawing Date:         STY5-0068-00       6/23/23         House Name:       Drawing Scale: 1/8" = 1'0"	By: VW
	DUNDAS 67 CONTENTMENT LANE SERENITY - 50'         Job Number: STY5-0068-00       Drawing Date: 6/23/23       Coord Name: GREG PIEPER       Coord Phone: 859-578-43         House Name:       Drawing Scale: 1/8" = 1'0"       Contract Drawn I Drawing Scale: 1/8" = 1'0"       Contract Drawn I Drawing Scale: 1/8" = 1'0"         the MEADOW II       Series: CLASS         Born on Date:       06/29/2021       CDs Drawn By:       SSP	By: WW
	DUNDAS 67 CONTENTMENT LANE SERENITY - 50'         Job Number: STY5-0068-00       Drawing Date: 6/23/23       Coord Name: GREG PIEPER       Coord Phone: 859-578-43         House Name:       Drawing Scale: 1/8" = 1'0"       Contract Drawn I Drawing Scale: 1/8" = 1'0"       Contract Drawn I Drawing Scale: 1/8" = 1'0"         the MEADOW II       Series: CLASS         Born on Date:       06/29/2021       CDs Drawn By:       SSP	By: WW
	DUNDAS         67 CONTENTMENT LANE         SERENITY - 50'         Job Number:       Drawing Date:         STY5-0068-00       6/23/23         GREG PIEPER       859-578-43         House Name:       Drawing Scale: 1/8" = 1'0"         Contract Drawing       Contract Drawing         Method Methods       Contract Drawing         Series:       Class         Plan No.:       Plan No.:	By: WW

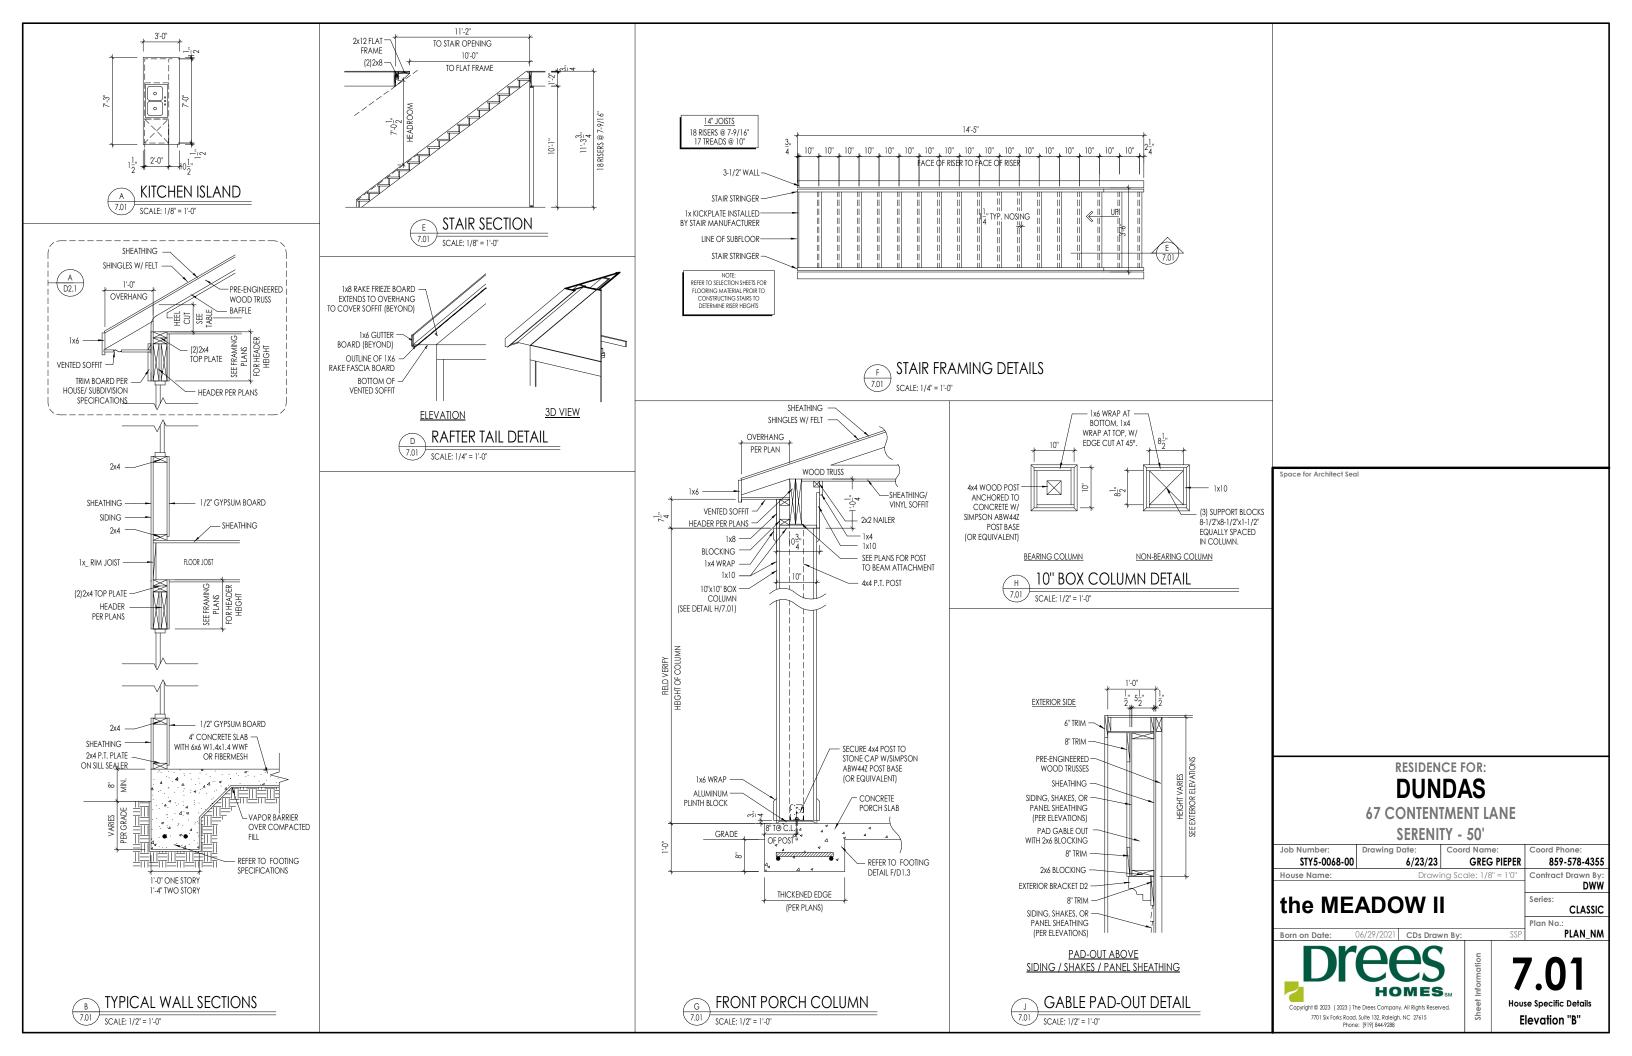


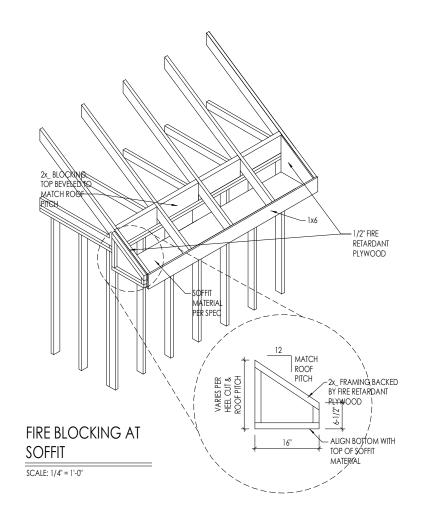


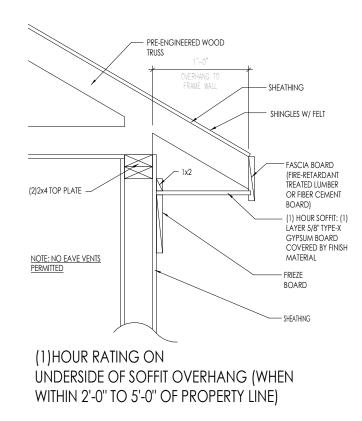

SCALE: 1" = 1'-0"

A SOFFIT FIRE BLOCKING DETAILS SCALE: 1/4" = 1'-0"

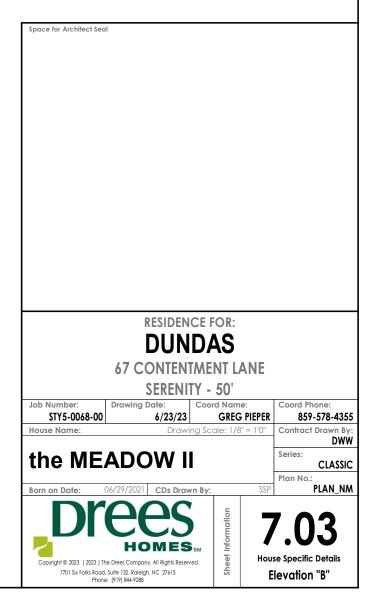

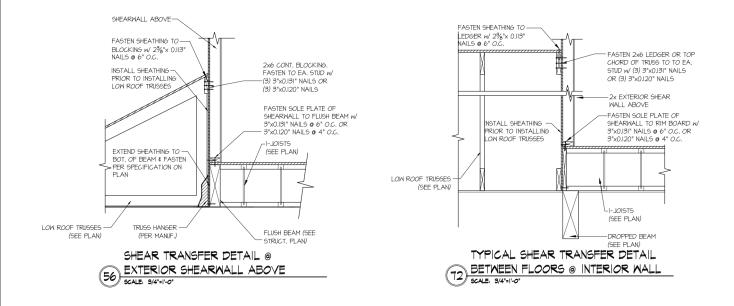

ATERAL DETAILS		REVISIONS: date:	project mgr: drawn by: issue date:		seal:
EADOW MODEL	MULHERN+KULP RESIDENTIAL STRUCTURAL ENGINEERING SEDEDALIA FURMAN, SAID (15 - AL) AURT. CA. 3022		lp project numbe	DREES HOMES	MULHEIN & KULP Structural Engineerin
	p 778-771-4074 = mulhamilup com	initial:	BSM CNV 8-12-22		ER. Constant

# RALEIGH WINDOW SCHEDULE

Drees General	Window Type	MI Windows Capitol				Drees General				
Callout	Window Type	Call No.	Rough Opening	Call No.	Rough Opening	Callout	Call No.	Rough Opening	Call No.	Rough Opening
660	SINGLE/DOUBLE HUNG	CW3500 1/8 x 6/0	20" x 60-1/4"							
670 860	SINGLE/DOUBLE HUNG SINGLE/DOUBLE HUNG	CW3500 1/8 x 7/0 CW3500 1/8 x 6/0	20" x 84"							
2030	SINGLE/DOUBLE HUNG	CW3500 2/0 x 3/0	24" x 36"							
040	SINGLE/DOUBLE HUNG	CW3500 2/0 x 4/0	24" x 48"							
050		CW3500 2/0 x 5/0 CW3500 2/0 x 6/0	24" x 60-1/4"							
060 070	SINGLE/DOUBLE HUNG SINGLE/DOUBLE HUNG	CW3500 2/0 x 6/0 CW3500 2/0 x 7/0	24 x 72 24" x 84"							
2430	SINGLE/DOUBLE HUNG	CW3500 2/4 x 3/0	28" x 36"							
2440	SINGLE/DOUBLE HUNG	CW3500 2/4 x 4/0	28" x 48"							
2450 2460	SINGLE/DOUBLE HUNG SINGLE/DOUBLE HUNG	CW3500 2/4 x 5/0 CW3500 2/4 x 6/0	28" x 60-1/4"							
2830	SINGLE/DOUBLE HUNG	CW3500 2/8 x 3/0	32" x 36"							
840	SINGLE/DOUBLE HUNG	CW3500 2/8 x 4/0	32" x 48"							
850 860	SINGLE/DOUBLE HUNG SINGLE/DOUBLE HUNG	CW3500 2/8 x 5/0 CW3500 2/8 x 6/0	<u>32" x 60-1/4"</u>							
030	SINGLE/DOUBLE HUNG	CW3500 2/8 x 8/0	<u>36-1/4" x 36"</u>							
3040	SINGLE/DOUBLE HUNG	CW3500 3/0 x 4/0	36-1/4" x 48"							
8050	SINGLE/DOUBLE HUNG	CW3500 3/0 × 5/0	36-1/4" x 60-1/4" 36-1/4" x 72"		L					
3060 3070	SINGLE/DOUBLE HUNG SINGLE/DOUBLE HUNG	CW3500 3/0 x 6/0	<u>36-1/4" x /2"</u>		·					
470	SINGLE/DOUBLE HUNG	CW3500 3/0 x 7/0	40" x 84"		<u>                                      </u>					
050 FIXED		910T 5/0 x 1/0	59-5/8" x 11-1/2"							
640 FIXED 020 FIXED		910T 4/0 x 1/8 CW3500 2/0 x 2/0	47-1/4" x 19-1/2"		<u>↓</u> ↓					
020 FIXED 030 FIXED		CW3500 2/0 x 2/0 CW3500SL 2/0 x 3/	<u>24 x 24</u> (0 24" x 36"		<u>+</u> ] ]-					
040 FIXED		CW3500SL 2/0 x 4/	′0 24" x 48"							
050 FIXED		CW3500SL 2/0 x 5/	<u>′0 24" x 60-1/4"</u>							
816 FIXED 860 FIXED		910TSL 2/6 x 1/8 CW3500 3/0 x 6/0	29-1/4" x 19-1/2" 36" x 72"							
016 FIXED		910TSL 3/0 x 1/8	35-1/4" x 19-1/2"							
020 FIXED		910TSL 3/0 x 2/0	35-1/4" x 19-1/2" 35-1/4" x 23-1/2"							
030 FIXED 040 FIXED		CW3500P 3/0 x 3/0 CW3500P 3/0 x 4/0	) 36-1/4" x 36"		<u> </u>					
050 FIXED		CW3500P 3/0 x 4/0	) 36-1/4" x 60-1/4"							
3060 FIXED		CW3500P 3/0 x 6/0	)   36-1/4" x 72"							
3070 FIXED		CW3500P 3/0 x 7/0	) <u>36-1/4" x 84"</u>							
4010 FIXED 4020 FIXED		910T 4/0 x 1/0 910T 4/0 x 2/0	47-1/4" x 11-1/2" 47-1/4" x 23-1/2"							
030 FIXED		CW3500P 4/0 x 3/0	) 48" x 36"							
1040 FIXED		CW3500P 4/0 x 4/0	) 48" x 48"							
4044 FIXED 4050 FIXED		CW3500P 4/0 x 4/4 CW3500P 4/0 x 5/0	1 48" x 52"							
4060 FIXED		CW3500P 4/0 x 5/0	) 48 x 00-1/4							
4070 FIXED		CW3500P 4/0 x 7/0	) 48" x 84"							
030 FIXED		CW3500P 5/0 x 3/0	) 60" x 36"		L					
5040 FIXED 5060 FIXED		CW3500P 5/0 x 4/0 CW3500P 5/0 x 6/0	$0 60^{\circ} \times 48^{\circ}$							
5070 FIXED		CW3500P 5/0 x 7/0	) 60" x 84"							
020 FIXED		910T 6/0 x 2/0	71-5/8" x 23-1/2"							
050 FIXED 060 FIXED		CW3500P 6/0 x 5/0 CW3500P 6/0 x 6/0	) 72" x 60-1/4"							
-0" HALF ROUNE	)	CW3500P 6/0 X 6/0	36-1/4"		<u>                                      </u>					
	)	CW3500 3/0 HC	48"							
-0" HALF ROUNE	)	CW3500 3/0 HC	60" 24"		<u> </u>					
020 OCTAGON '-4" QUARTER RC	DUND	CW3500 2/0 OCT CW3500 2/4 QC	28"		<u>                                     </u>					
-0" QUARTER RC	DUND	CW3500 2/4 QC	36-1/4"							
			+		<u>                                     </u>					
					<u>                                     </u>					
					<u>                                     </u>					
			+		<u>                                     </u>					
	<b>AA</b>	Drees Ho	nes l	Sheet Description:						Sheet N
Dre		7701 Six Forks Road, Suite 132, Raleigh, NC 27		WINDOW SC	CHEDULE					
$\boldsymbol{\nu}$ I $\boldsymbol{\vee}$	Copyright © 2	008, (2013) The Drees Company. All Rights Res any form or by any means, including photocopy	erved. No portion of this material may	be						SC-(
	IOMES <sub>SM</sub> of the Drees Co	any torm or by any means, incluaing photocopy ompany. The Drees Company will vigorously pros	my, mutout the express written permis	erial						

### \* MEETS EMERGENCY ESCAPE & RESCUE OPENING REQUIREMENTS

# MOULDED MILLWORK SCHEDULE

ARCHED HEADER D1 H8xxEF ARCHED HEADER D1K H8xxEF ARCHED HEADER D2 H8xxEF ARCHED HEADER D2 H8xxEF ARCHED HEADER D3 AH10x ARCHED HEADER D3 AH10x ARCHED HEADER D4 AR5xx ARCHED HEADER D4 AR5xx ARCHED HEADER D4 AR5xx ARCHED HEADER D5 AR10x ARCHED HEADER D5 AR10x ARCHED HEADER D6 AR10x ARCHED HEADER D6 AR10x ARCHED HEADER D7K H7xEF ARCHED HEADER D8 AR14x ARCHED HEADER D8 AR14x ARCHED HEADER D8 AR14x CROSSHEAD A1 H9xx CROSSHEAD A1 H9xx CROSSHEAD B1 H14xXB CROSSHEAD B1K H14xXB CROSSHEAD B1K H14xXB CROSSHEAD B2 H12xx CROSSHEAD B2 H12xx CROSSHEAD C2 H18xXB CROSSHEAD C2 H18xXB CROSSHEAD C2 H18xXB CROSSHEAD Z-E3-HDR Z-E3-HI CROSSHEAD Z-E3-HI CROSSHEAD Z-E3-HI CROSSHEAD Z-E3-HI CROSSHEAD Z-E3-HI CROSSHEAD Z-E3-HI CROSSHEAD Z-E3-HI CROSSHEAD Z-E3-HI CROSSHEAD Z-E3-HI CROSSHEAD Z-Z-HI CROSSHEAD Z-Z-HI CROSSHEAD Z-Z-HI CROSSHEAD Z-Z-HI	KR N/A TR N/A TR N/A TKR N/A TKR N/A K WCHSEGxxX10 ARxxX6M ARxxX6M C ARxxX6MK C ARxxX6MK C ARxX6MK C ARxX10MC C ARXX10MC C C ARXX10MC C ARXX10MC C ARXX10MC C C ARXX10MC C ARXX10MC C C ARXX10MC C ARXX10MC C ARXX10MC C ARXX10MC C ARXX10MC C ARXX10MC C ARXX10MC C ARXX10MC C ARXX10MC C ARXX10MC C C ARXX10MC C ARXX10MC ARXX10MC C ARXX10MC C ARXX10MC ARXX10MC ARXX10 ARXX10MC ARXX10 ARXX10 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ARCHED HEADER D6KAR10xARCHED HEADER D7KH7xxEFARCHED HEADER D8AR14xxARCHED HEADER D8AR14xxARCHED HEADER D9H9xxECROSSHEAD A1H9xxCROSSHEAD A1KH9xxKCROSSHEAD B1H14xxBCROSSHEAD B1H14xxBCROSSHEAD B2H12xxCROSSHEAD B2H12xxKCROSSHEAD C1H18xxBCROSSHEAD C2H18xxBCROSSHEAD Z-E1-HDRZ-E2-HDCROSSHEAD Z-E3-HDRZ-E3-HDCROSSHEAD Z-E3-HDRZ-E3-CLCROSSHEAD Z-E3-HDRZ-E3-CLCROSSHEAD Z-E3-HDRZ-E3-CLCROSSHEAD Z-E3-HDRZ-E3-CLCROSSHEAD Z-E3-HDRZ-E3-CLCROSSHEAD Z-E5-HDRZ-E5-HDWINDOW HEADER A1H6xxKWINDOW HEADER B1H9xx-2WINDOW HEADER B1H9xx-2WINDOW HEADER C1H9xxKWINDOW HEADER C2H9xxKWINDOW HEADER C3H12xxBWINDOW HEADER C4H14xxBWINDOW HEADER C4H14xxBWINDOW HEADER C4H14xxBWINDOW HEADER C4H9xxK-WINDOW HEADER C4H9xxK-WINDOW HEADER C4H9xxK-WINDOW HEADER C4<	ARXX10MCK           -4K         N/A           -4K         N/A           CC         ARxxX14MC           CCK         ARxxX14MCK           WCHXX14MCK         WCHXXX14MCK           WCHXXX9N         WCHXXX9N           WCHXXX9N         WCHXXX14BT           T         WCHXX14BT           TK         WCHXX12           WCHXX12         WCHXX14BT           TK         WCHXX14BT           TK         WCHXX14BT           TK         WCHXX14BT           TK         WCHXX14BT           TK         WCHXX14BT           TK         WCHXX14BT           TA         WCHXX14BT           TK         WCHXX14BT           TA         UDCHXX14BT           TA         UDCHXX14BT           TK         WCHXX14BT           TA         UDCHXX14BT           TA         UDCHXX14BT           TK         WCHXX14BT           TK         WCHXX14BT           TA         UDCHXX14BT           TA         UDCHXX18K           DR         Z-E1-HDR           QR         Z-E3-ARCHHDR           HDR         Z-E3-CLHDR
ARCHED HEADER D7KH7xxEFARCHED HEADER D8AR14xxARCHED HEADER D9H9xxECROSSHEAD A1H9xxCROSSHEAD A1KH9xxKCROSSHEAD A1KH9xxKCROSSHEAD B1H14xxBCROSSHEAD B1H14xxBCROSSHEAD B2H12xxCROSSHEAD B2H12xxKCROSSHEAD C1H18xxBCROSSHEAD C2KH12xxKCROSSHEAD C2KH18xxBCROSSHEAD C2KH18xxBCROSSHEAD Z-E1-HDRZ-E2-H1CROSSHEAD Z-E3-HDRZ-E3-H1CROSSHEAD Z-E3-HDRZ-E3-H1CROSSHEAD Z-E3-HDRZ-E3-A1CROSSHEAD Z-E3-HDRZ-E3-A1CROSSHEAD Z-E3-HDRZ-E3-A1CROSSHEAD Z-E3-HDRZ-E3-A1CROSSHEAD Z-E3-HDRZ-E3-A1CROSSHEAD Z-E3-HDRZ-E3-A1CROSSHEAD Z-E3-HDRZ-E3-C1CROSSHEAD Z-E3-HDRZ-E3-C1CROSSHEAD Z-E3-HDRZ-E3-C1CROSSHEAD Z-E3-HDRZ-E3-C1CROSSHEAD Z-E3-HDRZ-E3-C1CROSSHEAD Z-E3-HDRZ-E3-C1CROSSHEAD Z-E3-HDRZ-E3-M2CROSSHEAD Z-E3-HDRZ-E3-M2CROSSHEAD Z-E3-HDRZ-E3-M2CROSSHEAD Z-E3-HDRZ-E3-M2CROSSHEAD Z-E3-HDRZ-E3-M2CROSSHEAD Z-E3-HDRZ-E3-M2CROSSHEAD Z-E3-HDRZ-E3-M2CROSSHEAD Z-C3H12xxBWINDOW HEADER B1H9xx2WINDOW HEADER C1H9xxKWINDOW HEADER C2H9xxKWINDOW HEADER C3H12xxBWIND	-4K         N/A           KC         ARXXX14MC           KCK         ARXXX14MCK           WCHARSXX13         WCHARSXX13           WCHXX9N         WCHXX9N           WCHXX9N         WCHXX14BT           T         WCHXX14BT           TK         WCHXX14BT           WCHXX12         WCHXX14BT           TK         WCHXX12K           T         WCHXX14BT           TK         WCHXX14BT           TK         WCHXX14BT           TK         WCHXX14BT           TK         WCHXX14BT           TR         WCHXX14BT           TR         WCHXX14BT           TA         WCHXX14BT           TA         WCHXX14BT           TA         WCHXX14BT           TPA         LDCHXX18           DR         Z-E1-HDR           DR         Z-E3-HDR           DR         Z-E3-HDR           DR         Z-E3-CLHDR           DR         Z-E5-LHDR           DR         Z-E5-LHDR           WCHXX66         WCHXX66
ARCHED HEADER D8AR14xxARCHED HEADER D8KAR14xxARCHED HEADER D9H9xxECROSSHEAD A1H9xxCROSSHEAD A1KH9xxKCROSSHEAD B1H14xxBCROSSHEAD B1H14xxBCROSSHEAD B1KH14xxBCROSSHEAD B2H12xxCROSSHEAD B2H12xxKCROSSHEAD C1H18xxBCROSSHEAD C2KH18xxBCROSSHEAD C2CH18xxBCROSSHEAD Z-E1-HDRZ-E2-HICROSSHEAD Z-E3-HDRZ-E3-CICROSSHEAD Z-E3-CLHDRZ-E3-CICROSSHEAD Z-E3-CLHDRZ-E3-CICROSSHEAD Z-E3-CLHDRZ-E3-CICROSSHEAD Z-E3-CLHDRZ-E3-CICROSSHEAD Z-E3-CLHDRZ-E3-CICROSSHEAD Z-E3-HDRZ-E3-CICROSSHEAD Z-E3-HDRZ-E3-CICROSSHEAD Z-E3-CLHDRZ-E3-CICROSSHEAD Z-C2H9xx2IWINDOW HEADER A1H6xxKWINDOW HEADER B1H9xx2IWINDOW HEADER C1H9xxKWINDOW HEADER C2H9xxTKWINDOW HEADER C2H9xxTF-WINDOW HEADER C3WINDOW HEADER C4H14xxBWINDOW HEADER C4H14xxBWINDOW HEADER C4H14xxBWINDOW HEADER C4H14xxB </td <td>ACCARxxX14MCACKARxxX14MCKWCHARSxx13WCHXX9NWCHXX9NWCHXX14BTTKWCHXX14BTTKWCHXX12WCHXX12WCHXX12KTWCHXX12KTWCHXX12KTWCHXX14BTTKWCHXX14BTTKWCHXX14BTTKWCHXX14BTTKWCHXX14BTTKWCHXX18TPALDCHXX18DRZ-E1-HDRDRZ-E3-HDRCRZ-E3-ARCHHDRJHDRZ-E3-ARCHDRDRZ-E5-HDRWCHXX66WCHXX66</td>	ACCARxxX14MCACKARxxX14MCKWCHARSxx13WCHXX9NWCHXX9NWCHXX14BTTKWCHXX14BTTKWCHXX12WCHXX12WCHXX12KTWCHXX12KTWCHXX12KTWCHXX14BTTKWCHXX14BTTKWCHXX14BTTKWCHXX14BTTKWCHXX14BTTKWCHXX18TPALDCHXX18DRZ-E1-HDRDRZ-E3-HDRCRZ-E3-ARCHHDRJHDRZ-E3-ARCHDRDRZ-E5-HDRWCHXX66WCHXX66
ARCHED HEADER D8KAR14xxARCHED HEADER D9H9xxECROSSHEAD A1H9xxECROSSHEAD A1KH9xxKCROSSHEAD B1H14xxBCROSSHEAD B1KH14xxBCROSSHEAD B2H12xxCROSSHEAD B2KH12xxKCROSSHEAD B2CH12xxKCROSSHEAD C1H18xxBCROSSHEAD C2H18xxBCROSSHEAD C2KH18xxBCROSSHEAD C2KH18xxBCROSSHEAD C2KH18xxBCROSSHEAD C2KH18xxBCROSSHEAD C2KH18xxBCROSSHEAD Z-E3-HDRZ-E3-H1CROSSHEAD Z-E3-HDRZ-E3-H1CROSSHEAD Z-E3-HDRZ-E3-A1CROSSHEAD Z-E3-HDRZ-E3-C1CROSSHEAD Z-E3-HDRZ-E3-M1CROSSHEAD Z-E3-HDRZ-E3-M2MINDOW HEADER B1H9xx2WINDOW HEADER C1H9xx5WINDOW HEADER C1H9xx5WINDOW HEADER C2H9xx1KWINDOW HEADER C3H12xxBWINDOW HEADER C3KH12xxBWINDOW HEADER C3KH12xxBWINDOW HEADER C3KH12xxBWINDOW HEADER C3KH12xxBWINDOW HEADER C3KH12xxBWINDOW HEADER C3K <t< td=""><td>KCK ARXX14MCK WCHARSxx13 WCHxX9N WCHxX29N T WCHxX14BT TK WCHxX14BT TK WCHxX14BT WCHxX12 WCHxX12K T WCHxX12K T WCHxX14BT TK WCHxX14BT TK UCHxX14BT TK UCHxX14BT TK UCHxX14BT TK Z-E1-HDR DR Z-E3-HDR DR Z-E3-HDR CHHDR Z-E3-ARCHHDR LHDR Z-E3-ARCHHDR DR Z-E5-HDR DR Z-E5-HDR DR Z-E5-HDR</td></t<>	KCK ARXX14MCK WCHARSxx13 WCHxX9N WCHxX29N T WCHxX14BT TK WCHxX14BT TK WCHxX14BT WCHxX12 WCHxX12K T WCHxX12K T WCHxX14BT TK WCHxX14BT TK UCHxX14BT TK UCHxX14BT TK UCHxX14BT TK Z-E1-HDR DR Z-E3-HDR DR Z-E3-HDR CHHDR Z-E3-ARCHHDR LHDR Z-E3-ARCHHDR DR Z-E5-HDR DR Z-E5-HDR DR Z-E5-HDR
ARCHED HEADER D9H9xxECROSSHEAD A1H9xxCROSSHEAD A1KH9xxKCROSSHEAD B1H14xxBCROSSHEAD B1KH14xxBCROSSHEAD B2H12xxCROSSHEAD B2H12xxCROSSHEAD B2KH12xxCROSSHEAD B2KH12xxCROSSHEAD C1H18xxBCROSSHEAD C2H18xxBCROSSHEAD C2KH18xxBCROSSHEAD C2EH18xxBCROSSHEAD C2F1-HDRZ-E1-HDCROSSHEAD Z-E1-HDRZ-E3-HDCROSSHEAD Z-E3-HDRZ-E3-HDCROSSHEAD Z-E3-CLHDRZ-E3-HDCROSSHEAD Z-E3-CLHDRZ-E3-CLCROSSHEAD Z-E3-CLHDRZ-E3-CLCROSSHEAD Z-E3-CLHDRZ-E3-HDCROSSHEAD Z-E3-CLHDRZ-E3-HDCROSSHEAD Z-E3-CLHDRZ-E3-HDCROSSHEAD Z-E3-CLHDRZ-E3-HDCROSSHEAD Z-E3-CLHDRZ-E3-HDCROSSHEAD Z-E3-ARCHHDRZ-E3-HDCROSSHEAD Z-E3-ARCHHDRZ-E3-HDCROSSHEAD Z-E3-CLHDRZ-E3-HDCROSSHEAD Z-E3-RDZ-E3-HDCROSSHEAD Z-E3-RDZ-E3-HDCROSSHEAD Z-E3-RDZ-W3DWINDOW HEADER A1KH6xxKWINDOW HEADER B1KH9xx22WINDOW HEADER B2H9xxBTWINDOW HEADER C2H9xxTKWINDOW HEADER C2KH9xxTKWINDOW HEADER C3KH12xxBWINDOW HEADER C3KH12xxBWINDOW HEADER C3KH12xxBWINDOW HEADER C3KH12xxBWINDOW HEADER C4H14xXBWINDOW HEADER C3KH9xxK-	WCHARSxx13WCHxxX9NWCHxxX9NKTWCHxxX14BTTKWCHxx114BTWCHxx112WCHxx12KWCHxx12KTWCHxx14BTTKWCHxxX14BTTKWCHxxX14BTTKUCHxxX14BTTKWCHxxX14BTTRQRZ-E1-HDRDRZ-E3-HDRCRZ-E3-ARCHHDRDRZ-E5-HDRDRZ-E5-HDRWCHxxX6WCHxX6K
CROSSHEAD A1H9xxCROSSHEAD A1KH9xxKCROSSHEAD B1H14xxBCROSSHEAD B1KH14xxBCROSSHEAD B2CH12xxKCROSSHEAD B2CH12xxKCROSSHEAD B2CH12xxKCROSSHEAD B2CH12xxKCROSSHEAD C1H18xxBCROSSHEAD C1H18xxBCROSSHEAD C2CH18xxBCROSSHEAD C2CH18xxBCROSSHEAD C2CH18xxBCROSSHEAD C2CH18xxBCROSSHEAD C2CH18xxBCROSSHEAD Z-E1-HDRZ-E1-HICROSSHEAD Z-E2-HDRZ-E3-CLCROSSHEAD Z-E3-ARCHHDRZ-E3-CLCROSSHEAD Z-E3-ARCHHDRZ-E3-CLCROSSHEAD Z-E3-CLHDRZ-E3-CLCROSSHEAD Z-E3-CLHDRZ-E3-CLCROSSHEAD Z-E3-CLHDRZ-E3-CLCROSSHEAD Z-E3-CLHDRZ-E3-CLCROSSHEAD Z-E3-CLHDRZ-E3-CLCROSSHEAD Z-E3-RCHPCROSSHEAD Z-E3-RCZ-E3-CLWINDOW HEADER A1H6xxWINDOW HEADER B1H9xx-2WINDOW HEADER B1KH9xxB1WINDOW HEADER B2H9xxB1WINDOW HEADER C1H9xxTWINDOW HEADER C2H9xxTWINDOW HEADER C3H12xxBWINDOW HEADER C3KH12xxBWINDOW HEADER C3KH12xxBWINDOW HEADER C3KH12xxBWINDOW HEADER C1KH9xxF-WINDOW HEADER C3KH12xxBWINDOW HEADER C3KH12xxBWINDOW HEADER C3KH12xxBWINDOW HEADER C3KH12xxBWINDOW HEADER C3K <t< td=""><td>WCHxxX9N           WCHxxX9NK           T           WCHxxX14BT           TK           WCHxxX14BT           WCHxxX14BT           WCHxxX12           WCHxxX12K           WCHxxX14BT           TK           WCHxxX14BT           TK           WCHxxX14BT           TK           WCHxxX14BT           TK           WCHxxX14BT           TK           WCHxxX14BT           TK           DCHxxX14BT           TK           WCHxxX14BT           TK           WCHxxX14BT           TK           WCHxxX14BT           DR           Z-E3-HDR           DR           Z-E3-ARCHHDR           LHDR           Z-E3-CLHDR           DR           Z-E5-HDR           WCHxxX6</td></t<>	WCHxxX9N           WCHxxX9NK           T           WCHxxX14BT           TK           WCHxxX14BT           WCHxxX14BT           WCHxxX12           WCHxxX12K           WCHxxX14BT           TK           WCHxxX14BT           TK           WCHxxX14BT           TK           WCHxxX14BT           TK           WCHxxX14BT           TK           WCHxxX14BT           TK           DCHxxX14BT           TK           WCHxxX14BT           TK           WCHxxX14BT           TK           WCHxxX14BT           DR           Z-E3-HDR           DR           Z-E3-ARCHHDR           LHDR           Z-E3-CLHDR           DR           Z-E5-HDR           WCHxxX6
CROSSHEAD A1KH9xxKCROSSHEAD B1H14xxBCROSSHEAD B1KH14xxBCROSSHEAD B2KH12xxCROSSHEAD B2KH12xxKCROSSHEAD B2KH12xxKCROSSHEAD C1H18xxBCROSSHEAD C2H18xxBCROSSHEAD C2KH18xxBCROSSHEAD C2KH18xxBCROSSHEAD C2KH18xxBCROSSHEAD Z-E1-HDRZ-E1-HICROSSHEAD Z-E2-HDRZ-E3-HICROSSHEAD Z-E3-HDRZ-E3-HICROSSHEAD Z-E3-CLHDRZ-E3-CICROSSHEAD Z-E3-CLHDRZ-E3-CICROSSHEAD Z-E5-HDRZ-E5-HIWINDOW HEADER A1KH6xxKWINDOW HEADER B1H9xx-2WINDOW HEADER B1KH9xx-2WINDOW HEADER B2H9xxB1WINDOW HEADER C1H9xxF1WINDOW HEADER C1H9xxTWINDOW HEADER C1H9xxTWINDOW HEADER C3KH12xxBWINDOW HEADER C1KH9xxK-WINDOW HEADER C3KH12xxBWINDOW HEADER C3K <td>WCHxxX9NK           T         WCHxxX14BT           TK         WCHxxX14BT           WCHxxX14BT         WCHxxX14BTK           WCHxxX12         WCHxxX12K           T         WCHxxX12K           T         WCHxxX14BT           TK         WCHxXX14BT           TK         WCHxXX14BTK           T-PA         LDCHxXX18           TK-PA         LDCHxXX18K           DR         Z-E1-HDR           DR         Z-E3-HDR           RCHHDR         Z-E3-ARCHHDR           LHDR         Z-E3-CLHDR           DR         Z-E5-HDR           WCHxxX6         WCHxX6K</td>	WCHxxX9NK           T         WCHxxX14BT           TK         WCHxxX14BT           WCHxxX14BT         WCHxxX14BTK           WCHxxX12         WCHxxX12K           T         WCHxxX12K           T         WCHxxX14BT           TK         WCHxXX14BT           TK         WCHxXX14BTK           T-PA         LDCHxXX18           TK-PA         LDCHxXX18K           DR         Z-E1-HDR           DR         Z-E3-HDR           RCHHDR         Z-E3-ARCHHDR           LHDR         Z-E3-CLHDR           DR         Z-E5-HDR           WCHxxX6         WCHxX6K
CROSSHEAD B1H14xxBCROSSHEAD B1KH14xxBCROSSHEAD B2H12xxCROSSHEAD B2KH12xxKCROSSHEAD C1H18xxBCROSSHEAD C1KH18xxBCROSSHEAD C2H18xxBCROSSHEAD C2H18xxBCROSSHEAD C2H18xxBCROSSHEAD C2H18xxBCROSSHEAD C2CROSSHEAD C2CROSSHEAD C2H18xxBCROSSHEAD Z-E1-HDRZ-E1-HDCROSSHEAD Z-E3-HDRZ-E3-HDCROSSHEAD Z-E3-HDRZ-E3-CLCROSSHEAD Z-E3-CLHDRZ-E3-CLCROSSHEAD Z-E3-CLHDRZ-E3-CLCROSSHEAD Z-E3-CLHDRZ-E3-CLCROSSHEAD Z-E3-CLHDRZ-E3-CLCROSSHEAD Z-E3-CLHDRZ-E3-CLCROSSHEAD Z-E5-HDRZ-E3-CLWINDOW HEADER A1H6xxKWINDOW HEADER B1H9xx-2WINDOW HEADER B1H9xx-2WINDOW HEADER B1H9xx-2WINDOW HEADER B2H9xxB1WINDOW HEADER C1H9xxKWINDOW HEADER C2H9xxTKWINDOW HEADER C3H12xxBWINDOW HEADER C3H12xxBWINDOW HEADER C4H14xxBWINDOW HEADER C4H14xxBWINDOW HEADER D1H7xxFWINDOW HEADER C4H9xxK-WINDOW HEADER C4	T         WCHxxX14BT           TK         WCHxxX14BTK           WCHxxX12         WCHxxX12           WCHxxX12         WCHxxX12           WCHxxX12         WCHxxX12           WCHxxX12         WCHxxX12           WCHxxX12         WCHxxX12           WCHxxX12         WCHxxX12           T         WCHxxX12           TK         WCHxxX14BT           TFA         LDCHxxX14BTK           T-PA         LDCHxxX18K           DR         Z-E1-HDR           DR         Z-E3-HDR           CHDR         Z-E3-ARCHHDR           HDR         Z-E3-CLHDR           DR         Z-E5-TDR           WCHxxX6         WCHxxX6K
CROSSHEAD B1KH14xxBCROSSHEAD B2H12xxCROSSHEAD B2KH12xxKCROSSHEAD C1H18xxBCROSSHEAD C1KH18xxBCROSSHEAD C2CH18xxBCROSSHEAD C2KH18xxBCROSSHEAD C2KH18xxBCROSSHEAD Z-E1-HDRZ-E1-HICROSSHEAD Z-E2-HDRZ-E2-HICROSSHEAD Z-E3-ADRZ-E3-AICROSSHEAD Z-E3-ADRZ-E3-CLCROSSHEAD Z-E3-CLHDRZ-E3-CLCROSSHEAD Z-E3-CLHDRZ-E3-CLCROSSHEAD Z-E5-HDRZ-E3-CLCROSSHEAD Z-E5-HDRZ-E5-HIWINDOW HEADER A1H6xxLWINDOW HEADER B1H9xx-2WINDOW HEADER B1H9xx-2WINDOW HEADER B1H9xx-2WINDOW HEADER B1H9xx-2WINDOW HEADER C1H9xxKWINDOW HEADER C2H9xxKWINDOW HEADER C3H12xxBWINDOW HEADER C3H12xxBWINDOW HEADER C3H12xxBWINDOW HEADER C4H14xxBWINDOW HEADER C3H12xxBWINDOW HEADER C4H14xxBWINDOW HEADER C4H14xxBWINDOW HEADER C4H14xxBWINDOW HEADER C4H14xxBWINDOW HEADER C4H9xxK-WINDOW HEADER C4 <t< td=""><td>TK         WCHxxX14BTK           WCHxxX12         WCHxxX12K           T         WCHxxX14BT           TK         WCHxxX14BT           TK         WCHxxX14BT           TK         UCHxX14BT           TK         WCHxX14BT           TK         WCHxX14BT           TK         WCHxX14BT           TK         WCHxX14BT           TR         UCHxX14BT           OR         Z-E1-HDR           DR         Z-E3-HDR           QR         Z-E3-HDR           HDR         Z-E3-CLHDR           DR         Z-E5-TDR           WCHxxX6         WCHxxX6K</td></t<>	TK         WCHxxX14BTK           WCHxxX12         WCHxxX12K           T         WCHxxX14BT           TK         WCHxxX14BT           TK         WCHxxX14BT           TK         UCHxX14BT           TK         WCHxX14BT           TK         WCHxX14BT           TK         WCHxX14BT           TK         WCHxX14BT           TR         UCHxX14BT           OR         Z-E1-HDR           DR         Z-E3-HDR           QR         Z-E3-HDR           HDR         Z-E3-CLHDR           DR         Z-E5-TDR           WCHxxX6         WCHxxX6K
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CROSSHEAD C1KH18xxBCROSSHEAD C2H18xxBCROSSHEAD C2KH18xxBCROSSHEAD C2E1-HDRZ-E1-HDCROSSHEAD Z-E1-HDRZ-E2-HDRCROSSHEAD Z-E2-HDRZ-E3-HDRCROSSHEAD Z-E3-ARCHHDRZ-E3-AICROSSHEAD Z-E3-ARCHHDRZ-E3-CLCROSSHEAD Z-E3-CLHDRZ-E3-CLCROSSHEAD Z-E3-CLHDRZ-E5-HDRWINDOW HEADER A1H6xxWINDOW HEADER A1H6xxKWINDOW HEADER B1H9xx-2WINDOW HEADER B1KH9xx-2WINDOW HEADER B2H9xxB1WINDOW HEADER B2H9xxB1WINDOW HEADER C1H9xxXWINDOW HEADER C2H9xxTWINDOW HEADER C3H12xxBWINDOW HEADER C3KH12xxBWINDOW HEADER C3KH12xxBWINDOW HEADER C3KH12xxBWINDOW HEADER C3KH2xXF-W3WWINDOW HEADER C3KH2xXF-W3WWINDOW HEADER C3KH2-W3WWINDOW HEADER C3KH2-W3W <td>TK WCHxxX14BTK T-PA LDCHxxX18 TK-PA LDCHxxX18 TK-PA LDCHxxX18K DR Z-E1-HDR DR Z-E2-HDR DR Z-E3-HDR RCHHDR Z-E3-ARCHHDR LHDR Z-E3-CLHDR DR Z-E5-HDR WCHxxX6 WCHxxX6K</td>	TK WCHxxX14BTK T-PA LDCHxxX18 TK-PA LDCHxxX18 TK-PA LDCHxxX18K DR Z-E1-HDR DR Z-E2-HDR DR Z-E3-HDR RCHHDR Z-E3-ARCHHDR LHDR Z-E3-CLHDR DR Z-E5-HDR WCHxxX6 WCHxxX6K
CROSSHEAD C2H18xxBCROSSHEAD C2KH18xxBCROSSHEAD Z-E1-HDRZ-E1-HICROSSHEAD Z-E2-HDRZ-E2-HICROSSHEAD Z-E3-HDRZ-E3-HICROSSHEAD Z-E3-ARCHHDRZ-E3-AICROSSHEAD Z-E3-CLHDRZ-E3-CICROSSHEAD Z-E3-CLHDRZ-E5-HIRWINDOW HEADER A1H6xxWINDOW HEADER A1H6xxWINDOW HEADER B1H9xx-2WINDOW HEADER B1H9xx-2WINDOW HEADER B1H9xx-2WINDOW HEADER B1H9xx-2WINDOW HEADER C1H9xxB1WINDOW HEADER C2H9xxB1WINDOW HEADER C1H9xxXWINDOW HEADER C2H9xxTWINDOW HEADER C3H12xxBWINDOW HEADER C4H14xxBWINDOW HEADER C3H12xxBWINDOW HEADER C3H12xxBWINDOW HEADER C3H12xxBWINDOW HEADER C3H2xxF-MWINDOW HEADER C3H2xXF-MWINDOW HEADER C4H3xXF-MWINDOW HEADER C4H3xXF-MWINDOW HEADER C4H3xXF-MWINDOW HEADER C4H3xXF-MWINDOW HEADER C4H4WINDO	T-PA LDCHxxX18 TK-PA LDCHxxX18K DR Z-E1-HDR DR Z-E2-HDR DR Z-E3-HDR RCHHDR Z-E3-ARCHHDR LHDR Z-E3-ARCHHDR DR Z-E5-HDR WCHxxX6 WCHxxX6K
CROSSHEAD C2KH18xxBCROSSHEAD Z-E1-HDRZ-E1-HDRCROSSHEAD Z-E3-HDRZ-E3-HICROSSHEAD Z-E3-HDRZ-E3-HICROSSHEAD Z-E3-CLHDRZ-E3-AICROSSHEAD Z-E3-CLHDRZ-E3-CLCROSSHEAD Z-E3-CLHDRZ-E3-CLCROSSHEAD Z-E3-CLHDRZ-E3-CLCROSSHEAD Z-E3-HDRZ-E3-CLWINDOW HEADER A1H6xxWINDOW HEADER A1H6xxWINDOW HEADER A1H6xxWINDOW HEADER B1H9xx-2WINDOW HEADER B1H9xx-2WINDOW HEADER B1H9xx-2WINDOW HEADER B1H9xx-2WINDOW HEADER C1H9xxBTWINDOW HEADER C2H9xxKWINDOW HEADER C2H9xxKWINDOW HEADER C3H12xxBWINDOW HEADER C3H12xxBWINDOW HEADER C4H14xxBWINDOW HEADER D1H7xxF-4WINDOW HEADER D2KH9xxK-4WINDOW HEADER C4H14xxBWINDOW HEADER C4H9xxK-4WINDOW HEADER C4H9xxK-4WINDOW HEADER C4H9xxK-4WINDOW HEADER C4H9xxK-4WINDOW HEADER C4H9xxK-4WINDOW HEADER C4H7xxF-4WINDOW HEADER C4H9xxK-4WINDOW HEADER C4H9xxK-4WINDOW HEADER C4H9xxK-4WINDOW HEADER Z-W3Z-W3WINDOW HEADER Z-W3Z-W3WINDOW HEADER Z-W3Z-W3WINDOW HEADER Z-W3Z-W3	TK-PA         LDCHxxX18K           DR         Z-E1-HDR           DR         Z-E2-HDR           DR         Z-E3-HDR           CHHDR         Z-E3-ARCHHDR           LHDR         Z-E3-CLHDR           DR         Z-E5-HDR           WCHxxX6         WCHxxX6K
CROSSHEAD Z-E1-HDRZ-E1-HDRCROSSHEAD Z-E2-HDRZ-E2-HDRCROSSHEAD Z-E3-HDRZ-E3-HDRCROSSHEAD Z-E3-ARCHHDRZ-E3-AICROSSHEAD Z-E3-CLHDRZ-E3-CLCROSSHEAD Z-E5-HDRZ-E5-HDRWINDOW HEADER A1H6xxKWINDOW HEADER A1H6xxKWINDOW HEADER B1H9xx-2WINDOW HEADER B1H9xx-2WINDOW HEADER B1H9xx-2WINDOW HEADER B1H9xx-2WINDOW HEADER B1H9xx-2WINDOW HEADER C1H9xxB1WINDOW HEADER C2H9xxB1WINDOW HEADER C2H9xxTWINDOW HEADER C3H12xxBWINDOW HEADER C3H12xxBWINDOW HEADER C4H14xXBWINDOW HEADER D1H7xxF-4WINDOW HEADER D2KH9xxKWINDOW HEADER D1KH7xxF-4WINDOW HEADER C3Z-W3WINDOW HEADER C4H9xxKWINDOW HEADER C4H9xxKWINDOW HEADER C4H14xXBWINDOW HEADER C4H7xxF-4WINDOW HEADER C4H7xxF-4WINDOW HEADER C4H9xXKWINDOW HEADER C4H9xXKWINDOW HEADER Z-W3Z-W3WINDOW HEADER Z-W3Z-W3WINDOW HEADER Z-W3DZ-W3WINDOW HEADER Z-W3DZ-W3WINDOW HEADER Z-W3DZ-W3	DR         Z-E1-HDR           DR         Z-E2-HDR           DR         Z-E3-HDR           CHHDR         Z-E3-ARCHHDR           LHDR         Z-E3-CLHDR           DR         Z-E3-HDR           WCHXXX6         WCHXXX6K
CROSSHEAD Z-E2-HDRZ-E2-HDRCROSSHEAD Z-E3-HDRZ-E3-HDRCROSSHEAD Z-E3-ARCHHDRZ-E3-AICROSSHEAD Z-E3-CLHDRZ-E3-CLCROSSHEAD Z-E5-HDRZ-E5-HDRWINDOW HEADER A1H6xxWINDOW HEADER A1H6xxWINDOW HEADER A1H6xxWINDOW HEADER B1H9xx-2WINDOW HEADER B1H9xx-2WINDOW HEADER B1H9xx-2WINDOW HEADER B2H9xxB1WINDOW HEADER B2H9xxB1WINDOW HEADER C1H9xxKWINDOW HEADER C2H9xxKWINDOW HEADER C2H9xxKWINDOW HEADER C3H12xxBWINDOW HEADER C3H12xxBWINDOW HEADER C4H14xxBWINDOW HEADER D1H7xxF-4WINDOW HEADER D2KH9xxKWINDOW HEADER D2KH9xxKWINDOW HEADER C3H12xxBWINDOW HEADER C4H14xxBWINDOW HEADER C3H12xxBWINDOW HEADER C4H7xxF-4WINDOW HEADER C4H7xxF-4WINDOW HEADER C4H9xxK-4WINDOW HEADER Z-W3Z-W3WINDOW HEADER Z-W3Z-W3WINDOW HEADER Z-W3DZ-W3DWINDOW HEADER Z-W3DZ-W34WINDOW HEADER Z-W3Z-W3	DR         Z-E2-HDR           DR         Z-E3-HDR           DR         Z-E3-ARCHHDR           CHHDR         Z-E3-ARCHHDR           LHDR         Z-E3-CLHDR           DR         Z-E5-HDR           WCHxxX6         WCHxxX6K
CROSSHEAD Z-E3-HDRZ-E3-HDRCROSSHEAD Z-E3-ARCHHDRZ-E3-AICROSSHEAD Z-E3-CLHDRZ-E3-CLCROSSHEAD Z-E5-HDRZ-E5-HDRWINDOW HEADER A1H6xxWINDOW HEADER A1H6xxWINDOW HEADER A1H9xx-2WINDOW HEADER B1H9xx-2WINDOW HEADER B1H9xx-2WINDOW HEADER B1H9xx-2WINDOW HEADER B2H9xxB1WINDOW HEADER B2H9xxB1WINDOW HEADER C1H9xxCWINDOW HEADER C2H9xxKWINDOW HEADER C2H9xxTKWINDOW HEADER C3H12xxBWINDOW HEADER C3H12xxBWINDOW HEADER C4H14xxBWINDOW HEADER D1H7xxF-4WINDOW HEADER D2KH9xxK-4WINDOW HEADER D1H7xxF-4WINDOW HEADER C3Z-W3WINDOW HEADER C3Z-W3WINDOW HEADER Z-W3DZ-W3DWINDOW HEADER Z-W3DZ-W3DWINDOW HEADER Z-W3DZ-W34WINDOW HEADER Z-W3DZ-W44	DR         Z-E3-HDR           RCHHDR         Z-E3-ARCHHDR           LHDR         Z-E3-CLHDR           DR         Z-E5-HDR           WCHxxX6         WCHxxX6K
CROSSHEAD Z-E3-ARCHHDRZ-E3-AICROSSHEAD Z-E3-CLHDRZ-E3-CLCROSSHEAD Z-E5-HDRZ-E5-HDRWINDOW HEADER A1H6xxKWINDOW HEADER A1H6xxKWINDOW HEADER A1H6xxKWINDOW HEADER A1H9xx-2WINDOW HEADER B1H9xx-2WINDOW HEADER B1H9xx-2WINDOW HEADER B1H9xx-2WINDOW HEADER B2H9xxB1WINDOW HEADER B2H9xxB1WINDOW HEADER C1H9xxWINDOW HEADER C2H9xxTKWINDOW HEADER C2KH9xxTKWINDOW HEADER C3KH12xxBWINDOW HEADER C4H14xxBWINDOW HEADER D1H7xxFWINDOW HEADER D1KH7xxFWINDOW HEADER C2KH9xxK-WINDOW HEADER D1KH7xxFWINDOW HEADER C4H14xxBWINDOW HEADER C5H9xxK-WINDOW HEADER C4H14xxBWINDOW HEADER C4H14xxBWINDOW HEADER C4H2xXFWINDOW HEADER C4H2xXFWINDOW HEADER C4H2xXFWINDOW HEADER C5H9xXFWINDOW HEADER C4H9xXFWINDOW HEADER C4H2xXFWINDOW HEADER C4H2xXFWINDOW HEADER C4H2xXFWINDOW HEADER C4H2xXFWINDOW HEADER C4H2-W1WINDOW HEADER Z-W3Z-W3WINDOW HEADER Z-W3DZ-W3WINDOW HEADER Z-W3DZ-W4	RCHHDR         Z-E3-ARCHHDR           LHDR         Z-E3-CLHDR           DR         Z-E5-HDR           WCHxxX6         WCHxxX6K
CROSSHEAD Z-E3-CLHDRZ-E3-CLCROSSHEAD Z-E5-HDRZ-E5-HDRWINDOW HEADER A1H6xxWINDOW HEADER A1H6xxWINDOW HEADER A1H6xxWINDOW HEADER A1H6xxWINDOW HEADER B1H9xx-2WINDOW HEADER B1H9xx-2WINDOW HEADER B1H9xx-2WINDOW HEADER B1H9xx-2WINDOW HEADER B1H9xx-2WINDOW HEADER B2H9xxB1WINDOW HEADER B2H9xxB1WINDOW HEADER C1H9xxWINDOW HEADER C1H9xxWINDOW HEADER C1H9xxTWINDOW HEADER C2H9xxTWINDOW HEADER C3H12xxBWINDOW HEADER C3H12xxBWINDOW HEADER C4H14xxBWINDOW HEADER C4H14xxBWINDOW HEADER D1H7xxF-4WINDOW HEADER D2KH9xxK-WINDOW HEADER Z-W3Z-W3WINDOW HEADER Z-W3DZ-W3DWINDOW HEADER Z-W3DZ-W3DWINDOW HEADER Z-W3DZ-W4WINDOW HEADER Z-W4Z-W4	HDR         Z-E3-CLHDR           DR         Z-E5-HDR           WCHxxX6         WCHxxX6K
CROSSHEAD Z-E5-HDRZ-E5-HDRWINDOW HEADER A1H6xxWINDOW HEADER A1KH6xxKWINDOW HEADER B1H9xx-2WINDOW HEADER B1H9xx-2WINDOW HEADER B1H9xx-2WINDOW HEADER B1KH9xx-2WINDOW HEADER B1KH9xx-2WINDOW HEADER B1KH9xx-2WINDOW HEADER B2H9xxB1WINDOW HEADER C1H9xxB1WINDOW HEADER C2H9xxTWINDOW HEADER C1KH9xxTWINDOW HEADER C2KH9xxTKWINDOW HEADER C3KH12xxBWINDOW HEADER C3KH12xxBWINDOW HEADER C4H14xxBWINDOW HEADER D1H7xxF-4WINDOW HEADER D2KH9xxK-WINDOW HEADER Z-W1Z-W1WINDOW HEADER Z-W3Z-W3WINDOW HEADER Z-W3DZ-W3DWINDOW HEADER Z-W3DZ-W3DWINDOW HEADER Z-W3DZ-W3DWINDOW HEADER Z-W3DZ-W4WINDOW HEADER Z-W4Z-W4	DR Z-E5-HDR WCHxxX6 WCHxxX6K
WINDOW HEADER A1H6xxWINDOW HEADER A1KH6xxKWINDOW HEADER B1H9xx-2WINDOW HEADER B1KH9xx-2WINDOW HEADER B1KH9xx-2WINDOW HEADER B2KH9xxBTWINDOW HEADER C1H9xxBTWINDOW HEADER C1H9xxWINDOW HEADER C1H9xxWINDOW HEADER C1H9xxTWINDOW HEADER C2H9xxTWINDOW HEADER C2H9xxTWINDOW HEADER C3H12xxBWINDOW HEADER C3H12xxBWINDOW HEADER C4H14xxBWINDOW HEADER D1H7xxFWINDOW HEADER D1KH7xxFWINDOW HEADER D2KH9xxK-WINDOW HEADER Z-W3Z-W3WINDOW HEADER Z-W3DZ-W3DWINDOW HEADER Z-W3DZ-W3DWINDOW HEADER Z-W4Z-W4	WCHxxX6 WCHxxX6K
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WINDOW HEADER B1         H9xx-2           WINDOW HEADER B1K         H9xx-2           WINDOW HEADER B2         H9xxBT           WINDOW HEADER B2K         H9xxBT           WINDOW HEADER C1         H9xxBT           WINDOW HEADER C1         H9xxK           WINDOW HEADER C1         H9xxX           WINDOW HEADER C1K         H9xxK           WINDOW HEADER C2         H9xxT           WINDOW HEADER C2         H9xxT           WINDOW HEADER C2         H9xxT           WINDOW HEADER C2         H9xxT           WINDOW HEADER C3         H12xxB           WINDOW HEADER C3         H12xxB           WINDOW HEADER C3K         H12xxB           WINDOW HEADER C4         H14xxB           WINDOW HEADER D1K         H7xxF-           WINDOW HEADER D2K         H9xxK-           WINDOW HEADER Z-W3         Z-W3           WINDOW HEADER Z-W3         Z-W3           WINDOW HEADER Z-W3D         Z-W3D           WINDOW HEADER Z-W3D         Z-W3           WINDOW HEADER Z-W3D         Z-W3	
WINDOW HEADER B1KH9xx-2lWINDOW HEADER B2H9xxBTWINDOW HEADER C1H9xxBTWINDOW HEADER C1H9xxKWINDOW HEADER C1KH9xxKWINDOW HEADER C2H9xxTWINDOW HEADER C2KH9xxTKWINDOW HEADER C3H12xxBWINDOW HEADER C3H12xxBWINDOW HEADER C3H12xxBWINDOW HEADER C3KH12xxBWINDOW HEADER C4H14xxBWINDOW HEADER D1H7xxF-4WINDOW HEADER D1KH7xxF-4WINDOW HEADER D2KH9xxK-WINDOW HEADER Z-W1Z-W1WINDOW HEADER Z-W3DZ-W3BWINDOW HEADER Z-W3DZ-W3DWINDOW HEADER Z-W3DZ-W3DWINDOW HEADER Z-W3DZ-W3DWINDOW HEADER Z-W3DZ-W3DWINDOW HEADER Z-W4Z-W4	WCHxxX9N
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WINDOW HEADER C1H9xxWINDOW HEADER C1KH9xxKWINDOW HEADER C2H9xxTWINDOW HEADER C2KH9xxTKWINDOW HEADER C3H12xxBWINDOW HEADER C3KH12xxBWINDOW HEADER C4H14xxBWINDOW HEADER C4H14xxBWINDOW HEADER C1H7xxFWINDOW HEADER D1H7xxFWINDOW HEADER D2KH9xxK-WINDOW HEADER Z-W1Z-W1WINDOW HEADER Z-W3Z-W3WINDOW HEADER Z-W3DZ-W3DWINDOW HEADER Z-W3DZ-W3WWINDOW HEADER Z-W3DZ-W34WINDOW HEADER Z-W4Z-W4	WCHxxX10NBT
WINDOW HEADER C1KH9xxKWINDOW HEADER C2H9xxTWINDOW HEADER C2KH9xxTKWINDOW HEADER C3H12xxBWINDOW HEADER C3KH12xxBWINDOW HEADER C4H14xxBWINDOW HEADER C1H7xxFWINDOW HEADER D1H7xxFWINDOW HEADER D2KH9xxK-WINDOW HEADER Z-W1Z-W1WINDOW HEADER Z-W3Z-W3WWINDOW HEADER Z-W3KZ-W3KWINDOW HEADER Z-W3DZ-W3DWINDOW HEADER Z-W4Z-W4	
WINDOW HEADER C2         H9xxT           WINDOW HEADER C2K         H9xxTK           WINDOW HEADER C3         H12xxB           WINDOW HEADER C3K         H12xxB           WINDOW HEADER C4         H14xxB           WINDOW HEADER C4         H14xxB           WINDOW HEADER D1         H7xxF           WINDOW HEADER D1K         H7xxF           WINDOW HEADER D2K         H9xxK-           WINDOW HEADER Z-W1         Z-W1           WINDOW HEADER Z-W3K         Z-W3W           WINDOW HEADER Z-W3K         Z-W3K           WINDOW HEADER Z-W3K         Z-W3D           WINDOW HEADER Z-W3A         Z-W3D           WINDOW HEADER Z-W3A         Z-W3D           WINDOW HEADER Z-W3A         Z-W3D           WINDOW HEADER Z-W3A         Z-W3D	CCAxxX10
WINDOW HEADER C2K         H9xxTK           WINDOW HEADER C3         H12xxB           WINDOW HEADER C3K         H12xxB           WINDOW HEADER C4         H14xxB           WINDOW HEADER D1         H7xxF-           WINDOW HEADER D1K         H7xxF-           WINDOW HEADER D2K         H9xxK-           WINDOW HEADER Z-W1         Z-W1           WINDOW HEADER Z-W3         Z-W3W           WINDOW HEADER Z-W3K         Z-W3K           WINDOW HEADER Z-W3D         Z-W3D           WINDOW HEADER Z-W3K         Z-W3W           WINDOW HEADER Z-W3W         Z-W3W           WINDOW HEADER Z-W4         Z-W4	CCAxxX10K
WINDOW HEADER C3         H12xxB           WINDOW HEADER C3K         H12xxB           WINDOW HEADER C4         H14xxB           WINDOW HEADER D1         H7xxF           WINDOW HEADER D1K         H7xxF           WINDOW HEADER D2K         H9xxK           WINDOW HEADER Z-W1         Z-W1           WINDOW HEADER Z-W3         Z-W3W           WINDOW HEADER Z-W3K         Z-W3K           WINDOW HEADER Z-W3D         Z-W3D           WINDOW HEADER Z-W3A         Z-W3W           WINDOW HEADER Z-W4         Z-W3W	WCHxxX9T
WINDOW HEADER C3KH12xxBWINDOW HEADER C4H14xxBWINDOW HEADER D1H7xxFWINDOW HEADER D1KH7xxFWINDOW HEADER D2KH9xxK-WINDOW HEADER Z-W1Z-W1WINDOW HEADER Z-W3Z-W3WWINDOW HEADER Z-W3KZ-W3KWINDOW HEADER Z-W3DZ-W3WWINDOW HEADER Z-W4Z-W4	
WINDOW HEADER C4         H14xxB           WINDOW HEADER D1         H7xxF-           WINDOW HEADER D1K         H7xxF-           WINDOW HEADER D2K         H9xxK-           WINDOW HEADER Z-W1         Z-W1           WINDOW HEADER Z-W3         Z-W3           WINDOW HEADER Z-W3K         Z-W3K           WINDOW HEADER Z-W3D         Z-W3D           WINDOW HEADER Z-W3A         Z-W3A	
WINDOW HEADER D1         H7xxF-/           WINDOW HEADER D1K         H7xxF-/           WINDOW HEADER D2K         H9xxK-           WINDOW HEADER Z-W1         Z-W1           WINDOW HEADER Z-W3         Z-W3           WINDOW HEADER Z-W3K         Z-W3K           WINDOW HEADER Z-W3K         Z-W3K           WINDOW HEADER Z-W3D         Z-W3D           WINDOW HEADER Z-W3A         Z-W3A	
WINDOW HEADER D1K         H7xxF-/           WINDOW HEADER D2K         H9xxK-           WINDOW HEADER Z-W1         Z-W1           WINDOW HEADER Z-W3         Z-W3           WINDOW HEADER Z-W3K         Z-W3K           WINDOW HEADER Z-W3D         Z-W3D           WINDOW HEADER Z-W3D         Z-W3D           WINDOW HEADER Z-W3D         Z-W3D	
WINDOW HEADER D2K         H9xxK-           WINDOW HEADER Z-W1         Z-W1           WINDOW HEADER Z-W3         Z-W3           WINDOW HEADER Z-W3K         Z-W3K           WINDOW HEADER Z-W3D         Z-W3D           WINDOW HEADER Z-W3D         Z-W3D           WINDOW HEADER Z-W3D         Z-W3D	•
WINDOW HEADER Z-W1         Z-W1           WINDOW HEADER Z-W3         Z-W3           WINDOW HEADER Z-W3K         Z-W3K           WINDOW HEADER Z-W3D         Z-W3D           WINDOW HEADER Z-W3D         Z-W3D           WINDOW HEADER Z-W4         Z-W4	•
WINDOW HEADER Z-W3 Z-W3 WINDOW HEADER Z-W3K Z-W3K WINDOW HEADER Z-W3D Z-W3D WINDOW HEADER Z-W4 Z-W4	Z-W1
WINDOW HEADER Z-W3D Z-W3D WINDOW HEADER Z-W4 Z-W4	Z-W3
WINDOW HEADER Z-W4 Z-W4	Z-W3K
	7 14/00
WINDOW HEADER Z-W4K Z-W4K	Z-W3D
	Z-W4
	Z-W4

	PILASTERS			
Drees General Callout	Nuwood		Fypon	Drees Gene
FLUTED PILASTER A1	PL7xxF	PIL7Xxx		BAND MOULD [
FLUTED PILASTER B1	PL9xxF	PIL9Xxx		BAND MOULD
FLUTED PILASTER C1	PL11xxFM	PIL11Xxx		BARGE MOULD
PANEL PILASTER A2	PL7xxP	PIL7XxxDP		CASE MOULD D
PANEL PILASTER B2	PL9xxP	PIL9XxxDP		CASE MOULD D
PANEL PILASTER C2	PL11xxPM	PIL11XxxDP		CROWN MOUL
PILASTER D1	M311-9	PIL10XxxA		DENTIL MOULD
PILASTER D2	M323-9	N/A		DENTIL MOULD
PILASTER Z-E1-PIL	Z-E1-PIL	Z-E1-PIL		HALF ROUND M
PILASTER Z-E2-PIL	Z-E2-PIL	Z-E2-PIL		PANEL MOULD
PILASTER Z-E3-PIL	Z-E3-PIL	Z-E3-PIL		
PILASTER Z-PIL-EXT	Z-PIL-EXT	Z-PIL-EXT		
PLAIN PILASTER A3	PL7xxS	PIL7XxxP		
PLAIN PILASTER B3	PL9xxS	PIL9XxxP		
PLAIN PILASTER C3	PL11xxS	PIL11XxxP		Drees Gene
PLINTH D1	PF10		END OF PILASTER	BROW COMBO
PLINTH D2	P14.5	N/A		PEAK PEDIMENT
	LOUVERS			PEAK PEDIMEN
	LOOVERS			PEAKED COMB
Drago Constal Callout	Numeral	Euroon		RAMS HEAD PE
Drees General Callout	Nuwood	Fypon	Mid-America	ROUND PEDIME
CATHEDRAL LOUVER D1	CLV1224	CLV12X24		SUNRISE COMB
CATHEDRAL LOUVER D1T	CLV1224TRIM4	CLV12X24X4F		VICTORIAN PED
CATHEDRAL LOUVER D2	CLV1432	CLV14X32		
CATHEDRAL LOUVER D2T	CLV1432TRIM4	CLV14X32X4F	00 44 1422	
CATHEDRAL LOUVER D3	CLV2232	CLV22X32		
CATHEDRAL LOUVER D3T	CLV2232TRIM4	CLV22X32X4F		Drees Gene
HALF CIRCLE LOUVER D1	HRLV32	HRLV32X16		
HALF CIRCLE LOUVER D1T	HRLV32TRIM4	HRLV32X4F		HALF CIRCLE SU
HALF CIRCLE LOUVER D2	HRLV36	HRLV36X18		PALLADIAN WIN
HALF CIRCLE LOUVER D2T	HRLV36TRIM4	HRLV36X4F	00 43 2234	PALLADIAN WIN
OCTAGONAL LOUVER D1	OLV24	OLV24		PALLADIAN WIN
OCTAGONAL LOUVER D12	OLV24TRIM4	OLV24X4F		
OVAL LOUVER D1	OLV2537	OLV37X25		PALLADIAN WIN
OVAL LOUVER DIT	OLV2537TRIM4	OLV37X25X4F		
	LV1224V	LV12X24		
RECTANGUAR LOUVER D1			00 45 1218	PEAKED CAP HE
RECTANGUAR LOUVER D1T	LV1224VTRIM4	LV12X24-4F	00 45 1218	PLAIN SEGMEN
RECTANGUAR LOUVER D2	LV1636V	LV16X36		SEGMENT SUNB
RECTANGUAR LOUVER D2T	LV1636VTRIM4	LV16X36-4F		
RECTANGUAR LOUVER D3	LV2436V	LV24X36		
RECTANGUAR LOUVER D3T	LV2436VTRIM4	LV24X36-4F		
RECTANGUAR LOUVER D4	LV2424V	LV24X24		
RECTANGUAR LOUVER D4T	LV2424VTRIM4	LV24X24-4F		Drees Gene
ROUND LOUVER D1	RLV18	RLV18		GABLE D1
ROUND LOUVER DIT	RLV18TRIM4	RLV18X4F		KEYSTONE D1
ROUND LOUVER D2	RLV22	RLV22		KEYSTONE D2
				WREATH D1
ROUND LOUVER D2T	RLV22TRIM4	RLV22X4F		WREATH DI
TRIANGULAR LOUVER D1		TRLVxxX36	00 47 0x0x	
	BRACKETS			
Droop Coporal Callout	Numerad		Fypon	
Drees General Callout	Nuwood			
EXTERIOR BRACKET D1	BR437	N/A		
EXTERIOR BRACKET D2	DB102	DTLB6X4X6		
EXTERIOR BRACKET D3	BR304 (7" WIDE)	BKT24X24X7	7	
EXTERIOR BRACKET D3	BR455	N/A		
	BR300-1	BKT12X12X6	<u>,                                     </u>	
EXTERIOR BRACKET D5			)	
EXTERIOR BRACKET D6	BR300	BKT12X12		
EXTERIOR BRACKET D7	BR409	BKT16X18X3	3	
EXTERIOR BRACKET D8	BR413	DTLB5X5X3		
EXTERIOR BRACKET D9	TBD	BKT11X20		
EXTERIOR BRACKET D10	TBD	BKT12X24X3	3	
EXTERIOR BRACKET D11	BR435	BKT25X27		
EXTERIOR BRACKET D12	BR404	BKT16X30X4	1	
EXTERIOR BRACKET D13	BR23.13x10.13x5.5	N/A	<u>.</u>	
	TBD			
GABLE BRACKET D1			R(OR L)PITCH	
GABLE BRACKET D2	BR423-x:12	BKT5X20		
GABLE BRACKET D3	BR424-x:12	<u> </u>	UT 2" PROJECTION)	



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Sheet Description:

MOULDED MILLWORK SCHEDULE

LAST REVISED 11/22/17

## MOULDINGS

Drees General Callout	Nuwood	Fypon
BAND MOULD D1	M210-16	MLD612-12
BAND MOULD D2	M301-16	MLD220-16
BARGE MOULD D1	WM210	WM210
CASE MOULD D1	M320-16	MLD226-16
CASE MOULD D2	N/A	MLD244-12
CROWN MOULD D1	M404-16	MLD572-16
DENTIL MOULD D1	M105-16	MLD310-16
DENTIL MOULD D2	M108-8	MLD353-8
HALF ROUND MOULD D1	N/A	MLD605-12
PANEL MOULD D1	M310-8 OR 16	MLD612-12

## PEDIMENTS / COMBO HEADERS

Drees General Callout	Nuwood	Fypon
BROW COMBO D1	BCxx	CSAPxx
PEAK PEDIMENT D1	Pxx-4 (6:12)	PCPxx
PEAK PEDIMENT Z-E1-PED	Z-E1-PED	Z-E1-PED
PEAKED COMBO D1	PCxx-4	СРСРхх
RAMS HEAD PEDIMENT D1	Rxx	RHPxx00
ROUND PEDIMENT D1	Bxx-4	PSPxx
SUNRISE COMBO D1	SCxx-4	CSPxx
VICTORIAN PEDIMENT D1	VPxx	DVPxx w/ SWDHxxXxx

WIN	DOW DECORATIO	N
Drees General Callout	Nuwood	Fypon
HALF CIRCLE SUNBURST D1	SPxxxx	SWDHxxXxx
PALLADIAN WINDOW D1	H9AR10-xx xx'' FL/FR	ARxxX10MFLxxx
PALLADIAN WINDOW D1K	H9AR10-xxK xx" FL/FR	ARxxX10MFLxxx with K10TM
PALLADIAN WINDOW D2	H9AR10SPxxxx	ARxxX10MFLxxx with
		SWDHxxXxx
PALLADIAN WINDOW D2K	H9AR10SPxxxxK	ARxxX10MFLxxx with
		SWDHxxXxx and K10TM
PEAKED CAP HEADER D1	N/A	CHPCxxX15
Plain Segment D1	SPxxxxP	PSPxx
SEGMENT SUNBURST D1	SPxxxx	SWDHxxXxx

	ACCESSORIES	
Drees General Callout	Nuwood	Fypon
GABLE D1	PGDx12	GPA (width X height)
(EYSTONE D1	KY14F-3	KY14
CEYSTONE D2	KYHM9F	K9M
WREATH D1	N/A	WAB34

Sheet No.

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