REVISION:001 DATE: 11/22/21

ADJUST OPTION SQUARE FOOTAGES TO ACCURATELY SHOW THE DIFFERENCES FROM THE BASE PLAN SQUARE FOOTAGE TOTALS.

BEVISION:002

DATE: 12/08/21 RELOCATE FRONT DOOR TO ALIGN W/ GARAGE WALL. ADJUST FOUNDATION AND OPTIONS

ACCORDINGLY.

2. ADD WALL & DOOR AT FOYER FOR OPTIONAL SMART DOOR DELIVERY CENTER.

3. NOTE DOOR INTO MAIN HOUSE W/ OPTIONAL SMART DOOR DELIVERY CENTER TO BE 3068 3/4 LITE W/ 12" TRANSOM.

4. DIMENSION & LOCATE BED #4 CLOSET DOOR 5'-0" FROM EXTERIOR WALL.

CHANGE DOOR WIDTH FROM 2/6 TO 2/4 © BATH #3, BED #3 CLOSET, BATH #2, BED #2 CLOSET AND OPT. BED #5.

FLIP PANTRY SHELVES, DELETE DOOR ACCESSED FROM DROP ZONE & ADD 2/4 DOOR

ACCESSED FROM MESSY KITCHEN.
DIMENSION TO CENTER OF TRIPLE WINDOWS ONLY.
MAKE ALL STUD POCKETS 4 1/2".
ADD NOTE AT FIREPLACE FOR A "42"X39" R.O." FOR FIREBOX.

9. AUD NOTE AT INEPTAGE FOR A 42 X39 K.O. FOR FIREBUX.

10. RELOCATE WALL LUNGER STAR & NOTE © 35 WALL HT (VLF.).

11. ADD COURMET KITCHEN, ALTERNATE KITCHEN AND ALTERNATE GOURMET KITCHEN OPTIONS.

12. DELETE 2ND WINDOW NEAREST TO CORNER © POCKET OFFICE OPTION.

13. DELETE OPTIONAL PARITY DOOR LOCATION.

14. CHANGE SIDELOAD GARAGE FRONT WINDOWS FROM 5/0 HT TO 6/0 HT.

15. ADD 8° DEEP CHASE BEHIND 2ND FL LINEN CLOSET & HALL

16. RELOCATE WATER HEATER AT SIDELOAD GARAGE UNDER NEW LINEN CLOSET CHASE.

17. DECREASE DEPTH OF CHASE BEHIND OWNERS BATH WATER CLOSET TO 10° TO INCREASE WATER CLOSET DEPTH TO 6'-1".

MOVE OWNERS VANITY WALL UP TO ALLOW ROOM IN LAUNDRY FOR CHASE @ LINEN, OPT 30° CAB W/ OPT LT. AND WASHER/DRYER.

19. ADD PULL DOWN STAIR IN LAUNDRY. NOTE "25 1/2" X 54 1/2" R.O."
20. ADD 18"X24" CHASE IN OWNERS WIC CLOSET @ SHOWER WALL.

21. MAKE BATH#2 VANITY 60".

21. MAKE WIC @ BED/#2 5"-4" DEEP, ADDING 3" TO BATH #2.
23. MOVE BATH/#2 TOILET, TUB AND WINDOW 3" TOWARD FRONT OF HOUSE.
24. MAKE WINDOW IN BED #2 CLOSET TEMPERED.

REVISION:003 DATE: 2/4/2022

DIMENSION TRIPLE STUD POCKETS
RELOCATE ISLAND PER REDLINES.
REMOVE WINDOW IN MESSY KITCHEN
FULL HEIGHT WALL AT END OF CABINETS ON GARAGE ADJACENT WALL.
REMOVE UNDER-COUNTER SIDE WALLS IN ISLAND.

SHOW AND CALL OUT DROP ZONE BENCH AS 18" DEEP.
VERIFY CASED OPENINGS ARE 3/0x6/8 ON 1ST FLOOR.
ELIMINATE ALT KITCHEN
MATCH BASE PLAN LOCATION FOR WATER HEATER IN SIDE LOAD GARAGE.

9. MAICH BASE PLAN LOCATION FOR WATER HEATER IN SIDE LOAD GARAGE.
10. 3/4 LITE ENTRY DOOR.
11. CREATE SHOWER OPTION WITH 18" SEAT.
12. RESIZE STANDARD SHOWER TO 60X36. EXTEND FULL HEIGHT WALL AT STANDARD SHOWER.
13. ADD 236 WALL JUST INSIDE EXTERIOR WALL FOR OPT. SUPER SHOWER W/ OPT. 2ND FLOOR.
14. ALL LINEN CALLED OUT AS (4) SHELVES.
15. POCKET DOORS CHANGE TO STANDARD 2/4 IN OWNER'S WIC TO LAUNDRY.

16. EXTEND REAR PORCH 6" SO BEAM BEARS ON CAFE WALL.

17. CHANCE COLUMNS TO 6X6 P.T. WITH 1X WRAP FOR TRADITIONAL ELEVATION.

18. CHANGE EAR PORCH COLUMNS TO 6X6 P.T. POST, NO WRAP.

19. CHANGE ENTRY DOOR TO 3/4 LITE

19. CHANGE ENIKT DUCK 10 3/4 LIE

20. EXTEND PORCH SLAB 4'A FRONT AND EXTEND AROUND CORNER 20" TO SUPPORT STONE VENEER.

21. REMOVED HALF WALLS AT KITCHEN ISLAND AND UPDATED PER CABINET PROVIDER

22. CHANGED THE BASE OWNER'S BATH WINDOW TO 4010

24. CHANGED THE OWNER'S BATH OPTION SHOWER W/18" SEAT WINDOW TO 4010

24. CHANGED THE OWNER'S BATH OPTION SUPER SHOWER WINDOWS TO (2)3010
25. CHANGED THE OPTION 2ND FLOOR OWNER'S BATH WINDOW TO 4010

25. CHANGED THE OPTION AND FLOUR OWNER'S BATH WINDOW TO 4010
26. CHANGED THE OPTION ZUD FLOOR OWNER'S BATH OPTION SUPER SHOWER WINDOWS TO (2)3010
27. CHANGED 2ND FLOOR WINDOW OVER PORCH TO BE 2040 ALL ELEVATIONS
28. UPDATED THE WINDOW HEADER AT THE STAIR LANDING TO BE 8'-10" ABOVE LANDING
29. RE-CENTERED ECORGIAN PORCH TO BE CENTERED ON THE WINDOW ABOVE
30. ADDED AN EXTENDED PORCH OPTION TO THE TRADITIONAL ELEVATION ONLY

REVISION:004

DATE: 3/30/2022

CHANGED 2ND FLOOR WINDOW OVER PORCH TO BE 2040 ALL ELEVATIONS UPDATED THE WINDOW HEADER AT THE STAIR LANDING TO BE 8'-10" ABOVE LANDING CHANGED SIZE OF GEORGIAN PORCH TO BE CENTERED ON THE WINDOW ABOVE CHANGED STYLE OF GEORGIAN COLUMNS FROM ROUND TO SQUARE ADDED AN EXTENDED PORCH OPTION TO THE TRADITIONAL ELEVATION ONLY ADDED ELECTRICAL PLAN SHEETS

DATE: 7/22/2022

ADD STEM WALL SLAB FOUNDATION SHEETS.
ADD "STEM WALL" TO CRAWL ELEVATION TITLES AND ADD NOTE "SEE FOUNDATION PAGES FOR FOUNDATION TYPE". UPDATE SHEET TITLES

REVISION:006

REVISION:005

ADD THIRD CAR GARAGE OPTION MODIFYING THE 2 CAR GARAGE AND BEDROOM #2, ELEVATIONS.

Lot 26 Woodbridge South 238 Salem Village Drive

# NC.



Heated = 2,744 sq ftGarage = 415 sq ftFront Porch = 149 sq ft Covered Deck = 210 sa ft

## PLAN 4 The Selma - LH

### **'ENGLISH COUNTRY'**

Sheet No.	Sheet Description
0.0	Cover Sheet
1.1	Foundation (Slab)
1.1.1	Foundation Options (Slab)
1.2	Foundation (Crawl)
1.2.1	Foundation Options (Crawl)
1.2.2	Foundation Third Car Garage Option
1.3	Foundation (Stem Wall Slab)
1.3.1	Foundation Options (Stem Wall Slab)
2.1	First Floor Plan
2.1.1	First Floor Plan Options
2.2	Second Floor Plan
2.2.1	Second Floor Plan Options
2.2.2	Third Car Garage Floor Plan Option
2.4	Covered Porch Plans & Elevations (Slab)
2.4.1	Covered Porch Plans & Elevations (Crawl/Stem Wall)
2.5	Side Load Garage Elevations (Slab)
2.5.1	Side Load Garage Elevations (Crawl/ Stem Wall)
2.6	Third Car Garage Right & Front Elevations (Crawl/ Slab)
2.6.1	Third Car Garage Left & Rear Elevations ( Crawl/ Slab)
3.1	Front & Rear Elevations (Slab)
3.1.1	Front & Rear Elevations (Crawl/Stem Wall)
3.2	Side Elevations (Slab)
3.2.1	Side Elevations (Crawl/Stem Wall)
3.3	Roof Plan
5.1	First Floor Electrical
5.1.1	First Floor Options Electrical
5.2	Second Floor Electrical
5.2.1	Second Floor Options Electrical
5.2.2	Third Car Garage Option Electrical

	'EN	'ENGLISH COUNTRY' ELEVATIO							
		UNHEATED		HEATED					
FIRST FLOOR		0		1194	1				
SECOND FLOOR		0	П	1452	Г				
FRONT PORCH (CRAWL)		149	П	0	Г				
FRONT PORCH (SLAB)		150	П	0	Г				
REAR PATIO/DECK		208	П	0	Г				
2 CAR GARAGE		415	П	0	Г				
					ı				
SUBTOTALS		930		2646	ı				
			-						
TOTAL UNDER ROOF	3576								
OF	PTI	ONS							
	UN	HEATED S.F.	Н	eated s	.F.				
OPT. POCKET OFFICE		0		+64					
FIREPLACE BUMPOUT		0		+34					
COVERED PATIO/DECK		210	0						
THIRD CAR GARAGE		+323		+40					

#### **DESIGN CRITERIA:**

THIS PLAN IS TO BE BUILT IN CONFORMANCE WITH THE 2018 NORTH CAROLINA STATE BUILDING CODE: RESIDENTIAL CODE

DIMENSIONS SHALL GOVERN OVER SCALE, AND CODE SHALL GOVERN OVER DIMENSIONS.



DATE								-
DESCRIPTION						-	1	-
REV. #	1	2	3	4	2	9	7	8

Cover Sheet 'English Country

**SELMA** 

THE


4


**PLAN** 


South Designs ISSUE DATE: 7/1/2021 CURRENT REVISION DATE:

SCALE: 1/8" = 1'-0"

SHEET 0.0c

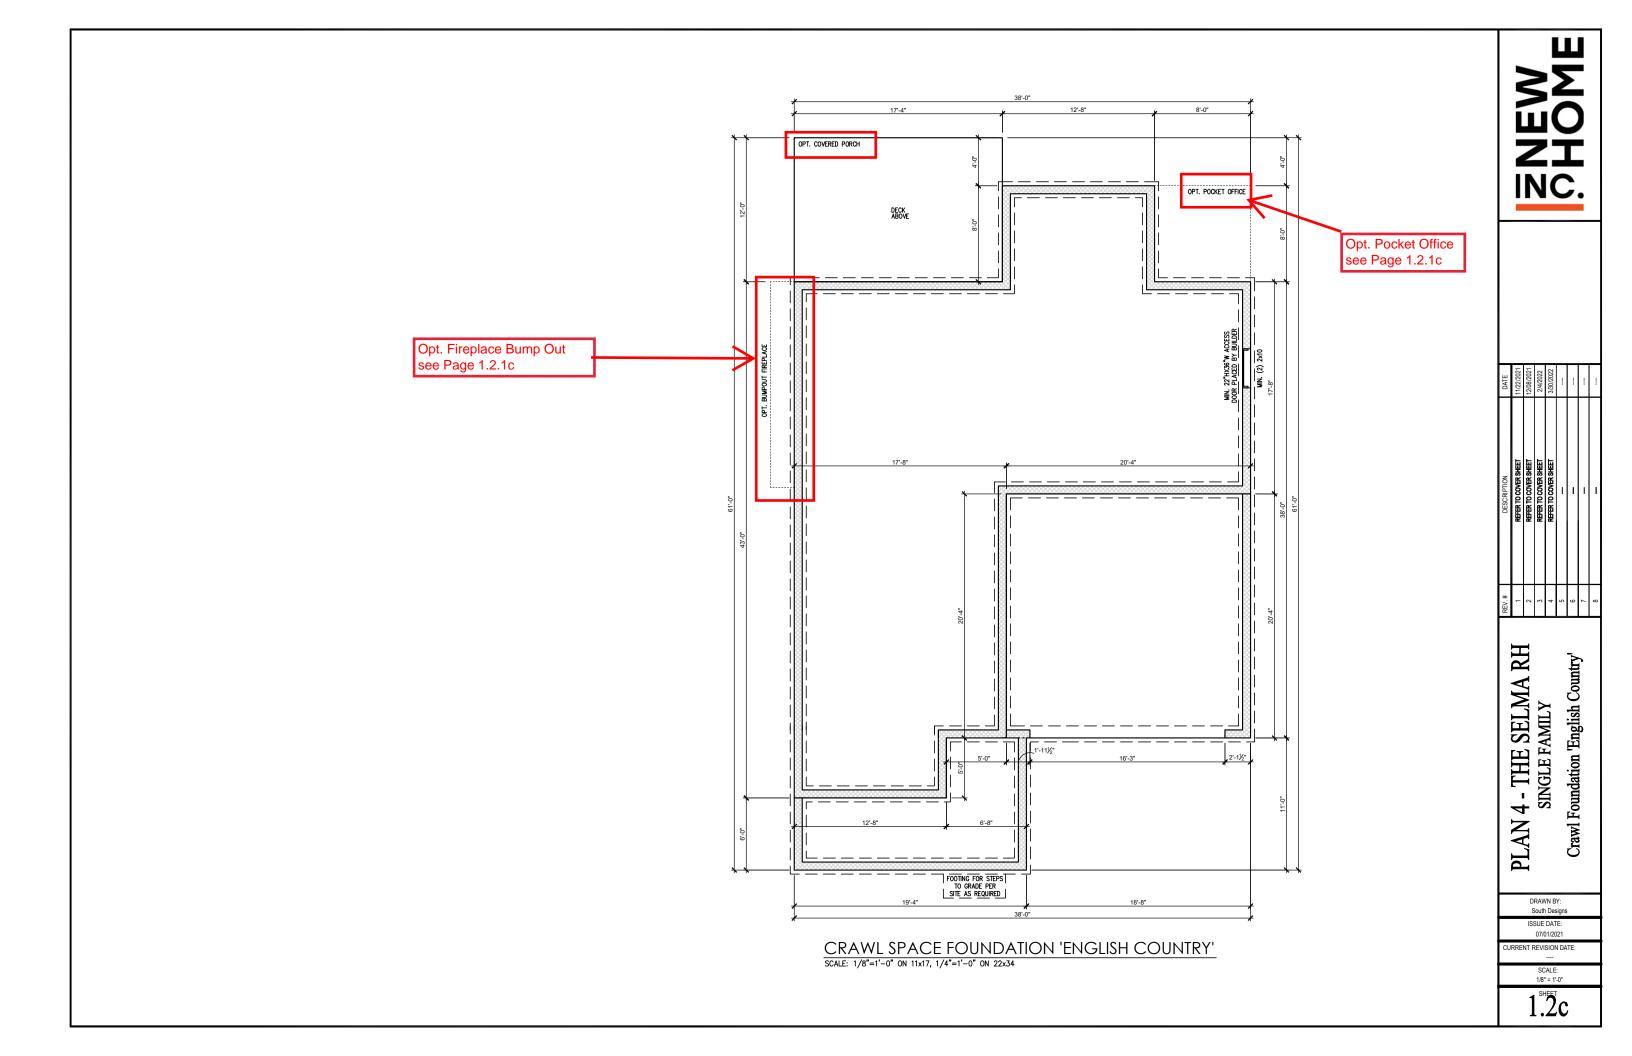

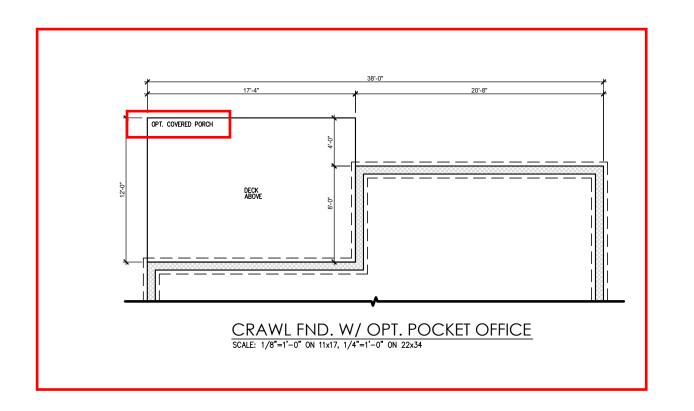

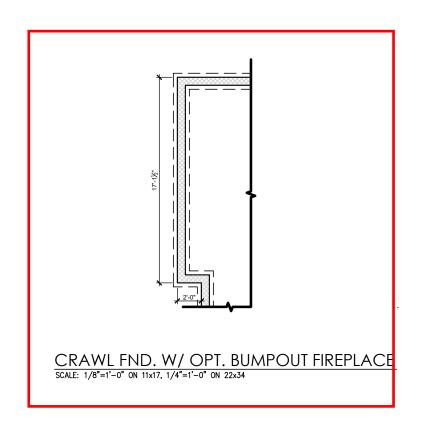



DATE	11/22/2021	12/08/2021	2/4/2022	3/30/2022				
DESCRIPTION	REFER TO COVER SHEET	-	-	-	1			
REV.#	1	2	3	7	9	9	7	8

PLAN 4 - THE SELMA RH SINGLE FAMILY Crawl Foundation Options 'English Country'

DRAWN BY: South Designs


ISSUE DATE: 07/01/2021 CURRENT REVISION DATE:

> SCALE: 1/8" = 1'-0"

1.2.1c


General Floor Plan Notes shall apply unless noted otherwise on plan.


- Wall Heights: Typically 9"-1 1/2" at first floor and 8'-1 1/2" at second floor and attics U.N.O. All walls are constructed using a double top plate. Splices at Double Top Plate do not need to occur at Vertical Studs but must be at least 24" apart from Joint in other Top Plate layer. Special wall heights are noted on plans where they occur.
- Wall Thickness is typically 3 1/2". 2x6 frame shall be used at walls that back up to plumbing fixtures.
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- Typical header height shall be 6'-11" AFF at First Floor, and 6'-11" AFF at Second Floor U.N.O. on elevation drawings. Windows at front elevation may be higher at the first floor.
- Jacks: Openings up to 3'-4" wide shall have (1) 2x4 jack stud SPF on each side. Openings greater than 3'-4" wide shall have (2) 2x4 jack studs SPF on each
- Soffits, Coffered Ceilings, Trey Ceilings and other significant ceiling plan elements are shown on the floor plans and are denoted as single dashed lines. Unless specifically call out as included, Kitchens do not include soffits over wall cabinetry.
- Door & Window Frames, where occurring near corners, shall be a minimum of 4 1/2" from corner. Except for walk-in closets with doors near a corner, doors at closets shall be centered on closet.
- Windows: Shall have at least (1) window in each sleeping room, that meets egress. Shall be provided with tempered glass of hazardous glazing areas. False windows shall be installed with obscure alazina.
- Closets for clothing or coat storage shall be equipped with 1 rod/shelf. Closets for linen shall have 4 open equal shelves. Closets for pantries shall have 4 equal wood shelves, painted.
- Stair treads shall be a min of 9" deep, risers shall be a maximum of 8 1/4", unless noted otherwise, per the current North Carolina Residential Code
- 10. Handrails and Guards at stairs shall be 34" above the finished surface of the ramp surface of the stair. Handrails at landings and overlooks of multilevel spaces shall be 36" above finished floor. Guards (pickets or balusters) shall be spaced with no more than 4" between guards.
- 11. Attic Access shall be provided at all attic area with a height greater than 30". Minimum clear attic access shall be 20" x 30". Pull down stairs and access doors in knee walls meeting minimum criteria are also acceptable.
- 12. Garage Door to Living Space shall be 2'-8" x 6'-8" minimum size and shall be 20 minute fire rated and weather sealed.
- 13. Garage Walls, as a minimum, shall be separated from living space by installing 1/2" gypsum board on the garage side of the wall. With habitable space above, the inside of all garage walls require 1/2" GWB supporting 5/8" type X GWB on ceiling.

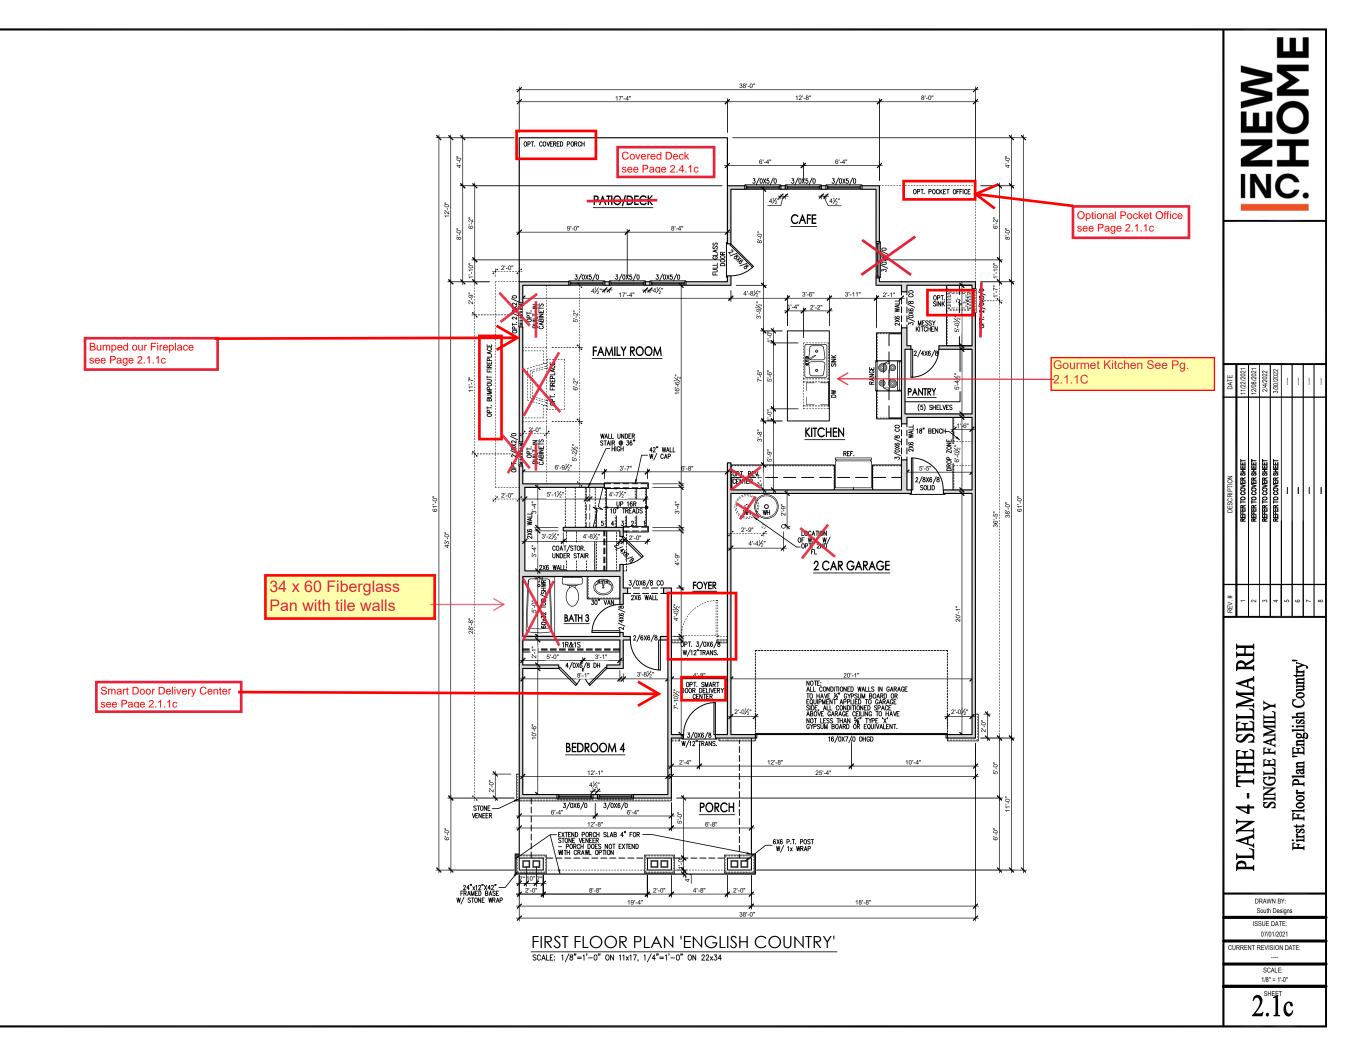


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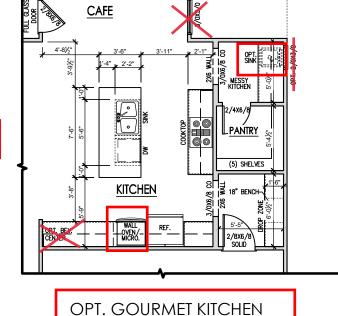


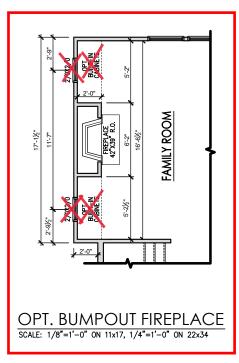

3/0 x 5/0 Window Pocket Office

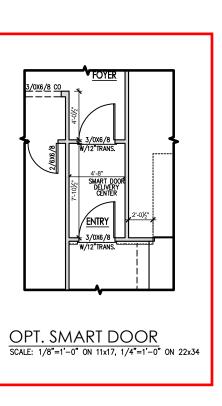

Gas Stub Out /LP Conversion

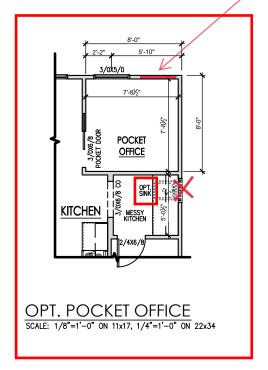

SCALE: 1/8"=1'-0" ON 11x17, 1/4"=1'-0" ON 22x34

PLAN 4 - THE SELMA RH
SINGLE FAMILY
First Floor Plan Options


ISSUE DATE: 07/01/2021 CURRENT REVISION DATE:

> SCALE: 1/8" = 1'-0"

2.1.10

General Floor Plan Notes shall apply unless noted otherwise on plan.

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SECOND FLOOR PLAN 'ENGLISH COUNTRY'

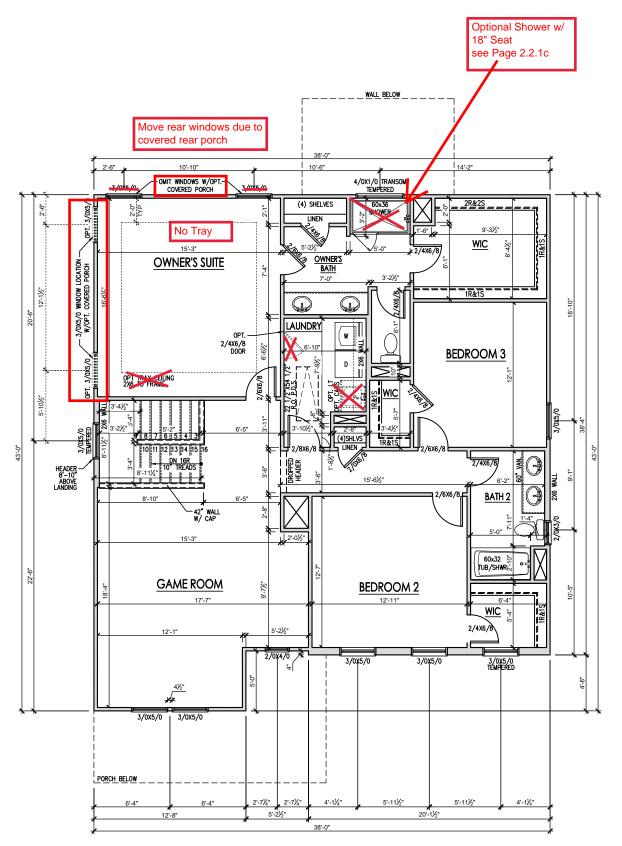SCALE: 1/8"=1'-0" ON 11x17, 1/4"=1'-0" ON 22x34

NEW SHOME

DATE	11/22/2021	12/08/2021	2/4/2022	3/30/2022				-
DESCRIPTION	REFER TO COVER SHEET	****	-		-			
REV.#	-	2	3	4	5	9	7	8

PLAN 4 - THE SELMA RH SINGLE FAMILY Second Floor Plan 'English Country'

> DRAWN BY: South Designs

ISSUE DATE: 07/01/2021

CURRENT REVISION DATE:


1/8" = 1'-0" SHEET

 $2.2^{\text{SHEET}}$ 

SCALE:

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DATE	11/22/2021	12/08/2021	2/4/2022	3/30/2022			-	!
DESCRIPTION	REFER TO COVER SHEET	-	-	-	1			
REV.#	-	2	3	4	5	9	7	8


PLAN 4 - THE SELMA RH SINGLE FAMILY Second Floor Plan Options
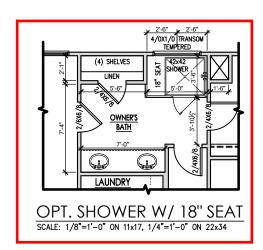
> DRAWN BY: South Designs

ISSUE DATE: 07/01/2021


CURRENT REVISION DATE:
---SCALE:
1/8" = 1'-0"


2 2 10

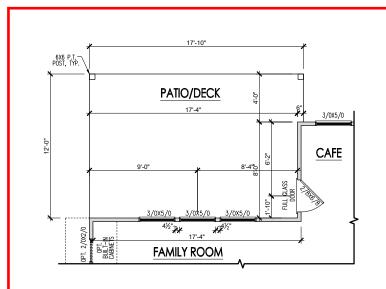

COVERED PORCH FLOOR PLAN


SCALE: 1/8"=1'-0" ON 11x17, 1/4"=1'-0" ON 22x34

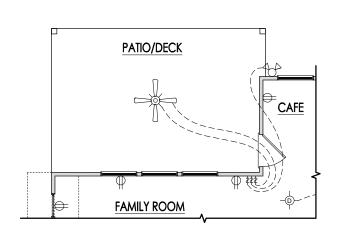

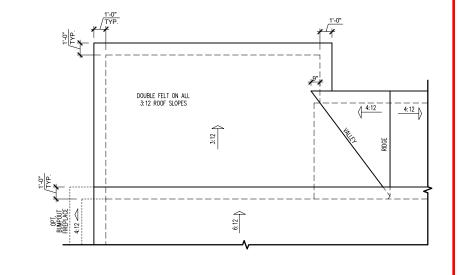

COVERED PORCH ELECTRICAL
SCALE: 1/8"=1'-0" ON 11x17, 1/4"=1'-0" ON 22x34

COVERED PORCH ROOF PLAN
SCALE: 1/8"=1'-0" ON 11x17, 1/4"=1'-0" ON 22x34

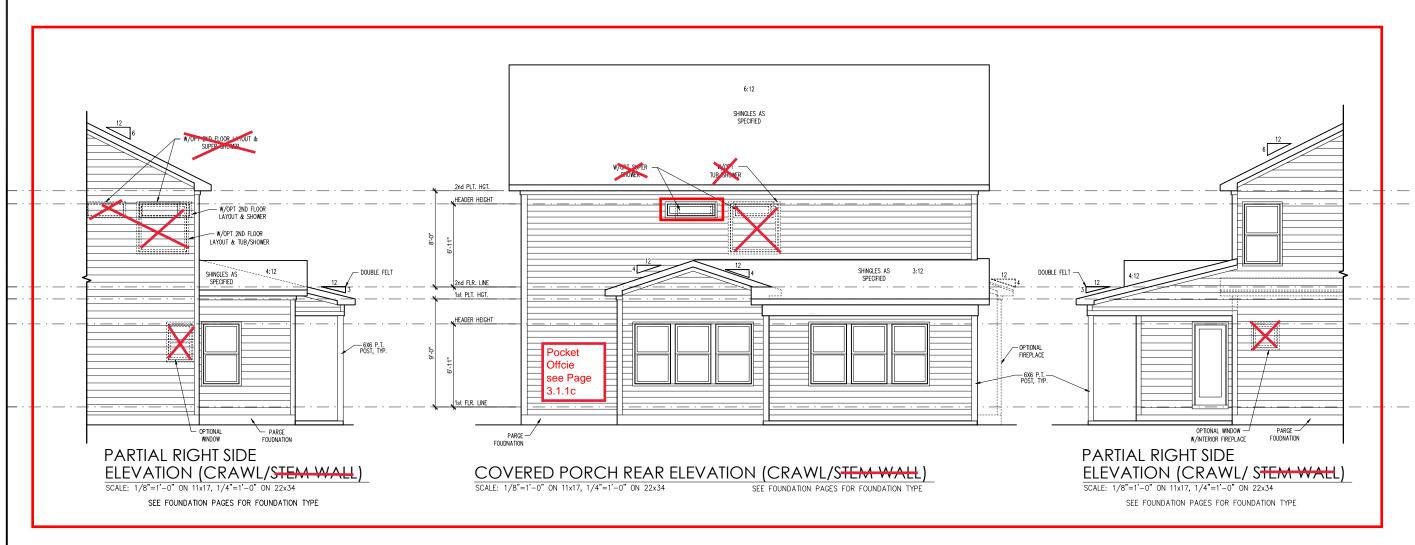

PLAN 4 - THE SELMA RH
SINGLE FAMILY
Covered Porch Plans & Elev(Crawl or Stem Wall) English
Country'

DRAWN BY: South Designs

ISSUE DATE: 07/01/2021

CURRENT REVISION DATE:
---SCALE:
1/8" = 1'-0"

2.4.1c

#### **General Elevation Notes**

General Elevation Notes shall apply unless noted otherwise on plan.

- Roof shall be finished with architectural composition shingles with slopes as noted on plan.
- Ridge Vent shall be provided and installed on all ridges greater than 6' in length per manufacturer's specifications.
- 3. Soffit Vent shall be continuous soffit vent
- House Wrap, "tyvek" or approved equal shall be installed over entire exterior wall per manufacturer's specifications and recommendations.
- Flashing shall be provided above all door and window openings, above finish wall material changes and at wall surfaces where lower roof areas abut vertical wall surfaces.
- Porch Railings shall be provided at all porch walking surfaces greater than 30" above adjacent finished grade. It shall be 36" high with guards spaced no more than 4" apart. Consult community specifications for material.
- Finish Wall Material shall be as noted on elevation drawings.
- 8. Brick Veneer, if included on elevation shall be tied to wall surface with galvanized corrugated metal lies at a rate of 24" oc horizontally and 16" oc vertically so that no more than 2.67sf of brick is supported by (1) tie. Space between face of wall and back face of brick shall be limited to a maximum of 1". Flashing shall be provided behind brick above all wall openings and at base of brick wall. Flashing shall be a minimum of 6-mil poly or other corrosion resistant material and shall be installed so that it laps under the house warp material a minimum of 2".

  Weepholes shall be provided at a rate of 48" oc and shall not be less than 3/16" in diameter and shall be located immediately above flashing.
- Brick Veneer Support Lintels shall be provided if brick veneer is included on elevation. Lintels shall be provided as listed in the following schedule and shall have a minimum bearing length of 6". Masonry Lintels shall be provided so that deflection is limited to L/600.

onry Opening Lintel Schedule

 Opening Size
 Angle

 up to 4'-0"
 3-1/2" x 3-1/2" x 5/16"

 1-1" to 5'-6"
 4" x 3-1/2" x 5/16" LLV

 5'-7" to 6'-6"
 5" x 3-1/2" x 5/16" LLV

 1-5" to 16'-4"
 6" x 3-1/2" x 5/16" LLV


 7" x 4" x 3/8" LLV

NOTE: MINIMUM 6:12 1'-0" ENERGY HEEL ON TRUSSES THAT ALLOWS FULL INSULATION ABOVE EXTERIOR WALLS 6" FASCIA -(TYP.) (TYP.) 4" FRIEZE BD 4" FRIEZE BD. 2nd PLT. HGT. 10" -SKIRTBOARD AS -SPECIFIED HEADER HEIGHT 6" HEAD · 4" WINDOW TRIM WNDOW TRIM 5" CORNER SHINGLES AS SPECIFIED 10" SKIRTBOARD AS SPECIFIED 1st PLT. HGT. HEADER HEIGHT — Bracket as Specified FRONT ELEVATION 'ENGLISH COUNTRY' (CRAWL/STEM WALL)

SCALE: 1/4" = 1'-0" ON 22x34, 1/8" = 1'-0" ON 11x17

For Rear Elevation see Page 2.4.1c Rear Covered Deck

But add Pocket Office, see left of this page

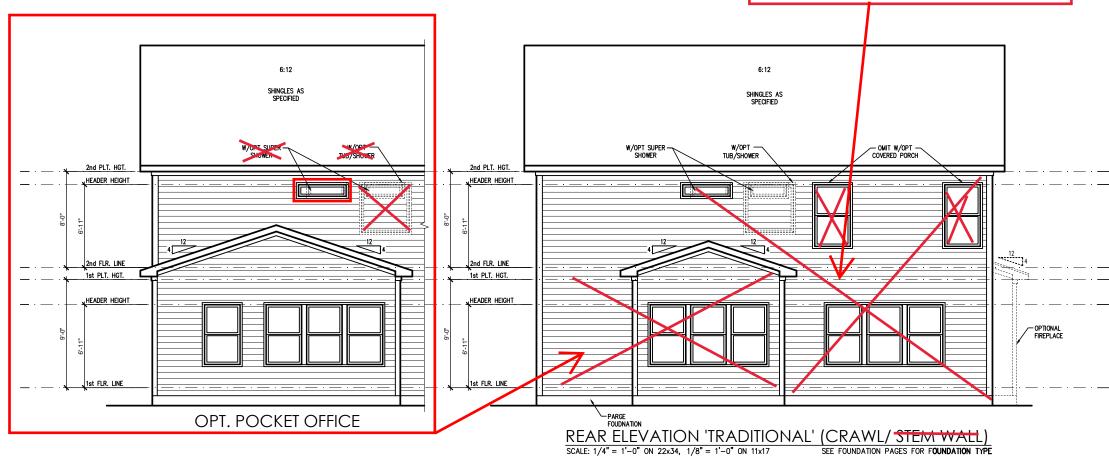

SEE FOUNDATION PAGES FOR FOUNDATION TYPE

ANDWIC.

PLAN 4 - THE SELMA RH SINGLE FAMILY Front & Rear Elevations (Crawl or Stem Wall) 'English Country'

DRAWN BY:
South Designs
ISSUE DATE:
07/01/2021
URRENT REVISION DATE:

3.1.1c


SCALE: 1/8" = 1'-0"

#### **General Elevation Notes**

General Elevation Notes shall apply unless noted otherwise on plan.

- Roof shall be finished with architectural c shingles with slopes as noted on plan.
- Ridge Vent shall be provided and installed on all ridges greater than 6' in length per manufacturer's specifications.
- Soffit Vent shall be continuous soffit vent
- House Wrap, "tyvek" or approved equal shall be installed over entire exterior wall per manufacturer's
- Flashing shall be provided above all door and window openings, above finish wall material changes and at wall surfaces where lower roof areas abut vertical wall surfaces.
- Porch Railings shall be provided at all porch walking surfaces greater than 30" above adjacent finished grade. It shall be 36" high with guards spaced no more than 4" apart. Consult community
- Finish Wall Material shall be as noted on elevation
- Brick Veneer, if included on elevation shall be tied to wall surface with galvanized corrugated metal ties at a rate of 24" oc horizontally and 16" oc verifically so that no more than 2.67st of brick is supported by (1) tie. Space between face of wall and back face of brick shall be limited to a maximum of 1". Flashing shall be provided behind brick above all wall openings and at base of brick wall. Flashing shall be a minimum of 6-mil poly or other corrosion resistant material and shall be installed so that it laps under the house wrap material a minimum of 2".

  Weepholes shall be provided at a rate of 48" oc and shall not be less than 3/16" in diameter and shall be located immediately above flashing.

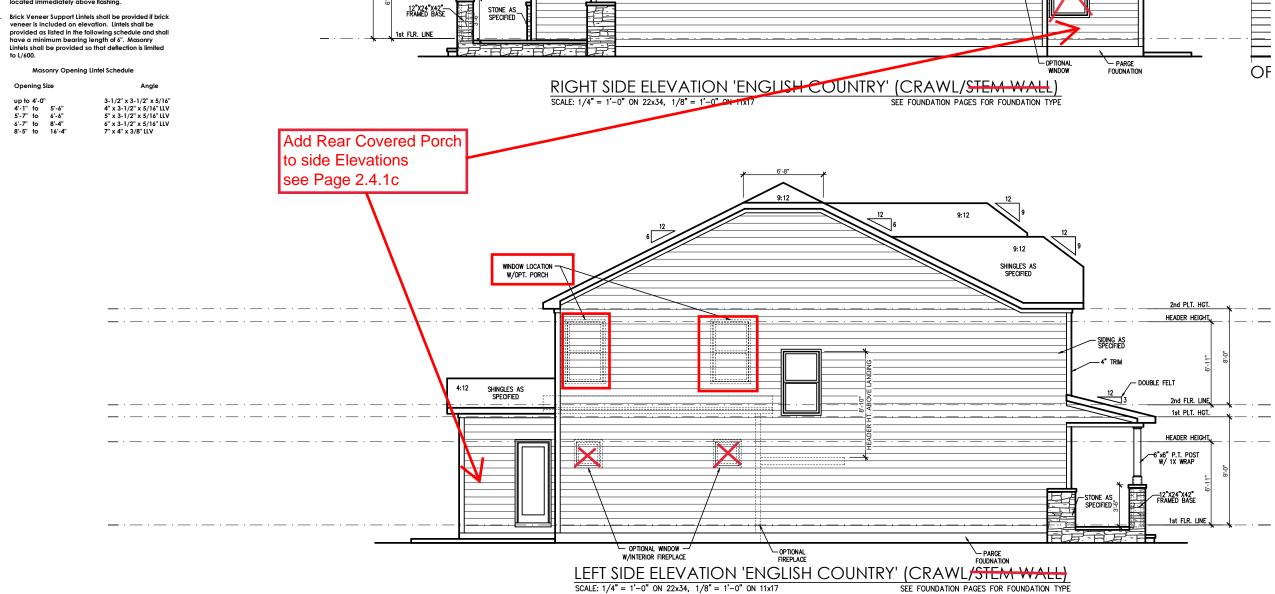

SHINGLES AS SPECIFIED

2nd PLT. HGT.

, HEADER HEIGHT

2nd FLR. LI 1st PLT. HGT HEADER HEIGHT



W/OPT 2ND FLOOR
LAYOUT & TUB/SHOWER


SHINGLES AS SPECIFIED

REV.#         DESCRIPTION         DATE           1         REPER TO COVER SHEET         11/22/2021           2         REPER TO COVER SHEET         12/08/2021           3         REPER TO COVER SHEET         2/4/2022           5         —         —           6         —         —           7         —         —           8         —         —	Щ.		_	_	_	_	_	_	_
	DATE	11/22/2021	12/08/2021	2/4/2022	3/30/2022				!
#	DESCRIPTION	REFER TO COVER SHEET	-	-	-	Ī			
	REV.#	1	2	3	4	2	9	7	8

- THE SELMA RH SINGLE FAMILY
Side Elevations (Crawl or Stem Wall)
'English Country' 4 **PLAN** 

South Designs ISSUE DATE: 07/01/2021 JRRENT REVISION DATE:

SCALE: 1/8" = 1'-0"

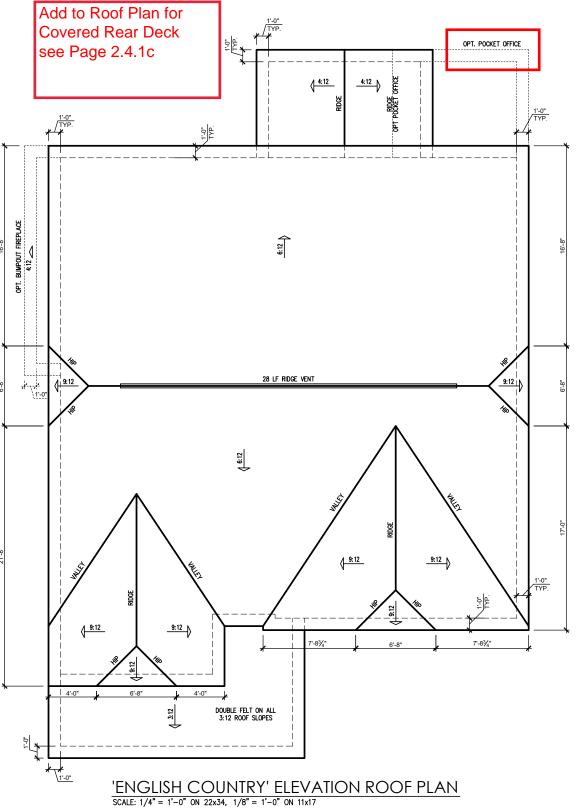

	ATTIC VENT SCHEDULE												
	'ENGLISH COUNTRY' ELEVATION												
MAIN	MAIN HOUSE			1514	AT / NEAR RIDGE			AT / NEAR EAVE					
VENT TYPE				SQ. FT. PERCENT OF TOTAL		POT SMALL (SQ. FT. EACH)	RIDGE VENT (SQ. FT. PER LF)	EAVE VENT (SQ. IN. EACH)	CONT. VENT (SQ. IN. PER LE)				
721111112	RAN		SUPPLIED	SUPPLIED	0.4236	0.2778	0.125	0.1944	0.0625				
RIDGE VENT	2.02	2.52	3.50	48.28	0	0	28.00						
SOFFIT VENTS	3.03	2.52	3.75	51.72	0				60.00				
TOTAL (MIN)	5.05	5.05	7.25	100.00	POT VENTS MAY BE REQUIRED IF THERE IS INSUFFICIENT RIDGE AVAILABLE								

\* SCHEDULE HAS BEEN CALCULATED ASSUMING EAVE VENTILATION AT 50-60% OF TOTAL AND RIDGE AT 40-50% OF TOTAL REQUIRED VENTILATION

ANDHC.

DATE	11/22/2021	12/08/2021	2/4/2022	3/30/2022		-	!	-
DESCRIPTION	REFER TO COVER SHEET		-	1	1			
REV.#	1	2	3	4	5	9	7	8

PLAN 4 - THE SELMA RH SINGLE FAMILY Roof Plan 'English Country'

DRAWN BY: South Designs

ISSUE DATE: 07/01/2021 CURRENT REVISION DATE:

SCALE: 1/8" = 1'-0"

3.3c

- BCI 5000s I.8 BY BC
- ALL WOOD I-JOISTS SHALL BE INSTALLED ACCORDING TO MANUFACTURER'S SPECIFICATIONS. • INSTALL SQUASH BLOCKS, WEB STIFFENERS, ETC.
- AS REQUIRED BY AND ACCORDING TO THE I-JOIST MANUFACTURER'S SPECIFICATIONS AND
- HANGERS FOR I-JOISTS ARE THE RESPONSIBILITY OF THE I-JOIST SUPPLIER.
- FLOOR TRUSSES BY THE MANUFACTURER MAY BE SUBSTITUTED FOR I-JOISTS.

#### TRUSS SYSTEM REQUIREMENTS NC (2018 NCRC): Wind: 115-120 mph

- TRUSS SYSTEM LAYOUTS (PLACEMENT PLANS) SHALL BE DESIGNED IN ACCORDANCE WITH SEALED STRUCTURAL PLANS. ANY NEED TO CHANGE TRUSSES SHALL BE COORDINATED WITH SOUTHERN ENGINEERS.
- TRUSS SCHEMATICS (PROFILES) SHALL BE PREPARED AND SEALED BY TRUSS MANUFACTURER.
- ALL TRUSSES SHALL BE DESIGNED FOR BEARING ON SPF #2 OR #3 PLATES OR LEDGERS (UNO).
- ALL REQUIRED ANCHORS FOR TRUSSES DUE TO UPLIFT OR BEARING SHALL MEET THE REQUIREMENTS AS SPECIFIED ON THE TRUSS SCHEMATICS.

#### FOUNDATION STRUCTURAL NOTES NC (2018 NCRC): Wind: 115-120 mph - CRAWL

(]. (3)2xIO SYP#2 OR SPF#2 GIRDER, TYPICAL UNO.

2 CONCRETE BLOCK PIER SIZE SHALL BE: HOLLOW UP TO 32" SIZE 12x16 UP TO 48" UP TO 9'-0" UP TO 64" UP TO 12'-0"

UP TO 96" WITH 30" x 30" x 10" CONCRETE FOOTING, UNO

3> WALL FOOTING AS FOLLOWS 8" - UP TO 2 STORY DEPTH:


10" - 3 STORY

16" - UP TO 2 STORY

20" - 3 STORY 16" - I STORY

20" - 2 STORY 24" - 3 STORY

- FOR FOUNDATION WALL HEIGHT AND BACKFILL REQUIREMENTS, REFER TO CODE TABLE R404.I.I (I THRU 4) NOTE: ASSUMED SOIL BEARING CAPACITY = 2000 PSE, CONTRACTOR MUST VERIEY SITE CONDITIONS AND CONTACT SOILS ENGINEER IF MARGINAL OR UNSTABLE SOILS ARE ENCOUNTERED.
- (4) 2xIO SPF #2 OR SYP #2 GIRDER
- (5) (2) 1.75×9.25 LVL OR LSL GIRDER
- 6 (3) 1.75×9.25 LVL OR LSL GIRDER
- "■" DESIGNATES A SIGNIFICANT POINT LOAD TO HAVE SOLID BLOCKING TO PIER. SOLID BLOCK ALL BEAM BEARING POINTS NOTED TO HAVE THREE OR MORE STUDS TO FND, TYPICAL.
- ABBREVIATIONS:
- "SJ" = SINGLE JOIST "DJ" = DOUBLE JOIST
- "TJ" = TRIPLE JOIST
- ADJUST SUBFLOOR THICKNESS OR JOIST SPACING AS REQ'D FOR FLOOR FINISH MATERIALS.

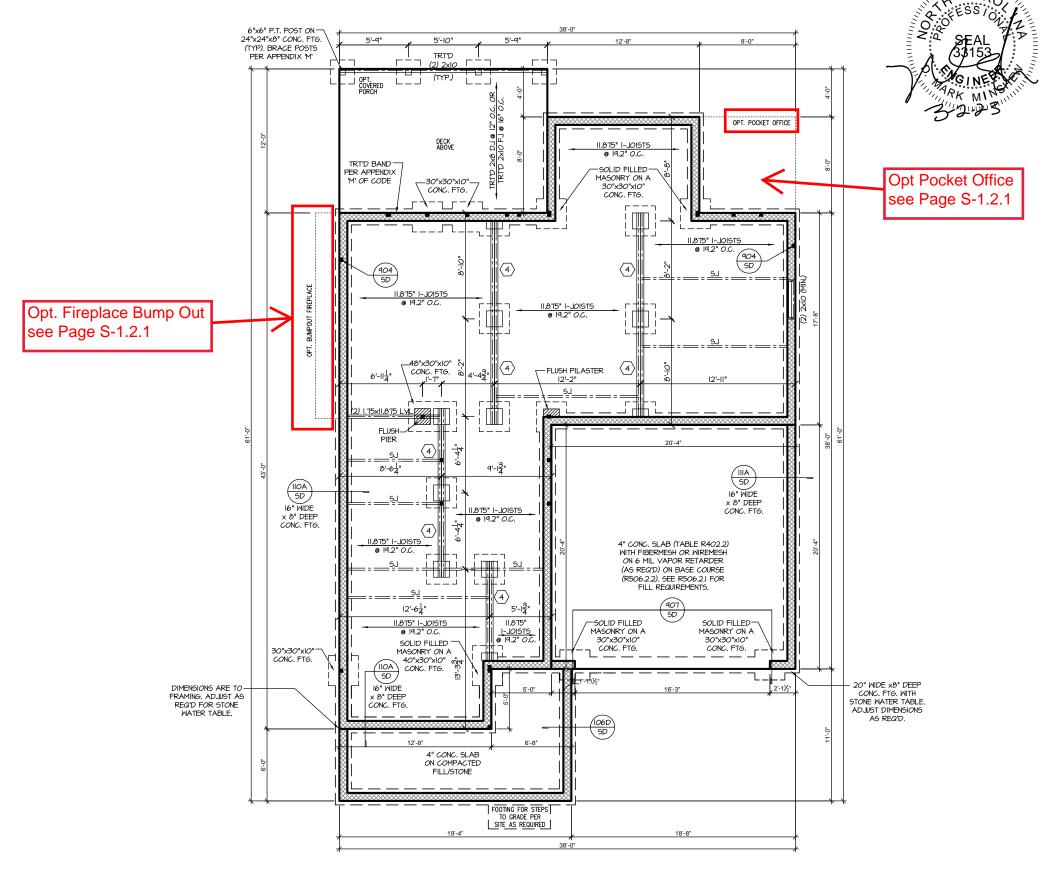


CRAWL SPACE FOUNDATION 'ENGLISH COUNTRY' SCALE: 1/8"=1'-0" ON 11x17, 1/4"=1'-0" ON 22x34


> REFER TO "SD" SHEET(S) FOR STANDARD DETAILS BRACING DETAILS AND STRUCTURAL NOTES


PROJECT # 21-2817-RH

P.A. 27609 Southern Engineers, F 3716 Benson Drive, Raleigh, NC 2 Phone: (919) 878-1617

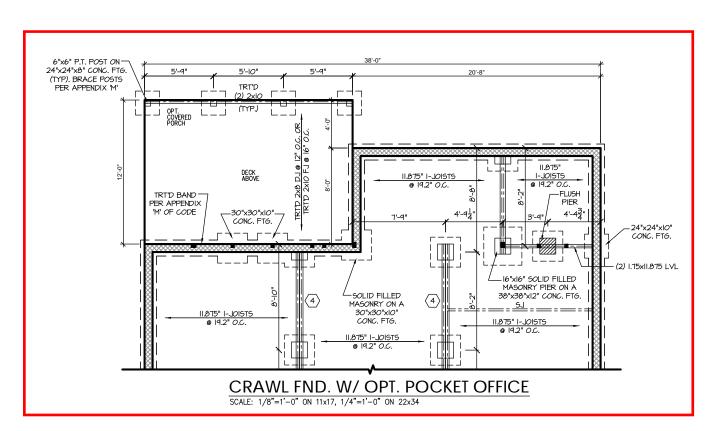



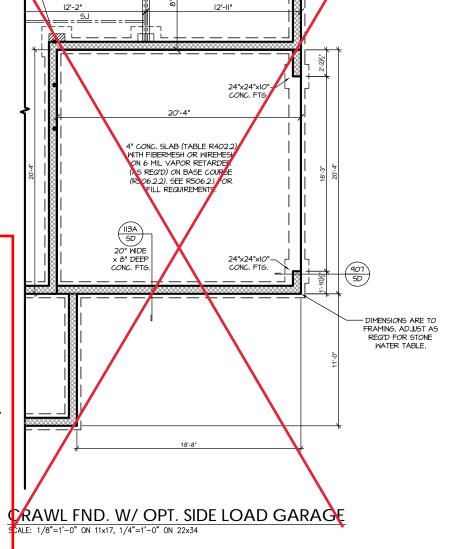

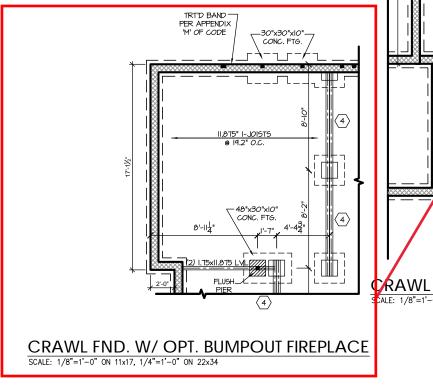

REFER TO "SD" SHEET(S) FOR STANDARD DETAILS, BRACING DETAILS AND STRUCTURAL NOTES. PROJECT # 21-2817-RH

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SOUTH DESIGNS

RH Selma NEW HOME, INC. The 8 Plan

S-1.2.

- I. TRUSS SYSTEM LAYOUTS (PLACEMENT PLANS) SHALL BE DESIGNED IN ACCORDANCE NITH SEALED STRUCTURAL PLANS, ANY NEED TO CHANGE TRUSSES SHALL BE COORDINATED WITH SQUITHERN ENGINEERS.
- TRUSS SCHEMATICS (PROFILES) SHALL BE PREPARED
  AND SEALED BY TRUSS, MANUFACTURER
- ALL TRUSSES SHALL BE DESIGNED FOR BEARING ON SPF #2 OR #3 PLATES OR LEDGERS (UNO).
- 4. ALL REQUIRED ANCHORS FOR TRUSSES DUE TO UPLIFT OR BEARING SHALL MEET THE REQUIREMENTS AS SPECIFIED ON THE TRUSS SCHEMATICS.

#### HEADER/BEAM & COLUMN NOTES


- I. ALL EXTERIOR AND LOAD BEARING HEADERS SHALL BE MIN. (2)2x6 (4" WALL) OR (3)2x6 (6" WALL) WITH (1) SUPPORT STIID, IN 1895 NOTED OTHERWISE
- 2. THE NUMBER SHOWN AT BEAM AND HEADER SUPPORTS INDICATES THE NUMBER OF SUPPORT STUDS REQUIRED IN STUD POCKET OR COLUMN. THE NUMBER OF KING STUDS AT EACH END OF HEADERS IN EXTERIOR WALLS SHALL BE ACCORDING TO ITEM "d" IN TABLE R602.3(5) OR AS BELOW PER NCDOI COMMENTARY "KING STUDS AT WALL OPENINGS" REVISED 1-4-2020;
- UP TO 3' SPAN: (I) KING STUD
- OVER 3' UP TO 6' SPAN: (2) KING STUDS
- OVER 6' UP TO 9' SPAN: (3) KING STUDS
- OVER 9' UP TO 12' SPAN: (4) KING STUDS
- OVER 12' UP TO 15' SPAN: (5) KING STUDS

#### FRAMING NOTES

NC (2018 NCRC): Wind: 115-120 mph

- I. BRACING METHOD AND TYPE; CONTINUOUSLY SHEATHED MSP; C5-MSP, NOTE THAT THE MALL BRACING AMOUNT PROVIDED ON THE PLANS (DETAILS AND SPECIFICATIONS) IS GREATER THAN THE AMOUNT OF WALL BRACING REQUIRED BY SECTION R602.10 OF THE CODE. SEE NOTES BELOW FOR DETAILS AND SPECIFICATIONS FOR WALL BRACING AND WALL FRAMING.
- 2. EXTERIOR WALL SHEATHING; WALLS SHALL BE BRACED BY SHEATHING WALLS ON ALL STORIES WITH MOOD STRUCTURAL PANEL SHEATHING (MSP) (EXPOSURE B: 17/16". EXPOSURE C: 15/32"), SHEATHING SHALL BE ATTACHED WITH 8d NAILS AT A 6"/12" NAILING PATTERN (6" OC AT PANEL EDGES AND 12" OC AT INTERWEDIATE SUPPORTS). INSTALL BLOCKING AT ALL PANEL EDGES.
- 3. MSP SHEATHING SHALL EXTEND TO THE UPPERMOST DOUBLE BEARING PLATE. BLOCK AT ROOF PER SECTION R602.10.45 AND ATTACH BRACED WALLS PER CODE. MSP SHEATHING BETWEEN FLOORS SHALL BE SPLICED ALONG CONTINUOUS BAND OR THE MSP SHEATHING MAY BE SPLICED ACROSS STUDS (CONTINUOUS ACROSS FLOOR SYSTEM) WITH BLOCKING AT PANEL EDGES, (MINIMUM 12" BEYOND FLOOR BREAK) OR OTHER APPROVED METHOD.
- 4. "HD" = HOLDOWN: HOLD-DOWN DEVICE (NOTED AS "HD" ON PLANS) SHALL BE AN 800 POUND CAPACITY ASSEMBLY AS NOTED ON PLANS, SEE DETAILS FOR HD ASSEMBLY.
- \*\*\*GROUND/FIRST FLOOR: USE "HD HOLD-DOWN DETAIL" ON SD SHEET (OR EQUIV.)

  \*\*\*INDEED EL CODE, ATTACH BASE OF KING STID MITH A SIMBOO
- \*\*UPPER FLOORS: ATTACH BASE OF KING STUD WITH A SIMPSON CS22 STRAP DOWN ACROSS THE BAND AND DOWN TO A STUD BELOW BAYEND TO BELOW EXTEND STRAP IT MIN ALONG EACH STUD (OR HEADER) AND ATTACH EACH END W (1) 8d NAILS.
- INTERIOR BRACED WALL: (NOTED AS "IBN" ON PLANS) ATTACH I/2" 6YPSUM BOARD (6B) ON EACH SIDE OF WALL WITH A MIN. OF 5d COOLER NAILS OR #6 SCREWS ® 1" O.C. ALONG THE EDGES AND AT INTERNEDIATE SUPPORTS.
- 6. INTERIOR BRACED WALL-WOOD STRUCTURAL PANEL: (NOTED AS "IBM-MSP" ON PLANS). ATTACH ONE SIDE WITH 36" WSP SHEATHING WITH 36 NAILS AT A 6"/12" NAILING PATTERN (6" OC AT PANEL EDGES AND 12" OC AT INTERMEDIATE SUPPORTS). INSTALL BLOCKING AT ALL PANEL EDGES. ATTACH 6B OVER WSP AS REQUIRED. ATTACH OPPOSITE SIDE WITH 1/2" GB WITH A MIN. OF 5d COOLER NAILS OR #6 SCREMS @ 7" OC ALONG THE EDGES AND AT INTERMEDIATE SUPPORTS

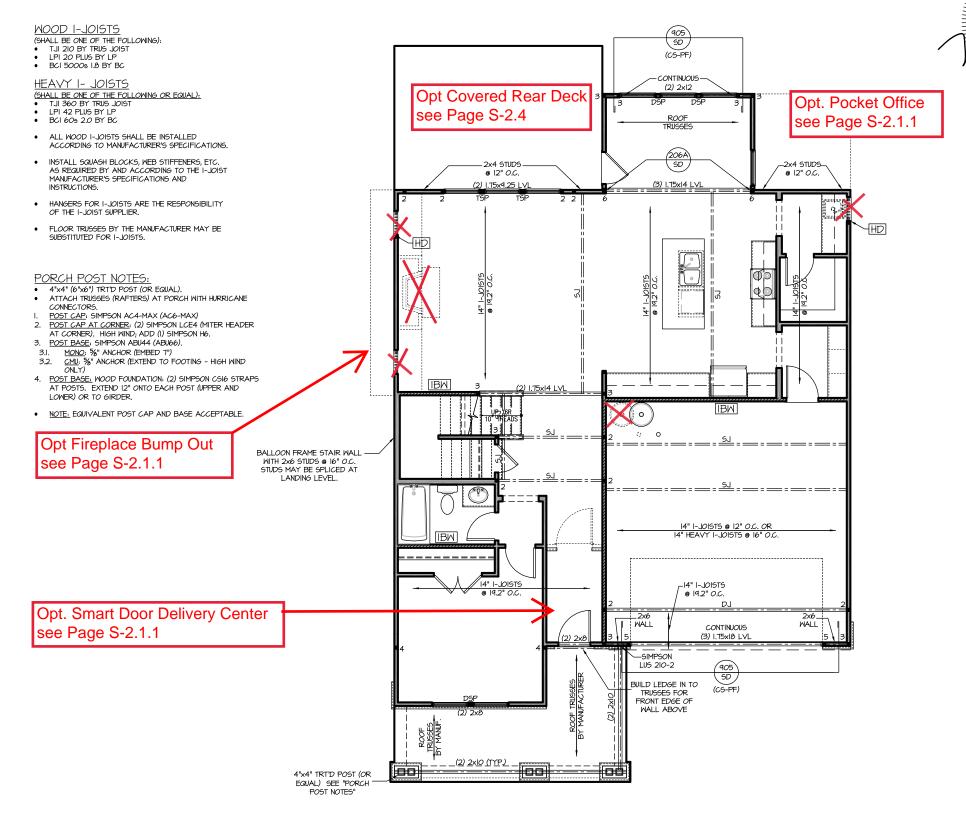

FIRST FLOOR PLAN 'ENGLISH COUNTRY'

SCALE: 1/8"=1'-0" ON 11x17, 1/4"=1'-0" ON 22x34

PROJECT # 21-2817-RH

CARO

are to be brought to the rs. Failure to do so will r from date of seal. terms & conditions as

include construction means, methods, tech ocediures or safety precautions.
so of discrepancies on plans are to be brough tention of Southern Engineers. Failure to do I Engineer's liability.
r projects permitted one year from date of is

Southern Engineers, P.A. Scanning State Benson Drive, Raleigh, NC 27609 A Phone: (919) 878-1617 Electronse: C-4772


SOUTH DESIGNS


04 - The Selma - RH
NEW HOME, INC.


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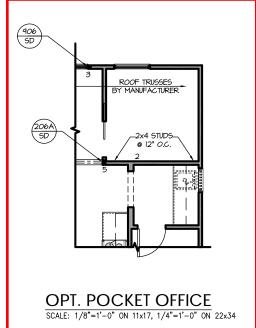
Plan


REFER TO "5D" SHEET(5) FOR STANDARD DETAILS, BRACING DETAILS AND STRUCTURAL NOTES.



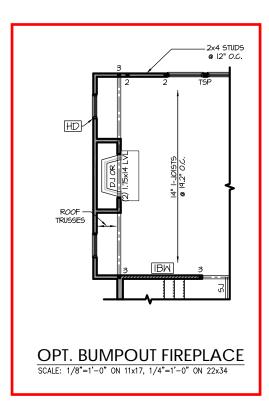

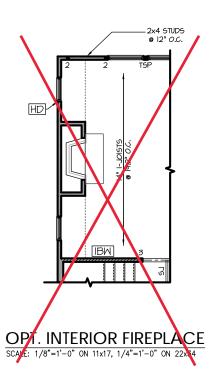

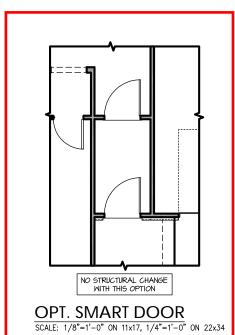

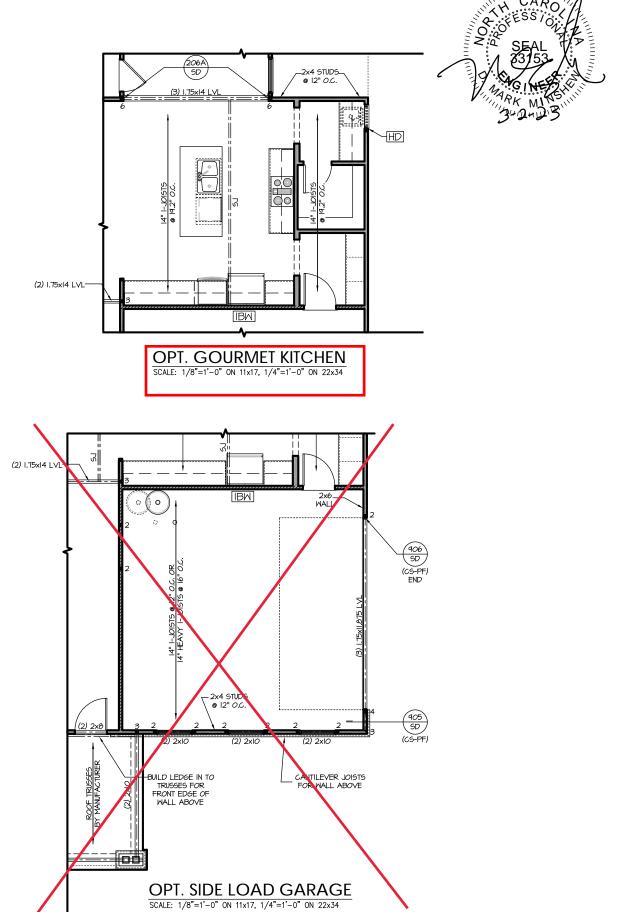

PROJECT # 21-2817-RH

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SOUTH DESIGNS

RH The Selma NEW HOME, INC. 8 Plan (

REFER TO "SD" SHEET(S) FOR STANDARD DETAILS, BRACING DETAILS AND STRUCTURAL NOTES.

#### TRUSS SYSTEM REQUIREMENTS

NC (2018 NCRC): Wind: 115-120 mph

- TRUSS SYSTEM LAYOUTS (PLACEMENT PLANS) SHALL BE DESIGNED IN ACCORDANCE WITH SEALED STRUCTURAL PLANS. ANY NEED TO CHANGE TRUSSES SHALL BE
- TRUSS SCHEMATICS (PROFILES) SHALL BE PREPARED
- ALL TRUSSES SHALL BE DESIGNED FOR BEARING ON SPF #2 OR #3 PLATES OR LEDGERS (UNO).
- ALL REQUIRED ANCHORS FOR TRUSSES DUE TO UPLIFT OR BEARING SHALL MEET THE REQUIREMENTS AS SPECIFIED ON THE TRUSS SCHEMATICS.

#### HEADER/BEAM & COLUMN NOTES


- ALL EXTERIOR AND LOAD BEARING HEADERS SHALL SUPPORT STUD, UNLESS NOTED OTHERWISE.
- 2. THE NUMBER SHOWN AT BEAM AND HEADER SUPPORTS INDICATES THE NUMBER OF SUPPORT STUDS REQUIRED IN STUD POCKET OR COLUMN. THE NUMBER OF KING STUDS AT EACH END OF HEADERS IN EXTERIOR WALLS SHALL BE ACCORDING TO ITEM "d" IN TABLE R602.3(5) OR AS BELOW PER NCDOI COMMENTARY "KING STUDS AT WALL OPENINGS" REVISED 1-9-2020: UP TO 3' SPAN: (1) KING STUD
- OVER 3' UP TO 6' SPAN: (2) KING STUDS
- OVER 6' UP TO 9' SPAN: (3) KING STUDS
- OVER 9' UP TO 12' SPAN: (4) KING STUDS
- OVER 12' UP TO 15' SPAN: (5) KING STUDS

#### FRAMING NOTES

NC (2018 NCRC): Wind: 115-120 mph

- BRACING METHOD AND TYPE: CONTINUOUSLY SHEATHED WSP: CS-MSP. NOTE THAT THE WALL BRACING AMOUNT PROVIDED ON THE PLANS (DETAILS AND SPECIFICATIONS) IS GREATER THAN THE AMOUNT OF WALL BRACING REQUIRED BY SECTION R602.10 OF THE CODE. SEE NOTES BELOW FOR DETAILS AND SPECIFICATIONS FOR WALL BRACING AND WALL FRAMING.
- EXTERIOR WALL SHEATHING: WALLS SHALL BE BRACED BY
  SHEATHING WALLS ON ALL STORIES WITH WOOD STRUCTURAL PANEL SHEATHING (WGP) (EXPOSURE B: T/16", EXPOSURE C: 15/32").
  SHEATHING SHALL BE ATTACHED WITH 8d NAILS AT A 6"/12" NAILING PATTERN (6" OC AT PANEL EDGES AND 12" OC AT INTERMEDIATE SUPPORTS). INSTALL BLOCKING AT ALL PANEL EDGES.
- 3. WSP SHEATHING SHALL EXTEND TO THE UPPERMOST DOUBLE BEARING PLATE. BLOCK AT ROOF PER SECTION R602.10.4.5 AND ATTACH BRACED WALLS PER CODE. WSP SHEATHING BETWEEN FLOORS SHALL BE SPLICED ALONG CONTINUOUS BAND OR THE WSP SHEATHING MAY BE SPLICED ACROSS STUDS (CONTINUOUS ACROSS FLOOR SYSTEM) WITH BLOCKING AT PANEL EDGES. (MINIMUM 12" BEYOND FLOOR BREAK) OR OTHER APPROVED METHOD.
- 4. "HD" = HOLDOWN: HOLD-DOWN DEVICE (NOTED AS "HD" ON PLANS) SHALL BE AN 800 POUND CAPACITY ASSEMBLY AS NOTED ON PLANS, SEE DETAILS FOR HD ASSEMBLY.
- \*\*GROUND/FIRST FLOOR: USE "HD HOLD-DOWN DETAIL" ON SD SHEET (OR EQUIV.)
- STEEL (OR EGOIV)

  "UPPER ILOORS, ATTACH BASE OF KING STUD WITH A SIMPSON C522 STRAP DOWN ACROSS THE BAND AND DOWN TO A STUD BELOW OR HEADER BELOW. EXTEND STRAP T" MIN ALONG EACH STUD (OR HEADER) AND ATTACH EACH END W (1) 8d NAILS.
- 5. INTERIOR BRACED WALL: (NOTED AS "IBW" ON PLANS) ATTACH I/2" GYPSUM BOARD (GB) ON EACH SIDE OF WALL WITH A MIN. OF 5d COOLER NAILS OR #6 SCREWS @ 7" O.C. ALONG THE EDGES AND AT INTERMEDIATE SUPPORTS.
- 6. INTERIOR BRACED WALL-WOOD STRUCTURAL PANEL: (NOTED AS "IBM-WSP" ON PLANS). ATTACH ONE SIDE WITH 1/6" WSP SHEATHING MITH 8d NAILS AT A 6"/12" NAILING PATTERN (6" OC AT PANEL EDGES AND 12" OC AT INTERMEDIATE SUPPORTS). INSTALL BLOCKING AT ALL PANEL EDGES, ATTACH 6B OVER WEP AS REQUIRED. ATTACH OPPOSITE SIDE WITH 1/2" 6B WITH A MIN. OF 5d COOLER NAILS OR #6 SCREWS @ 1" OC ALONG THE EDGES AND AT

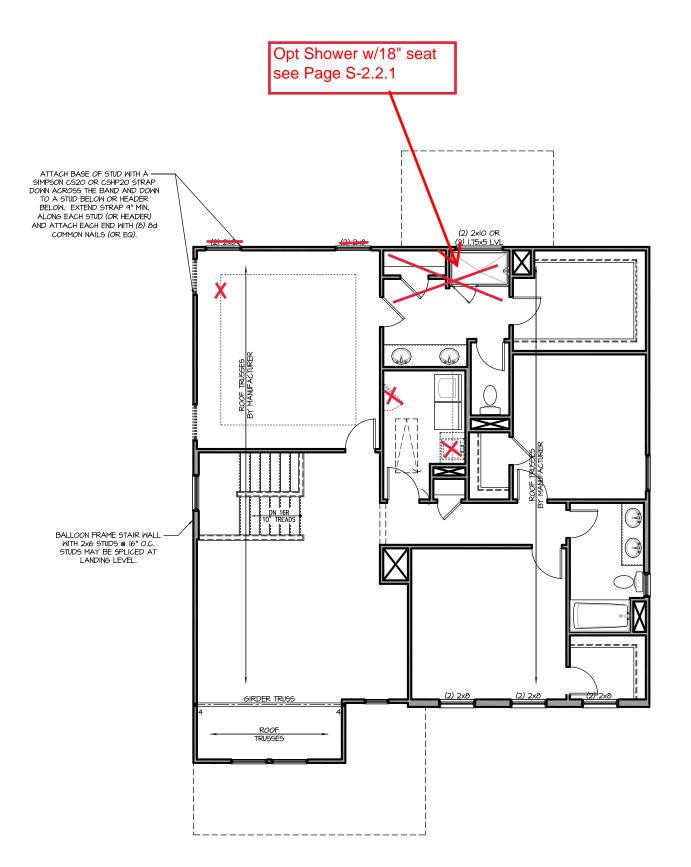

SECOND FLOOR PLAN 'ENGLISH COUNTRY'

SCALE: 1/8"=1'-0" ON 11x17, 1/4"=1'-0" ON 22x34

PROJECT # 21-2817-RH


P.A. 27609 Engineers, Drive, Raleigh, NC Southern E
3716 Benson Dri
Phone: (

SOUTH DESIGNS

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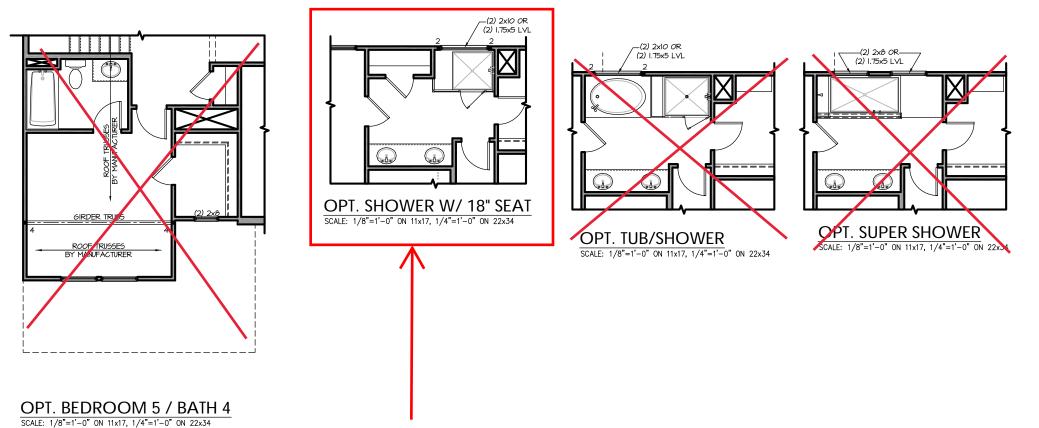
Plan

REFER TO "SD" SHEET(S) FOR STANDARD DETAILS BRACING DETAILS AND STRUCTURAL NOTES

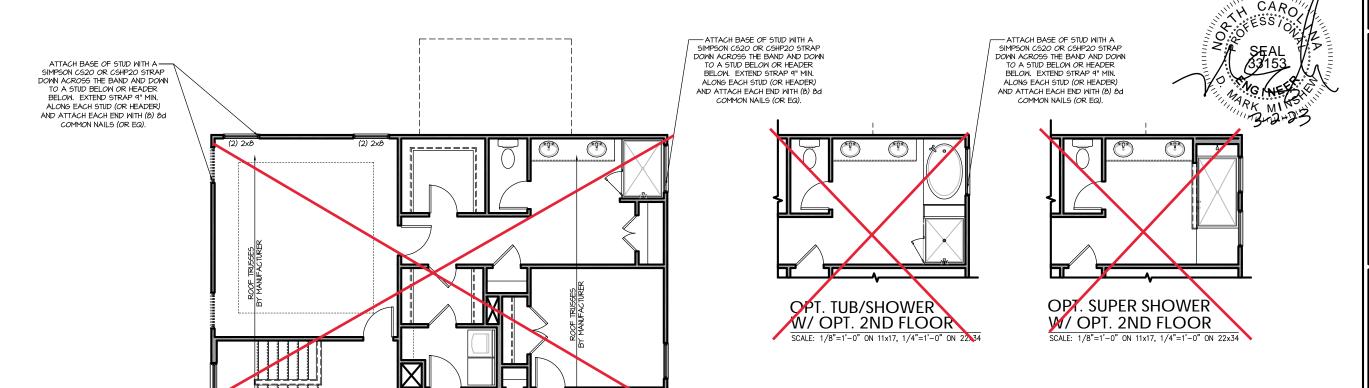

OPT. 2ND FLOOR

SCALE: 1/8"=1'-0" ON 11x17, 1/4"=1'-0" ON 22x34



REFER TO "SD" SHEET(S) FOR STANDARD DETAILS, BRACING DETAILS AND STRUCTURAL NOTES.

PROJECT # 21-2817-RH

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SOUTH DESIGNS

RH Selma NEW HOME, Plan

#### TRUSS SYSTEM REQUIREMENTS

NC (2018 NCRC): Wind: 115-120 mph


- TRUSS SYSTEM LAYOUTS (PLACEMENT PLANS) SHALL BE DESIGNED IN ACCORDANCE WITH SEALED STRUCTURAL PLANS. ANY NEED TO CHANGE TRUSSES SHALL BE COORDINATED WITH SOUTHERN ENGINEERS.
- 2. TRUSS SCHEMATICS (PROFILES) SHALL BE PREPARED AND SEALED BY TRUSS MANUFACTURER.
- ALL TRUSSES SHALL BE DESIGNED FOR BEARING ON SPF #2 OR #3 PLATES OR LEDGERS (UNO).
- ALL REQUIRED ANCHORS FOR TRUSSES DUE TO UPLIFT OR BEARING SHALL MEET THE REQUIREMENTS AS SPECIFIED ON THE TRUSS SCHEMATICS.

#### TRUSS SYSTEM REQUIREMENTS NC (2018 NCRC): Wind: 115-120 mph

- TRUSS SYSTEM LAYOUTS (PLACEMENT PLANS)
  SHALL BE DESIGNED IN ACCORDANCE WITH SEALED STRUCTURAL PLANS, ANY NEED TO CHANGE TRUSSES SHALL BE COORDINATED WITH SOUTHERN
- TRUSS SCHEMATICS (PROFILES) SHALL BE PREPARED AND SEALED BY TRUSS MANUFACTURER. 2.
- ALL TRUSSES SHALL BE DESIGNED FOR BEARING ON SPF #2 OR #3 PLATES OR LEDGERS (UNO).
- ALL REQUIRED ANCHORS FOR TRUSSES DUE TO UPLIFT OR BEARING SHALL MEET THE REQUIREMENTS AS SPECIFIED ON THE TRUSS SCHEMATICS.

	ATTIC VENT SCHEDULE												
'ENGLISH COUNTRY' ELEVATION													
MAIN HOUSE SQ FTG 1514 AT / NEAR RIDGE					AT / NE	AR EAVE							
VENT TYPE	SQ. FT. VENT TYPE REQUIRED		SQ. FT.	PERCENT OF TOTAL	POT LARGE (SQ. FT. EACH)	POT SMALL (SQ. FT. EACH)	RIDGE VENT (SQ. FT. PER LF)	EAVE VENT (SQ. IN. EACH)	CONT. VENT (SQ. IN. PER LF)				
	RAN	IGE	SUPPLIED	SUPPLIED	SUPPLIED	0.4236	0.2778	0.125	0.1944	0.0625			
RIDGE VENT	2.02	2.52	3.50	48.28	0	0	28.00						
SOFFIT VENTS	3.03	2.52	3.75	51.72				0	60.00				
TOTAL (MIN)	5.05	5.05	7.25	100.00	POT VENTS MAY BE REQUIRED IF THERE IS INSUFFICIENT RIDGE AVAILABLE								

<sup>\*</sup> SCHEDULE HAS BEEN CALCULATED ASSUMING EAVE VENTILATION AT 50-60% OF TOTAL AND RIDGE AT 40-50% OF TOTAL REQUIRED VENTILATION

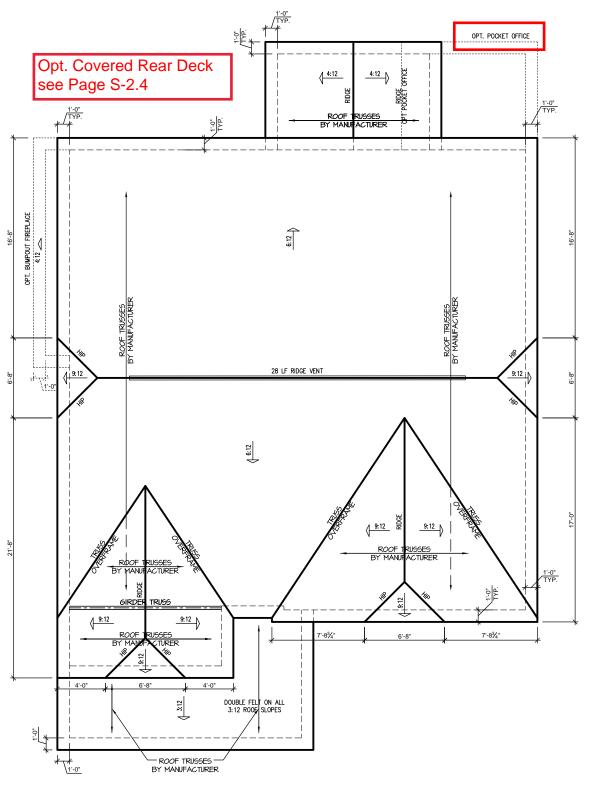

'ENGLISH COUNTRY' ELEVATION ROOF PLAN SCALE: 1/4" = 1'-0" ON 22x34, 1/8" = 1'-0" ON 11x17

PROJECT # 21-2817-RH


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SOUTH DESIGNS

RH Selma NEW HOME,

Plan

REFER TO "SD" SHEET(S) FOR STANDARD DETAILS, BRACING DETAILS AND STRUCTURAL NOTES.

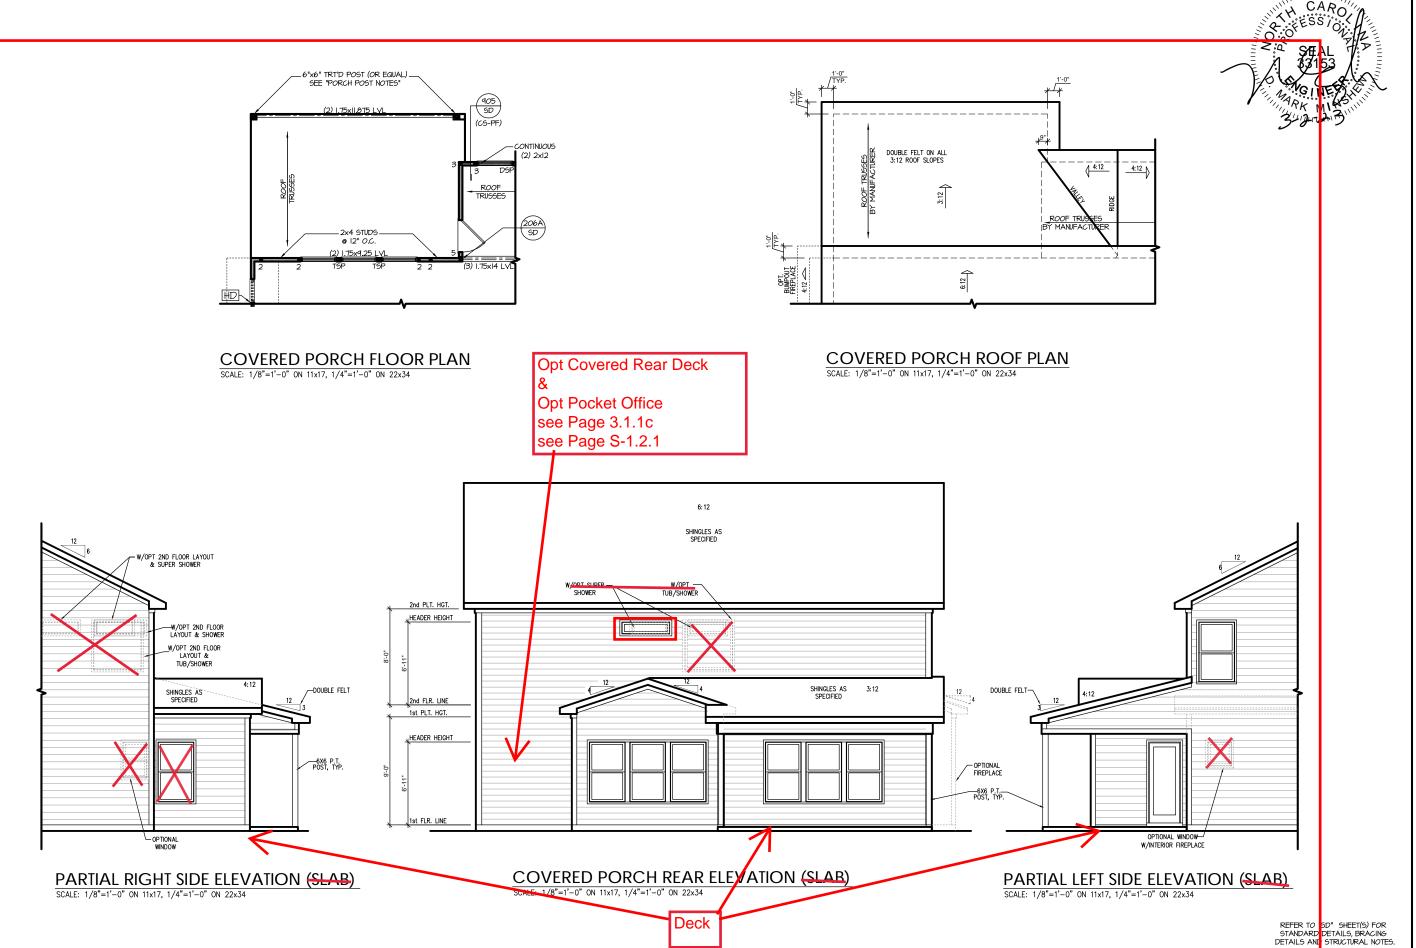

PROJECT # 21-2817-RH

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