



MONOLITHIC SLAB

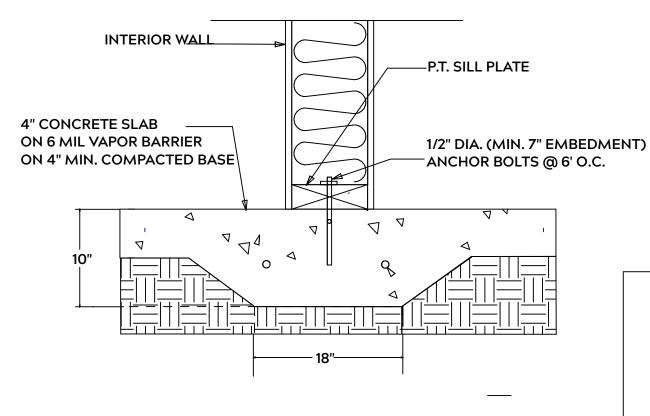

LUG FOOTING

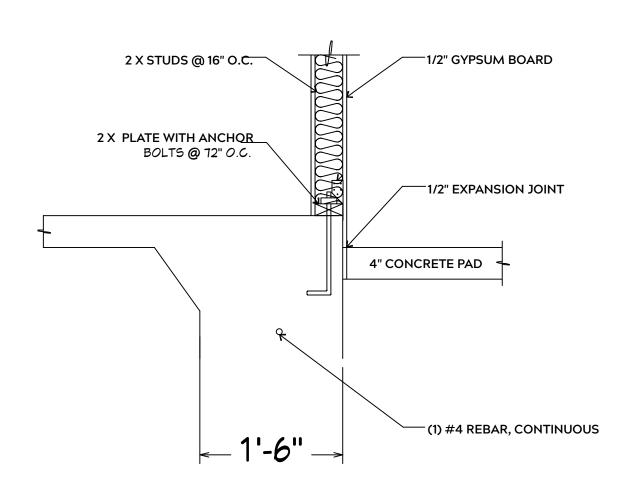

FOUNDATION NOTES:

GENERAL FRAMING NOTES:

TO ITS ORIGINAL CAPACITY

AND USE 3 X 16d NAILS 2" IN AT EACH END.

PRESSURE TREATED

AND / OR KILN DRIED

ENGINEER

TREATED

ALL FOOTINGS SHALL BEAR ON ORIGINAL UNDISTURBED SOIL THE 28 DAY COMPRESSIVE STRENGTH OF ALL FOOTINGS IS 3000 PSI

PROVIDE WATER PROOFING AND PERIMTER DRAINS AS REQUIRED

FOOTING WIDTHS ARE BASED ON A LOAD BEARING SOIL CAPACITY OF 2000 PSI

PROVIDE 6 MIL POLY VAPOR BARRIER TO COVER GROUND IN CRAWL SPACE AND GROUND UNDER POURED CONCRETE

ALL ANCHOR BOLTS TO BE 1/2" X 12" LONG.
ANCHOR BOLTS SHALL BE SPACED AT A
MAXIMUM OF 6' ON CENTER AND NO MORE
THEN 1' FROM EACH CORNER

ALL LUMBER IN CONTACT WITH CONCRETE OR MASONRY SHALLE BE

FRAMING LUMBER SHALL BE SYP #2 GRADE AND / OR SPRUCE PINE FIR #1

SHALL PROVIDE DRAWINGS / SCHEMATICS, WHICH SHALL BEAR OF A N.C.

STUDS AND JOISTS SHALL NOT BE CUT TO INSTALL PLUMBING OR WIRING

NAIL MULTIPLE MEMBERS WITH 2 ROWS OF 16d NAILS STAGGERED 32" O.C.

ALL FRAMING TO BE 16" O.C. WALL FRAMING DIMENSIONS ARE BASED ON 2X4

OR 2X6 EXTERIOR WALLS AND 2X4 INTERIOR WALLS. DOULBE / TRIPLE JACK

ALL EXPOSED FRAMING ON PORCHES OR DECKS SHALL BE PRESSURE

NAIL FLOOR JOISTS TO SILL PLATE WITH WITH 8d TOE NAILS


PROVIDE WATERPROOFING AND DRAINS AS REQUIRED

STUDS AS NECESSARY UNDER HEADERS AS REQUIRED

LVL'S TO BE SIZED BY OTHERS (TRUSS MANUFACTURER)

WITHOUT ADDING METAL OR WOOD SIDE PANELS TO STRENGTHEN MEMBER


WHERE PRE-ENGINEERED JOISTS AND TRUSSES ARE USED, MANUFACTURER

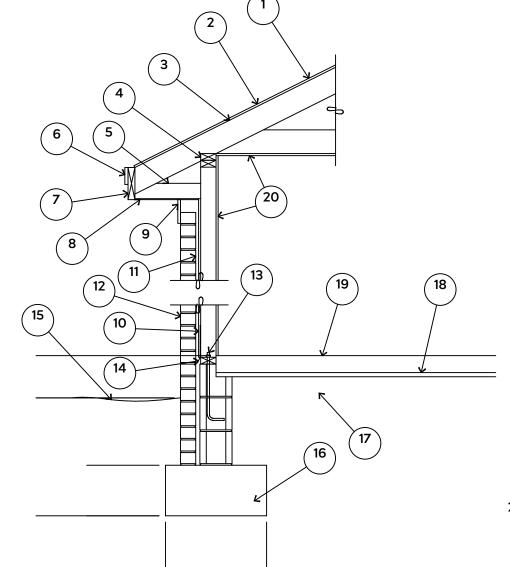

- 1. 15# FELT UNDERLAYMENT UNDER COMPOSITION SHINGLES.
- 2. ROOF DECKING.
- 3. 2 X RAFTERS / ENGINEERED TRUSSES
- 4. DOUBLE TOP PLATE.
- 5. 2 X 4 RETURN.6. 3/4" FASCIA OR PVC TRIM COIL
- 7. 2 X FASCIA
- 8. 1/4" PLYWOOD OR VINYL SOFFIT
- 9. 1X FREIZE BOARD (TO BE USED WITH BRICK VENEERS)
- 10. INSULATION BOARD OR HOUSE WRAP
- 11. AIR SPACE.12 BRICK WITH BRICK TIES PER
- MANUFACTURER'S

 SPECIFICATIONS.
- 13. 1/2" X 12" ANCHOR BOLTS, 6'-0" O.C., 12" FROM CORNERS.
- 14. FLASHING WITH WEEP HOLES @ 48" O.C.
- 48" O.C. 15. FINISHED GRADE.
- 16. FOOTING
- 17. COMPACTED EARTH FILL
- 18. 6 MIL. VAPOR BARRIER
- 19. 4" CONCRETE SLAB, 3,000 P.S.I. WITH 6" X 6" 10 GA. X 10 GA. WELDED WIRE FABRIC.
- 20. 1/2" GYPSUM BOARD.

EXTERIOR WALL SECTION

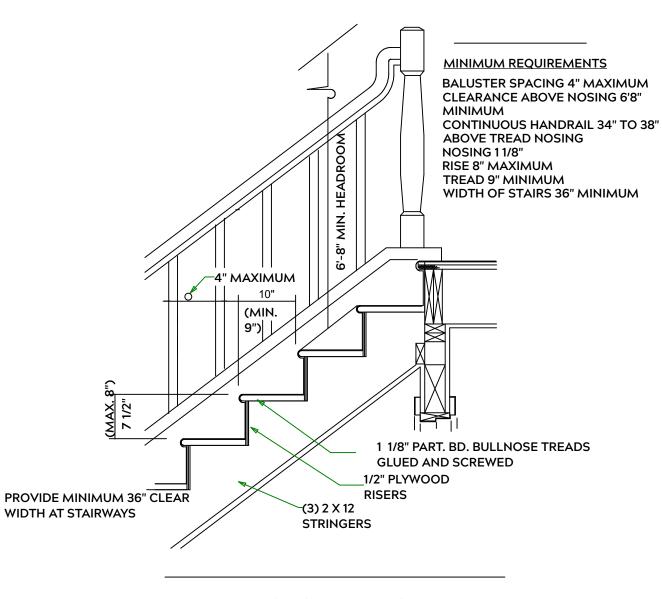

STAIR DETAIL

INTERIOR WALL @ GARAGE STEP DOWN

PLAN: Rothbard w/ Porch

ETAIL SHEETS

PROJECT ADDRESS: 341 Solomon Dr. Liberty Meadows Lot 42

omes 3

Precision Custom Homes Raeford, NC Shaun@PrecisionCustomHomesh

DATE:


7/20/23

SCALE:

1/4" = 1'

SHEET:


A-3

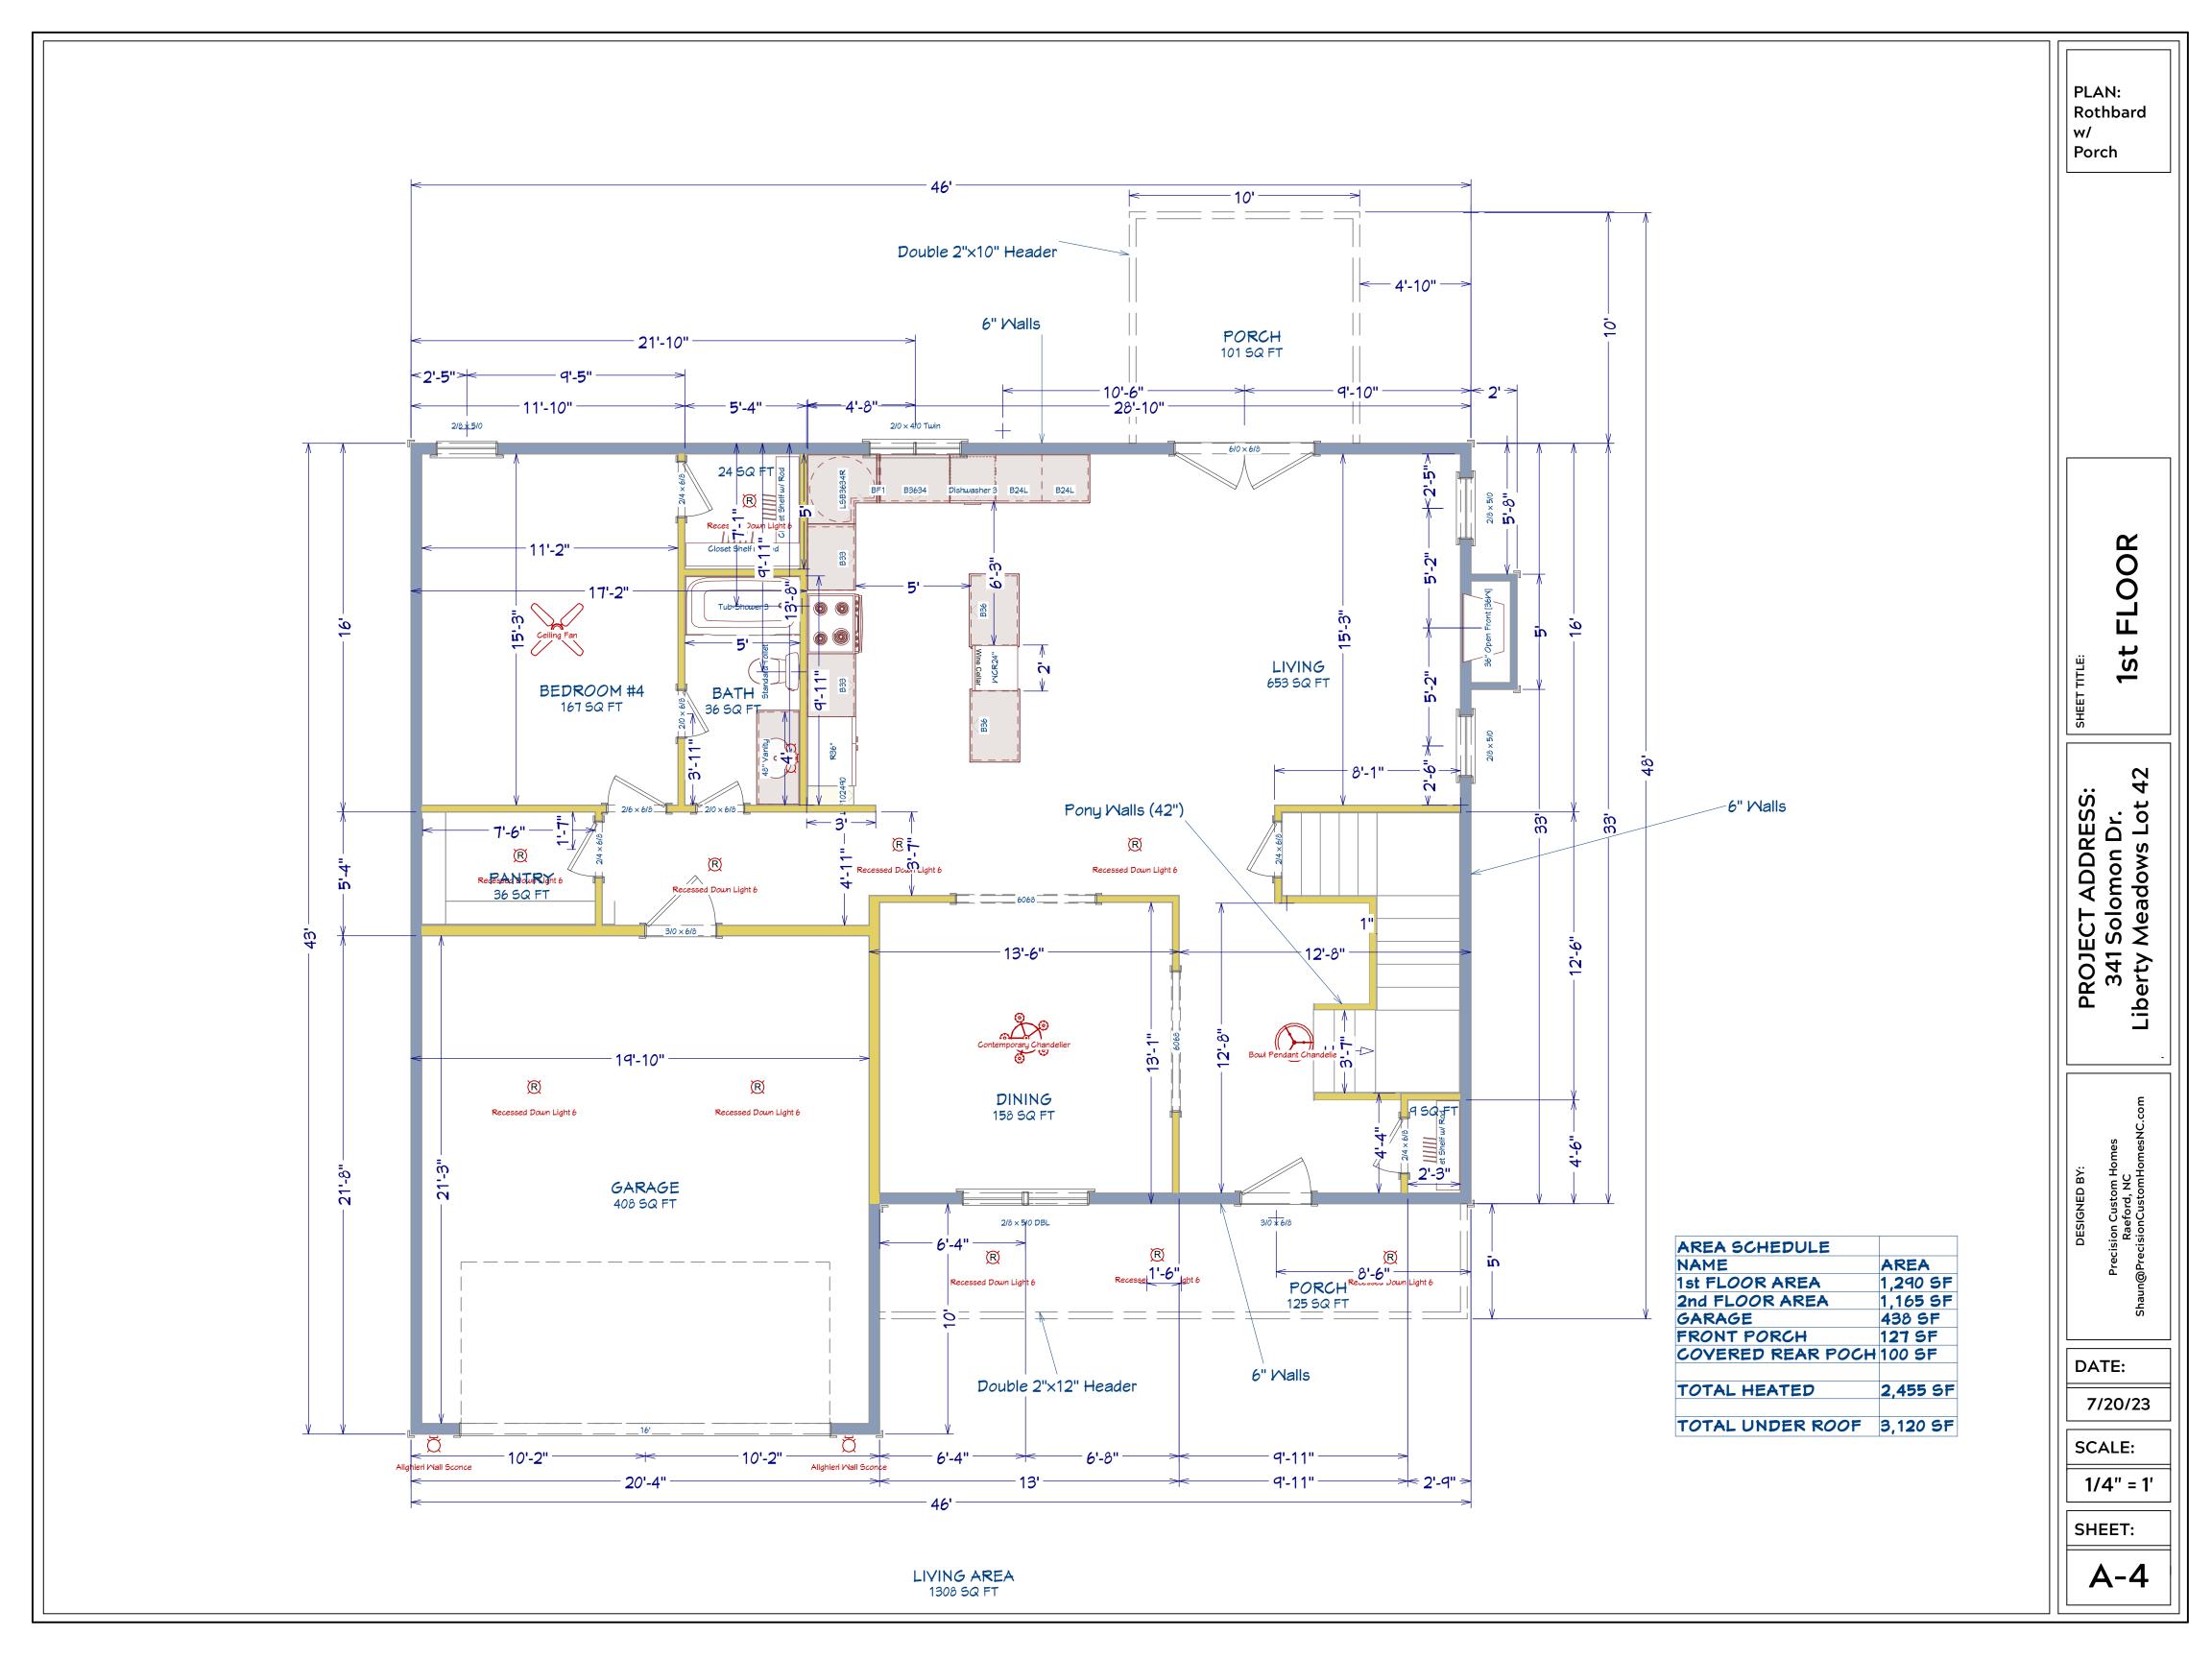



2nd FLOOR

PROJECT ADDRESS: 341 Solomon Dr. Liberty Meadows Lot 42

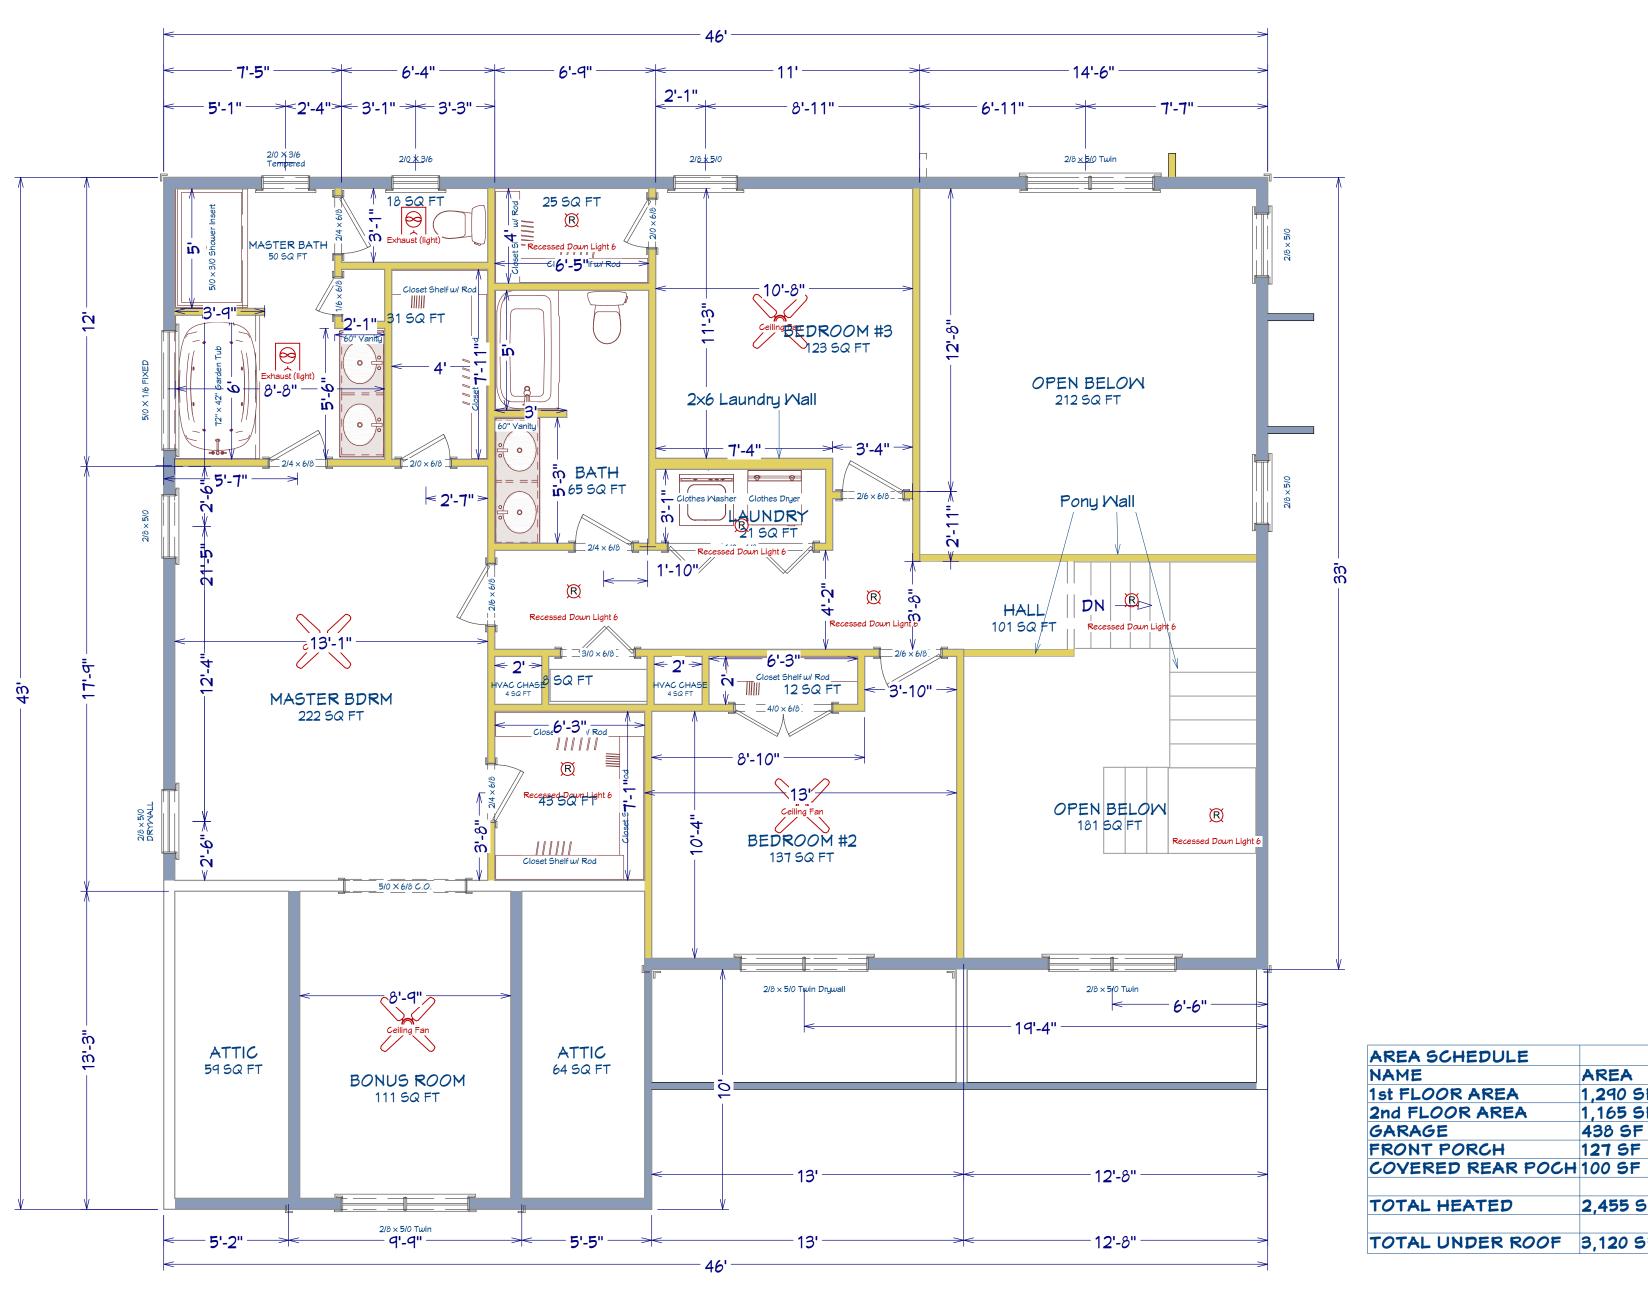

2,455 SF TOTAL UNDER ROOF 3,120 SF

AREA

1,290 SF

1,165 SF 438 SF

127 SF

SCALE:

DATE:

7/20/23

SHEET:

1/4" = 1'

Precision Custom Hom Raeford, NC n@PrecisionCustomHom

A-5

LIVING AREA 1165 SQ FT

North Carolina 2018 - R402.1.5 Total UA

Property 168 Edes Ct. Cameron, NC 28326 Model: Rothbard

Community: Liberty Meadows

Template - SMG Precision - Liberty Meadows Lot 20 - CZ 4 slab -Liberty Meadows Lot 20 Organization
Southern Energy Manager

Justin Smith

Builder

SMG Precision Properties



This report is based on a proposed design and does not confirm field enforcement of design elements.

Inspection Status

Results are projected

Building UA

Elements	NC Reference	As Designed
Ceilings	47.3	44.9
Above-Grade Walls	195.7	145.3
Windows, Doors and Skylights	126.2	113.8
Slab Floor:	76.4	99.6
Framed Floors	13.5	14.7
Foundation Walls	0.0	0.0
Rim Joists	8.8	7.1
Overall UA (Design must be equal or lower):	467.9	425.4

Requirements

402.1.5	Total UA alternative compliance passes by 9.1%.	
402.3.2	Average SHGC: 0.28 Max SHGC: 0.30	
R402.4.2.2	Air Leakage Testing	Air sealing is 4.80 ACH at 50 Pa. It must not exceed 5.00 ACH at 50 Pa.
R402.5	Area-weighted average fenestration SHGC	
R402.5	Area-weighted average fenestration U-Factor	
R404.1	Lighting Equipment Efficiency	
Mandatory Checklist	Mandatory code requirements that are not checked by Ekotrope must be met.	
R403.3.1	Duct Insulation	
403.3.3	Duct Testing	

Design exceeds requirements for North Carolina 2018 Prescriptive compliance by 9.1%.

Name:	Justin Smith	Signature:	Justin Smith
Organization:	Southern Energy Management	Digitally signed:	9/2/22 at 12:56 PM

Property 168 Edes Ct. Cameron, NC 28326 Model: Rothbard Community: Liberty Meadows

Template - SMG Precision - Liberty Meadows Lot 20 - CZ 4 slab - ecoSelect Liberty Meadows Lot 20

Organization Southern Energy Manag

Southern Energy Management Justin Smith

Inspection Status

Results are projected

Builder

SMG Precision Properties



General Building Informati	ion
Number Of Bedrooms	4
Number Of Floors	2
Conditioned Floor Area [sq. ft.]	2,455
Has Electric Vehicle Ready Space	No
Unconditioned, attached garage?	Yes
Conditioned Volume [cu. ft.]	25,604
Total Units in Building	1
Residence Type	Single family detached
Number of Floors in Building	-
Floor Number	-
Model	Rothbard
Community	Liberty Meadows
RESNET/IECC 2006 Climate Zone	4A
IECC 2021 Climate Zone	3A

Foundation Wall

None Present

Foundation Wall Library List

None Present

Slab									
	Name	Library Type	Perimeter	Floor Grade	Carpet R	Exposed Masonry Area	Surface Area	Location	Enclosing
	slab	Uninsulated	158	On Grade	1	0	1,290.0 ft²	Exposed Exterior	Conditioned Space

Slab Library	List						
Name	Wall Construction Type	Slab Completely Insulated?	Underslab Insulation Width [ft]	Perimeter Insulation Depth [ft]	Perimeter Insulation R Value	Thermal Break	Effective R-value
Uninsulated	Wood Frame / Other	No	0	0	0	No	0.00

Property 168 Edes Ct. Cameron, NC 28326 Model: Rothbard Community: Liberty Meadows

Liberty Meadows Lot 20

Community: Liberty Meadows

Template - SMG Precision - Liberty Meadows Lot 20
- CZ 4 slab - ecoSelect

Organization Southern Energy Management Justin Smith

Builder SMG Precision Properties Inspection Status Results are projected



	Framed Floo	r				
	Name	Library Type	Carpet R	Floor Grade	Surface Area	Location
ı						
ı	over garage	R 19, 16"OC G1 Carpet	0	Above Grade	287.0 ft²	Unconditioned, attached garage

Framed Floo	or Library List	:
	Name	Effective R-value
R 19, 16"OC	G1 Carpet	19.566

Rim Joist			
Name	Library Type	Surface Area	Location
1st floor ambient	R 19 G1, 16"OC	126.0 ft²	Exposed Exterior
1st floor garage	R 19 G1, 16"OC	32.0 ft²	Unconditioned, attached garage

Rim Joist Library List		
Name	Effective Insulation R-value	
R 19 G1, 16"OC	17.30	

Name	Library Type	Surface Color	Surface Area	Locatio
1st floor ambient	R 19 Adv. Framing G1 16" O.C	Medium	1,135.0 ft²	Exposed Exterio
1st floor garage	R 19 Adv. Framing G1 16" O.C	Medium	287.0 ft²	Unconditioned, attached garage
	-			
2nd floor ambient	R 19 Adv. Framing G1 16" O.C	Medium	1,158.0 ft²	Exposed Exterior
2nd floor attic	R 19 Adv. Framing G1 16" O.C	Medium	322.0 ft²	Atti

Property 168 Edes Ct. Cameron, NC 28326 Model: Rothbard Community: Liberty Meadows

Template - SMG Precision - Liberty Meadows Lot 20 - CZ 4 slab - ecoSelect Liberty Meadows Lot 20

Organization Southern Energy Management Justin Smith

Builder SMG Precision Properties Inspection Status Results are projected



Wall Library List		
Name	Effective R-value	
R 19 Adv. Framing G1 16" O.C	17.492	

Glazing									
Name	Library Type	Wall Assignment	Foundation Wall Assignment	is Operable	Overhang Depth	Overhang Ft To 0 Top	Overhang Ft To Bottom	Orientation	Surface Area
front 2nd unshaded	33/28	2nd floor ambient		Yes	0	0	0	West	81.0 ft²
front shaded	33/28	1st floor ambient		Yes	5	1	6	West	27.0 ft²
left 2nd unshaded	33/28	2nd floor ambient		Yes	0	0	0	North	27.0 ft²
left unshaded	33/28	1st floor ambient		Yes	0	0	0	North	27.0 ft²
rear 2nd unshaded	33/28	2nd floor ambient		Yes	0	0	0	East	54.5 ft²
rear shaded	33/28	1st floor ambient		Yes	10	2	9	East	40.2 ft²
rear unshaded	33/28	1st floor ambient		Yes	0	0	0	East	29.5 ft²
right 2nd unshaded	33/28	2nd floor ambient		Yes	0	0	0	South	34.5 ft²

Glazing Library List			
Name	Shgc	U-factor	
33/28	0.28	0.330	

Skylight		
	None Present	

None Present

Property 168 Edes Ct. Cameron, NC 28326 Model: Rothbard Community: Liberty Meadows

Organization Southern Energy Management Justin Smith

Builder

SMG Precision Properties

Inspection Status Results are projected



Template - SMG Precision - Liberty Meadows Lot 20 - CZ 4 slab - ecoSelect Liberty Meadows Lot 20

Opaque Doo	r							
Name	Library Type	Wall Assignment	Foundation Wall Assignment		Solar Absorptance		Surface Area	Location
front entry	Fiberglass R-5	1st floor ambient		0.9	0.75	Medium	20.0 ft²	Exposed Exterior
garage entry	Fiberglass R-5	1st floor garage		0.9	0.75	Medium	20.0 ft²	Unconditioned, attached garage

Opaque Door Library List Effective U-factor Fiberglass R-5 0.200

Roof Insulation	on					
Name	Library Type	Attic Exterior Area [ft²]	Clay or Concrete Roof Tiles	Surface Color	Surface Area	Location
attic	R 38 Attic BLOWN FG G1 2x10 24"OC NO Padiant Barrier	2,318.19	No	Dark	1,577.0 ft²	Attic

Roof Insulation Library List				
Name	Has Radiant Barrier	Effective R-value		
R 38 Attic BLOWN FG G1 2x10 24"OC NO	No	35.115		

Whole House Inf	iltration	
Infiltration	Measurement Type	Shelter Class
2048 CFM at 50 Pa	Blower-door tested	4

Mechanical Ventilation

None Present

Property 168 Edes Ct. Cameron, NC 28326 Model: Rothbard Community: Liberty Meadows

Template - SMG Precision - Liberty Meadows Lot 20 - CZ 4 slab - ecoSelect Liberty Meadows Lot 20

OrganizationSouthern Energy Management
Justin Smith

Builder





_	iberty ineadows Lot 20					
	Lighting % Interior Fluorescent Lighting	% Interior LED Lighting	% Exterior Fluorescent Lighting	% Exterior LED Lighting	% Garage Fluorescent Lighting	% Garage LED Lighting
	0	90	0	0	0	0
	Onsite Genera		one Present			
	Onsite Genera	ation Library List				
		No	one Present			
	Solar Generat	tion				
		No	one Present			
	Dehumidifier					
		No	one Present			
	Dehumidifier	Library List				
		No	one Present			
	Whole House	Fan				
		No	one Present			

Property 168 Edes Ct. Cameron, NC 28326 Model: Rothbard Community: Liberty Meadows

Template - SMG Precision - Liberty Meadows Lot 20 - CZ 4 slab - ecoSelect Liberty Meadows Lot 20

Organization Southern Energy Management Justin Smith

Builder

SMG Precision Properties



Whole House Fan Library List

None Present

Conditioning Equipment								
Name	Library Type	Serial Number	Heating Percent Load	Cooling Percent Load	Hot Water Percent Load			
1st floor heat pump	z 24k 14 SEER 8.0hspf		52%	52%	0%	Attic		
2nd floor heat pump	z 24k 14 SEER 8.0hspf		48%	48%	0%	Attic		
Water Heating	z 50 gal. 0.95 EF Elec		0%	0%	100%	Unconditioned Garage		

Inspection Status

Results are projected

Equipment Type: z 24k 14 S	EER 8.0hspf
Equipment Type	Air Source Heat Pump
Fuel Type	Electric
Distribution Type	Forced Air
Motor Type	PSC (Single Speed)
Heating Efficiency	8 HSPF
Heating Capacity [kBtu/h]	24
Backup Fuel Type	Electric
Switchover Temperature [°F]	0
Backup Heating Efficiency	1 COP
Use default Supplemental Heat	Yes
Cooling Efficiency	14 SEER
Cooling Capacity [kBtu/h]	24

Equipment Type: z 24k 14	4 SEER 8.0hspf	
Equipment Type	Air Source Heat Pump	
Fuel Type	Electric	
Distribution Type	Forced Air	
Motor Type	PSC (Single Speed)	
Heating Efficiency	8 HSPF	
Heating Capacity [kBtu/h]	24	
Backup Fuel Type	Electric	
Switchover Temperature [°F]	0	
Backup Heating Efficiency	1 COP	
Use default Supplemental Heat	Yes	
Cooling Efficiency	14 SEER	
Cooling Capacity [kBtu/h]	24	

Property 168 Edes Ct. Cameron, NC 28326 Model: Rothbard Community: Liberty Meadows

Template - SMG Precision - Liberty Meadows Lot 20 - CZ 4 slab - ecoSelect Liberty Meadows Lot 20

Organization Southern Energy Management

Justin Smith

Builder





Equipment Type: z 50 gal. 0.95 EF Elec				
Equipment Type	Residential Water Heater			
Fuel Type	Electric			
Distribution Type	Hydronic Delivery (Radiant)			
Hot Water Efficiency	0.95 Energy Factor			
Tank Capacity (gal.)	50			
Hot Water Capacity [kBtu/h]	40			
Recovery Efficiency	0.98			

D: (!! (! 0 (
Distribution System	
Distribution Type	Forced Air
Heating Equipment	1st floor heat pump
Cooling Equipment	1st floor heat pump
Sq. Feet Served	1,290
# Return Grilles	2
Supply Duct R Value	8
Return Duct R Value	8
Supply Duct Area [ft²]	348.3
Return Duct Area [ft²]	129
Leakage to Outdoors	51 CFM @ 25Pa (3.95 / 100 ft²)
Total Leakage	51 CFM25
Total Leakage Duct Test Conditions	Post-Construction
Use Default Flow Rate	Yes
Duct 1	
Duct Location	Attic (well vented)
Percent Supply Area	70
Percent Return Area	70
Duct 2	
Duct Location	Conditioned Space
Percent Supply Area	30
Percent Return Area	30
Duct 3	
Duct Location	Conditioned Space
Percent Supply Area	0
Percent Return Area	0
Duct 4	
Duct Location	Conditioned Space
Percent Supply Area	0
Percent Return Area	0
Duct 5	
Duct Location	Conditioned Space
Percent Supply Area	0
Percent Return Area	0
Duct 6	
Duct Location	Conditioned Space
Percent Supply Area	0
Percent Return Area	0
	-

Property 168 Edes Ct. Cameron, NC 28326 Model: Rothbard Community: Liberty Meadows

Template - SMG Precision - Liberty Meadows Lot 20 - CZ 4 slab - ecoSelect Liberty Meadows Lot 20

Organization Southern Energy Management Justin Smith

Builder



21 4 4 T	E 14:
Distribution Type	Forced Air
Heating Equipment	2nd floor heat pump
Cooling Equipment	2nd floor heat pump
Sq. Feet Served	1,165
# Return Grilles	2
Supply Duct R Value	8
Return Duct R Value	8
Supply Duct Area [ft²]	314.55
Return Duct Area [ft²]	116.5
_eakage to Outdoors	46 CFM @ 25Pa (3.95 / 100 ft²)
Total Leakage	46 CFM25
Total Leakage Duct Test Conditions	Post-Construction
Jse Default Flow Rate	Yes
Duct 1	
Duct Location	Attic (well vented)
Percent Supply Area	100
Percent Return Area	100
Duct 2	
Duct Location	Conditioned Space
Percent Supply Area	0
Percent Return Area	0
Duct 3	
Duct Location	Conditioned Space
Percent Supply Area	0
Percent Return Area	0
Duct 4	
Duct Location	Conditioned Space
Percent Supply Area	0
Percent Return Area	0
Duct 5	
Duct Location	Conditioned Space
Percent Supply Area	0
Percent Return Area	0
Duct 6	
Duct Location	Conditioned Space
Percent Supply Area	0
Percent Return Area	0

HVAC Grading	
HVAC Grading Not Conducted	

Ceiling Fan		
Has Ceiling Fan	No	
Cfm Per Watt	100	

Property 168 Edes Ct. Cameron, NC 28326 Model: Rothbard Community: Liberty Meadows

Template - SMG Precision - Liberty Meadows Lot 20 - CZ 4 slab - ecoSelect Liberty Meadows Lot 20

Organization

Southern Energy Management Justin Smith

Inspection Status

Results are projected

Builder



Water Distribution	
Water Fixture Type	Low-flow
Use Default Hot Water Pipe Length	No
Hot Water Pipe Length [ft]	79
At Least R3 Pipe Insulation?	No
Hot Water Recirculation System?	No
Recirculation System Pipe Loop Length [ft]	20
Drain Water Heat Recovery?	No

Clothes Dryer	
Cef	3.01
Fuel Type	Electric
Field Utilization	Timer Controls
Is Outside Conditioned Space	No
Clothes Dryer Available	Yes
Defaults Type	HERS Reference

Clothes Washer	
Label Energy Rating	153 kWh/Year
Annual Gas Cost	\$12.00
Electric Rate	\$0.11/kWh
Gas Rate	\$1.22/Therm
Capacity	3.31
Imef	2.1547
Defaults Type	Custom
Load Type	Front-load
Loads Per Week	6
Is Outside Conditioned Space	No
Clothes Washer Available	Yes

Dishwasher	
Dishwasher Efficiency	270 kWh
Dishwasher Size	Standard
Annual Gas Cost	\$22.23
Electric Rate	\$0.12/kWh
Gas Rate	\$1.09/Therm
Is Outside Conditioned Space	No

Property 168 Edes Ct. Cameron, NC 28326 Model: Rothbard Community: Liberty Meadows

emplate - SMG Precision - Liberty Meadows Lo

Template - SMG Precision - Liberty Meadows Lot 20 - CZ 4 slab - ecoSelect Liberty Meadows Lot 20

Organization

Southern Energy Management Justin Smith

Inspection Status

Results are projected

Builder

SMG Precision Properties





Appliances and Controls	
Thermostat Cooling Setpoint	* * * * 75.0
Thermostat Heating Setpoint	* * * * 70.0
Range/Oven Fuel	Electric
Convection Oven?	No
Induction Range?	No
Range/Oven Outside Conditioned Space?	No
Refrigerator Consumption	538 kWh/Year
Refrigerator Outside Conditioned Space?	No

Notes

Initial Inputs _____JS 09/02/22_____

- -confirm HVAC specs
- -confirm water heater specs
- -confirm ventilation entry
- -modeled to worst case orientation
- -confirm cfl lighting %

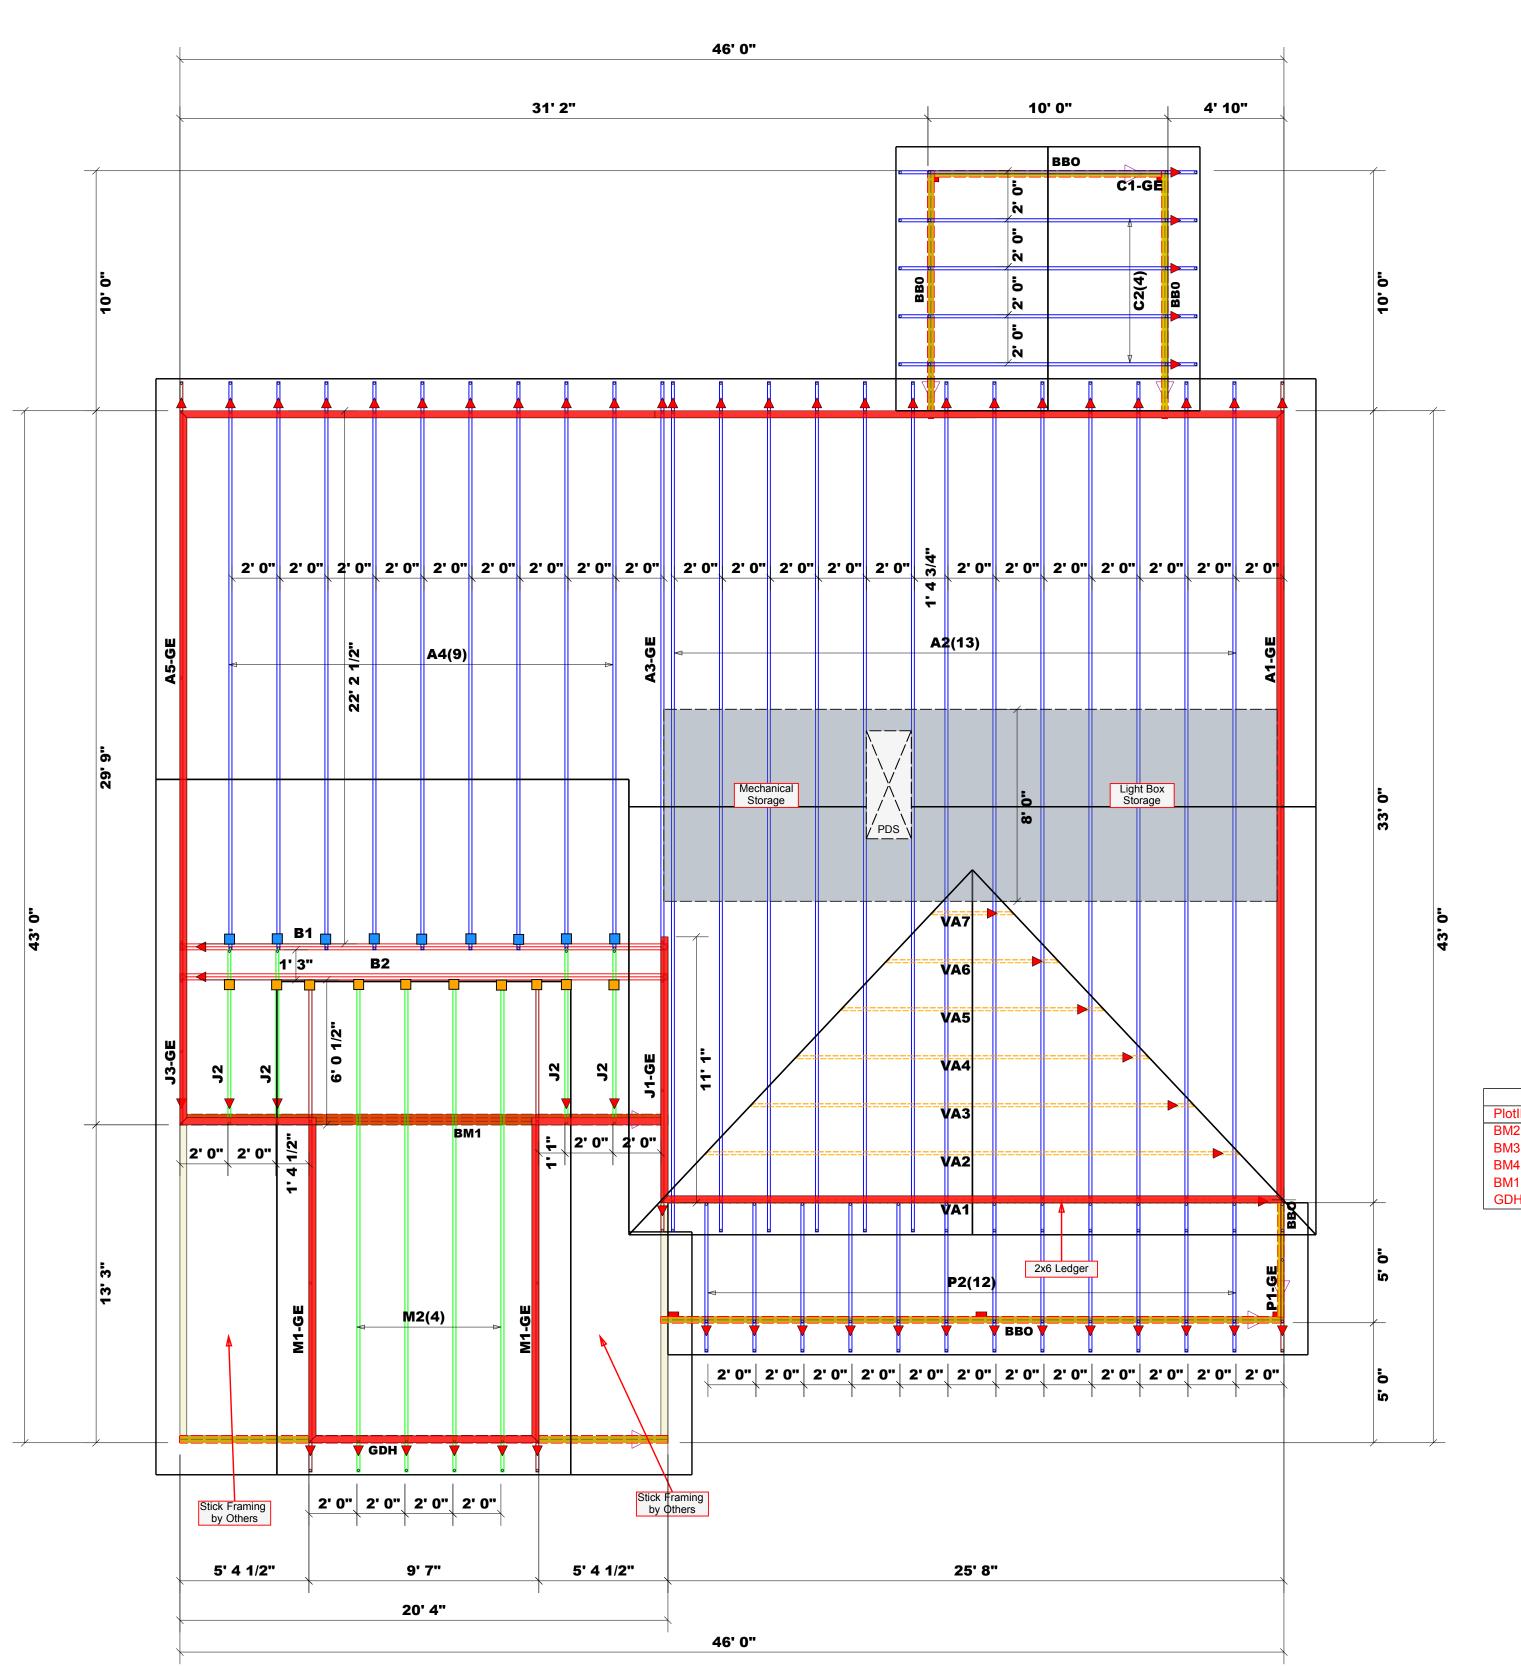

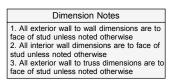

Roof Area = 2630.09 sq.ft. Ridge Line = 59.33 ft. Hip Line = 0 ft. Horiz. OH = 182 ft. Raked OH = 315.12 ft. Decking = 90 sheets

All Walls Shown Are Considered Load Bearing

= Indicates Left End of Truss (Reference Engineered Truss Drawing) Do Not Erect Trusses Backwards

Truss Placement Plan
Scale: 1/4"=1'

Plumbing Drop Notes Plumbing drop locations shown are NOT exact.
 Contractor to verify ALL plumbing drop locations prior to setting Floor Trusses.
 Adjust spacing as needed not to exceed 24"oc.

Connector Information			Nail Information				
Sym	Product	Manuf	Qty	Supported Member	Header	r Truss	
	MSH422	USP	9	Varies	10d/3"	10d/3"	
	JUS26	USP	10	Varies	10d/3"	10d/3"	
	HUS26	USP	9	Varies	16d/3-1/2"	16d/3-1/2"	

		Products			
PlotID	Length	Product	Plies	Net Qty	Fab Type
BM2	7' 0"	1-3/4"x 9-1/4" LVL Kerto-S	2	2	FF
BM3	7' 0"	1-3/4"x 9-1/4" LVL Kerto-S	2	2	FF
BM4	6' 0"	1-3/4"x 9-1/4" LVL Kerto-S	2	2	FF
BM1	21' 0"	1-3/4"x 14" LVL Kerto-S	3	3	FF
GDH	21' 0"	1-3/4"x 16" LVL Kerto-S	2	2	FF

Hatch Legend
Mechanical & Light Storage
2nd Floor Walls @ 8' 1 1/2" UNO
Flush Beam
Drop Beam

COMTECH **ROOF & FLOOR TRUSSES & BEAMS**

Reilly Road Industrial Park Fayetteville, N.C. 28309 Phone: (910) 864-8787 Fax: (910) 864-4444

Bearing reactions less than or equal to 3000# are deemed to comply with the prescriptive Code requirements. The contractor shall refer to the attached Tables (derived from the prescriptive Code requirements) to determine the minimum foundation size and number of wood studs required to support reactions greater than 3000# but not greater than 15000#. A registered design professional shall be retained to design the support system for any reaction that exceeds those specified in the attached Tables. A registered design professional shall be retained to design the support system for all reactions that exceed 15000#.

Neil Baggett

LOAD CHART FOR JACK STUDS (BASED ON TABLES R502.5(1) & (b))

NUMBER OF JACK STUDS REQUIRED @ EA END OF HEADER/GIRDER END REACTION
(UP TO)
REQ'D STUDS FOR
(3) PLY HEADER END REACTION
(UP TO)
REQ'D STUDS FOR
(4) PLY HEADER 3400 1 1700 1 2550 1 3400 2 6800 2 5100 2 5100 3 7650 3 10200 3 6800 4 10200 4 13600 4 8500 5 17000 5 12750 5 10200 6 15300 6 11900 7 13600 8 15300 9

ADDRESS	42 Liberty Meadows, Cameron, NC
EV.	7/18/2023
DRAWN BY	DRAWN BY Neil Baggett
SALESMAN	SALESMAN Neil Baggett

THIS IS A TRUSS PLACEMENT DIAGRAM ONLY. THIS IS A TRUSS PLACEMENT DIAGRAM ONLY. These trusses are designed as individual building components to be incorporated into the building design at the specification of the building designer. See individual design sheets for each truss design identified on the placement drawing. The building designer is responsible for temporary and permanent bracing of the roof and floor system and for the overall structure. The design of the truss support structure including headers, beams, walls, and columns is the responsibility of the building designer. For general guidance regarding bracing, consult BCSI-B1 and BCSI-B3 provided with the truss delivery package or online @ sbcindustry.com

russ delivery package or online @ sbcindustry.com

Precision Custom Homes & Renov

Lot 42 Liberty Meadows

JOB NAME

BUILDER

Rothbard 1.0 w/CP

PLAN


7/11/2023

SEAL DATE

J0523-2578

N/A

QUOTE #

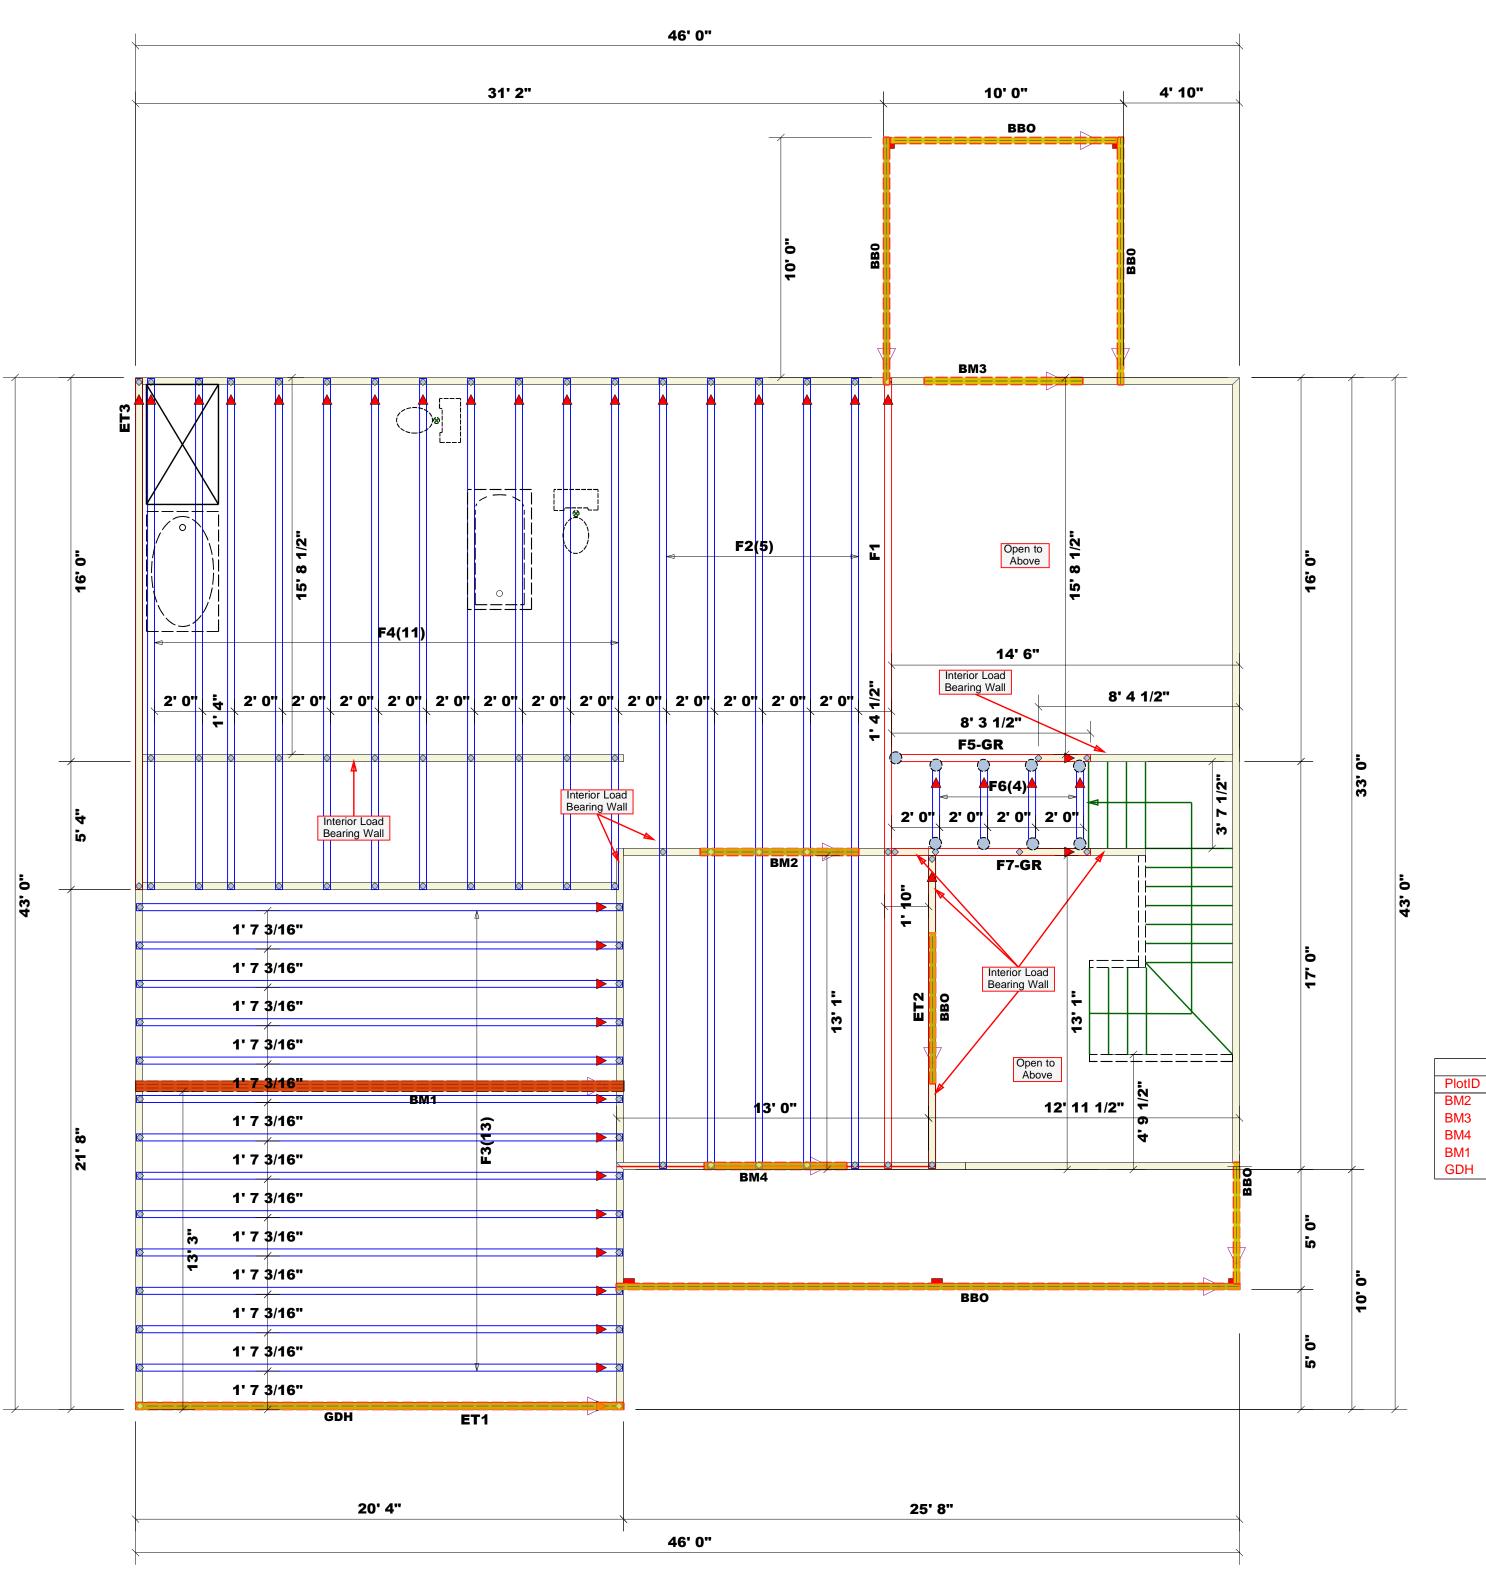

Dimension Notes All exterior wall to wall dimensions are to face of stud unless noted otherwise
 All interior wall dimensions are to face of stud unless noted otherwise
 All exterior wall to truss dimensions are to face of stud unless noted otherwise

Roof Area = 2630.09 sq.ft. Ridge Line = 59.33 ft. Hip Line = 0 ft. Horiz. OH = 182 ft. Raked OH = 315.12 ft. Decking = 90 sheets


All Walls Shown Are Considered Load Bearing

= Indicates Left End of Truss (Reference Engineered Truss Drawing) Do Not Erect Trusses Backwards

Truss Placement Plan
Scale: 1/4"=1' Plumbing Drop Notes Plumbing drop locations shown are NOT exact.
 Contractor to verify ALL plumbing drop locations prior to setting Floor Trusses.
 Adjust spacing as needed not to exceed 24"oc.

Connector Information				Nail Information		
Product	Manuf	Qty	Supported Member	Header	Truss	
MSH422	USP	9	Varies	10d/3"	10d/3"	
JUS26	USP	10	Varies	10d/3"	10d/3"	
HUS26	USP	9	Varies	16d/3-1/2"	16d/3-1/2"	

		Products			
PlotID	Length	Product	Plies	Net Qty	Fab Type
BM2	7' 0"	1-3/4"x 9-1/4" LVL Kerto-S	2	2	FF
BM3	7' 0"	1-3/4"x 9-1/4" LVL Kerto-S	2	2	FF
BM4	6' 0"	1-3/4"x 9-1/4" LVL Kerto-S	2	2	FF
BM1	21' 0"	1-3/4"x 14" LVL Kerto-S	3	3	FF
GDH	21' 0"	1-3/4"x 16" LVL Kerto-S	2	2	FF

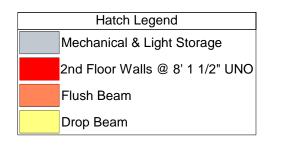

соттесн **ROOF & FLOOR TRUSSES & BEAMS**

Reilly Road Industrial Park Fayetteville, N.C. 28309 Phone: (910) 864-8787 Fax: (910) 864-4444

Bearing reactions less than or equal to 3000# are deemed to comply with the prescriptive Code requirements. The contractor shall refer to the attached Tables (derived from the prescriptive Code requirements) to determine the minimum foundation size and number of wood studs required to support reactions greater than 3000# but not greater than 15000#. A registered design professional shall be retained to design the

Neil Baggett

LOAD CHART FOR JACK STUDS (BASED ON TABLES R502.5(1) & (b))

Meadows, Liberty Neil Baggett Neil Baggett 7/18/2023 Harnett 42 SALESMAN DRAWN BY DATE REV. ADDRESS COUNTY

Precision Custom Homes & Renov Lot 42 Liberty Meadow Rothbard 1.0 w/CP J0523-2579 7/11/2023 N/A JOB NAME SEAL DATE **QUOTE** # PLAN

THIS IS A TRUSS PLACEMENT DIAGRAM ONLY. THIS IS A TRUSS PLACEMENT DIAGRAM ONLY. These trusses are designed as individual building components to be incorporated into the building design at the specification of the building design at the specification of the building designer. See individual design sheets for each truss design identified on the placement drawing. The building designer is responsible for temporary and permanent bracing of the roof and floor system and for the overall structure. The design of the truss support structure including headers, beams, walls, and columns is the responsibility of the building designer. For general guidance regarding bracing, consult BCSI-B1 and BCSI-B3 provided with the truss delivery package or online @ sbcindustry.com

BUILDER

