	LIVE LOAD	DEAD LOAD
TABLE R301.4	(PSF)	(PSF)
DWELLING UNITS	40	10
SLEEPING ROOMS	30	10
ATTICS WITH STORAGE	20	10
ATTICS WITHOUT STORAGE	10	10
ROOF SNOW	20	10
STAIRS	40	10
DECKS	40	10
EXTERIOR BALCONIES	60	10
PASSENGER VEHICLE GARAGES	50	
FIRE ESCAPES	40	10
GUARDRAILS AND HANDRAILS	200	

#### MATERIALS

- 1. FRAMING LUMBER SHALL BE #2 SPRUCE PINE FIR (SPF) WITH THE FOLLOWING DESIGN PROPERTIES: Fb = 875 PSI Fv = 70 PSI E = 1.4E6 PSI
- 2. FRAMING LUMBER EXPOSED TO WEATHER OR IN CONTACT WITH THE GROUND, CONCRETE OR MASONRY SHALL BE #2 SOUTHERN YELLOW PINE (SYP) TREATED IN ACCORDANCE WITH AWPA C22 WITH THE FOLLOWING DESIGN PROPERTIES:  $Fb = 1050 \ PSI \quad Fv = 95 \ PSI \quad E = 1.666 \ PSI$
- 3. ENGINEERED WOOD BEAMS SHALL BE LAMINATED VENEER LUMBER (LVL) OR PARALLEL STRAND LUMBER (PSL) WITH THE FOLLOWING MINIMUM DESIGN PROPERTIES: Fb = 2900 PSI 
  Fv = 285 PSI 
  E = 1.9E6 PSI
- 4. STRUCTURAL STEEL SHALL CONFORM TO ASTM A-36 MINIMUM GRADE.
- 5. BOLTS SHALL CONFORM TO A307 MINIMUM GRADE.
- 6. REBAR SHALL BE DEFORMED STEEL CONFORMING TO ASTM A615 GRADE 60.
- 7. POURED CONCRETE SHALL HAVE A MINIMUM SPECIFIED COMPRESSIVE STRENGTH OF 3000 PSI AT 28 DAYS. MATERIALS USED TO PRODUCE CONCRETE SHALL COMPLY WITH THE APPLICABLE STANDARDS LISTED IN ACI 318 OR ASTM C 1157.
- 8. CONCRETE LOCATED PER TABLE R402.2 SHALL BE AIR ENTRAINED WITH THE TOTAL AIR CONTENT NOT LESS THAN 5 PERCENT OR MORE THAN 7 PERCNET.
- 9. MASONRY UNITS SHALL CONFORM TO ACI 530/ASCE 5/TMS 402 AND MORTAR SHALL COMPLY WITH ASTM C 270.
- 10. ALLOWABLE SOIL BEARING PRESSURE 2000 PSF.

#### GENERAL

ENGINEER'S SEAL APPLIES TO STRUCTURAL COMPONENTS ONLY AND DOES NOT CERTIFY ARCHITECTURAL LAYOUT OR DIMENSIONAL ACCURACY. ENGINEER IS NOT RESPONSIBLE FOR CONSTRUCTION METHODS OR ANY DEVIATION FROM THE

ALL CONSTRUCTION, WORKMANSHIP, MATERIAL QUALITY AND SELECTION SHALL BE IN ACCORDANCE WITH THE NORTH CAROLINA STATE BUILDING CODE - RESIDENTIAL CODE 2018 EDITION FROM THE INTERNATIONAL RESIDENTIAL CODE 2018 (IRC), AND LOCAL CODES AND REGULATIONS. DIMENSIONS SHALL GOVERN OVER SCALE AND CODE SHALL GOVERN OVER DIMENSIONS.

#### ADDITIONAL LOADS

FIGURE R301.2(4) - ULTIMATE DESIGN WIND SPEEDS 115-120 MPH

FIGURE R301.2(2) - SEISMIC DESIGN CATEGORY B

 $\underline{\text{TABLE R301.2(4)}} - \text{DESIGN POSITIVE AND NEGATIVE PRESSURE FOR DOORS AND WINDOW FOR A MEAN ROOF HEIGHT OF 35} \\ \overline{\text{FEET OR LESS SHALL BE 25 PSF}}$ 

TABLE R301.2(2) - COMPONENT AND CLADDING LOADS FOR A MEAN ROOF HEIGHT OF 30 FEET OR LESS LOCATED IN EXPOSURE B

ROOF VALUES BOTH POSITIVE AND NEGATIVE SHALL BE DESIGNED BASED ON ROOF PITCHES AS FOLLOWS:

45.4 PSF FOR 0:12 TO 2.25:12, 34.8 PSF FOR 2.25:12 TO 7:12 AND 21 PSF FOR 7:12 TO 12:12 WALL CLADDING IS DESIGNED FOR A 24.1 PSF POSITIVE AND NEGATIVE PRESSURE

#### ENERGY COMPLIANCE:

 $\frac{\text{TABLE N1102.1}}{\text{N1102.1}} \cdot \text{REFER TO TABLE N1101.1 TO DETERMINE THE CLIMATE ZONE BY COUNTY } \text{ AND REFER TO TABLE } \\ \frac{\text{N1102.1}}{\text{N1102.1}} \cdot \text{REFULL FOR R VALUE INSULATION REQUIREMENTS LISTED BY ZONE.} \\$ 

 $\frac{\text{TABLE N1102.1 - ZONE 7} \cdot \text{MAX. GLAZING U FACTOR: } 0.40. \ \text{MIN. INSULATION R VALUES: CEILING } {\text{R-30}}, \text{ WALLS } {\text{R-13}}, \\ \text{FLOORS } \underline{\text{R-19}}, \text{ BASEMENT WALLS } \underline{\text{R-7}}, \text{ SLAB PERIMETER } \underline{\text{R-0}}, \text{ CRAWL SPACE WALLS } \underline{\text{R-7}}.$ 

 $\frac{\text{TABLE N1102.1 - ZONE 8 - MAX. GLAZING U FACTOR: 0.40.}}{\text{FLOORS } \underbrace{\text{R-19}}, \text{BASEMENT WALLS } \underbrace{\text{R-8}}, \text{SLAB PERIMETER } \underbrace{\text{R-5} (2 \text{ FT DEEP})}, \text{CRAWL SPACE WALLS } \underbrace{\text{R-30}}, \text{WALLS } \underbrace{\text{R-10}}.$ 

#### CONSTRUCTION

- 1. STEEL FLITCH BEAMS SHALL BE FASTENED TOGETHER WITH 1/2" DIAMETER BOLTS WITH WASHERS PLACED UNDER THE THREADED END OF THE BOLT. BOLTS SHALL BE SPACED AT MAXIMUM 24" o.c. STAGGERED TOP AND BOTTOM OF BEAM WITH A MINIMUM 2" EDGE DISTANCE. TWO BOLTS SHALL BE LOCATED AT 6" FROM EACH END OF FLITCH BEAM.
- 2. STEEL BEAMS SHALL BE SUPPORTED AT EACH END WITH A MINIMUM BEARING LENGTH OF 3 1/2" AND FULL FLANGE WIDTH.

  PEAMS MIST BE ANCHORED AT EACH END WITH A MINIMUM OF FOUR 164 NAULS OF TWO 1675 AND 16 SOPEMS.
- BEAMS MUST BE ANCHORED AT EACH END WITH A MINIMUM OF FOUR 16d NAILS OR TWO 1/2" x 4" LAG SCREWS.
- 3. ENGINEERED WOOD BEAMS SHALL BE INSTALLED WITH ALL CONNECTIONS PER MANUFACTURER'S INSTRUCTIONS.
- 4. ALL BEAMS SHALL BE CONTINUOUSLY SUPPORTED LATERALLY AND SHALL BEAR FULL WIDTH ON THE SUPPORTING WALLS OR COLUMNS INDICATED WITH A MINIMUM OF THREE STUDS.
- 5. SOLID BLOCKING SHALL BE PROVIDED AT ALL POINT LOADS TO TRANSFER LOADS THROUGH FLOOR LEVELS. COLUMNS SHALL BE CONTINUOUS TO THE FOUNDATION OR TO OTHER STRUCTURAL ELEMENTS.
- 6. ENGINEERED WOOD FLOOR SYSTEMS AND ROOF TRUSS SYSTEMS SHALL BE PROVIDED FOR REVIEW AND COORDINATED WITH THE ENGINEER OF RECORD. INSTALLATION SHALL BE IN ACCORDANCE WITH THE MANUFACTURER'S INSTRUCTIONS.
- 7. WALL BRACING REQUIREMENTS SHALL BE IN ACCORDANCE WITH SECTION R602.10 OF THE NORTH CAROLINA RESIDENTIAL
- 8. BRICK LINTELS SHALL BE 3 1/2 x 3 1/2 x 1/4 STEEL ANGLE FOR UP TO 6'0" MAXIMUM SPAN AND 6 x 4 x 5/16 FOR SPANS GREATER THAN 6'0".
- 9. BRICK LINTELS AT SLOPED AREAS SHALL BE 4 x 3 1/2 x 1/4 STEEL ANGLE WITH 16d NAILS IN 3/16" HOLES IN 4" ANGLE LEG AT 12" o.c. TO DOUBLE RAFTER. WHEN THE SLOPE EXCEEDS 4:12 A MINIMUM OF 3 x 3 x 1/4 PLATES SHALL BE WELDED AT 24" o.c. ALONG THE STEEL ANGLE.

#### MEAN ROOF HEIGHT 1 STORY = 11'-0"

CLADDING POSITIVE & NEGATIVE PRESSURE = 21

#### 1 1/2 STORY = 19'-0"

CLADDING POSITIVE & NEGATIVE PRESSURE = 34.8 PSF

#### 2 STORY = 19'-0"

CLADDING POSITIVE & NEGATIVE PRESSURE = 34.8 PSF

#### ANCHOR BOLTS

INSTALL ANCHOR BOLTS, NUTS, AND WASHERS PER CODE AT ALL EXTERIOR WALL TREATED PLATES AND AT INTERIOR BEARING

WITHIN 12" FROM THE ENDS OF EACH PLATE.

WALL
TREATED PLATES ON SLAB
FOUNDATIONS. TO BE A MINIMUM OF 6' O.C. AND

DESIGN PRESSURES
MINIMUM RATING: 25 PSF

MI WINDOWS 3500 SERIES LOW E-GLASS WINDOWS

# ABBREVIATIONS CONC CONCRETE CONT CONTINUOUS DBL DOUBLE DJ DOUBLE JOIST DSP DOUBLE STUD POCKET EA EACH FL PT FLAT PLATE FTG FOOTING HGR HANGER LVL LAMINATED VENEER LUMBER NTS NOT TO SCALE OC ON CENTER PSL PARALLEL STRAND LUMBER PT PRESSURE TREATED

STUD POCKET

UNLESS NOTED OTHERWISE

# THE "Winston" PLAN NO. 1441

SQUARE FOOT	AGE
FIRST FLOOR	611 S.F.
SECOND FLOOR	810 S.F.
TOTAL HEATED AREA	1441 S.F.
OVERALL WIDTH	24'-0"
OVERALL DEPTH	37'-4"

	revision l	.OG				
Rev	Description	Drawn By	Date	Sheets Affected	Brochure Required	Engineering Required
1						
2						
3						
4						
5						
6						
7						
8						
9						
10						
11						
12						
13						
14						

#### TABLE N1102.1 CLIMATE ZONES 3-5

CLIMATE ZONE	FENESTRATION U-FACTOR <sup>6</sup> -j	SKYLIGHT <sup>b</sup> U-FACTOR	GLAZED FENESTRATION SHGC <sup>b, <u>k</u></sup>	CEILING R.VALUE™	WOOD FRAME WALL R-VALUE	MASS WALL R-VALUE	FLOOR R-VALUE	BASEMENT <sup>©</sup> WALL R-VALUE	SLAB <sup>d</sup> R-VALUE & DEPTH	CRAWL SPACE° WALL R-VALUE
3	0.35	0.55	0.30	38 or 30ci	15 or 13 + 2.5h	5/13 or 5/10ci	19	5/13	0	5/13
4	0.35	0.55	0.30	38 or 30ci	15 or 13 + 2.5 <sup>h</sup>	5/13 or 5/10ci	19	10/15	10	10/15
5	0.36	0.55	NR	38 or 30ci	19 <sup>n</sup> or 13 + 5 <sup>h</sup> or 15 + 3 <sup>h</sup>	13/17 <u>or</u> 13/12.5 ci	30°	10/15	10	10/19

- foot = 304.8 mm.

  Realuse are minimums. Urbictions and SHGC are maximums. When insulation is installed in a cavity which is less than the label or design thickness of the insulation, the installed Availue of the insulation shall not be less than the Availue specified in the label.
- R-values are minimums. Lifectors and SHGC are maximums. When insulation is installed in a cavity which is less than the label or design thickness of the insulation, it is.
  The farestration Ufficience of the continuous skylights. The SHGC column applies to all glazzed ferestration.
   "MHS" means R-10 continuous insulated sheathing on the interior or data from or different from the continuous insulated sheathing on the interior or data from or different from the continuous and the interior of the basement wall or cavit space we
- R. S. Shill be added to the required side dega Rusiuse for heated sides. For monthline sides, includion shall be applied from the inspection age downward to the bottom of the feeting or a maximum of 24 inches below grade, whichever is less. For feeting sides, includion shall patent to the bottom of the bottom of the feeting or a maximum of 24 inches whichever is less. (See Appendix O).

  Refeated.

  Refeated.

  Refeated.

  Refeated.
- Basement well invalution is not required in worm-humid locations as defined by Figure N1101.7 and Table N1101.7.
   Drisulation sufficients of ferming cavity, R-19 minimum.
   The first value is sently insulation, the second value is continuous insulation, so "12-5" means R-12 cavity insulation due R-6 continuous
- used. If studues a reaching covers more than 25 opered of exterior, structures sheathing what he supplemented with insulated sheathing of at least R-2.
  The second R-value applies when more than his the insulation is on the interior of the mass was reached by the second R-value applies when more than his the insulation is the interior of the mass was reached by the second R-value applies without penalty in addition to the exemption in Section NT (10.2.3.5, maximum of two placed femalentiation product assemblies without penalty, in addition to the exemption in Section NT (10.2.3.5, maximum of two placed femalentiation product assemblies without penalty.
- addition for exemption in Section N102.3.3, a maximum of two pipesed femeration product assemblies having a Undertorn operater than 0.65 shall be permitted to be substituted for infirmum notes compliant finerationing reduct assemblies without generally, addition to the exemption in Section N102.3.3, a maximum of two pipesed femeration regular assemblies having a SHIGD on present than 0.70 shall be exempted to be a substituted for infirmum nodes compliant fineration; or option assemblies without penalty.

  30 shall be deemed to addity free colling installation requirement wherever the full implient of processors ASO insulation regular to the accessor of the colling insulation regular way where additional regular to the colling of the colling insulation regular to the colling of the colling insulation regular to the colling of the colling insulation regular way where additional regular to the colling of the colling insulation regular to the colling of the colling insulation regular to the colling of the colling insulation and the coll
- n\_ Table value souther smooth or not also a where the paper is limited by the job of the roof, then the insulation must fill the space up to the air baffs.

  n\_R-10 fleepipas betts compressed and installed in a nominal 2 × 0 femina causily is deemed to comply. Elections betts made R-10 or higher compressed and installed in a 2 × 4 wall is not deemed to comply.

  Superment was lineating the minimum mass wall specific heat content op/general may use the mass and R-suble as the minimum repulsement.
- must extend to either the

	ATTIC VENT SCHEDULE								
ELEVATION									
MAIN	HOUSE		SQ FTG 3093 AT / NEAR RIDGE AT / NEAR EA				AR EAVE		
VENT TYPE	SQ. REQU	FT. JIRFD	SQ. FT.	PERCENT OF TOTAL	POT LARGE (SQ. FT. EACH)	POT SMALL (SQ. FT. EACH)	RIDGE VENT (SQ. FT. PER LF)	EAVE VENT (SQ. IN. EACH)	CONT. VENT (SQ. IN. PER LF)
0	RAN		SUPPLIED	SUPPLIED SUPPLIED		0.2778	0.125	0.1944	0.0625
RIDGE VENT	4.12	5.16	6.63	39.85	0	0	53.00		
SOFFIT VENTS	6.19	5.16	10.00	60.15				0	160.00
TOTAL (MIN)	10.31	10.31	16.63	100.00	POT VENTS MAY BE REQUIRED IF THERE IS INSUFFICIENT RIDGE AVAILABLE				

\* SCHEDULE HAS BEEN CALCULATED ASSUMING EAVE VENTILATION AT 50-60% OF TOTAL AND RIDGE AT 40-50% OF TOTAL REQUIRED VENTILATION

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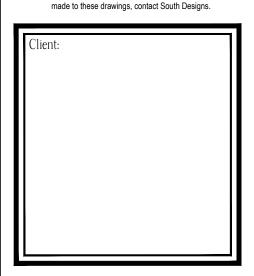
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Drawn By: RW	√B
Checked By: RW  Date: 5-24-2	
Revision No.	Revision Date

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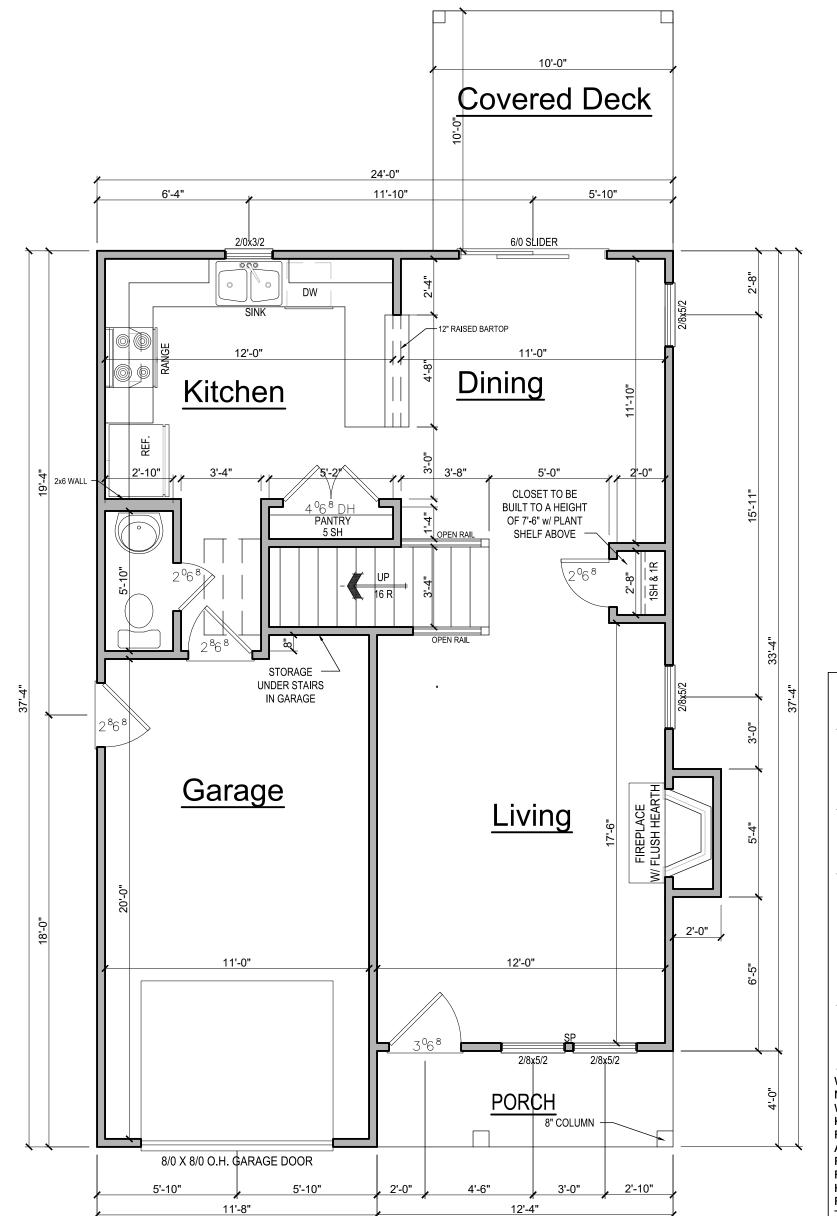
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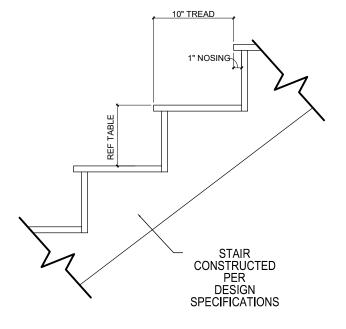


COVER

CS-1
Sheet No. Of



FIRST FLOOR PLAN



	RISER HEIGHTS PER	STAIR CONFIGUR	ATION
PLATE HEIGHT	10" FLOOR SYSTEM	14" FLOOR SYSTEM	16" FLOOR SYSTEM
8'-1 1/2"	14 RISERS @ 7 11/16"	15 RISERS @ 7 1/2"	15 RISERS @ 7 5/8"
9'-1 1/2''	16 RISERS @ 7 1/2"	16 RISERS @ 7 3/4"	17 RISERS @ 7 7/16"
10'-1 1/2"	17 RISERS @ 7 3/4"	18 RISERS @ 7 9/16"	18 RISERS @ 7 11/16

# 2 TYPICAL STAIR DETIAL SCALE: 3/8" = 1'-0"

#### **GENERAL NOTES**

#### WALLS:

ALL WALLS ARE DRAWN 4"
THICK U.N.O.
ANGLED WALL ARE DRAWN
@45° U.N.O.

#### SMOKE DETECTORS:

LOCATION AND NUMBER OF DETECTORS SHALL CONFORM TO NEC.

#### EGRESS:

ALL BEDROOMS MUST HAVE
AT LEAST ONE WINDOW WHICH
CONFORMS TO R-310 OF THE
N.C. BLDG. CODE. IT IS THE
CONTRACTOR'S RESPONSIBILITY
TO VERIFY CHOSEN WINDOWS
MEET EGRESS REQUIREMENTS
AS MANUFATURERS VARY.

#### ATTIC ACCESS:

MIN. ATTIC ACCESS SHALL BE PROVIDED BY BUILDER AND LOCATED ON SITE.

## WALL/CEILING HGT. WALL AND CEILING HEIGHT

NOTES ARE BASED ON NOMINAL WALL SIZE.
KNEE WALL HEIGHT LABELS FOR WALLS UNDER RAFTERS ASSUME AN EXTRA 2" FOR FURRING (IN HEATED SPACES) FOR INSULATION. THE WALL HEIGHT REFERS TO THE HGT. FROM THE FLOOR DECKING TO THE BOTTOM OF THE FURRING.

NOTE:

HANDRAILS SHALL BE PROVIDE ON AT LEAST ONE SIDE OF STAIR TREADS WITH 4, OR MORE RISERS. VERTICAL HT. OF HANDRAILS SHALL BE NOT LESS THAN 34" AND NO MORE THAN 38" PER NC 2018 RESIDENTIAL CODE SEC. R311.7.8

GUARDS ON ALL HANDRAILS SHALL BE PLACED SO THAT A SPHERE OF 4" CANNOT PASS THROUGH PER NC 2018 RESIDENTIAL CODE SEC. R312.1



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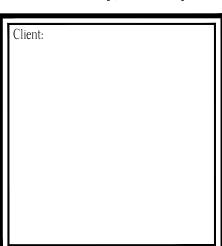
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	d By: RW		
Date: Revision		Revision Date	
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II ——			_

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FIRST FLOOR PLAN

Plan No.

A-1

Sheet No. Of

SQUARE FOOTAGE

FIRST FLOOR
SECOND FLOOR


TOTAL HEATED AREA

OVERALL WIDTH
OVERALL DEPTH

611 S.F.
810 S.F.

1441 S.F.

24'-0"
37'-4"

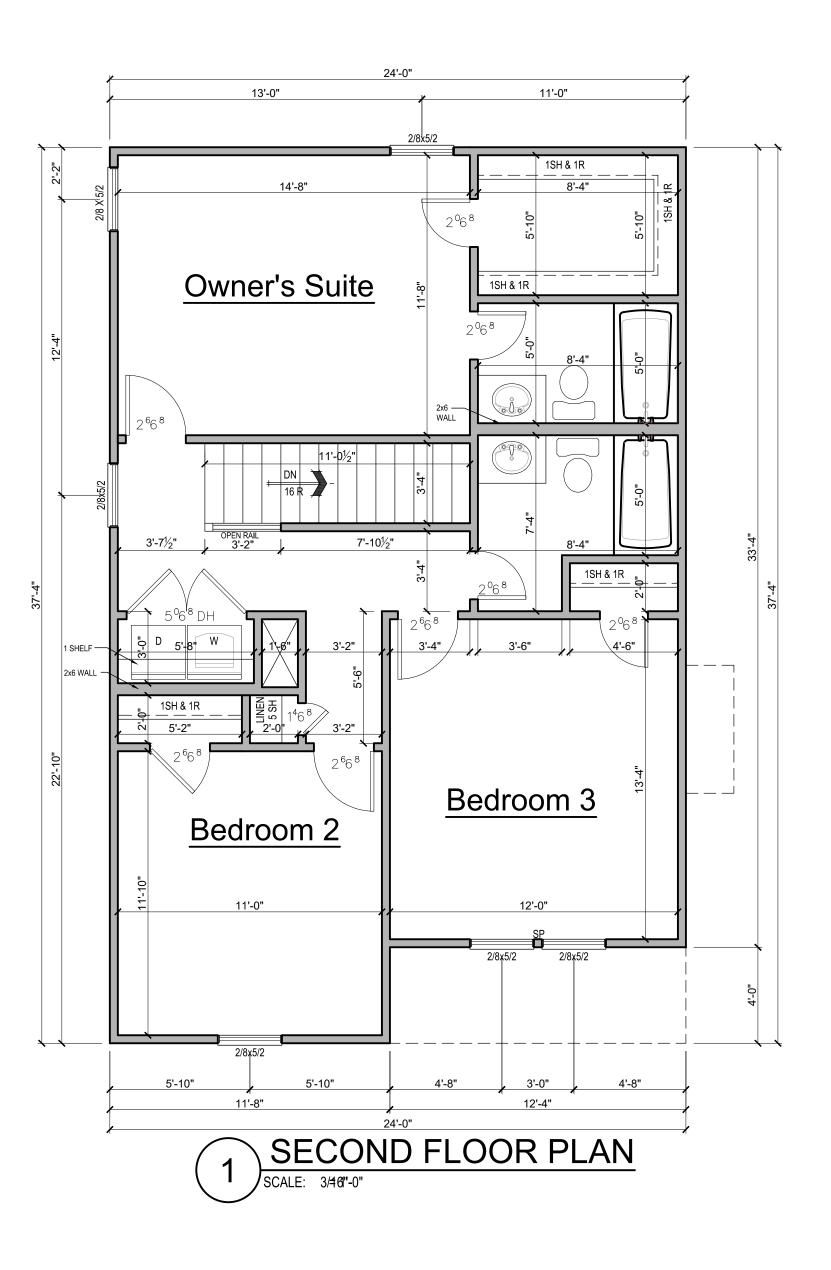



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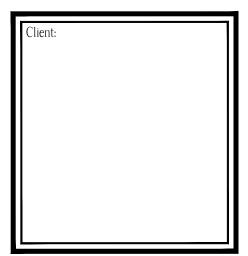
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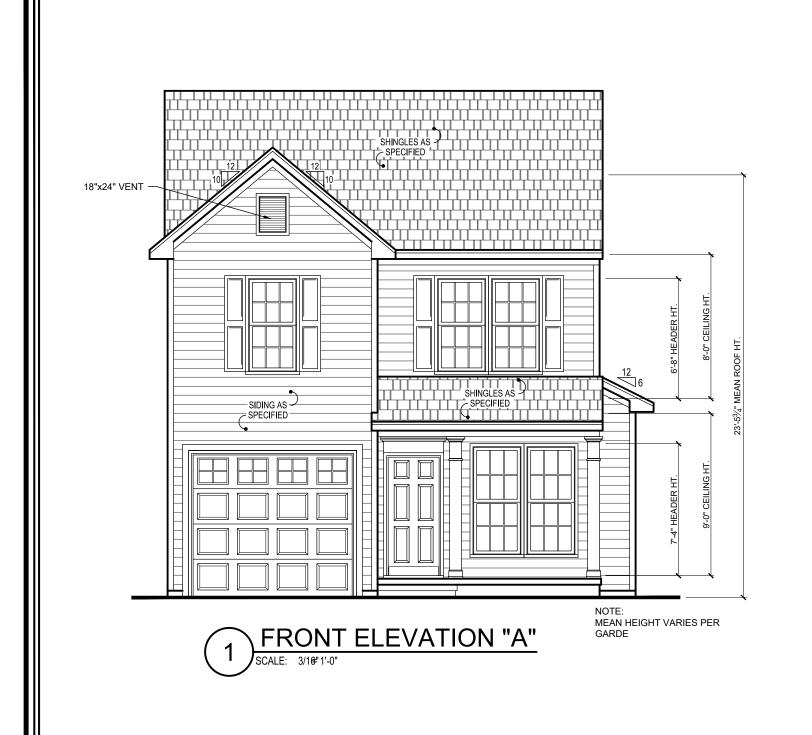
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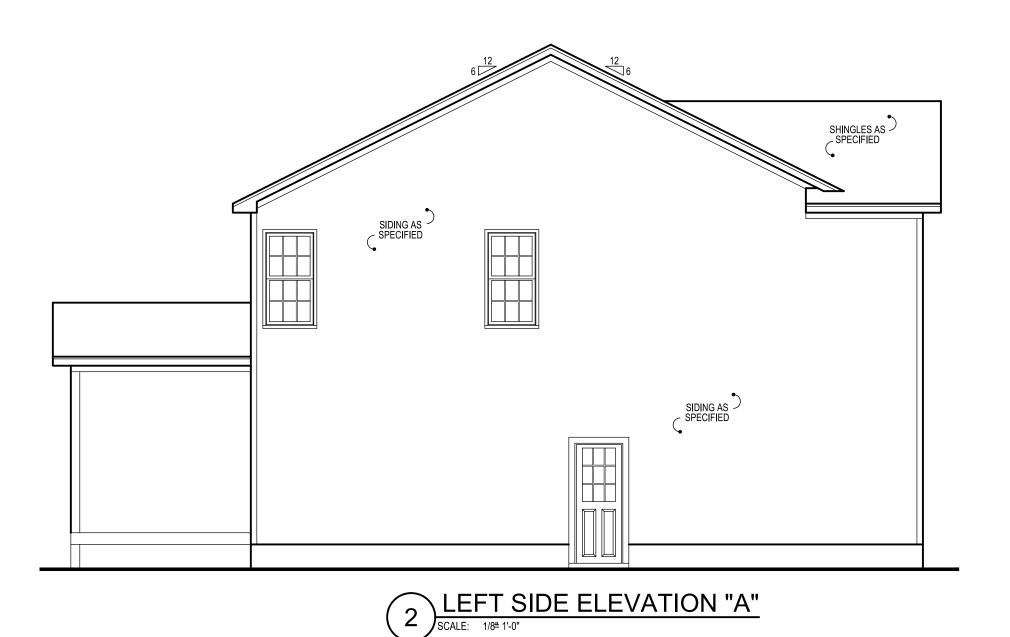
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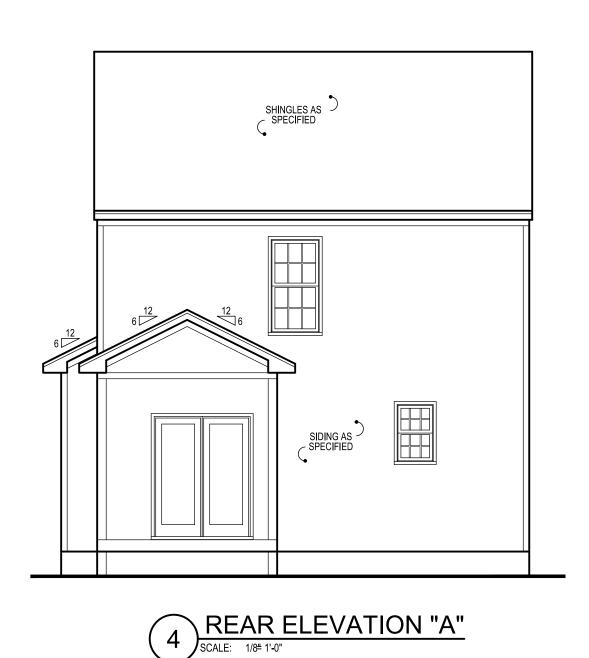



SECOND FLOOR PLAN


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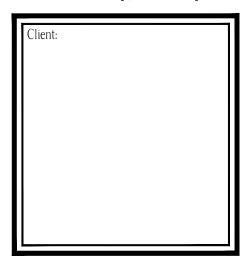
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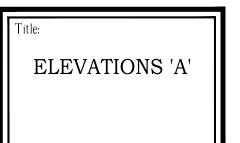
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Revision No.	Revision Date


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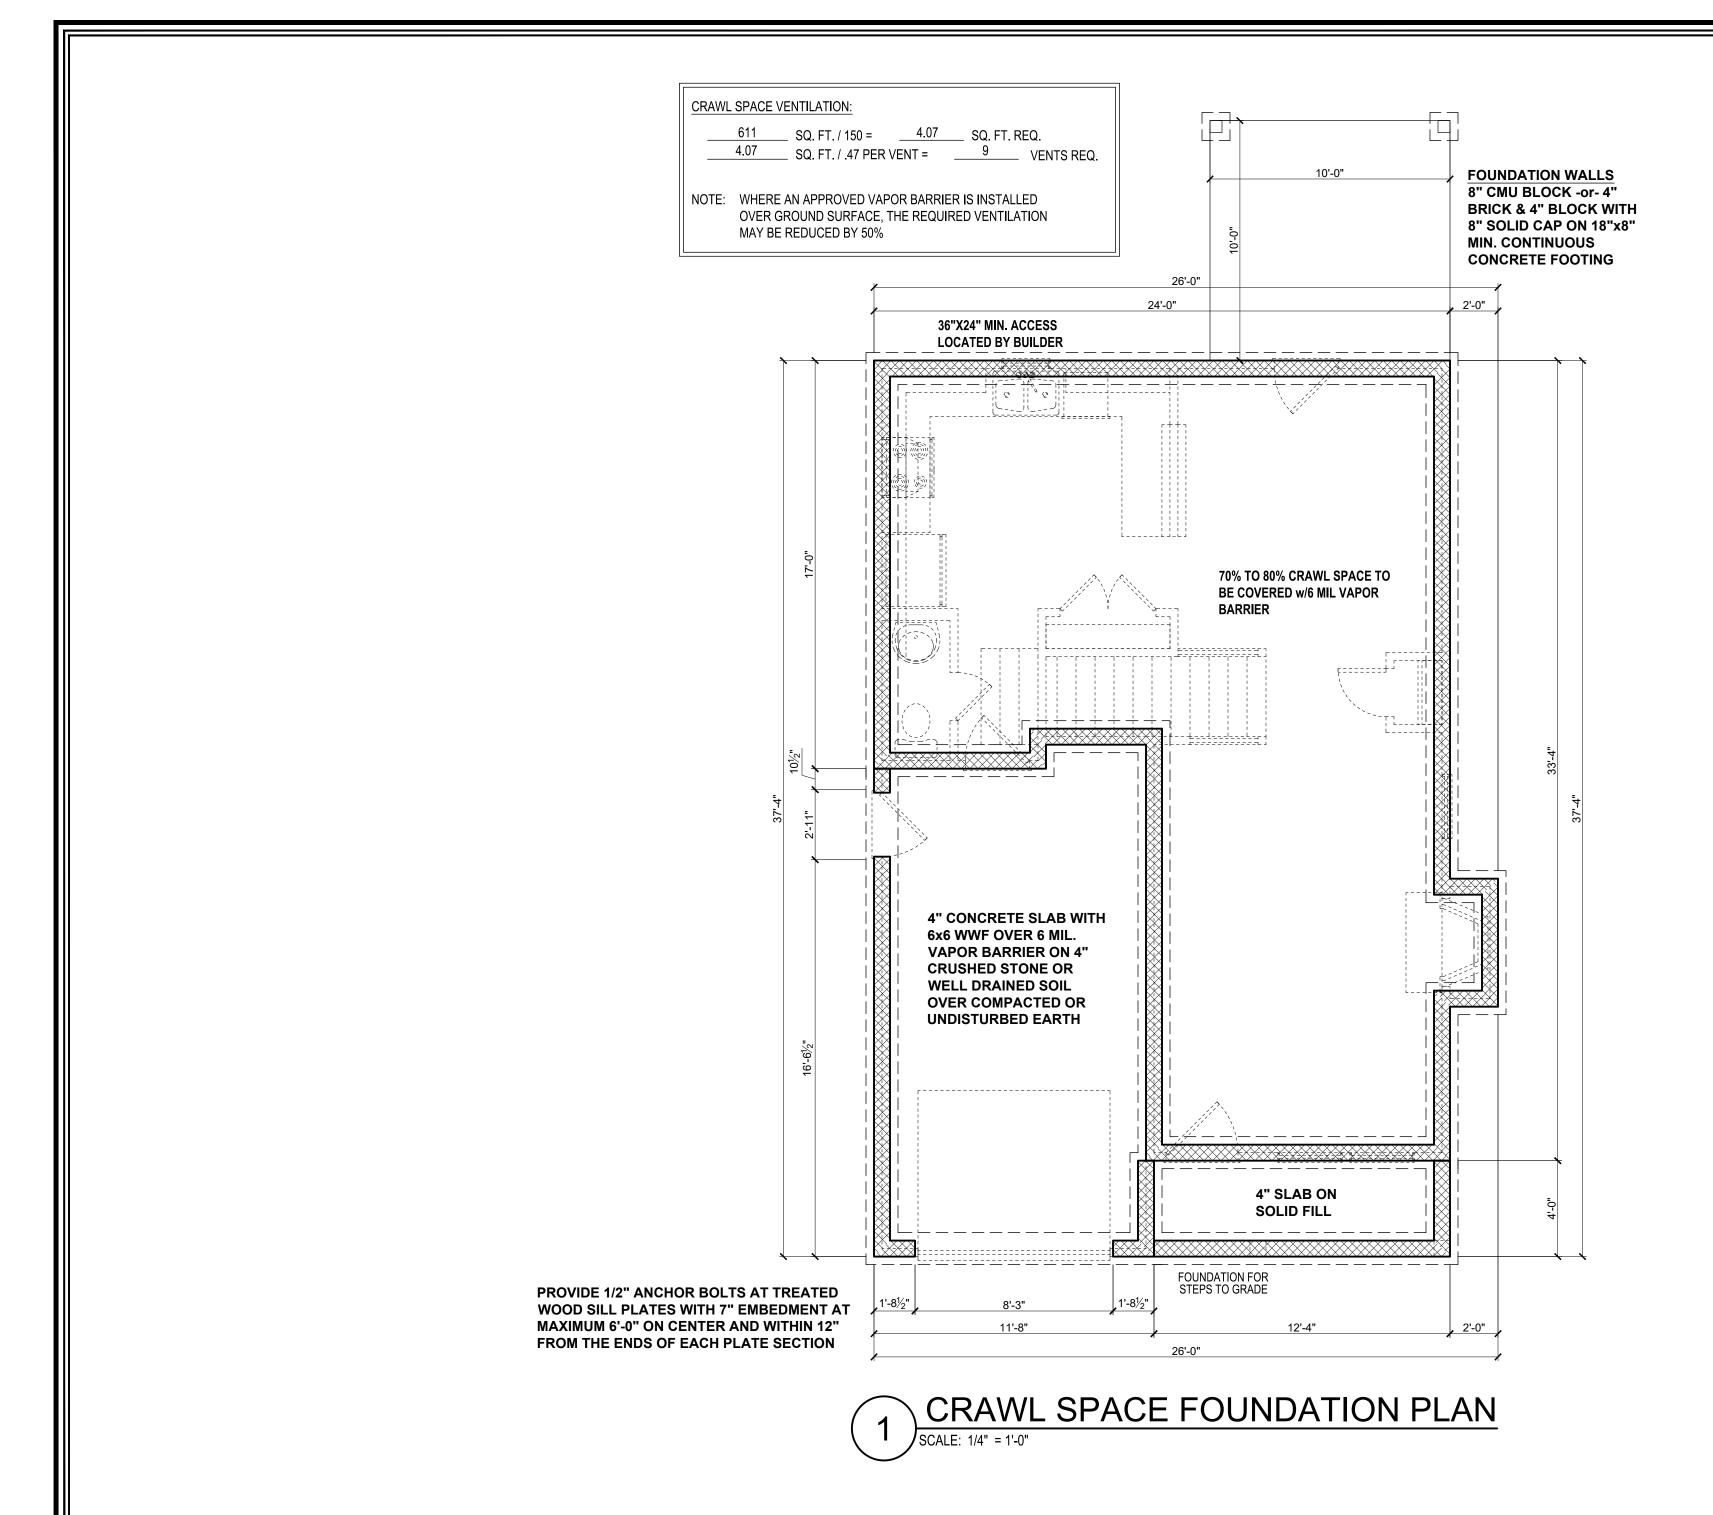
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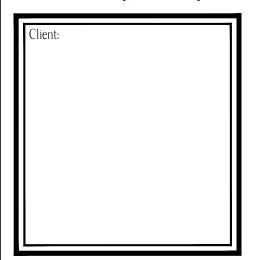
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		Revision No.	Revision Date


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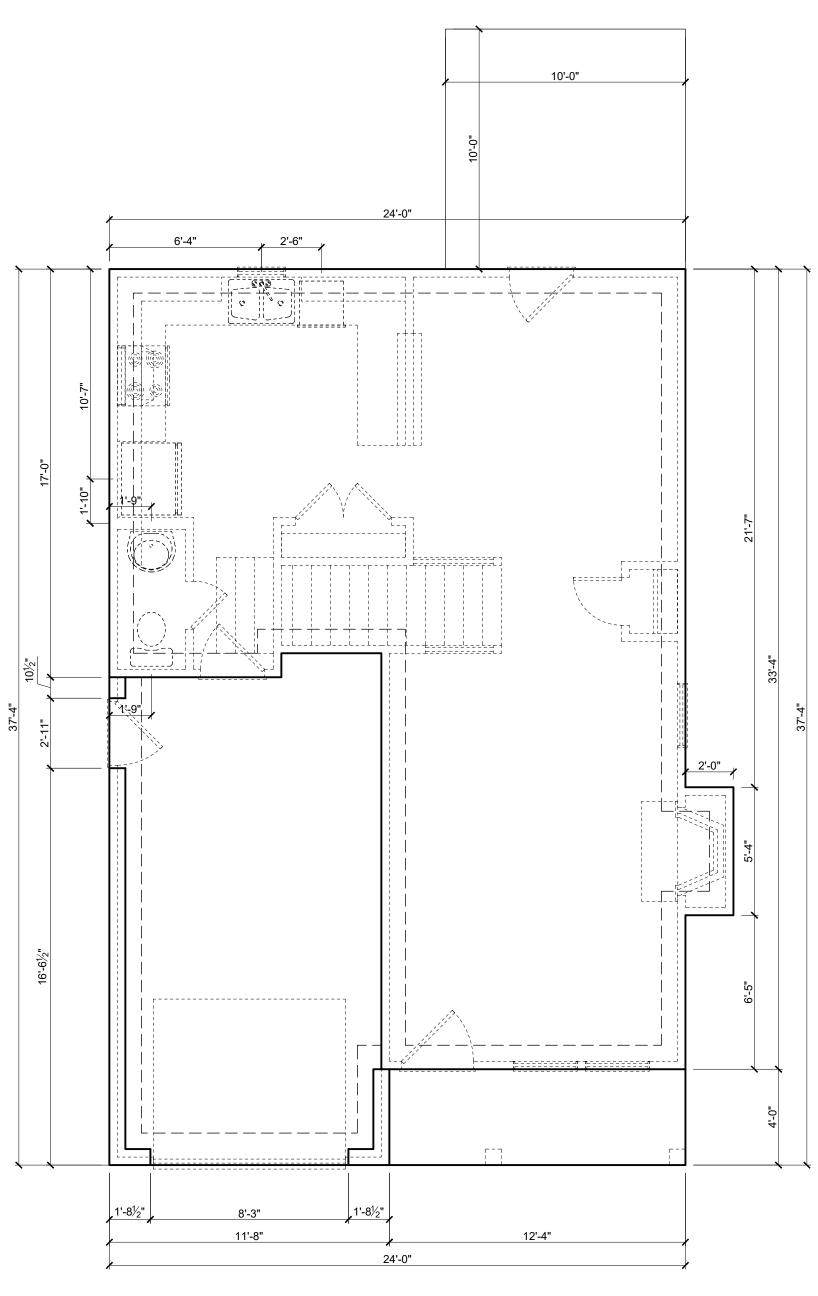
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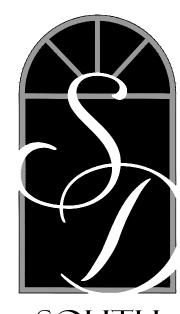
Title:
FOUNDATION



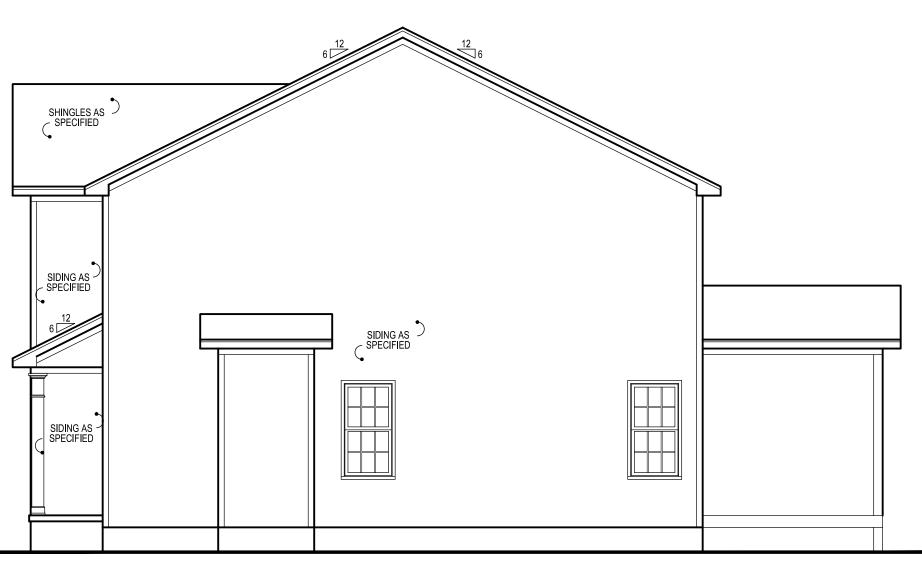

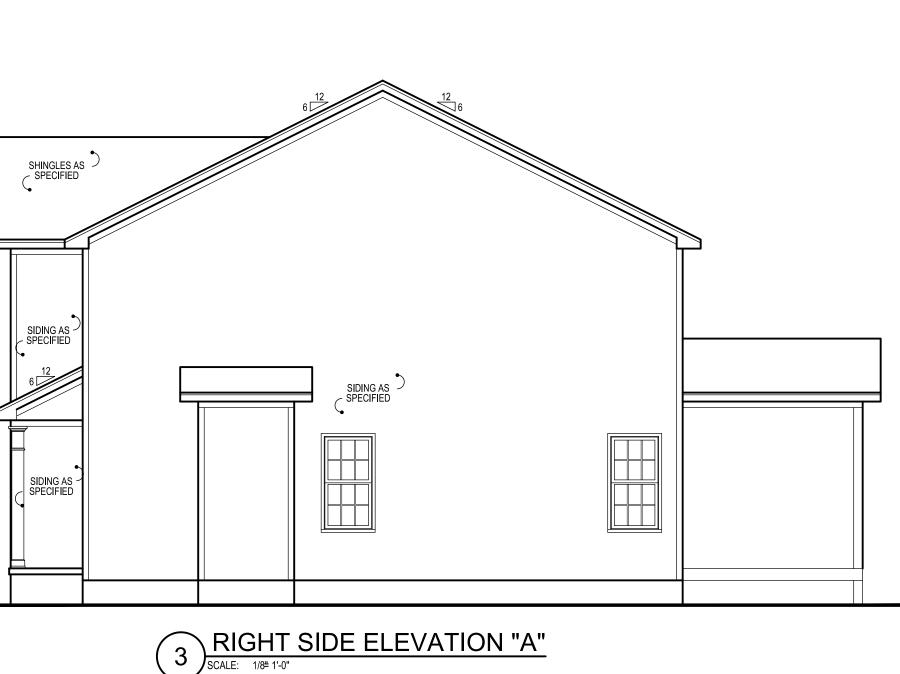MONOLYTHIC FOUNDATION PLAN

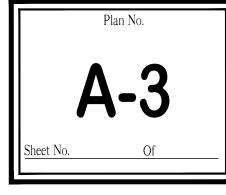SCALE: 1/4# 1'-0"

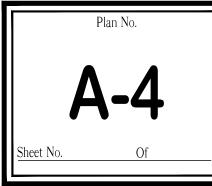

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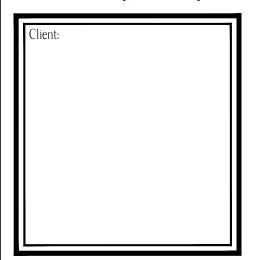
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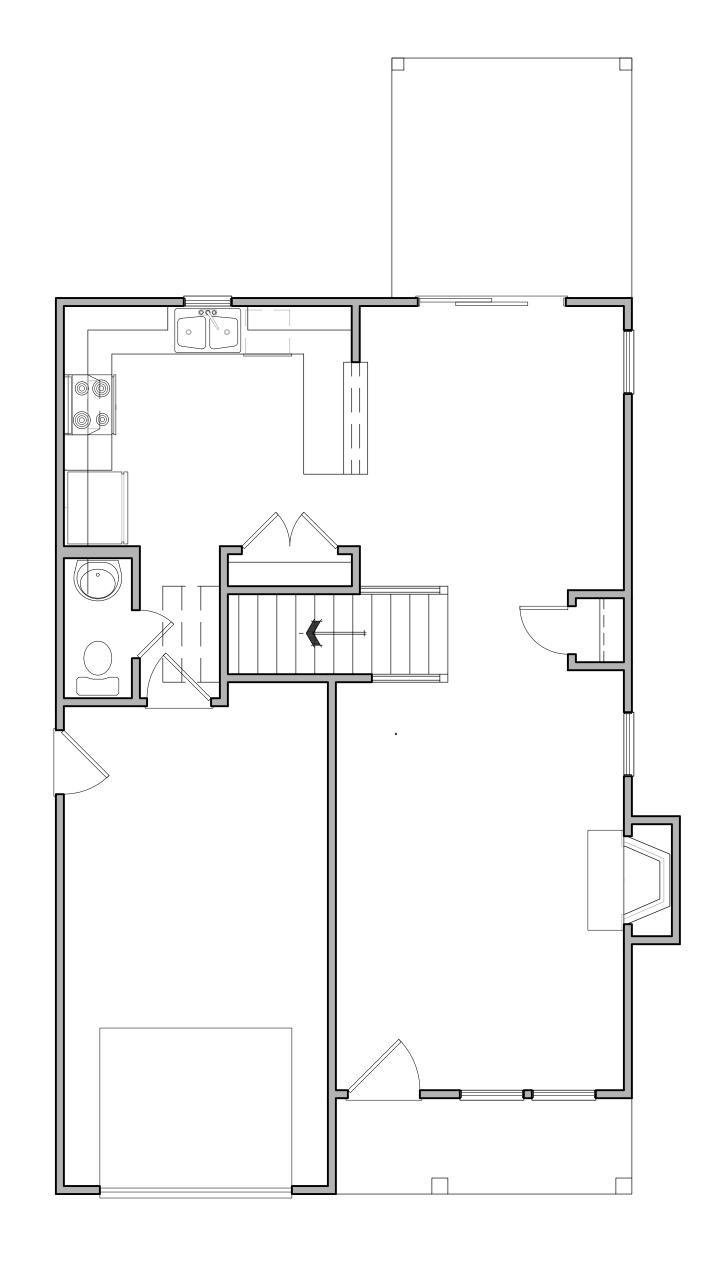


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FOUNDATION

Plan No.

A-4.1

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SECOND FLOOR FRAMING PLAN

SCALE: 1/4# 1'-0"



# SOUTH DESIGNS


P.O. Box 688 Wake Forest, NC 27588 (O) 919-556-2226 (F) 919-556-2228 www.southdesigns.com

	Drawn By: RWB
I	Checked By: RWB
I	Date: 5-24-2023
	Revision No. Revision Date

#### Designer Signature

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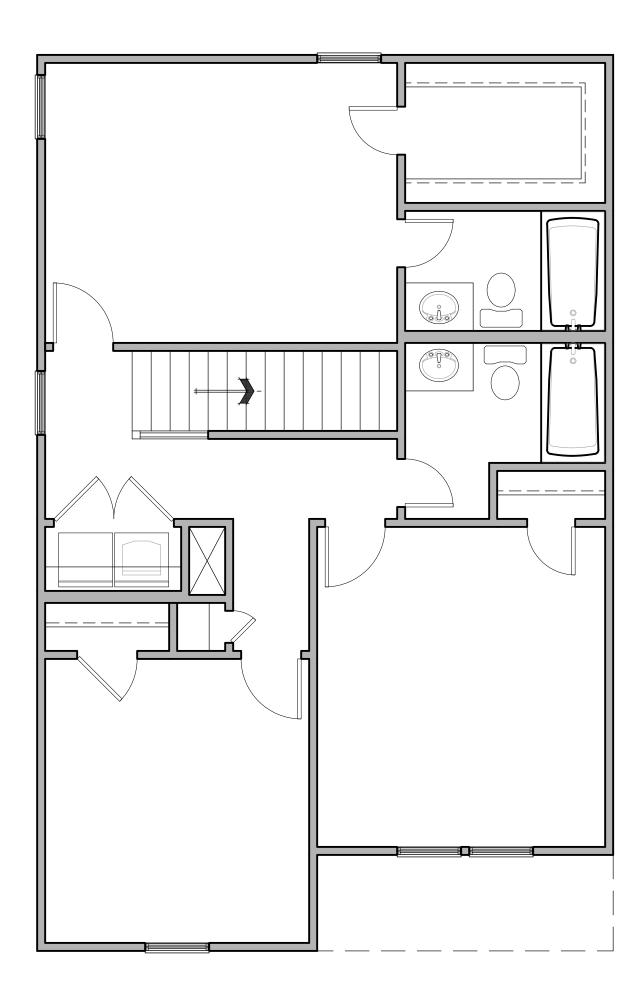
Title:

ELEVATIONS 'B'

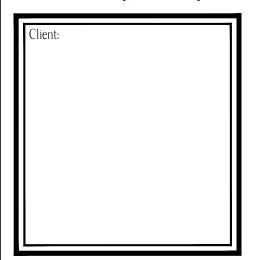Plan No.

A-5

Sheet No. Of







# SOUTH DESIGNS


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	Drawn By: RWB
ı	Checked By: RWB
ı	Date: 5-24-2023
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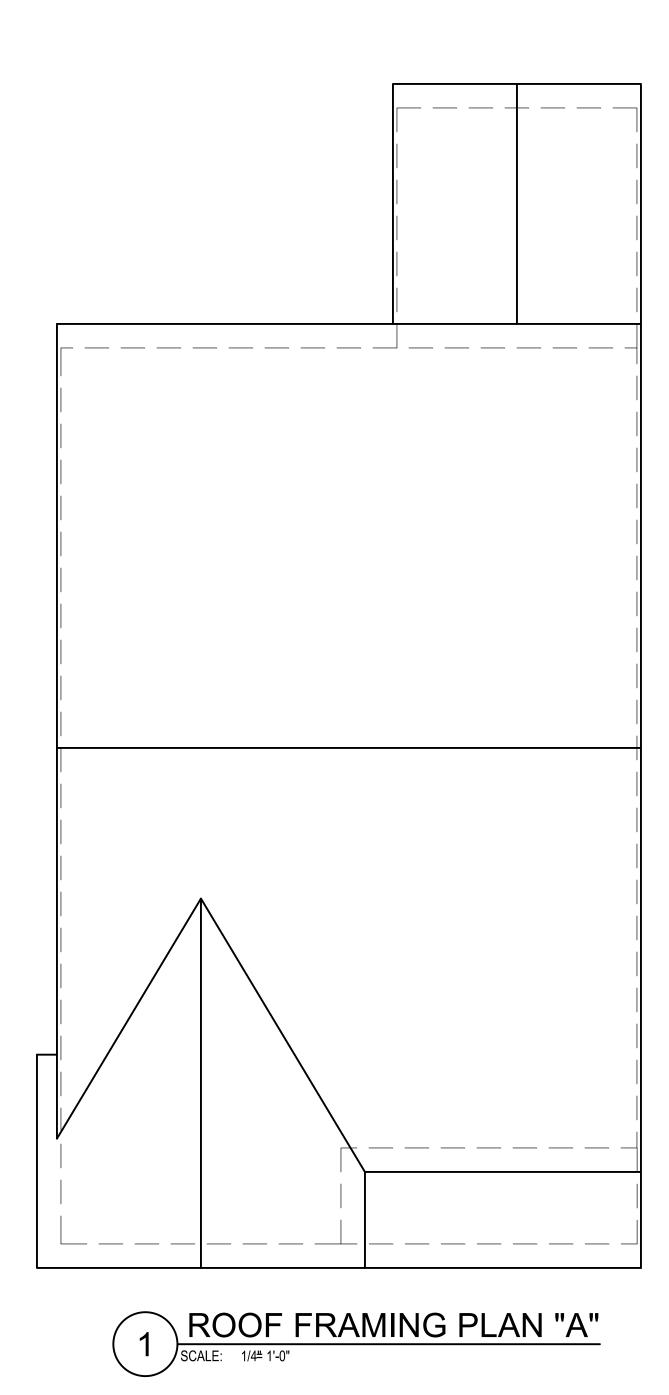
Title:

CEILING FRAMING

Plan No.

A-6

Sheet No. Of

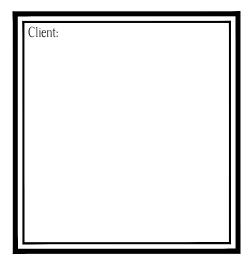



# SOUTH DESIGNS P.O. Box 688


Wake Forest, NC 27588 (O) 919-556-2226 (F) 919-556-2228 www.southdesigns.com

Drawn By: RWB
Checked By: RWB
Date: 5-24-2023
Revision No. Revision Date

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Title:
ROOF PLANS

Plan No.

A-7

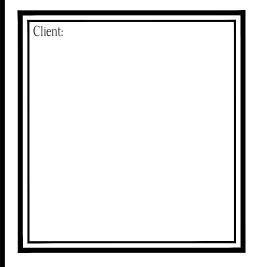Sheet No. Of