

—SCREEN

6" X 6" TREATED WOOD POSTS

PARGE & PAINT

FIBERGLASS SHINGLES (TYPICAL)

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RIGHT ELEVATION


MASONRY \_ Foundation

SCALE: 1/16" = 1'-0"

SIDING (TYP.)

CULTURED STONE

1 X 4 CORNER Board

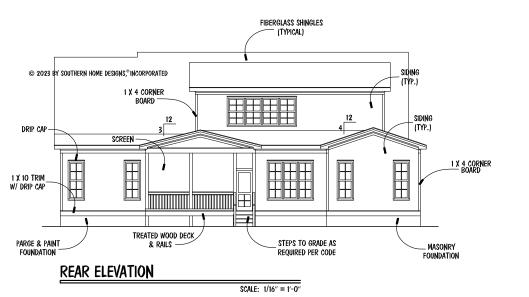



**CSIGNS** 


Southern Home D

THE MINION RESIDENCE LOT 120 SERENITY

TRIPLE A HOMES, INC. ENGR. #:

DATE: 03-30-23 SHEET: A-1

PLAN #: 23-033023

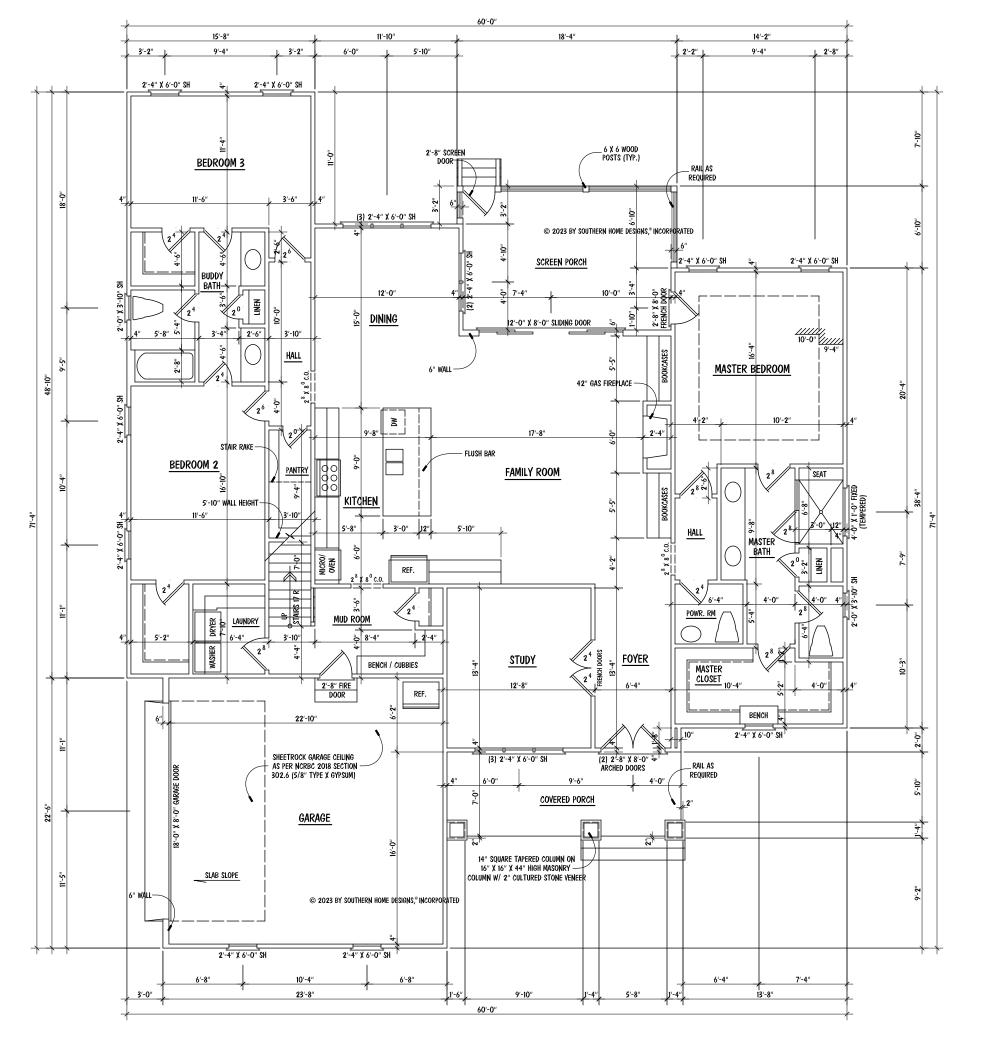

- SET WINDOWS @ 8'-0" A.F.F. (TYP.) U.N.O
- SET WINDOWS IN MASTER TOILET & BUDDY
- BATH @ 7'-4" A.F.F.
- STAIRS: UP 17 R (TYP.), 1ST FLOOR TO 2ND FLOOR

OF FREE VENT AREA REQUIRED

SEE SECTION R408.1 OF IRC 2015 NCRC 2018

FREE VENT AREA REQUIRED MAY BE REDUCED TO 1/1500 IF APPROVED VAPOR BARRIER IS INSTALLED OVER 100% OF CRAWL FLOOR AREA AND VENTS ARE INSTALLED TO PERMIT CROSS- VENTILATION OF CRAWL SPACE. SEE SECTION R408.1.1.

### NOTES:

• MEAN ROOF HEIGHT FOR THIS STRUCTURE IS 20'-9"

### ATTIC VENTILATION:

300

**SQUARE FOOTAGE** FIRST FLOOR 2415 SECOND FLOOR 595 TOTAL 3010 **MISCELLANEOUS** 530 GARAGE FRONT PORCH 137 SCREEN PORCH 213 MECH. / STOR. 809

## FIRST FLOOR PLAN

SCALE: 1/8" = 1'-0"

SHEET: A-2 PLAN #: 23-033023

DATE: 03-30-23

ENGR. #:

Houseplan

Southern

THE MINION RESIDENCE LOT 120 SERENITY

TRIPLE A HOMES, INC.

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NOTES:

- 10'-0" CEILING HGT. (TYP.) U.N.O.


CRAWL SPACE VENTILATION

2415 SQ. FT. OF CRAWL AREA / 150 = 16.10 SQ. FT.

3295 SQUARE FEET = 10.98 REQUIRED

THE NET FREE AREA OF VENTILATION REQUIRED IS TO BE

10.98 SQUARE FEET.

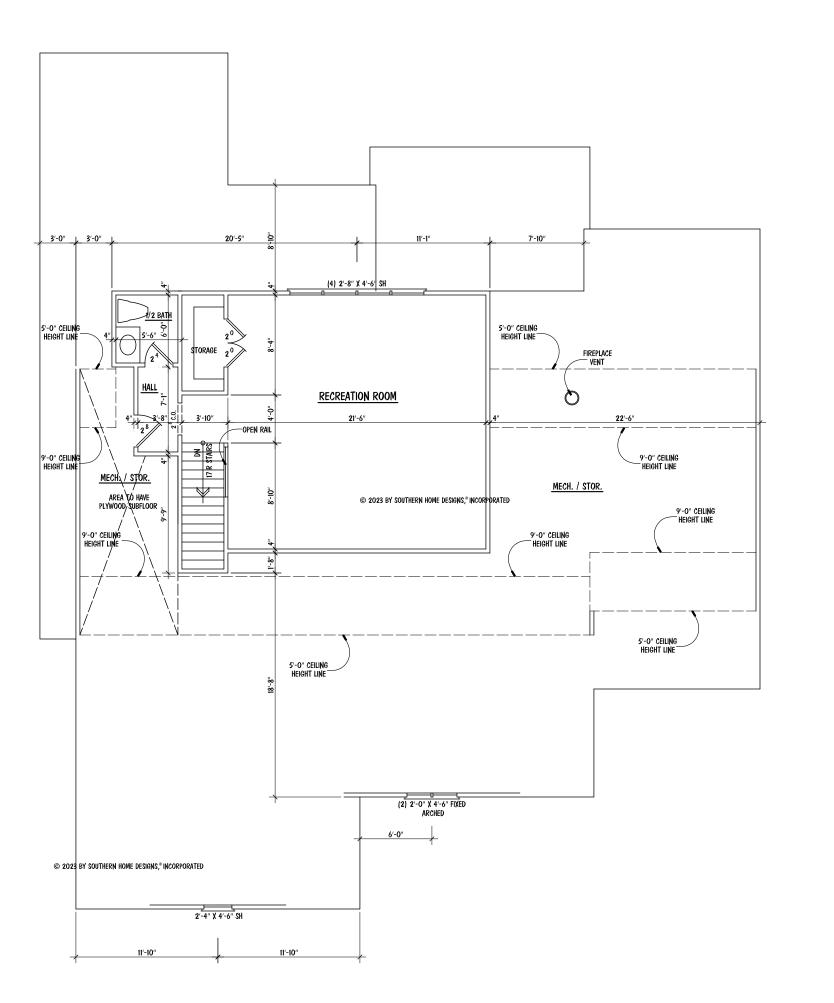

### NOTES:

- 9'-0" CEILING HGT. (TYP.) U.N.O. SET WINDOWS @ 7'-8" A.F.F. (TYP.) U.N.O SET WINDOW IN GARAGE GABLE @ 6'-2" A.F.F.
- SET WINDOWS IN FRONT GABLE @ 6'-8" A.F.F.
- STAIRS: DN 17 R (TYP.), 2ND FLOOR TO 1ST FLOOR



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THE MINION RESIDENCE LOT 120 SERENITY


TRIPLE A HOMES, INC.


## SECOND FLOOR PLAN


SCALE: 1/8" = 1'-0"


SHEET: A-3 PLAN #: 23-033023


DATE: 03-30-23

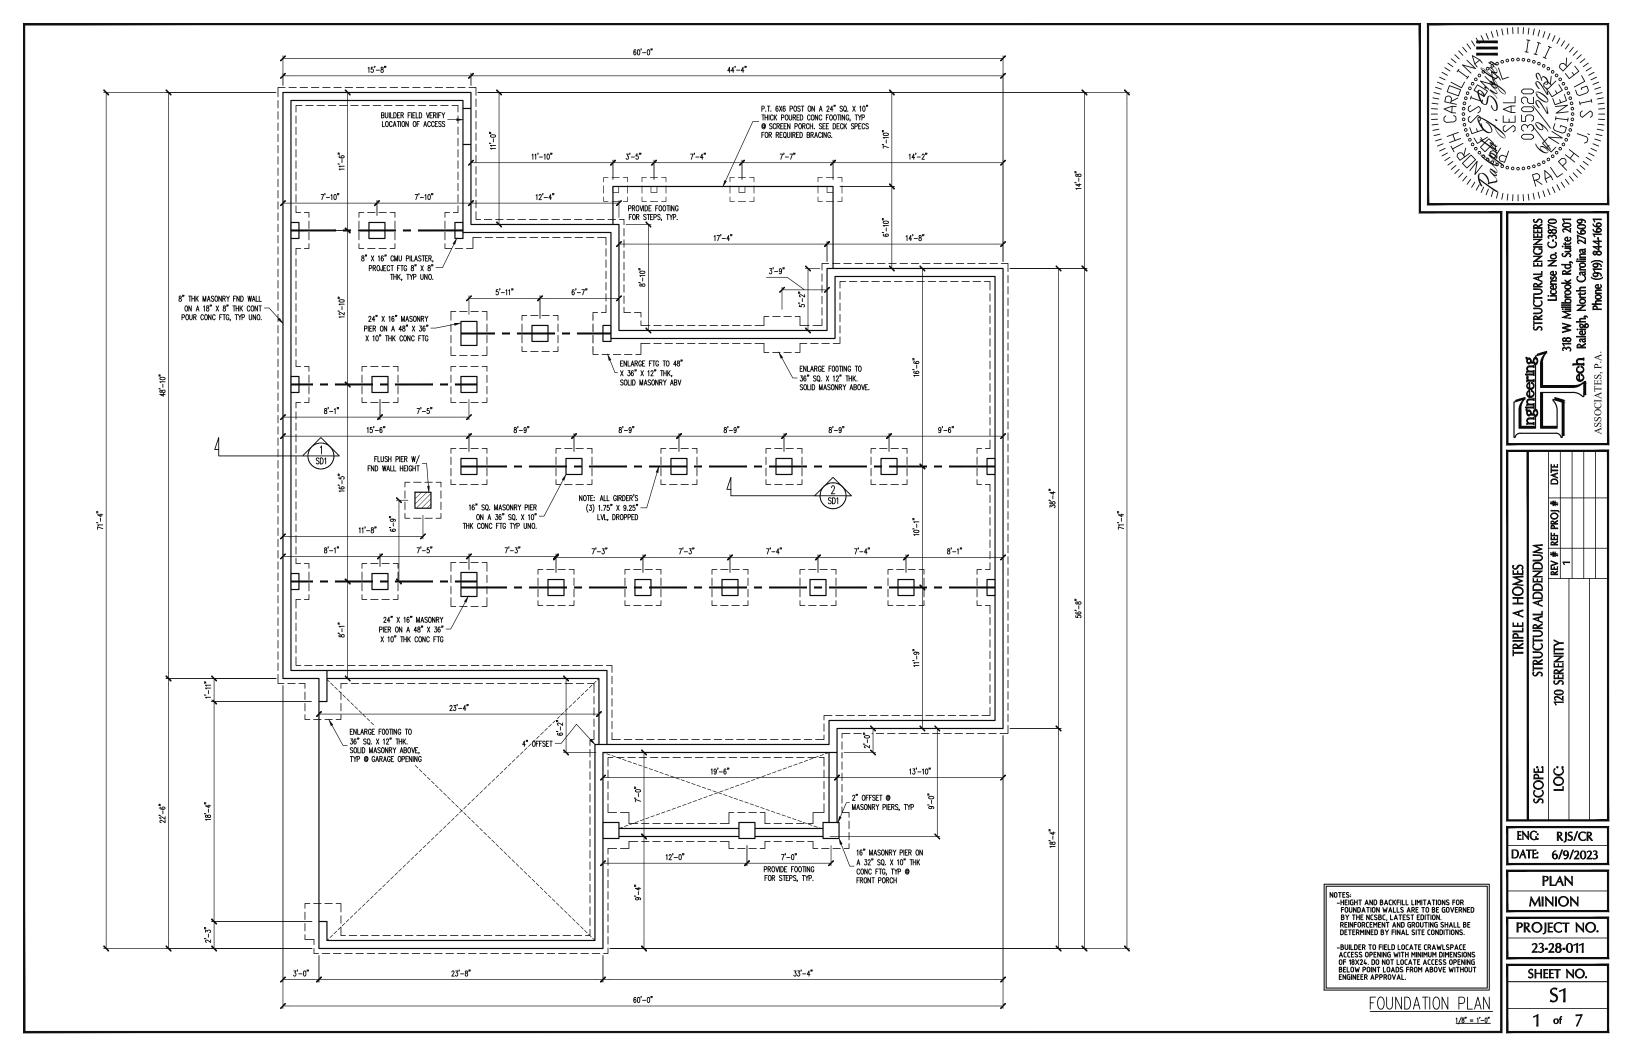

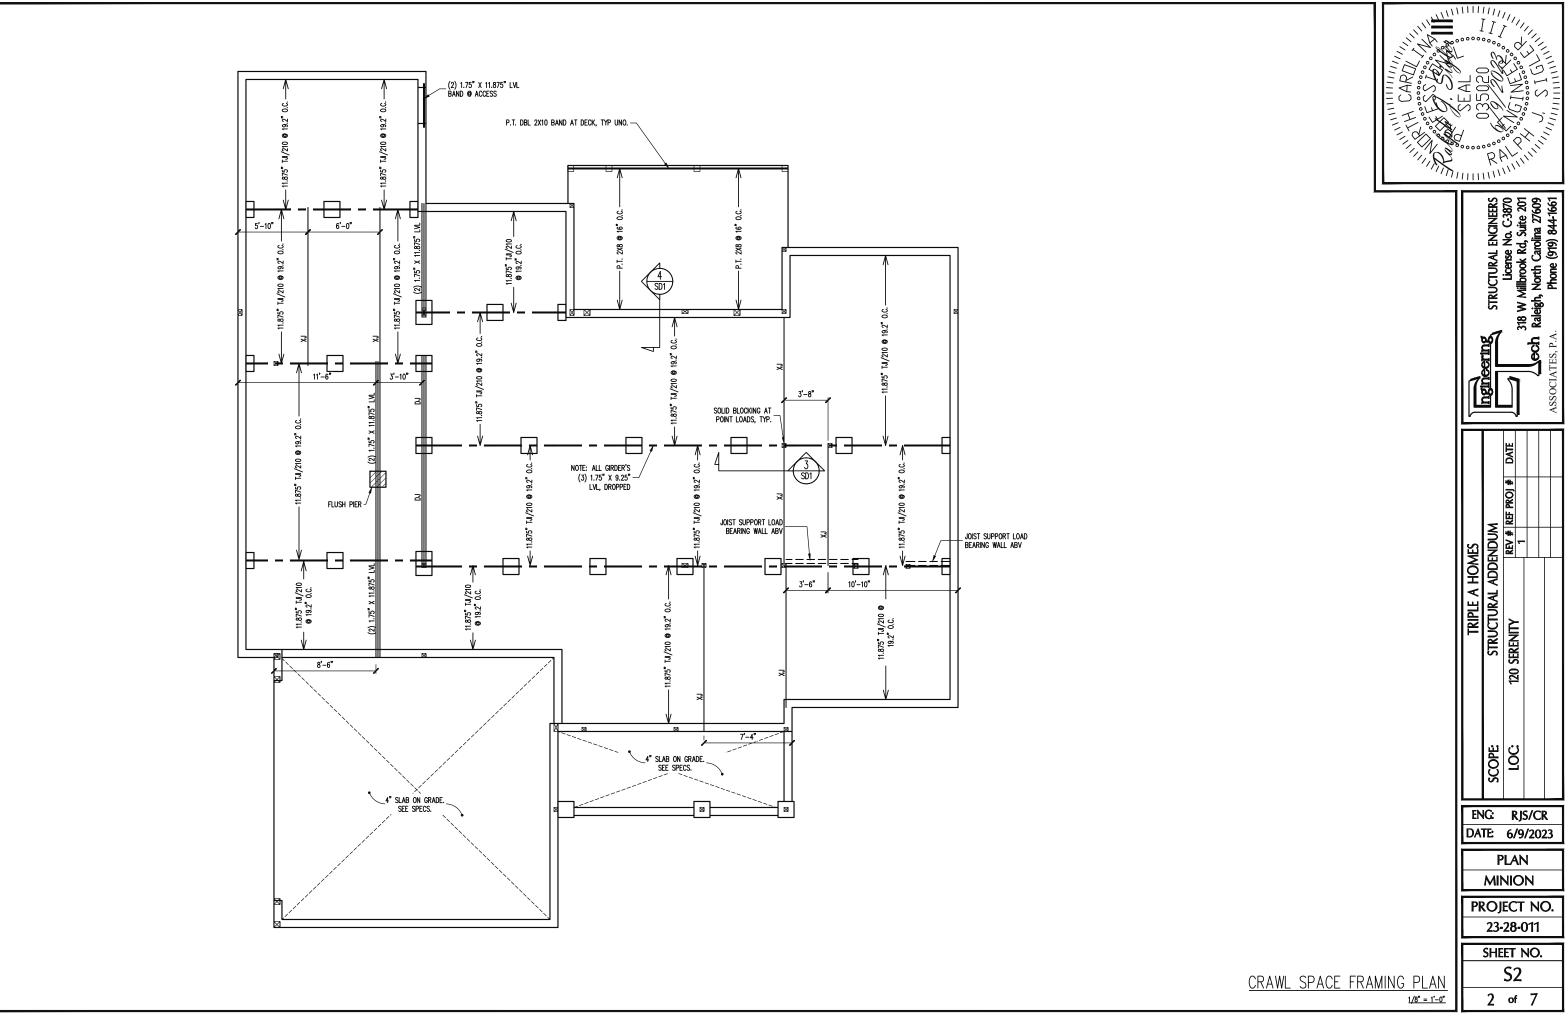

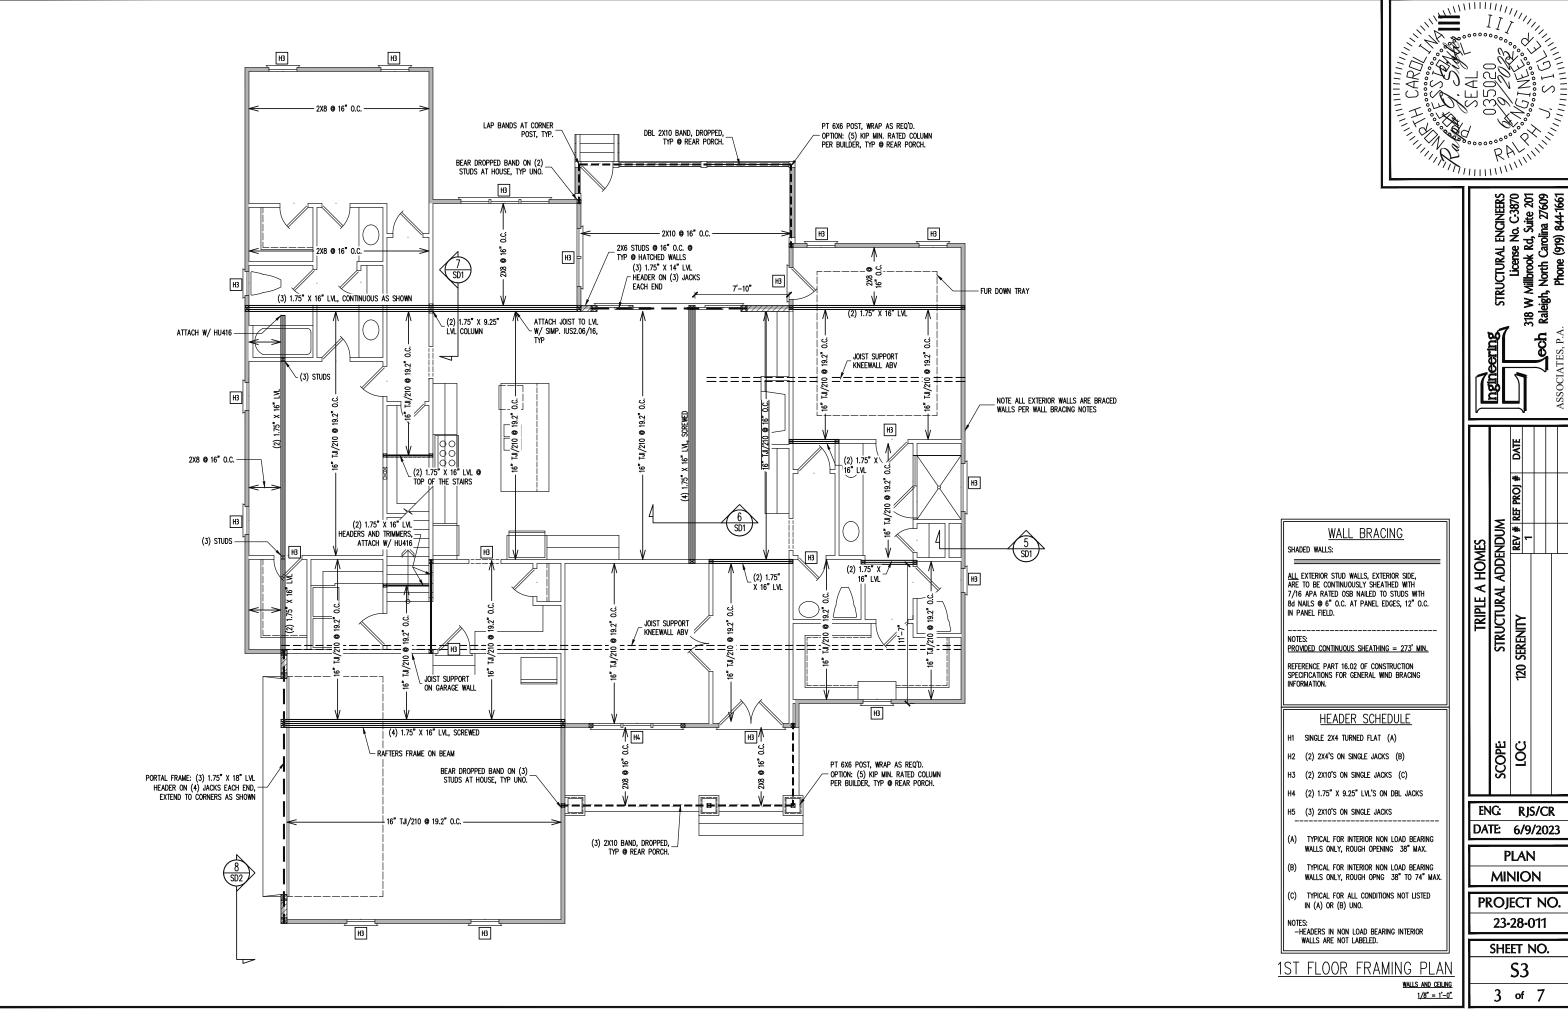

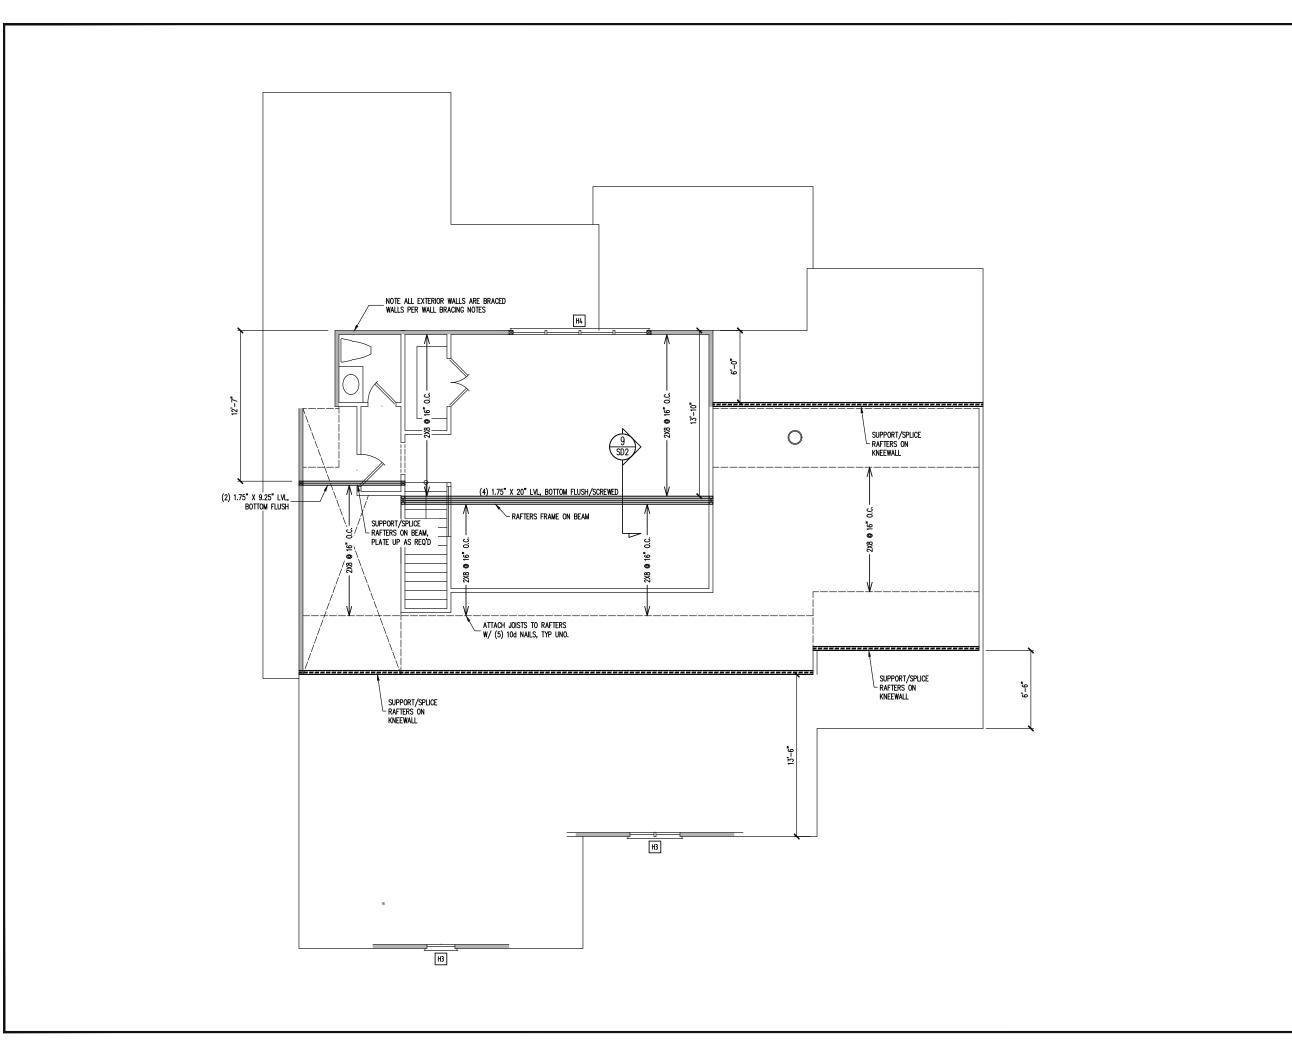

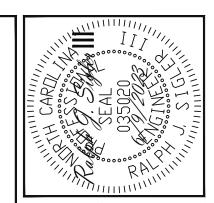

TRIPLE A HOMES
STRUCTURAL ADDENDUM
TITY

REV # REF PROJ #

WALL BRACING

ALL EXTERIOR STUD WALLS, EXTERIOR SIDE, ARE TO BE CONTINUOUSLY SHEATHED WITH 7/16 APA RATED OSB NAILED TO STUDS WITH 80 MAILS © 6" O.C. AT PANEL EDGES, 12" O.C. IN PANEL FIELD.

SHADED WALLS:

NOTES: PROVIDED CONTINUOUS SHEATHING = 132' MIN.

REFERENCE PART 16.02 OF CONSTRUCTION SPECIFICATIONS FOR GENERAL WIND BRACING INFORMATION.

## HEADER SCHEDULE

- H1 SINGLE 2X4 TURNED FLAT (A)
- H2 (2) 2X4'S ON SINGLE JACKS (B)
- H3 (2) 2X10'S ON SINGLE JACKS (C)
- H4 (2) 1.75" X 9.25" LVL'S ON DBL JACKS
- H5 (3) 2X10'S ON SINGLE JACKS
- (A) TYPICAL FOR INTERIOR NON LOAD BEARING WALLS ONLY, ROUGH OPENING 38" MAX.
- (B) TYPICAL FOR INTERIOR NON LOAD BEARING WALLS ONLY, ROUGH OPNG 38" TO 74" MAX.
- (C) TYPICAL FOR ALL CONDITIONS NOT LISTED IN (A) OR (B) UNO.

-HEADERS IN NON LOAD BEARING INTERIOR
WALLS ARE NOT LABELED.

## 2ND FLOOR FRAMING PLAN

WALLS AND CEILING  $1/8^{\circ} = 1'-0''$ 

4 of 7

ENG: RJS/CR

DATE: 6/9/2023


PLAN


MINION

PROJECT NO. 23-28-011

SHEET NO.

**S4** 

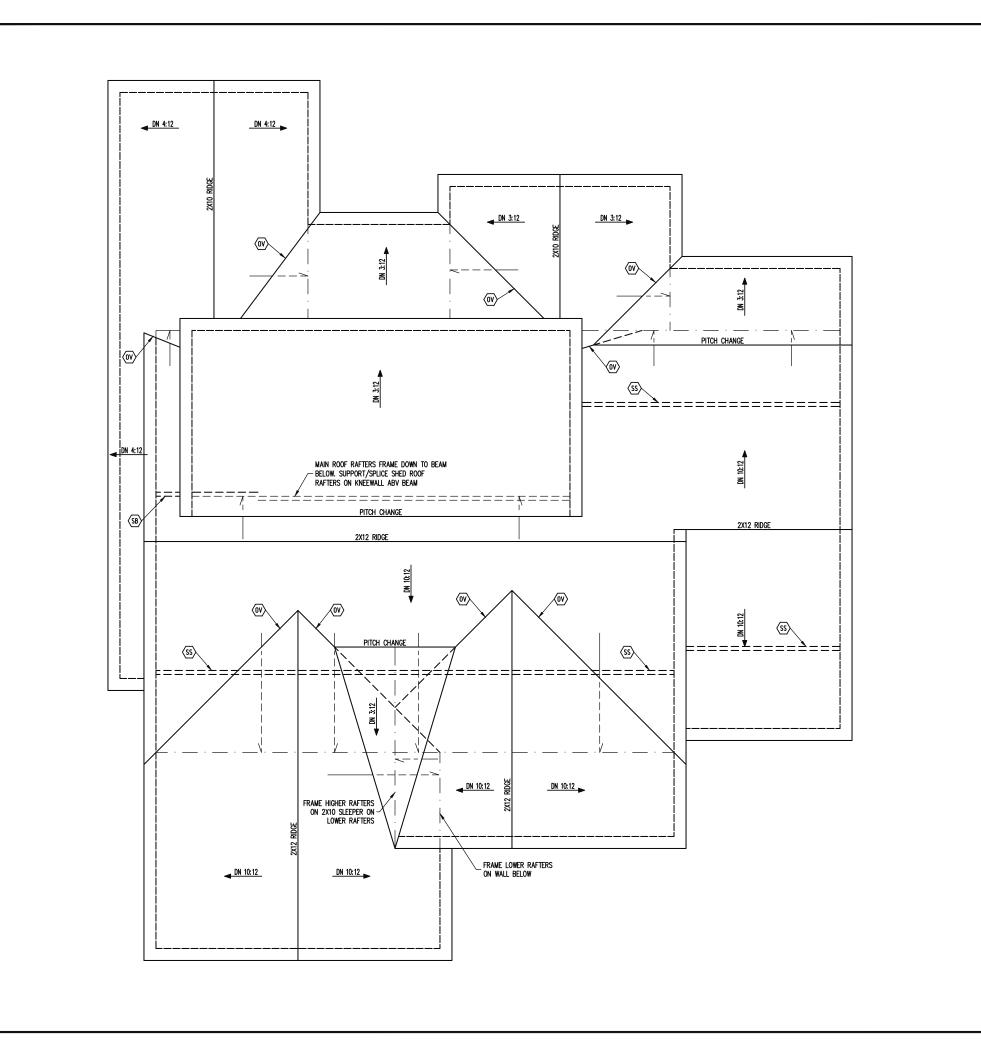

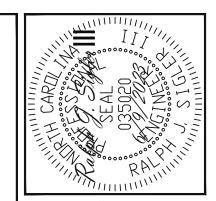

STRUCTURAL ADDENDUM

O SERENITY

REV # REF PROJ #

FRAMING NOTES

ROOF ONLY

-COMMON RAFTERS 2X8 © 16" O.C. TYP U.N.O.

-COLLAR TIES 2X4 EVERY 3RD SET OF RAFTERS
TYP U.N.O.

-ROOF PITCHES 12:12 TYP U.N.O.

-VERIFY ROOF PITCHES, OVERHANG LENGTHS, AND KNEEWALL FRAMING HGTS WITH ARCHITECTURAL DRAWNGS, TYPICAL.

# FRAMING SCHEDULE

- SUPPORT BRICK VENEER WITH ANGLE ATTACHED TO MODIFIED STUD WALL
- SUPPORT BRICK VENEER PER SECT.703.7 OF THE NCRC, LATEST EDITION.
- OV OVERFRAME VALLEY ( 2X10 SLEEPER )
- SK DBL 2X4 STIFF KNEE
- SUPPORT/SPLICE RAFTERS ON KNEEWALL BELOW

ROOF FRAMING PLAN

**S5** 5 of 7

ENG: RJS/CR

DATE: 6/9/2023


PLAN


MINION

PROJECT NO.

23-28-011

SHEET NO.

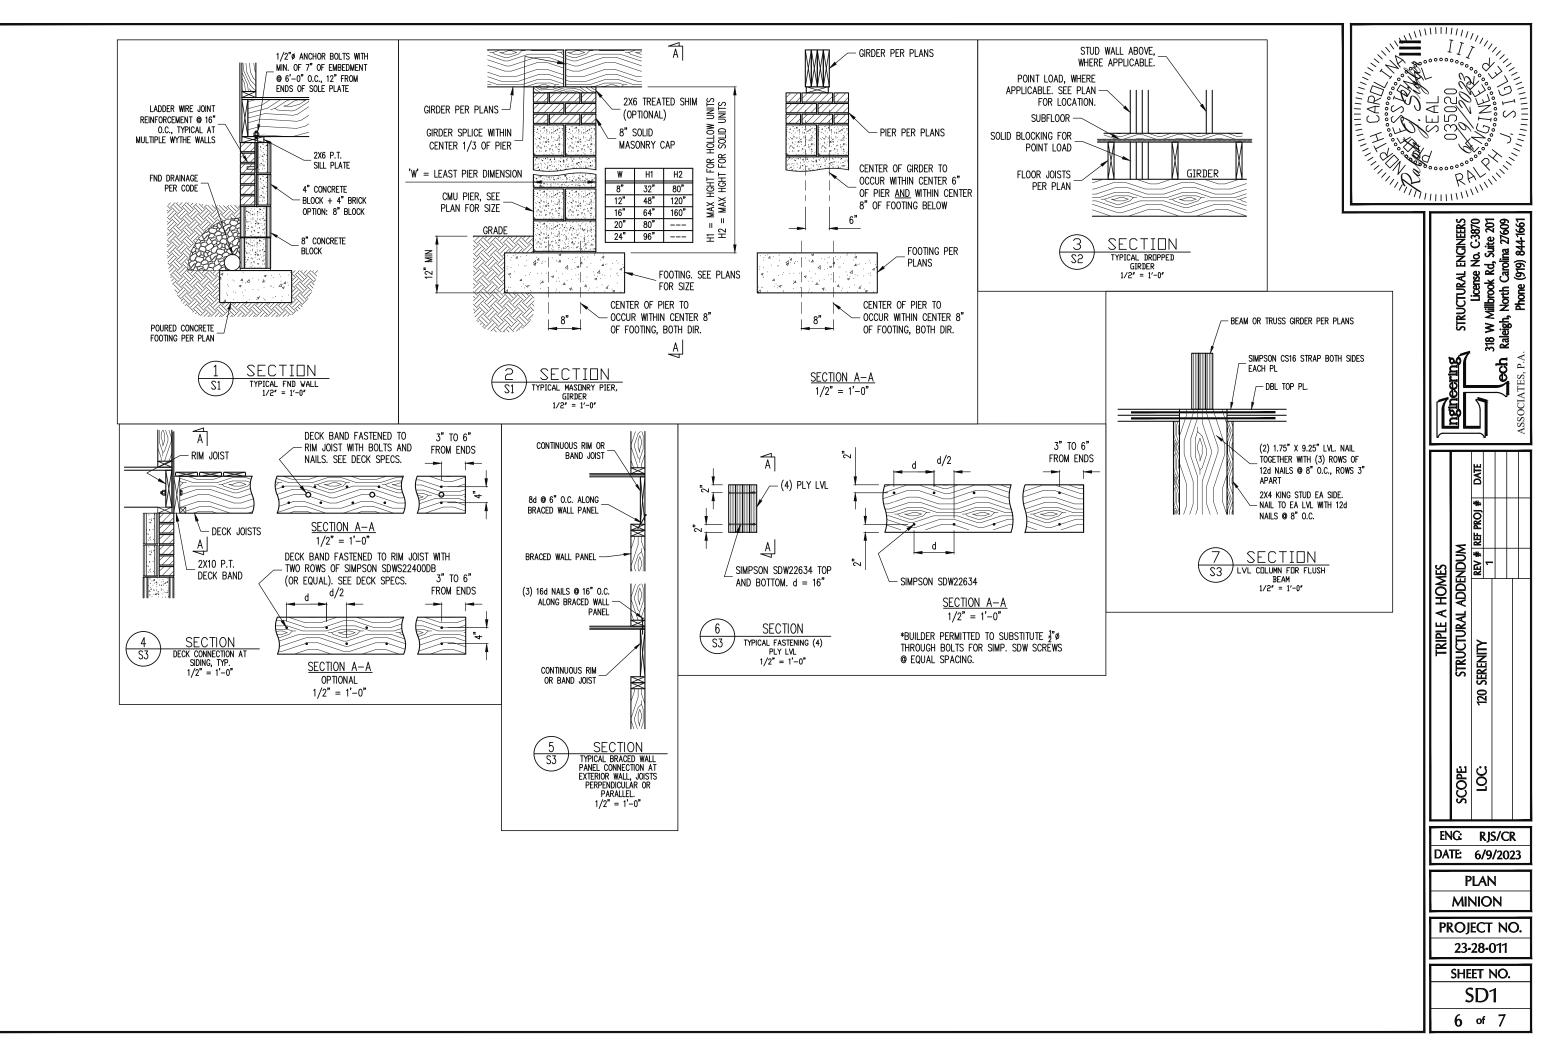

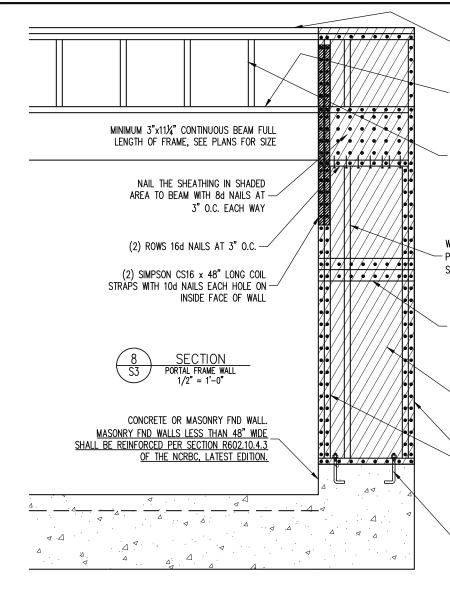

(2) CONT. 2X TOP PLATES, EXTEND EACH END INTO ADJACENT WALL. NAIL SPLICES WITH 8-16d NAILS PER SPLICE/LAP.

CONT. 2X PLATE WITH 10d NAILS AT 16" O.C. INTO HEADER/BEAM

7/16" O.S.B. OR 15/32" PLYWOOD EXTERIOR WALL SHEATHING AT UNSHADED AREAS (BEAM, INFILL WALL ABOVE BEAM, AND CENTER WALL). NAIL SHEATHING TO ALL SUPPORTS (STUDS, PLATES, BLOCKING, ETC.) WITH 8d NAILS AT 6" O.C. AT SHEET EDGES AND 12" O.C. IN THE FIELD.


WHERE FULL HEIGHT PANEL WIDTH EXCEEDS 16", PROVIDE ADDITIONAL STUDS AT 16" O.C. NAIL SHEATHING TO ALL STUDS WITH 8d NAILS AT 3" O.C.


FOR A PANEL SPLICE (IF NEEDED), PANEL EDGES SHALL OCCUR OVER AND BE NAILED TO COMMON BLOCKING AND OCCUR WITHIN MIDDLE 24" OF WALL HEIGHT. ONE ROW OF 3" O.C. NAILING IS REQUIRED IN EACH PANFL FDGF.

> 7/16" O.S.B. OR 15/32" PLYWOOD EXTERIOR WALL SHEATHING. AT SHADED AREAS NAIL SHEATHING TO ALL SUPPORTS (STUDS, PLATES, BLOCKING, ETC.) WITH 8d NAILS AT 3" O.C.

(2)2x STUD MIN. AT START AND END OF WALL SEGMENTS EACH SIDE OF OPENING. SEE PLANS FOR ADDITIONAL STUDS

2x4 P.T. PLATE WITH TWO 1/2" DIA x 7" EMBED ANCHOR BOLTS WITH A 3/16"x2"x2" PLATE WASHERS OR ADDITIONAL HOLDOWN PER PLANS. OPTION: (2) 5/8" DIA. THREADED RODS INSTALLED PER SECTION R602.10.4.3 OF THE NCRBC, LATEST EDITION.

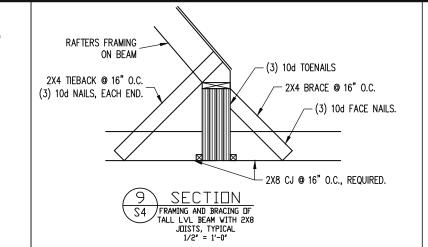

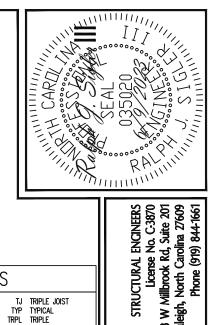

## **NOTES**

THE RUILDER IS RESPONSIBLE FOR REVIEWING PLANS PRIOR TO CONSTRUCTION. THE RUILDER SHALL IMMEDIATELY CONTACT THE ENGINEER OF RECORD (EOR) BEFORE PROCEEDING IF THE Following conditions are noted before or during construction:

- 1) THE WORKING PLANS DO NOT BEAR THE SEAL OF THE EOR
- 2) THE PLANS CONTAIN DISCREPANT OR INCOMPLETE INFORMATION

ANY ERRORS DUE TO A FAILURE TO FOLLOW THE ABOVE PROCEDURES SHALL NOT BE THE RESPONSIBILITY OF THE EOR. FURTHERMORE, IT IS THE RESPONSIBILITY OF THE BUILDER TO ENSURE THAN ANY REVISIONS ISSUED BY THE EOR ARE PROMPLY DISTRIBUTED TO THE

THE EOR DOES NOT PERFORM FENESTRATION OR VENTING CALCULATIONS OR ANY OTHER CALCULATIONS THAT ARE NOT DIRECTLY RELATED TO STRUCTURAL ENGINEERING.

FL PL FLITCH PLATE ROOF AND FLOOR TRUSSES TO BE DESIGNED BY AN ENGINEER REGISTERED BY THE STATE. FINAL TRUSS DRAWING SHOULD BE SUBMITTED TO THE EOR FOR REVIEW

## **ABBREVIATIONS**

- FND FOUNDATION FTG FOOTING HDG HOT DIPPED GAI VANIZED HGR HANGER
- LVL LAMINATED VENEER NTS NOT TO SCALE O.C. ON CENTER

SQ SQUARE

PSL PARALLEL STRAND LUMBER PT PRESSURE TREATED QJ QUAD JOIST SP SPACE (OR SPACING) SSP SINGLE STUD POCKET

## TJ TRIPLE JOIST TYPICAL TRPL TRIPLE TSP TRIPLE STUD POCKET

## OTHERWISE XJ EXTRA JOIST

## DECK SPECIFICATIONS

ABV ABOVE

RTWN RFTWFFN

CONC CONCRETE

DBL DOUBLE

EQ EQUAL

FLG FLANGE

EACH

DSP

BOTH ENDS

DIAMETER

DOUBLE JOIST

DBL STUD POCKET

CONTINUOUS SHEATHING

- A DECK IS AN EXPOSED EXTERIOR WOOD FLOOR STRUCTURE WHICH MAY BE ATTACHED TO A STRUCTURE OR BE FREE STANDING. ROOFED PORCHES, OPEN OR SCREENED IN, MAY BE CONSTRUCTED USING THESE PROVISIONS.
- SUPPORT POSTS SHALL BE SUPPORTED BY A FOOTING.
- WHEN ATTACHED TO A STRUCTURE, THE STRUCTURE TO WHICH ATTACHED SHALL HAVE A TREATED WOOD BAND FOR THE LENGTH OF THE DECK, OR CORROSION RESISTANT FLASHING 9. SHALL BE USED TO PREVENT MOISTURE FROM COMING IN CONTACT WITH THE UNTREATED FRAMING OF THE STRUCTURE. THE DECK BAND AND THE STRUCTURE BAND SHALL BE CONSTRUCTED IN CONTACT WITH FACH OTHER EXCEPT AT BRICK VENEER AND WHERE PLYWOOD SHEATHING IS REQUIRED AND PROPERLY FLASHED. SIDING SHALL NOT BE INSTALLED BETWEEN THE STRUCTURE AND THE DECK BAND IF ATTACHED TO A BRICK STRUCTURE, NEITHER FLASHING NOR A TREATED BAND FOR THE BRICK STRUCTURE IS REQUIRED. IN ADDITION, THE TREATED DECK BAND SHALL BE CONSTRUCTED IN CONTACT
- WHEN THE DECK IS SUPPORTED AT THE STRUCTURE BY ATTACHING THE DECK TO THE STRUCTURE, THE FOLLOWING ATTACHMENT SCHEDULES SHALL APPLY FOR ATTACHING THE

### A. ALL STRUCTURES EXCEPT BRICK STRUCTURES

	JOIST LENGTH		
	UP TO 8' MAX. UP TO 16' MAX		
REQUIRED FASTENERS	ONE- 5/8" Ø BOLT @ 42" O.C. AND (2) ROWS OF 12d NAILS @ 8" O.C. OR TWO ROWS OF SIMPSON SDWS22400DB @ d = 32" O.C. STAGGERED	ONE- 5/8" Ø BOLT @ 20" O.C. AND (3) ROWS OF 12d NAILS @ 6" O.C. OR TWO ROWS OF SIMPSON SDWS22400DB @ d = 16" O.C. STAGGERED	

A . BRICK VENEER STRUCTURES

	JOIST LENGTH	
	UP TO 8' MAX.	UP TO 16' MAX.
REQUIRED FASTENERS	ONE- 5/8" Ø BOLT @ 28" O.C.	ONE- 5/8" Ø BOLT @ 16" O.C.

- 5. IF THE DECK BAND IS SUPPORTED BY A 1/2" MINIMUM MASONRY LEDGE ALONG THE FOUNDATION WALL, 5/8" Ø BOLTS SPACED @ 48" O.C. MAY BE USED FOR SUPPORT.
- OTHER MEANS OF SUPPORT, SUCH AS JOIST HANGERS, MAY BE USED TO CONNECT DECK
- GIRDERS SHALL BEAR DIRECTLY ON POSTS OR BE BE CONNECTED TO THE SIDES OF POSTS WITH 2- 5/8" Ø BOLTS
- FLOOR DECKING SHALL BE NO. 2 GRADE TREATED SOUTHERN PINE OR EQUIVALENT. THE MINIMUM FLOOR DECKING THICKNESS SHALL BE AS FOLLOWS:

JOIST SPAN	DECKING
12" O.C. 16" O.C.	1" S4S 1" T&G
24" O.C. 32" O.C.	1 1/4" S4S 2" S4S

MAXIMUM HEIGHT OF DECK SUPPORT POSTS IS AS FOLLOWS:

POST SIZE	MAX POST HEIGHT
4X4	8'
6X6	20'
ENGINEERED	20' +

- NOTES: 1) THIS TABLE IS BASED ON NO. 2 TREATED SOUTHERN PINE POSTS. 2) THIS TABLE IS BASED ON A MAXIMUM TRIBUTARY AREA OF 128 SQ. FT. 3) POST HEIGHT IS FROM TOP OF FOOTING TO BOTTOM OF GIRDER.
- 10. DECKS SHALL BE BRACED TO PROVIDE LATERAL STABILITY BY ONE OF THE FOLLOWING
  - A. WHEN THE DECK FLOOR HEIGHT IS LESS THAN 4'-0" AND THE DECK IS ATTACHED TO THE STRUCTURE IN ACCORDANCE WITH SECTION 4, LATERAL BRACING IS NOT REQUIRED.
- B. 4X4 WOOD KNEE BRACES MAY BE PROVIDED ON EACH COLUMN IN BOTH DIRECTIONS. THE KNEE BRACES SHALL ATTACH TO EACH POST AT A POINT NOT LESS THAN 1/3 OF THE POST LENGTH FROM THE TOP OF THE POST, AND THE BRACES SHALL BE ANGLED BETWEEN 45° AND 60° FROM THE HORIZONTAL. KNEE BRACES SHALL BE ATTACHED AT THE ENDS TO THE GIRDER AND THE POST WITH ONE - 5/8" BOLT
- C. FOR FREE STANDING DECKS WITHOUT KNEE BRACES OR DIAGONAL BRACING, LATERAL STABILITY MAY BE PROVIDED BY EMBEDDING THE POSTS IN CONCRETE IN ACCORDANCE

POST SIZE	TRIBUT. AREA	POST HEIGHT	EMB. DEPTH	CONC. DIAM.
4X4	48 SQ. FT.	4'-0"	2'-6"	1'-0"
6X6	120 SQ. FT.	6'-0"	3'-6"	1'-8"

- D. 2X6 DIAGONAL VERTICAL CROSS BRACING SHALL BE PROVIDED IN TWO PERPENDICULAR DIRECTIONS FOR FREE STANDING DECKS OR PARALLEL TO THE STRUCTURE AT THE EXTERIOR COLUMN LINE FOR ATTACHED DECKS. THE BRACES SHALL BE ATTACHED TO THE POSTS WITH ONE - 5/8" Ø BOLT AT EACH END OF THE BRACE.
- NOTES: 1) ALL NAILS AND BOLTS ARE TO BE HOT DIPPED GALVANIZED.
  - 2) MINIMUM EDGE DISTANCE FOR BOLTS IS 2 1/2".
  - 3) NAILS MUST PENETRATE THE SUPPORTING STRUCTURE BAND A MINIMUM OF 1 1/2".

ADDENDUM REV # RI TRIPLE A RUCTURAL


> ENG: RJS/CR DATE: 6/9/2023

> > PLAN MINION

PROJECT NO. 23-28-011

SHEET NO. SD2

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STR. DETAIL PLAN
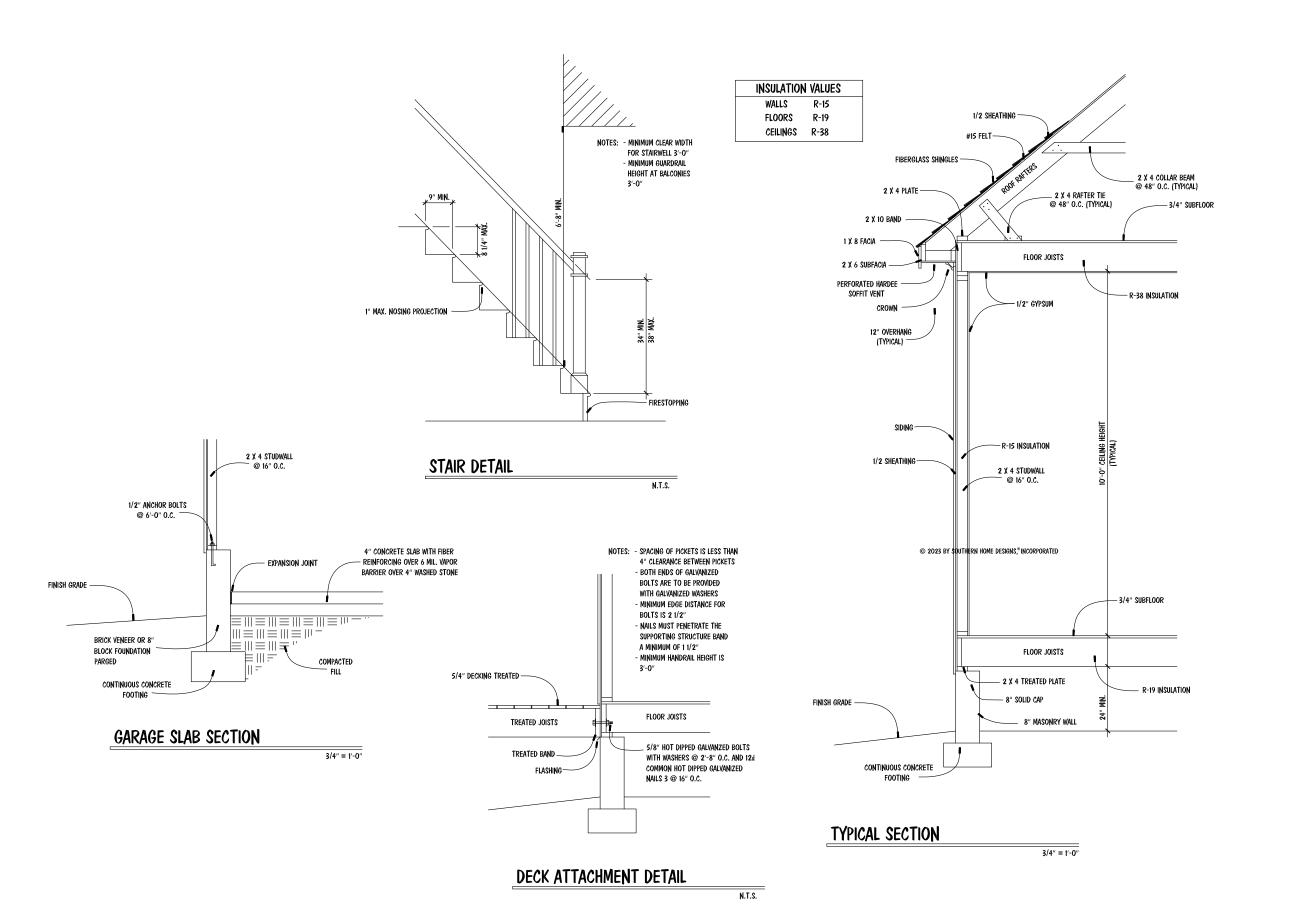
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Southern Home Designs

BNGGIRDGEANTHD

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THE MINION RESIDENCE LOT 120 SERENITY

TRIPLE A HOMES, INC.

ENGR. #: DATE: 03-30-23

SHEET: A-4 PLAN #: 23-033023