#### **REVISION LOG**

REVISION:001 DATE: 07/22/2022 Lot 11 369 Yates Mill Drive Fuquay Varina, NC 27526

- ADD STEM WALL SLAB FOUNDATION SHEETS
  ADD "STEM WALL" TO CRAWL ELEVATION TITLES AND NOTE "SEE FOUNDATION PAGES
  FOR FOUNDATION TYPE". UPDATE SHEET TITLES.

# WOODBRIDGE SOUTH SHOW ENC.



SQUARE	<u> </u>	<u>-001</u>	<u>A</u> (	<u>GE</u>		
	Γ	CRAFTSMA	/N' EL	EVATION		
		UNHEATED		HEATED		
FIRST FLOOR		0		1341		
SECOND FLOOR		0		1508		
FRONT PORCH		157		0		
REAR PATIO/DECK		188		0		
2 CAR GARAGE		469		0		
SUBTOTALS		814		2849		
TOTAL UNDER ROOF		3	663			
OI	PTI	ONS				
	UN	HEATED S.F	Ē. Н	EATED S.F		
POCKET OFFICE		+24	П	+132		
SMART DOOR		-30	П	+30		
SITTING ROOM		0		+152		
OPT. 3RD CAR GARAGE		+260		0		
COVERED PATIO/DECK	188 0					
EXTENDED COVERED PATIO/DECK		324		0		
	Ι.		1			

# PLAN 5 THE APEX - LH

## 'CRAFTSMAN'

heet No.	Sheet Description
0.0	Cover Sheet
1.1	Foundation (Slab)
1.1.1	Foundation Options (Slab)
1.1.2	Foundation Options (Slab) Foundation (Crawl)
1.2.1	Foundation Options (Crawl)
1.2.1	Foundation Options (Crawl)
1.3	Foundation (Stem Wall Slab)
1.3.1	Foundation Options (Stem Wall Slab)
1.3.1	Foundation Options (Stem Wall Slab)
2.1	First Floor Plan
2.1.1	First Floor Plan Options
2.2	Second Floor Plan
2.2.1	Second Floor Plan Options
2.4	Covered Porch Plans & Elevations (Slab)
2.4.1	Covered Porch Plans & Elevations (Crawl/Stem Wall)
2.5	Extended Cafe Elevations & Roof Plan (Slab)
2.5.1	Extended Cafe Elevations & Roof Plan (Crawl)
2.6	2-Car Sideload Garage Plans
2.6.1	2-Car Sideload Garage Elevations
2.7	3-Car Garage Plans
2.7.1	3-Car Garage Elevations
3.1	Front & Rear Elevations (Slab)
3.1.1	Front & Rear Elevations (Crawl/Stem Wall)
3.2	Side Elevations (Slab)
3.2.1	Side Elevations (Crawl/Stem Wall)
3.3	Roof Plan
5.1	First Floor Electrical
5.1.1	First Floor Options Electrical
5.2	Second Floor Electrical
5.2.1	Second Floor Options Electrical

## **DESIGN CRITERIA:**

THIS PLAN IS TO BE BUILT IN CONFORMANCE WITH THE 2018 NORTH CAROLINA STATE BUILDING CODE: RESIDENTIAL CODE

DIMENSIONS SHALL GOVERN OVER SCALE, AND CODE SHALL GOVERN OVER DIMENSIONS.



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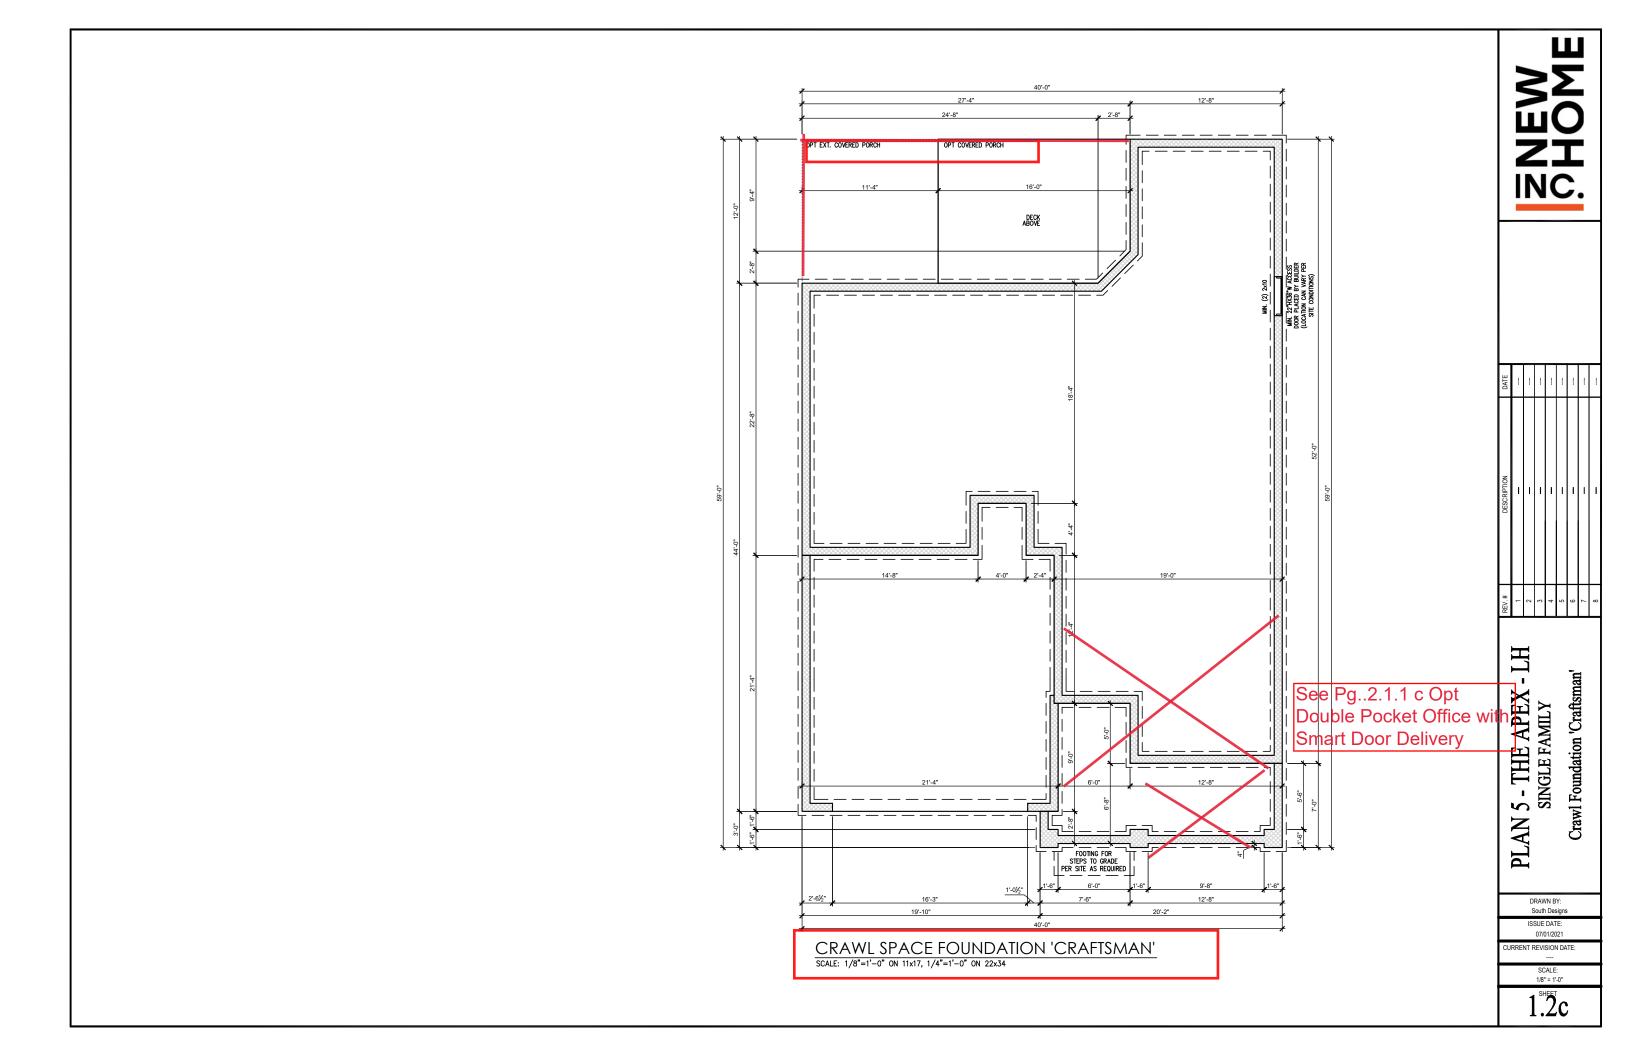
PLAN 5 - THE APEX Cover Sheet 'Craftsman'

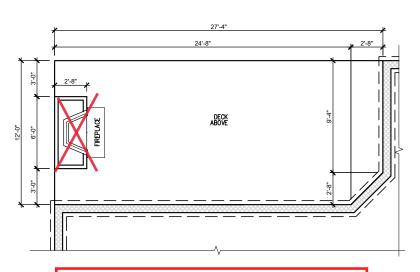
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ISSUE DATE: JRRENT REVISION DATE

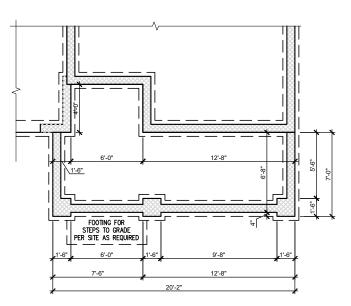
1/8" = 1'-0"

0.0c





CRAWL FND. W<del>/ OPT. FIREPLAC</del>E @ EXT. COVERED PATIO/PORCH SCALE: 1/8"=1'-0" ON 11x17, 1/4"=1'-0" ON 22x34



CRAWL FND. W/ SMART DELIVERY DR. W/ DBL POCK. OFFICE SCALE: 1/8"=1'-0" ON 11x17, 1/4"=1'-0" ON 22x34

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PLAN 5 - THE APEX - LH SINGLE FAMILY Crawl Foundation Options 'Craftsman'

DRAWN BY: South Designs

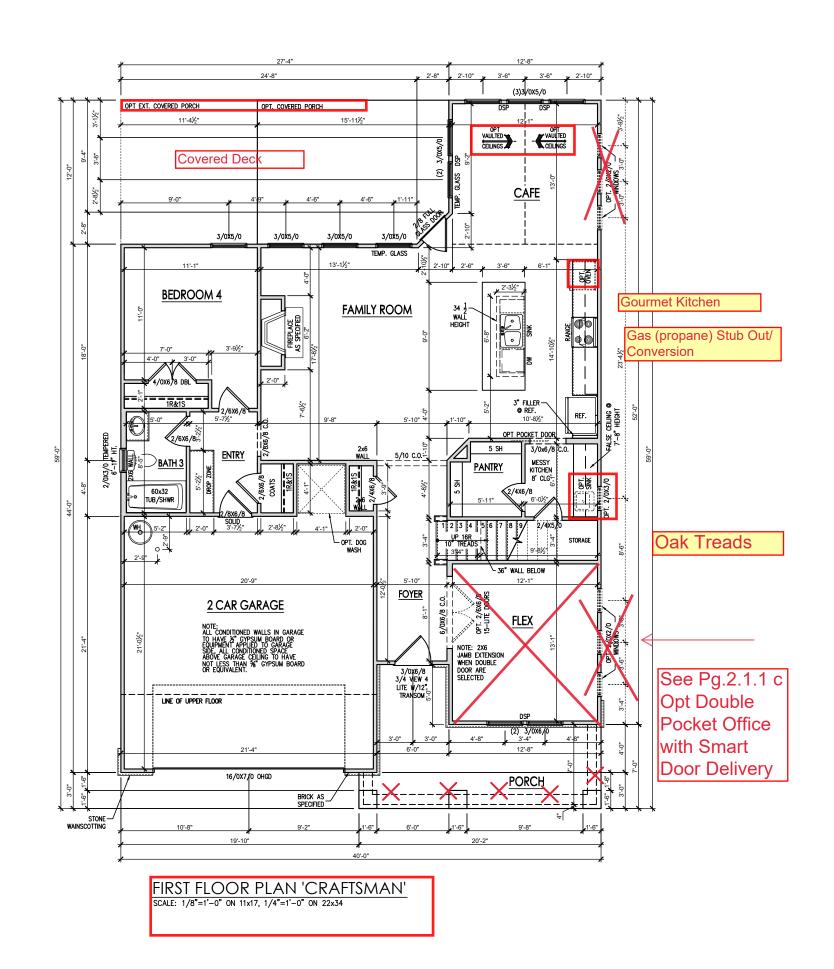
ISSUE DATE: 07/01/2021

CURRENT REVISION DATE:

SCALE: 1/8" = 1'-0" 1.2.1c

General Floor Plan Notes shall apply unless noted otherwise on plan.

- Wall Heights: Typically 9'-1 1/2" at first floor and second floor, and 9'-1 1/2" at attics U.N.O. All walls are constructed using a double top plate. Splices at Double Top Plate do not need to occur at Vertical Studs but must be at least 24" apart from Joint in other Top Plate layer. Special wall heights are noted on plans where they occur.
- Wall Thickness is typically 3 1/2". 2x6 frame shall be used at walls that back up to plumbling fixtures.
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- Jacks: Openings up to 3'-4" wide shall have (1) 2x4 jack stud SPF on each side. Openings greater than 3'-4" wide shall have (2) 2x4 jack studs SPF on each
- 5. Soffits, Coffered Ceilings, Trey Ceilings and other significant ceiling plan elements are shown on the floor plans and are denoted as single dashed lines. Unless specifically call out as included, Kitchens do not include soffits over wall cabinetry.
- Door & Window Frames, where occurring near corners, shall be a minimum of 4 1/2" from corner. Except for walk-in closets with doors near a corner, doors at closets shall be centered on closet.
- Windows: Shall have at least (1) window in each sleeping room, that meets egress. Shall be provided with tempered glass at hazardous glazing areas. False windows shall be installed with obscure glazing.
- Closets for clothing or coat storage shall be equipped with 1 rod/shelf. Closets for linen shall have 4 open equal shelves. Closets for pantries shall have 4 equal wood shelves, painted.
- Stair treads shall be a min of 9" deep, risers shall be a maximum of 8 1/4", unless noted otherwise, per the current North Carolina Residential Code
- 10. Handrails and Guards at stairs shall be 34" above the finished surface of the ramp surface of the stair. Handrails at landings and overlooks of multilevel spaces shall be 36" above finished floor. Guards (pickets or balusters) shall be spaced with no more than 4" between guards.
- 11. Affic Access shall be provided at all affic area with a height greater than 30°. Minimum clear affic access shall be 20° x 30°. Pull down stairs and access doors in knee walls meeting minimum criteria are also acceptable.
- 12.Garage Door to Living Space shall be 2'-8" x 6'-8" minimum size and shall be 20 minute fire rated and weather sealed.
- 13. Garage Walls, as a minimum, shall be separated from living space by installing 1/2" gypsum board on the garage side of the wall. With habitable space above, the inside of all garage walls require 1/2" GWB supporting 5/8" type X GWB on ceiling.





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PLAN 5 - THE APEX - SINGLE FAMILY
First Floor Plan 'Craftsman'

DRAWN BY: South Designs

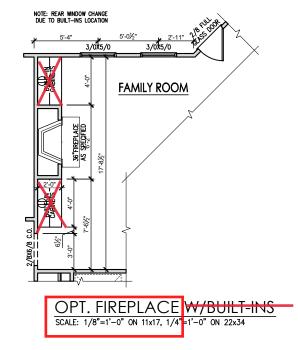
ISSUE DATE: 07/01/2021

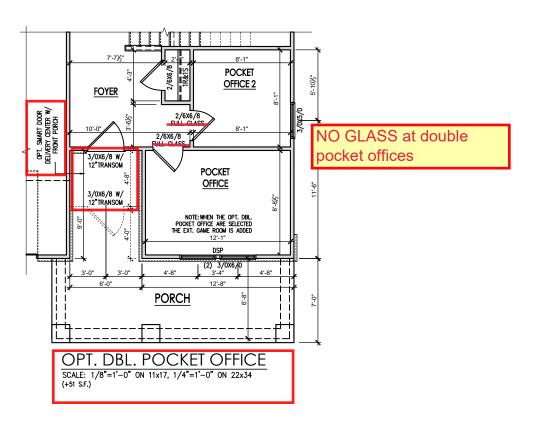
CURRENT REVISION DATE:

1/8" = 1'-0"
2.1c

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DESCRIPTION	_	I	_	-	-	-	-	-	
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PLAN 5 - THE APEX - LH SINGLE FAMILY

First Floor Plan Options 'Craftsman'

DRAWN BY:
South Designs

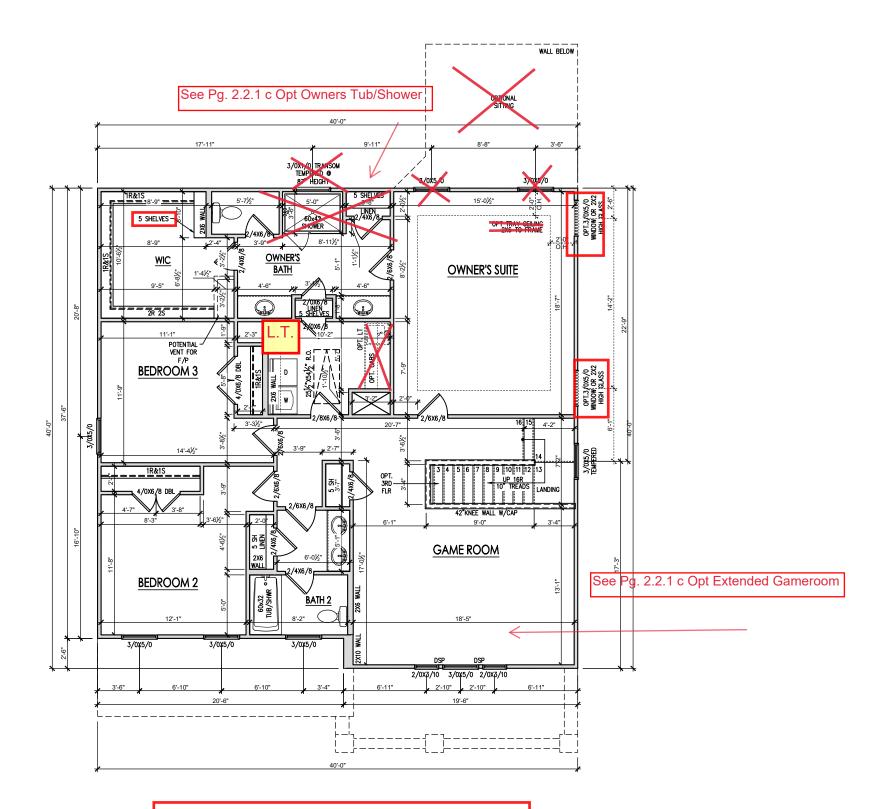
ISSUE DATE: 07/01/2021 CURRENT REVISION DATE:

> SCALE: 1/8" = 1'-0"

2.1.1c

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SECOND FLOOR PLAN 'CRAFTSMAN'
SCALE: 1/8"=1'-0" ON 11x17, 1/4"=1'-0" ON 22x34

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PLAN 5 - THE APEX - I SINGLE FAMILY Second Floor Plan 'Craftsman'

> DRAWN BY: South Designs ISSUE DATE:

ISSUE DATE: 07/01/2021 CURRENT REVISION DATE:

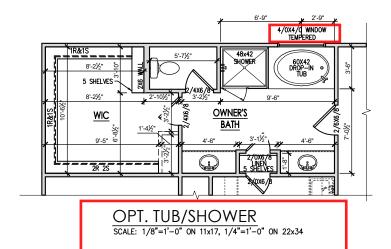
> SCALE: 1/8" = 1'-0"

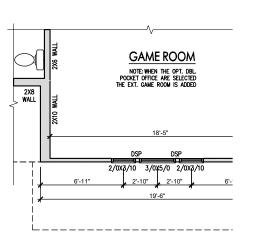
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General Floor Plan Notes shall apply unless noted otherwise on plan.

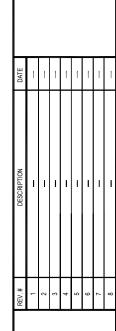
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OPT. EXT. GAME ROOM
SCALE: 1/8"=1'-0" ON 11x17, 1/4"=1'-0" ON 22x34



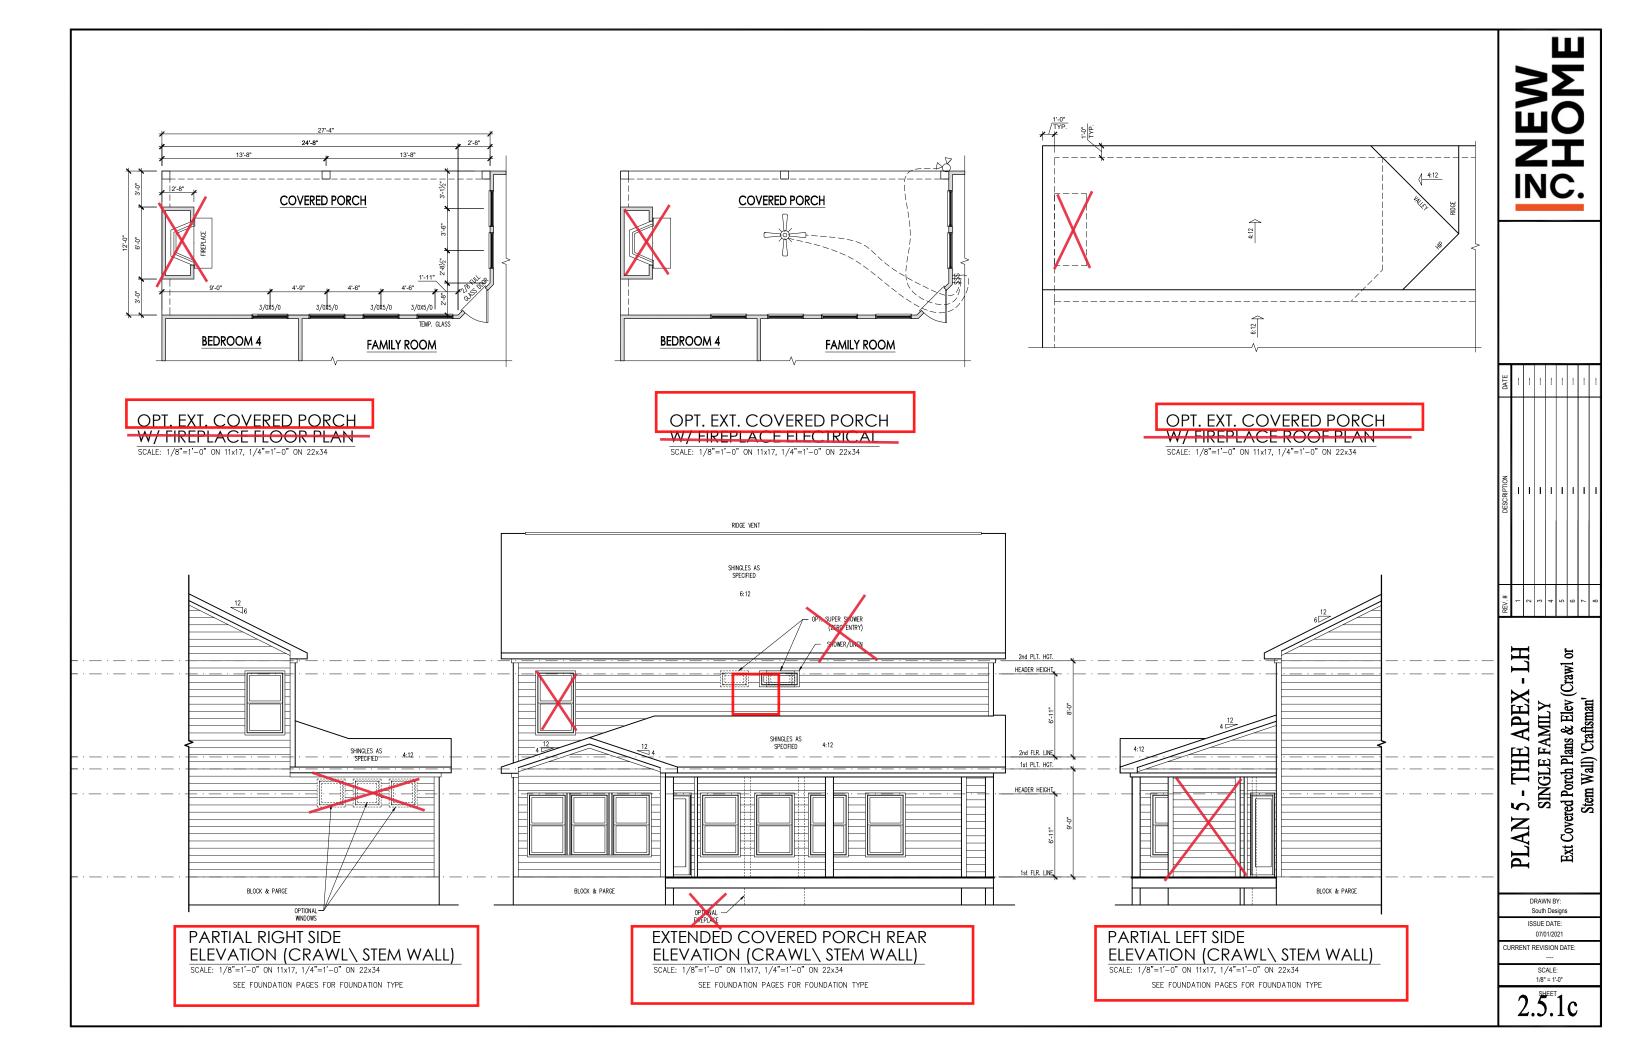
PLAN 5 - THE APEX - LH SINGLE FAMILY Second Floor Plan Options 'Craftsman'

> DRAWN BY: South Designs

ISSUE DATE: 07/01/2021

CURRENT REVISION DATE:
---SCALE:
1/8" = 1'-0"

2.2.1c



#### **General Elevation Notes**

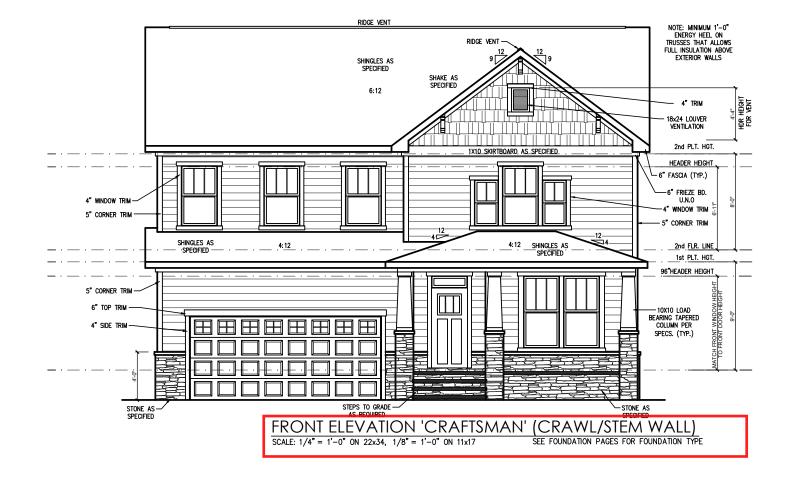
General Elevation Notes shall apply unless noted otherwise on plan.

- Roof shall be finished with architectural composition shingles with slopes as noted on plan.
- Ridge Vent shall be provided and installed on all ridges greater than 6' in length per manufacturer's specifications.
- 3. Soffit Vent shall be continuous soffit vent
- House Wrap, "tyvek" or approved equal shall be installed over entire exterior wall per manufacturer's specifications and recommendations.
- Flashing shall be provided above all door and window openings, above finish wall material changes and at wall surfaces where lower roof areas abut vertical wall surfaces.
- Porch Railings shall be provided at all porch walking surfaces greater than 30" above adjacent finished grade. It shall be 33" high with guards spaced no more than 4" apart. Consult community specifications for material.
- Finish Wall Material shall be as noted on elevation drawings.
- 8. Brick Veneer, if included on elevation shall be fied to wall surface with galvanized corrugated metal fies at a rate of 24" oc horizontally and 16" oc vertically so that no more than 2.67sf of brick is supported by (1) fie. Space between face of wall and back face of brick shall be limited to a maximum of 1". Flashing shall be provided behind brick above all wall openings and at base of brick wall. Flashing shall be a minimum of 6-mil poly or other corrosion resistant material and shall be installed so that it laps under the house wrap material a minimum of 2". Weepholes shall be provided at a rate of 48" oc and shall not be less than 3/16" in diameter and shall be located immediately above flashing.
- Brick Veneer Support Lintels shall be provided if brick veneer is included on elevation. Lintels shall be provided as listed in the following schedule and shall have a minimum bearing length of 6". Masonry Lintels shall be provided so that deflection is limited to L/600.

Masonry Opening Lintel Schedule

Opening Size Angle

3-1/2" x 3-1/2" x 5/16
4" x 3-1/2" x 5/16" LLV
5" x 3-1/2" x 5/16" LLV
6" x 3-1/2" x 5/16" LLV
7" x 4" x 3/8" LLV



NEW SHOME

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DESCRIPTION	_	-	_	-		-	-	-
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PLAN 5 - THE APEX - LH
SINGLE FAMILY
Front & Rear Elevations (Crawl or Stem
Wall) 'Craftsman'

DRAWN BY: South Designs

ISSUE DATE: 07/01/2021

CURRENT REVISION DATE:
---SCALE:
1/8" = 1'-0"

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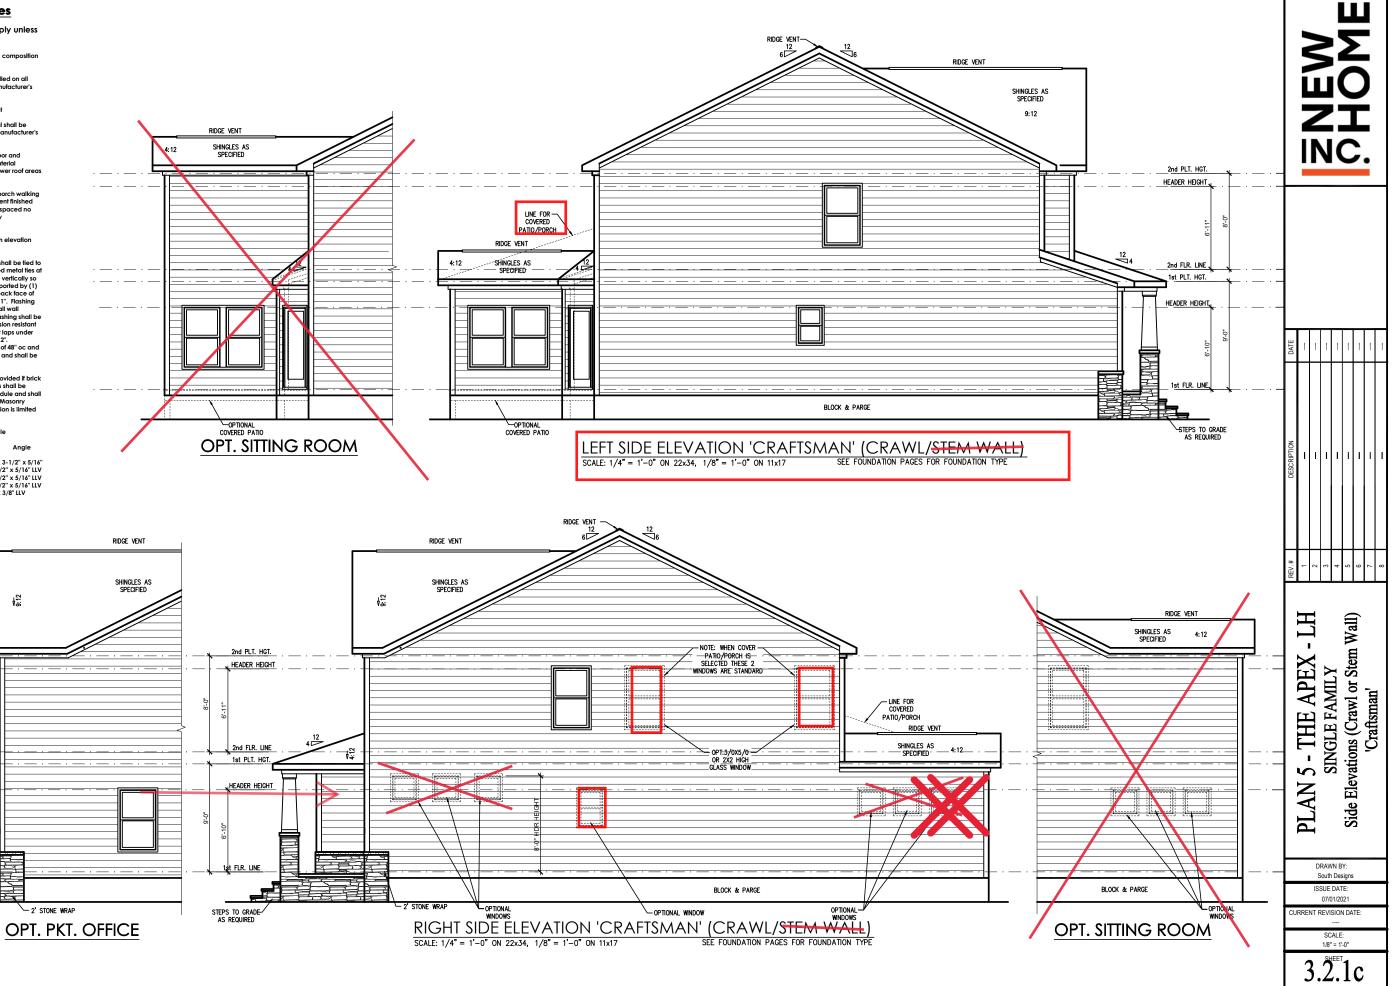
#### **General Elevation Notes**

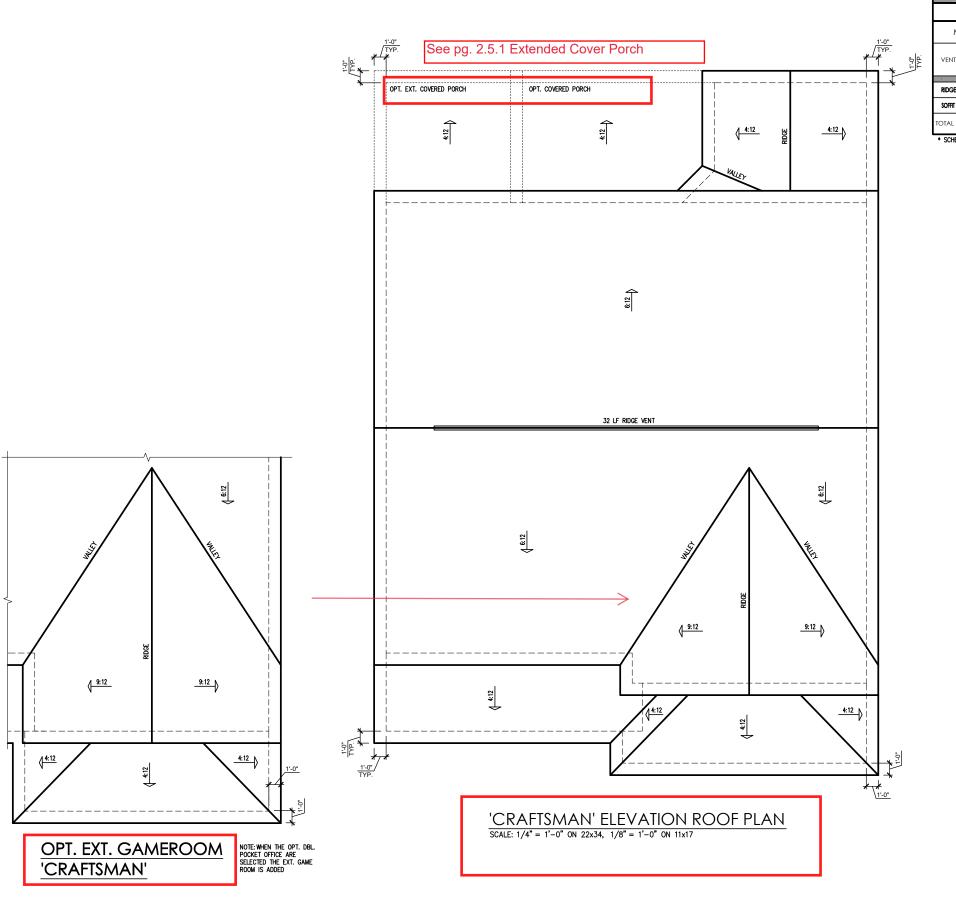
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- Ridge Vent shall be provided and installed on all ridges greater than 6' in length per manufacturer's specifications.
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- Finish Wall Material shall be as noted on elevation

STEPS TO GRADE AS REQUIRED

wall surface with galvan a rate of 24" oc horizont that no more than 2.67st tle. Space between fact brick shall be limited to a shall be provided behind openings and at base of a minimum of 6-mil poly material and shall be ins the house wrap material Weepholes shall be provided not be less than 3/1 located immediately ab 19. Brick Veneer Support Lin veneer is included on el provided as listed in the have a minimum bearing Lintels shall be provided to 1/400.	brick wall. Rashing shall be or other corrosion resistant talled so that if laps under a minimum of 2". rided at a rate of 48" oc and 15" in diameter and shall be over flashing.  tels shall be provided if brick evation. Lintels shall be following schedule and shall glength of 6". Masonry so that deflection is limited		OPTIONAL	4:12
Masonry Opening			COVERED PATIO	2014
Opening Size	Angle		OPT. SITTING RC	<u>JOM</u>
up to 4'-0" 4'-1" to 5'-6" 5'-7" to 6'-6" 6'-7" to 8'-4" 8'-5" to 16'-4"	3-1/2" x 3-1/2" x 5/16" 4" x 3-1/2" x 5/16" LLV 5" x 3-1/2" x 5/16" LLV 6" x 3-1/2" x 5/16" LLV 7" x 4" x 3/8" LLV			
		RIDGE VENT		RIDGE VENT
	₹ <u>2</u>	SHINGLES AS SPECIFIED	u 2nd PLT. HGT.	SHINGLES AS SPECIFIED
	_ · <del> </del>	<u> </u>	HEADER HEIGHT	
			I J DEAUER DEIGHT	





					TTIC '	VENT S	CHEDU	LE				
	'CRAFTSMAN' ELEVATION											
	main house		SQ FTG	1549	AT	AT / NEAR RIDGE			AR EAVE			
	VENT TYPE	SQ. REQL	. FT.	SQ. FT.	PERCENT OF TOTAL	POT LARGE (SQ. FT. EACH)	POT SMALL (SQ. FT. EACH)	RIDGE VENT (SQ. FT. PER LF)	EAVE VENT (SQ. IN. EACH)	CONT. VENT (SQ. IN. PER LF)		
		RAN		SUPPLIED	SUPPLIED	0.4236	0.2778	0.125	0.1944	0.0625		
	RIDGE VENT	2.07	2.58	4.00	44.44	0	0	32.00				
	SOFFIT VENTS	3.10	2.58	5.00	55.56				0	80.00		
	TOTAL (MIN)	5.16	5.16	9.00	100.00	POT VENTS MAY BE REQUIRED IF THERE IS INSUFFICIENT RIDGE AVAILABLE						
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\* SCHEDULE HAS BEEN CALCULATED ASSUMING EAVE VENTILATION AT 50-60% OF TOTAL AND RIDGE AT 40-50% OF TOTAL REQUIRED VENTILATION

MUC.

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DESCRIPTION	I	1	-	-		-	1	-	
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PLAN 5 - THE APEX - LH SINGLE FAMILY Roof Plan 'Craftsman'

> DRAWN BY: South Designs

ISSUE DATE: 07/01/2021

CURRENT REVISION DATE:
--SCALE:
1/8" = 1'-0"

3.3c

#### TRUSS SYSTEM REQUIREMENTS

NC (2018 NCRC): Wind: 115-120 mph

- TRUSS SYSTEM LAYOUTS (PLACEMENT PLANS) SHALL BE DESIGNED IN ACCORDANCE WITH SEALED STRUCTURAL PLANS, ANY NEED TO CHANGE TRUSSES SHALL BE COORDINATED WITH SOUTHERN ENGINEERS.
- TRUSS SCHEMATICS (PROFILES) SHALL BE PREPARED AND SEALED BY TRUSS MANUFACTURER.
- ALL TRUSSES SHALL BE DESIGNED FOR BEARING ON SPF #2 OR #3 PLATES OR LEDGERS (UNO).
- ALL REQUIRED ANCHORS FOR TRUSSES DUE TO UPLIFT OR BEARING SHALL MEET THE REQUIREMENTS AS SPECIFIED ON THE TRUSS SCHEMATICS.

#### WOOD I-JOISTS

(SHALL BE ONE OF THE FOLLOWING OR EQUAL):

- TJI 210 BY TRUS JOIST
- LPI 20 PLUS BY LPBCI 5000s I.8 BY BC

#### HEAVY WOOD I-JOISTS

(SHALL BE ONE OF THE FOLLOWING OR EQUAL):

• TJI 360 BY TRUS JOIST

- LPI 42 PLUS BY LP
- BCI 60s 2.0 BY BC
- ALL WOOD I-JOISTS SHALL BE INSTALLED ACCORDING TO MANUFACTURER'S SPECIFICATIONS.
- INSTALL SQUASH BLOCKS, WEB STIFFENERS, ETC. AS REQUIRED BY AND ACCORDING TO THE I-JOIST MANUFACTURER'S SPECIFICATIONS AND INSTRUCTIONS
- HANGERS FOR I-JOISTS ARE THE RESPONSIBILITY OF THE I-JOIST SUPPLIER.
- FLOOR TRUSSES BY MANUFACTURER MAY BE SUBSTITUTED FOR ANY I-JOISTS.

#### FOUNDATION STRUCTURAL NOTES NC (2018 NCRC): Wind: 115-120 mph - CRAWL

(I.) (3)2xIO SYP#2 OR SPF#2 GIRDER, TYPICAL UNO.

CONCRETE BLOCK PIER SIZE SHALL BE:

② •• •• <u>SIZE</u> 8x16 HOLLOW UP TO 32" <u>SOLID</u> UP TO 5'-0" UP TO 48" UP TO 9'-0" 16x16 UP TO 64" UP TO 12'-0" 24x24

WITH 30" x 30" x 10" CONCRETE FOOTING, UNO.

3 WALL FOOTING AS FOLLOWS

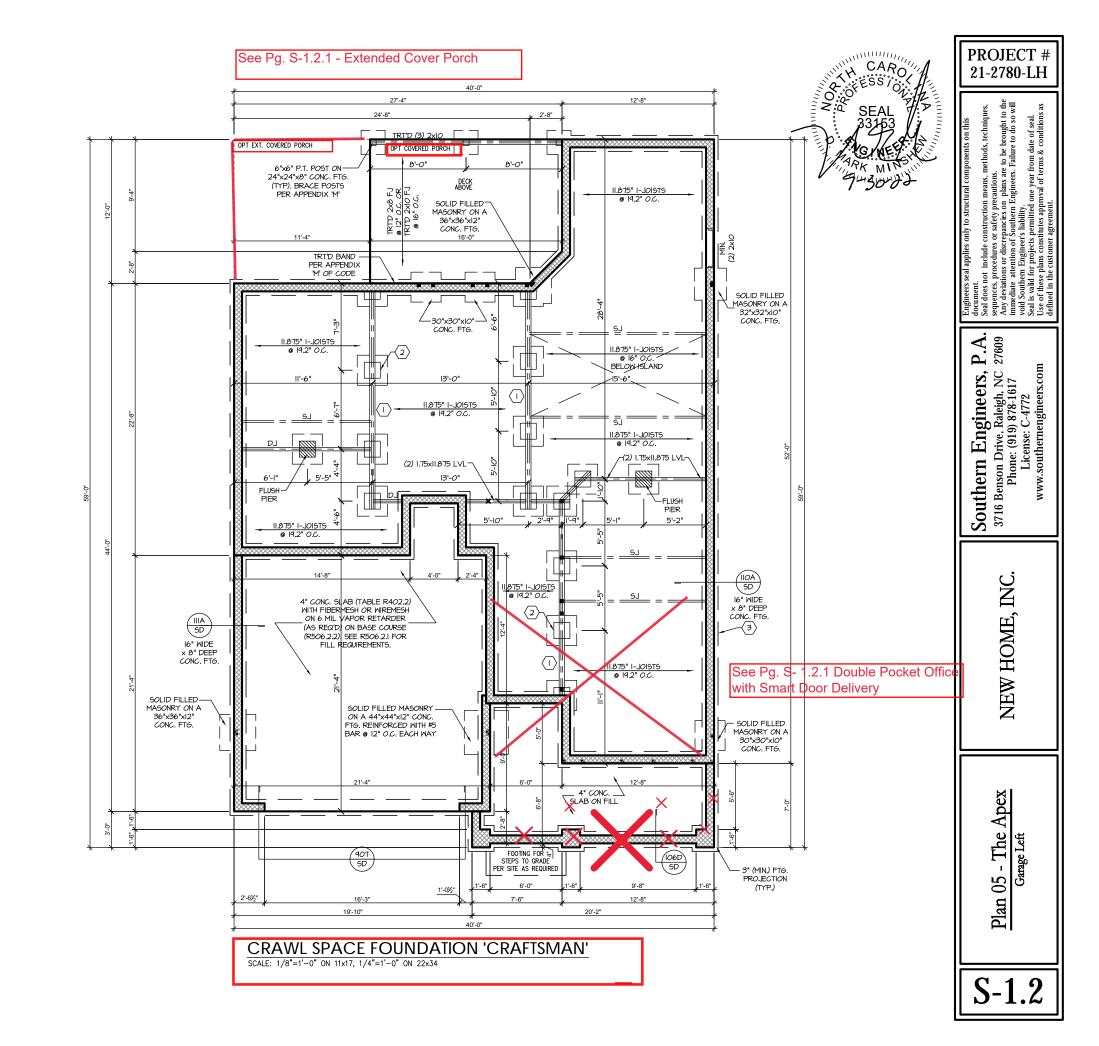
8" - UP TO 2 STORY DEPTH:

MIDTH: 16" - UP TO 2 STORY SIDING:

20" - 3 STORY 16" - 1 STORY BRICK:

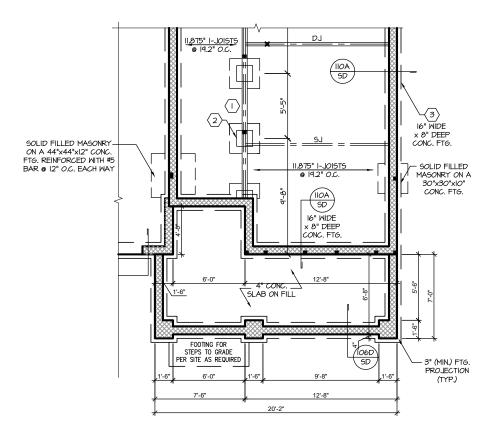
20" - 2 STORY 24" - 3 STORY

- FOR FOUNDATION WALL HEIGHT AND BACKFILL REQUIREMENTS, REFER TO CODE TABLE R40411 (I THRU 4) NOTE: ASSUMED SOIL BEARING CAPACITY = 2000 PSF. CONTRACTOR MUST VERIFY SITE CONDITIONS AND CONTACT SOILS ENGINEER IF MARGINAL OR UNSTABLE SOILS ARE ENCOUNTERED.
- 4 (4) 2xIO SPF #2 OR SYP #2 GIRDER
- (5) (2) 1.75x9.25 LVL OR LSL GIRDER
- 6 (3) 1.75×9.25 LVL OR LSL GIRDER
- "" DESIGNATES A SIGNIFICANT POINT LOAD TO HAVE SOLID BLOCKING TO PIER. SOLID BLOCK ALL BEAM BEARING POINTS NOTED TO HAVE THREE OR MORE STUDS TO FND, TYPICAL.
- ABBREVIATIONS:
- "SJ" = SINGLE JOIST
- "DJ" = DOUBLE JOIST
- "TJ" = TRIPLE JOIST
- ADJUST SUBFLOOR THICKNESS OR JOIST SPACING AS REQ'D FOR FLOOR FINISH MATERIALS.



CRAWL FND. W/ OPT. FIREPLACE

@ EXT. COVERED PATIO/PORCH
SCALE: 1/8"=1'-0" ON 11x17, 1/4"=1'-0" ON 22x34



CRAWL FND. W/ SMART DELIVERY DR. W/ DBL POCK. OFFICE SCALE: 1/8"=1'-0" ON 11x17, 1/4"=1'-0" ON 22x34

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S-1.2.

#### HEADER/BEAM & COLUMN NOTES

- ALL EXTERIOR AND LOAD BEARING HEADERS SHALL BE MIN. (2)2x6 (4" WALL) OR (3)2x6 (6" WALL) WITH (I) SUPPORT STUD, UNLESS NOTED OTHERWISE
- 2. THE NUMBER SHOWN AT BEAM AND HEADER SUPPORTS INDICATES THE NUMBER OF SUPPORT STUDS REQUIRED IN STUD POCKET OR COLUMN. THE NUMBER OF KING STUDS AT EACH END OF HEADERS IN EXTERIOR WALLS SHALL BE ACCORDING TO ITEM "d" IN TABLE R602.3(5) OR AS BELOW PER NCDOI COMMENTARY "KING STUDS AT WALL OPENINGS" REVISED 1-9-2020:
- UP TO 3' SPAN: (I) KING STUD
- OVER 3' UP TO 6' SPAN: (2) KING STUDS OVER 6' UP TO 9' SPAN: (3) KING STUDS
- OVER 9' UP TO 12' SPAN: (4) KING STUDS
- OVER 12' UP TO 15' SPAN: (5) KING STUDS

### TRUSS SYSTEM REQUIREMENTS

NC (2018 NCRC): Wind: 115-120 mph

- TRUSS SYSTEM LAYOUTS (PLACEMENT PLANS) SHALL BE DESIGNED IN ACCORDANCE WITH SEALED STRUCTURAL PLANS, ANY NEED TO CHANGE TRUSSES SHALL BE COORDINATED WITH SOUTHERN ENGINEERS
- TRUSS SCHEMATICS (PROFILES) SHALL BE PREPARED AND SEALED BY TRUSS MANUFACTURER.
- ALL TRUSSES SHALL BE DESIGNED FOR BEARING ON SPF #2 OR #3 PLATES OR LEDGERS (UNO).
- ALL REQUIRED ANCHORS FOR TRUSSES DUE TO UPLIFT OR BEARING SHALL MEET THE REQUIREMENTS AS SPECIFIED ON THE TRUSS SCHEMATICS.

**MOOD I-JOISTS** 

LPI 20 PLUS BY LP

BCI 5000s I.8 BY BC

TJI 360 BY TRUS JOIST

BCI 60s 2.0 BY BC

HEAVY WOOD I-JOISTS (SHALL BE ONE OF THE FOLLOWING OR EQUAL):

- PORCH POST NOTES:

   4"x4" (6"x6") TRT'D POST (OR EQUAL).
- ATTACH TRUSSES (RAFTERS) AT PORCH WITH HURRICANE CONNECTORS.
- POST CAP: SIMPSON AC4-MAX (AC6-MAX)
  POST CAP AT CORNER: (2) SIMPSON LCE4 (MITER
  HEADER AT CORNER). HIGH WIND; ADD (I) SIMPSON H6.
- 3. POST BASE: SIMPSON ABU44 (ABU66).
- MONO: 5/6" ANCHOR (EMBED 7")
- CMU: %" ANCHOR (EXTEND TO FOOTING HIGH WIND
- POST BASE: WOOD FOUNDATION: (2) SIMPSON CSI6 STRAPS AT POSTS. EXTEND 12" ONTO EACH POST (UPPER AND LOWER) OR TO GIRDER.
- NOTE: EQUIVALENT POST CAP AND BASE ACCEPTABLE.

(SHALL BE ONE OF THE FOLLOWING OR EQUAL):

• TJI 210 BY TRUS JOIST

ALL WOOD I-JOISTS SHALL BE INSTALLED

ACCORDING TO MANUFACTURER'S SPECIFICATIONS.

INSTALL SQUASH BLOCKS, WEB STIFFENERS, ETC. AS

HANGERS FOR I-JOISTS ARE THE RESPONSIBILITY OF THE I-JOIST SUPPLIER.

MANUFACTURER'S SPECIFICATIONS AND INSTRUCTIONS.

REQUIRED BY AND ACCORDING TO THE I-JOIST

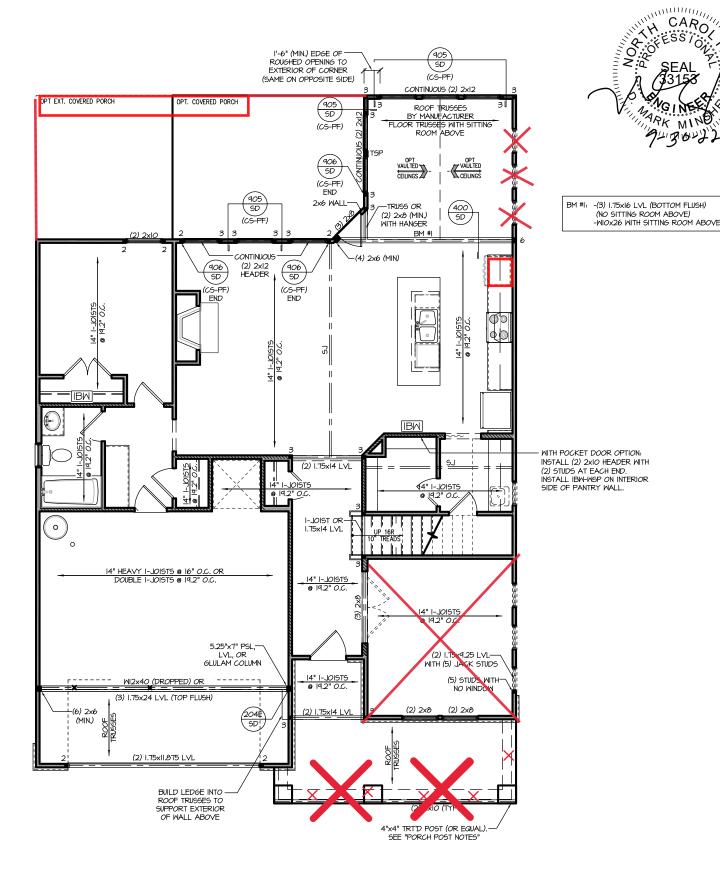
FLOOR TRUSSES BY MANUFACTURER MAY BE

SUBSTITUTED FOR ANY I-JOISTS.

#### FRAMING NOTES

NC (2018 NCRC): Wind: 115-120 mph

- BRACING METHOD AND TYPE: CONTINUOUSLY SHEATHED WSP: CS-WSP. NOTE THAT THE WALL BRACING AMOUNT PROVIDED ON THE PLANS (DETAILS AND SPECIFICATIONS) IS GREATER THAN THE AMOUNT OF WALL BRACING REQUIRED BY SECTION R602.10 OF THE CODE, SEE NOTES BELOW FOR DETAILS AND SPECIFICATIONS FOR WALL BRACING AND
- EXTERIOR WALL SHEATHING: WALLS SHALL BE BRACED BY SHEATHING
  WALLS ON ALL STORIES WITH WOOD STRUCTURAL PANEL SHEATHING (MSP) (EXPOSURE B: 7/16". EXPOSURE C: 15/32"). SHEATHING SHALL BE ATTACHED WITH 8d NAILS AT A 6"/12" NAILING PATTERN (6" OC AT PANEL EDGES AND 12" OC AT INTERMEDIATE SUPPORTS). INSTALL BLOCKING AT ALL PANEL EDGES.
- WSP SHEATHING SHALL EXTEND TO THE UPPERMOST DOUBLE BEARING PLATE. BLOCK AT ROOF PER SECTION R602.10.4.5 AND ATTACH BRACED WALLS PER CODE. WSP SHEATHING BETWEEN FLOORS SHALL BE SPLICED ALONG CONTINUOUS BAND OR THE WSP SHEATHING MAY BE SPLICED ACROSS STUDS (CONTINUOUS ACROSS FLOOR SYSTEM) WITH BLOCKING AT PANEL EDGES. (MINIMUM 12" BEYOND FLOOR BREAK) OR OTHER
- 4.  $\frac{"HD"}{BE}$  AN 800 POUND CAPACITY ASSEMBLY AS NOTED ON PLANS, SEE DETAILS FOR HD ASSEMBLY.
- \*\*GROUND/FIRST FLOOR: USE "HD HOLD-DOWN DETAIL" ON SD SHEET (OR FOULV)
- \*\*UPPER FLOORS: ATTACH BASE OF KING STUD WITH A SIMPSON C522 STRAP DOWN ACROSS THE BAND AND DOWN TO A STUD BELOW OR HEADER BELOW. EXTEND STRAP 7" MIN ALONG EACH STUD (OR HEADER) AND ATTACH EACH END W (7) 8d NAILS.
- INTERIOR BRACED WALL: (NOTED AS "IBM" ON PLANS) ATTACH 1/2" GYPSUM BOARD (GB) ON EACH SIDE OF WALL WITH A MIN. OF 5d COOLER NAILS OR #6 SCREWS @ 7" O.C. ALONG THE EDGES AND AT
- INTERIOR BRACED WALL-WOOD STRUCTURAL PANEL: (NOTED AS "<u>IBM-MSP</u>" ON PLANS). ATTACH ONE SIDE WITH "6" WSP SHEATHING WITH 8d NAILS AT A 6"/12" NAILING PATTERN (6" OC AT PANEL EDGES AND 12" OC AT INTERMEDIATE SUPPORTS). INSTALL BLOCKING AT ALL PANEL EDGES. ATTACH GB OVER MSP AS REQUIRED. ATTACH OPPOSITE SIDE WITH 1/2" GB WITH A MIN. OF 5d COOLER NAILS OR #6 SCREWS @ 7" OC ALONG THE EDGES AND AT INTERMEDIATE SUPPORTS.



FIRST FLOOR PLAN 'CRAFTSMAN' SCALE: 1/8"=1'-0" ON 11x17, 1/4"=1'-0" ON 22x34

Apex The 05 Plan

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PROJECT #

21-2780-LH

e to be brought to the Failure to do so will

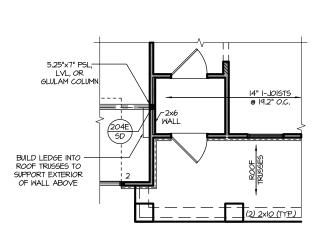
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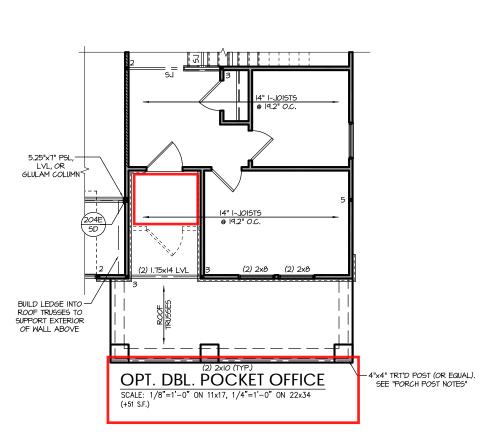
Engineers, Drive, Raleigh, NC e: (919) 878-1617

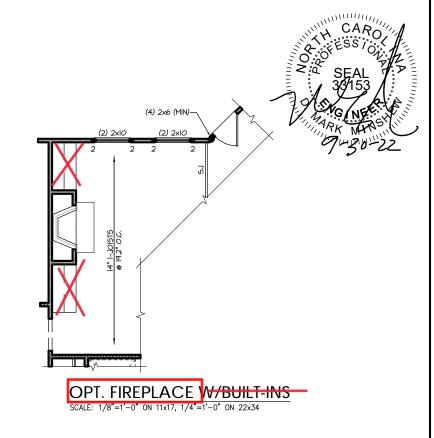
Southern Engi 3716 Benson Drive, Ra Phone: (919) 8

one year from date of seal. oval of terms & conditions



OPT. SMART DOOR DELIVERY CENTER W/ FRONT PORCH SCALE: 1/8"=1'-0" ON 11x17, 1/4"=1'-0" ON 22x34 (+28 S.F.)





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#### HEADER/BEAM & COLUMN NOTES

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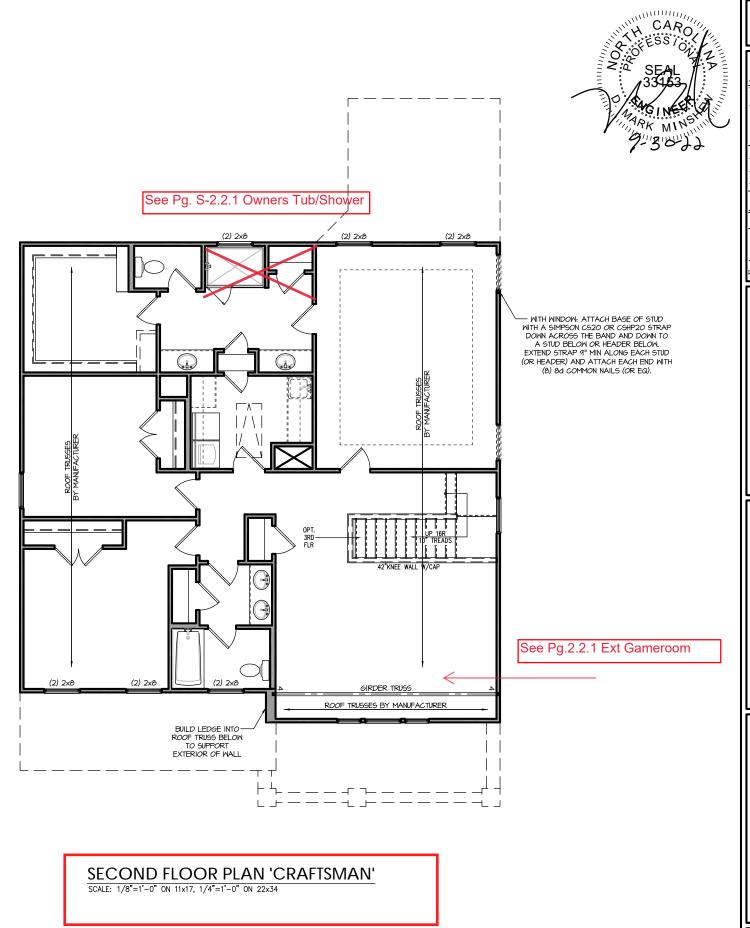
- PORCH POST NOTES:

   4"x4" (6"x6") TRT'D POST (OR EQUAL).
- ATTACH TRUSSES (RAFTERS) AT PORCH WITH HURRICANE CONNECTORS.
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  POST CAP AT CORNER: (2) SIMPSON LCE4 (MITER
  HEADER AT CORNER). HIGH WIND; ADD (I) SIMPSON H6.
- 3. POST BASE: SIMPSON ABU44 (ABU66).
- MONO: %" ANCHOR (EMBED 7")
- CMU: %" ANCHOR (EXTEND TO FOOTING HIGH WIND ONLY)
- POST BASE: WOOD FOUNDATION: (2) SIMPSON CSIG STRAPS AT POSTS. EXTEND 12" ONTO EACH POST (UPPER AND LOWER) OR TO GIRDER.
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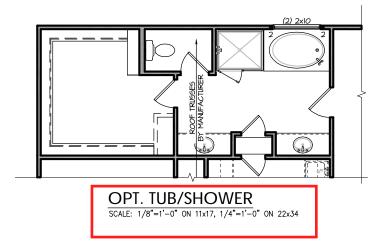
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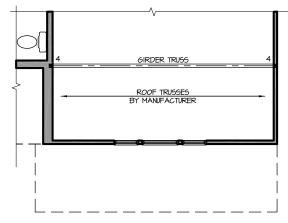
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> HOME, NEW

Apex The 05 Plan





(APPLIES ONLY WITH "OPT. DOUBLE POCKET OFFICE" BELOW)

OPT. EXT. GAME ROOM
SCALE: 1/8"=1'-0" ON 11x17, 1/4"=1'-0" ON 22x34

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6"x6" TRT'D POST (OR EQUAL).

SEE "PORCH POST NOTES"

(3) 2x12 SPF #2 OR (3) I,T5x4.25 LVL

3 3

(CS-PF)

SD

CONTINUOUS -(2) 2×12 HEADER

906 SD

906 SD (OS-PF) END SEAL SEAL ARK MICHAEL ARK MICH

4:12

OPT. EXT. COVERED PORCH
W/ FIREPLACE FLOOR PLAN
SCALE: 1/8"=1'-0" ON 11x17, 1/4"=1'-0" ON 22x34

OPT. EXT. COVERED PORCH
W/ FIREPLACE ROOF PLAN
SCALE: 1/8"=1'-0" ON 11x17, 1/4"=1'-0" ON 22x34

ROOF TRUSSES IY MANUFACTURER

PARTIAL RIGHT SIDE ELEVATION
SOLE 1/21-1-10 of 12.234

EXT. COVERED PORCH REAR ELEVATION
SOLE 1/21-10 of 11.71, 1/4-1-1-0 of 12.234

EXT. COVERED PORCH REAR ELEVATION
SOLE 1/21-10 of 11.71, 1/4-1-1-0 of 12.234

PROJECT # 21-2780-LH

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on plans are to be brought to the n Engineers. Failure to do so will 9. y. ed one year from date of seal.

date of the construction means, in sequences, procedures or safety precautions.

Any deviations or discrepancies on plans are immediate attention of Southern Engineers.

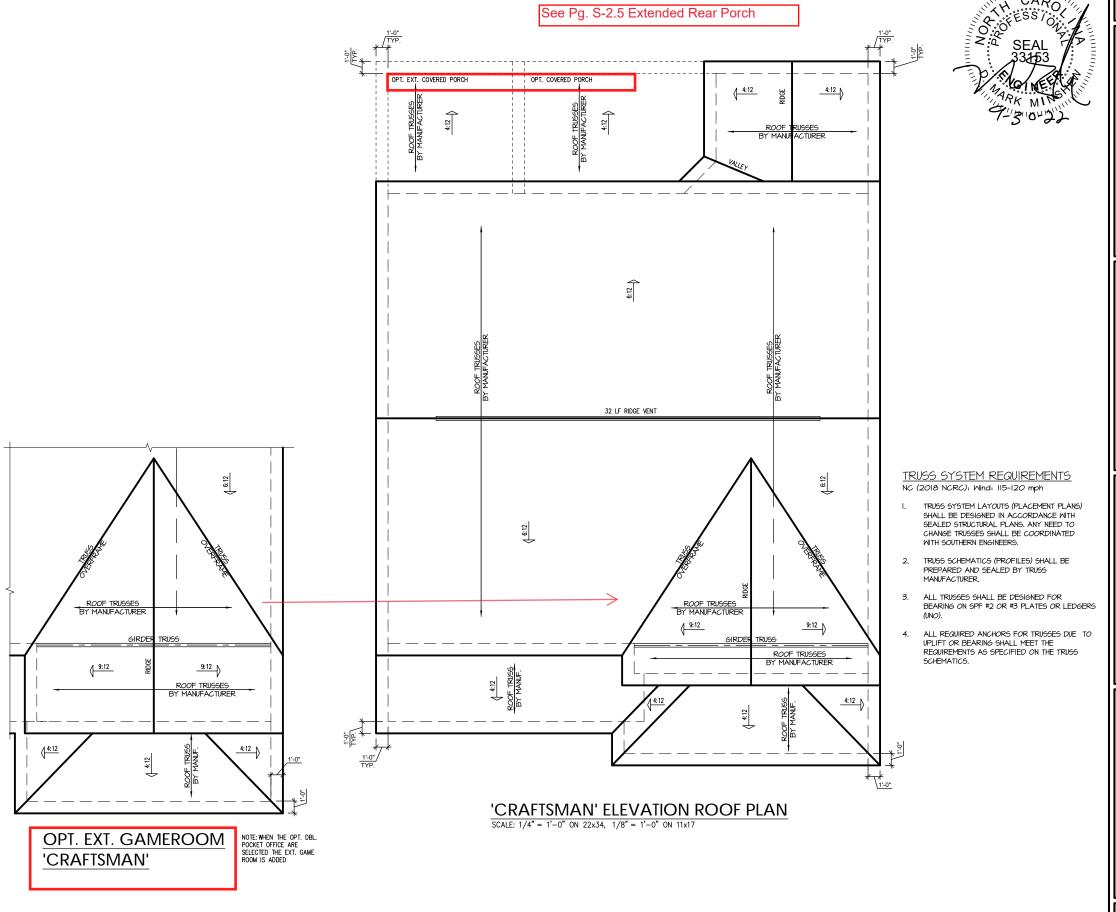
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S-2.5

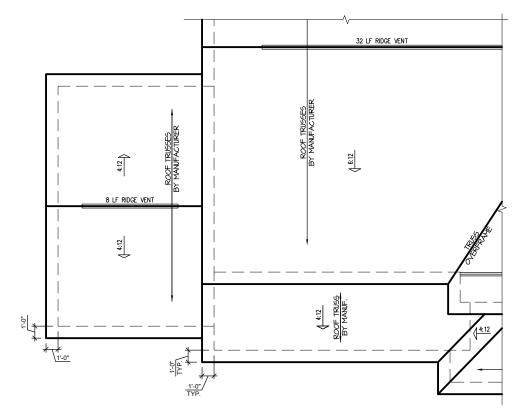


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OPT. 3-CAR GARAGE

'CRAFTSMAN' ROOF PLAN

SCALE: 1/4" = 1'-0" ON 22x34, 1/8" = 1'-0" ON 11x17

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