

□ No Comments See Comments Items drawn on any drawings and not written in the contract selctions <u>WILL NOT</u> be included in the site specific drawings.

I. Shown on plans. Note opening will have to slope with stair stringer.

2. XXX

3. XXX

4. XXX

Reason For Modification:

I. Please review

2. XXX

3. XXX

4. XXX

. XXX

2. XXX

3. XXX

4. XXX

Architecture Plan Review:


. Remove door at closet under stair at study

Customer Request:

2. XXX

3. XXX

4. XXX

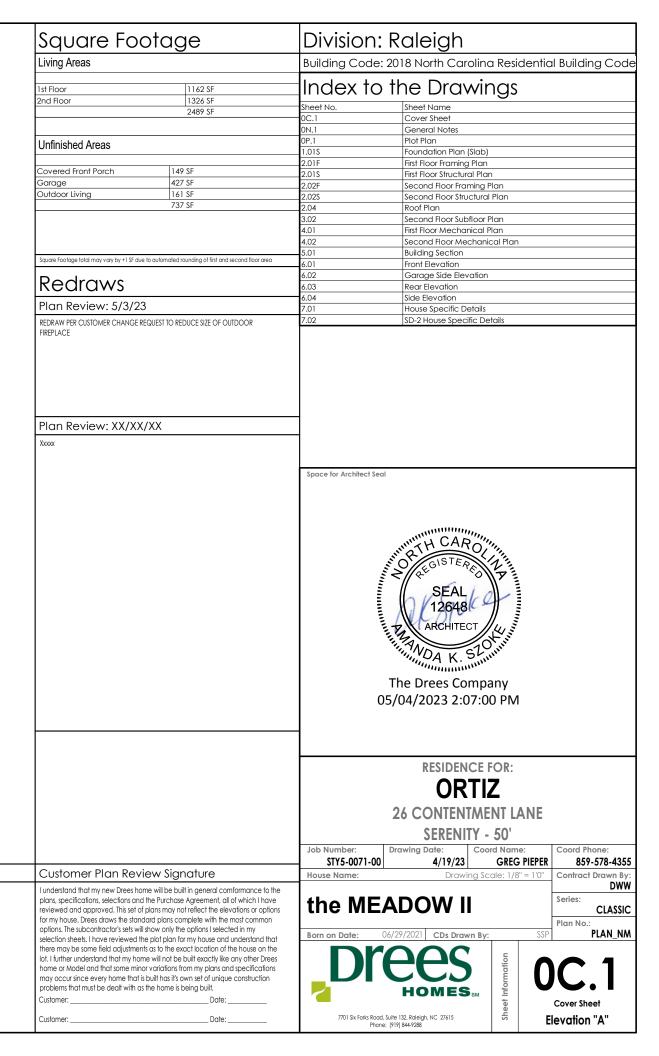

GENERAL NOTES - RALEIGH

FOUNDATION NOTES

CRAWL SPACES:

SLOPE CONCRETE SLAB 4" MINIMUM TOWARDS GARAGE DOOR

- EXTERIOR FLATWORK/GARAGES SHALL HAVE A MINIMUM CONCRETE SRENGTH OF 4,500 PSI

FOOTINGS TO A MINIMUM CONCRETE STRENGTH OF 2500 PSI, UNLESS OTHERWISE NOTED

ASSUMED ALLOWABLE SOIL BEARING PRESSURE: 2 000 p s f

WATERPROOF FOUNDATION WITH BITUMINOUS SPRAY.

WALL TIES EMBEDDED IN THE HORIZONTAL MORTAR JOINT SHALL BE 16" ON CENTER, TIES IN ALTERNATE COURSES SHALL BE STAGGERED. THE MAXIMUM VERTICAL DISTANCE BETWEEN TIES SHALL NOT EXCEED 16" AND THE MAXIMUM HORIZONTAL DISTANCE SHALL NOT EXCEED

16" ADDITIONAL TIES SHALL BE PROVIDED AT ALL OPENINGS, AND WITHIN 12" OF THE OPENING

CORE FILL ENTIRE BLOCK WALL WHEN THE WALL IS 4'-0" TALL OR HIGHER. INSTALL #4 REBAR IN EACH HOLLOW AREA OF EACH BLOCK FROM FOOTING TO TOP OF WALL, ON THE ENTIRE WALL PRIOR TO CORE FILLING IT.

TOP COURSE OF BLOCK ON ALL WALLS WILL BE FILLED SOLID WITH MORTAR PLACING THE FOUNDATION STRAPS OR BOLTS IN THE MORTAR 6'-0" ON CENTER, AND 12" FROM EACH CORNER

12"x16" PIERS: HOLLOW MASONRY UP TO 48" HIGH, SOLID MASONRY UP TO 9'0" HIGH

16"x16" PIERS: HOLLOW MASONRY UP TO 64" HIGH, SOLID MASONRY UP TO 12'0" HIGH

- BLOCK PIERS SHOULD BE PLACED DIRECTLY ON CONCRETE FOOTINGS PER PLAN. THEY SHOULD BE PLUMBED AND SQUARE WITHIN 1/4".

- SILL PLATES TO BE A MINIMUM OF 2x4 NOMINAL LUMBER.

BASEMENTS:

- SLOPE CONCRETE SLAB 4" MINIMUM TOWARDS GARAGE DOOR

- EXTERIOR FLATWORK/GARAGES SHALL HAVE A MINIMUM CONCRETE SRENGTH OF 4,500 PSI

- FOOTINGS TO A MINIMUM CONCRETE STRENGTH OF 2500 PSI, UNLESS OTHERWISE NOTED- ALL FOUNDATION WALLS TO BE CAST IN PLACE CONCRETE 3000 PSI MIN, UNLESS OTHERWISE

- BASEMENT WINDOW LOCATIONS MAY VARY FROM DRAWING DUE TO LOT CONDITIONS.

- BACKFILL ADJACENT TO FOUNDATION WALLS SHALL NOT BE PLACED UNTIL THE WALL HAS SUFFICIENT STRENGTH AND HAS BEEN ANCHORED TO THE FLOOR OR HAS BEEN SUFFICIENTLY BRACED TO PREVENT DAMAGE BY THE BACKFILL.

- ASSUMED ALLOWABLE SOIL BEARING PRESSURE: 2,000 p.s.f.

- WATERPROOF FOUNDATION WITH BITUMINOUS SPRAY.

- VERTICAL CONTROL JOINTS IN BASEMENT FOUNDATION WALLS - STANDARD LOCATION GUIDELINES:

1) PLACE A CONTROL JOINT IN ALL UNBRACED WALLS OVER 30' IN LENGTH. (NOTE: "T" WALLS AND CORNERS COUNT AS A BRACE).

2) WINDOWS THAT ARE LARGER THAN THE STANDARD BASEMENT WINDOW REQUIRE A CONTROL JOINT.

3) CONTROL JOINTS ARE NOT REQUIRED AT EVERY WINDOW THAT IS STANDARD SIZE

4) IF THERE IS A STANDARD WINDOW LOCATED IN A WALL SEGMENT THAT REQUIRES A CONTROL JOINT, THEN THE CONTROL JOINT SHOULD BE PLACED ON THE SIDE OF THE WINDOW that is adjacent to the long side of the wall. If there is more than one window in a wall then only one window should have a control joint.

5) DOORS DO NOT GET CONTROL JOINTS.

6) CONTROL JOINTS SHOULD NOT BE LOCATED WITHIN 3' OF A BEAM POCKET.

7) CONTROL JOINTS ARE REQUIRED AT THE FIRST AND LAST STEP DOWN AT STEPPED BASEMENT FOUNDATION WALLS.

- INTERIOR FLATWORK SHALL HAVE A MINIMUM CONCRETE STRENGTH OF 3,000 PSI.

- ALL VERTICAL STEEL AND ALL STEEL IN STRUCTURAL SLABS TO BE GRADE 60. ALL HORIZONTAL STEEL IN FOUNDATION WALLS AND FOOTERS TO BE GRADE 40 STEEL

R-15

FRAMING NOTES

DESIGN LOADS:

FLOORS: 40 psf LIVE LOAD + 10 psf DEAD LOAD = 50 psf ROOF:

18 psf LIVE LOAD + 17psf DEAD LOAD = 35 psf DESIGN DEFLECTION LIMITS (BASED ON LIVE LOAD, EXCEPT MASONRY):

> RAFTERS GREATER THAN 3:12 L/180 MASONRY VENEER L/600

NOMINAL LUMBER FLOORS: L/360

MANUFACTURED WOOD FLOORS: DESIGNED TO MINIMUM PRO RATING OF 35 (OR EQUIVALENT). NO MORE THAN 8 POINT DIFFERENCE BETWEEN ADJACENT SPANS.

L/480 FOR SPANS UP TO 16'-0" AND NO GREATER THAN 1/2" DEFLECTION

L/240

GARAGE FLOOR: 50 psf LIVE LOAD

WIND SPEED: 120 MPH

CEILINGS

L/600 FOR SPANS OVER 16'-0" IF SIMPLE SPAN AND NO GREATER THAN 1/2" DEFLECTION L/840 FOR SPANS OVER 16'-0" IF CONTINUOUS SPAN. AND NO GREATER THAN 1/2" DEFLECTION

SEISMIC: "A" & "B"

JOIST SPACING:

19.2" o.c. MAXIMUM SPACING

DOUBLE EVERY OTHER FLOOR JOIST UNDER KITCHEN ISLANDS

INSTALL UNCOUPLING MEMBRANE IN TILE FLOOR AREAS IF 19.2" o.c. FLOOR JOIST SPACING

GLUE AND MECHANICALLY FASTEN [SCREWS] WOOD FLOOR IF 19.2" o.c. FLOOR JOIST SPACING

MANUFACTURED WOOD PRODUCTS (INCLUDING, BUT NOT LIMITED TO, STRUCTURAL WOOD BEAMS AND I-JOISTS) SHALL BE FABRICATED. HANDLED, AND INSTALLED IN ACCORDANCE WITH THE MANUFACTURER'S INSTRUCTIONS.

-JOISTS ARE NOT TO BE PLACED DIRECTLY OVER INTERIOR PARALLEL WALLS. (TO PREVENT UNEVEN FLOOR DEFLECTION FROM OCCURRING) ALL WOOD BEAMS/HEADERS: 2x6's TO BE SPF STUD GRADE OR BETTER/ 2x8 OR LARGER TO BE SYP #2 | PER NDS 2012 | OR BETTER, U.O.N.

ALL HEADERS SHALL BE SUPPORTED BY (1) 2x JACK STUD AND (1) 2x KING STUD MINIMUM. THE NUMBER OF STUDS SPECIFIED AT A SUPPORT INDICATES THE NUMBER OF JACKS REQUIRED, U.N.O. AT FLUSH OR DROPPED BEAMS, THE NUMBER OF STUDS SPECIFIED INDICATES THE TOTAL NUMBER OF STUDS REQUIRED TO SUPPORT THE BEAM

EXTERIOR WALLS TO BE 2x4 SPF STUD GRADE AT 16" O.C. UNLESS OTHERWISE NOTED (10'4-1/2" MAXIMUM WALL HEIGHT)

ALL INTERIOR BEARING WALLS AND WALLS AT BASEMENT & FIRST FLOOR STAIRWELLS, KITCHEN, BATH, & GARAGE TO BE 2x4 SPF STUD GRADE @ 16" o.c.; ALL OTHER NON-BEARING INTERIOR WALLS TO BE 2x4 SPF STUD GRADE @ 24" o.c. U.O.N.

ALL WALLS TO BE 3 1/2" UNLESS OTHERWISE NOTED.

PROVIDE SOLID BEARING TO FOUNDATION OR BEAM BELOW FOR ALL BEAMS, HEADERS & GIRDER TRUSSES. PROVIDE BLOCKING BETWEEN JOISTS AS REQUIRED.

SEE SELECTION SHEET FOR SIZE AND STYLE OF FIREPLACE. SEE FIREPLACE ELEVATION DETAIL FOR ADDITIONAL FRAMING REQUIREMENTS, IF ANY. CHECK SELECTION SHEETS FOR FLOOR COVERING AT TOP AND BOTTOM OF STAIR RISERS AND ADJUST RISERS AS REQ'D.

PROVIDE BLOCKING AT ALL HANDRAIL TERMINATION AND BRACKET LOCATIONS.

20-MINUTE FIRE RATED DOOR BETWEEN GARAGE AND LIVING AREA.

EXTERIOR WALL TO BE 2x4 SPF STUD G AT 16" o.c., UNLESS OTHERWISE NOTED (10'-0" MAXIMUM UNBRACED WALL HEIGHT).

ALL EXTERIOR WALLS AND INTERIOR BEARING WALLS, FRAMED HIGHER THAN THE STANDARD PLATE HEIGHT, SHALL BE FRAMED WITH CONTINUOUS FULL HEIGHT STUDS TO THE HIGHEST CEILING (I.E. NO INTERMEDIATE BREAKS) TO PREVENT LATERAL HINGE CONDITIONS.

IN THE GARAGE, PROVIDE 1/2" GYP. BOARD AT ALL WALLS COMMON TO LIVING SPACE AND ALL STRUCTURAL MEMBERS SUPPORTING FLOOR/CEILING ASSEMBLY. GARAGE CEILING TO BE 1/2" SAG RESISTANT GYP. BOARD WHEN THERE ARE NO HABITABLE SPACES ABOVE, OR 5/8" TYPE X GYP. BOARD WHEN HABITABLE SPACES ARE ABOVE.

ALL EMERGENCY ESCAPE & RESCUE OPENINGS TO BE A MAXIMUM OF 44" OFF OF FINISHED FLOOR AND HAVE MINIMUM OPENING DIMENSIONS OF 24" IN HEIGHT, 20" IN WIDTH, & HAVE A MINIMUM OPENING AREA OF 5.7 S.F.

ALL DOORS TO BE 6'-8" TALL UNLESS OTHERWISE NOTED.

ALL GLASS IN INTERIOR AND EXTERIOR DOORS TO BE TEMPERED (INCLUDING SIDELITES AND TRANSOMS)

ALL LUMBER CONTACTING CONCRETE TO BE PRESSURE TREATED.

ALL FASTENERS, HANGERS, AND OTHER CONNECTORS TO BE USED WITH PRESSURE TREATED WOOD ARE TO HAVE ZMAX COATING (OR EQUIVALENT) HOT-DIPPED GALVANIZED OR STAINLESS STEEL.

AT STAIR HANDRAIL, ON ONE SIDE ONLY, SHALL BE CONTINUOUS FOR THE ENTIRE LENGTH OF THE STAIRWAY, AND ENDS SHALL BE RETURNED TO A WALL OR POST. THE HANDRAIL MAY BE INTERRUPTED AT A NEWEL POST AT A TURN.

ALL HANDRAIL GRIP PORTIONS SHALL NOT EXCEED 2-1/4" IN CROSS SECTIONAL DIMENSION.

HANDRAILS SHALL BE INSTALLED ON ALL STAIRS WITH 2 OR MORE RISERS, HANDRAIL HEIGHTS SHALL BE A MINIMUM OF 34" AND A MAXIMUM OF 38".

ALL STAIRS TO BE CONSTRUCTED SO AS NOT TO ALLOW A 4" SPHERE TO PASS THROUGH THE RISER.

GUARDRAILS MUST BE A MINIMUM OF 36" HIGH. GUARDRAILS AT THE OPEN SIDES OF STAIRS MUST BE A MINIMUM OF 34" HIGH MEASURED VERTICALLY

FROM THE NOSING AT THE TREADS. THE HORIZONTAL SPACING OF THE VERTICAL BALUSTERS SHALL BE 4" O.C.

- GUARDRAIL DESIGN TO RESIST A MINIMUM OF 200 LBS LATERAL FORCE

MECHANICAL/ELECTRICAL NOTES

- ANY GAS APPLIANCES MUST BE INSTALLED PER MANUFACTURER'S SPECIFICATIONS.

- HOLD THE CENTERLINE OF ALL EXTERIOR LIGHT FIXTURES AT 5'-8" OFF BOTTOM OF DOOR OPENING.

- ALL KITCHEN CABINET DIMENSIONS ARE CABINET TO CABINET

- CABINET STYLES MAY VARY FROM INTERIOR ELEVATIONS DEPENDING ON STYLE, MANUFACTURER, ETC. FOR CABINET

DETAILS SEE SHOP DRAWINGS.

- CABINET SIZES MAY VARY WITH FULL-OVERLAY CABINETS.

- GROUND FAULT INTERRUPTER (GFCI) OUTLETS TO BE INSTALLED PER NEC 2017, SECT. 210.8

R-38 BATT

- PROVIDE HOSE BIBS PER DIVISION SPEC. SHEET. EXACT LOCATION TO BE FIELD DETERMINED UNLESS OTHERWISE NOTED ON THE PLANS.

R-19

- MIN. 50 C.F.M. FOR ALL EXHAUST FANS IN BATHROOMS

INSULATION DETAILS

EXTERIOR STUD WALL CAVITY:

(SLOPED AND VERTICAL SPACE)

FLOOR JOIST CAVITY AT STANDARD PERIMETER:

FLOOR JOIST CAVITY AT CANTILEVER: (OVER HORIZONTAL SPACE) OVER GARAGE:

R-19 R-38 BLOWN

FI EVATION NOTES

WINDOW STYLE AND MULLIONS MAY VARY FROM ELEVATION DEPENDING UPON MANUFACTURER. STYLE, PATTERN, TYPE,

- USE SECONDARY HEAT BARRIER ON ALL DIRECT VENT FIREPLACES 7' OR LESS ABOVE A WALKWAY.

- GRADE AWAY FROM FOUNDATION WALLS SHALL FALL A MINIMUM OF 6" WITHIN THE FIRST 10'.

- PROVIDE TYVEK OR EQUIVALENT HOUSE WRAP BEHIND BRICK AND STONE VENEER OVER WOOD SHEATHING.

PROVIDE BRICK WEEP HOLES AT 24" O.C. WITH BRICK VENEER AND MORTER NET BEHIND AND THROUGH WEEP HOLES. - PROVIDE FLASHING AND WEEP HOLES ABOVE ALL BRICK ANGLE IRONS, BELOW ALL BRICK SILLS AND ABOVE SILL PLATE

EXTERIOR STEPS TO HAVE A MAXIMUM 8" RISER. WHEN VERTICAL RISE EXCEEDS 30" OR FOUR OR MORE CONTINUOUS RISERS, A HANDRAIL IS REQUIRED

ROOF PLAN NOTES

- ALL OVERHANGS TO HAVE (2) SOFFIT VENTS PER EACH 8' SOFFIT SECTION.

- PROVIDE BAFFLES AT EXTERIOR TRUSS BEARING FOR VENTILATION.

PROVIDE 15# FELT PAPER LINDER SHINGLES



05/04/2023 2:07:01 PM

RESIDENCE FOR:

ORTIZ

26 CONTENTMENT LANE SERENITY - 50

STY5-0071-00 4/19/23 **GREG PIEPER** House Name:

Drawina Date

Job Number

Born on Date:

the MEADOW II

CDs Drawn By

Coord Name

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Elevation "A"

Series

Plan No

Coord Phone


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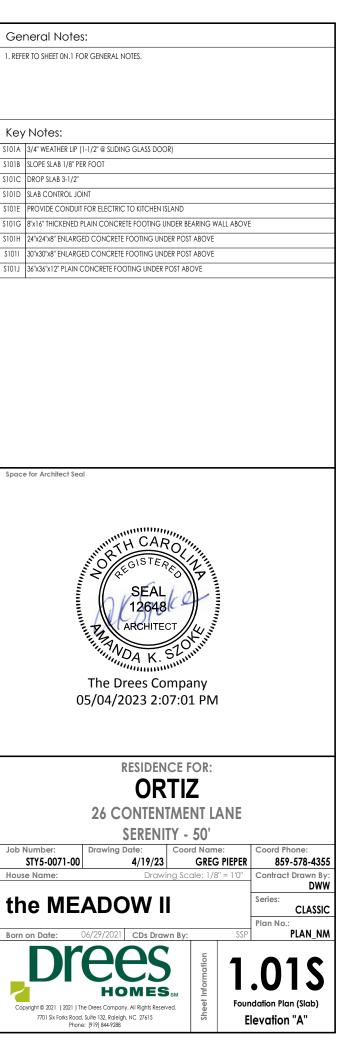
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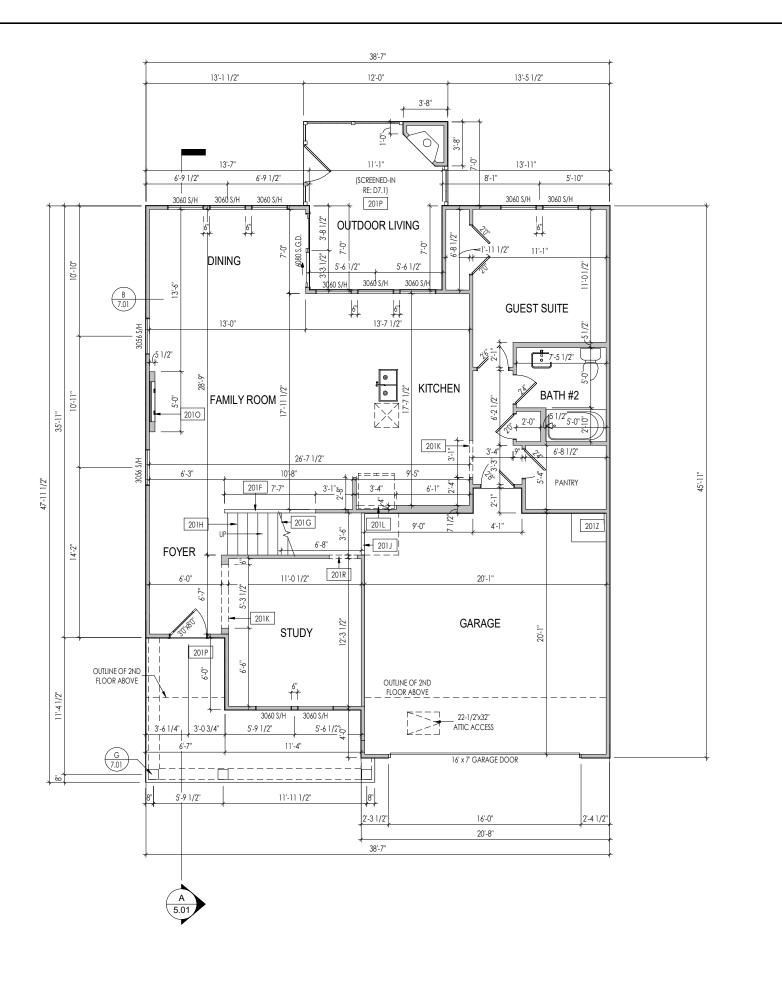
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PLAN NM

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PROVIDE 8' TALL DOORS THROUGHOUT FIRST FLOOR, U.N.O.

General Notes:

- 1. REFER TO SHEET ON.1 FOR GENERAL NOTES.
- ALL FIRST FLOOR CEILINGS TO BE 10'-1" ABOVE SUBFLOOR UNLESS OTHERWISE NOTED.
 FRAME TOP OF ALL WINDOWS AT 1'10" BELOW TOP OF PLATE UNLESS OTHERWISE NOTED.
- A. ALL DROPPED, INTERIOR HEADERS (FALSE AND BEARING) ARE DROPPED 1'-3" FROM CEILING.
- 5. REFER TO SELECTION SHEETS FOR FLOORING MATERIAL PRIOR TO CONSTRUCTING STAIRS TO DETERMINE
 - RISER HEIGHTS.

 6. REFER TO SHEET 2.01S FOR STRUCTURAL INFORMATION.

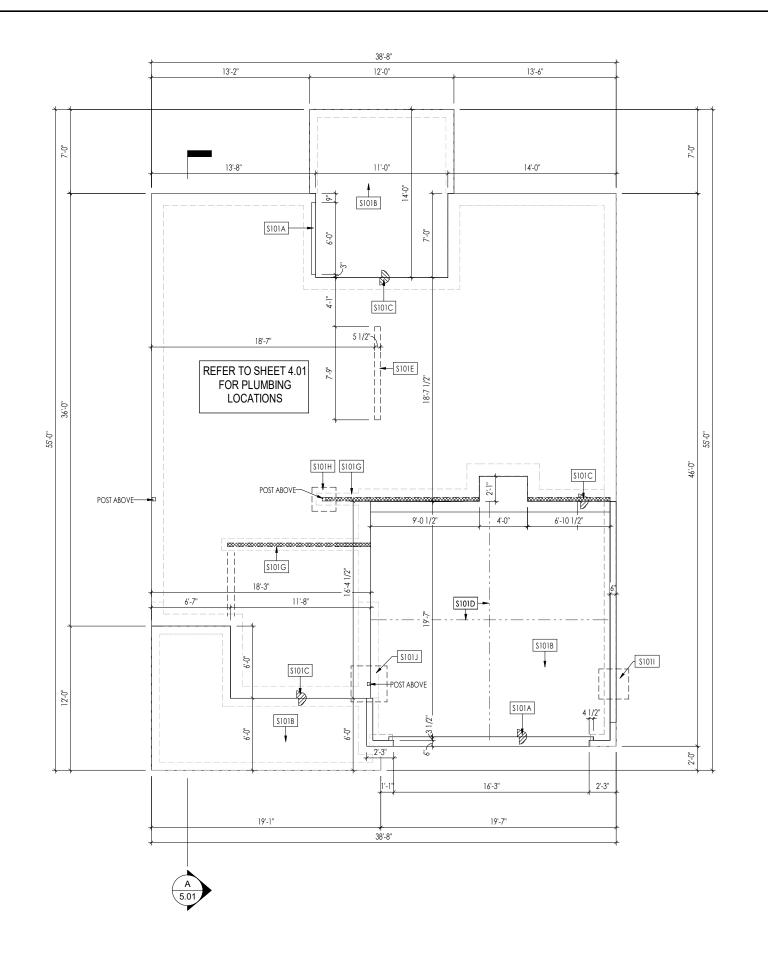Key Notes:

- 201F SLOPE WALL EVEN WITH TOP OF STAIR STRINGER, RAILING ABOVE
- 201G APPROX, LOCATION OF 36" HIGH WALL UNDER STAIRS (FIELD VERIFY)
- 201H SEE DETAIL F/7.01 FOR STAIR FRAMING DETAILS
- 01J +/- 8'1 1/2" HIGH WALL UNDER STAIRS ABOVE
- DIK FRAME TOP OF OPENING AT HEIGHT SPECIFIED IN GENERAL NOTES ON THIS SHEET
- 201L REFRIG. HEADER HELD TO 6'-6" A.F.F.
- 2010 PRE-FABRICATED FIREPLACE INSERT
- 201P CARPENTER TO DROP ELECTRICAL WIRE THROUGH PORCH CEILING FOR LIGHTS
- 201R SLOPE TOP OPENING FLUSH WITH STAIR STRINGER
- 201Z 18" HIGH WATER HEATER PLATFORM

Space for Architect Seal



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RESIDENCE FOR:

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26 CONTENTMENT LANE SERENITY - 50'

| Job Number: | Drawing Date: | Coord Name: | | STY5-0071-00 | 4/19/23 | GREG PIEPER |

se Name: Drawing Scale: 1/8"

the MEADOW II

DWV Series:

859-578-4355

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Plan No.:
SP PLAN NM

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2.01
First Floor Framing Plan
Elevation "A"

LATERAL/WALL BRACING & WALL SHEATHING SPECIFICATIONS

THIS MODEL HAS BEEN DESIGNED TO RESIST LATERAL FORCES RESULTING FROM:

120 MPH WIND IN 2018 NCSBC MAP

(120 MPH WIND SPEED IN ASCE 7-10 WIND MAP, PER IRC R301.2.1.1) EXP. B & SEISMIC CAT. A/B.

EXT. WALL SHEATHING SPECIFICATION

- 7/16" OSB OR 15/32" PLYWOOD: FASTEN SHEATHING w/ 2-3/8"x 0.113 NAILS @ 6" O.C. AT EDGES & @ 12" O.C. IN THE PANEL FIELD. (TYP,
- ALL SHEATHING PANELS SHALL BE ORIENTED AND INSTALLED FULL HEIGHT OF SHEAR WALL OR 2X HORIZONTAL BLOCKING SHALL BE PROVIDED TO SUPPORT ALL UNSUPPORTED PANEL EDGES & EDGE FASTENING.
- ALL EXT. WALLS SHALL BE CONTINUOUSLY SHEATHED AND ARE CONSIDERED SHEAR WALLS.
- ALT. STAPLE CONNECTION SPEC: 1 3/4" 16 GA STAPLES 1/1/6" CROWN) @ 3" O.C. AT EDGES & @ 6" O.C IN FIELD.

3" O.C. EDGE NAILING

* AT DESIGNATED AREAS - FASTEN PANEL EDGES OF WOOD STRUCTURAL WALL SHEATHING TO FRAMING W/ 2-3/8"x 0.113 NAILS @ 3"O.C. NO STAPLE ALTERNATIVE AVAILABLE AT THIS SPEC. ALL SHEATHING PANELS SHALL BE ORIENTED AND INSTALLED FULL HEIGHT OF SHEAR WALL OR 2x HORIZONTAL BLOCKING SHALL BE PROVIDED TO SUPPORT UNSUPPORTED PANEL EDGES AND 3"O.C. EDGE FASTENING.

NOTES


- SEE CONNECTION SPECIFICATIONS CHART FOR STANDARD SHEAR TRANSFER DETAILING, IF ADDITIONAL CAPACITY IS REQUIRED BY DESIGN, IT WILL BE SPECIFICALLY NOTED ON PLAN.
- DESIGN ASSUMES 16" O.C MAX. STUD SPACING, U.N.O.
 ALL STRUCTURAL PANELS ARE TO BE DIRECTLY APPLIED TO STUD FRAMING.

• PRE-MANUFACTURED PANELIZED WALLS: FASTEN TOGETHER END STUDS OF WALL PANELS SHEATHED W/ OSB OR PLYWOOD W/ 10d NAILS @ 4" O.C. (THRU ONE SIDE ONLY)

INDICATES EXTENT OF INT. OSB SHEARWALL, AND/OR 3" O.C. EDGE NAILING

► INDICATES HOLDOWN

INDICATES POST ABOVE (P.A.) PROVIDE SOLID BLOCKING UNDER POST OR JAMB ABOVE.
MAY STRO. SEET

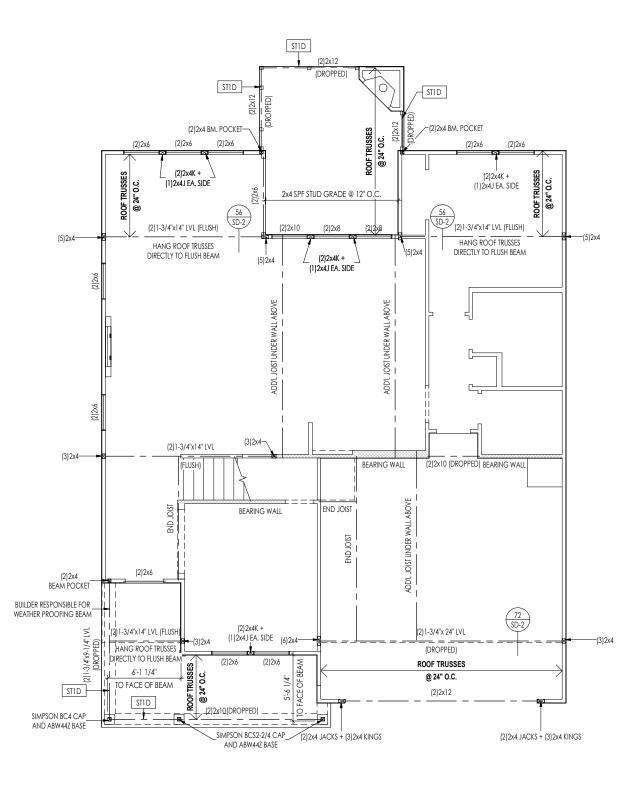

General Notes:

1. REFER TO SHEET ON.1 FOR GENERAL NOTES.

Key Notes:

STID FRAME TOP OF BEAM AT 10'-1" ABOVE FIRST FLOOR SUBFLOOR/SLAB

CONNECTION SPECIFICATIONS (TYP. U.N.O.) NOTE: 10d NAIL = 3" x 0.131" GUN NAIL DIST TO SOLE PLATE (3)10d TOENAILS OLE PLATE TO JOIST/BLK'G. 10d NAILS @ 6" o.c. UD TO SOLE PLATE (3) 10d TOENAILS OP OR SOLE PLATE TO STUD M TO TOP PLATE 10d TOENAILS @ 6" o.c K'G. BTWN. JOISTS TO TOP PL (3)10d TOENAILS (3)10d TOENAILS + (1) SIMPSON H2.5A AFTER/TRUSS TO TOP PLATE AB. END TRUSS TO DBL. TOP PL 10d TOENAILS @ 8" o.c. 2x10 BLK EVERY 3RD BAY FASTENED TO DBL. TOP PLATE T. w/ HEEL HT. 9 1/4" TO 12" w/ 10d TOENAILS @ 6" O.C. 2x12 BLK EVERY 3RD BAY FASTENED TO DBL. TOP PLATE T. w/ HEEL HT. 12" TO 16" w/ 10d TOENAILS @ 6" O.C LAP WALL SHTG. w/ DBL. TOP PL. & INSTALL ON TRUSS VERT. FASTEN w/ 8d NAILS @ 6" O.C. T. w/ HEEL HT. UP TO 24" LAP WALL SHTG. w/ DBL. TOP PL. & INSTALL ON TRUSS VERT. T. w/ HEEL HT. 24" TO 48" FASTEN w/ 8d NAILS @ 6" O.C. PROVIDE 2x BLK @ EA. BAY AT OUBLE STUD 10d NAILS @ 24" o.c. 10d NAILS @ 24" o.c. OUBLE TOP PLATE (10)10d NAILS IN LAPPED AREA OUBLE TOP PLATE LAP SPLICE OP PLATE LAP @ CORNERS & NTERSECTING WALLS (2)10d NAILS WALL SHTG. LAP w/ SILL PL. & FASTENED PER SHEAR WALL FASTENING SPEC. ALL TO FOUNDATION

Space for Architect Seal



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RESIDENCE FOR:

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26 CONTENTMENT LANE SERENITY - 50'

the MEADOW II

06/29/2021 CDs Drawn By:

Series:

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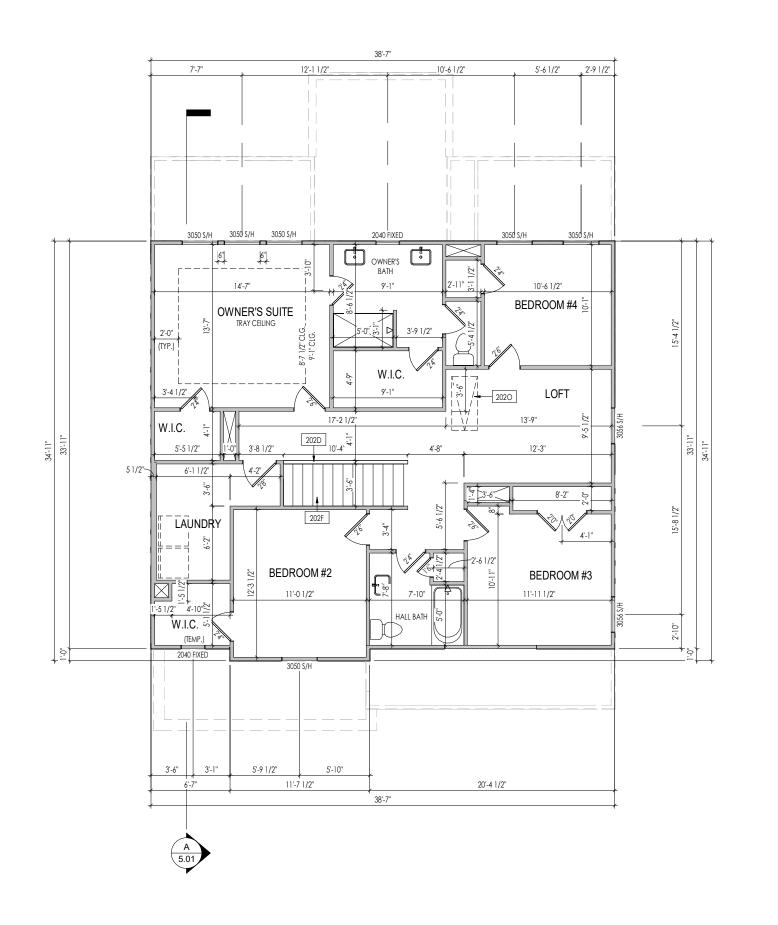
Plan No.:

PLAN NM

DWW

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Phone: 1919 8447288

2.015
First Floor Structural Pla
Elevation "A"



General Notes:

- . REFER TO SHEET ON.1 FOR GENERAL NOTES.
- 1. REPERTOR SHEEL WINT POR SECRETAR IN OTIES.

 2. ALL SECOND FLOOR CELLINGS TO BE 9'-1" ABOVE SUBFLOOR UNLESS OTHERWISE NOTED.

 3. FRAME TOP OF ALL WINDOWS AT 1'-0 1/4" BELOW TOP OF PLATE UNLESS OTHERWISE NOTED.
- 4. ALL DROPPED, INTERIOR HEADERS (FALSE AND BEARING) ARE DROPPED 1'-0" FROM CEILING.
- 5. REFER TO SELECTION SHEETS FOR FLOORING MATERIAL PRIOR TO CONSTRUCTING STAIRS TO DETERMINE
- RISER HEIGHTS.

 6. REFER TO SHEET 2.02S FOR STRUCTURAL INFORMATION.

Key Notes:

202D 36" HIGH WALL

202F SEE DETAIL F/7.01 FOR STAIR FRAMING DETAILS

2020 PULL DOWN ATTIC ACCESS STAIRS (25-1/2" x 54") WITH LIGHT AND OUTLET

Space for Architect Seal



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RESIDENCE FOR:

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26 CONTENTMENT LANE

SERENITY - 50'

Coord Name: Job Number: Drawing Date: 4/19/23 **GREG PIEPER** 859-578-4355 STY5-0071-00 DWW

the MEADOW II

HOMES_{SM}

Plan No.: PLAN NM

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- ALL SHEATHING PANELS SHALL BE ORIENTED AND INSTALLED FULL HEIGHT OF SHEAR WALL OR 2X HORIZONTAL BLOCKING SHALL BE PROVIDED TO SUPPORT ALL UNSUPPORTED PANEL EDGES & EDGE
- ALL EXT. WALLS SHALL BE CONTINUOUSLY SHEATHED AND ARE CONSIDERED SHEAR WALLS.
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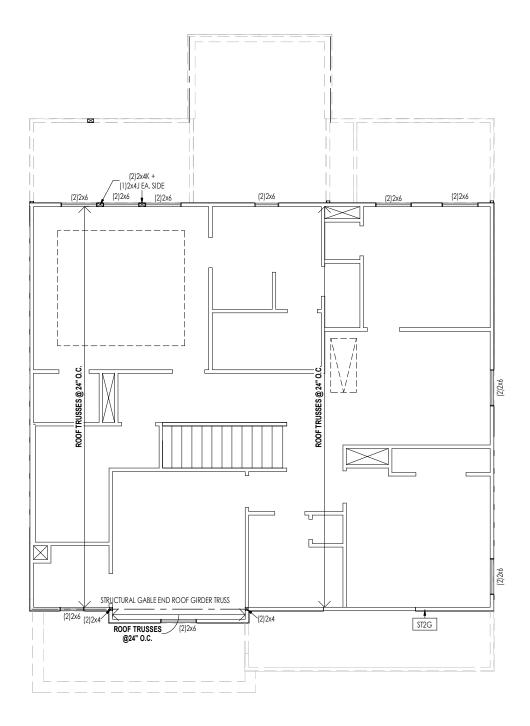
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NDICATES HOLDOWN

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General Notes:

. REFER TO SHEET ON.1 FOR GENERAL NOTES.

Key Notes:

T2G PROVIDE CONT. SHTG, BEHIND LOW ROOF TRUSSES DOWN TO SECOND FLOOR SOLE PLATE (TYP.)

CONNECTION SPECIFICATIONS (TYP. U.N.O.) NOTE: 10d NAIL = 3" x 0.131" GUN NAIL (3)10d TOENAILS OLE PLATE TO JOIST/BLK'G. 10d NAILS @ 6" o.c. UD TO SOLE PLATE (3) 10d TOENAILS OP OR SOLE PLATE TO STUD M TO TOP PLATE 10d TOENAILS @ 6" o.c. LK'G. BTWN. JOISTS TO TOP PL (3)10d TOENAILS (3)10d TOENAILS + (1) SIMPSON H2.5A AFTER/TRUSS TO TOP PLATE SAB, END TRUSS TO DBL, TOP PL 10d TOENAILS @ 8" o.c. 2x10 BLK EVERY 3RD BAY FASTENED TO DBL. TOP PLATE .T. w/ HEEL HT. 9 1/4" TO 12" w/ 10d TOENAILS @ 6" O.C. 2x12 BLK EVERY 3RD BAY FASTENED TO DBL. TOP PLATE T. w/ HEEL HT. 12" TO 16" w/ 10d TOENAILS @ 6" O.C LAP WALL SHTG. w/ DBL. TOP PL. & INSTALL ON TRUSS VERT. FASTEN w/ 8d NAILS @ 6" O.C. .T. w/ HEEL HT. UP TO 24" LAP WALL SHTG. w/ DBL. TOP PL. & INSTALL ON TRUSS VERT. T. w/ HEEL HT. 24" TO 48" FASTEN w/ 8d NAILS @ 6" O.C. PROVIDE 2x BLK @ EA. BAY AT OUBLE STUD 10d NAILS @ 24" o.c. OUBLE TOP PLATE 10d NAILS @ 24" o.c. (10)10d NAILS IN LAPPED AREA OUBLE TOP PLATE LAP SPLICE TOP PLATE LAP @ CORNERS & NTERSECTING WALLS (2)10d NAILS WALL SHTG. LAP w/ SILL PL. & FASTENED PER SHEAR WALL FASTENING SPEC.

Space for Architect Seal

VALL TO FOUNDATION



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RESIDENCE FOR:

ORTIZ

26 CONTENTMENT LANE SERENITY - 50'


Coord Name Job Number: Drawina Date STY5-0071-00 4/19/23 **GREG PIEPER** 859-578-4355 Drawing Scale: 1/8" = 1'0" DWW

the MEADOW II

CLASSIC Plan No. PLAN NM

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Elevation "A"

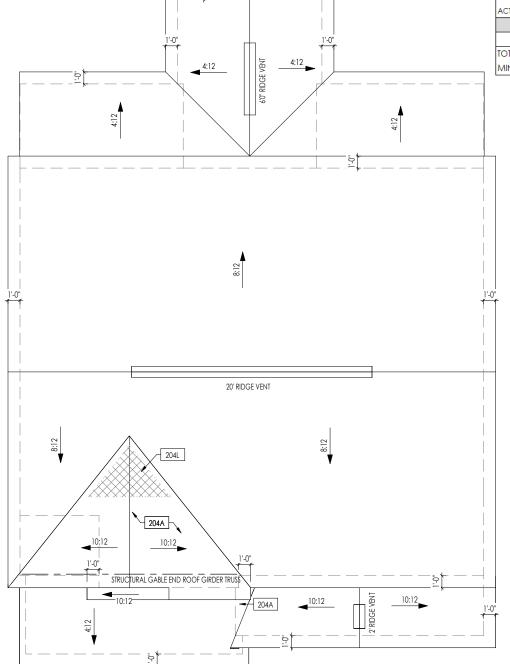

| ROOF VENTILATION | | | |
|---|------------|-------|--------|
| CITY/SERIES: | RALEIGH | | |
| | MAIN HOUSE | LOWER | GARAGE |
| TOTAL ATTIC AREA: | 1,471 | 408 | 127 |
| REQUIRED NET FREE VENTILATION (ATTIC AREA/300): | 4.90 | 1.36 | 0.42 |
| ACTUAL NET FREE VENTILATION (UPPER + LOWER): | 5.42 | 2.60 | 0.54 |
| DOWNSPOUT CALCULATION | | | |
| | MAIN HOUSE | LOWER | GARAGE |
| TOTAL DRAINABLE ROOF AREA: | 1912.3 | 530.4 | 165. |
| MINIMUM # OF DOWNSPOUTS: | 4 | 1 | |

| HEEL CUT STANDARDS | | | | | |
|--------------------|-------|---------|---------|--|--|
| | | OVER | HANG | | |
| | | 1'-0" | 2'-0" | | |
| | 4:12 | 3-3/4" | 7-3/4" | | |
| ROOF PITCH | 5:12 | 4-3/4" | 9-3/4" | | |
| | 6:12 | 5-3/4" | 11-3/4" | | |
| | 7:12 | 6-3/4" | 13-3/4" | | |
| | 8:12 | 7-3/4" | N/A | | |
| | 9:12 | 8-3/4" | N/A | | |
| | 10:12 | 9-3/4" | N/A | | |
| | 12:12 | 11-3/4" | N/A | | |
| | 14:12 | 13-3/4" | N/A | | |

General Notes: 1. REFER TO SHEET ON.1 FOR GENERAL NOTES.

Key Notes:

204A VALLEY TRUSS OVER FRAMING @ 24" O.C.
204L NO ROOF DECKING UNDER OVERFRAMING IN THIS AREA TO ALLOW FOR PROPER ATTIC VENTILATION

CONNECTION SPECIFICATIONS (TYP. U.N.O.)

NOTE: 10d NAIL = 3" x 0.131" GUN NAIL

| JOIST TO SOLE PLATE | (3)10d TOENAILS |
|--|---|
| SOLE PLATE TO JOIST/BLK'G. | 10d NAILS @ 6" o.c. |
| STUD TO SOLE PLATE | (3) 10d TOENAILS |
| TOP OR SOLE PLATE TO STUD | (3) 10d NAILS |
| RIM TO TOP PLATE | 10d TOENAILS @ 6" o.c. |
| BLK'G. BTWN. JOISTS TO TOP PL. | (3)10d TOENAILS |
| RAFTER/TRUSS TO TOP PLATE | (3)10d TOENAILS + (1) SIMPSON H2.5A |
| GAB. END TRUSS TO DBL. TOP PL. | 10d TOENAILS @ 8" o.c. |
| R.T. w/ HEEL HT. 9 1/4" TO 12" | 2x10 BLK EVERY 3RD BAY FASTENED TO DBL. TOP PLATE w/ 10d TOENAILS @ 6" O.C. |
| R.T. w/ HEEL HT. 12" TO 16" | 2x12 BLK EVERY 3RD BAY FASTENED TO DBL. TOP PLATE W/ 10d TOENAILS @ 6" O.C. |
| R.T. w/ HEEL HT. UP TO 24" | LAP WALL SHTG. w/ DBL. TOP PL. & INSTALL ON TRUSS VERT FASTEN w/ 8d NAILS @ 6" O.C. |
| R.T. w/ HEEL HT. 24" TO 48" | LAP WALL SHTG. W/ DBL. TOP PL. & INSTALL ON TRUSS VERT FASTEN W/ 8d NAILS @ 6" O.C. PROVIDE 2x BLK @ EA. BAY AT TOP OF HEEL |
| DOUBLE STUD | 10d NAILS @ 24" o.c. |
| DOUBLE TOP PLATE | 10d NAILS @ 24" o.c. |
| DOUBLE TOP PLATE LAP SPLICE | (10)10d NAILS IN LAPPED AREA |
| TOP PLATE LAP @ CORNERS & INTERSECTING WALLS | (2)10d NAILS |
| WALL TO FOUNDATION | WALL SHTG. LAP w/ SILL PL. & FASTENED PER SHEAR WALL FASTENING SPEC. |
| | |

Space for Architect Seal



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RESIDENCE FOR:

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26 CONTENTMENT LANE SERENITY - 50'

| Drawing Date: | Coord Name: | Coord Name:

the MEADOW II

/29/2021 CDs Drawn By:

Series:

CLASSIC

Plan No.:


PLAN_NM

859-578-4355

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Phone: [1919 844-9288

2.04
Roof Plan
Elevation "A"

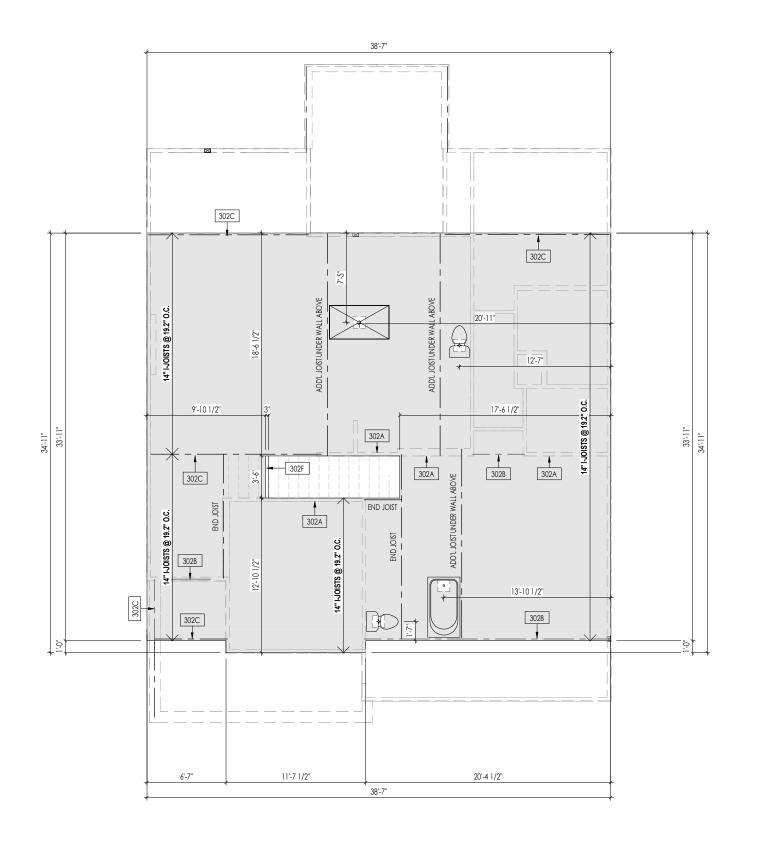

General Notes:

- 1. REFER TO SHEET ON.1 FOR GENERAL NOTES.
- 2. FLOOR JOISTS TO BE 14" 5000 SERIES, OR EQUAL, @ 19.2 O.C. UNLESS OTHERWISE NOTED.
- 3. JOISTS ARE NOT TO BE PLACE DIRECTLY OVER INTERIOR PARALLEL WALL.
- (TO PREVENT UNEVEN FLOOR DEFLECTION FROM OCCURRING)

 4. ADD'L JOISTS MAY BE LOCATED UP TO 2" AWAY FROM THE PARTITION WALL ABOVE IN CASES WHERE MECHANICAL PENETRATIONS

Key Notes:

302A BEARING WALL BELOW

302B BEAM BELOW - SEE SHEET 2.01S FOR MORE INFO

302C FLUSH BEAM - SEE SHEET 2.01S FOR MORE INFO

302F (2)2x8 (TOP FLUSH) NEXT TO 2x12 FLAT FRAME FOR STAIR HEADROOM - SEE DETAIL E/7.01

Space for Architect Seal



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RESIDENCE FOR:

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26 CONTENTMENT LANE SERENITY - 50'

the MEADOW II

6/29/2021 CDs Drawn Bv:

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DWW


Plan No.: PLAN NM

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HOMES SM
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5.UZ econd Floor Subfloor Plo Elevation "A"

PROVIDE 8' TALL DOORS THROUGHOUT FIRST FLOOR. U.N.O.



General Notes: . REFER TO SHEET ON.1 FOR GENERAL NOTES. Key Notes: 401A TO SWITCH OR LIGHT ABOVE 401D HOLD OUTLET HIGH ON ISLAND 401E OUTLET FOR RANGE HOOD/MICROWAVE HELD HIGH, VENT TO EXTERIOR 401G PUSH BUTTON FOR GARBAGE DISPOSAL OR SWITCH LOCATED IN SINK CABINET - REFER TO SELECTIONS 401K PRE-FABRICATED FIREPLACE INSERT MECHANICAL LEGEND ■ DATA JACK ⇒ WALL OUTLET CLG. MOUNTED LIGHT FIXT. ■ STAIR LIGHT SURFACE MOUNT DISC LIGHT OR RECESSED CEILING LIGHT, PER SPECS.

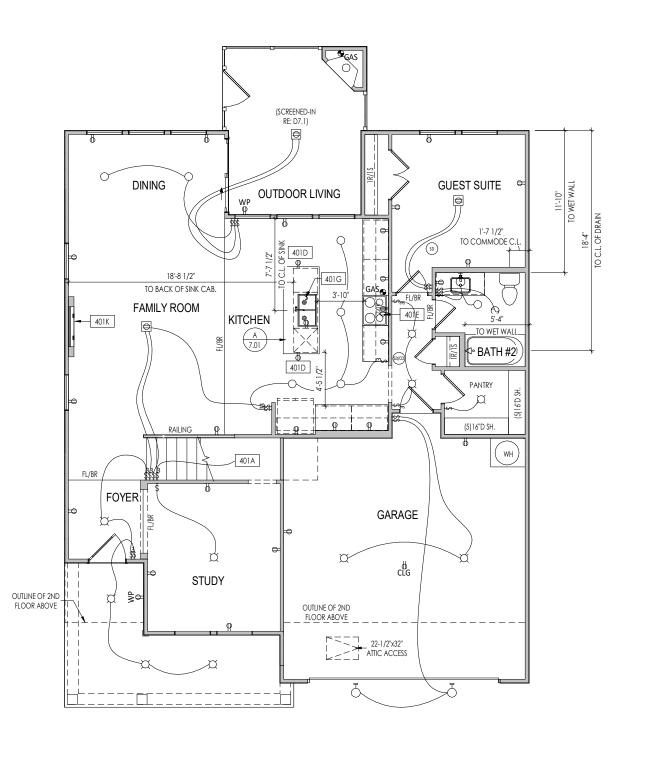- ₩EATHERPROOF GFCI OUTLET № 220 VOLT OUTLET
- 8 ← GFCI OUTLET
- FLOOR OUTLET
- (TV) CABLE TELEVISION JACK (PIN LIGHT
- ← SINGLE POLE SWITCH ⇔ 3-WAY SWITCH
- FLUORESCENT LIGHT
- UNDER CABINET LIGHTING BLOCK, MOUNT, & SWITCH FOR FUTURE FAN/LIGHT COMBINATION (CENTER, UNLESS OTHERWISE NOTED)

₩ WALL SCONCE @ 5'-6" A.F.F.

- + HOSE BIB SHOWER HEAD
- → WALL MOUNTED LIGHT FIXT. Gas Gas Hook up - DOUBLE SPOTLIGHT FIXT.
- DIRECTIONAL CAN LIGHT SD SMOKE DETECTOR
 - SMOKE DETECTOR/ CO DETECTOR COMBINATION
 - EXHAUST FAN AND LIGHT COMBINATION
 - CLG. MTD. EXHAUST FAN

Space for Architect Seal



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26 CONTENTMENT LANE SERENITY - 50'

Coord Name: Job Number: Drawing Date: **GREG PIEPER** STY5-0071-00 4/19/23 859-578-4355 House Name: Drawing Scale: 1/8" = 1'0" DWW

the MEADOW II





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PLAN NM

7701 Six Forks Road, Suite 132, Raleigh, NC 27615 Phone: [919] 844-9288 Elevation "A"





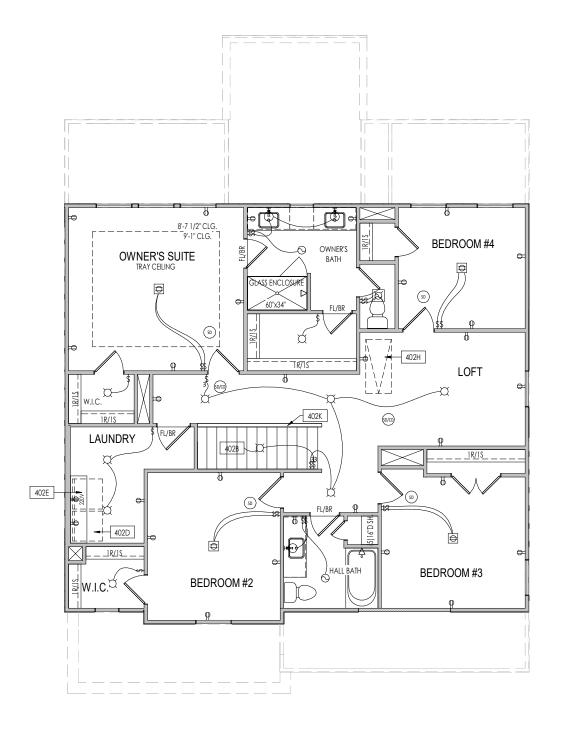

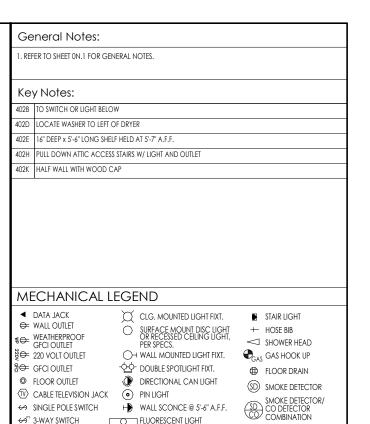₩ALL SCONCE @ 5'-6" A.F.F.

EXHAUST FAN AND LIGHT COMBINATION

CLG. MTD. EXHAUST FAN

FLUORESCENT LIGHT

UNDER CABINET LIGHTING

← SINGLE POLE SWITCH

Space for Architect Seal

BLOCK, MOUNT, & SWITCH FOR FUTURE FAN/LIGHT COMBINATION (CENTER, UNLESS OTHERWISE NOTED)

⇔ 3-WAY SWITCH

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RESIDENCE FOR:

ORTIZ

26 CONTENTMENT LANE

SERENITY - 50' Coord Name: Job Number: Drawing Date:

GREG PIEPER 859-578-4355 STY5-0071-00 4/19/23 House Name: Drawing Scale: 1/8" = 1'0" DWW

the MEADOW II


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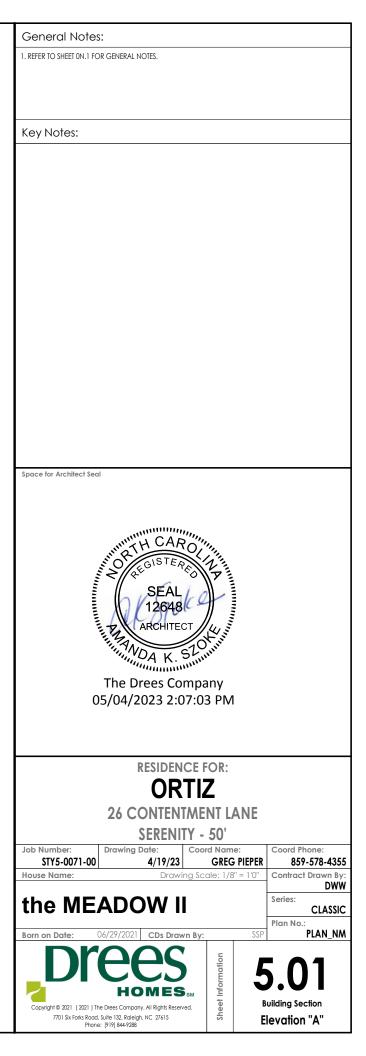
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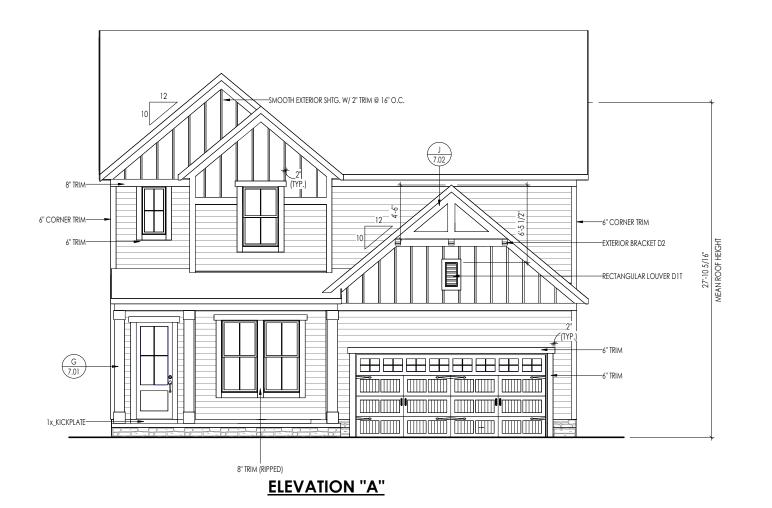
CLASSIC

PLAN NM



A BUILDING SECTION THRU STAIRS
5.01 1/8" = 1'-0"



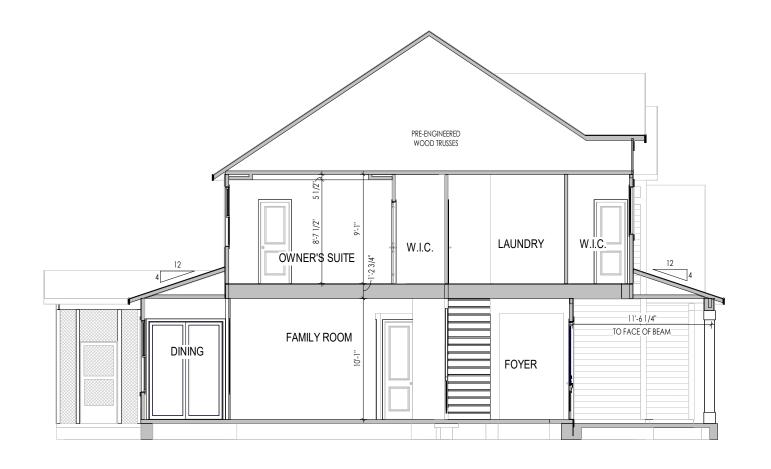

TYPICAL TRIM:

6" FASCIA (ALL SIDES)

8" FRIEZE (FRONT ONLY, UNLESS OTHERWISE NOTED)

General Notes:

- . REFER TO SHEET ON.1 FOR GENERAL NOTES.
- 2. ROOFING MATERIAL PER SELECTIONS.
 3. CONTACT M&K ENGINEERING FOR HEADER SIZE/BRICK SUPPORT IF GRADE DROPS AND THE AMOUNT OF BRICK OVER GARAGE DOOR SHOWN ON CURRENT ELEVATION IS NO LONGER ACCURATE

Key Notes:

BRICK VENEER LINTEL SCHEDULE HEIGHT OF VENEER ABOVE LINTEL STEEL ANGLE SIZE L3-1/2 x3-1/2 x1/4 20 FT. MAX Up to 3'-6" L5x 3-1/2x 5/16 (LLV) Up to 6'-0" 20 FT. MAX L6x 3- 1/2x 3/8 (LLV) 20 FT. MAX Up to 8'-0" L7x 4x 3/8 (LLV) 9'-0" 12 FT. MAX *16'-0" L7x 4x 3/8 (LLV) 3 FT. MAX L8x 4x 1/2 (LLV) *16'-0" 4-1/2 FT. MAX

ALL LINTELS <=6' SHALL HAVE 4" MINIMUM BEARING AT EACH END.

ALL LINTELS >=6' SHALL HAVE 8" MINIMUM BEARING AT EACH END.

* FASTENED TO HDR @ 1/3 SPAN POINTS THRU 1-1/2 "LONG VERTICALLY SLOTTED HOLES IN LINTEL W/ 1/2" DIA. x 3-1/2 " LONG LAG SCREWS. LOCATE LAG SCREWS @ MIDDLE OF SLOTTED HOLE & TIGHTEN SCREWS ENOUGH TO ALLOW MOVEMENT OF LINTEL.

**ANY LINTEL CONDITION NOT SPECIFIED ABOVE SHALL BE DESIGNED

Space for Architect Seal



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RESIDENCE FOR:

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26 CONTENTMENT LANE SERENITY - 50'

Coord Name: Job Number: Drawing Date **GREG PIEPER** STY5-0071-00 4/19/23 859-578-4355 House Name:

the MEADOW II

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Elevation "A"

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PLAN NM

General Notes: TYPICAL TRIM: 1. REFER TO SHEET ON.1 FOR GENERAL NOTES. 2. ROOFING MATERIAL PER SELECTIONS. 3. REFER TO LINTEL SCHEDULE AS NEEDED ON SHEET 6.01. 6" FASCIA (ALL SIDES) **8" FRIEZE** (FRONT ONLY, UNLESS OTHERWISE NOTED) Key Notes: 4" TRIM-Space for Architect Seal -SCREENED-IN PATIO 2'-0" The Drees Company 05/04/2023 2:07:04 PM **26 CONTENTMENT LANE** Job Number: Drawing Date: STY5-0071-00 House Name: the MEADOW II **HOMES**_{SM} Copyright © 2021 (2021) The Drees Company. All Rights Reserved. 7701 Six Forks Road, Suite 132, Raleigh, NC 27615 Phone: [919] 844-9288

RESIDENCE FOR: ORTIZ

SERENITY - 50'

Coord Name:

Drawing Scale: 1/8" = 1'0"

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Plan No.:

Garage Side Elevation

Elevation "A"

DWW

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PLAN_NM

4/19/23 GREG PIEPER

| 4 CORNER TRM |
|--------------------|
| —SCREENED-IN PATIO |
| |

TYPICAL TRIM:

6" FASCIA (ALL SIDES)

8" FRIEZE (FRONT ONLY, UNLESS OTHERWISE NOTED)

General Notes:

- 1. REFER TO SHEET ON.1 FOR GENERAL NOTES. 2. ROOFING MATERIAL PER SELECTIONS. 3. REFER TO LINTEL SCHEDULE AS NEEDED ON SHEET 6.01.

Key Notes:

Space for Architect Seal

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RESIDENCE FOR:

ORTIZ

26 CONTENTMENT LANE

SERENITY - 50' Coord Name: Job Number: Drawing Date: 4/19/23 GREG PIEPER

Drawing Scale: 1/8" = 1'0" Contract Drawn By House Name: the MEADOW II

STY5-0071-00

CLASSIC Plan No.:

Coord Phone:

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Elevation "A"





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26 CONTENTMENT LANE

SERENITY - 50'

Coord Name: Drawing Date: 4/19/23 GREG PIEPER 859-578-4355 Drawing Scale: 1/8" = 1'0" Contract Drawn By:

the MEADOW II


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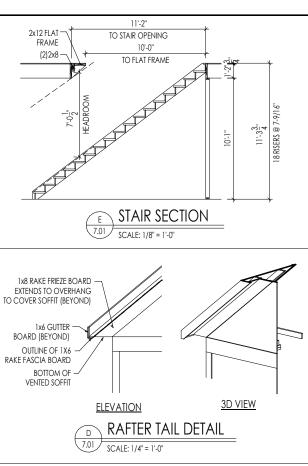
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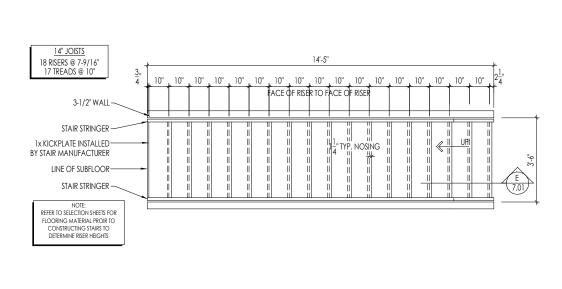
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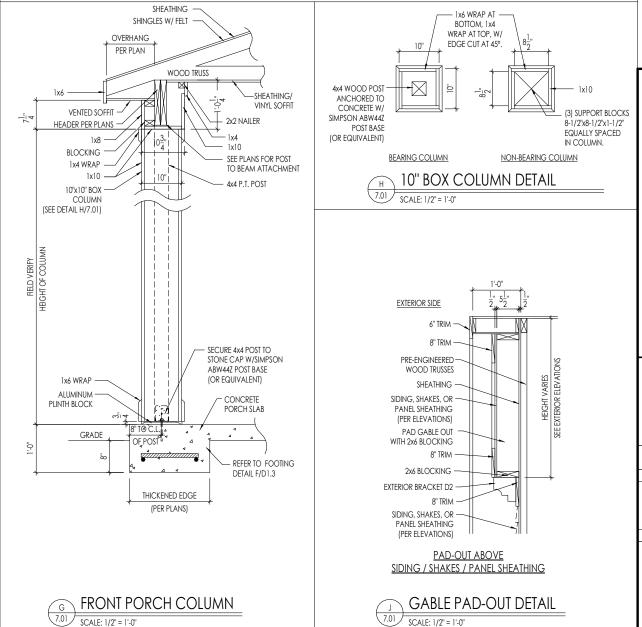
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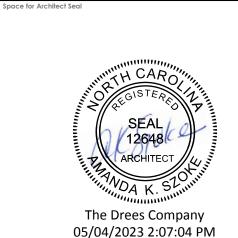






STAIR FRAMING DETAILS SCALE: 1/4" = 1'-0"



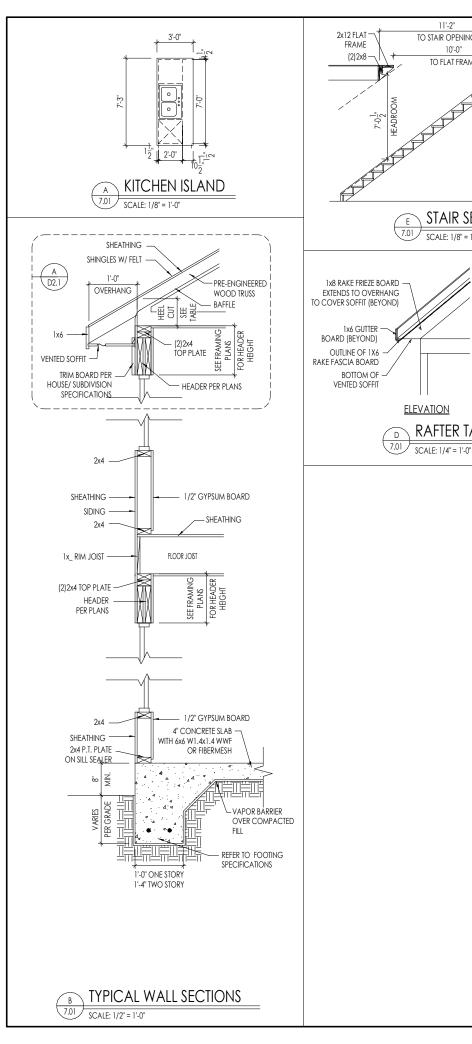

RESIDENCE FOR:

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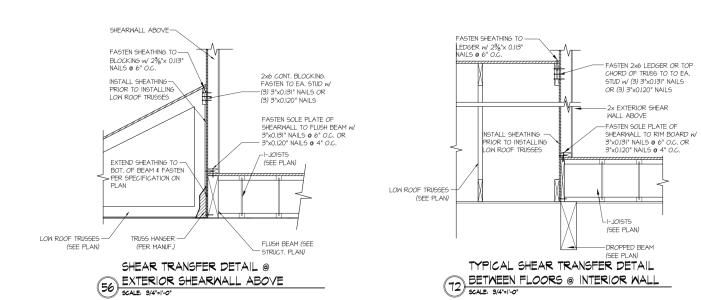
26 CONTENTMENT LANE SERENITY - 50'

GREG PIEPER 859-578-4355 STY5-0071-00 4/19/23 DWW the MEADOW II CLASSIC Plan No. PLAN NM

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Job Number

Elevation "A"



HOMES DREES

Mulhern+Kulp project number:

BSM project mgr: CNV drawn by: issue date: 08-12-22


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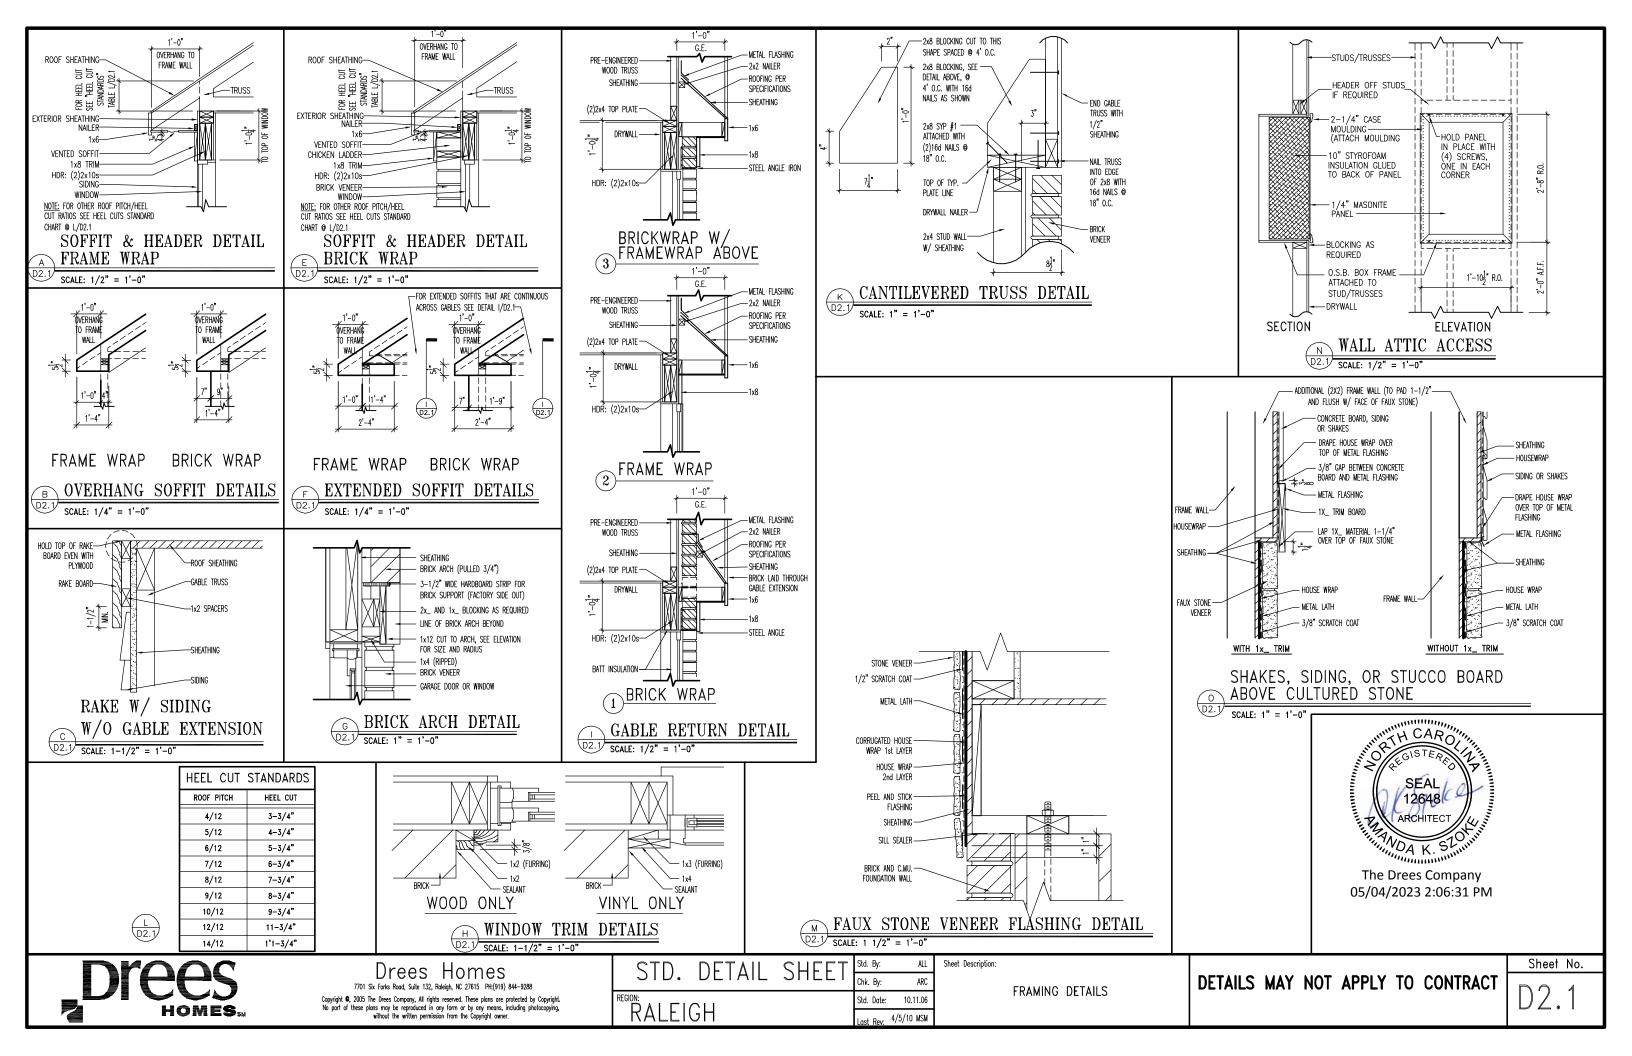
initial:

MULHERN+KULP
RESIDENTAL STRUCTURAL ENGINEERING
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9.779-771-2014 - multeminique com

LATERAL DETAILS Meadow Modei

SD-2



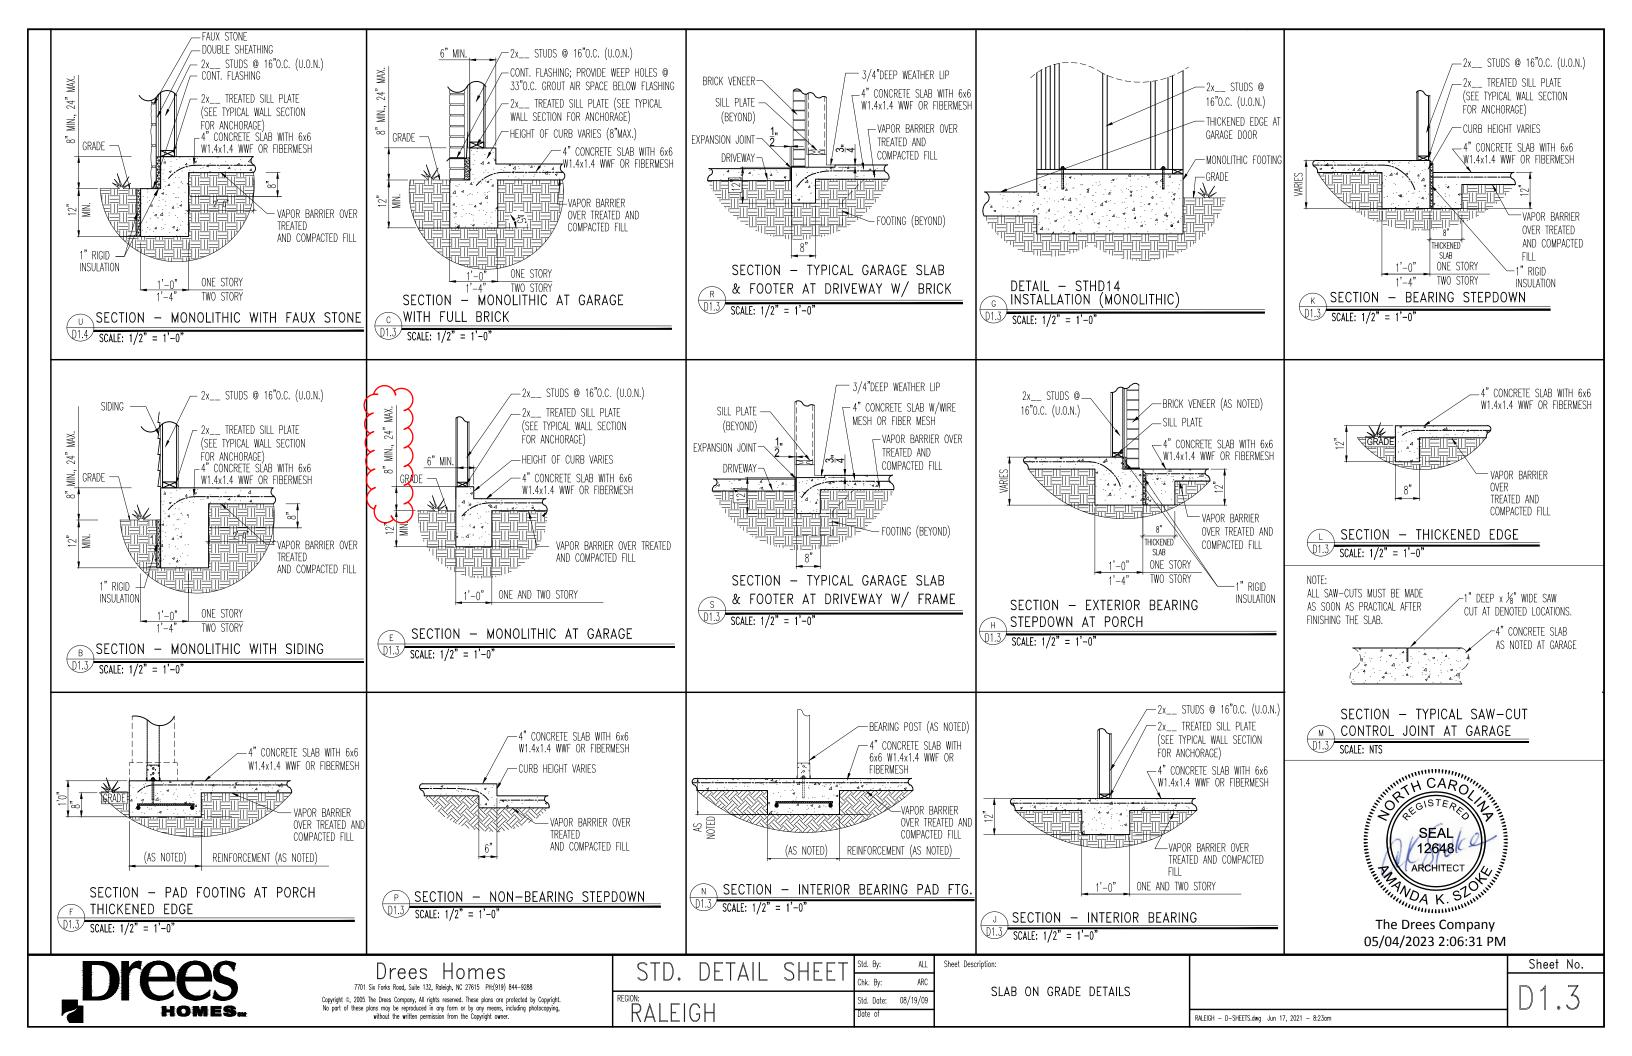




SEAL 12648 ARCHITECT

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D2.2






SINGLE TRAY CEILING DETAIL
D2.4 SCALE: 1/2" = 1'-0"

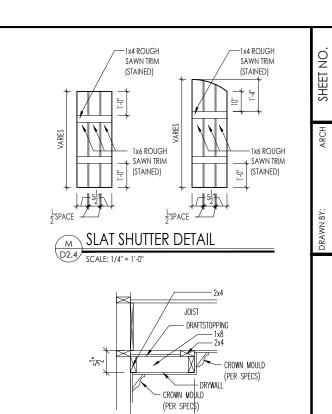1'-4"






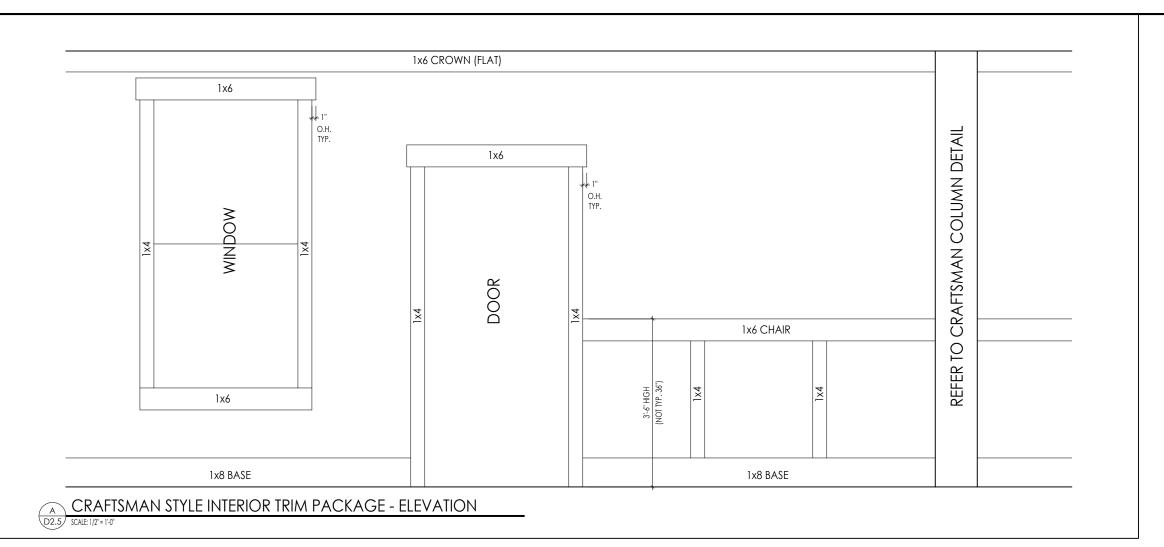


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D2.5



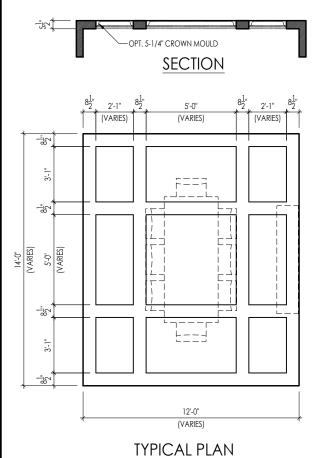

Note: Ceiling treatment details will tray down into space on enclosed rooms located on the 1st floor. On enclosed rooms on the 2nd floor, the ceiling treatment will tray up into the roof truss system. On 2-story spaces, the ceiling treatment will tray down into the space and require an appropriate sized header to capture the ceiling detail return.

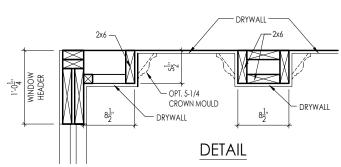
-8x8 BOX BEAM **SECTION** 7'-4" (VARIES) TYPICAL PLAN

On enclosed rooms on the 2nd floor, the ceiling treatment will tray up into the roof truss system. On 2-story spaces, the ceiling treatment will tray down into the space and require an appropriate sized header to capture the ceiling detail return.

Note: Ceiling treatment details will tray down into space on enclosed rooms located on the 1st floor.

-5-1/4" CROWN MOULD 5/8"x3/4" BASE MOULD


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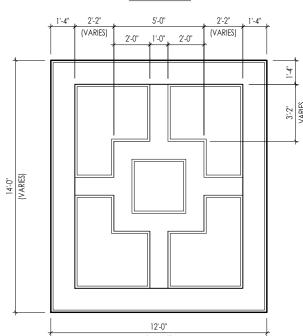


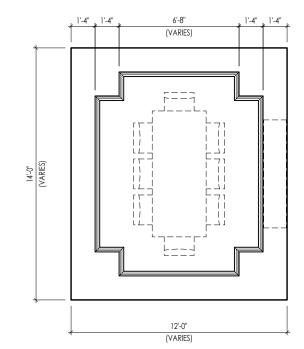TYPICAL PLAN



Note: Ceiling treatment details will tray down into space on enclosed rooms located on the 1st floor. On enclosed rooms on the 2nd floor, the ceiling treatment will tray up into the roof truss system. On 2-story spaces, the ceiling treatment will tray down into the space and require an appropriate sized header to capture the ceiling detail return.




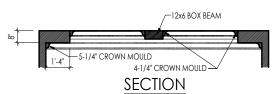

TYPICAL PLAN



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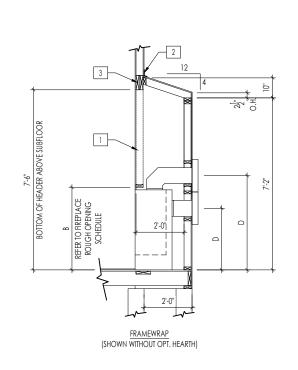


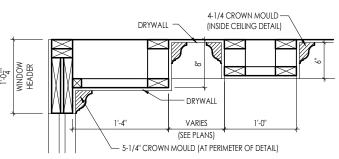
DETAIL

Note: Ceiling treatment details will tray down into space on enclosed rooms located on the 1st floor. On enclosed rooms on the 2nd floor, the ceiling treatment will tray up into the roof truss system. On 2-story spaces, the ceiling treatment will tray down into the space and require an appropriate sized header to capture the ceiling detail return.

CEILING TREATMENTS


SCALE: AS NOTED



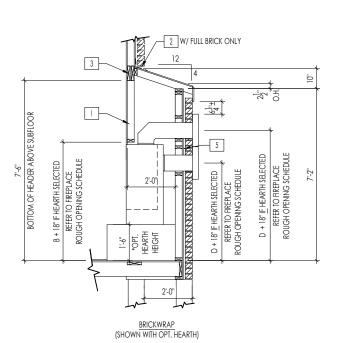


FIREPLACE DOGHOUSE SECTIONS

SCALE: 1/4" = 1'-0"

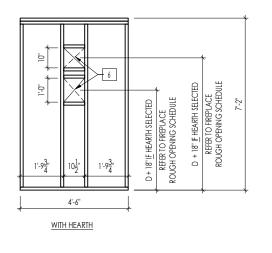

DIRECT VENT REAR WALL FRAMING

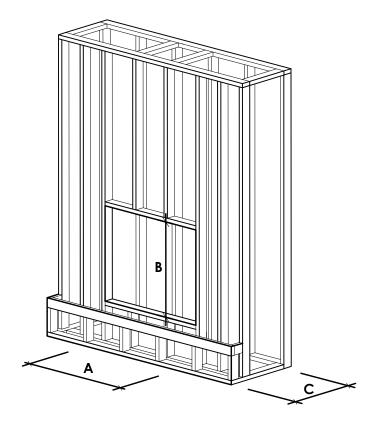

NOTE: PROVIDE OSB SHEATHING WHEN STONE VENEER SELECTED

| FIREPLACE ROUGH OPENING SCHEDULE | | | | | | | |
|----------------------------------|---------------------------|--------------------------|--|--|---|--|--|
| | MODEL | А | В | С | D | | |
| FIREPLACE MANUFACTURER | | (FIREBOX REQUIRED WIDTH) | (FIREBOX REQUIRED HEIGHT) *ADD 18" W/ OPT. HEARTH | (FIREBOX REQUIRED DEPTH - INTERIOR REAR WALL TO FRONT EXTERIOR WALL) | (VENT CENTERLINE HEIGHT) *ADD 18" W/ OPT. HEARTH | | |
| | SLIMLINE SL-7 | 42" | 38-1/4" | 16-1/4" | TOP 40" SIDE 26-7/8" | | |
| HEAT & GLO | COSMO 42 | 49" | 32-3/4" | 17-3/4" | TOP ONLY 47-1/16" | | |
| | | | | | | | |
| | COURTYARD 36 | 43-3/8" | 44-1/8" | 18-3/8" | SEE MANUFACTURER'S SPEC | | |
| HEARTH & HOME | COURTYARD 42 | 49-1/4" | 44-1/8" | 18-1/8" | SEE MANUFACTURER'S SPEC | | |
| | LANAI *(NOT IN CINCY/NKY) | 57-3/4" | 39-1/2" | 17-5/8" | SEE MANUFACTURER'S SPEC | | |
| | RAVE | 50" | 40-1/4" | 18-1/4" | TOP ONLY 46-1/2" | | |
| | | | all dimensions | are in inches | | | |



REFER TO SHEET ON.1 FOR GENERAL NOTES.
 VERIFY FIREPLACE MODEL AND HEARTH SELECTION WITH CUSTOMER'S SELECTIONS.

Key Notes

1 FUTURE FRAMING FOR F.P. OPENING AFTER INSULATION HAS BEEN INSTALLED IN EXT. WALLS

2 FLASHING

3 HEADER PER PLAN

4

5 1" AIRSPACE

6 BOX OUT FOR FLUE (REFER TO SELECTIONS FOR FIREPLACE AND OPENING HEIGHT)





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| Std. Drawn By: | MRPH | Sheet Description: | SCALE: VARIES |
|----------------------|-----------|---|---------------|
| | | FIREPLACE DETAIL | |
| Std. Date: | 02.29.20 | | |
| Date of Last Rev: | 7.21.2021 | g:\architecture\cincinnat\cinti standard drawings\fireplace\fireplace detail sheets.dwg | |

Sheet No.

F-1

RALEIGH WINDOW SCHEDULE

* MEETS EMERGENCY ESCAPE & RESCUE OPENING REQUIREMENTS

| | | MI Windows | and Doors | | | T | | | | OPENING REQUIREMENTS |
|--------------------------------------|--|--|------------------------------------|----------|---------------|--------------------------|----------|---------------|----------|----------------------|
| Drees General Callout | Window Type | Capitol Call No. | Series Rough Opening | Call No. | Rough Opening | Drees General Callout | Call No. | Rough Opening | Call No. | Rough Opening |
| 1660 | SINGLE/DOUBLE HUNG | CW3500 1/8 x 6/0 | | Call No. | Rough Opening | | Call No. | Kough Opening | Call No. | Kough Opening |
| 1670 | SINGLE/DOUBLE HUNG | CW3500 1/8 x 7/0 | 20" x 84" | | | | | | | |
| 1860 | SINGLE/DOUBLE HUNG | CW3500 1/8 x 6/0 | 20" x 60-1/4" | | | | | | | |
| 2030 2040 | SINGLE/DOUBLE HUNG SINGLE/DOUBLE HUNG | CW3500 2/0 x 3/0 CW3500 2/0 x 4/0 | 24 X 36 24" x 48" | | | | | | | |
| 2050 | SINGLE/DOUBLE HUNG | CW3500 2/0 x 5/0 | 24" x 60-1/4" | | | | | | | |
| 2060 | SINGLE/DOUBLE HUNG | CW3500 2/0 x 6/0 | 24" x 72" | | | | | | | |
| 2070 2430 | SINGLE/DOUBLE HUNG SINGLE/DOUBLE HUNG | CW3500 2/0 x 7/0 CW3500 2/4 x 3/0 | 24" X 84" 28" x 36" | | | | | | | _ |
| 2440 | SINGLE/DOUBLE HUNG | CW3500 2/4 x 4/0 | 28" x 48" | | | | | | | |
| 2450 | SINGLE/DOUBLE HUNG | CW3500 2/4 x 5/0 | 28" x 60-1/4" | | | | | | | |
| 2460 2830 | SINGLE/DOUBLE HUNG SINGLE/DOUBLE HUNG | CW3500 2/4 x 6/0 CW3500 2/8 x 3/0 | 28 X /2 32" x 36" | | | | | | | |
| 2840 | SINGLE/DOUBLE HUNG | CW3500 2/8 x 4/0 | 32" x 48" | | | | | | | |
| 2850 | SINGLE/DOUBLE HUNG | CW3500 2/8 x 5/0 | 32" x 60-1/4" | | | | | | | |
| * 2860 3030 | SINGLE/DOUBLE HUNG SINGLE/DOUBLE HUNG | CW3500 2/8 x 6/0 | 32" X /2" 36-1/4" v 36" | | | | | | | |
| 3040 | SINGLE/DOUBLE HUNG | CW3500 3/0 x 3/0 CW3500 3/0 x 4/0 | 36-1/4" x 48" | | | | | | | |
| * 3050 | SINGLE/DOUBLE HUNG | I CW3500 3/0 x 5/0 | I 36-1/4" x 60-1/4"I | | | | | | | |
| * 3060 * 3070 | SINGLE/DOUBLE HUNG SINGLE/DOUBLE HUNG | CW3500 3/0 x 6/0 CW3500 3/0 x 7/0 | | | | | | | | |
| * 3470 | SINGLE/DOUBLE HUNG | CW3500 3/0 x 7/0 | 40" x 84" | | | | | | | |
| 1050 FIXED | | 910T 5/0 x 1/0 | 59-5/8" x 11-1/2" | | | | | | | |
| 1640 FIXED 2020 FIXED | | 910T 4/0 x 1/8 CW3500 2/0 x 2/0 | 47-1/4" x 19-1/2" | | | | | | | |
| 2030 FIXED | | CW3500 2/0 x 2/0 CW3500SL 2/0 x 3/ | 0 24" x 36" | | | | | | | |
| 2040 FIXED | | CW3500SL 2/0 x 4/ | 0 24" x 48" | | | | | | | |
| 2050 FIXED | | CW3500SL 2/0 x 5/ | | | | | | | | |
| 2816 FIXED 2860 FIXED | | 910TSL 2/6 x 1/8 CW3500 3/0 x 6/0 | 29-1/4" x 19-1/2" 36" x 72" | | | | | | | |
| 3016 FIXED | | 910TSL 3/0 x 1/8 | 35-1/4" x 19-1/2" | | | | | | | |
| 3020 FIXED | | 910TSL 3/0 x 2/0 | 35-1/4" x 23-1/2" | | | | | | | |
| 3030 FIXED 3040 FIXED | | CW3500P 3/0 x 3/0 CW3500P 3/0 x 4/0 | 36-1/4 X 36 36-1/4" x 48" | | | | | | | |
| 3050 FIXED | | CW3500P 3/0 x 5/0 | 36-1/4" x 60-1/4" | | | | | | | |
| 3060 FIXED | | CW3500P 3/0 x 6/0 | 36-1/4" x 72" | | | | | | | |
| 3070 FIXED 4010 FIXED | | CW3500P 3/0 x 7/0 910T 4/0 x 1/0 | 36-1/4 X 84 47-1/4" x 11-1/2" | | | | | | | |
| 4020 FIXED | | 910T 4/0 x 2/0 | 47-1/4" x 23-1/2" | | | | | | | |
| 4030 FIXED | | CW3500P 4/0 x 3/0 | 48" x 36" | | | | | | | |
| 4040 FIXED 4044 FIXED | | CW3500P 4/0 x 4/0 CW3500P 4/0 x 4/4 | 48 X 48 48" x 52" | | | | | | | |
| 4050 FIXED | | CW3500P 4/0 x 5/0 | 48" x 60-1/4" | | | | | | | |
| 4060 FIXED | | CW3500P 4/0 x 6/0 | 48" x 72" | | | | | | | |
| 4070 FIXED 5030 FIXED | | CW3500P 4/0 x 7/0 CW3500P 5/0 x 3/0 | | | | | | | | |
| 5040 FIXED | | CW3500P 5/0 x 4/0 | 60" x 48" | | | | | | | |
| 5060 FIXED | | CW3500P 5/0 x 6/0 | 60" x 72" | | | | | | | |
| 5070 FIXED 6020 FIXED | | CW3500P 5/0 x 7/0 910T 6/0 x 2/0 | 60" x 84" 71-5/8" x 23-1/2" | | | | | | | |
| 6050 FIXED | | CW3500P 6/0 x 5/0 | 72" x 60-1/4" | | | | | | | |
| 6060 FIXED | | CW3500P 6/0 x 6/0 | 72" x 72" | | | | | | | |
| 3'-0" HALF ROUNI 4'-0" HALF ROUNI | | CW3500 3/0 HC CW3500 3/0 HC | 36-1/4" 48" | | | | | | | |
| 5'-0" HALF ROUNI |) | CW3500 3/0 HC | 60" | | | | | | | |
| 2020 OCTAGON | | CW3500 2/0 OCT | 60" | | | | | | | |
| 2'-4" QUARTER RO 3'-0" QUARTER RO | | CW3500 2/4 QC CW3500 3/0 QC | 28" 36-1/4" | | | | | | | |
| J-0 QUARTER RO | סאטע | CW3300 3/0 QC | J 20-1/7 | | | | | | | |
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Drees Homes

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Sheet Description:

WINDOW SCHEDULE

Sheet No.

MOULDED MILLWORK SCHEDULE

| LAST REVISED 11/22/11 |
|-----------------------|
|-----------------------|

| | HEADERS | |
|------------------------|--------------|----------------|
| Drees General Callout | Nuwood | Fypon |
| ARCHED HEADER D1 | H8xxEFR | N/A |
| ARCHED HEADER D1K | H8xxEFKR | N/A |
| ARCHED HEADER D2 | H8xxEFTR | N/A |
| ARCHED HEADER D2K | H8xxEFTKR | N/A |
| ARCHED HEADER D3 | AH10xx | WCHSEGxxX10 |
| ARCHED HEADER D3K | N/A | WCHSEGxxX10K |
| ARCHED HEADER D4 | AR5xx | ARxxX6M |
| ARCHED HEADER D4K | AR5xxK | ARxxX6MK |
| ARCHED HEADER D5 | AR10xxEC | ARxxX6METAR6C |
| ARCHED HEADER D5K | AR10xxECK | ARxxX6METAR6CK |
| ARCHED HEADER D6 | AR10xxC | ARxxX10MC |
| ARCHED HEADER D6K | AR10xxCK | ARxxX10MCK |
| ARCHED HEADER D7K | H7xxEF-4K | N/A |
| ARCHED HEADER D8 | AR14xxC | ARxxX14MC |
| ARCHED HEADER D8K | AR14xxCK | ARxxX14MCK |
| ARCHED HEADER D9 | H9xxE | WCHARSxx13 |
| CROSSHEAD A1 | H9xx | WCHxxX9N |
| CROSSHEAD A1K | H9xxK | WCHxxX9NK |
| CROSSHEAD B1 | H14xxBT | WCHxxX14BT |
| CROSSHEAD B1K | H14xxBTK | WCHxxX14BTK |
| CROSSHEAD B2 | H12xx | WCHxxX12 |
| CROSSHEAD B2K | H12xxK | WCHxxX12K |
| CROSSHEAD C1 | H18xxBT | WCHxxX14BT |
| CROSSHEAD C1K | H18xxBTK | WCHxxX14BTK |
| CROSSHEAD C2 | H18xxBT-PA | LDCHxxX18 |
| CROSSHEAD C2K | H18xxBTK-PA | LDCHxxX18K |
| CROSSHEAD Z-E1-HDR | Z-E1-HDR | Z-E1-HDR |
| CROSSHEAD Z-E2-HDR | Z-E2-HDR | Z-E2-HDR |
| CROSSHEAD Z-E3-HDR | Z-E3-HDR | Z-E3-HDR |
| CROSSHEAD Z-E3-ARCHHDR | Z-E3-ARCHHDR | Z-E3-ARCHHDR |
| CROSSHEAD Z-E3-CLHDR | Z-E3-CLHDR | Z-E3-CLHDR |
| CROSSHEAD Z-E5-HDR | Z-E5-HDR | Z-E5-HDR |
| WINDOW HEADER A1 | H6xx | WCHxxX6 |
| WINDOW HEADER A1K | H6xxK | WCHxxX6K |
| WINDOW HEADER B1 | H9xx-2 | WCHxxX9N |
| WINDOW HEADER B1K | H9xx-2K | WCHxxX9NK |
| WINDOW HEADER B2 | H9xxBT | WCHxxX10NBT |
| WINDOW HEADER B2K | H9xxBTK | WCHxxX10NBTK |
| WINDOW HEADER C1 | H9xx | CCAxxX10 |
| WINDOW HEADER C1K | H9xxK | CCAxxX10K |
| WINDOW HEADER C2 | H9xxT | WCHxxX9T |
| WINDOW HEADER C2K | H9xxTK | WCHxxX9TK |
| WINDOW HEADER C3 | H12xxBT | WCHxxX10BT |
| WINDOW HEADER C3K | H12xxBTK | WCHxxX10BTK |
| WINDOW HEADER C4 | H14xxBT | WCHxxX14BT |
| WINDOW HEADER D1 | H7xxF-4 | N/A |
| WINDOW HEADER DIK | H7xxF-4K | N/A |
| WINDOW HEADER D2K | H9xxK-1 | N/A |
| WINDOW HEADER Z-W1 | Z-W1 | Z-W1 |
| WINDOW HEADER Z-W3 | Z-W3 | Z-W3 |
| WINDOW HEADER Z-W3K | Z-W3K | Z-W3K |
| WINDOW HEADER Z-W3D | Z-W3D | Z-W3D |
| WINDOW HEADER Z-W4 | Z-W4 | Z-W4 |
| WINDOW HEADER Z-W4K | Z-W4K | Z-W4K |
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| PILASTERS | | | | | |
|-----------------------|-----------|----------------------------|--|--|--|
| Drees General Callout | Nuwood | Fypon | | | |
| FLUTED PILASTER A1 | PL7xxF | PIL7Xxx | | | |
| FLUTED PILASTER B1 | PL9xxF | PIL9Xxx | | | |
| FLUTED PILASTER C1 | PL11xxFM | PIL11Xxx | | | |
| Panel Pilaster A2 | PL7xxP | PIL7XxxDP | | | |
| PANEL PILASTER B2 | PL9xxP | PIL9XxxDP | | | |
| Panel Pilaster C2 | PL11xxPM | PIL11XxxDP | | | |
| PILASTER D1 | M311-9 | PIL10XxxA | | | |
| PILASTER D2 | M323-9 | N/A | | | |
| PILASTER Z-E1-PIL | Z-E1-PIL | Z-E1-PlL | | | |
| PILASTER Z-E2-PIL | Z-E2-PIL | Z-E2-PIL | | | |
| PILASTER Z-E3-PIL | Z-E3-PIL | Z-E3-PIL | | | |
| PILASTER Z-PIL-EXT | Z-PIL-EXT | Z-PIL-EXT | | | |
| PLAIN PILASTER A3 | PL7xxS | PIL7XxxP | | | |
| PLAIN PILASTER B3 | PL9xxS | PIL9XxxP | | | |
| PLAIN PILASTER C3 | PL11xxS | PIL11XxxP | | | |
| PLINTH D1 | PF10 | ADD "P" TO END OF PILASTER | | | |
| PLINTH D2 | P14.5 | N/A | | | |
| | LOUVERS | | | | |

| Drees General Callout | Nuwood | Fypon | Mid-America |
|------------------------|--------------|-------------|-------------|
| CATHEDRAL LOUVER D1 | CLV1224 | CLV12X24 | |
| CATHEDRAL LOUVER D1T | CLV1224TRIM4 | CLV12X24X4F | |
| CATHEDRAL LOUVER D2 | CLV1432 | CLV14X32 | |
| CATHEDRAL LOUVER D2T | CLV1432TRIM4 | CLV14X32X4F | 00 44 1422 |
| CATHEDRAL LOUVER D3 | CLV2232 | CLV22X32 | |
| CATHEDRAL LOUVER D3T | CLV2232TRIM4 | CLV22X32X4F | |
| HALF CIRCLE LOUVER D1 | HRLV32 | HRLV32X16 | |
| HALF CIRCLE LOUVER D1T | HRLV32TRIM4 | HRLV32X4F | |
| HALF CIRCLE LOUVER D2 | HRLV36 | HRLV36X18 | |
| HALF CIRCLE LOUVER D2T | HRLV36TRIM4 | HRLV36X4F | 00 43 2234 |
| OCTAGONAL LOUVER D1 | OLV24 | OLV24 | |
| OCTAGONAL LOUVER D12 | OLV24TRIM4 | OLV24X4F | |
| OVAL LOUVER D1 | OLV2537 | OLV37X25 | |
| OVAL LOUVER DIT | OLV2537TRIM4 | OLV37X25X4F | |
| RECTANGUAR LOUVER D1 | LV1224V | LV12X24 | 00 45 1218 |
| RECTANGUAR LOUVER D1T | LV1224VTRIM4 | LV12X24-4F | 00 45 1218 |
| RECTANGUAR LOUVER D2 | LV1636V | LV16X36 | |
| RECTANGUAR LOUVER D2T | LV1636VTRIM4 | LV16X36-4F | |
| RECTANGUAR LOUVER D3 | LV2436V | LV24X36 | |
| RECTANGUAR LOUVER D3T | LV2436VTRIM4 | LV24X36-4F | |
| RECTANGUAR LOUVER D4 | LV2424V | LV24X24 | |
| RECTANGUAR LOUVER D4T | LV2424VTRIM4 | LV24X24-4F | |
| ROUND LOUVER D1 | RLV18 | RLV18 | |
| ROUND LOUVER D1T | RLV18TRIM4 | RLV18X4F | |
| ROUND LOUVER D2 | RLV22 | RLV22 | |
| ROUND LOUVER D2T | RLV22TRIM4 | RLV22X4F | |
| TRIANGULAR LOUVER D1 | | TRLVxxX36 | 00 47 0x0x |
| <u> </u> | | 1 | |

BRACKETS

| Drees General Callout | Nuwood | Fypon |
|-----------------------|-------------------|-----------------------------|
| EXTERIOR BRACKET D1 | BR437 | N/A |
| EXTERIOR BRACKET D2 | DB102 | DTLB6X4X6 |
| EXTERIOR BRACKET D3 | BR304 (7" WIDE) | BKT24X24X7 |
| EXTERIOR BRACKET D4 | BR455 | N/A |
| EXTERIOR BRACKET D5 | BR300-1 | BKT12X12X6 |
| EXTERIOR BRACKET D6 | BR300 | BKT12X12 |
| EXTERIOR BRACKET D7 | BR409 | BKT16X18X3 |
| EXTERIOR BRACKET D8 | BR413 | DTLB5X5X3 |
| EXTERIOR BRACKET D9 | TBD | BKT11X20 |
| EXTERIOR BRACKET D10 | TBD | BKT12X24X3 |
| EXTERIOR BRACKET D11 | BR435 | BKT25X27 |
| EXTERIOR BRACKET D12 | BR404 | BKT16X30X4 |
| EXTERIOR BRACKET D13 | BR23.13x10.13x5.5 | N/A |
| GABLE BRACKET D1 | TBD | DTLB6X4X6R(OR L)PITCH |
| GABLE BRACKET D2 | BR423-x:12 | BKT5X20 |
| GABLE BRACKET D3 | BR424-x:12 | BKT5X20 (CUT 2" PROJECTION) |
| | | • |

| MOULDINGS | | | | | |
|-----------------------|--------------|-----------|--|--|--|
| Drees General Callout | Nuwood | Fypon | | | |
| BAND MOULD D1 | M210-16 | MLD612-12 | | | |
| BAND MOULD D2 | M301-16 | MLD220-16 | | | |
| BARGE MOULD D1 | WM210 | WM210 | | | |
| CASE MOULD D1 | M320-16 | MLD226-16 | | | |
| CASE MOULD D2 | N/A | MLD244-12 | | | |
| CROWN MOULD D1 | M404-16 | MLD572-16 | | | |
| DENTIL MOULD D1 | M105-16 | MLD310-16 | | | |
| DENTIL MOULD D2 | M108-8 | MLD353-8 | | | |
| HALF ROUND MOULD D1 | N/A | MLD605-12 | | | |
| PANEL MOULD D1 | M310-8 OR 16 | MLD612-12 | | | |
| | | | | | |

PEDIMENTS / COMBO HEADERS

| Drees General Callout | Nuwood | Fypon |
|------------------------|---------------------------------------|--------------------|
| BROW COMBO D1 | BCxx | CSAPxx |
| PEAK PEDIMENT D1 | Pxx-4 (6:12) | PCPxx |
| PEAK PEDIMENT Z-E1-PED | Z-E1-PED | Z-E1-PED |
| PEAKED COMBO D1 | PCxx-4 | CPCPxx |
| RAMS HEAD PEDIMENT D1 | Rxx | RHPxx00 |
| ROUND PEDIMENT D1 | Bxx-4 | PSPxx |
| SUNRISE COMBO D1 | SCxx-4 | CSPxx |
| VICTORIAN PEDIMENT D1 | VPxx | DVPxx w/ SWDHxxXxx |
| | · · · · · · · · · · · · · · · · · · · | |

WINDOW DECORATION

| Drees General Callout | Nuwood | Fypon |
|-------------------------|----------------------|--------------------------|
| HALF CIRCLE SUNBURST D1 | SPxxxx | SWDHxxXxx |
| PALLADIAN WINDOW D1 | H9AR10-xx xx" FL/FR | ARxxX10MFLxxx |
| PALLADIAN WINDOW D1K | H9AR10-xxK xx" FL/FR | ARxxX10MFLxxx with K10TM |
| PALLADIAN WINDOW D2 | H9AR10SPxxxx | ARxxX10MFLxxx with |
| | | SWDHxxXxx |
| PALLADIAN WINDOW D2K | H9AR10SPxxxxK | ARxxX10MFLxxx with |
| | | SWDHxxXxx and K10TM |
| PEAKED CAP HEADER D1 | N/A | CHPCxxX15 |
| PLAIN SEGMENT D1 | SPxxxxP | PSPxx |
| SEGMENT SUNBURST D1 | SPxxxx | SWDHxxXxx |
| | | |

ACCESSORIES

| Drees General Callout | Nuwood | Fypon |
|-----------------------|---------|----------------------|
| GABLE D1 | PGDx12 | GPA (width X height) |
| KEYSTONE D1 | KY14F-3 | KY14 |
| KEYSTONE D2 | KYHM9F | К9М |
| WREATH D1 | N/A | WAB34 |
| | | |



MOULDED MILLWORK SCHEDULE

Sheet No.