

23-281
DATE
BY
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DATE
BY

REVISIONS	
No.	Remarks

9101 Ten-Ten Rd.
Raleigh, NC 27603
Office: (919) 302-0693




1253
Single Car

Signature Homes
1209 N Main Street
Lillington, NC 27546

ELEVATIONS
Sheet Number
1
of 2



FRONT ELEVATION 'B'
1/4" = 1'-0"

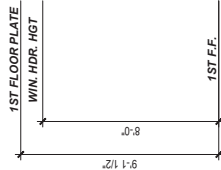

CRAWL SPACE VENTILATION CALCULATIONS

-VENT LOCATIONS MAY VARY FROM THOSE SHOWN ON THE PLAN BUT SHOULD BE PLACED TO PROVIDE ADEQUATE VENTILATION AT ALL POINTS TO PREVENT DEAD AIR POCKETS.
-100% VAPOR BARRIER MUST BE PROVIDED WITH 12" MIN. LAP JOINTS.

-THE TOTAL AREA OF VENTILATION OPENINGS MAY BE REDUCED TO 1/1500 AS LONG AS REQUIRED OPENINGS ARE PLACED SO AS TO PROVIDE CROSS-VENTILATION OF THE SPACE.
-THE INSTALLATION OF OPERABLE LOUVERS SHALL NOT BE PROHIBITED. (COMPLY WITH NC CODE MIN. WITH REGARD TO VENT PLACEMENT FROM CORNERS)

1253	SQ. FT. OF CRAWL SPACE/1500
0.84	SQ. FT. OF REQUIRED VENTILATION
PROVIDED BY: 4	VENTS AT 0.45 SQ. FT. NET FREE
VENTILATION EACH= 1.8	SQ. FT. OF VENTILATION

****FOUNDATION DRAINAGE- WATERPROOFING PER SECTIONS 405 & 406.**

ATTIC VENTILATION CALCULATIONS

-CALCULATIONS SHOWN BELOW ARE BASED ON VENTILATORS USED AT LEAST 3 FT. ABOVE THE CORNICE VENTS WITH THE BALANCE OF VENTILATION PROVIDED BE GABLE VENTS.
-CATHEDRAL CEILINGS SHALL HAVE A MIN. 1" CLEARANCE BETWEEN THE BOTTOM OF THE ROOF DECK AND THE INSULATION.

1.651	SQ. FT. OF ATTIC/500*
5.50	EACH OF INLET AND OUTLET REQUIRED.

****WALL AND ROOF CLADDING DESIGN VALUES**

-WALL CLADDING IS DESIGNED FOR A 24.1 SQ. FT. OR GREATER POSITIVE AND NEGATIVE PRESSURE.
-ROOF VALUES BOTH POSITIVE AND NEGATIVE SHALL BE AS FOLLOWS:
45.5 LBS. PER SQ. FT. FOR ROOF PITCHES OF 0/12 TO 2.25/12
34.8 LBS. PER SQ. FT. FOR ROOF PITCHES OF 2.25/12 TO 7/12
21 LBS. PER SQ. FT. FOR ROOF PITCHES OF 7/12 TO 12/12

**** MEAN ROOF HEIGHT 30' OR LESS**


GENERAL NOTES:

- IT IS THE CONTRACTORS RESPONSIBILITY TO VERIFY THAT ALL DIMENSIONS, ROOF PITCHES, AND SQUARE FOOTAGE ARE CORRECT PRIOR TO CONSTRUCTION. K&A HOME DESIGNS, INC. IS NOT RESPONSIBLE FOR ANY DIMENSIONING, ROOF PITCH, OR SQUARE FOOTAGE ERRORS ONCE CONSTRUCTION BEGINS.
- ALL WALLS SHOWN ON THE FLOOR PLANS ARE DRAWN AT 4" UNLESS NOTED OTHERWISE.
- ALL ANGLED WALL SHOWN ON THE PLANS ARE 45 DEGREES UNLESS NOTED OTHERWISE.
- STUD WALL DESIGN SHALL CONFORM TO ALL NORTH CAROLINA STATE BUILDING CODE REQUIREMENTS.
- DO NOT SCALE PLANS. DRAWING SCALE MAY BE DISTORTED DUE TO COPIER IMPERFECTIONS.
- ALL CONSTRUCTION SHALL BE IN ACCORDANCE WITH NORTH CAROLINA RESIDENTIAL STATE BUILDING CODE, 2018 EDITION.


SQUARE FOOTAGE

HEATED SQUARE FOOTAGE	UNHEATED SQUARE FOOTAGE
FIRST FLOOR= 1253	GARAGE= 286
SECOND FLOOR= N/A	FRONT PORCH= 25
THIRD FLOOR= N/A	SCREEN PORCH= N/A
BASEMENT= N/A	DECK= N/A
	STORAGE= N/A


TOTAL HEATED= 1253 TOTAL UNHEATED= N/A

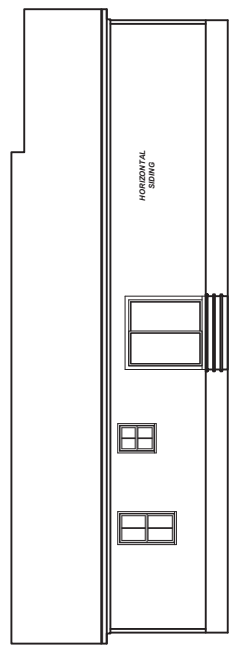


REAR ELEVATION 'B'
1/8" = 1'-0"

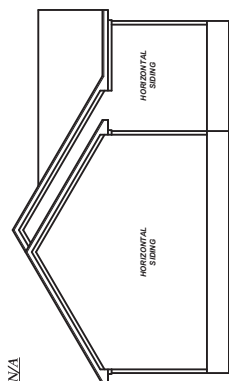

LEFT ELEVATION 'B'
1/8" = 1'-0"

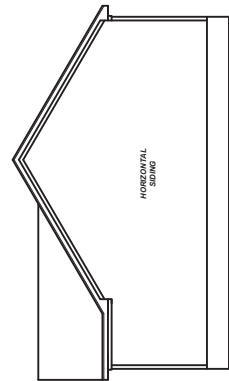

RIGHT ELEVATION 'B'
1/8" = 1'-0"

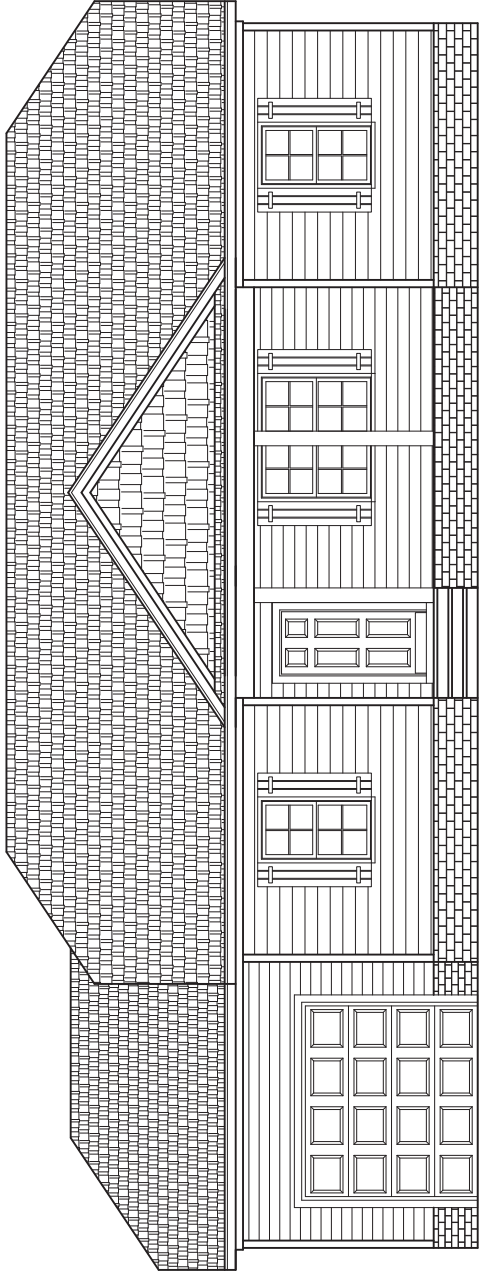

FRONT ELEVATION 'C'

1/4" = 1'-0"

CRAWL SPACE VENTILATION CALCULATIONS

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1.253	SQ. FT. OF CRAWL SPACE/1500	
0.84	SQ. FT. OF REQUIRED VENTILATION	
PROVIDED BY:	4	VENTS AT 0.45 SQ. FT. NET FREE
VENTILATION EACH	1.8	SQ. FT. OF VENTILATION

****FOUNDATION DRAINAGE- WATERPROOFING PER SECTIONS 405 & 406.**

ATTIC VENTILATION CALCULATIONS

-CALCULATIONS SHOWN BELOW ARE BASED ON VENTILATORS USED AT LEAST 3 FT. ABOVE THE CORNICE VENTS WITH THE BALANCE OF VENTILATION PROVIDED BE GABLE VENTS.
 -CATHEDRAL CEILINGS SHALL HAVE A MIN. 1" CLEARANCE BETWEEN THE BOTTOM OF THE ROOF DECK AND THE INSULATION.

1.651	SQ. FT. OF ATTIC/500*	5.50
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EACH OF INLET AND OUTLET REQUIRED.

****WALL AND ROOF CLADDING DESIGN VALUES**

-WALL CLADDING IS DESIGNED FOR A 24.1 SQ. FT. OR GREATER POSITIVE AND NEGATIVE PRESSURE.

-ROOF VALUES BOTH POSITIVE AND NEGATIVE SHALL BE AS FOLLOWS:

45.5 LBS. PER SQ. FT. FOR ROOF PITCHES OF 0/12 TO 2.25/12

34.8 LBS. PER SQ. FT. FOR ROOF PITCHES OF 2.25/12 TO 7/12

21 LBS. PER SQ. FT. FOR ROOF PITCHES OF 7/12 TO 12/12

**** MEAN ROOF HEIGHT 30' OR LESS**

GENERAL NOTES:


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SQUARE FOOTAGE

HEATED SQUARE FOOTAGE	UNHEATED SQUARE FOOTAGE
FIRST FLOOR= 1253	GARAGE= 286
SECOND FLOOR= N/A	FRONT PORCH= 25
THIRD FLOOR= N/A	SCREEN PORCH= N/A
BASEMENT= N/A	DECK= N/A
	STORAGE= N/A


TOTAL HEATED= 1253

TOTAL UNHEATED= N/A

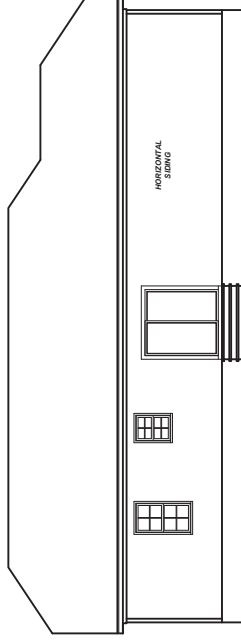


REAR ELEVATION 'C'

1/8" = 1'-0"

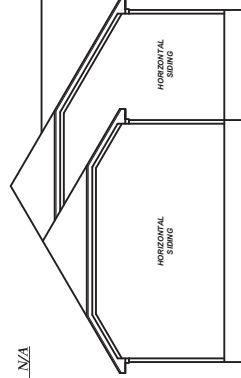

LEFT ELEVATION 'C'

1/8" = 1'-0"

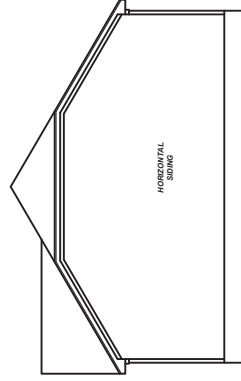

RIGHT ELEVATION 'C'

1/8" = 1'-0"

23-281
Rev. 1/23
Project No. 23-281
Client Name: KBB
Design: REFER TO ELEV.

REV. NO.	DATE	REVISIONS



9101 Ten-Ten Rd.
Raleigh, NC 27603
Office: (919) 302-0693



1253
Single Car

Signature Homes
1209 N Main Street
Lillington, NC 27546

ELEVATIONS
Sheet Number
1
of 2

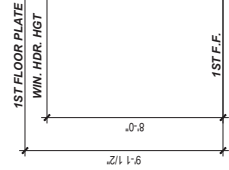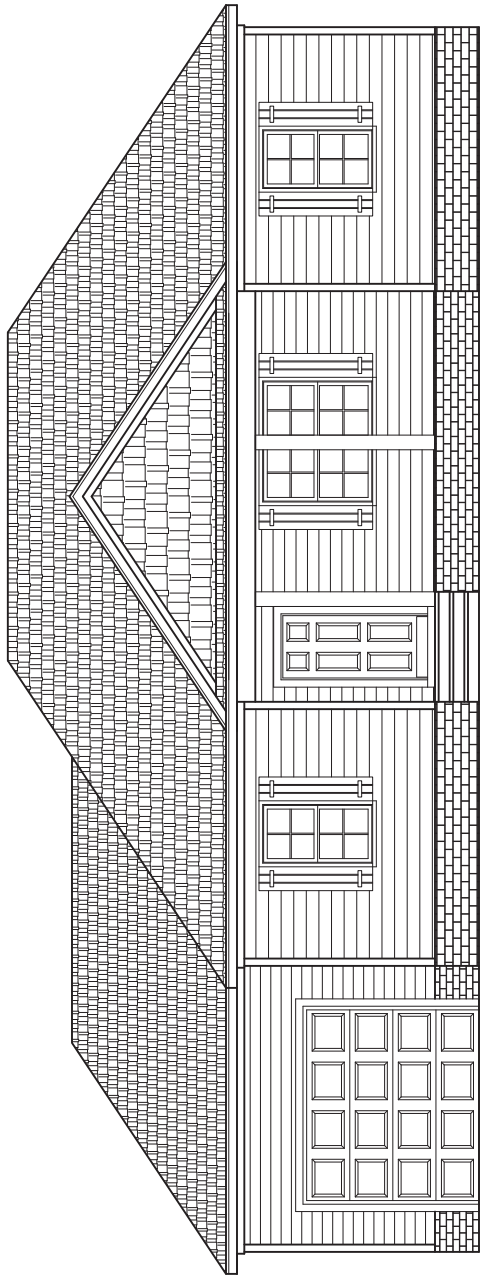

FRONT ELEVATION 'D'
1/4" = 1'-0"

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0.84	SQ. FT. OF REQUIRED VENTILATION
PROVIDED BY: 4	VENTS AT 0.45 SQ. FT. NET FREE
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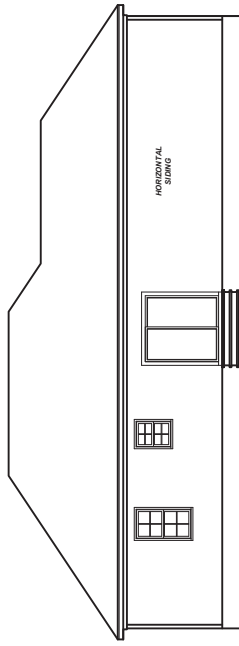
1651	SQ. FT. OF ATTIC/500*
5.50	

EACH OF INLET AND OUTLET REQUIRED.

***WALL AND ROOF CLADDING DESIGN VALUES**


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**** MEAN ROOF HEIGHT 30' OR LESS**




REAR ELEVATION 'D'
1/8" = 1'-0"

SQUARE FOOTAGE	UNHEATED SQUARE FOOTAGE
HEATED SQUARE FOOTAGE	1253
FIRST FLOOR=	N/A
SECOND FLOOR=	N/A
THIRD FLOOR=	N/A
BASEMENT=	N/A
GARAGE=	286
FRONT PORCH=	25
SCREEN PORCH=	N/A
DECK=	N/A
STORAGE=	N/A
TOTAL HEATED=	1253
TOTAL UNHEATED=	N/A

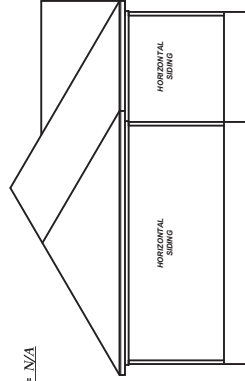

LEFT ELEVATION 'D'
1/8" = 1'-0"

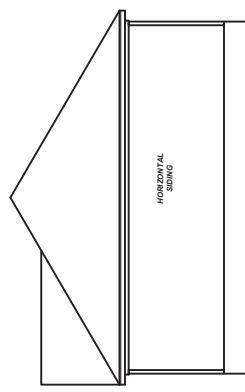

RIGHT ELEVATION 'D'
1/8" = 1'-0"

NO. 23-281
DATE 01.23
DESIGNED BY KBB
DRAWN BY KBB
SCALE 1/4" = 1'-0"

REVISIONS	
No.	Remarks


9101 Ten-Ten Rd.
 Raleigh, NC 27603
 Office: (919) 302-0693
K&A HOME DESIGN INC.
 Email: Kent@KandAHomeDesigns.com Website: www.KandAHomeDesigns.com

1253
 Single Car

Signature Homes
 1209 N Main Street
 Lillington, NC 27546

FLOOR PLAN
 Sheet Number
2
 of 2

FIRST FLOOR PLAN
ELEV. 'B', 'C', & 'D'
 1/4" = 1'-0" CEILING HT. = 9'-0"
 THIS OPTION ADDS 112SF

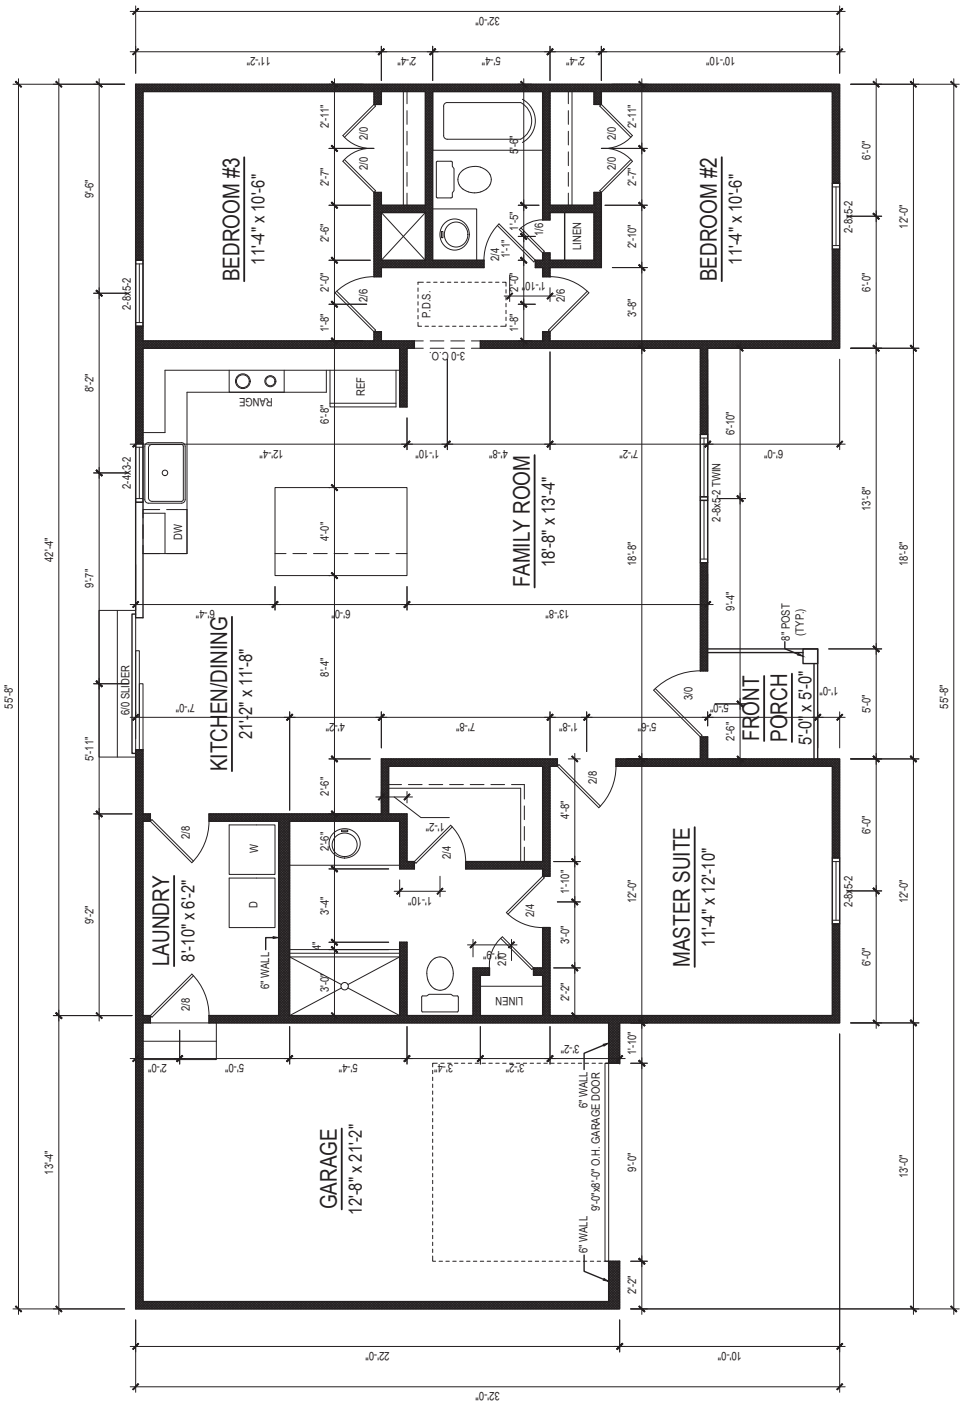

FIRST FLOOR PLAN
 1/4" = 1'-0" CEILING HT. = 9'-0"

