REVISION LOG REVISION:DO1 DATE: 6/20/2022 1. ADD SIDE LOAD GARAGE. REVISION:DO2 DATE: 7/05/2022 1. ADD OPT. EXTENDED CAFE W/ COVERED PATIO/DECK.

1. ADD STEM WALL SLAB FOUNDATION SHEETS

REVISION:003

Lot 22 WS - 124 Village Drive Fuquay - Varina, NC 27526

NC.



DESIGN CRITERIA:

THIS PLAN IS TO BE BUILT IN CONFORMANCE WITH THE 2018 NORTH CAROLINA STATE BUILDING CODE: RESIDENTIAL CODE

DIMENSIONS SHALL GOVERN OVER SCALE, AND CODE SHALL GOVERN OVER DIMENSIONS.

2010 Smithfield - RH

'FRENCH COUNTRY' ELEVATION

eet No.	Sheet Description							
0.0	Cover Sheet							
1.1	Foundation (Slab)							
1.1.1	Foundation Options (Slab)							
1.1.2	Foundation Options (Slab)							
1.2	Foundation (Crawl) Foundation Options (Crawl)							
1.2.1	Foundation Options (Crawl)							
1.2.2	Foundation (Stem Wall Slab))							
1.3	, , , , , , , , , , , , , , , , , , , ,							
1.3.1	Foundation Options (Stem Wall Slab)							
1.3.2	Foundation Options (Stem Wall Slab)							
2.1	First Floor Plan							
2.1.1	First Floor Plan Options							
2.2	Second Floor Plan							
2.2.1	Second Floor Plan Options							
2.3	Opt. Third Floor							
2.4	Covered Patio Plans & Elevations (Slab)							
2.4.1	Covered Deck Plans & Elevations (Crawl)							
2.5	Extended Cafe Elevations & Roof Plan (Slab)							
2.5.1	Extended Cafe Elevations & Roof Plan (Crawl)							
2.6	Extended Cafe w/ Covered Patio Elevations & Roof Plan (Slab)							
2.6.1	Extended Cafe w/ Covered Deck Elevations & Roof Plan (Crawl)							
2.7	2-Car Sideload Garage Plans							
2.7.1	2-Car Sideload Garage Elevations							
3.1	Front & Rear Elevations (Slab)							
3.1.1	Front & Rear Elevations (Crawl)							
3.1.2	Front & Rear Elevations (Slab) Attic Option							
3.1.3	Front & Rear Elevations (Crawl) Attic Option							
3.2	Side Elevations (Slab)							
3.2.1	Side Elevations (Crawl)							
3.2.2	Side Elevations (Slab) Attic Option							
3.2.3	Side Elevations (Crawl) Attic Option							
3.3	Roof Plan							
5.1	First Floor Flectrical							
5.2	Second Floor Electrical							
5.2.1	Second Floor Options Electrical							
5.2.1	Opt. Third Floor Electrical							

SQUARE	FOOT	AGE			
	FRENCH COUNTRY				
	UNHEATED	HEATED			
FIRST FLOOR	0	846			
SECOND FLOOR	0	1164			
FRONT PORCH	56	0			
2 CAR GARAGE	414	0			
PATIO	144	0			
SUBTOTALS	614	2010			
TOTAL UNDER ROOF	26	524			
OI	PTIONS				
	UNHEATED S.F.	HEATED S.F.			
UNFIN. THIRD FLOOR	+554	0			
EINIGHED THIRD ELOOP	0	+554			
FINISHED THIRD FLOOR		-007			
EXTENDED CAFE	-144	+120			
	-144 +150				
EXTENDED CAFE		+120			
EXTENDED CAFE PATIO W/ EXT CAFE	+150	+120			
EXTENDED CAFE PATIO W/ EXT CAFE EXTENDED FAMILY	+150	+120 0 +29			





DATE								1
DESCRIPTION	ı	1	-	-	-	-	-	-
REV.#	1	2	3	4	5	9	7	8

2010 - SMITHFIELD - --Cover Sheet French Cour


DRAWN BY:
South Designs
ISSUE DATE:
10/29/2021
CURRENT REVISION DATE:
SCALE:
1/8" = 1'-0"

0.0b

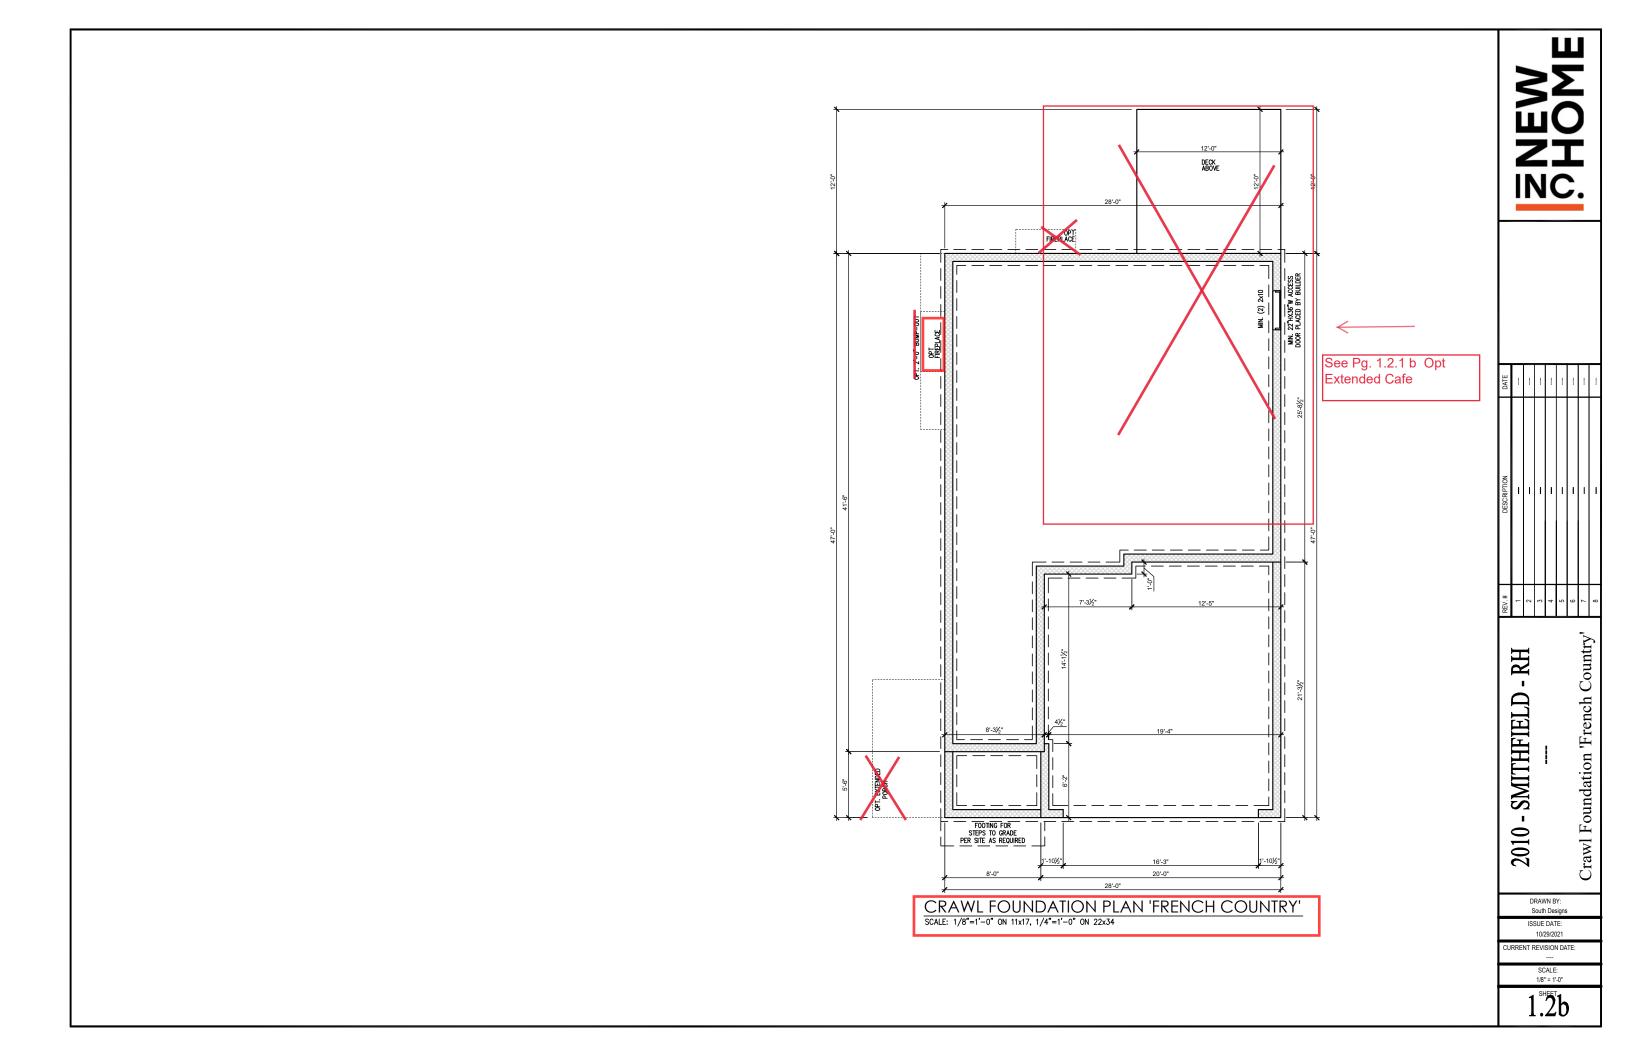

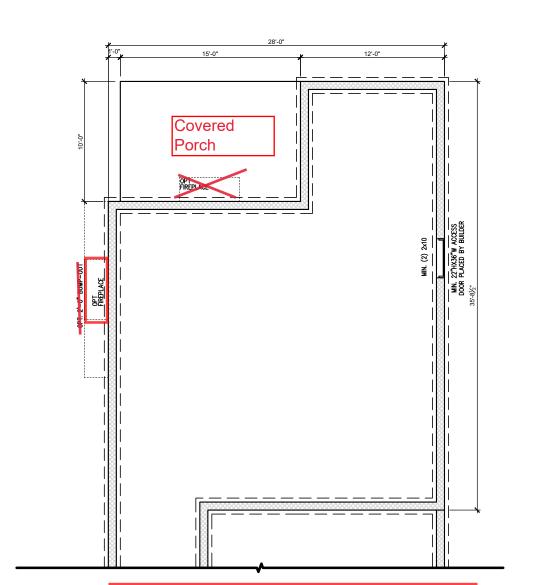

CRAWL FND. W/ OPT. EXTENDED CAFE SCALE: 1/8"=1'-0" ON 11x17, 1/4"=1'-0" ON 22x34

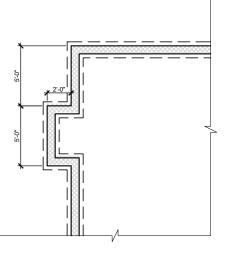

CRAWL FND W/ OPT. SIDE FIREPLACE
SCALE: 1/8"=1'-0" ON 11x17, 1/4"=1'-0" ON 22x34

DATE								
DESCRIPTION	ı	1	-	-	-	-	-	1
REV.#	1	2	3	4	5	9	7	8

Crawl Foundation Options 'French Country' 2010 - SMITHFIELD - RH


ISSUE DATE: 10/29/2021

CURRENT REVISION DATE:

SCALE: 1/8" = 1'-0"

General Floor Plan Notes shall apply unless noted otherwise on plan.

- Wall Heights: Typically 9'-1 1/2" at first floor, 8'-1 1/2" at second floor, and 8'-1 1/2" at attics U.N.O. All walls are constructed using a double top plate. Splices at Double Top Plate do not need to occur at Vertical Studs but must be at least 24" apart from Joint in other Top Plate layer. Special wall heights are noted on plans where they occur.
- Wall Thickness is typically 3 1/2". 2x6 frame shall be used at walls that back up to plumbing fixtures.
 Walls greater than 10' high shall be framed with 2x6 framing or greater and will be noted as a special condition where it occurs on plan.
- 3. Typical header height shall be 6'-11" AFF at First Floor, and 6'-11" AFF at Second Floor U.N.O.
- Jacks: Openings up to 3"-4" wide shall have (1) 2x4 jack stud SPF on each side. Openings greater than 3'-4" wide shall have (2) 2x4 jack studs SPF on each
- 5. Soffits, Coffered Ceilings, Trey Ceilings and other significant ceiling plan elements are shown on the floor plans and are denoted as single dashed lines. Unless specifically call out as included, Kitchens do not include soffits over wall cabinetry.
- Door & Window Frames, where occurring near corners, shall be a minimum of 4 1/2" from corner. Except for walk-in closets with doors near a corner, doors at closets shall be centered on closet.
- Windows: Shall have at least (1) window in each sleeping room, that meets egress. Shall be provided with tempered glass at hazardous glazing areas. False windows shall be installed with obscure glazing.
- Closets for clothing or coat storage shall be equipped with 1 rod/shelf. Closets for linen shall have 4 open equal shelves. Closets for panties shall have 4 equal wood shelves, painted.
- Stair treads shall be a min of 9" deep, risers shall be a maximum of 8 1/4", unless noted otherwise, per the current North Carolina Residential Code
- 10. Handrails and Guards at stairs shall be 34" above the finished surface of the ramp surface of the stair. Handrails at landings and overlooks of multilevel spaces shall be 36" above finished floor. Guards (pickets or balusters) shall be spaced with no more than 4" between guards.
- 11. Affic Access shall be provided at all affic area with a height greater than 30". Minimum clear affic access shall be 20" x 30". Pull down stairs and access doors in knee walls meeting minimum criteria are also acceptable.
- 12. Garage Door to Living Space shall be 2'-8" x 6'-8" minimum size and shall be 20 minute fire rated and weather sealed.
- 13. Garage Walls, as a minimum, shall be separated from living space by installing 1/2" gypsum board on the garage side of the wall. With habitable space above, the inside of all garage walls require 1/2" GWB supporting 5/8" Youe X GWB on ceiling

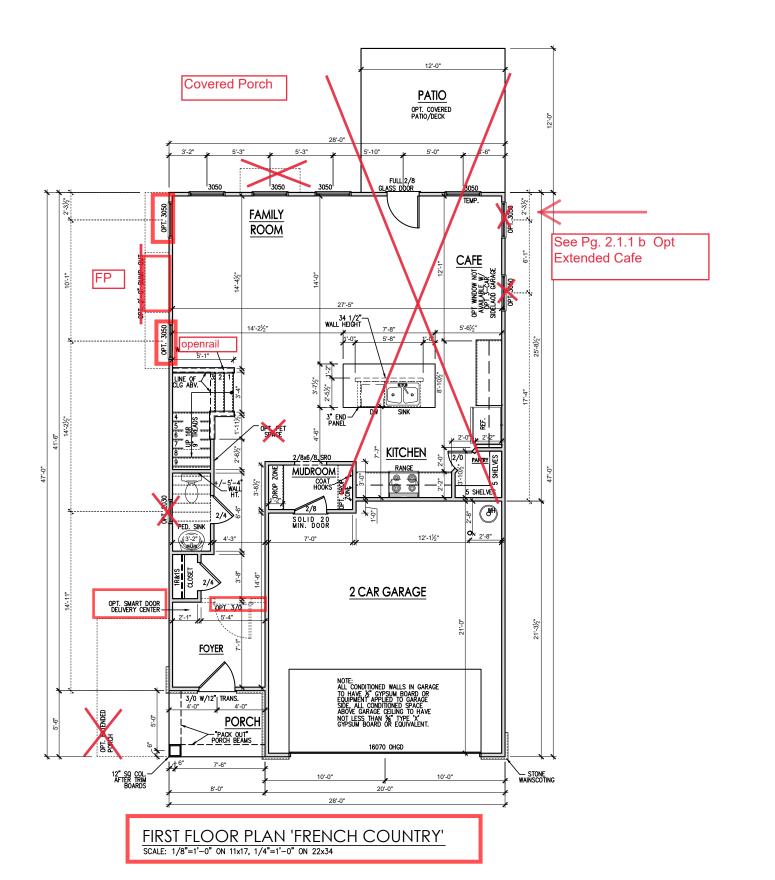

DATE								
DESCRIPTION	ı	1	-	-	-	-	1	-
REV.#	1	7	3	7	9	9	2	8

2010 - SMITHFIELD -

RH

Country'

Plan 'French

First Floor

DRAWN BY: South Designs


ISSUE DATE: 10/29/2021

CURRENT REVISION DATE:
---SCALE:
1/8" = 1'-0"

2.1b

General Floor Plan Notes shall apply unless noted otherwise on plan.

- Wall Heights: Typically 9°-1 1/2" at first floor, 8'-1 1/2" at second floor, and 8'-1 1/2" at attics U.N.O. All walls are constructed using a double top plate. Splices at Double Top Plate do not need to occur at Vertical Studs but must be at least 24" apart from Joint in other Top Plate layer. Special wall heights are noted on plans where they occur.
- Wall Thickness is typically 3 1/2". 2x6 frame shall be used at walls that back up to plumbing fixtures.
 Walls greater than 10' high shall be framed with 2x6 framing or greater and will be noted as a special condition where it occurs on plan.
- 3. Typical header height shall be 6'-11" AFF at First Floor, and 6'-11" AFF at Second Floor U.N.O.
- Jacks: Openings up to 3"-4" wide shall have (1) 2x4 jack stud SPF on each side. Openings greater than 3"-4" wide shall have (2) 2x4 jack studs SPF on each side.
- 5. Soffits, Coffered Ceilings, Trey Ceilings and other significant ceiling plan elements are shown on the floor plans and are denoted as single dashed lines. Unless specifically call out as included, Kitchens do not include soffits over wall cabinetry.
- Door & Window Frames, where occurring near corners, shall be a minimum of 4 1/2" from corner. Except for walk-in closets with doors near a corner, doors at closets shall be centered on closet.
- Windows: Shall have at least (1) window in each sleeping room, that meets egress. Shall be provided with tempered glass at hazardous glazing areas. False windows shall be installed with obscure glazing.
- Closets for clothing or coat storage shall be equipped with 1 rod/shelf. Closets for linen shall have 4 open equal shelves. Closets for panties shall have 4 equal wood shelves, painted.
- Stair treads shall be a min of 9" deep, risers shall be a maximum of 8 1/4", unless noted otherwise, per the current North Carolina Residential Code
- 10. Handrails and Guards at stairs shall be 34" above the finished surface of the ramp surface of the stair. Handrails at landings and overlooks of multilevel spaces shall be 36" above finished floor. Guards (pickets or balusters) shall be spaced with no more than 4" between guards.
- 11. Attic Access shall be provided at all attic area with a height greater than 30". Minimum clear attic access shall be 20" x 30". Pull down stalis and access doors in knee walls meeting minimum criteria are also acceptable.
- 12. Garage Door to Living Space shall be 2'-8" x 6'-8" minimum size and shall be 20 minute fire rated and weather sealed.
- 13. Garage Walls, as a minimum, shall be separated from living space by installing 1/2" gypsum board on the garage side of the wall. With habitable space above, the inside of all garage walls require 1/2" GWB supporting 5/8" type X GWB on ceiling.

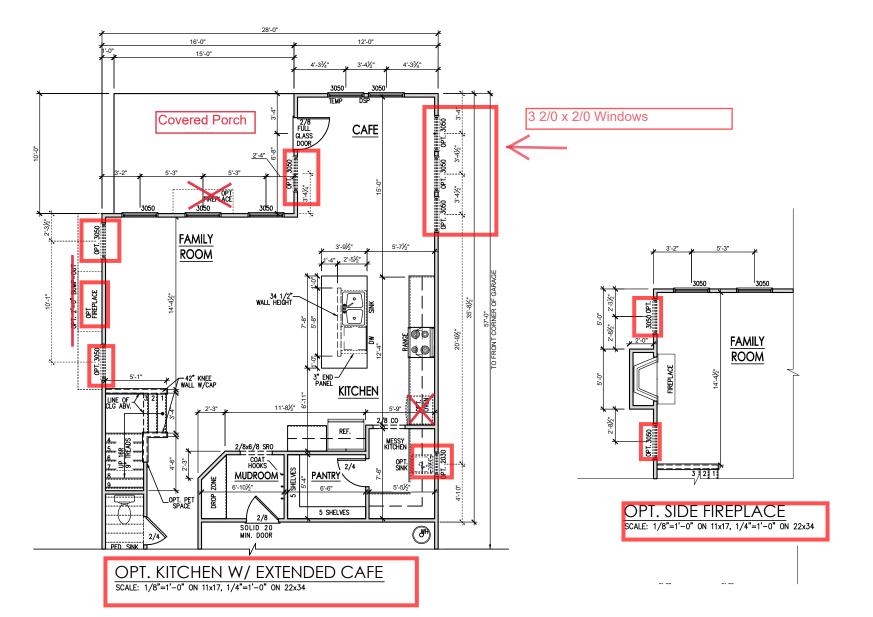

Ш
>Σ
<u>ЩО</u>
INC.

DATE									
DESCRIPTION	I	1	-	-	-	-	1	-	
REV.#	1	2	3	4	5	9	7	8	

2010 - SMITHFIELD ---- 'French Country'

First Floor Options

RH

DRAWN BY: South Designs


10/29/2021 CURRENT REVISION DATE:

> SCALE: 1/8" = 1'-0"

2.1.1h

General Floor Plan Notes shall apply unless noted otherwise on plan.

- Wall Heights: Typically 9'-1 1/2" at first floor, 8'-1 1/2" at second floor, and 8'-1 1/2" at attics U.N.O. All walls are constructed using a double top plate. Splices at Double Top Plate do not need to occur at Vertical Studs but must be at least 24" apart from Joint in other Top Plate layer. Special wall heights are noted on plans where they occur.
- Wall Thickness is typically 3 1/2". 2x6 frame shall be used at walls that back up to plumbing fixtures.
 Walls greater than 10' high shall be framed with 2x6 framing or greater and will be noted as a special condition where it occurs on plan.
- 3. Typical header height shall be 6'-11" AFF at First Floor, and 6'-11" AFF at Second Floor U.N.O.
- Jacks: Openings up to 3"-4" wide shall have (1) 2x4 jack stud SPF on each side. Openings greater than 3'-4" wide shall have (2) 2x4 jack studs SPF on each
- 5. Soffits, Coffered Ceilings, Trey Ceilings and other significant ceiling plan elements are shown on the floor plans and are denoted as single dashed lines. Unless specifically call out as included, Kitchens do not include soffits over wall cabinetry.
- Door & Window Frames, where occurring near corners, shall be a minimum of 4 1/2" from corner. Except for walk-in closets with doors near a corner, doors at closets shall be centered on closet.
- Windows: Shall have at least (1) window in each sleeping room, that meets egress. Shall be provided with tempered glass at hazardous glazing areas. False windows shall be installed with obscure glazing.
- Closets for clothing or coat storage shall be equipped with 1 rod/shelf. Closets for linen shall have 4 open equal shelves. Closets for pontries shall have 4 equal wood shelves, painted.
- Stair treads shall be a min of 9" deep, risers shall be a maximum of 8 1/4", unless noted otherwise, per the current North Carolina Residential Code
- 10. Handrails and Guards at stairs shall be 34" above the finished surface of the ramp surface of the stair. Handrails at landings and overlooks of multilevel spaces shall be 36" above finished floor. Guards (pickets or balusters) shall be spaced with no more than 4" between guards.
- 11. Affic Access shall be provided at all affic area with a height greater than 30". Minimum clear affic access shall be 20" x 30". Pull down stairs and access doors in knee walls meeting minimum criteria are also acceptable.
- 12.Garage Door to Living Space shall be 2'-8" x 6'-8" minimum size and shall be 20 minute fire rated and weather sealed.
- 13. Garage Walls, as a minimum, shall be separated from living space by installing 1/2" gypsum board on the garage side of the wall. With habitable space above, the inside of all garage walls require 1/2" GWB supporting 5/8" type X GWB on ceiling.

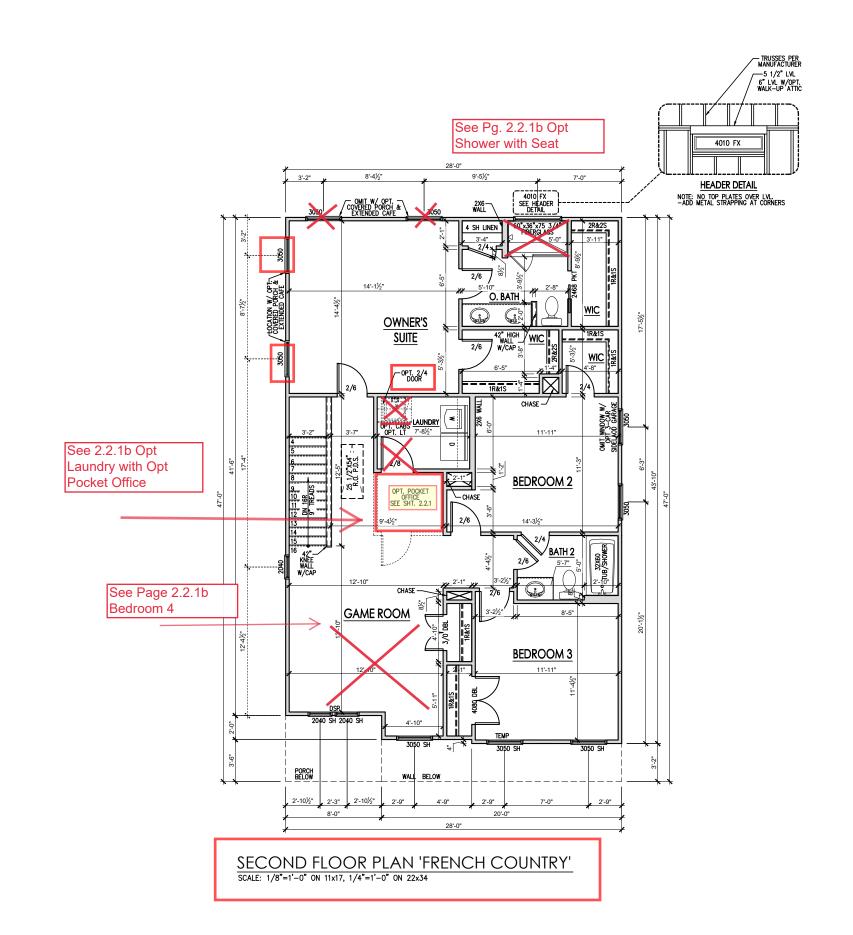



DATE									
DESCRIPTION	ı	Ι	_	-	-	-	-	1	
REV.#	1	2	3	4	2	9	7	8	

2010 - SMITHFIELD - RH --- Plan 'French Country'

Second Floor

DRAWN BY: South Designs


ISSUE DATE: 10/29/2021

CURRENT REVISION DATE:
---SCALE:
1/8" = 1'-0"


2.2b

General Floor Plan Notes shall apply unless noted otherwise on plan.


- Wall Heights: Typically 9°-1 1/2" at first floor, 8'-1 1/2" at second floor, and 8'-1 1/2" at attics U.N.O. All walls are constructed using a double top plate. Splices at Double Top Plate do not need to occur at Vertical Studs but must be at least 24" apart from Joint in other Top Plate layer. Special wall heights are noted on plans where they occur.
- Wall Thickness is typically 3 1/2". 2x6 frame shall be used at walls that back up to plumbing fixtures.
 Walls greater than 10' high shall be framed with 2x6 framing or greater and will be noted as a special condition where it occurs on plan.
- 3. Typical header height shall be 6'-11" AFF at First Floor, and 6'-11" AFF at Second Floor U.N.O.
- Jacks: Openings up to 3'-4" wide shall have (1) 2x4 jack stud SPF on each side. Openings greater than 3'-4" wide shall have (2) 2x4 jack studs SPF on each side.
- 5. Soffits, Coffered Ceilings, Trey Ceilings and other significant ceiling plan elements are shown on the floor plans and are denoted as single dashed lines. Unless specifically call out as included, Kitchens do not include soffits over wall cabinetry.
- Door & Window Frames, where occurring near corners, shall be a minimum of 4 1/2" from corner. Except for walk-in closets with doors near a corner, doors at closets shall be centered on closet.
- Windows: Shall have at least (1) window in each sleeping room, that meets egress. Shall be provided with tempered glass at hazardous glazing areas. False windows shall be installed with obscure alazina.
- Closets for clothing or coat storage shall be equipped with 1 rod/shelf. Closets for linen shall have 4 open equal shelves. Closets for pantries shall have 4 equal wood shelves, painted.
- Stair treads shall be a min of 9" deep, risers shall be a maximum of 8 1/4", unless noted otherwise, per the current North Carolina Residential Code
- 10.Handrails and Guards at stairs shall be 34" above the finished surface of the ramp surface of the stair. Handrails at landings and overlooks of multilevel spaces shall be 36" above finished floor. Guards (pickets or balusters) shall be spaced with no more than 4" between guards.
- 11. Affic Access shall be provided at all affic area with a height greater than 30". Minimum clear affic access shall be 20" x 30". Pull down stairs and access doors in knee walls meeting minimum criteria are also acceptable.
- 12. Garage Door to Living Space shall be 2'-8" x 6'-8" minimum size and shall be 20 minute fire rated and weather sealed.
- 13. Garage Walls, as a minimum, shall be separated from living space by installing 1/2" gypsum board on the garage side of the wall. With habitable space above, the inside of all garage walls require 1/2" GWB supporting 5/8" type X GWB on celling.

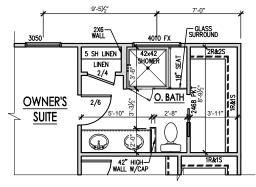

OPT. SHOWER W/ SEAT
SCALE: 1/8"=1'-0" ON 11x17, 1/4"=1'-0" ON 22x34

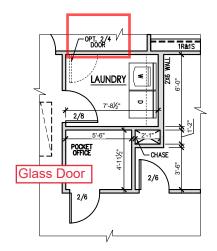

LAUNDRY W/OPT. POCKET OFFICE
SCALE: 1/8"=1'-0" ON 11x17, 1/4"=1'-0" ON 22x34

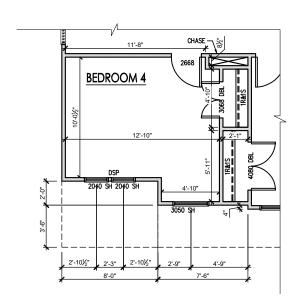

OPT. BEDROOM 4 I.L.O. GAMEROOM
SCALE: 1/8"=1'-0" ON 11x17, 1/4"=1'-0" ON 22x34

≥Σ
MO
艺工
INC.

DATE									
DESCRIPTION	I	1	-	-	-	-	1	-	
REV.#	-	2	3	4	2	9	7	8	


2010 - SMITHFIELD - RH
---Second Floor Plan Options 'French Country'

DRAWN BY: South Designs

ISSUE DATE: 10/29/2021 CURRENT REVISION DATE:

> SCALE: 1/8" = 1'-0"

2.2.1b

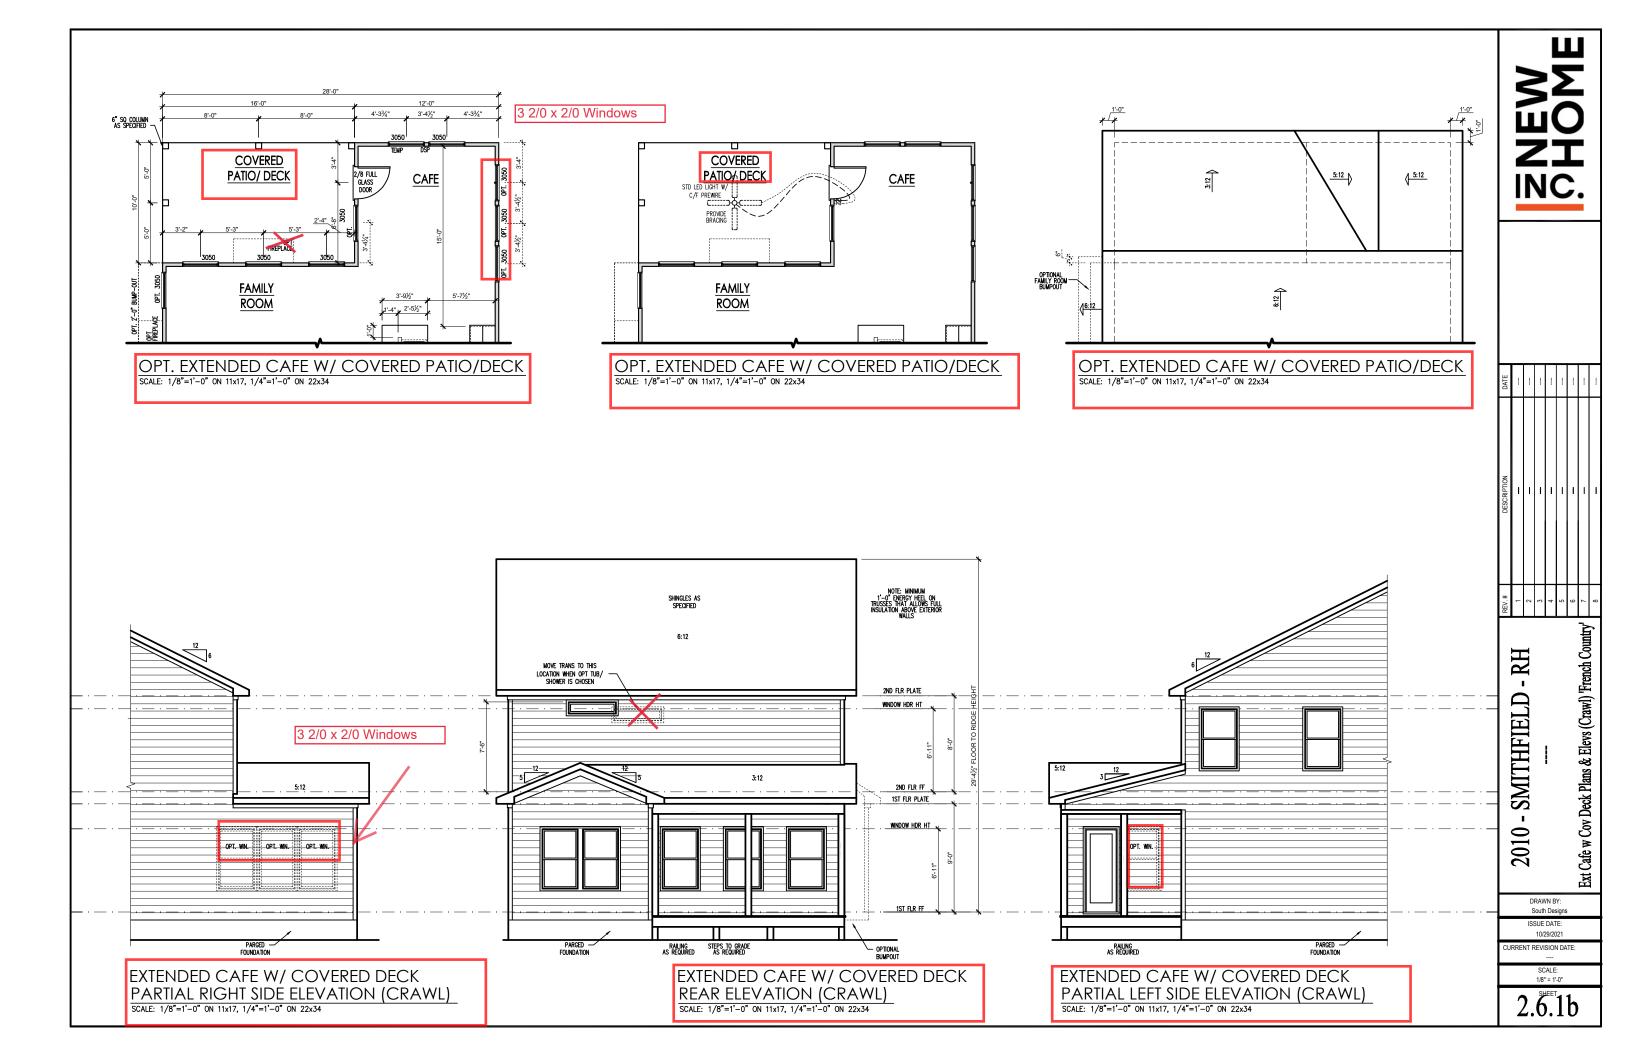

General Elevation Notes


General Elevation Notes shall apply unless noted otherwise on plan.


- Roof shall be finished with architectural composition
 shingles with slopes as noted on plan
- Ridge Vent shall be provided and installed on all ridges greater than 6' in length per manufacturer's specifications.
- 3. Soffit Vent shall be continuous soffit vent
- House Wrap, "tyvek" or approved equal shall be installed over entire exterior wall per manufacturer's specifications and recommendations.
- Flashing shall be provided above all door and window openings, above finish wall material changes and at wall surfaces where lower roof areas abut vertical wall surfaces.
- Porch Railings shall be provided at all porch walking surfaces greder than 30" above adjacent finished grade. It shall be 36" high with guards spaced no more than 4" apart. Consult community specifications for material.
- Finish Wall Material shall be as noted on elevation drawings.
- 8. Brick Veneer, if included on elevation shall be fied to wall surface with galvanized corrugated metal fies at a rate of 24" oc horizontally and 16" oc vertically so that no more than 2.67st of brick is supported by (1) fie. Space between face of wall and back face of brick shall be limited to a maximum of 1". Rashing shall be provided behind brick above all wall openings and at base of brick wall. Flashing shall be a minimum of 6-mil poly or other corrosion resistant material and shall be installed so that it laps under the house wrap material a minimum of 2".

 Weepholes shall be provided at a rate of 48" oc and shall not be less than 3/16" in diameter and shall be located immediately above floshing.
- Brick Veneer Support Lintels shall be provided if brick veneer is included on elevation. Lintels shall be provided as listed in the following schedule and shall have a minimum bearing length of 6". Massarry Lintels shall be provided so that deflection is limited to L/600.


Masonry Opening Lintel Schedule

Opc.	9	0	7g.c
up to	4'-0"		3-1/2" x 3-1/2" x 5/16"
4'-1"	to	5'-6"	4" x 3-1/2" x 5/16" LLV
5'-7"	to	6'-6"	5" x 3-1/2" x 5/16" LLV
6'-7"	to	8'-4"	6" x 3-1/2" x 5/16" LLV
8'-5"	to	16'-4"	7" x 4" x 3/8" LLV

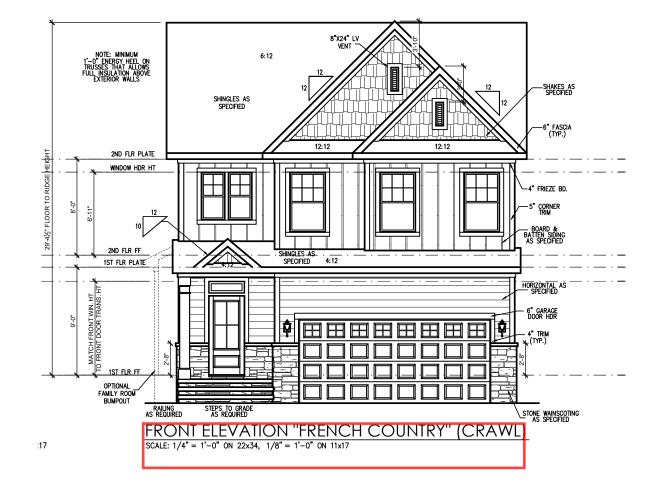

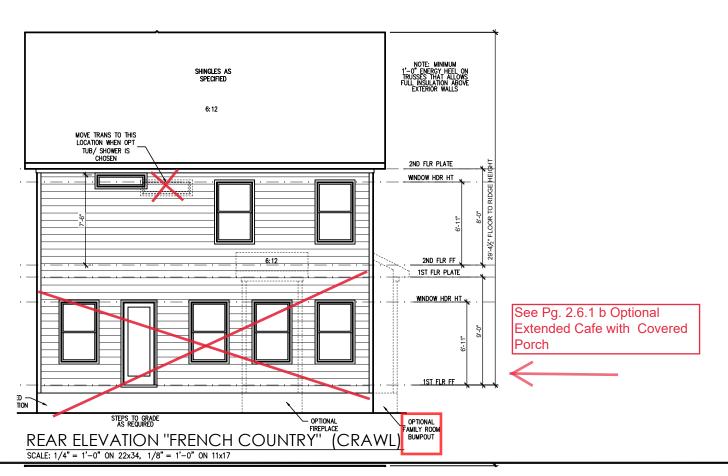



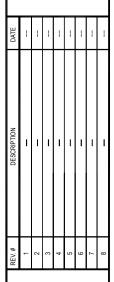

----Front & Rear Elevations (Crawl) 'French Country'

RH

SMITHFIELD

.


2010.

DRAWN BY: South Designs

ISSUE DATE: 10/29/2021

JRRENT REVISION DATE
---SCALE:
1/8" = 1'-0"


3.1.1b

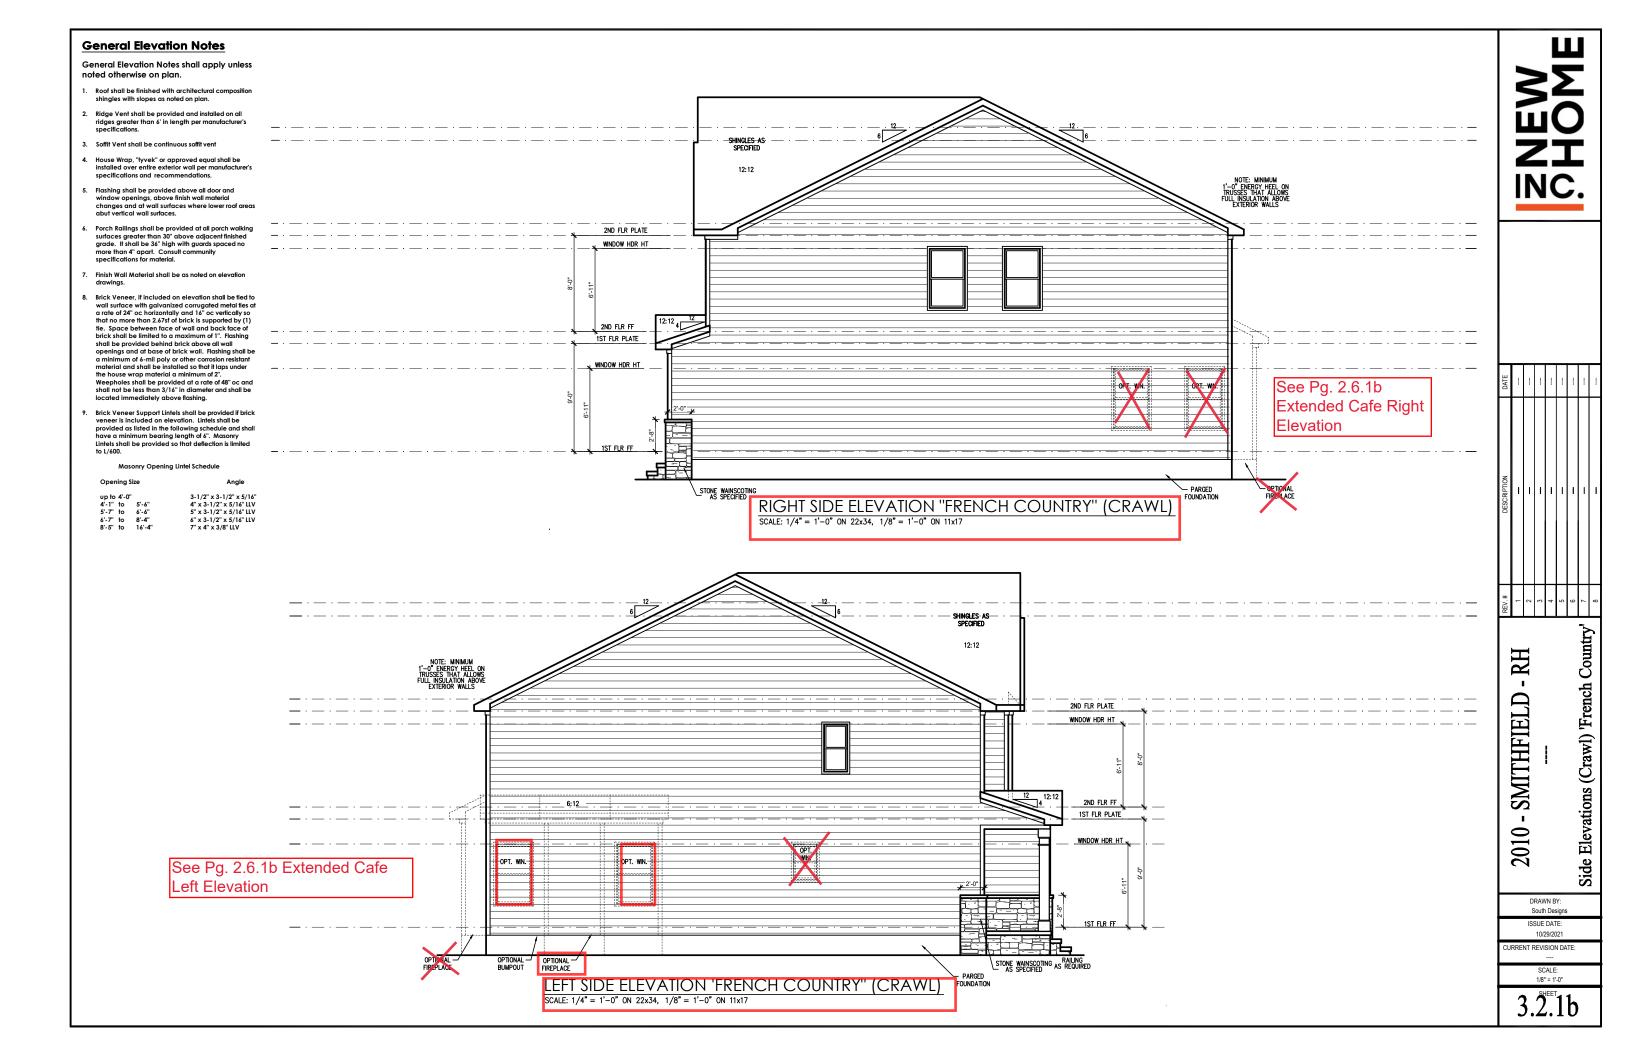

See Pg 2.6.1 b Optional Extended Cafe with Covered Patio Roof Plan

	ATTIC VENT SCHEDULE											
	"FRENCH COUNTRY" ELEVATION											
MAIN	MAIN HOUSE			1206	AT / NEAR RIDGE			AT / NEAR EAVE				
VENT TYPE	VENT TYPE SQ. FT. REQUIRED RANGE		SQ. FT. SUPPLIED	PERCENT OF TOTAL SUPPLIED	POT LARGE (SQ. FT. EACH)	POT SMALL (SQ. FT. EACH)	RIDGE VENT (SQ. FT. PER LE)	EAVE VENT (SQ. IN. EACH)	CONT. VENT (SQ. IN. PER LF)			
72.11.11.2					0.4236	0.2778	0.125	0.1944	0.0625			
RIDGE VENT	1.61	2.01	2.50	52.63	0	0	20.00					
SOFFIT VENTS	2.41	2.01	2.25	47.37				0	36.00			
TOTAL (MIN)	4.02	4.02	4.75	100.00	POT VENTS MAY BE REQUIRED IF THERE IS INSUFFICIENT RIDGE AVAILABLE							

* SCHEDULE HAS BEEN CALCULATED ASSUMING EAVE VENTILATION AT 50-60% OF TOTAL AND RIDGE AT 40-50% OF TOTAL REQUIRED VENTILATION

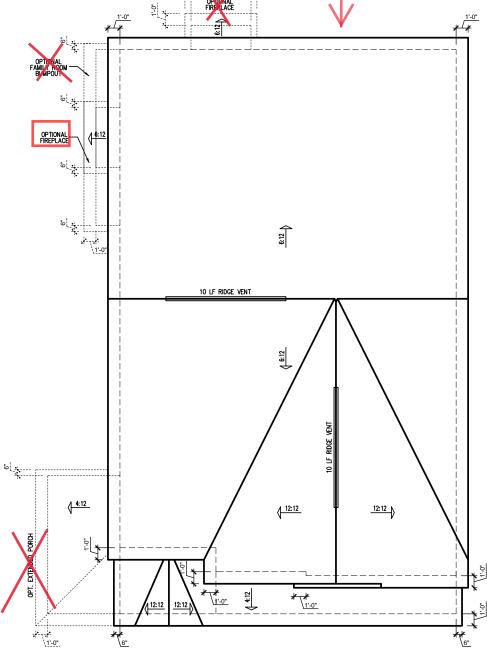

"FRENCH COUNTRY" ROOF PLAN SCALE: 1/4" = 1'-0" ON 22x34, 1/8" = 1'-0" ON 11x17

DATE								
DESCRIPTION	ı	1	-	-	-	_	-	-
REV.#	-	2	3	4	2	9	7	8

2010 - SMITHFIELD - RH ---


Roof Plan 'French Country'


DRAWN BY: South Designs


ISSUE DATE: 10/29/2021

CURRENT REVISION DATE:
---SCALE:
1/8" = 1'-0"

3.3b

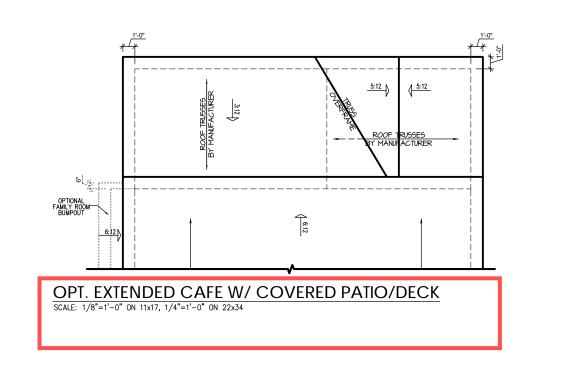

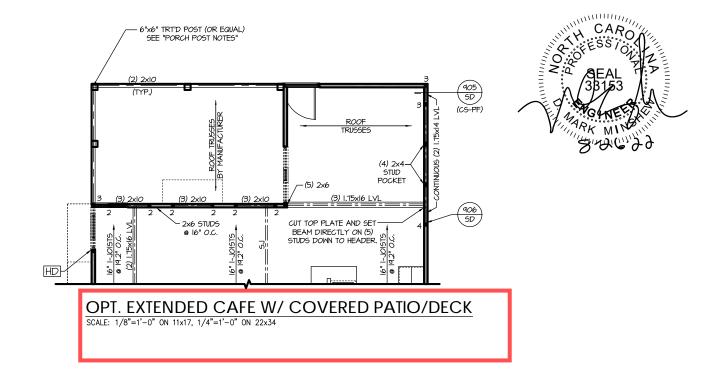

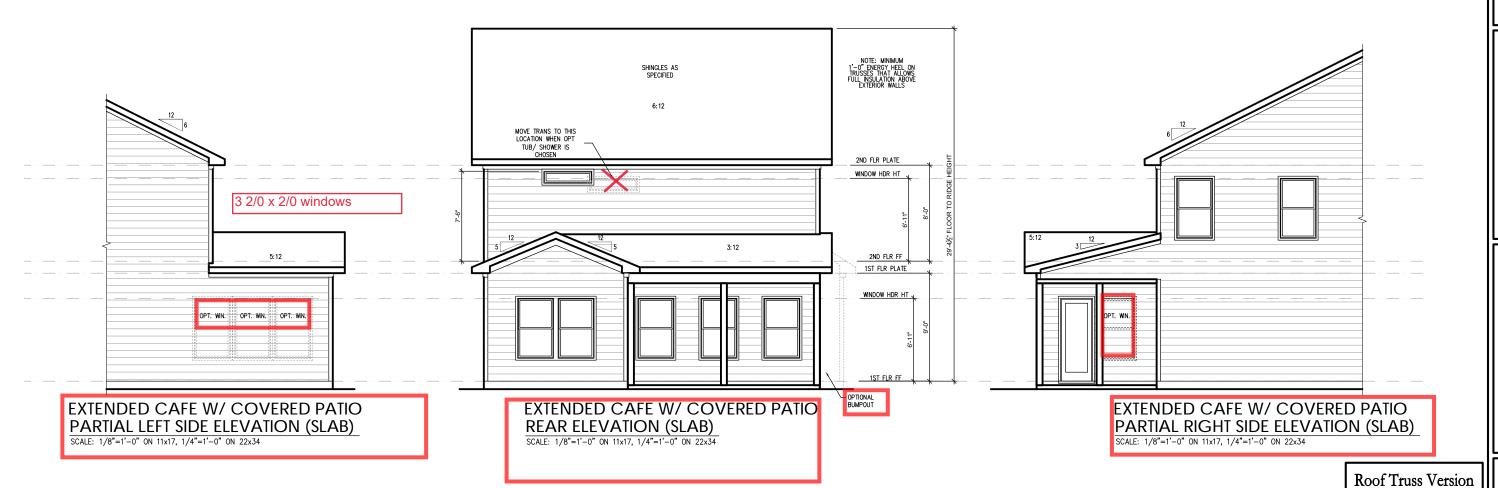

PROJECT # 21-3366-RH

nons.

sa are to be brought to the reer. Failure to do so will reer from date of seal.

Seal does not include construction means, methods, techn sequences, procedures or safety precautions.

Any deviations or discrepancies on plans are to be brough immediate attention of Southern Engineers. Failure to do void Southern Engineers' liability.


Southern Engineers, P.A. 3716 Benson Drive, Raleigh, NC 27609 Phone: (919) 878-1617

NEW HOME, INC.

SMITHFIELD
Garage Right

S-2.6

See Pg. S-2.6 Opt. Extended Cafe with Covered Porch

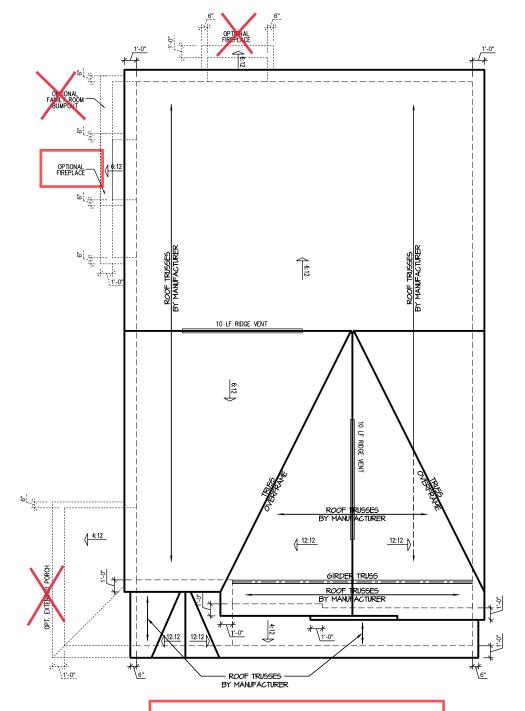

"FRENCH COUNTRY" ROOF PLAN SCALE: 1/4" = 1'-0" ON 22x34, 1/8" = 1'-0" ON 11x17

TRUSS SYSTEM REQUIREMENTS NC (2018 NCRC): Wind: 115-120 mph

- TRUSS SYSTEM LAYOUTS (PLACEMENT PLANS) SHALL BE DESIGNED IN ACCORDANCE WITH SEALED STRUCTURAL PLANS. ANY NEED TO CHANGE TRUSSES SHALL BE COORDINATED WITH SOUTHERN ENGINEERS.
- 2. TRUSS SCHEMATICS (PROFILES) SHALL BE PREPARED AND SEALED BY TRUSS MANUFACTURER.
- ALL TRUSSES SHALL BE DESIGNED FOR BEARING ON SPF #2 OR #3 PLATES OR LEDGERS (UNO).
- 4. ALL REQUIRED ANCHORS FOR TRUSSES DUE TO UPLIFT OR BEARING SHALL MEET THE REQUIREMENTS AS SPECIFIED ON THE TRUSS SCHEMATICS.

ROOF FRAMING NOTES: NC (2018 NCRC): Wind: 115-120 mph

- 1. 2x8 RAFTERS @ 16" O.C. WITH 2xIO RIDGE, UNO.
- (2) 2xIO OR 1.75xII.875 LVL HIP. (2) 2xIO HIPS MAY BE SPLICED WITH A MIN. 6'-O" OVERLAP AT CENTER
- (2) 2xIO OR 1.75x9.25 LVL VALLEY. DO NOT SPLICE VALLEYS
- 4) 1.75x11.875 LVL OR (2)1.75x9.25 LVL VALLEY
- (5) FALSE FRAME VALLEY ON 2xIO FLAT PLATE (6) 2x6 RAFTERS @ 16" O.C. W/ 2x8 RIDGE, UNO.
- 1) 2xIO RAFTERS @ I6" O.C. W 2xI2 RIDGE, UNO.
- (8) EXTEND RIDGE 12" BEYOND INTERSECTION

- "SR" = SINGLE RAFTER
 "DR" = DOUBLE RAFTER
 "TR" = TRIPLE RAFTER
 "RS" = ROOF SUPPORT
 "B" = (3) STUD OR 4x4 POST FOR ROOF SUPPORT (USE
 2X6 STUDS OR 6X6 POST FOR SUPPORT OVER IO'-O' IN
- AND STUDY OR AND FOST FOR SUPPORT OVER 10-0 IN HEIGHT)
 ATTACH VAULTED RAFTERS WITH HURRICANE CLIPS.
 SIMPSON "H-2.5A" OR EQUIVALENT. TIES TO BE INSTALLED ON THE OUTSIDE FACE OF FRAMING.
 INSTALL RAFTER TIES AND COLLAR TIES PER SECTION R802.3.I OF THE 2018 NC RESIDENTIAL CODE.

	ATTIC VENT SCHEDULE										
	"FRENCH COUNTRY" ELEVATION										
MAIN	MAIN HOUSE			1206	AT / NEAR RIDGE			AT / NEAR EAVE			
VENT TYPE	SQ. FT. REQUIRED RANGE		SQ. FT. SUPPLIED	PERCENT OF TOTAL SUPPLIED	POT LARGE (SQ. FT. EACH)	POT SMALL (SQ. FT. EACH)	RIDGE VENT (SQ. FT. PER LF)	EAVE VENT (SQ. IN. EACH)	CONT. VENT (SQ. IN. PER LF)		
					0.4236	0.2778	0.125	0.1944	0.0625		
RIDGE VENT	1.61	2.01	2.50	52.63	0	0	20.00				
SOFFIT VENTS	2.41	2.01	2.25	47.37				0	36.00		
TOTAL (MIN)	4.02	4.02	4.75	100.00	POT VENTS MAY BE REQUIRED IF THERE IS INSUFFICIENT RIDGE AVAILABLE						

^{*} SCHEDULE HAS BEEN CALCULATED ASSUMING EAVE VENTILATION AT 50-60% OF TOTAL AND RIDGE AT 40-50% OF TOTAL REQUIRED VENTILATION

PROJECT # 21-3366-RH

P.A. 27609

Southern Engineers, P 3716 Benson Drive, Raleigh, NC 2. Phone: (919) 878-1617

HOME, NEW]

SMITHFIELD

Roof Truss Version

CRAWL FOUNDATION PLAN 'FRENCH COUNTRY'

SCALE: 1/8"=1'-0" ON 11x17, 1/4"=1'-0" ON 22x34



- TRUSS SYSTEM LAYOUTS (PLACEMENT PLANS) SHALL BE DESIGNED IN ACCORDANCE WITH SEALED STRUCTURAL PLANS. ANY NEED TO CHANGE TRUSSES SHALL BE COORDINATED WITH SOUTHERN ENGINEERS.
- TRUSS SCHEMATICS (PROFILES) SHALL BE PREPARED AND SEALED BY TRUSS MANUFACTURER.
- ALL TRUSSES SHALL BE DESIGNED FOR BEARING ON SPF #2 OR #3 PLATES OR LEDGERS (UNO).
- ALL REQUIRED ANCHORS FOR TRUSSES DUE TO UPLIFT OR BEARING SHALL MEET THE REQUIREMENTS AS SPECIFIED ON THE TRUSS SCHEMATICS.

- <u>SOLID</u> UP TO 5'-0"
- UP TO 12'-0"

- FOR FOUNDATION WALL HEIGHT AND BACKFILL REQUIREMENTS, REFER TO CODE TABLE R404.I.I (I THRU 4) NOTE: ASSUMED SOIL BEARING CAPACITY = 2000 PSF. CONTRACTOR MUST VERIFY SITE CONDITIONS AND CONTACT SOILS ENGINEER IF MARGINAL OR UNSTABLE SOILS ARE ENCOUNTERED.
- " " DESIGNATES A SIGNIFICANT POINT LOAD TO HAVE SOLID BLOCKING TO PIER. SOLID BLOCK ALL BEAM BEARING POINTS NOTED TO HAVE THREE OR
- ADJUST SUBFLOOR THICKNESS OR JOIST SPACING

- <u>MOOD 1-JOISTS</u> (SHALL BE ONE OF THE FOLLOWING OR EQUAL):
- TJI 210 BY TRUS JOIST LPI 20 PLUS BY LP
- BCI 5000s I.8 BY BC

HEAVY WOOD I-JOISTS

- (SHALL BE ONE OF THE FOLLOWING OR EQUAL):

 TJI 360 BY TRUS JOIST
 - IPI 42 PI IS BY IP
 - BCI 60s 2.0 BY BC
- ALL WOOD I-JOISTS SHALL BE INSTALLED ACCORDING TO MANUFACTURER'S SPECIFICATIONS.
- INSTALL SQUASH BLOCKS, WEB STIFFENERS, ETC. AS REQUIRED BY AND ACCORDING TO THE I-JOIST MANUFACTURER'S SPECIFICATIONS AND INSTRUCTIONS.
- HANGERS FOR I-JOISTS ARE THE RESPONSIBILITY OF
- FLOOR TRUSSES BY MANUFACTURER MAY BE

PROJECT # 21-3366-RH

e to be brought to t Failure to do so wi

P.A. 27609 Southern Engineers, F 3716 Benson Drive, Raleigh, NC 2 Phone: (919) 878-1617


HOME,

NEW


SMITHFIELD

Roof Truss Version

S-1.2

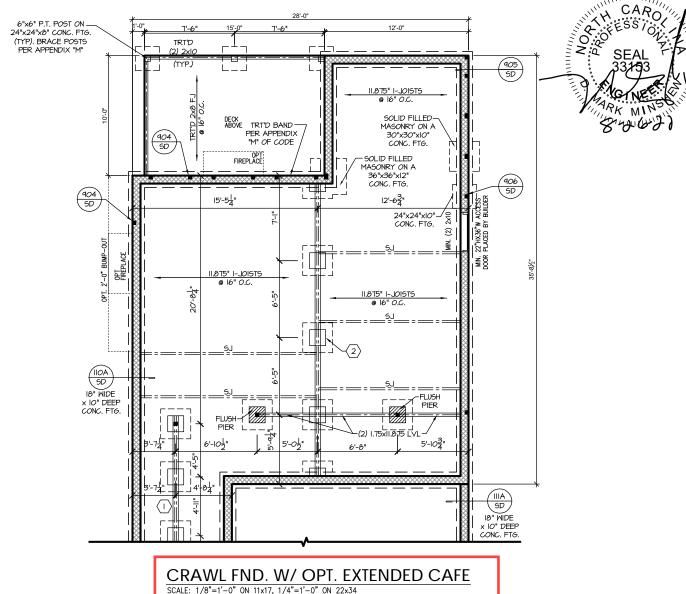

CRAWL FND. W/ OPT. EXTENDED CAFE
SCALE: 1/8"=1'-0" ON 11x17, 1/4"=1'-0" ON 22x34

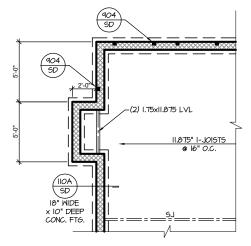

CRAWL FND W/ OPT. SIDE FIREPLACE

SCALE: 1/8"=1'-0" ON 11x17, 1/4"=1'-0" ON 22x34

PROJECT # 21-3366-RH

Southern Engineers, P.A. 3716 Benson Drive, Raleigh, NC 27609 Phone: (919) 878-1617 License: C-4772 www.southernengineers.com

NEW HOME, INC.

SMITHFIELD

Roof Truss Version

- TRUSS SYSTEM LAYOUTS (PLACEMENT PLANS) SHALL BE DESIGNED IN ACCORDANCE WITH SEALED STRUCTURAL PLANS. ANY NEED TO CHANGE TRUSSES SHALL BE COORDINATED WITH SOUTHERN ENGINEERS
- TRUSS SCHEMATICS (PROFILES) SHALL BE PREPARED AND SEALED BY TRUSS MANUFACTURER.
- ALL TRUSSES SHALL BE DESIGNED FOR BEARING ON SPF #2 OR #3 PLATES OR LEDGERS (UNO).
- ALL REQUIRED ANCHORS FOR TRUSSES DUE TO UPLIET OR BEARING SHALL MEET THE REQUIREMENTS AS SPECIFIED ON THE TRUSS SCHEMATICS.

HEADER/BEAM & COLUMN NOTES

- ALL EXTERIOR AND LOAD BEARING HEADERS SHALL BE MIN. (2)2x6 (4" WALL) OR (3)2x6 (6" WALL) WITH (1) SUPPORT STUD, UNLESS NOTED OTHERWISE.
- THE NUMBER SHOWN AT BEAM AND HEADER SUPPORTS INDICATES THE NUMBER OF SUPPORT STUDS REQUIRED IN STUD POCKET OR COLUMN. THE NUMBER OF KING STUDS AT EACH END OF HEADERS IN EXTERIOR WALLS SHALL BE ACCORDING TO ITEM "d" IN TABLE R602.3(5)

 OR AS BELOW PER NCDO! COMMENTARY "KING STUDS See Pg S -2.1.1 Side AT WALL OPENINGS" REVISED 1-9-2020:
 - UP TO 3' SPAN: (I) KING STUD
 - OVER 3' UP TO 6' SPAN: (2) KING STUDS OVER 6' UP TO 9' SPAN: (3) KING STUDS
- OVER 9' UP TO 12' SPAN: (4) KING STUDS
- OVER 12' UP TO 15' SPAN: (5) KING STUDS


FRAMING NOTES

NC (2018 NCRC): Wind: 115-120 mph

- BRACING METHOD AND TYPE: CONTINUOUSLY SHEATHED WSP: CS-WSP, NOTE THAT THE WALL BRACING AMOUNT PROVIDED ON THE PLANS (DETAILS AND SPECIFICATIONS) IS GREATER THAN THE AMOUNT OF WALL BRACING REQUIRED BY SECTION R602.10 OF THE CODE. SEE NOTES BELOW FOR DETAILS AND SPECIFICATIONS FOR WALL BRACING AND WALL FRAMING.
- EXTERIOR WALL SHEATHING: WALLS SHALL BE BRACED BY SHEATHING WALLS ON ALL STORIES WITH WOOD STRUCTURAL PANEL SHEATHING (WSP) (EXPOSURE B: 1/16". EXPOSURE C: 15/32"). SHEATHING SHALL BE ATTACHED WITH 8d NAILS AT A 6"/12" NAILING PATTERN (6" OC AT PANEL EDGES AND 12" OC AT INTERMEDIATE SUPPORTS). INSTALL BLOCKING AT ALL PANEL
- WSP SHEATHING SHALL EXTEND TO THE UPPERMOST DOUBLE BEARING PLATE. BLOCK AT ROOF PER SECTION R602.10.4.5 AND ATTACH BRACED WALLS PER CODE. MSP SHEATHING BETWEEN FLOORS SHALL BE SPLICED ALONG CONTINUOUS BAND OR THE MSP SHEATHING MAY BE SPLICED ACROSS STUDS (CONTINUOUS ACROSS FLOOR SYSTEM) WITH BLOCKING AT PANEL EDGES. (MINIMUM 12" BEYOND FLOOR BREAK) OR OTHER APPROVED
- "HD" = HOLDOWN: HOLD-DOWN DEVICE (NOTED AS "HD" ON PLANS)
 SHALL BE AN 800 POUND CAPACITY ASSEMBLY AS NOTED ON
 PLANS, SEE DETAILS FOR HD ASSEMBLY.
- **GROUND/FIRST FLOOR: USE "HD HOLD-DOWN DETAIL" ON SD
- SHEET (OR EQUIV.) SHEET (OR EQUIV).

 **UPPER FLOORS: ATTACH BASE OF KING STUD WITH A SIMPSON
 C522 STRAP DOWN ACROSS THE BAND AND DOWN TO A STUD
 BELOW OR HEADER BELOW. EXTEND STRAP T" MIN ALONG EACH STUD (OR HEADER) AND ATTACH EACH END W (7) 8d NAILS.
- 5. INTERIOR BRACED WALL: (NOTED AS "IBW" ON PLANS) ATTACH I/2" GYPSUM BOARD (GB) ON EACH SIDE OF WALL WITH A MIN. OF 5d COOLER NAILS OR #6 SCREWS @ 7" O.C. ALONG THE EDGES AND AT INTERMEDIATE SUPPORTS.
- 6. INTERIOR BRACED WALL-WOOD STRUCTURAL PANEL: (NOTED AS "IBW-MSP" ON PLANS), ATTACH ONE SIDE WITH 76" MSP SHEATHING WITH 8d NAILS AT A 6"/12" NAILING PATTERN (6" OC AT PANEL EDGES AND 12" OC AT INTERMEDIATE SUPPORTS). INSTALL BLOCKING AT ALL PANEL EDGES. ATTACH GB OVER WSP AS REQUIRED. ATTACH OPPOSITE SIDE WITH 1/2" GB WITH A MIN. OF 5d COOLER NAILS OR #6 SCREWS @ 7" OC ALONG THE EDGES AND AT INTERMEDIATE SUPPORTS.

See Pg. S-2.1.1 Optional Kitchen with Extended Cafe

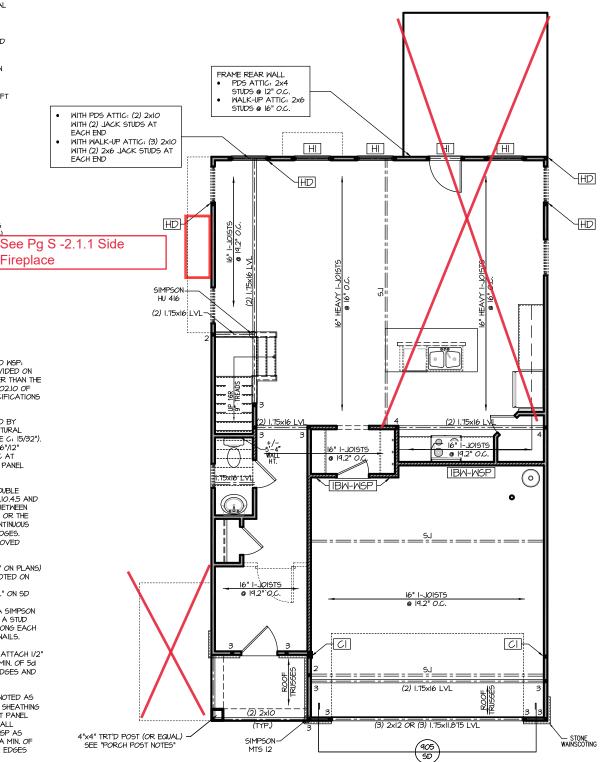

FIRST FLOOR PLAN 'FRENCH COUNTRY' SCALE: 1/8"=1'-0" ON 11x17, 1/4"=1'-0" ON 22x34

MOOD I-JOISTS

(SHALL BE ONE OF THE FOLLOWING OR EQUAL):

- TJI 210 BY TRUS JOIST LPI 20 PLUS BY LP
- BCI 5000s I.8 BY BC

HEAVY WOOD I-JOISTS

(SHALL BE ONE OF THE FOLLOWING OR EQUAL):

• TJI 360 BY TRUS JOIST

- LPI 42 PLUS BY LP
- BCI 60s 2.0 BY BC
- ALL MOOD I-JOISTS SHALL BE INSTALLED ACCORDING TO MANUFACTURER'S SPECIFICATIONS.
- REQUIRED BY AND ACCORDING TO THE I-JOIST MANUFACTURER'S SPECIFICATIONS AND INSTRUCTIONS.
- HANGERS FOR I-JOISTS ARE THE RESPONSIBILITY OF
- FLOOR TRUSSES BY MANUFACTURER MAY BE SUBSTITUTED FOR ANY I-JOISTS.

PORCH POST NOTES:

- 4"x4" (6"x6") TRT'D POST (OR EQUAL).
- ATTACH TRUSSES (RAFTERS) AT PORCH WITH HURRICANE
- POST CAP AT CORNER: (2) SIMPSON LCE4 (MITER HEADER
- AT CORNER). HIGH WIND: ADD (I) SIMPSON H6. POST BASE: SIMPSON ABU44 (ABU66).
- MONO: %" ANCHOR (EMBED 7")
- 3.2. <u>CMU: 5%" ANCHOR (EXTEND TO FOOTING HIGH WIND ONLY)</u>
- POST BASE: WOOD FOUNDATION: (2) SIMPSON CSI6 STRAPS AT POSTS. EXTEND 12" ONTO EACH POST (UPPER AND LOWER) OR TO GIRDER.
- NOTE: EQUIVALENT POST CAP AND BASE ACCEPTABLE.

HI

- JACK STUDS AT EACH END
- WITH WALK-UP ATTIC: (3) 2xIO WITH (2) 2x6 JACK STUDS AT EACH END

CI

WITH PDS ATTIC: 3.5"x5.25" PSL/LVL COLUMN WITH WALK-UP ATTIC: 3.5"x7" PSL/LVL COLUMN WITH BOTH OPTIONS INSTALL A 2x4 STUD ON EACH SIDE OF COLUMN AND ATTACH WITH (2) ROWS OF 12d NAILS @ 6" O.C.

PROJECT # 21-3366-RH


to be brought to t Failure to do so w

docu Seal (Seque Any (imme void (Use o

P.A. 27609 Engineers, Drive, Raleigh, NC Southern Engi 3716 Benson Drive, Ra Phone: (919) 8

Roof Truss Version

S-2.

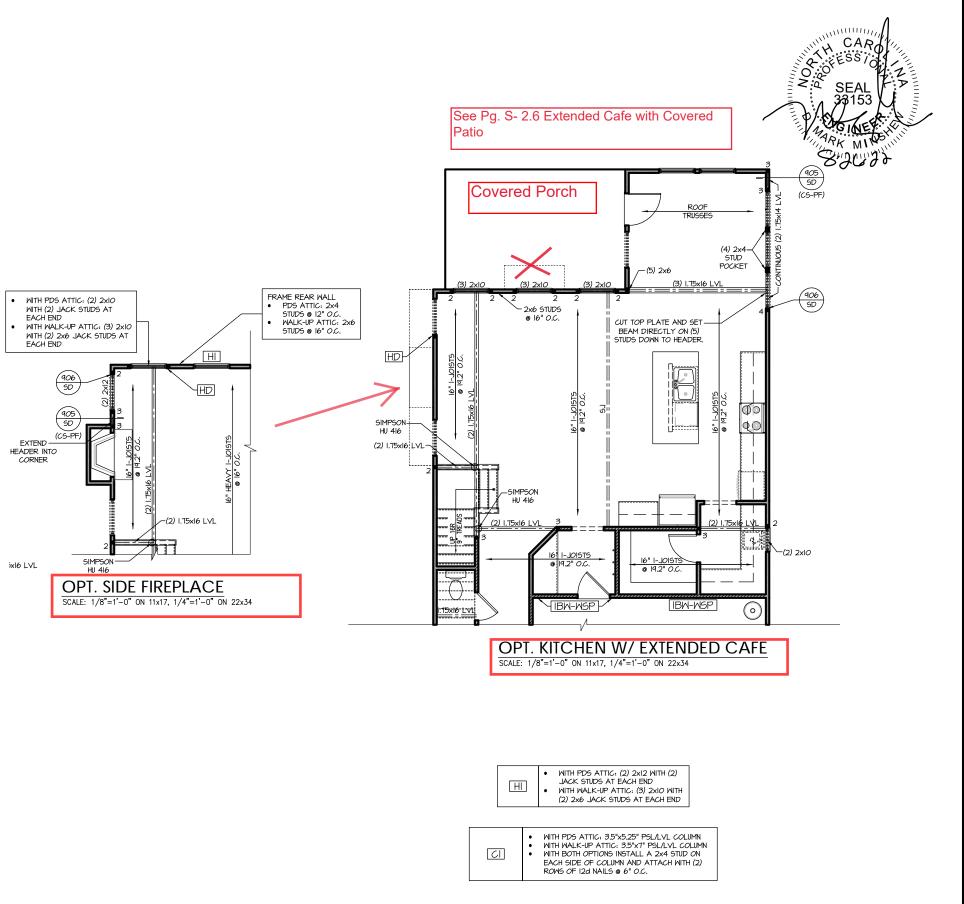

PROJECT #

21-3366-RH

Southern Engineers, P.A. 3716 Benson Drive, Raleigh, NC 27609 Phone: (919) 878-1617 License: C-4772 www.southernengineers.com

NEW HOME, INC.

SMITHFIELD

TRUSS SYSTEM REQUIREMENTS

NC (2018 NCRC): Wind: 115-120 mph

- TRUSS SYSTEM LAYOUTS (PLACEMENT PLANS) SHALL BE DESIGNED IN ACCORDANCE WITH SEALED STRUCTURAL PLANS. ANY NEED TO CHANGE TRUSSES SHALL BE COORDINATED WITH SOUTHERN ENGINEERS
- TRUSS SCHEMATICS (PROFILES) SHALL BE PREPARED AND SEALED BY TRUSS MANUFACTURER.
- ALL TRUSSES SHALL BE DESIGNED FOR BEARING ON SPF #2 OR #3 PLATES OR LEDGERS (UNO)
- ALL REQUIRED ANCHORS FOR TRUSSES DUE TO UPLIET OR BEARING SHALL MEET THE REQUIREMENTS AS SPECIFIED ON THE TRUSS SCHEMATICS.

HEADER/BEAM & COLUMN NOTES


- ALL EXTERIOR AND LOAD BEARING HEADERS SHALL BE MIN. (2)2x6 (4" WALL) OR (3)2x6 (6" WALL) WITH (I) SUPPORT STUD, UNLESS NOTED OTHERWISE.
- THE NUMBER SHOWN AT BEAM AND HEADER SUPPORTS INDICATES THE NUMBER OF SUPPORT STUDS REQUIRED IN STUD POCKET OR COLUMN. THE NUMBER OF KING STUDS AT EACH END OF HEADERS IN EXTERIOR WALLS SHALL BE ACCORDING TO ITEM "d" IN TABLE R602.3(5) OR AS BELOW PER NCDOI COMMENTARY "KING STUDS AT WALL OPENINGS" REVISED 1-9-2020:
- UP TO 3' SPAN: (I) KING STUD
- OVER 3' UP TO 6' SPAN: (2) KING STUDS OVER 6' UP TO 9' SPAN: (3) KING STUDS
- OVER 9' UP TO 12' SPAN: (4) KING STUDS
- OVER 12' UP TO 15' SPAN: (5) KING STUDS

FRAMING NOTES

NC (2018 NCRC): Wind: 115-120 mph

- BRACING METHOD AND TYPE: CONTINUOUSLY SHEATHED WSP: CS-WSP. NOTE THAT THE WALL BRACING AMOUNT PROVIDED ON THE PLANS (DETAILS AND SPECIFICATIONS) IS GREATER THAN THE AMOUNT OF WALL BRACING REQUIRED BY SECTION R602.10 OF THE CODE. SEE NOTES BELOW FOR DETAILS AND SPECIFICATIONS FOR WALL BRACING AND WALL FRAMING.
- EXTERIOR WALL SHEATHING: WALLS SHALL BE BRACED BY SHEATHING WALLS ON ALL STORIES WITH WOOD STRUCTURAL PANEL SHEATHING (WSP) (EXPOSURE B: 1/16". EXPOSURE C: 15/32"). SHEATHING SHALL BE ATTACHED WITH 8d NAILS AT A 6"/12" NAILING PATTERN (6" OC AT PANEL EDGES AND 12" OC AT INTERMEDIATE SUPPORTS). INSTALL BLOCKING AT ALL PANEL
- WSP SHEATHING SHALL EXTEND TO THE UPPERMOST DOUBLE BEARING PLATE. BLOCK AT ROOF PER SECTION R602.10.4.5 AND ATTACH BRACED WALLS PER CODE. MSP SHEATHING BETWEEN FLOORS SHALL BE SPLICED ALONG CONTINUOUS BAND OR THE WSP SHEATHING MAY BE SPLICED ACROSS STUDS (CONTINUOUS ACROSS FLOOR SYSTEM) WITH BLOCKING AT PANEL EDGES. (MINIMUM 12" BEYOND FLOOR BREAK) OR OTHER APPROVED
- 4. "HD" = HOLDOWN: HOLD-DOWN DEVICE (NOTED AS "HD" ON PLANS)
 SHALL BE AN 800 POUND CAPACITY ASSEMBLY AS NOTED ON
 PLANS. SEE DETAILS FOR HD ASSEMBLY.
- **GROUND/FIRST FLOOR: USE "HD HOLD-DOWN DETAIL" ON SD SHEET (OR EQUIV.)
- SHEET (OR EQUIV).

 **UPPER FLOORS: ATTACH BASE OF KING STUD WITH A SIMPSON
 C522 STRAP DOWN ACROSS THE BAND AND DOWN TO A STUD
 BELOW OR HEADER BELOW. EXTEND STRAP T" MIN ALONG EACH STUD (OR HEADER) AND ATTACH EACH END W (7) 8d NAILS.
- 5. INTERIOR BRACED WALL: (NOTED AS "IBM" ON PLANS) ATTACH I/2" GYPSUM BOARD (GB) ON EACH SIDE OF WALL WITH A MIN. OF 5d COOLER NAILS OR #6 SCREWS @ 7" O.C. ALONG THE EDGES AND AT INTERMEDIATE SUPPORTS.
- 6. INTERIOR BRACED WALL-WOOD STRUCTURAL PANEL: (NOTED AS "IBW-MSP" ON PLANS), ATTACH ONE SIDE WITH 7/6" WSP SHEATHING WITH 8/3 NAILS AT A 6"/12" NAILING PATTERN (6" OC AT PANEL EDGES AND 12" OC AT INTERMEDIATE SUPPORTS). INSTALL BLOCKING AT ALL PANEL EDGES. ATTACH GB OVER WSP AS REQUIRED. ATTACH OPPOSITE SIDE WITH 1/2" GB WITH A MIN. OF 5d COOLER NAILS OR #6 SCREWS @ 7" OC ALONG THE EDGES AND AT INTERMEDIATE SUPPORTS.

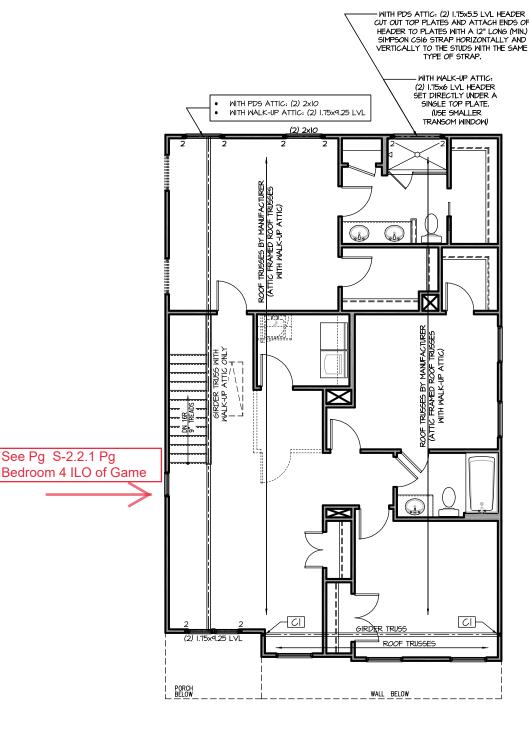

- WITH PDS ATTIC: (6) 2x4 COLUMN. ATTACH EACH STUD WITH (2) I2d NAILS @ 6" O.C.

 WITH WALK-UP ATTIC: 3.5"x7" PSL/LVL COLUMN
- INSTALL A 2x4 STUD ON EACH SIDE OF COLUMN AND ATTACH WITH (2) ROWS OF 12d NAILS @ 6" O.C.

HOME,

NEW

PROJECT # 21-3366-RH

e to be brought to t Failure to do so wi

P.A. 27609

Southern Engineers, F 3716 Benson Drive, Raleigh, NC 2 Phone: (919) 878-1617


SMITHFIELD

SECOND FLOOR PLAN 'FRENCH COUNTRY'

SCALE: 1/8"=1'-0" ON 11x17, 1/4"=1'-0" ON 22x34

Roof Truss Version



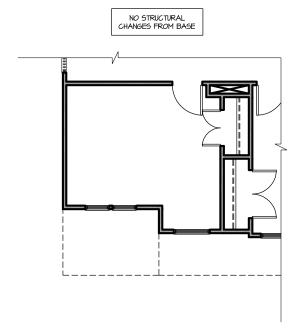

OPT. BEDROOM 4 I.L.O. GAMEROOM
SCALE: 1/8"=1'-0" ON 11x17, 1/4"=1'-0" ON 22x34



Southern Engineers, P.A. Seadocum 3716 Benson Drive, Raleigh, NC 27609 Any de Phone: (919) 878-1617

PROJECT # 21-3366-RH


NEW HOME, INC. $\frac{371}{1}$


| NEW H


SMITHFIELD Garan Birth


Roof Truss Version


S-2.2.

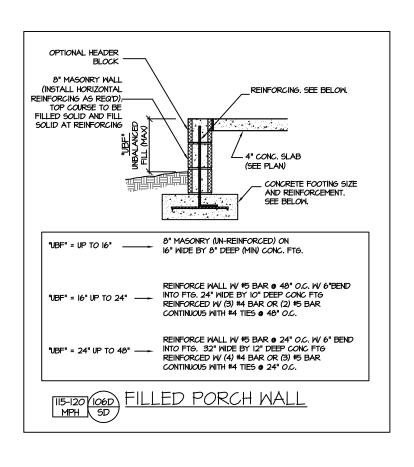


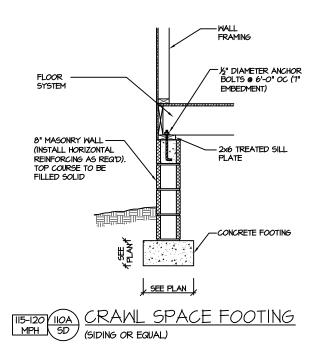

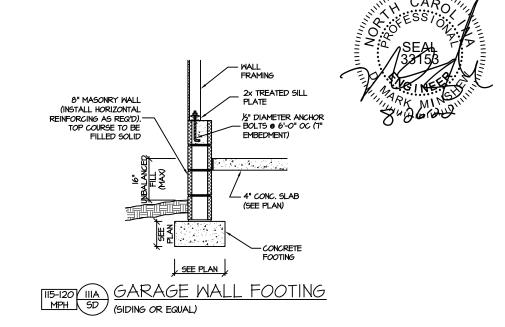

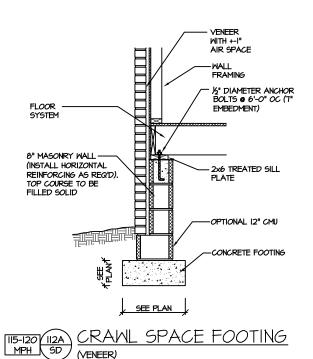

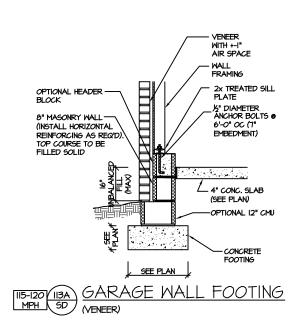

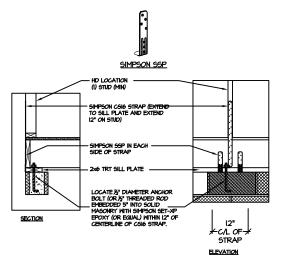

BRACED WALL END CONDITION " HD"

HOLD-DOWN DETAIL

NOTE: SIMPSON DTT-IZ IS ACCEPTABLE ALTERNATE
NOTE: ALTERNATE HD HOLD-DOWN DEVICES OR SYSTEMS MAY
BE USED TO MEET THE CODE REQUIRED 800 LB CAPACITY IN
LIEU OF THE ABOVE DETAIL.

CRAWL SPACE FOUNDATION

PROJECT # 21-3366

s are to be brought to the cers. Failure to do so will contain from date of seal.


I does not include construction means, methods, techni unences, procedures or safety precautions. y deviations or distrepancies on plans are to be brought ordate attention of Southern Engineers. Failure to do d Southern Engineers' liability.

Southern Engineers, P.A. 3716 Benson Drive, Raleigh, NC 27609 Phone: (919) 878-1617 License: C-4772

www.southernengineers.com

NEW HOME, INC.

SMITHFIELD PLAN

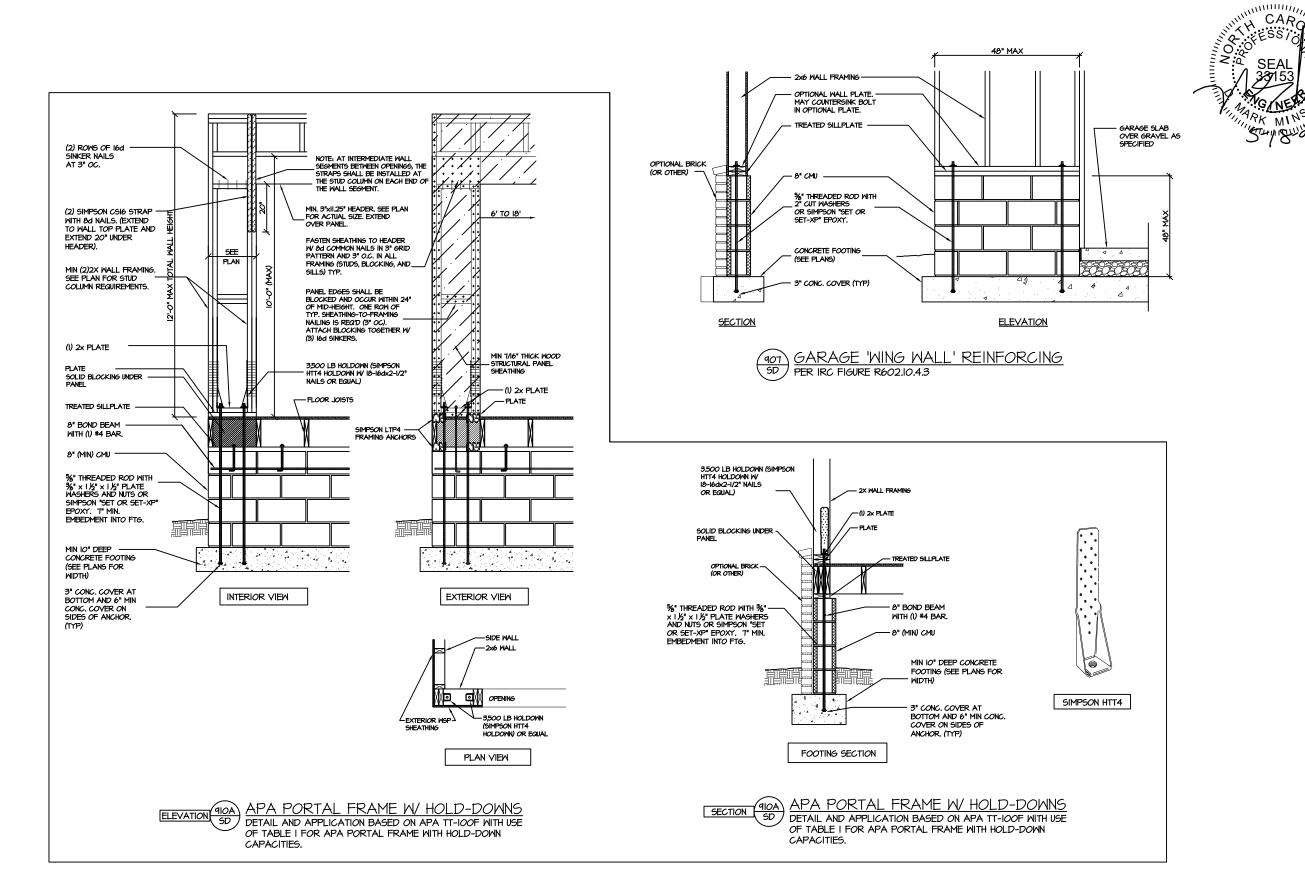

PROJECT # 21-3366

CARO

PK MINE


ude construction means, methods, techniques, ures or safety precautions. discrepancies on plans are to be brought to the on of Southern Engineers. Failure to do so will gineer is lability.


P.A. 27609 Southern Engineers, P. 3716 Benson Drive, Raleigh, NC 277 Phone: (919) 878-1617 License: C-4772 www.southernengineers.com

NEW HOME,


PLAN SMITHFIELD



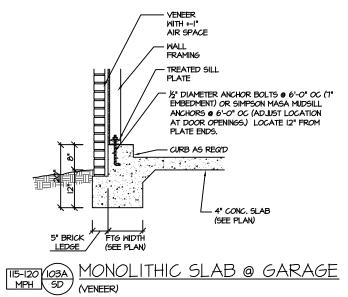


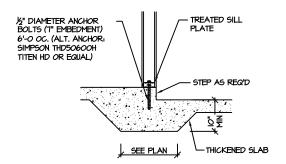


THICKENED SLAB @ GARAGE | 115-120 | 105A | MPH | SD (INTERIOR GARAGE WALL)

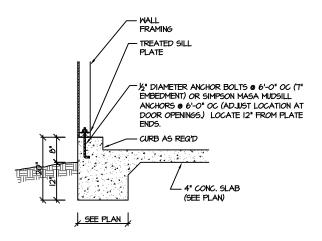


MONOLITHIC SLAB @ GARAGE (SIDING OR EQUAL)

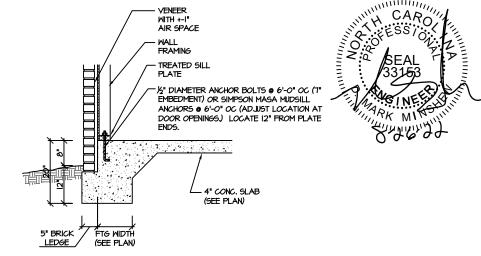

MONOLITHIC SLAB FOOTING (VENEER)

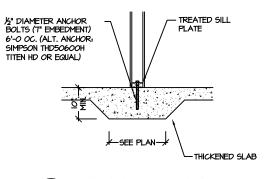

THICKENED SLAB (INTERIOR READING MALL)

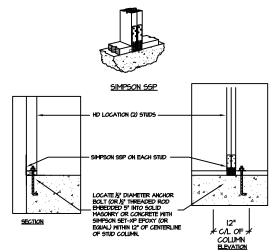

BRACED WALL END CONDITION "HD" HOLD-DOWN DETAIL

NOTE: SIMPSON DTT-IZ IS ACCEPTABLE ALTERNATE NOTE: ALTERNATE HD HOLD-DOWN DEVICES OR SYSTEMS MAY BE USED TO MEET THE CODE REQUIRED 800 LB CAPACITY IN LIEU OF THE ABOVE DETAIL.

SLAB FOUNDATION


PROJECT # 21-3366


P.A. 27609 Southern Engineers, P 3716 Benson Drive, Raleigh, NC 27 Phone: (919) 878-1617 License: C-4772


www.southernengineers.com

INC. NEW HOME,

PLAN SMITHFIELD

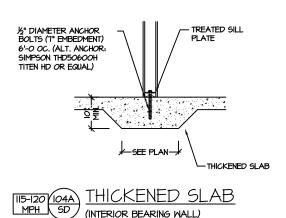

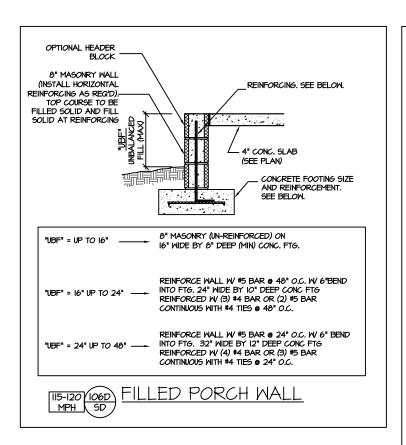

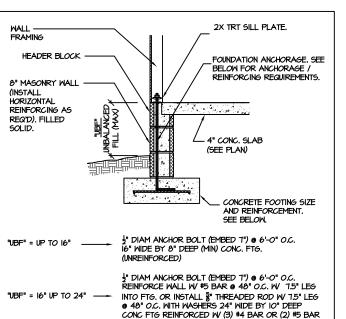

CONTINUOUS WITH #4 TIES @ 48" O.C.

"UBF" = 24" UP TO 48" ----


½" DIAM ANCHOR BOLT (EMBED T") @ 6'-0" O.C. REINFORCE WALL W #5 BAR @ 24" O.C. W 15" LEG INTO FTG. OR INSTALL № THREADED ROD W 1.5" LEG @ 24" O.C. WITH WASHERS 24" WIDE BY 10" DEEP

CONC FTG REINFORCED W (3) #4 BAR OR (2) #5 BAR CONTINUOUS WITH #4 TIES @ 24" O.C.


STEM WALL SLAB FOOTING


(SIDING OR EQUAL)




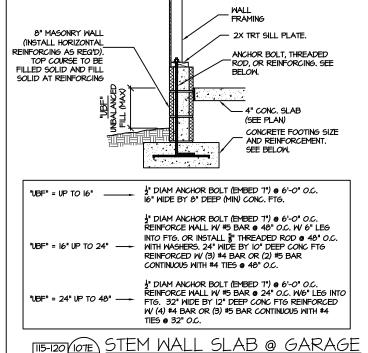

(SIDING OR EQUAL)

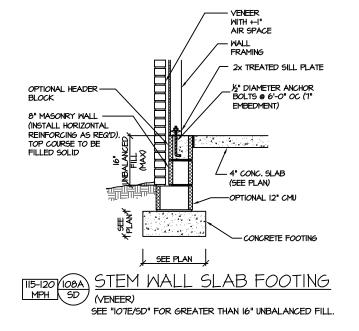

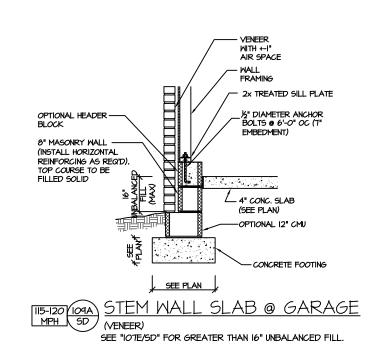

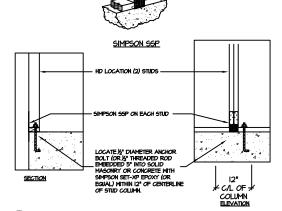

BRACED WALL END CONDITION "HD" HOLD-DOWN DETAIL

115-120 107E MPH SD

NOTE: SIMPSON DTT-IZ IS ACCEPTABLE ALTERNATE NOTE: ALTERNATE HD HOLD-DOWN DEVICES OR SYSTEMS MAY BE USED TO MEET THE CODE REQUIRED 800 LB CAPACITY IN LIEU OF THE ABOVE DETAIL.

STEM WALL SLAB FOUNDATION

PROJECT # 21-3366

P.A. 27609

Southern Engineers, P 3716 Benson Drive, Raleigh, NC 2' Phone: (919) 878-1617 License: C-4772

www.southernengineers.com

NEW HOME,

PLAN SMITHFIELD


PROJECT # 21-3366


Engineers, Drive, Raleigh, NC : e: (919) 878-1617 nson Drive, R. Phone: (919) Southern 3716 Benson D

CARO

STRUCTURAL NOTES NC (2018 NCRC): Wind: 115-120 mph


- ENGINEER'S SEAL APPLIES ONLY TO STRUCTURAL COMPONENTS INCLUDING ROOF RAFTERS, HIPS, VALLEYS, RIDGES, FLOORS, WALLS, BEAMS AND HEADERS, COLUMNS, CANTILEVERS, OFFSET LOAD BEARING WALLS, PIER & GIRDER SYSTEM, FOOTING, AND PILING SYSTEM. ENGINEER'S SEAL DOES NOT CERTIFY DIMENSIONAL ACCURACY OR ARCHITECTURAL LAYOUT INCLUDING ROOF SYSTEM, ALL REQUIREMENTS FOR PROFESSIONAL CERTIFICATION SHALL BE PROVIDED BY THE APPROPRIATE PROFESSIONAL. SOUTHERN ENGINEERS, P.A. CERTIFIES ONLY THE STRUCTURAL COMPONENTS AS SPECIFICALLY STATED.
- ALL CONSTRUCTION SHALL CONFORM TO THE LATEST REQUIREMENTS OF THE 2018 NC RESIDENTIAL CODE, PLUS ALL LOCAL CODES AND REGULATIONS. THE STRUCTURAL ENGINEER IS NOT RESPONSIBLE FOR, AND WILL NOT HAVE CONTROL OF, CONSTRUCTION MEANS, METHODS, TECHNIQUES, SEQUENCES OR PROCEDURES, OR FOR SAFETY PRECAUTIONS AND PROGRAMS IN CONNECTION WITH THE CONSTRUCTION MORK, NOR WILL THE ENGINEER BE RESPONSIBLE FOR THE CONTRACTOR'S FAILURE TO CARRY OUT THE CONSTRUCTION WORK IN ACCORDANCE WITH THE CONTRACT DOCUMENTS. "CONSTRUCTION REVIEW" SERVICES ARE NOT PART OF OUR CONTRACT.
 ALL MEMBERS SHALL BE FRAMED ANCHORED, TIED AND BRACED IN ACCORDANCE WITH GOOD CONSTRUCTION PRACTICE AND THE BUILDING CODE.
- DESIGN LOADS (LISTED AS: LIVE LOAD, DEAD LOAD, DEFLECTION)
- ROOMS OTHER THAN SLEEPING ROOMS: (40 PSF, IO PSF, L/360)
- SLEEPING ROOMS: (30 PSF, IO PSF, L/360)
- ATTIC WITH PERMANENT STAIR: (40 PSF, IO PSF, L/360)
- ATTIC WITHOUT PERMANENT STAIR: (20 PSF, IO PSF, L/360) ATTIC WITHOUT STORAGE: (10 PSF, 10 PSF, L/240)
- STAIRS: (40 PSF, IO PSF, L/360)
- EXTERIOR BALCONIES: (60 PSF, IO PSF, L/360)
- DECKS: (40 PSF, 10 PSF, L/360) GUARDRAILS AND HANDRAILS: (200 LBS)
- PASSSENGER VEHICLE GARAGES: (50 PSF, IO PSF, L/360)
- FIRE ESCAPES: (40 PSF, IO PSF, L/360)
- SNOW: (20 PSF)
- 4. WALLS SHALL BE BRACED BY SHEATHING WALLS ON ALL STORIES WITH WOOD STRUCTURAL PANELS. SEE FRAMING NOTES FOR THICKNESS AND NAILING REQUIREMENTS
- 5. SEE APPENDIX M (DCA6) FOR EXTERIOR DECK REQUIREMENTS INCLUDING ATTACHMENTS FOR LATERAL LOADS.
- 6. CONCRETE SHALL HAVE A MINIMUM 28 DAY STRENGTH OF 3000 PSI AND A MAXIMUM SLUMP OF 5 INCHES UNLESS NOTED OTHERWISE (UNO). AIR ENTRAINED PER TABLE 402.2. ALL CONCRETE SHALL BE PROPORTIONED MIXED HANDLED SAMPLED TESTED AND PLACED IN ACCORDANCE WITH ACI STANDARDS. ALL SAMPLES FOR PUMPING SHALL BE TAKEN FROM THE EXIT END OF THE PUMP, CONTROL JOINTS IN SLABS SHALL BE SPACED ON A GRID OF +-30 TIMES THE DEPTH (D). CONTROL JOINTS SHALL BE SAWCUT TO A DEPTH OF I/D. (I.E. 4" CONCRETE SLABS SHALL HAVE 1/4" DEEP CONTROL JOINTS SAWOUT IN SLAB ON A +-10'-0" x +-10'-0" GRID).
- ALLOMABLE SOIL BEARING PRESSURE ASSUMED TO BE 2000 PSF. THE CONTRACTOR MUST CONTACT A GEOTECHNICAL ENGINEER AND THE STRUCTURAL ENGINEER IF UNGATISFACTORY SUBSURFACE CONDITIONS ARE ENCOUNTERED. THE SURFACE AREA ADJACENT TO THE FOUNDATION WALL SHALL BE PROVIDED WITH ADEQUATE DRAINAGE, AND SHALL BE GRADED SO AS TO DRAIN SURFACE WATER AWAY FROM FOUNDATION WALLS.
- 8. ALL FRAMING LUMBER SHALL BE SPF #2 (Fb = 875 PSI) UNLESS NOTED OTHERWISE (UNO). ALL TREATED LUMBER SHALL BE SYP # 2. PLATE MATERIAL MAY BE SPF # 3 OR SYP #3 (Fc(perp) =
- 9. L.V.L. SHALL BE LAMINATED VENEER LUMBER: Fb=2600 PSI, Fv=285 PSI, E=I.9xi0 PSI. P.S.L. SHALL BE PARALLEL STRAND LUMBER: Fb=2400 PSI, Fv=240 PSI, E=2.0xl0 PSI. L.S.L. SHALL BE LAMINATED STRAND LUMBER: Fb=2250 PSI, Fv=400 PSI, E=1.55xl0 PSI. INSTALL ALL CONNECTIONS PER MANUFACTURERS INSTRUCTIONS.
- IO. ALL ROOF TRUSS AND I-JOIST LAYOUTS SHALL BE PREPARED IN ACCORDANCE WITH THE SEALED STRUCTURAL DRAWINGS, TRUSSES AND I-JOISTS SHALL BE INSTALLED ACCORDING TO THE MANUFACTURE'S SPECIFICATIONS, ANY CHANGE IN TRUSS OR I-JOIST LAYOUT SHALL BE COORDINATED WITH SOUTHERN ENGINEERS.
- ALL STRUCTURAL STEEL SHALL BE ASTM A-36. STEEL BEAMS SHALL BE SUPPORTED AT EACH END WITH A MINIMUM BEARING LENGTH OF 3 1/2" INCHES AND FULL FLANGE WIDTH, PROVIDE SOLID BEARING FROM BEAM SUPPORT TO FOUNDATION. BEAMS SHALL BE ATTACHED TO EACH SUPPORT WITH TWO LAG SCREWS (I/2" DIAMETER x 4" LONG). LATERAL SUPPORT IS CONSIDERED ADEQUATE PROVIDING THE JOIST ARE TOE NAILED TO THE SOLE PLATE, AND SOLE PLATE IS NAILED OR BOLTED TO THE BEAM FLANGE @ 48" O.C. ALL STEEL TUBING SHALL BE ASTM A500.
- 12. REBAR SHALL BE DEFORMED STEEL, ASTM615, GRADE 60. LAP ALL REBAR SPLICES 30 BAR DIAMETERS.
- 13. FLITCH BEAMS SHALL BE BOLTED TOGETHER USING (2) ROWS OF 1/2" DIAMETER BOLTS (ASTM A325) WITH WASHERS PLACED UNDER THE THREADED END OF BOLT. BOLTS SHALL BE SPACED AT 24" O.C. (MAX), AND STAGGERED AT THE TOP AND BOTTOM OF BEAM (2" EDGE DISTANCE), WITH 2 BOLTS LOCATED AT 6" FROM EACH END.
- 14. BRICK LINTELS (WHEN REQUIRED) SHALL BE 3 1/2"x3 1/2"x1/4" STEEL ANGLE FOR UP TO 6'-0" SPAN AND 6"x4"x5/16" STEEL ANGLE WITH 6" LEG VERTICAL FOR SPANS UP TO 9'-0". SEE PLANS FOR SPANS OVER 4'-0". SEE ALSO SECTION R703.8.3 LINTELS.

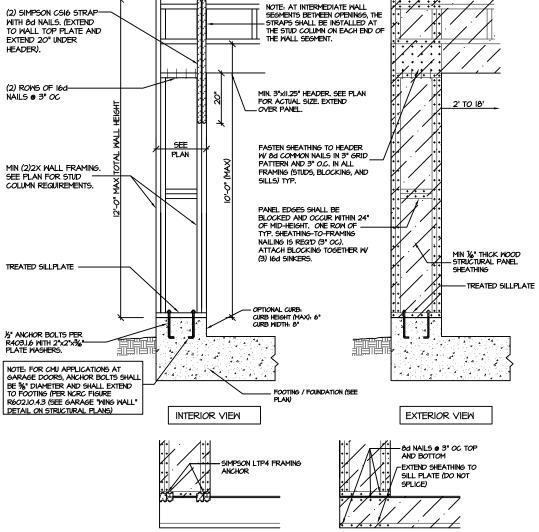

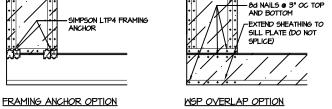

CS-PF - OVER WOOD FLOOR

<u>CS-PF: CONTINUOUS PORTAL FRAME</u> CONSTRUCTION DETAIL AND APPLICATION BASED ON NORC FIGURE R602.10.1 - PORTAL FRAME CONSTRUCTION

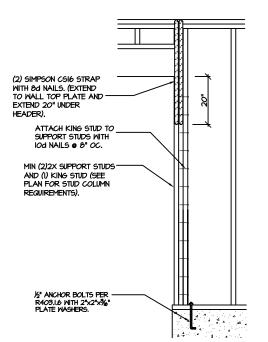

CS-PF: END CONDITION DETAIL (FOR USE WITH SINGLE CS-PF CONDITION) DETAIL AND APPLICATION BASED ON NORC FIGURE R602.IO.I - PORTAL FRAME CONSTRUCTION