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E: DIVINEHOMESTEADDESIGN@GMAIL.COM
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## SHEET LIST:


<u> </u>	<u></u> _
T1.1	COVER SHEET
<b>S1.1</b>	<b>FOUNDATION PLAN</b>
A1.1	<b>1ST FLOOR PLAN</b>
A1.2	2ND FLOOR PLAN
A1.3	SCHEDULES
A2.1	<b>EXTERIOR ELEVATIONS</b>
A2.2	<b>EXTERIOR ELEVATIONS</b>
A3.1	<b>BUILDING SECTIONS</b>

A3.3 ROOF PLAN

A3.2

E1.1 1ST FLR. ELECTRICAL PLANE1.2 2ND FLR. ELECTRICAL PLAN

**WALL SECTIONS** 

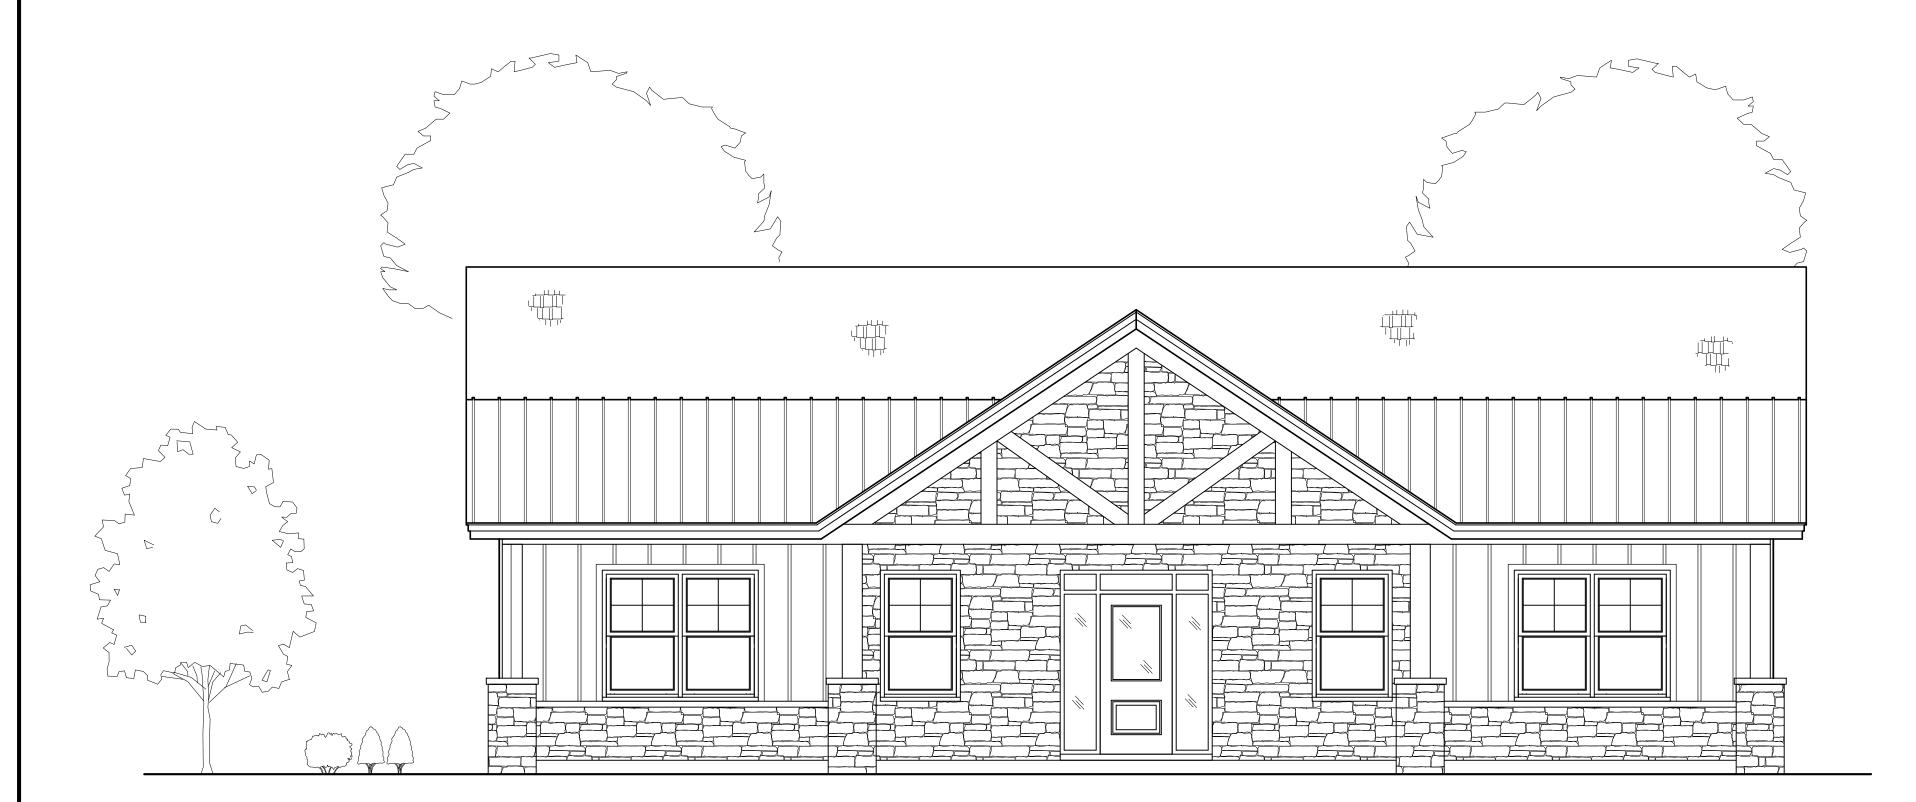



# AREA NOTES:

- \* FIRST FLOOR = 1,497 HEATED SQ FT
- \* OPTIONAL LOFT = 334 HEATED SQ FT
- \* FRONT COVERED PORCH = 335 SQ FT
- \* SCREENED PORCH = 174 SQ FT\* REAR COVERED PORCH = 372 SQ FT

## **GENERAL NOTES**

- 1. CONTRACTOR TO VERIFY ALL EXISTING CONDITIONS, DIMENSIONS, ETC... AND NOTIFY DESIGNER OF ANY DISCREPANCIES PRIOR TO START OF CONSTRUCTION. ANY ITEMS NOT REPORTED SHALL BE CONSIDERED VERIFIED AND ACCEPTED BY THE CONTRACTOR.
- 2. ALL STRUCTURAL COMPONENTS TO BE DETERMINED BY OTHERS AND SHALL NOT BE THE RESPONSIBILITY OF THE DESIGNER.
- ALL LOAD BEARING WALLS, BEAMS, AND RAFTER BRACING SHOULD CARRY LOADS THRU ALL LEVELS TO FOUNDATION AND BE SUPPORTED BY GRADE BEAMS OR FOOTINGS DESIGNED TO CARRY LOADS.
- FLOOR AND ROOF TRUSS DRAWINGS MUST BE PROVIDED BY MANUF.
   ALL CONSTRUCTION SHALL CONFORM TO ALL FEDERAL, STATE AND LOCAL CODES AND ORDINANCES CURRENTLY IN EFFECT, PLANS DESIGNED TO MEET IRC 2018.
- CONTRACTOR TO PROTECT ALL EXISTING FINISHED ITEMS TO REMAIN, INCLUDING BUT NOT LIMITED TO FLOORS, WALLS, CEILINGS, MILLWORK, FIXTURES, ETC...
   VERIFY FLOOR ELEVATIONS ON BOTH SIDES OF PARTITIONS BEING
- REMOVED. PREPARE FLOOR AS REQUIRED FOR SMOOTH LEVEL FLOOR CONDITION AS APPLICABLE FOR FINISH BEING INSTALLED.

  8. REPAIR AND/OR REPLACE ANY ITEMS DAMAGED DURING DEMOLITION OR
- CONSTRUCTION. DOCUMENT ANY EXISTING DAMAGE PRIOR TO THE START OF DEMOLITION/CONSTRUCTION WITH PHOTOGRAPHIC EVIDENCE.

  9. ALL PLUMBING, MECHANICAL AND ELECTRICAL WORK SHALL BE
- DESIGNED/CONSTRUCTED BY LICENSED SUBCONTRACTORS TO MEET ALL FEDERAL, STATE AND LOCAL CODES.

  10. IF CONFLICTS WITH OTHER TRADES ARISE NOTIFY THE GENERAL
- CONTRACTOR IMMEDIATELY TO RESOLVE.


  11. ALL APPLICABLE PRODUCTS SUCH AS FINISHES, FIXTURES, WINDOWS, DOORS, ETC. MUST BE SUBMITTED IN WRITING TO THE GENERAL
- CONTRACTOR FOR APPROVAL.

  12. ALL DIMENSIONS SHOULD BE READ OR CALCULATED AND NEVER SCALED.

  13. SQUARE FOOTAGE CALCULATIONS ARE MADE FROM THE OUTSIDE OF THE
- EXTERIOR FRAME WALL.

  14. DIVINE HOMESTEAD DESIGN ASSUMES NO LIABILITY FOR ANY CHANGES OR MODIFICATIONS MADE TO THESE PLANS BY OTHERS.
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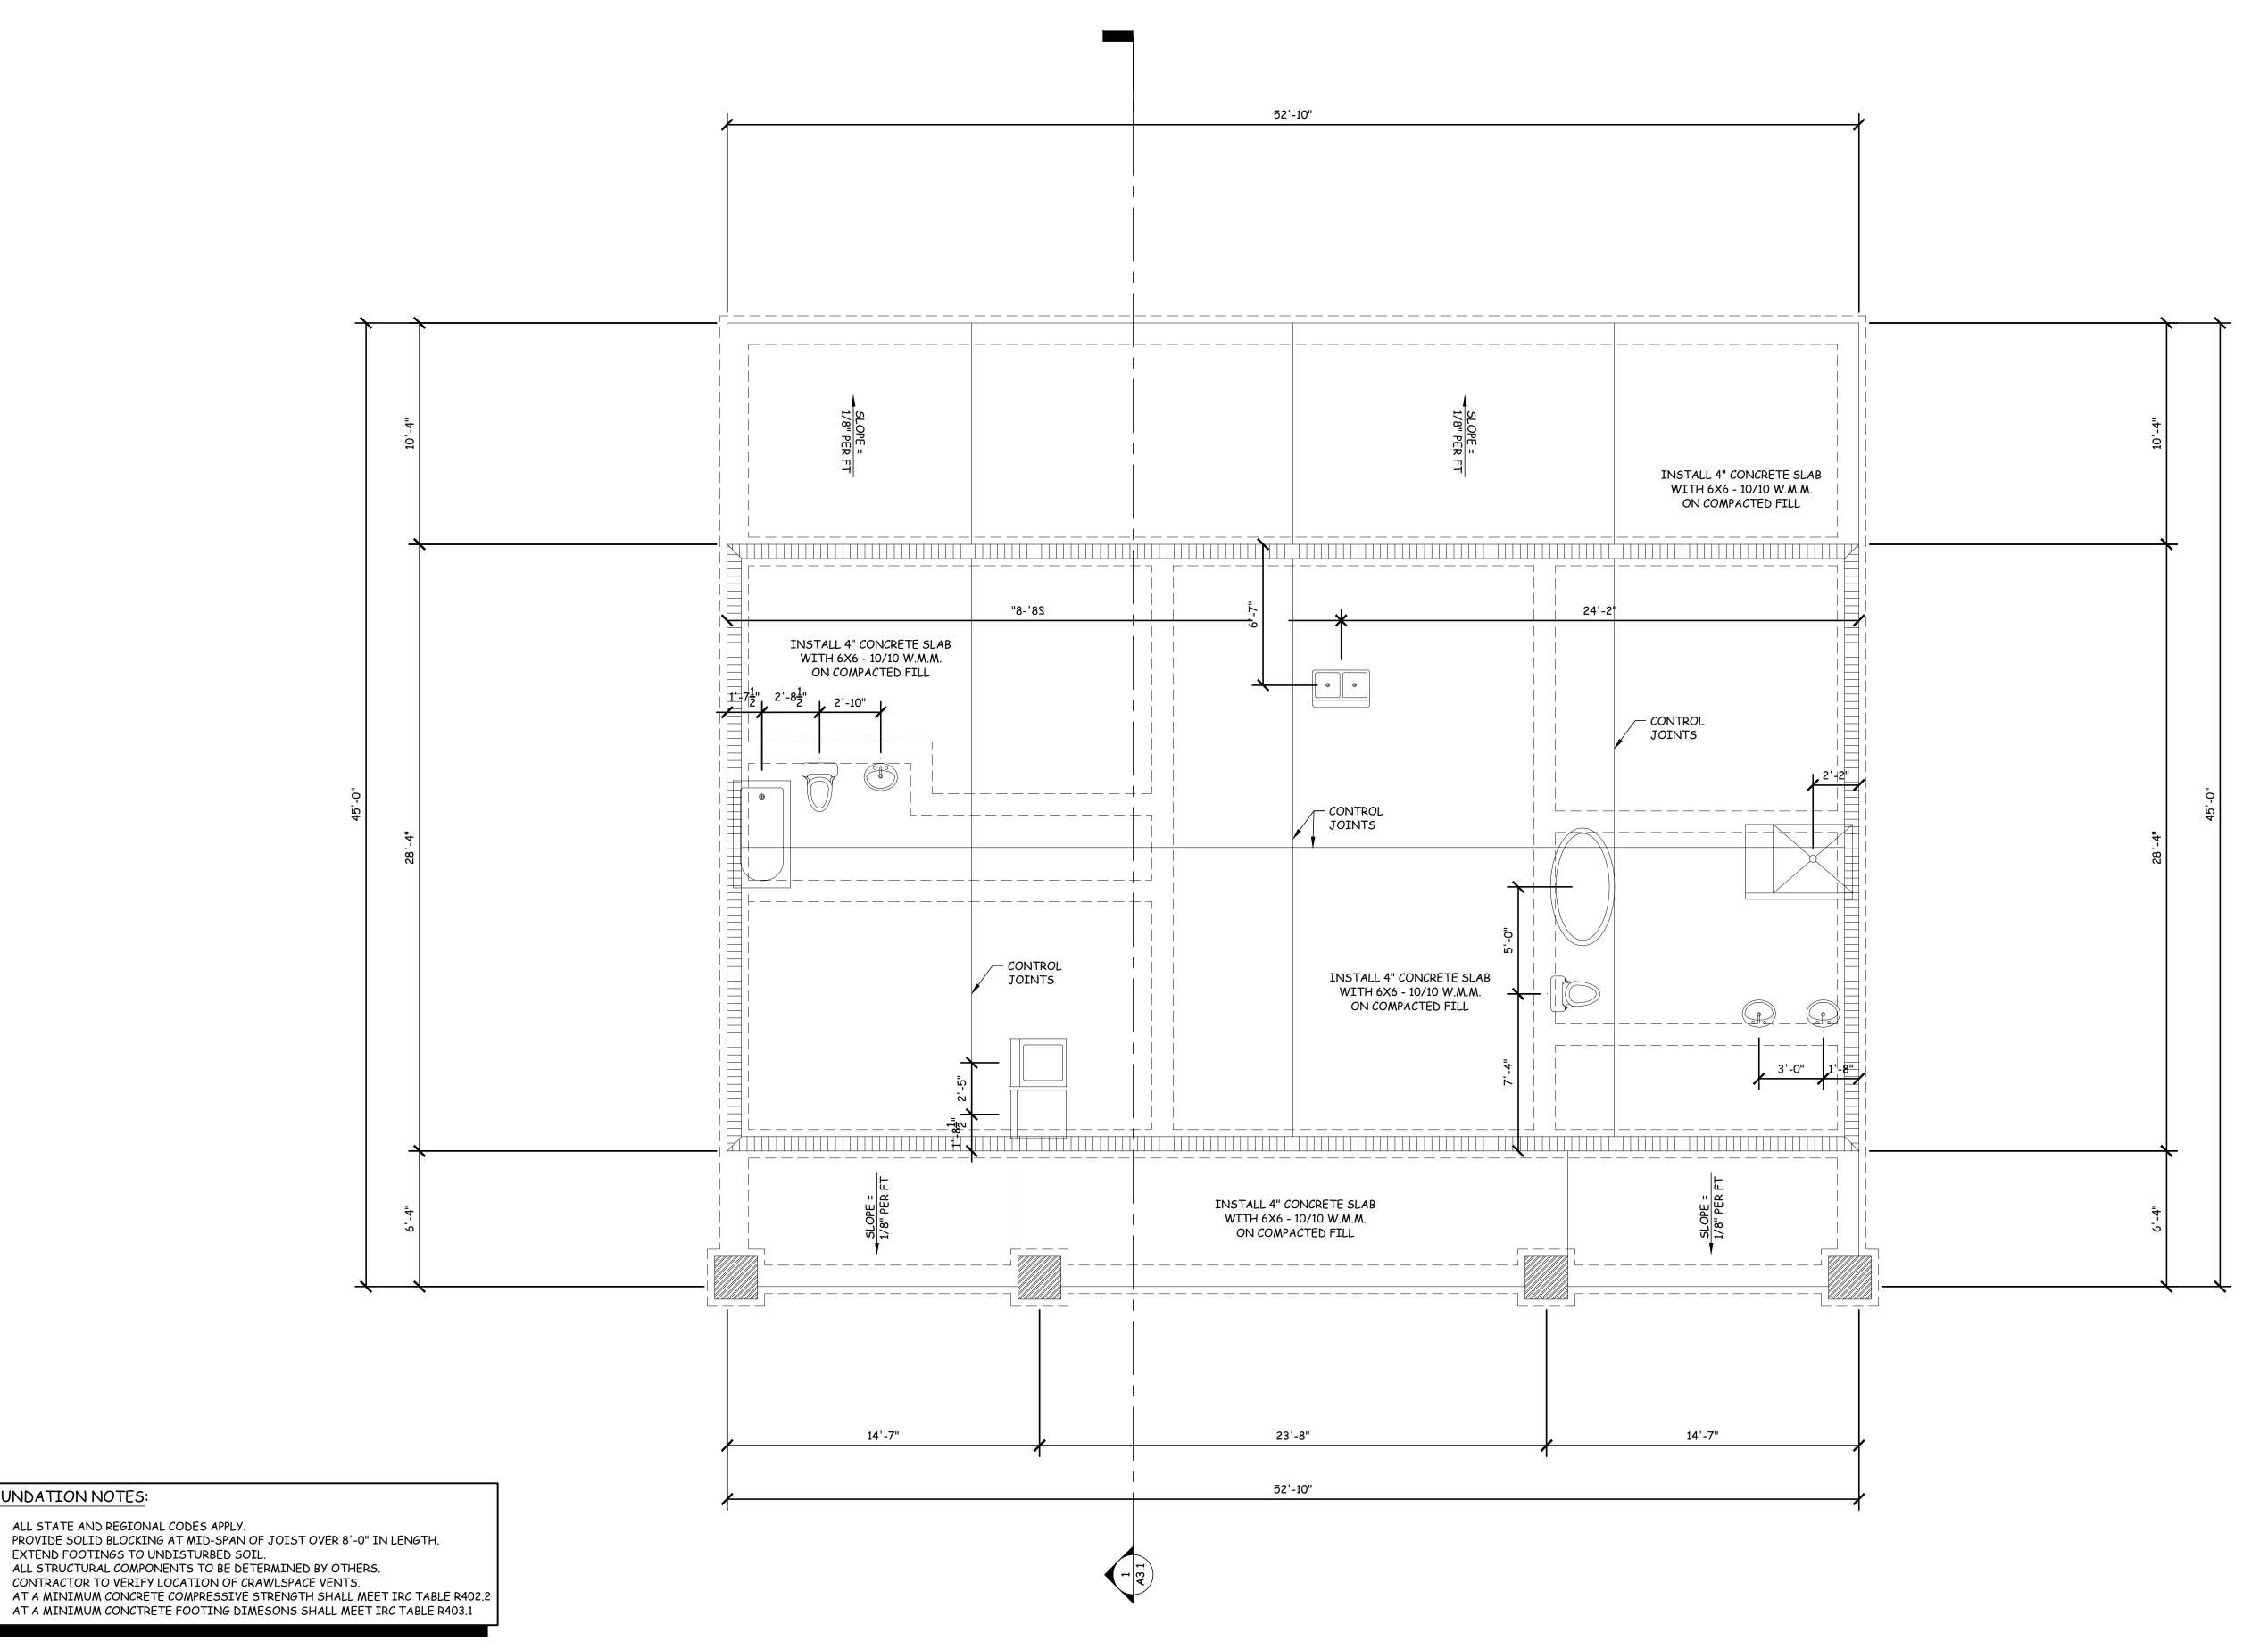
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Drawn By: DAH
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Date: 05/25/2023 Size: 24" x 36"

Sheet Title :
COVER SHEET

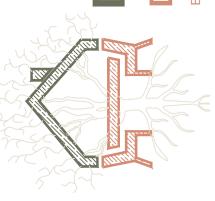Sheet Number:

T1.1



FOUNDATION PLAN
-/-|s1.1

1/4" = 1'-0"

FOUNDATION NOTES:

DIMENSION NOTES:

NOTED OTHERWISE

ALL STATE AND REGIONAL CODES APPLY.

EXTEND FOOTINGS TO UNDISTURBED SOIL.

ALL OUTER DIMENSIONS ARE TO OUTSIDE OF FRAMING UNLESS

ALL DIMENSIONS ARE ROUNDED TO THE NEAREST 1/2 INCH FOR

EASE OF READING CONSTRUCTION DRAWINGS. CONTRACTOR TO VERIFY CRITICAL MEASUREMENTS IN THE FIELD WITH GREATER PRECISION AND NOTIFY THE DESIGNER IF ANY CONCERNS ARISE.

FOUNDATION LEGEND



= 8" BLOCK WALL

THIS DRAWING SHALL BE CONSIDERED DIAGRAMMATIC & SCHEMATIC IN NATURE. IT SHALL BE THE RESPONSIBILITY OF THE RESPECTIVE SUBCONTRACTOR TO ENSURE ADEQUATE REINFORCEMENT, FOUNDATIONS AND STRUCTURAL COMPONENTS ARE PROVIDED.

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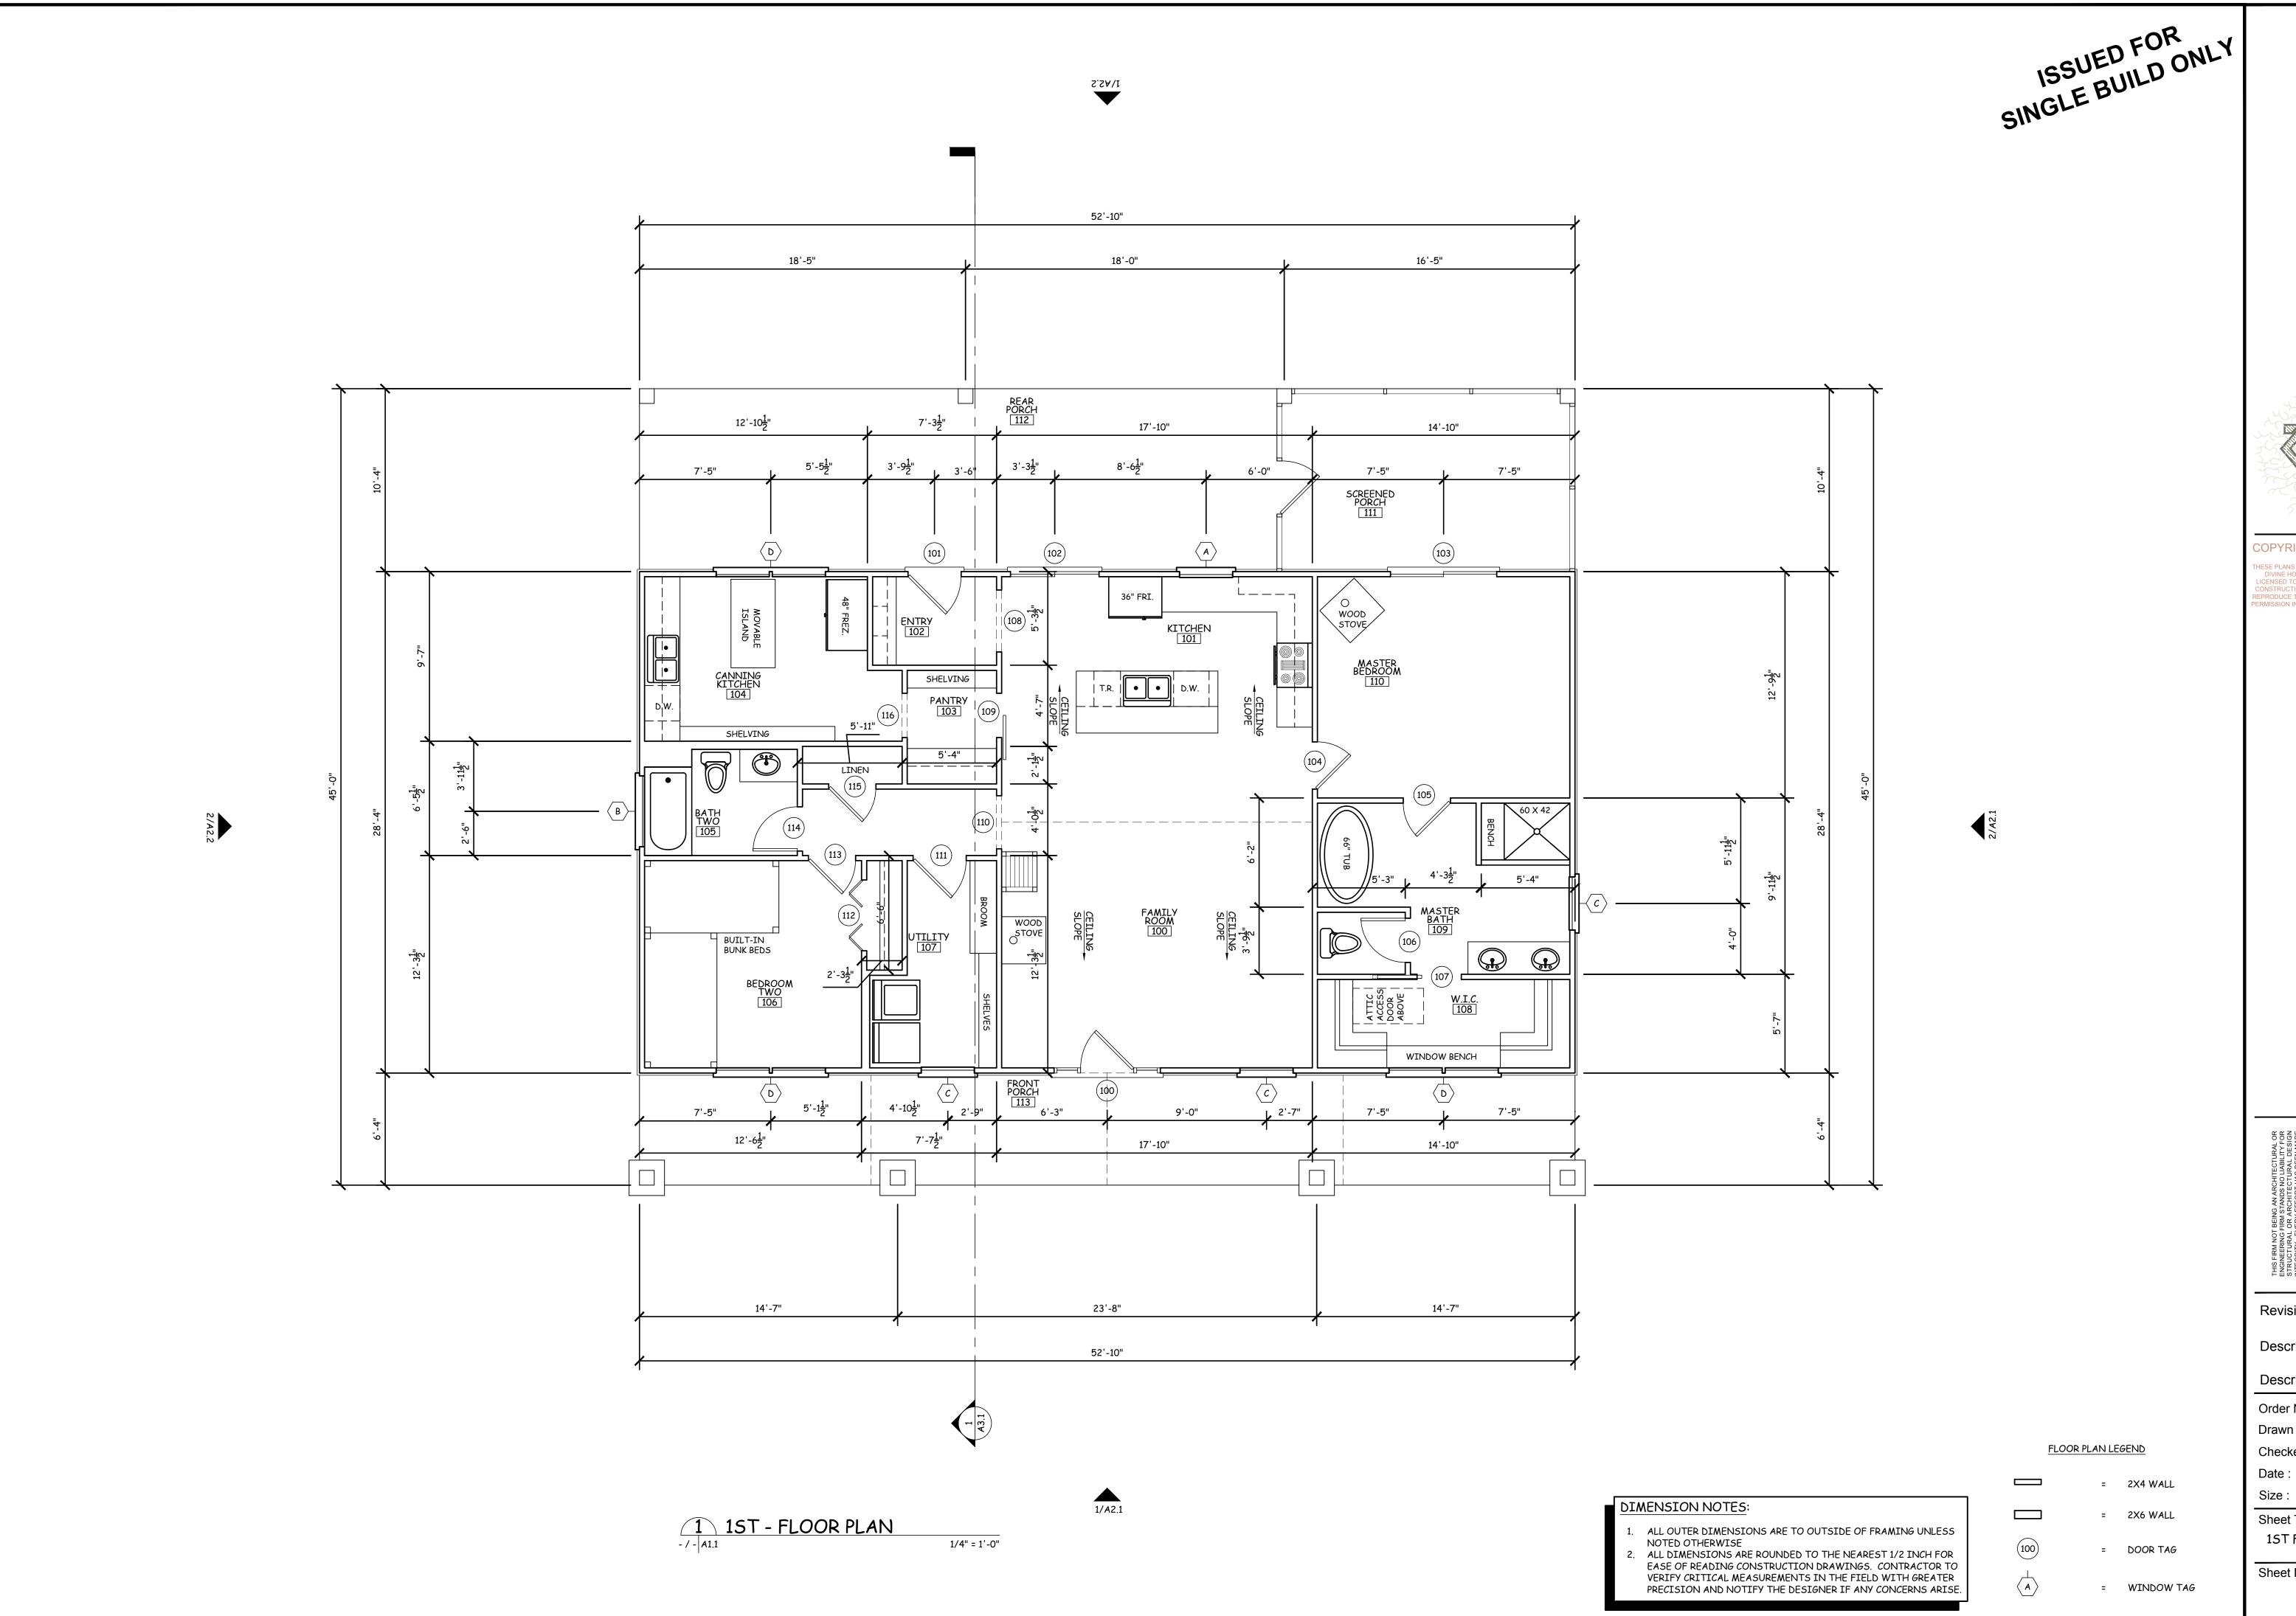
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FOUNDATION PLAN

Sheet Number:



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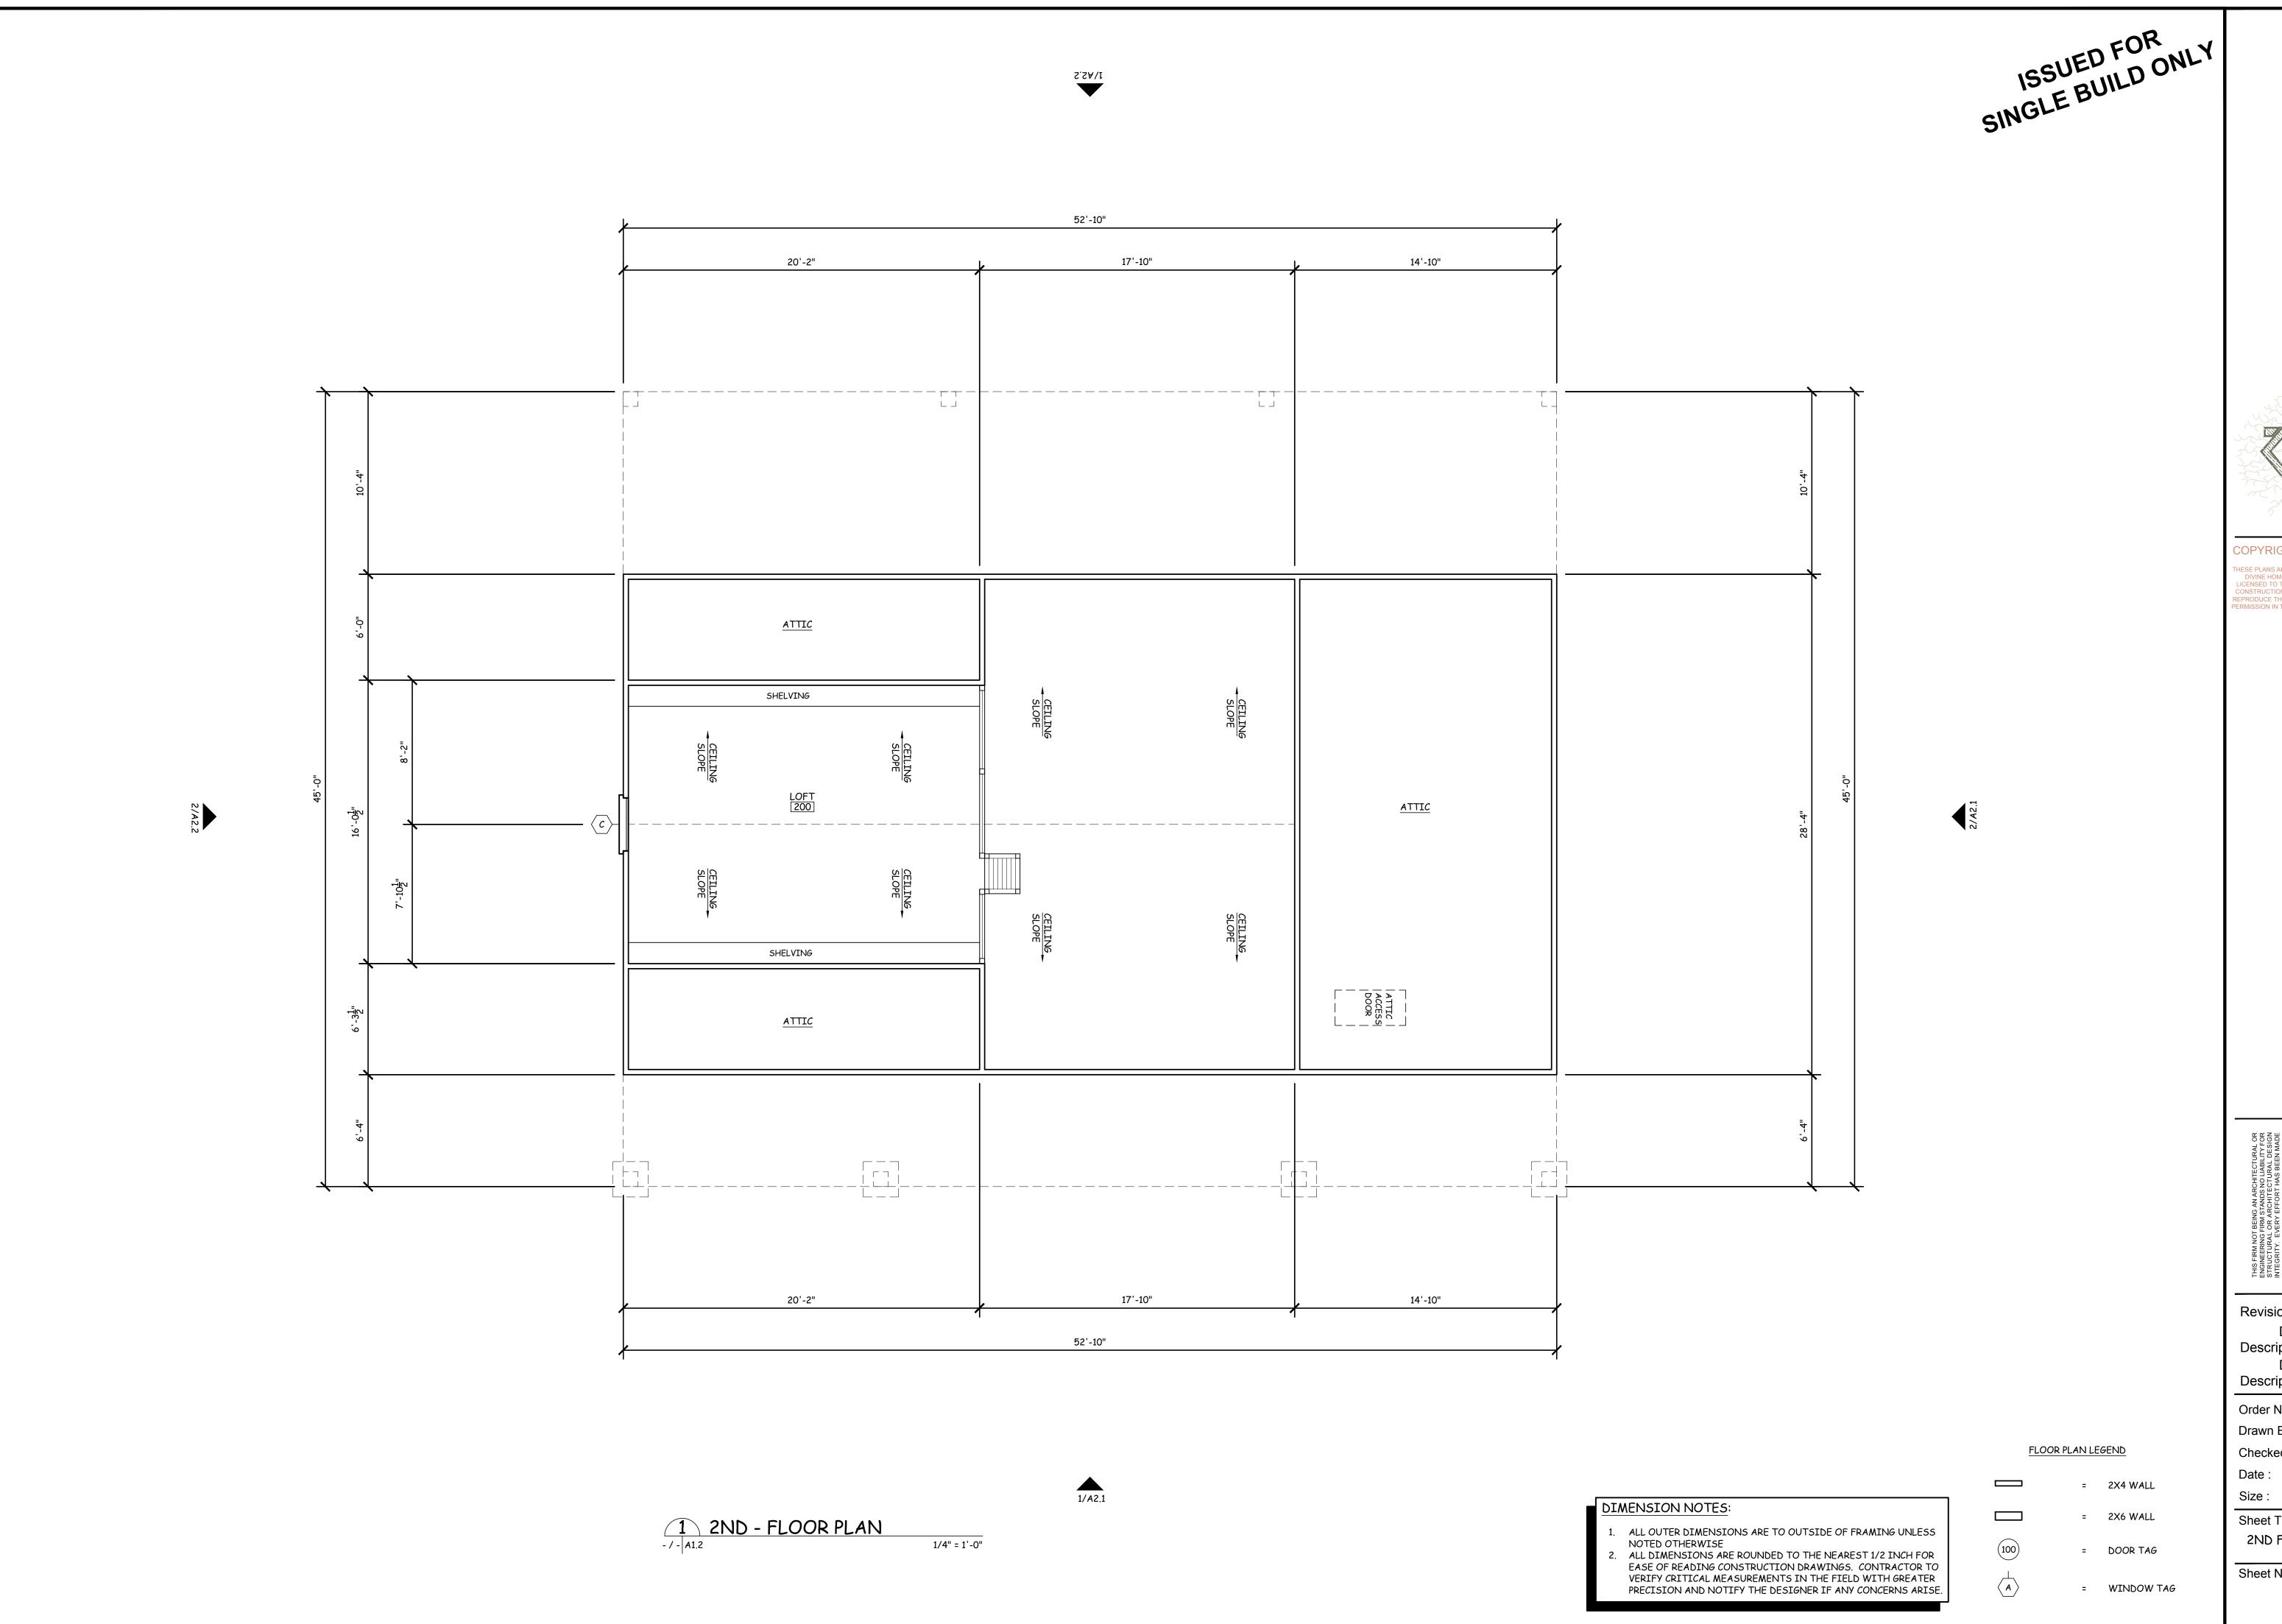
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24" x 36" Sheet Title:

1ST FLOOR PLAN

Sheet Number: A1.1



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24" x 36" Size:

Sheet Title: 2ND FLOOR PLAN

Sheet Number:

A1.2

05/25/2023

# ROOM FINISH SCHEDULE

ROOM		FLOOR		BASE	WALLS		TRIM			CEILING		REMARKS
ROOM	NAME	MATERIAL	FINISH		MATERIAL	FINISH	CORNICE	WINDOW	DOORS	MATERIAL	HEIGHT	
FIRST	FLOOR											
100	FAMILY	LVP	-	B1	1/2" GYPSUM BD	PAINT	-	D&W1	D&W1	1/2" GYPSUM BD	-	CATHEDRAL CEILING
101	KITCHEN	LVP	-	B1	1/2" GYPSUM BD	PAINT	-	D&W1	D&W1	1/2" GYPSUM BD	9'-0"	
102	ENTRY	LVP	-	B2	1/2" GYPSUM BD	PAINT	1 PIECE	D&W1	D&W1	1/2" GYPSUM BD	9'-0"	
103	PANTRY	LVP	-	B2	1/2" GYPSUM BD	PAINT	1 PIECE	D&W1	D&W1	1/2" GYPSUM BD	9'-0"	
104	CANNING KITCHEN	LVP	-	B1	1/2" GYPSUM BD	PAINT	1 PIECE	D&W1	D&W1	1/2" GYPSUM BD	9'-0"	
105	BATH TWO	LVP	-	B1	1/2" GYPSUM BD	PAINT	1 PIECE	D&W1	D&W1	1/2" GYPSUM BD	9'-0"	
106	BEDROOM TWO	LVP	-	B1	1/2" GYPSUM BD	PAINT	1 PIECE	D&W1	D&W1	1/2" GYPSUM BD	9'-0"	
107	UTILITY	LVP	-	B1	1/2" GYPSUM BD	PAINT	1 PIECE	D&W1	D&W1	1/2" GYPSUM BD	9'-0"	
108	W.I.C.	LVP	-	B1	1/2" <i>G</i> YPSUM BD	PAINT	1 PIECE	D&W1	D&W1	1/2" GYPSUM BD	9'-0"	
109	MASTER BATH	LVP	-	B2	1/2" GYPSUM BD	PAINT	1 PIECE	D&W1	D&W1	1/2" GYPSUM BD	9'-0"	
110	MASTER BEDROOM	LVP	-	B2	1/2" GYPSUM BD	PAINT	1 PIECE	D&W1	D&W1	1/2" GYPSUM BD	9'-0"	
111	SCREENED PORCH	CONCRETE	-	-	-	-	-	-	-	BEADED BOARD	9'-3"	
112	REAR PORCH	CONCRETE	-	-	-	-	-	-	-	BEADED BOARD	9'-3"	
113	FRONT PORCH	CONCRETE	-	-	-	-	-	-	-	BEADED BOARD	9'-3"	
200	LOFT	CARPET	-	B2	1/2" <i>G</i> YPSUM BD	PAINT	-	D&W1	D&W1	1/2" GYPSUM BD	-	CATHEDRAL CEILING

# WINDOW SCHEDULE

MARK	WINDOW			
	SIZE	HEAD HGT	ТУРЕ	REMARKS
FIRST	& SECOND FLOO	R		
Α	3'-0" X 3'-6"	7'-6"	DOUBLE HUNG WINDOW	
В	4'-0" X 1'-0"	7'-6"	FIXED WINDOW	
С	3'-0" X 5'-0"	7'-6"	DOUBLE HUNG WINDOW	
Q	(2) 3'-0" X 5'-0"	7'-6"	(2) DOUBLE HUNG WINDOWS	

## DOOR & WINDOW NOTES:

- VERIFY ALL ROUGH OPENING SIZES IN ADVANCE.
   VERIFY WINDOW STYLES, GRID PATTERNS & DOOR PROFILES IN ADVANCE.
- 3. VERIFY DOOR HARDWARE TYPES & FINISHES IN ADVANCE.
- PROVIDE WINDOW FALL PROTECTION PER R612.2.
   ALL OCCUPIED ROOMS MUST HAVE WINDOWS THAT COMPLY WITH R310.2.1
  OF THE 2018 IRC.

## STAIR NOTES:

- 1. MINIMUM 36" CLEAR WIDTH FOR STAIRWAY.
- MAXIMUM 4-1/2" HANDRAIL PROJECTION INTO STAIRWAY WIDTH, ON EITHER SIDE.
- MINIMUM 6'-8" HEADROOM HEIGHT CLEARANCE FOR STAIRWAY.
   MAXIMUM 12'-3" VERTICAL HEIGHT (RISE) FOR A FLIGHT OF STAIRS W/O A LANDING.
- 5. MAXIMUM 7-3/4" RISER HEIGHT.
- MINIMUM 10" STAIR TREAD DEPTH WITH NOSING OR MINIMUM 11" W/O NOSING.
   HANDRAIL GRASPABILITY TO BE EITHER TYPE I OR II WITH A MINMUM 1-1/2" CLEARANCE FROM WALL.
- 8. HANDRAIL HEIGHT TO BE PLACED BETWEEN 34" TO 38"9. STAIRS & HANDRAILS TO CONFIRM TO R311.7 OF THE 2018 IRC.


# DOOR SCHEDULE

MARK	DOOR			
	SIZE	HEAD HGT	ТУРЕ	REMARKS
EXTE	RIOR - 15T & 2ND	FLOOR		
100	3'-0" X 6'-8"	6'-8"	EXTERIOR GRADE WOOD	1'-6" SIDE LITES
101	3'-0" X 6'-8"	6'-8"	ENTRY DOOR - FULL GLASS	INSULATED
102	5'-0" X 6'-8"	6'-8"	SLIDING GLASS DOORS	INSULATED
103	6'-0" X 6'-8"	6'-8"	SLIDING GLASS DOORS	
104	2'-8" X 6'-8"	6'-8"	INTERIOR DOOR	
105	2'-8" X 6'-8"	6'-8"	INTERIOR DOOR	
106	2'-6" X 6'-8"	6'-8"	INTERIOR DOOR	
107	2'-6" X 6'-8"	6'-8"	POCKET DOOR	
108	3'-6" X 6'-8"	6'-8"	INTERIOR DOOR	
109	2'-6" X 6'-8"	6'-8"	BARN DOOR	
110	3'-0" X 6'-8"	6'-8"	CASED OPENING	
111	3'-0" X 6'-8"	6'-8"	INTERIOR DOOR	
112	(2) 2'-0" X 6'-8"	6'-8"	BI-FOLD DOORS	
113	2'-8" X 6'-8"	6'-8"	INTERIOR DOOR	
114	2'-6" X 6'-8"	6'-8"	INTERIOR DOOR	
115	2'-8" X 6'-8"	6'-8"	INTERIOR DOOR	
116	2'-6" X 6'-8"	6'-8"	CASED OPENING	

ISSUED FOR ONI

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DESIGN

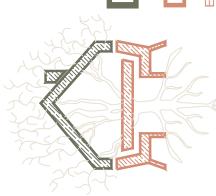

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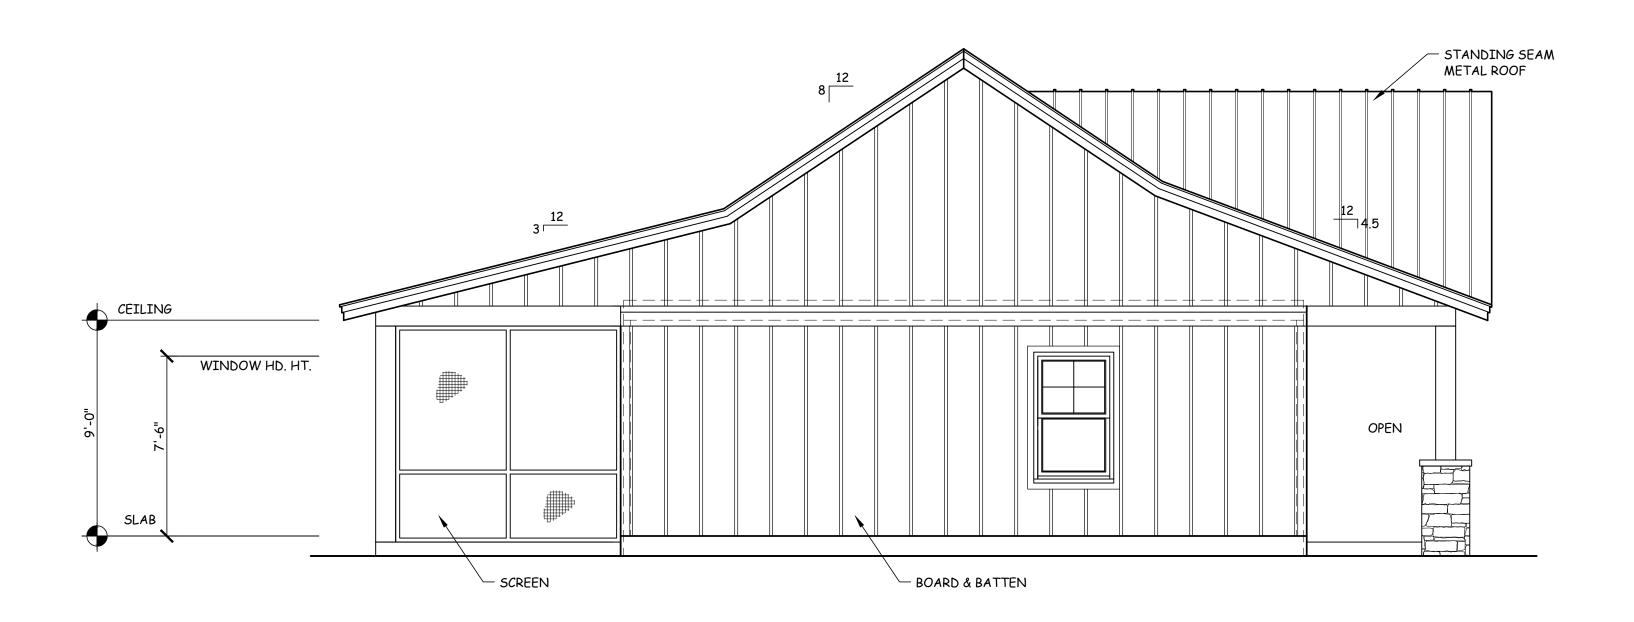
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SCHEDULES

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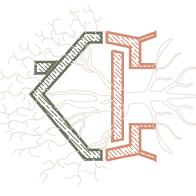


NOTE: FOUNDATION TYPES VARY, REFER TO FOUNDATION PLAN FOR EXACT TYPE. PROVIDE RAILINGS ON PORCHES/DECKS AS REQUIRED.

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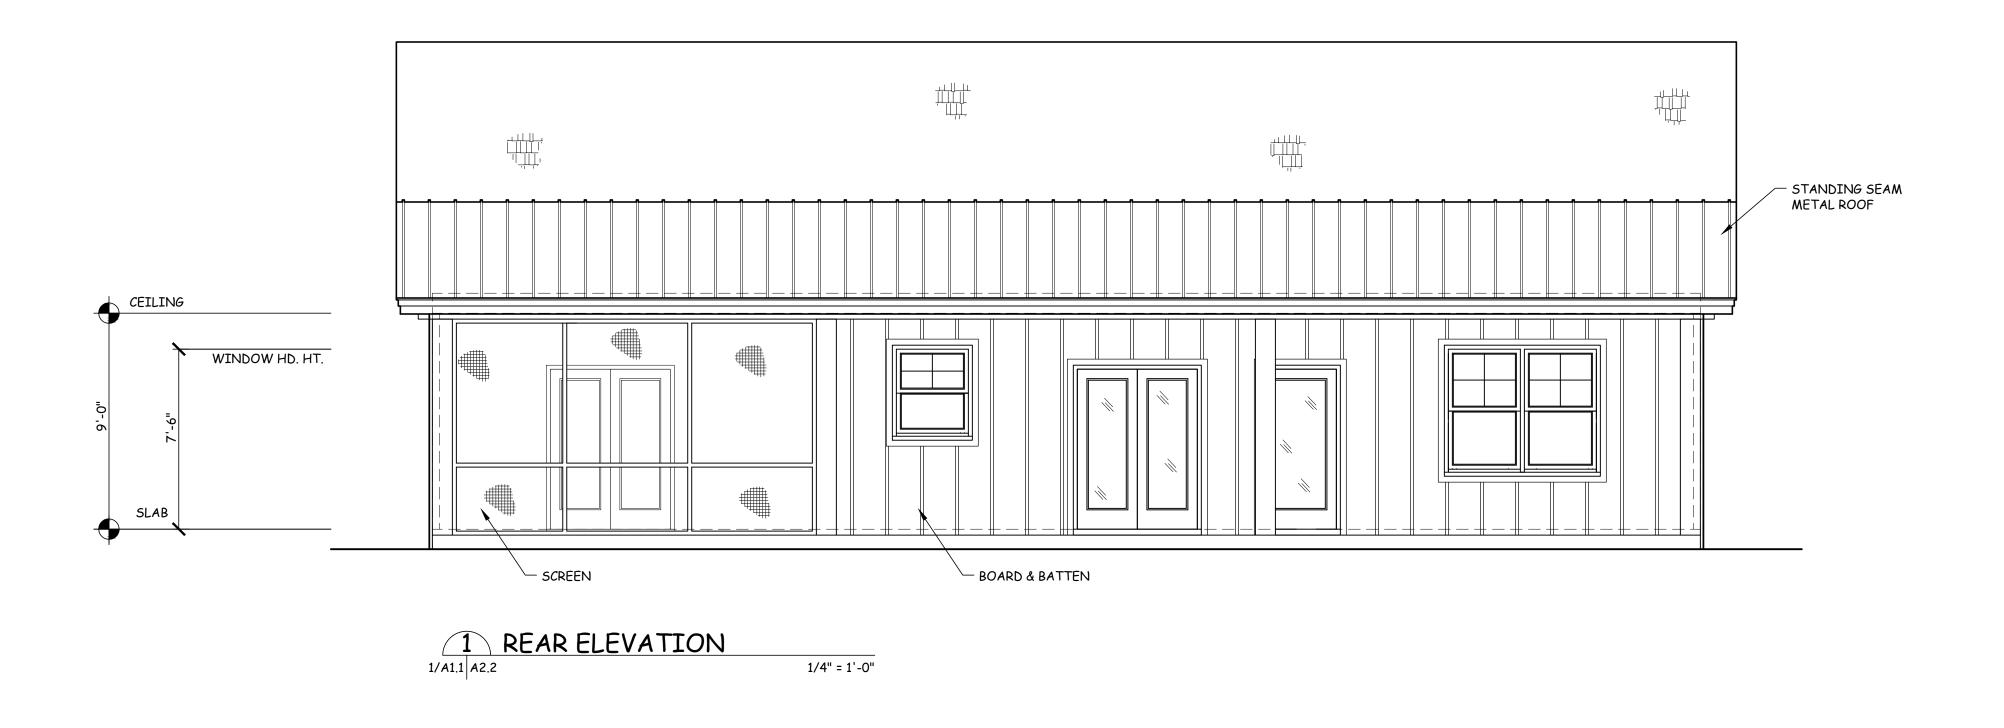
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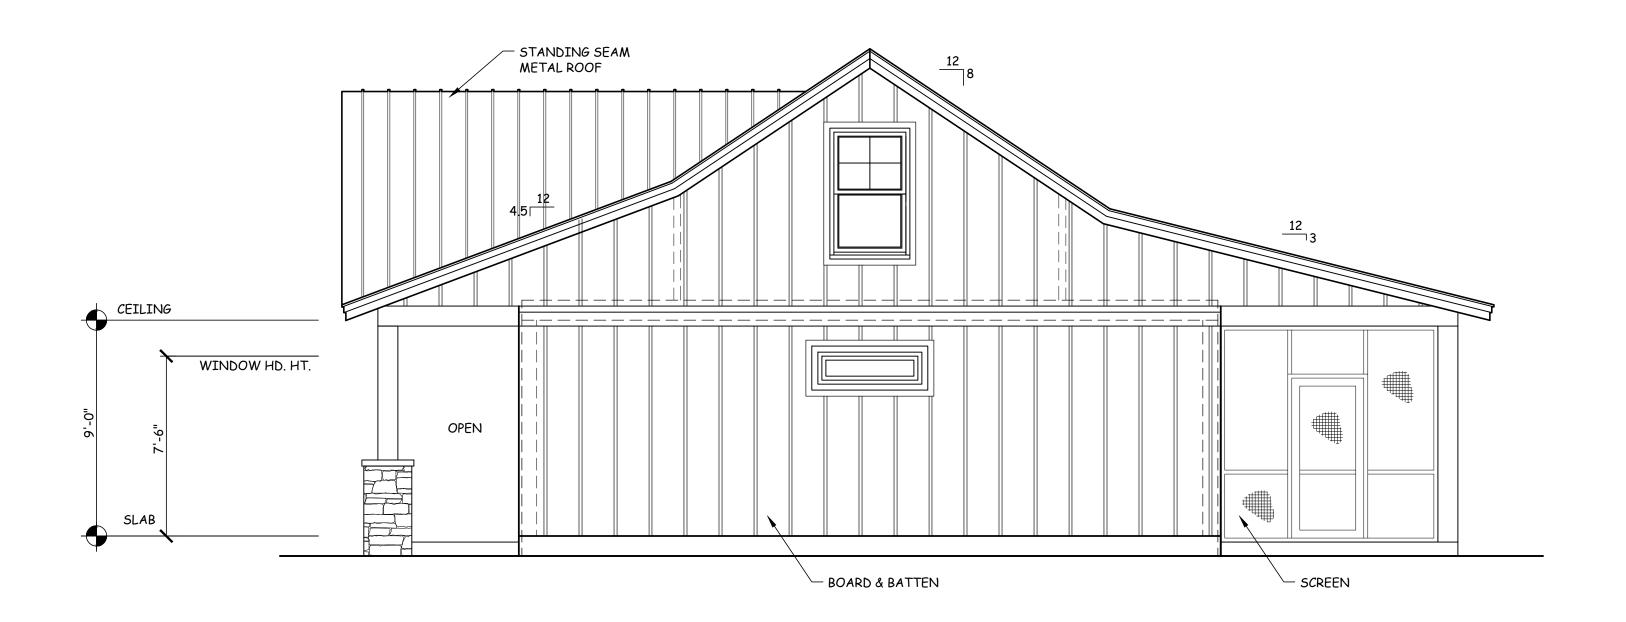
Sheet Title :

EXTERIOR ELEVATIONS

Sheet Number:

A2.1






2 LEFT SIDE ELEVATION

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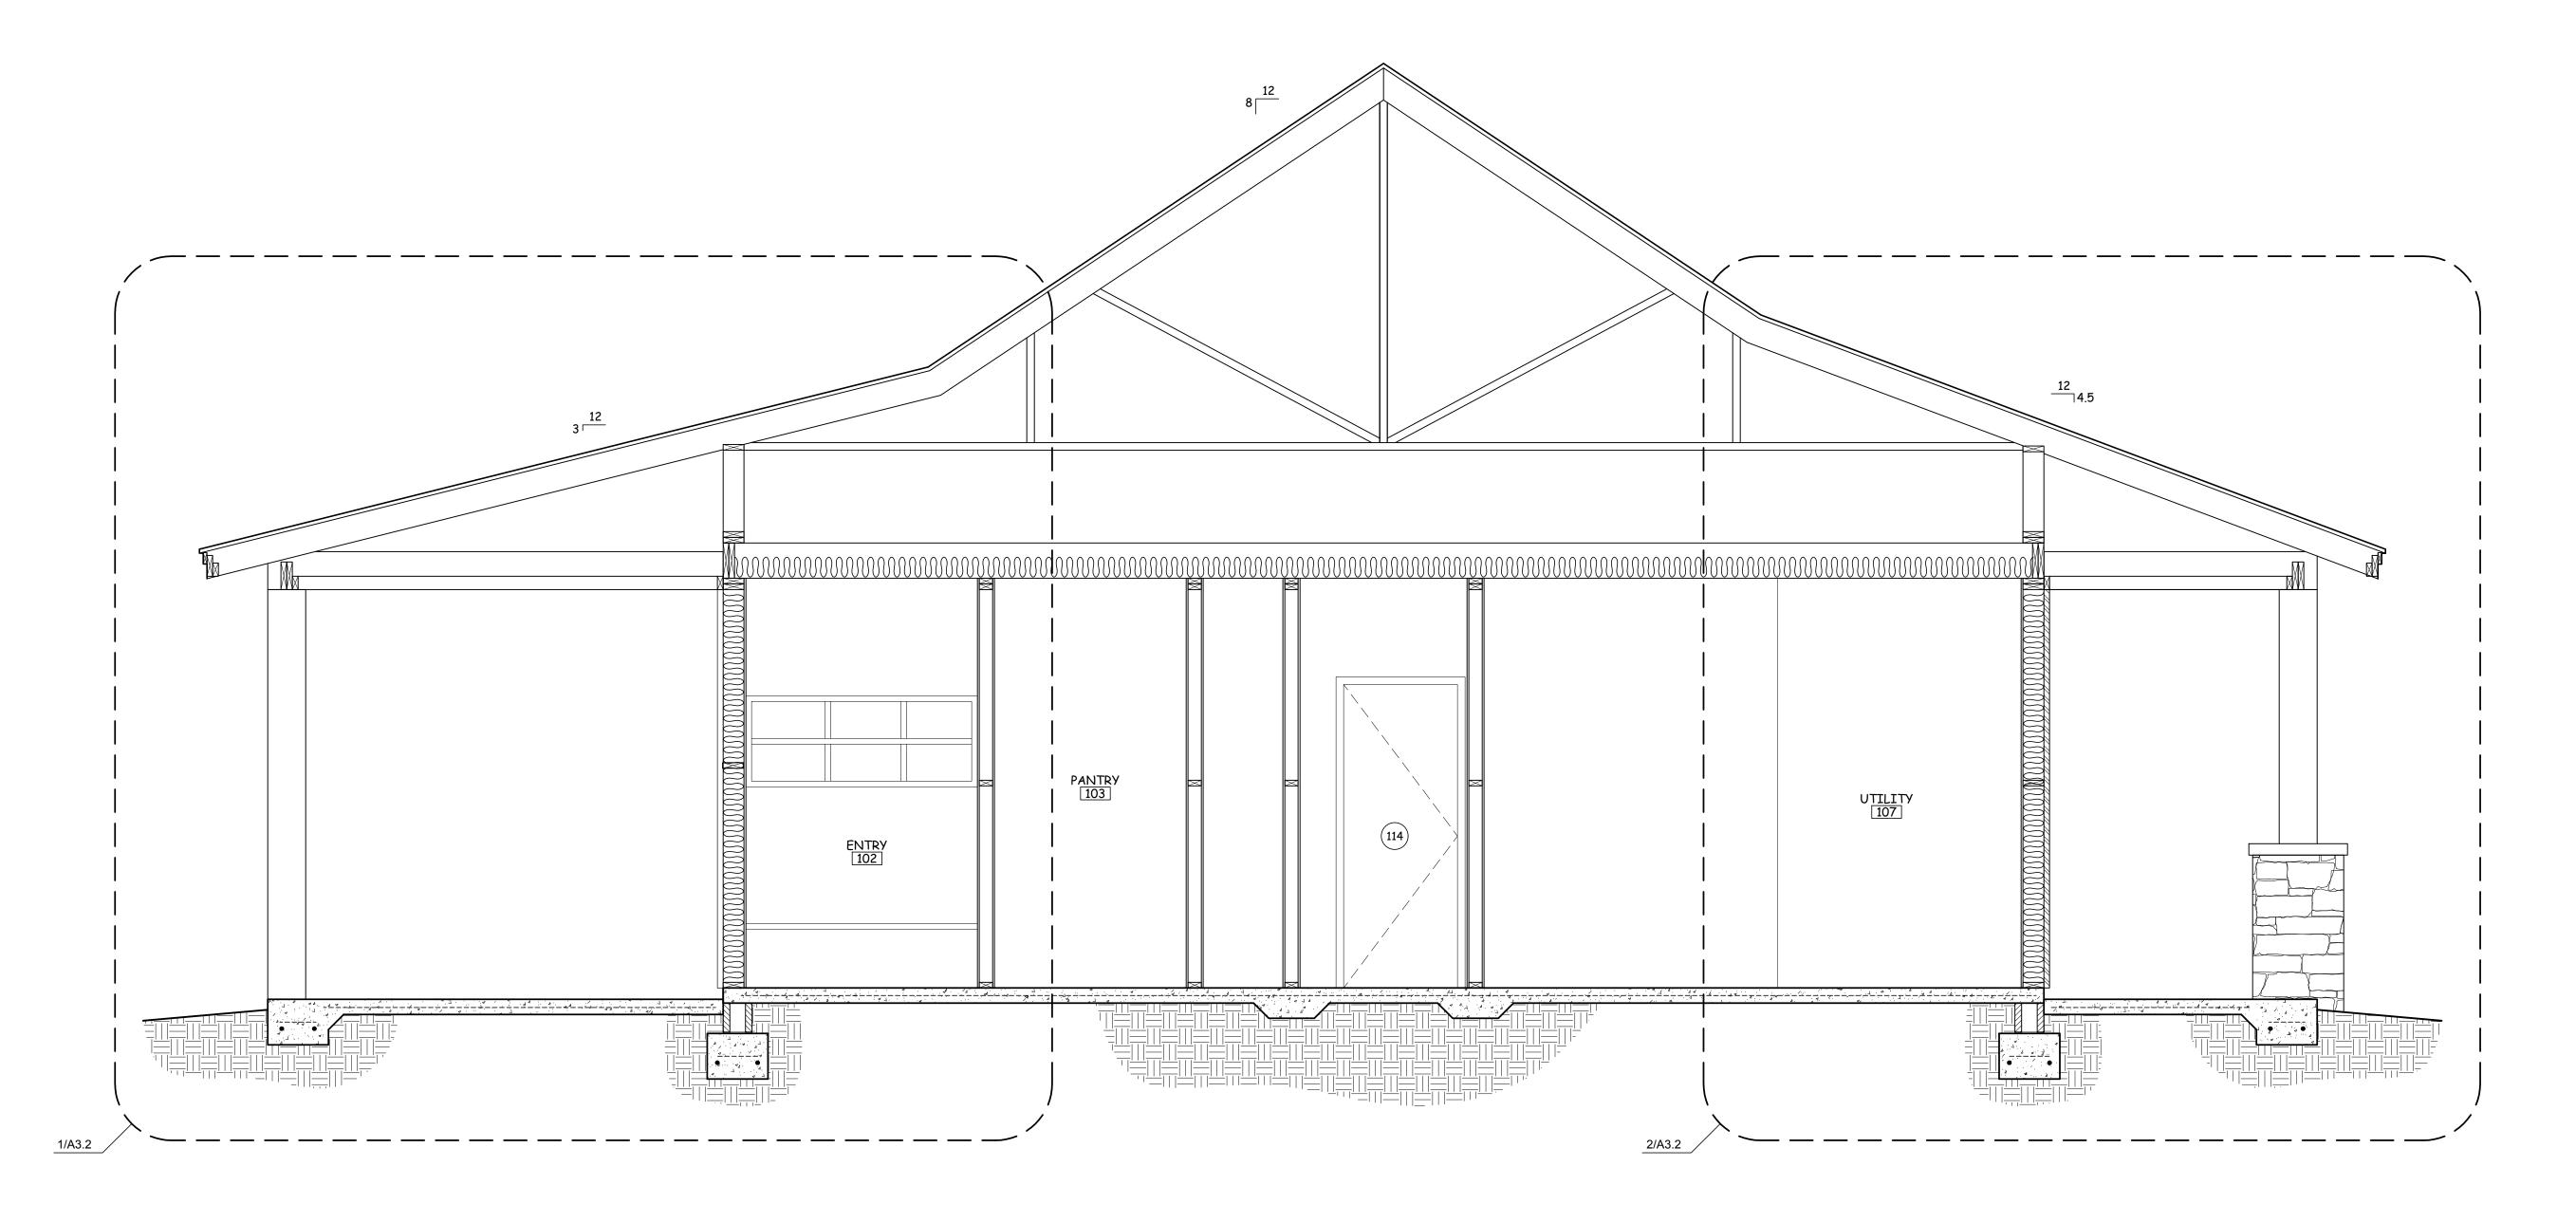
EXTERIOR ELEVATIONS

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## WALL SECTION NOTES:

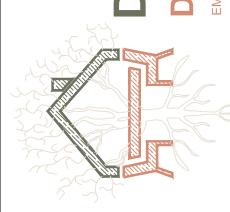- 1. THE SIZE, HEIGHT AND SPACING OF STUDS MUST BE IN ACCORDANCE W/
- AT A MINIMUM FLOOR JOIST SPANS SHALL MEET IRC TABLE R502.3.1
  RAFTERS MUST BE SIZED BASED ON THE RAFTER SPANS IN TABLE R802.4.1
- CEILING JOIST MUST BE SIZED BASED ON THE JOIST SPANS IN TABLE
- AT A MINIMUM CONCRETE COMPRESSIVE STRENGTH SHALL MEET IRC
- TABLE R402.2
- AT A MINIMUM CONCTRETE FOOTING DIMESONS SHALL MEET IRC TABLE

ISSUED FOR ONLY SINGLE BUILD ONLY



1 BUILDING SECTION
1/A1.1 A3.1 1/2" = 1'-0"

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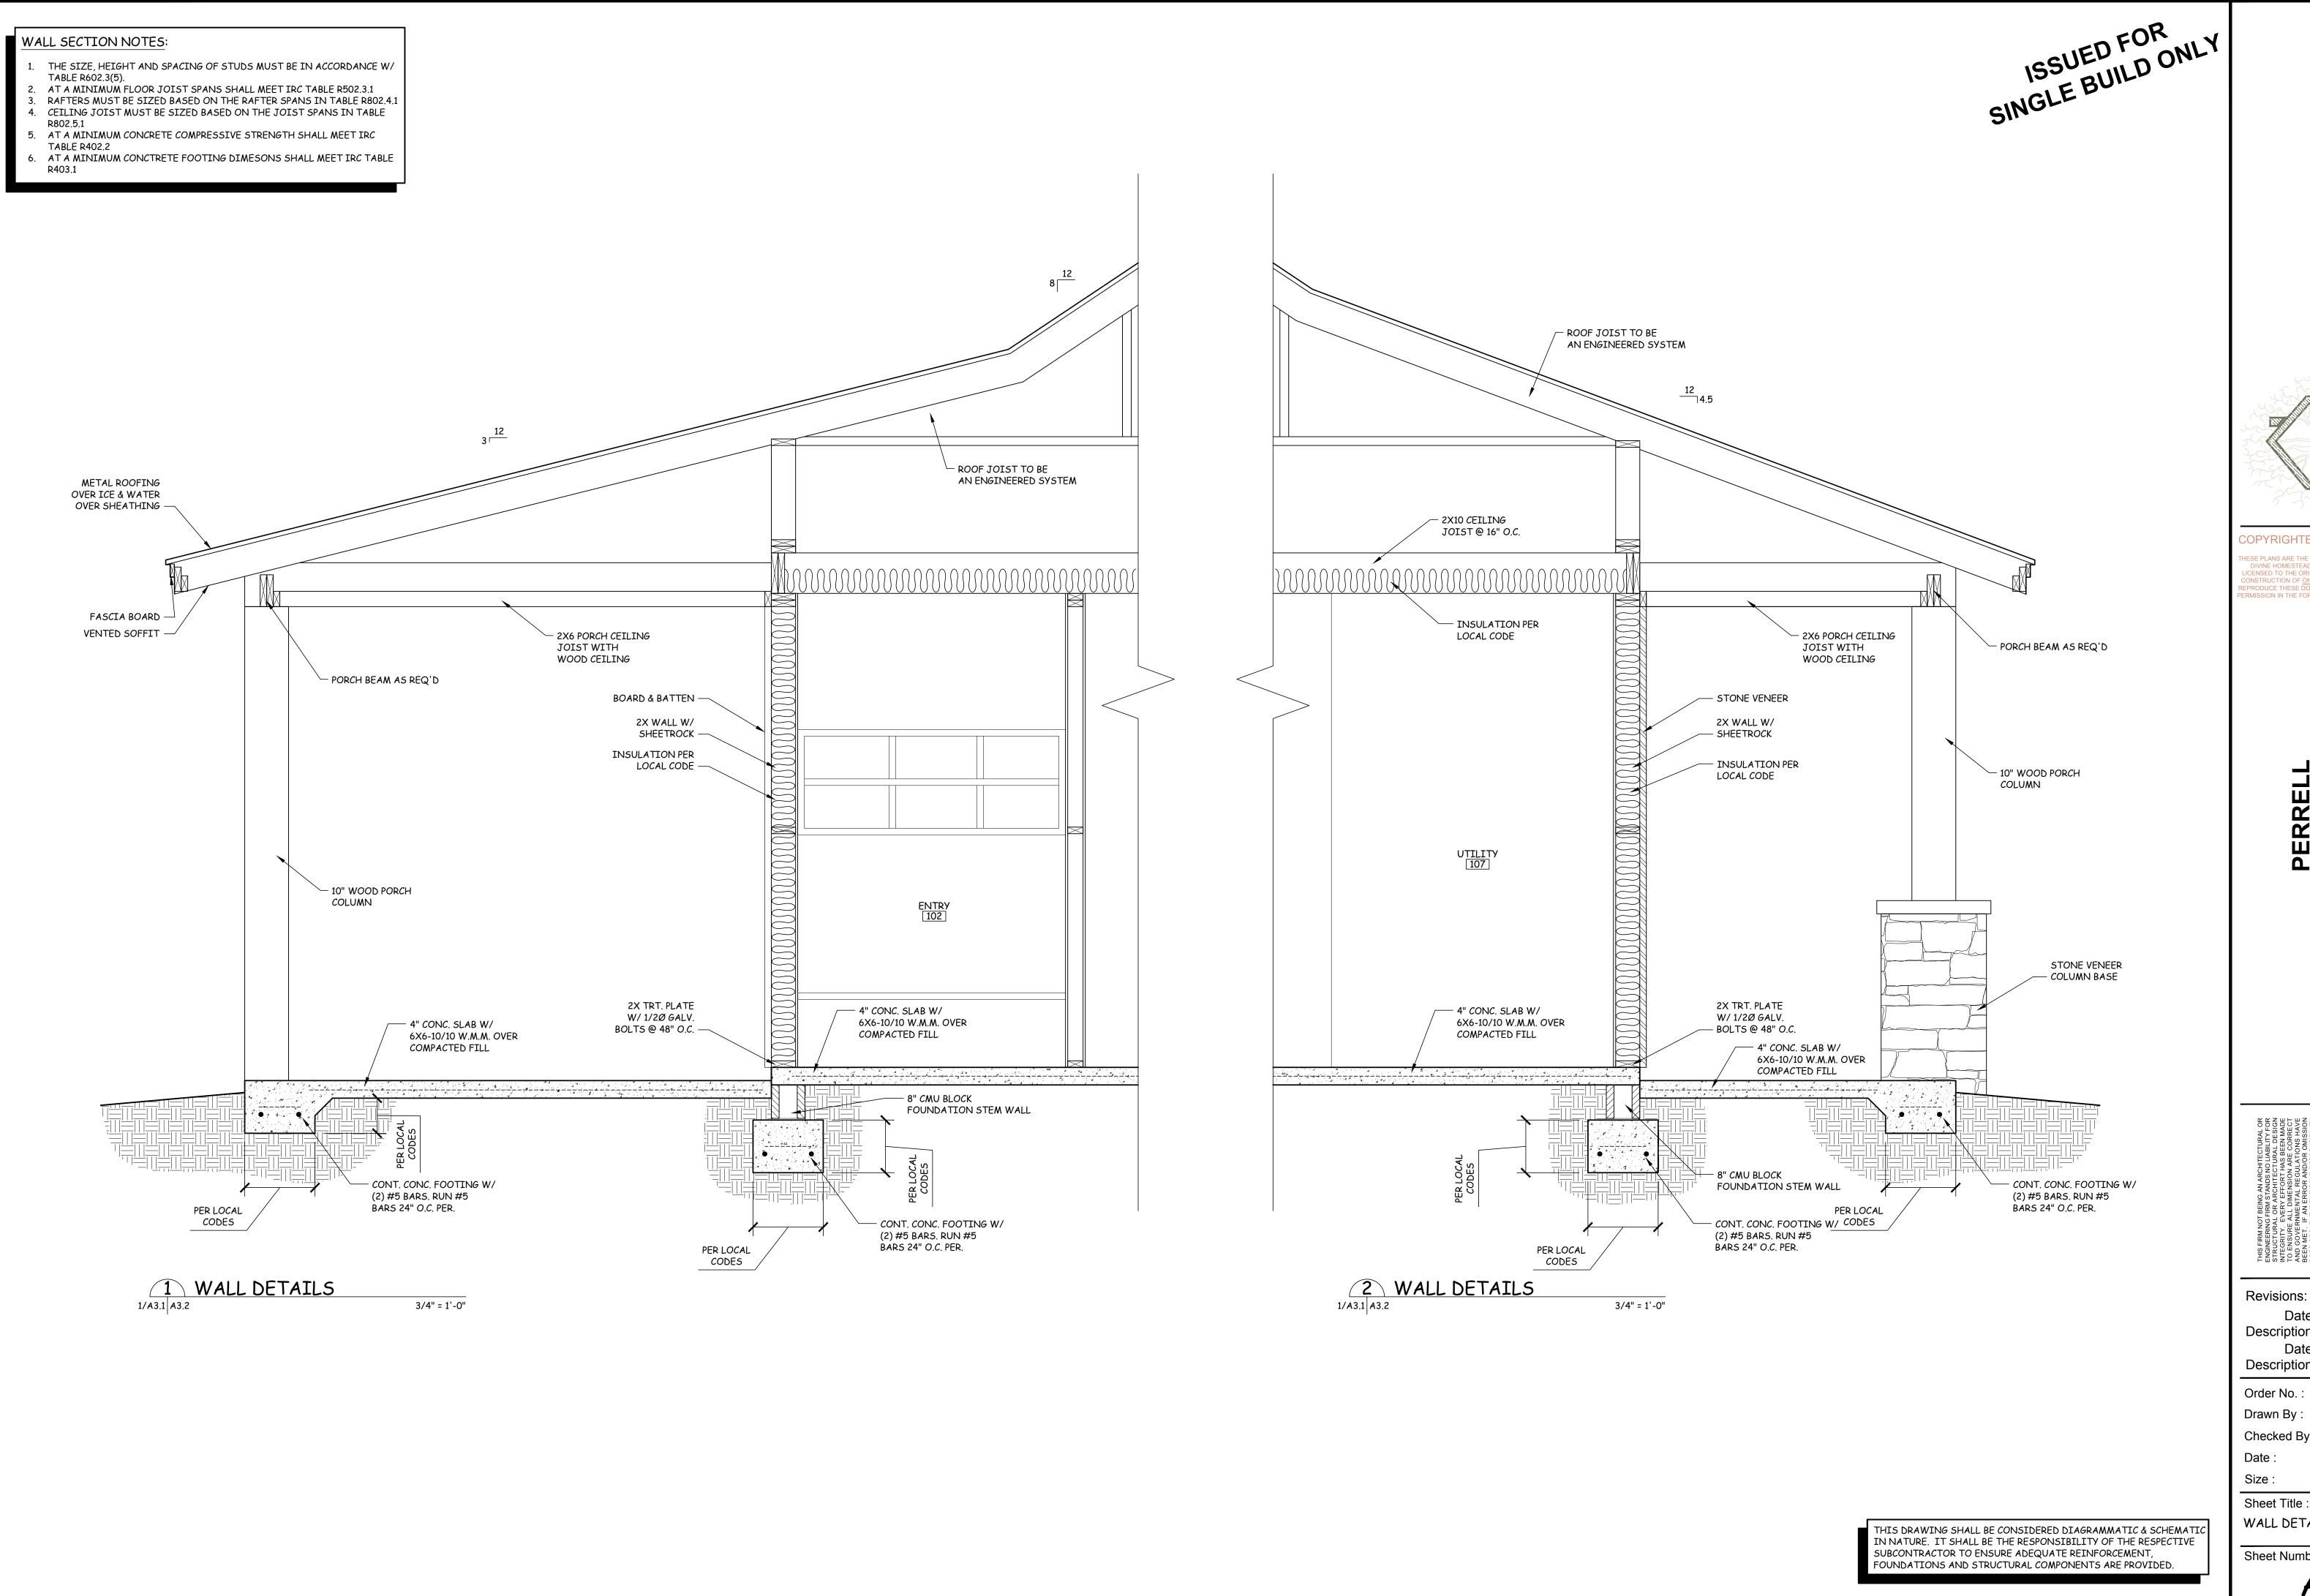
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BUILDING SECTION

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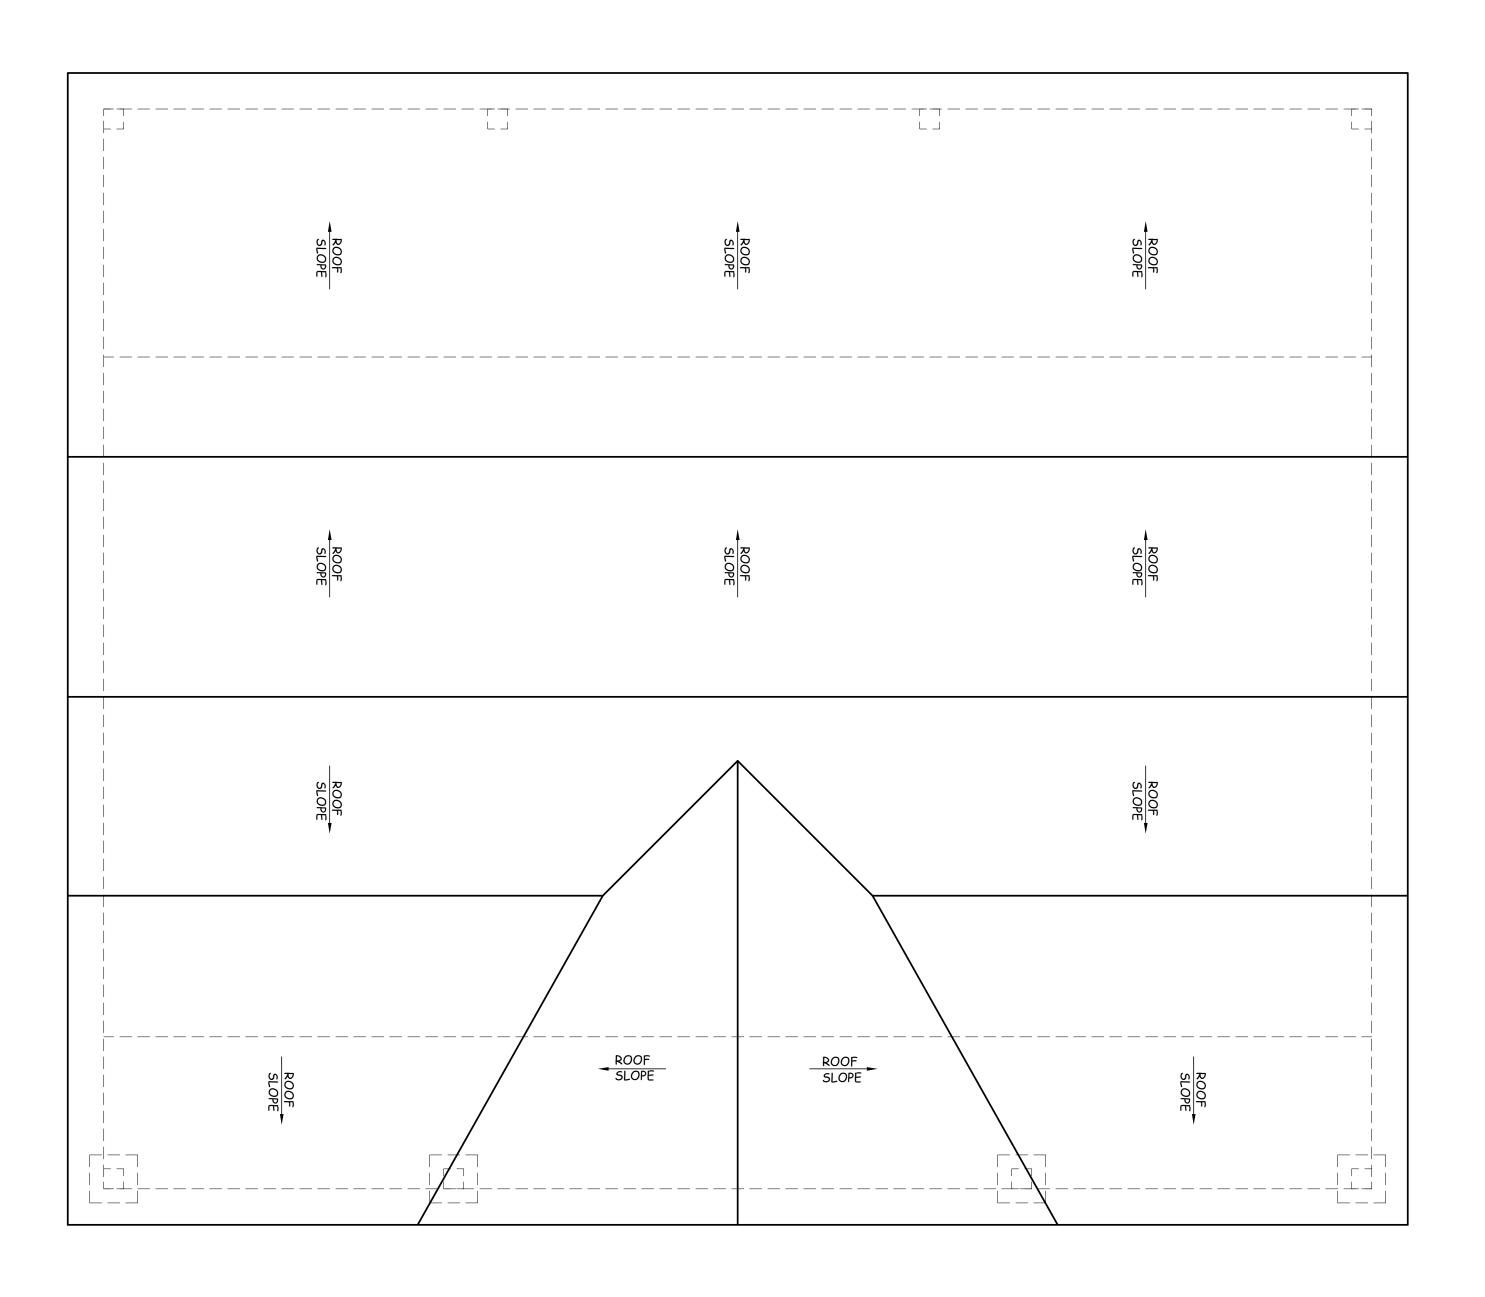
Date: Description: Description:

Order No.: 230524590030 Drawn By: DAH Checked By: DAH 05/25/2023 24" x 36"

WALL DETAILS

Sheet Number:

A3.2



1 ROOF PLAN
-/- A3.3 1/4" = 1'-0"



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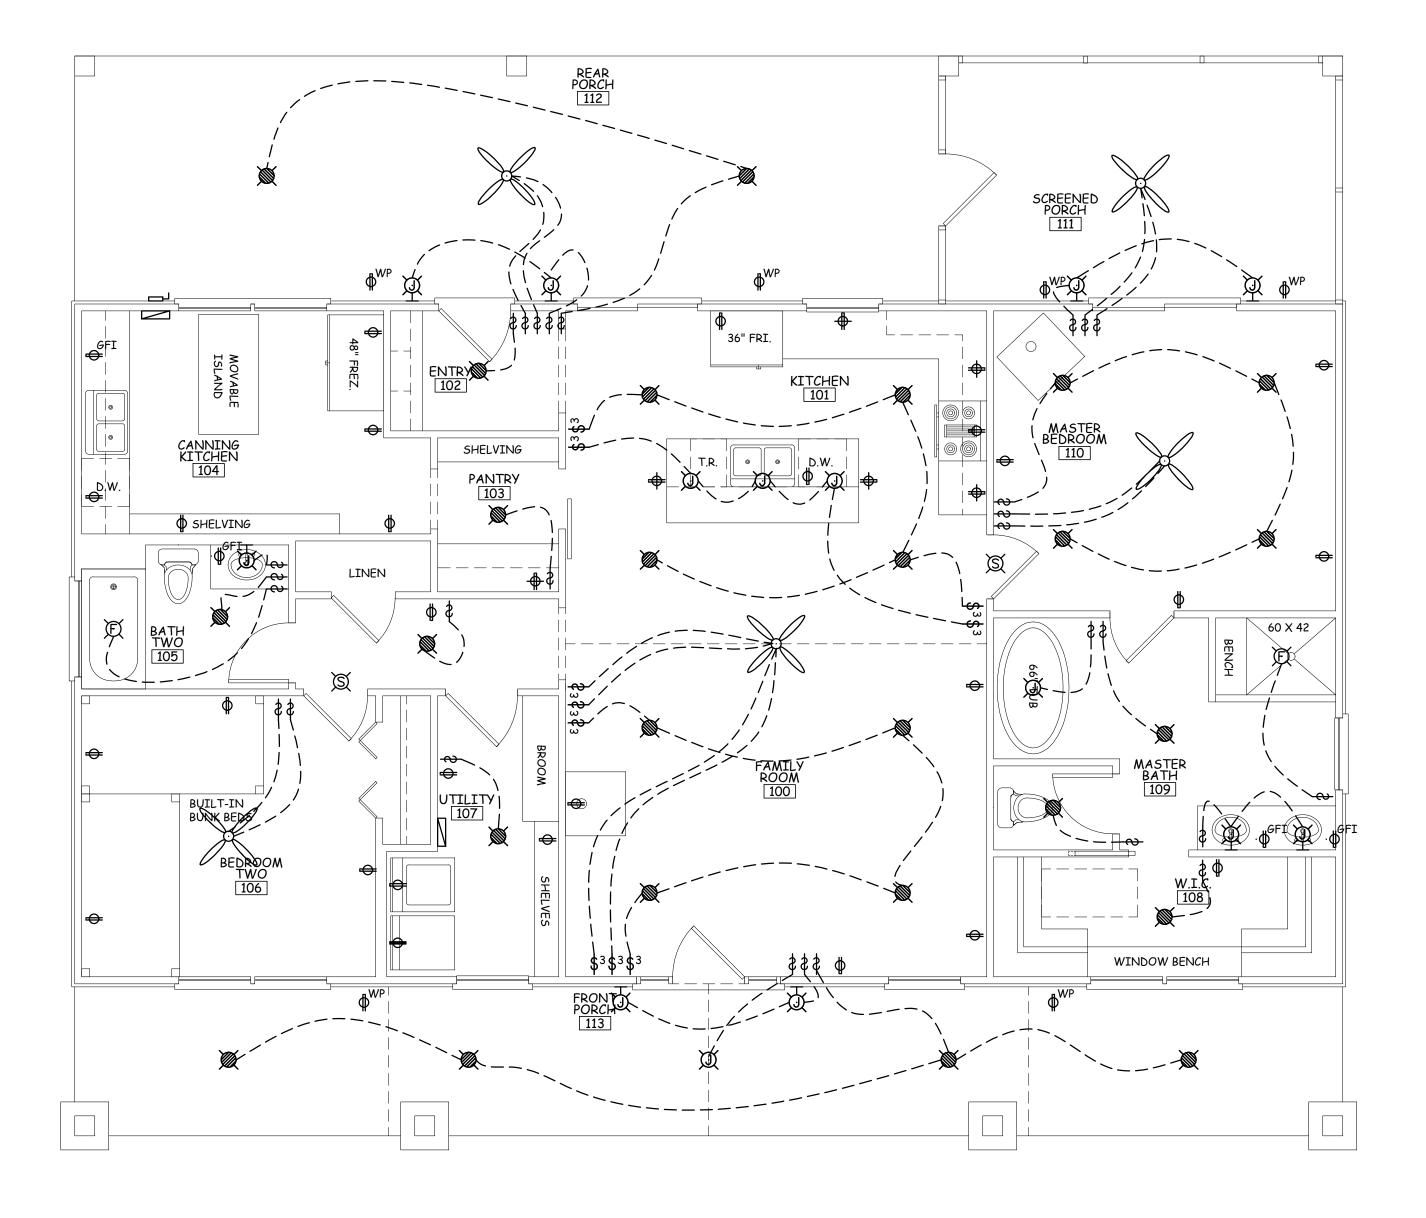
24" x 36" Size: Sheet Title: ROOF PLAN

Sheet Number:

A3.3

- ALL CIRCUITRY & WIRE SIZES TO BE DETERMINED BY ELECTRICIAN FOR GENERAL
- POWER, APPLIANCES, EQUIPMENT & LIGHTING. VERIFY IN ADVANCE WHAT EQUIPMENT & APPLIANCES WILL BE NATURAL GAS.
- 3. ELECTRICAL EQUIPMENT TO BE SIZED & DETERMINED BY ELECTRICIAN IN ADVANCE. 4. UNLESS OTHERWISE NOTED PROVIDE POWER OUTLETS IN EVERY ROOM TO MEET
- CODE MINIMUM REQUIREMENTS. 5. PRIOR TO THE INSTALLATION OF DRYWALL ELECTRICIAN TO WALK HOME WITH
- G.C./OWNER TO VERIFY OUTLET PLACEMENT.
- 6. PROVIDE SMOKE/CARBON MONOXIDE DETECTORS AS REQUIRED BY NEC.
- 7. EXTERIOR LIGHTS MUST BE RATED FOR EXTERIOR APPLICATIONS. 8. OWNER TO DETERMINE LOCATION OF SWITCHES TO FLOOD LIGHTS.
- 9. OWNER TO DETERMINE LOCATION OF FLOOR OUTLETS.
  10. OWNER TO DETERMINE LOCATION OF ANY LIGHT TO BE CENTERED ABOVE A PIECE OF FURNITURE OR CABINET.

ISSUED FOR ONLY SINGLE BUILD ONLY



	ELECTRIC	AL LEGEND	
ф	DUPLEX RECEPTACLE 110V	Ø	LIGHT FIXTURE JUNCTION BOX
<b>ф</b>	DUPLEX REC. 110V - ABOVE COUNTER	Ä	LIGHT FIXTURE - WALL MOUNTED
₩P	WEATHER DUPLEX RECEPTACLE 110V	Í	EXHAUST FAN/LIGHT COMBO
GFI <del>→</del>	GROUND FAULT INTERRUPTER 110V	Ø	RECESSED LIGHT
ф	RECEPTACLE 220V	8	FLOOD LIGHT
<b>\ph</b>	SWITCHED DUPLEX RECEPTACLE 110V	Ø	SMOKE DETECTOR
	DUPLEX FLOOR RECEPTACLE 110V		ELECTRICAL PANEL
Ó	MAIN DISCONNECT		FLUORESCENT FIXTURE
\$	SINGLE POLE SWITCH		CFILING FAN
<b>\$</b> 3	2 WAY SWITCH		CETLING FAIN

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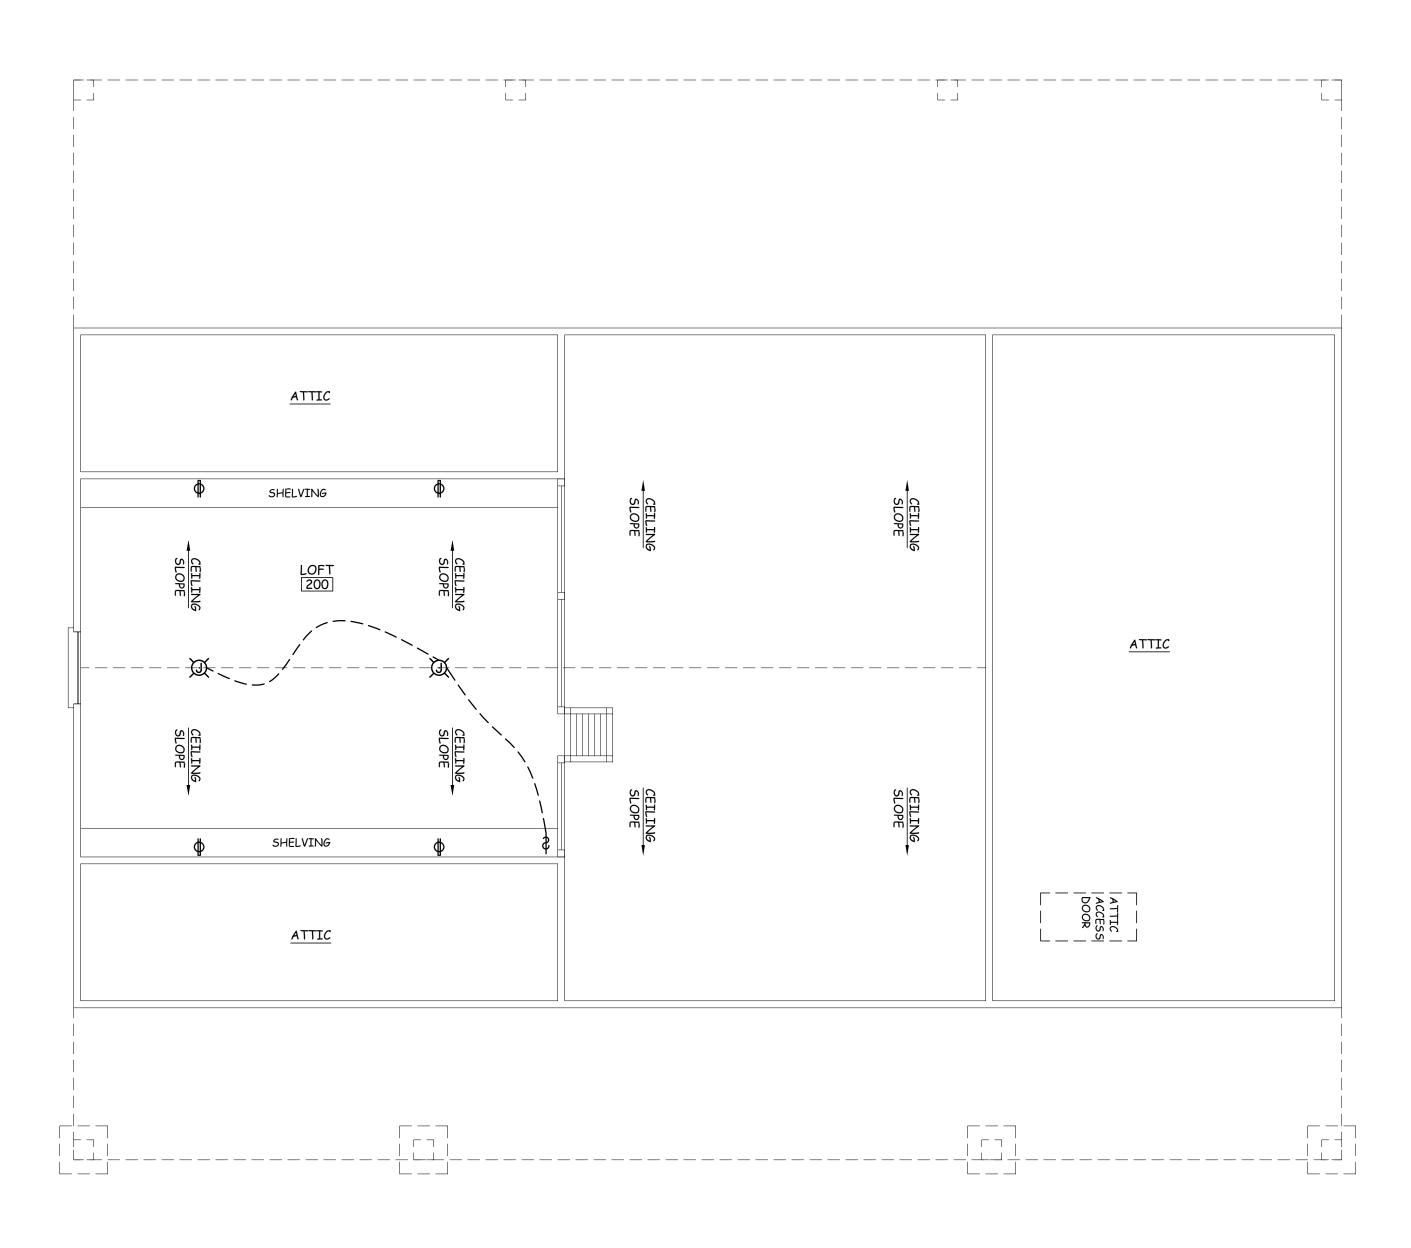
Checked By: DAH 05/25/2023 24" x 36" Size:

Sheet Title: 1ST FLOOR

Sheet Number:

1 1ST FLR. ELECTRICAL PLAN
1/4" = 1'-1/4" = 1'-0"

- 1. ALL CIRCUITRY & WIRE SIZES TO BE DETERMINED BY ELECTRICIAN FOR GENERAL
- POWER, APPLIANCES, EQUIPMENT & LIGHTING. 2. VERIFY IN ADVANCE WHAT EQUIPMENT & APPLIANCES WILL BE NATURAL GAS.
- 3. ELECTRICAL EQUIPMENT TO BE SIZED & DETERMINED BY ELECTRICIAN IN ADVANCE. 4. UNLESS OTHERWISE NOTED PROVIDE POWER OUTLETS IN EVERY ROOM TO MEET
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- 6. PROVIDE SMOKE/CARBON MONOXIDE DETECTORS AS REQUIRED BY NEC. 7. EXTERIOR LIGHTS MUST BE RATED FOR EXTERIOR APPLICATIONS.
- 8. OWNER TO DETERMINE LOCATION OF SWITCHES TO FLOOD LIGHTS.
- 9. OWNER TO DETERMINE LOCATION OF FLOOR OUTLETS. 10. OWNER TO DETERMINE LOCATION OF ANY LIGHT TO BE CENTERED ABOVE A PIECE OF FURNITURE OR CABINET.



ELECTRIC	AL LEGEND	
DUPLEX RECEPTACLE 110V	Ø	LIGHT FIXTURE JUNCTION BOX
DUPLEX REC. 110V - ABOVE COUNTER	西	LIGHT FIXTURE - WALL MOUNTED
WEATHER DUPLEX RECEPTACLE 110V	Œ	EXHAUST FAN/LIGHT COMBO
GROUND FAULT INTERRUPTER 110V	Ø	RECESSED LIGHT
RECEPTACLE 220V	8	FLOOD LIGHT
SWITCHED DUPLEX RECEPTACLE 110V	Ø	SMOKE DETECTOR
DUPLEX FLOOR RECEPTACLE 110V		ELECTRICAL PANEL
MAIN DISCONNECT		FLUORESCENT FIXTURE
SINGLE POLE SWITCH		CETITALS FAN
2 WAY SWITCH		CEILING FAN
	DUPLEX RECEPTACLE 110V  DUPLEX REC. 110V - ABOVE COUNTER  WEATHER DUPLEX RECEPTACLE 110V  GROUND FAULT INTERRUPTER 110V  RECEPTACLE 220V  SWITCHED DUPLEX RECEPTACLE 110V  DUPLEX FLOOR RECEPTACLE 110V  MAIN DISCONNECT  SINGLE POLE SWITCH	DUPLEX REC. 110V - ABOVE COUNTER  WEATHER DUPLEX RECEPTACLE 110V  GROUND FAULT INTERRUPTER 110V  RECEPTACLE 220V  SWITCHED DUPLEX RECEPTACLE 110V  DUPLEX FLOOR RECEPTACLE 110V  MAIN DISCONNECT  SINGLE POLE SWITCH

THIS DRAWING SHALL BE CONSIDERED DIAGRAMMATIC & SCHEMATIC IN NATURE. IT SHALL BE THE RESPONSIBILITY OF THE RESPECTIVE SUBCONTRACTOR TO ENSURE ADEQUATE EQUIPMENT, CICURTRY, LUMENS, LIGHTING, POWER ETC. IS PROVIDED.

HOME 

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PE| 23052


Revisions: Description:

Description: Order No.: 230524590030

Drawn By: DAH Checked By: DAH 05/25/2023 24" x 36" Size:

Sheet Title: 2ND FLOOR ELECTRICAL PLAN

Sheet Number:

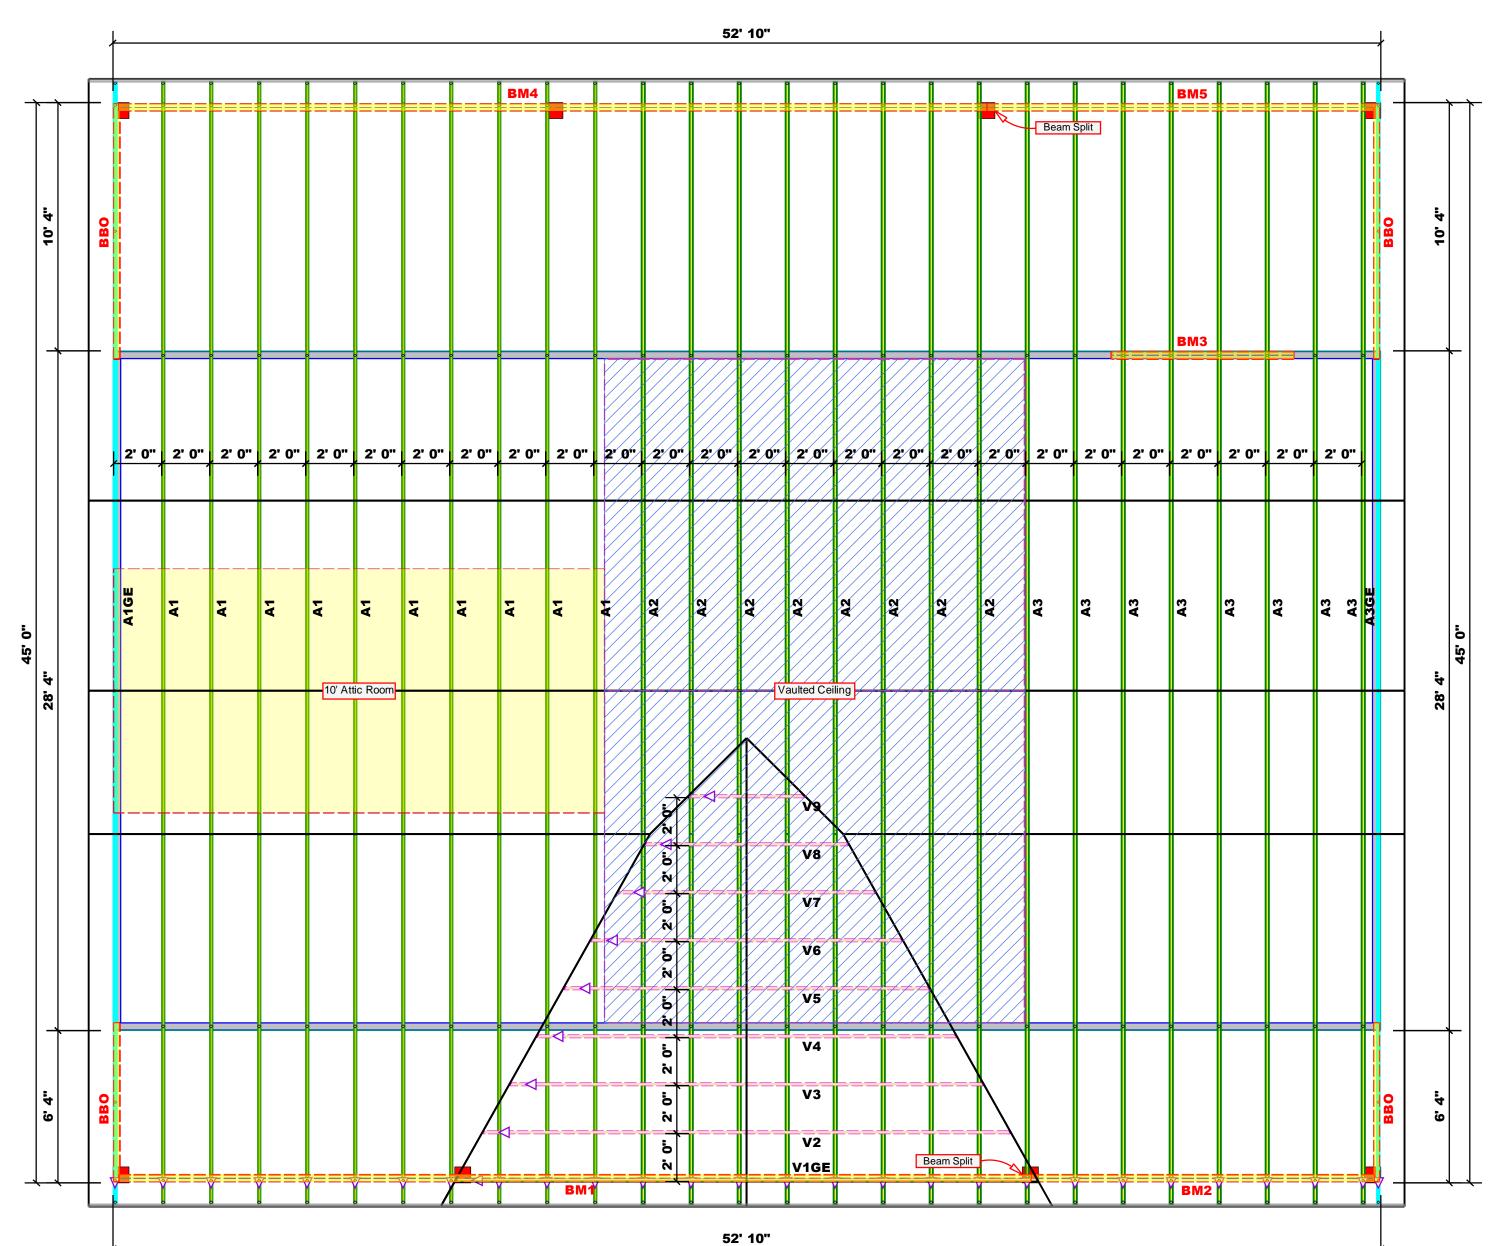

All Headers Are

Considered Load Bearing

Roof Area = 2881.18 sq.ft. Ridge Line = 0 ft. Hip Line = 1.26 ft. Horiz. OH = 282.75 ft. Raked OH = 133.46 ft.

Dimension Notes 1. All exterior wall to wall dimensions are to face of sheathing unless noted otherwise 2. All interior wall dimensions are to face of stud unless noted otherwise 3. All exterior wall to truss dimensions are to

face of stud unless noted otherwise

Hatch Legend Vaulted Ceiling Drop Beam

PlotID	Length	Product	Plies	Net Qty
BM1	38' 0"	1-3/4"x 9-1/4" LVL Kerto-S	2	2
BM2	15' 0"	1-3/4"x 9-1/4" LVL Kerto-S	2	2
BM3	8' 0"	1-3/4"x 9-1/4" LVL Kerto-S	2	2
BM4	37' 0"	1-3/4"x 9-1/4" LVL Kerto-S	2	2
BM5	17' 0"	1-3/4"x 9-1/4" LVL Kerto-S	2	2

Truss Placement Plan

Considered 2X10 Beams Unless Otherwise Noted

All Walls Shown Are

Decking = 99 sheets

PlotID	Length	Product	Plies	Net Qty
BM1	38' 0"	1-3/4"x 9-1/4" LVL Kerto-S	2	2
BM2	15' 0"	1-3/4"x 9-1/4" LVL Kerto-S	2	2
BM3	8' 0"	1-3/4"x 9-1/4" LVL Kerto-S	2	2
BM4	37' 0"	1-3/4"x 9-1/4" LVL Kerto-S	2	2
BM5	17' 0"	1-3/4"x 9-1/4" LVL Kerto-S	2	2

▲= Denotes Left End of Truss (Reference Engineered Truss Drawing)

COMTECH **ROOF & FLOOR TRUSSES & BEAMS** 

> Reilly Road Industrial Park Fayetteville, N.C. 28309 Phone: (910) 864-8787 Fax: (910) 864-4444

Jonathan Landry

Jonathan Landry

CITY / CO.	Lillington / Harnett
ADDRESS	7491 Old U.S. Highway 421
WODEL	Roof
DATE REV.	02/05/24
DRAWN BY	Jonathan Landry
SALES REP.	Lenny Norris

Ashley Cummings 7481 Old U.S. I N/A JOB NAME SEAL DATE QUOTE # BUILDER

THIS IS A TRUSS PLACEMENT DIAGRAM ONLY.
These trusses are designed as individual building components to be incorporated into the building design at the specification of the building designer. See individual design sheets for each truss design identified on the placement drawing. The building designer is responsible for temporary and permanent bracing of the roof and floor system and for the overall structure. The design of the truss support structure including headers, beams, walls, and columns is the responsibility of the building designer. For general guidance regarding bracing, consult BCSI-B1 and BCSI-B3 provided with the truss delivery package or online @ sbcindustry.com



BM1

Client: Project: Address: Ashley Cummings

7481 Old U.S. Highway 421 Lillington, NC 27546


Date: 2/5/2024 Input by:

Jonathan Landry Job Name: 7481 Old U.S. Hwy 421 Page 1 of 6

Project #: J1223-6914

**Kerto-S LVL** 2-Ply - PASSED 1.750" X 9.250"

Level: Level

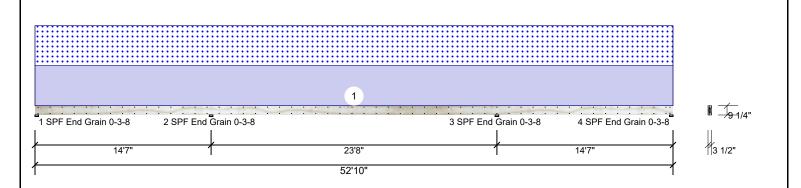

Member Info	rmation			Rea	ctions UNP	ATTERI	NED lb (	Uplift)			
Type:	Girder	Application:	Floor	Brg	Direction	Live	e D	ead	Snow	Wind	Const
Plies:	2	Design Method:	ASD	1	Vertical	(	)	285	252	0	0
Moisture Condition	on: Dry	Building Code:	IBC/IRC 2015	2	Vertical	(	) 1	358	1201	0	0
Deflection LL:	480	Load Sharing:	No	3	Vertical	(	) 1	358	1201	0	0
Deflection TL:	360	Deck:	Not Checked	4	Vertical	(	)	285	252	0	0
Importance:	Normal - II	Ceiling:	Gypsum 1/2"								
Temperature:	Temp <= 100°F			_							
				Bea	rings						
				Bea	aring Length	Dir.	Cap. Re	eact D/L lb	Total	Ld. Case	Ld. Comb.
				1-	SPF 3.500"	Vert	6%	284 / 315	600	L_L	D+S

	<b>Analysis Res</b>	sults					
	Analysis	Actual	Location	Allowed	Capacity	Comb.	Case
	Neg Moment	-4856 ft-lb	14'7"	14423 ft-lb	0.337 (34%)	D+S	LL_
	Pos Moment	3645 ft-lb	26'5"	14423 ft-lb	0.253 (25%)	D+S	_L_
	Unbraced	3645 ft-lb	26'5"	3648 ft-lb	0.999 (100%)	D+S	_L_
	Shear	1301 lb	15'6"	7943 lb	0.164 (16%)	D+S	LL_
ı	LL Defl inch	0.324 (L/876)	26'5 1/16"	0.592 (L/480)	0.548 (55%)	S	L

١	Bearing	Length	Dir.	Cap. I	React D/L lb	Total	Ld. Case	Ld. Comb.
	1 - SPF End Grain	3.500"	Vert	6%	284 / 315	600	L_L	D+S
	2 - SPF End Grain	3.500"	Vert	23%	1358 / 1224	2583	LL_	D+S
	3 - SPF End Grain	3.500"	Vert	23%	1358 / 1224	2583	_LL	D+S
	4 - SPF End Grain	3.500"	Vert	6%	284 / 315	600	L_L	D+S

#### **Design Notes**

TL Defl inch 0.631 (L/450)

1 Provide support to prevent lateral movement and rotation at the end bearings. Lateral support may also be required at the interior bearings by the building code.

26'5 1/16" 0.789 (L/360) 0.800 (80%) D+S

- 2 Fasten all plies using 2 rows of 10d Box nails (.128x3") at 12" o.c. Maximum end distance not to exceed 6".
- 3 Refer to last page of calculations for fasteners required for specified loads.
- 4 Girders are designed to be supported on the bottom edge only.
- 5 Top loads must be supported equally by all plies.
- 6 Top must be laterally braced at a maximum of 21'3 5/8" o.c.
- 7 Bottom must be laterally braced at a maximum of 15'10 3/8" o.c.

8 Lateral slenderness ratio based on single ply width.

ID	Load Type	Location	Trib Width	Side	Dead 0.9	Live 1	Snow 1.15	Wind 1.6	Const. 1.25	Comments
1	Part. Uniform	0-0-0 to 52-10-0		Тор	55 PLF	0 PLF	55 PLF	0 PLF	0 PLF	A2
	Self Weight				7 PLF					

Calculated Structured Designs is responsible only of the structural adequacy of this component based on the design criteria and loadings shown. It is the responsibility of the customer and/or the contractor to ensure the component suitability of the intended application, and to verify the dimensions and loads.

Dry service conditions, unless noted otherwise
 LVL not to be treated with fire retardant or corrosive

Handling & Installation

I. LVL beams must not be cut or drilled
 Refer to manufacturer's product information regarding installation requirements, multi-ply fastening details, beam strength values, and code approvals
 Damaged Beams must not be used

Design assumes top edge is laterally restrained
Provide lateral support at bearing points to avoid
lateral displacement and rotation

6. For flat roofs provide proper drainage to prevent ponding

This design is valid until 6/28/2026

Metsä Wood 301 Merritt 7 Building, 2nd Floor Norwalk, CT 06851 (800) 622-5850 www.metsawood.com/us

Manufacturer Info



Client: Ashley Cummings Project:

Address:

7481 Old U.S. Highway 421

Date: 2/5/2024 Input by:

Jonathan Landry Job Name: 7481 Old U.S. Hwy 421

> J1223-6914 Level: Level


Page 2 of 6

Lillington, NC 27546 Project #:

**Kerto-S LVL** BM1

1.750" X 9.250"

2-Ply - PASSED

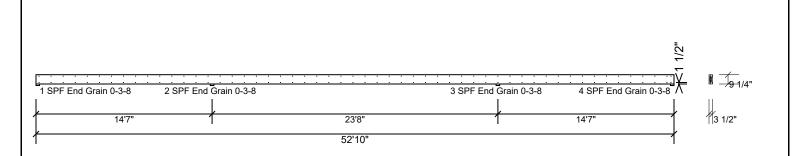

### Multi-Ply Analysis

Fasten all plies using 2 rows of 10d Box nails (.128x3") at 12" o.c.. Maximum end distance not to exceed 6".

	•	
Capacity	0.0 %	
Load	0.0 PLF	
Yield Limit per Foot	163.7 PLF	
Yield Limit per Fastener	81.9 lb.	
См	1	
Yield Mode	IV	
Edge Distance	1 1/2"	
Min. End Distance	3"	
Load Combination		
Duration Factor	1.00	

#### Notes

NOtes
Calculated Structured Designs is responsible only of the structural adequacy of this component based on the design criteria and loadings shown. It is the responsibility of the customer and/or the contractor to ensure the component suitability of the intended application, and to verify the dimensions and loads.

Dry service conditions, unless noted otherwise
 LVL not to be treated with fire retardant or corrosive

### Handling & Installation

Handling & Installation

1. UVI beams must not be cut or drilled

2. Refer to manufacturer's product information regarding installation requirements, multi-ply fastening details, beam strength values, and code approvals

3. Damaged Beams must not be used

4. Design assumes top edge is laterally restrained

5. Provide lateral support at bearing points to avoid lateral displacement and rotation

For flat roofs provide proper drainage to prevent ponding

This design is valid until 6/28/2026

Metsä Wood 301 Merritt 7 Building, 2nd Floor Norwalk, CT 06851 (800) 622-5850 www.metsawood.com/us

Manufacturer Info



Client: Project: Address:

Ashley Cummings

7481 Old U.S. Highway 421 Lillington, NC 27546


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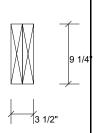
Jonathan Landry Job Name: 7481 Old U.S. Hwy 421

Project #: J1223-6914

#### **Kerto-S LVL** 2-Ply - PASSED 1.750" X 9.250" BM<sub>2</sub>

Level: Level



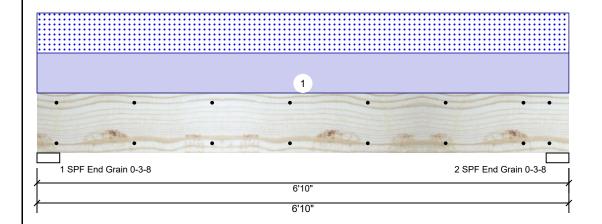

Page 3 of 6

#### Member Information

Type:	Girder
Plies:	2
Moisture Condition:	Dry
Deflection LL:	480
Deflection TL:	360
Importance:	Normal - II
Temperature:	Temp <= 100°F

Application: Floor Design Method: ASD **Building Code: IBC/IRC 2015** 

Load Sharing: No

Not Checked Deck: Ceiling: Gypsum 1/2"

### Reactions UNPATTERNED Ib (Uplift)

Brg	Direction	Live	Dead	Snow	Wind	Const
1	Vertical	0	1463	1438	0	0
2	Vertical	0	1463	1438	0	0

### **Analysis Results**

Analysis	Actual	Location	Allowed	Capacity	Comb.	Case
Moment	4314 ft-lb	3'5"	14423 ft-lb	0.299 (30%)	D+S	L
Unbraced	4314 ft-lb	3'5"	10210 ft-lb	0.423 (42%)	D+S	L
Shear	2005 lb	5'9 1/4"	7943 lb	0.252 (25%)	D+S	L
LL Defl inch	0.041 (L/1843)	3'5"	0.159 (L/480)	0.260 (26%)	S	L
TL Defl inch	0.084 (L/914)	3'5"	0.212 (L/360)	0.394 (39%)	D+S	L

#### Bearings

Bearing	Length	Dir.	Сар. н	React D/L Ib	Iotai	Ld. Case	La. Comb.
1 - SPF End Grain	3.500"	Vert	28%	1463 / 1438	2901	L	D+S
2 - SPF End Grain	3.500"	Vert	28%	1463 / 1438	2901	L	D+S

### **Design Notes**

- 1 Provide support to prevent lateral movement and rotation at the end bearings. Lateral support may also be required at the interior bearings by the building code.
- 2 Fasten all plies using 2 rows of 10d Box nails (.128x3") at 12" o.c. Maximum end distance not to exceed 6".
- 3 Refer to last page of calculations for fasteners required for specified loads.
- 4 Girders are designed to be supported on the bottom edge only.
- 5 Top loads must be supported equally by all plies.
- 6 Top must be laterally braced at end bearings.
- 7 Lateral slenderness ratio based on single ply width.

ID	Load Type	Location	Trib Width	Side	Dead 0.9	Live 1	Snow 1.15	Wind 1.6	Const. 1.25	Comments
1	Uniform			Top	421 PLF	0 PLF	421 PLF	0 PLF	0 PLF	A4

Self Weight 7 PLF

Calculated Structured Designs is responsible only of the structural adequacy of this component based on the design criteria and loadings shown. It is the responsibility of the customer and/or the contractor to ensure the component suitability of the intended application, and to verify the dimensions and loads.

- Dry service conditions, unless noted otherwise
   LVL not to be treated with fire retardant or corrosive
- Handling & Installation
- LVL beams must not be cut or drilled Refer to manufacturer's product information regarding installation requirements, multi-ply fastening details, beam strength values, and code approvals Damaged Beams must not be used
- Design assumes top edge is laterally restrained
  Provide lateral support at bearing points to avoid
  lateral displacement and rotation
- 6. For flat roofs provide proper drainage to prevent ponding

This design is valid until 6/28/2026

Metsä Wood 301 Merritt 7 Building, 2nd Floor Norwalk, CT 06851 (800) 622-5850 www.metsawood.com/us

Manufacturer Info

Comtech, Inc. 1001 S Reilly Road Fayetteville Cumberland 28314

Version 23.40.705 Powered by iStruct™ Dataset: 23090101.2907



Client: Ashley Cummings

Project:

Address:

7481 Old U.S. Highway 421 Lillington, NC 27546

Date: 2/5/2024 Input by: Jonathan Landry Job Name: 7481 Old U.S. Hwy 421


Project #: J1223-6914


**Kerto-S LVL** BM<sub>2</sub>

1.750" X 9.250"

2-Ply - PASSED

Level: Level

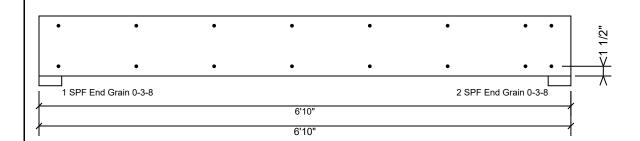

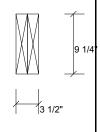

Page 4 of 6

### Multi-Ply Analysis

Fasten all plies using 2 rows of 10d Box nails (.128x3") at 12" o.c.. Maximum end distance not to exceed 6".

Capacity	0.0 %
Load	0.0 PLF
Yield Limit per Foot	163.7 PLF
Yield Limit per Fastener	81.9 lb.
См	1
Yield Mode	IV
Edge Distance	1 1/2"
Min. End Distance	3"
Load Combination	
Duration Factor	1.00

#### Notes

NOtes

Calculated Structured Designs is responsible only of the structural adequacy of this component based on the design criteria and loadings shown. It is the responsibility of the customer and/or the contractor to ensure the component suitability of the intended application, and to verify the dimensions and loads.

- Dry service conditions, unless noted otherwise
   LVL not to be treated with fire retardant or corrosive

### Handling & Installation

- Handling & Installation

  1. UVI beams must not be cut or drilled

  2. Refer to manufacturer's product information regarding installation requirements, multi-ply fastening details, beam strength values, and code approvals

  3. Damaged Beams must not be used

  4. Design assumes top edge is laterally restrained

  5. Provide lateral support at bearing points to avoid lateral displacement and rotation
- For flat roofs provide proper drainage to prevent ponding

This design is valid until 6/28/2026

Metsä Wood 301 Merritt 7 Building, 2nd Floor Norwalk, CT 06851 (800) 622-5850 www.metsawood.com/us

Manufacturer Info



BM<sub>3</sub>

**Kerto-S LVL** 

Client: Project: Address: Ashley Cummings

7481 Old U.S. Highway 421

Date: 2/5/2024 Input by:

Jonathan Landry Job Name: 7481 Old U.S. Hwy 421

> J1223-6914 Level: Level

Page 5 of 6

Lillington, NC 27546 Project #: 2-Ply - PASSED 1.750" X 9.250"

1 2 SPF End Grain 0-3-8 1 SPF End Grain 0-3-8 3 SPF End Grain 0-3-8 4 SPF End Grain 0-3-8 18'5" 16'5' 18 52'10"

Member Inform	Member Information					Reactions UNPATTERNED Ib (Uplift)						
Туре:	Girder	Application:	Floor	Brg	Direction	Live	Dead	Snow	Wind	Const		
Plies:	2	Design Method:	ASD	1	Vertical	0	688	634	0	0		
Moisture Condition:	: Dry	Building Code:	IBC/IRC 2015	2	Vertical	0	1871	1725	0	0		
Deflection LL:	480	Load Sharing:	No	3	Vertical	0	1703	1571	0	0		
Deflection TL:	360	Deck:	Not Checked	4	Vertical	0	609	561	0	0		
Importance:	Normal - II	Ceiling:	Gypsum 1/2"	'	70.1104.	· ·	000	00.	· ·	· ·		
Temperature:	Temp <= 100°F											
				Bea	rings							
				Bea	aring Length	Dir.	Cap. React D	/L lb Tota	Ld. Case	Ld. Comb.		
				1 - End	SPF 3.500" d	Vert	13% 687	/ 671 1358	3 L_L	D+S		

Case

Comb.

Capacity

Analysis Res	ults
Analysis	Actual
Nea Moment	-6198 ft-lb

18'5" 14423 ft-lb 0.430 (43%) D+S LL\_ Pos Moment 4897 ft-lb 7'7 15/16" 14423 ft-lb 0.339 (34%) D+S LL 4897 ft-lb 1 000 Unbraced 7'7 15/16" 4899 ft-lb  $L_L$ (100%)1795 lb 17'6" 7943 lb 0.226 (23%) D+S Shear LL\_ LL Defl inch 0.297 (L/734) 8'8" 0.455 (L/480) 0.654 (65%) S  $L_{\perp}L$ TL Defl inch 0.565 (L/386) 8'6 1/8" 0.606 (L/360) 0.932 (93%) D+S LL

Location Allowed

- 1	Bearing	Length	Dir.	Cap. F	React D/L lb	Total	Ld. Case	Ld. Comb.
	1 - SPF End Grain	3.500"	Vert	13%	687 / 671	1358	L_L	D+S
	2 - SPF End Grain	3.500"	Vert	32%	1872 / 1784	3656	LL_	D+S
	3 - SPF End Grain	3.500"	Vert	29%	1703 / 1652	3356	_LLL	D+S
	4 - SPF End Grain	3.500"	Vert	12%	609 / 606	1215	L_L	D+S

### **Design Notes**

- 1 Provide support to prevent lateral movement and rotation at the end bearings. Lateral support may also be required at the interior bearings by the building code.
- 2 Fasten all plies using 2 rows of 10d Box nails (.128x3") at 12" o.c. Maximum end distance not to exceed 6"
- 3 Refer to last page of calculations for fasteners required for specified loads.
- 4 Girders are designed to be supported on the bottom edge only.
- 5 Top loads must be supported equally by all plies.
- 6 Top must be laterally braced at a maximum of 15'8 3/4" o.c.
- 7 Bottom must be laterally braced at a maximum of 12'3 3/8" o.c.

8 Lateral slenderness ratio based on single ply width.

ID	Load Type	Location	Trib Width	Side	Dead 0.9	Live 1	Snow 1.15	Wind 1.6	Const. 1.25	Comments
1	Uniform			Тор	85 PLF	0 PLF	85 PLF	0 PLF	0 PLF	A2
	Self Weight				7 PLF					

Calculated Structured Designs is responsible only of the structural adequacy of this component based on the design criteria and loadings shown. It is the responsibility of the customer and/or the contractor to ensure the component suitability of the intended application, and to verify the dimensions and loads.

Dry service conditions, unless noted otherwise
 LVL not to be treated with fire retardant or corrosive

### Handling & Installation

LVL beams must not be cut or drilled
Refer to manufacturer's product information regarding installation requirements, multi-ply fastening details, beam strength values, and code approvals

2 Damaged Beams must not be used

Design assumes top edge is laterally restrained
Provide lateral support at bearing points to avoid
lateral displacement and rotation

6. For flat roofs provide proper drainage to prevent ponding

This design is valid until 6/28/2026

Metsä Wood 301 Merritt 7 Building, 2nd Floor Norwalk, CT 06851 (800) 622-5850 www.metsawood.com/us

Manufacturer Info



BM<sub>3</sub>

Client: Ashley Cummings

Project:

Address:


7481 Old U.S. Highway 421 Lillington, NC 27546

Date: 2/5/2024 Input by: Jonathan Landry Job Name: 7481 Old U.S. Hwy 421

Project #: J1223-6914 Level: Level

Page 6 of 6

**Kerto-S LVL** 2-Ply - PASSED 1.750" X 9.250"

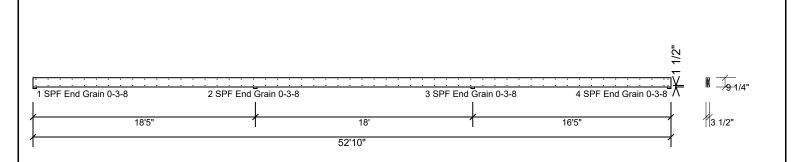

### Multi-Ply Analysis

Fasten all plies using 2 rows of 10d Box nails (.128x3") at 12" o.c.. Maximum end distance not to exceed 6".

	•	
Capacity	0.0 %	
Load	0.0 PLF	
Yield Limit per Foot	163.7 PLF	
Yield Limit per Fastener	81.9 lb.	
См	1	
Yield Mode	IV	
Edge Distance	1 1/2"	
Min. End Distance	3"	
Load Combination		
Duration Factor	1.00	

#### Notes

NOtes
Calculated Structured Designs is responsible only of the structural adequacy of this component based on the design criteria and loadings shown. It is the responsibility of the customer and/or the contractor to ensure the component suitability of the intended application, and to verify the dimensions and loads.

Dry service conditions, unless noted otherwise
 LVL not to be treated with fire retardant or corrosive

### Handling & Installation

Handling & Installation

1. UVI beams must not be cut or drilled

2. Refer to manufacturer's product information regarding installation requirements, multi-ply fastening details, beam strength values, and code approvals

3. Damaged Beams must not be used

4. Design assumes top edge is laterally restrained

5. Provide lateral support at bearing points to avoid lateral displacement and rotation

For flat roofs provide proper drainage to prevent ponding

This design is valid until 6/28/2026

Metsä Wood 301 Merritt 7 Building, 2nd Floor Norwalk, CT 06851 (800) 622-5850 www.metsawood.com/us

Manufacturer Info

