REVISION LOG

REVISION:001

ADJUST OPTION SQUARE FOOTAGES TO ACCURATELY SHOW THE DIFFERENCES FROM THE BASE PLAN SQUARE FOOTAGE TOTALS.

ADJUST OPTION SQUARE FOOTAGES TO ACCURATELY SHOW THE DIFFERENCES FROM THE BASE PLAN

ADJUST OPTION SQUARE FOOTAGES TO ACCURATELY SHOW THE DIFFERENCES FROM THE SOUARE FOOTAGE TOTALS.

EXTENDED TRIM AT GARAGE DOOR DOWN TO BASE AND CUT STONE BACK ADJUSTED KITCHEN ISLAND RESIZED THE FIREPLACE OPTION RELOCATED THE WINDOW IN THE MESSY KITCHEN TO BEHIND THE OPT. SINK CHANGED MESSY KITCHEN WINDOW TO OPTIONAL

6. CHANGED MESSY KITCHEN WINDOW TO OPTIONAL
7. ADDED CHASE TO OWNER'S WIC
8. ADDED DIMS TO 0. BATH VANITY FOR CLARIFICATION
9. REMOVED OPT. DOOR TO LOFT
10. ADDED CHASE TO LOFT WIC
11. RELOCATED LINEN IN THE 0. BATH OPTIONS
12. REMOVED THE OPT. SUPER SHOWER (ZERO ENTRY)
13. FLIPPED SMART DOOR DELIVERY DOOR HANDING
14. CHANGED ALL LINEN CLOSETS TO HAVE ONLY 4 SHELVES
15. CHANGED SIZE OF BASE SHOWER TO 60X36
16. UPDATED OPTIONAL SQ. TE, CHART
17. REMOVED HALF WALLS AT KITCHEN ISLAND AND UPDATED PER CABINET PROVIDER
18. EXTEND PORCH SLAB 4" AT FRONT AND EXTEND AROUND CORNER 20" TO SUPPORT STONE VENEER
19. EXTEND PORCH SLAB 4" AT FRONT AND EXTEND AROUND CORNER 20" TO SUPPORT STONE VENEER
19. EXTEND PORCH SLAB 4" AT FRONT AND EXTEND AROUND CORNER 20" TO SUPPORT STONE VENEER
19. EXTEND PORCH SLAB 4" AD ROUND THE POPULETER AT THE "CREATMAN" (EVALUATION).

19. EXTEND PORCH SLAB 4" AROUND THE PERIMETER AT THE 'CRAFTSMAN' ELEVATION

DATE: 3/30/2022

EXTEND PORCH SLAB 4" AROUND THE PERIMETER AT THE 'CRAFTSMAN' ELEVATION ADDED A COLUMN DETAIL FOR CLARITY ON THE 'CRAFTSMAN' ELEVATION ADDED A SEPARATE OPTION FOR THE POCKET OFFICE WITH THE SMART DELIVERY DOOR ADDED A SEPARATE OPTION FOR THE POCKET OFFICE WITH THE SMART DELIVERY DOOR

REVISION:004 DATE: 6/20/2022

1. ADD SIDE LOAD GARAGE.

REVISION:005

DATE: 7/22/2022

ADD STEM WALL SLAB FOUNDATION SHEETS
 CORRECT OPTIONAL SWART DELIVERY DOOR LOCATION ON FOUNDATION PLANS TO MATCH FLOOR PLAN.

Lot 114 Duncan's Creek - 180 Beacon Hill Road Lillington, NC 27546

PLAN 2 The Holly - RH 'CRAFTSMAN' ELEVATION






DESIGN CRITERIA:

THIS PLAN IS TO BE BUILT IN CONFORMANCE WITH THE 2018 NORTH CAROLINA STATE BUILDING CODE: RESIDENTIAL CODE

DIMENSIONS SHALL GOVERN OVER SCALE, AND CODE SHALL GOVERN OVER DIMENSIONS.

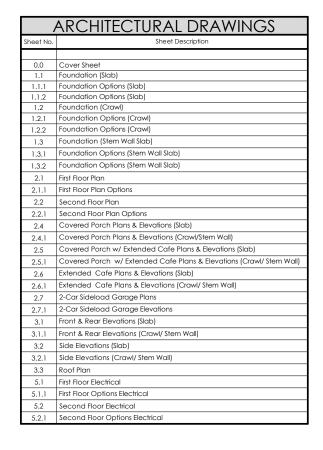

SQUARE FOOTAGE									
	CRAFTSMAN								
	UNHEATED	HEATED							
FIRST FLOOR	0	872							
SECOND FLOOR	0	1345							
FRONT PORCH	125	0							
2 CAR GARAGE	437	0							
PATIO	160	0							
SUBTOTALS	722	2217							
TOTAL UNDER ROOF	29	39							
O	PTIONS								
	UNHEATED S.F.	HEATED S.F.							
EXTENDED PATIO	+148	0							
COVERED PATIO	160	0							
EXTENDED CAFE	0	+152							
REAR POCKET OFFICE	0	+60							
FRONT POCKET OFFICE	0	+39							
FRONT PORCH W/	128	0							
FRONT POCKET OFFICE	120	ı							
	0 +61								
FRONT POCKET OFFICE W/SMART DOOR	0	+61							




l									
	DATE	11/22/2021	2/4/2022	3/30/2022					
	DESCRIPTION	REFER TO COVER SHEET	REFER TO COVER SHEET	REFER TO COVER SHEET	1	-	-	-	ı
	REV.#	٢	2	3	4	2	9	7	8
ı									

RH

Sheet 'Craftsman' - THE HOLLY Cover ~ PLAN.

ISSUE DATE 7/1/2021 JRRENT REVISION DATE:

1/8" = 1'-0"

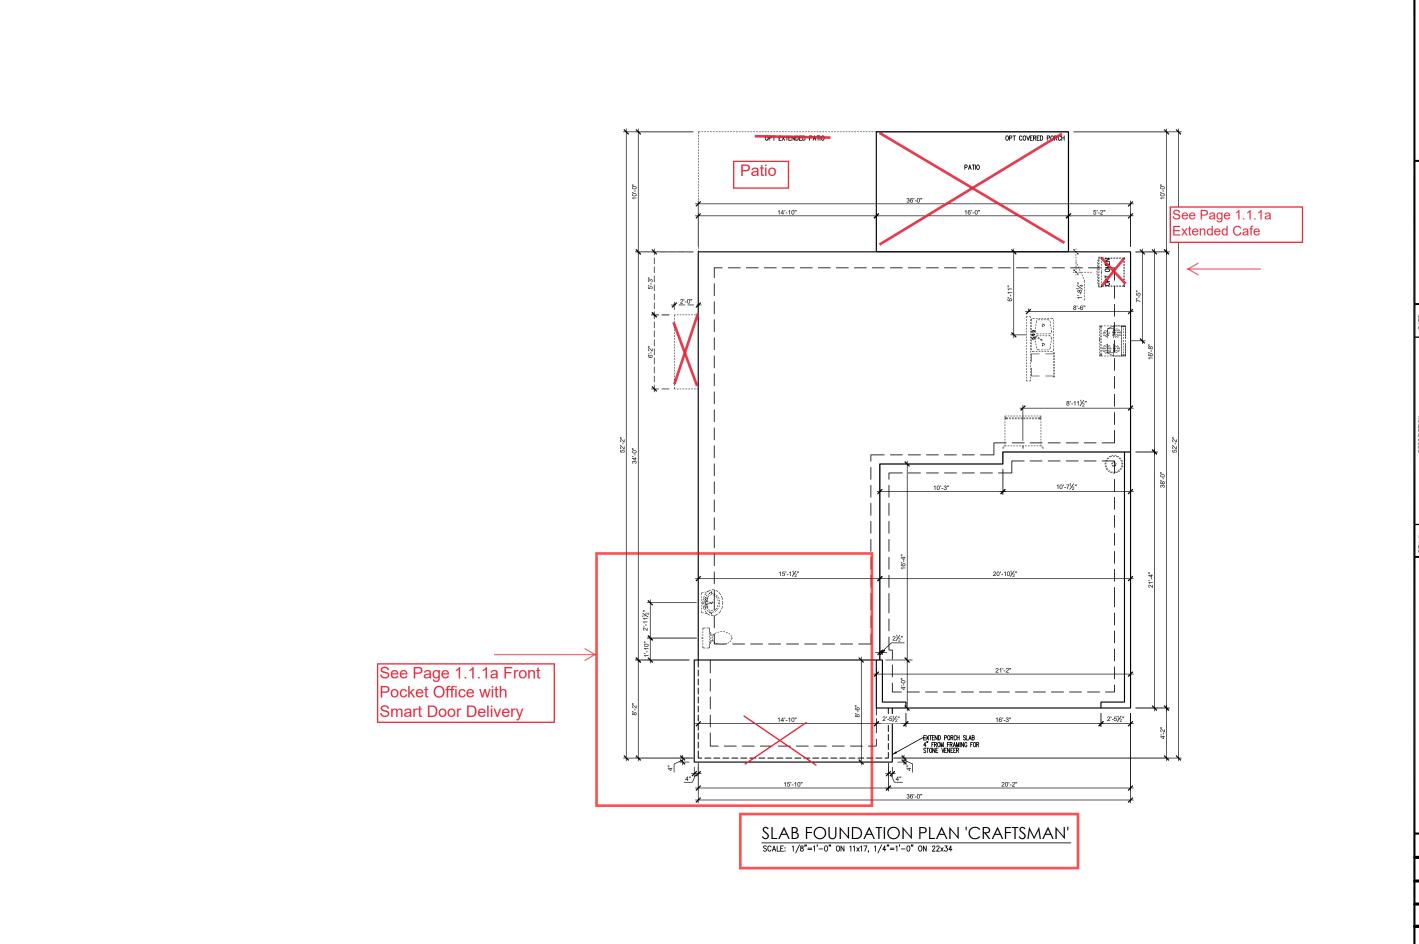

ZNEW PHOME

REV.#	DESCRIPTION	DATE
1	REFER TO COVER SHEET	11/22/2021
2	REFER TO COVER SHEET	2/4/2022
3	REFER TO COVER SHEET	3/30/2022
4		
2	****	
9	-	
7		
ŏ		

PLAN 2 - THE HOLLY - RH ---


Foundation Slab 'Craftsman'


DRAWN BY: South Designs

ISSUE DATE:
7/1/2021
CURRENT REVISION DATE:

SCALE: 1/8" = 1'-0"

1.Îa

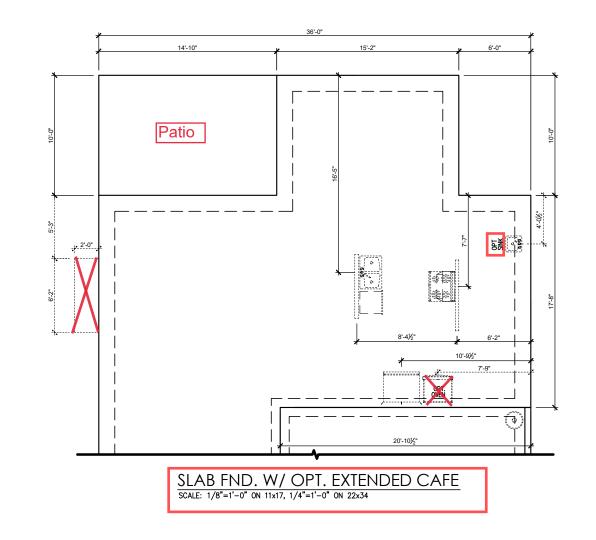

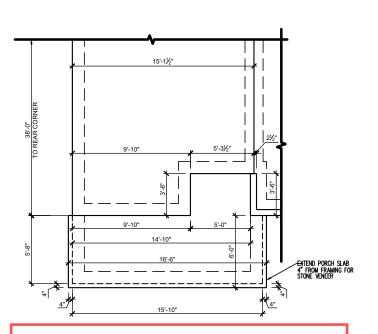

SLAB FND. W/OPT. SMART DOOR
SCALE: 1/8"=1'-0" ON 11x17, 1/4"=1'-0" ON 22x34
*ONLY AVAILABLE W/ POCKET OFFICE OPTION

With From

Pocket Office

	REV.#	DESCRIPTION	۵
DI AN 2 THE HOI I V DH	1	REFER TO COVER SHEET	11/
	2	REFER TO COVER SHEET	/7
	3	REFER TO COVER SHEET	3/3
	4	-	
	5	-	
	9	-	
Foundation Ontions Slab 'Craftsman'	7	-	
r cantagnon opinons state orational	8	_	


DRAWN BY: South Designs

ISSUE DATE: 7/1/2021 CURRENT REVISION DATE:

SCALE: 1/8" = 1'-0"

General Floor Plan Notes shall apply unless noted otherwise on plan.

- Wall Heights: Typically 9'-1 1/2" at first floor and 8'-1 1/2" at second floor and attics U.N.O. All walls are constructed using a double top pidne. Splices at Double Top Pidne do not need to occur at Vertical Studs but must be at least 24" apart from Joint in other Top Pidne layer. Special wall heights are noted on plans where they occur.
- Wall Thickness is typically 3 1/2". 2x6 frame shall be used at walls that back up to plumbing fixtures.
 Walls greater than 10' high shall be framed with 2x6 framing or greater and will be noted as a special condition where it occurs on plan.
- Typical header height shall be 6'-11" AFF at First Floor, and 6'-11" AFF at Second Floor U.N.O. on elevation drawings. Windows at front elevation may be higher at the first floor.
- Jacks: Openings up to 3'-4" wide shall have (1) 2x4
 jack stud SPF on each side. Openings greater than
 3'-4" wide shall have (2) 2x4 jack studs SPF on each
 side.
- Soffits, Coffered Ceilings, Trey Ceilings and other significant ceiling plan elements are shown on the floor plans and are denoted as single dashed lines. Unless specifically call out as included, Kitchens do not include soffits over wall cabinetry.
- Door & Window Frames, where occurring near corners, shall be a minimum of 4 1/2" from corner. Except for walk-in closets with doors near a corner, doors at closets shall be centered an closet.
- Windows: Shall have at least (1) window in each sleeping room, that meets egress. Shall be provided with tempered glass at hazardous glazing areas. False windows shall be installed with obscure alazina.
- Closets for clothing or coat storage shall be equipped with 1 rod/shelf. Closets for linen shall have 4 open equal shelves. Closets for pantries shall have 4 equal wood shelves, painted.
- Stair treads shall be a min of 9" deep, risers shall be a maximum of 8 1/4", unless noted otherwise, per the current North Carolina Residential Code
- 10. Handrails and Guards at stairs shall be 34" above the finished surface of the ramp surface of the stair. Handrails at landings and overlooks of multilevel spaces shall be 36" above finished floor. Guards (pickets or balusters) shall be spaced with no more than 4" between guards.
- 11.Attic Access shall be provided at all attic area with a height greater than 30". Minimum clear attic access shall be 20" x 30". Pull down stairs and access doors in knee walls meeting minimum criteria are also acceptable.
- 12.Garage Door to Living Space shall be 2'-8" x 6'-8" minimum size and shall be 20 minute fire rated and weather sealed.
- 13. Garage Walls, as a minimum, shall be separated from living space by installing 1/2" gypsum board on the garage side of the wall. With habitable space above, the inside of all garage walls require 1/2" GWB supporting 5/8" type X GWB on ceiling.

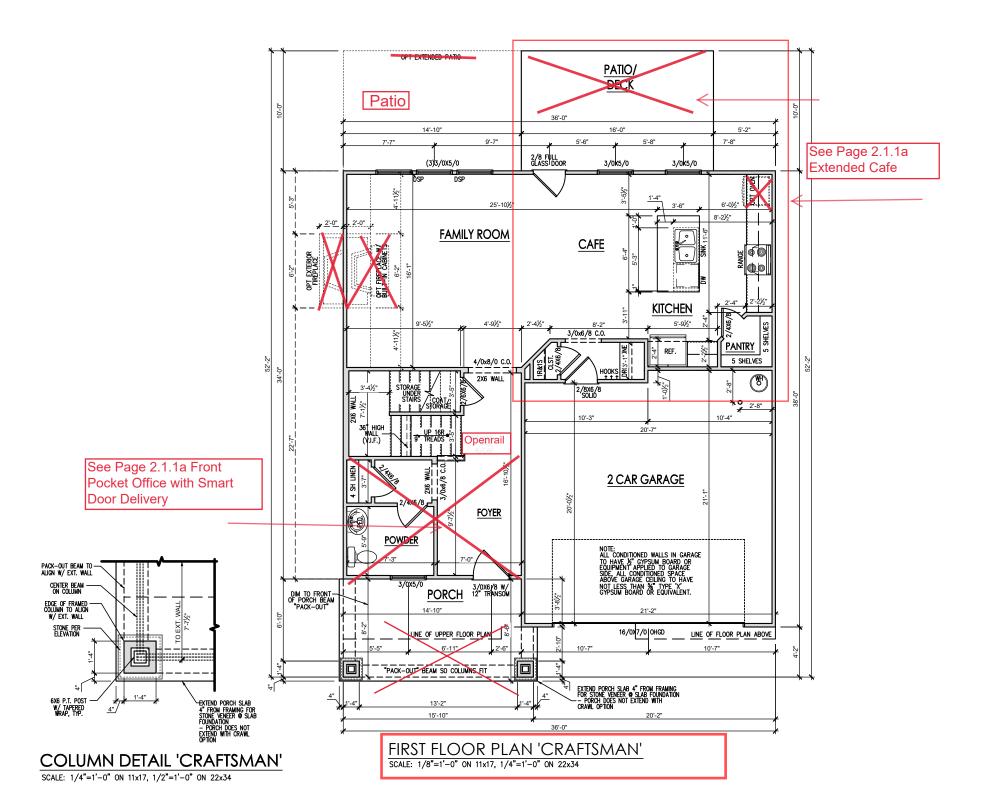

NEW PHOME

REV.# DESCRIPTION DATE 1 REFER TO COVER SHEET 1/1/22/2021 2 REFER TO COVER SHEET 2/4/2022 3 REFER TO COVER SHEET 3/40/2022 4 — 6 — 7 7 8									
	DATE	11/22/2021	2/4/2022	3/30/2022					
REV.# 1 2 2 1 7 7 8 3 8 7 7 8 8	DESCRIPTION	REFER TO COVER SHEET	REFER TO COVER SHEET	REFER TO COVER SHEET	-	-	-	1	-
	REV.#	1	2	3	4	2	9	7	8

PLAN 2 - THE HOLLY --- Plan 'Craftsman'

Floor]

First

RH

DRAWN BY: South Designs


7/1/2021 CURRENT REVISION DATE:


> SCALE: 1/8" = 1'-0"

 $2.\overline{1}a$

General Floor Plan Notes shall apply unless noted otherwise on plan.

- Wall Heights: Typically 9'-1 1/2" at first floor and 8'-1 1/2" at second floor and attics U.N.O. All walls are constructed using a double top plate. Splices at Double Top Plate do not need to occur at Vertical Studs but must be at least 24" apart from Joint in other Top Plate layer. Special wall heights are noted on plans where they occur.
- Wall Thickness is typically 3 1/2". 2x6 frame shall be used at walls that back up to plumbing fixtures.
 Walls greater than 10' high shall be framed with 2x6 framing or greater and will be noted as a special condition where it occurs on plan.
- Typical header height shall be 6'-11" AFF at First Floor, and 6'-11" AFF at Second Floor U.N.O. on elevation drawings. Windows at front elevation may be higher at the first floor.
- Jacks: Openings up to 3'-4" wide shall have (1) 2x4 jack stud SPF on each side. Openings greater than 3'-4" wide shall have (2) 2x4 jack studs SPF on each side.
- Soffits, Coffered Ceilings, Trey Ceilings and other significant ceiling plan elements are shown on the floor plans and are denoted as single dashed lines. Unless specifically call out as included, Kitchens do not include soffits over wall cabinetry.
- Door & Window Frames, where occurring near corners, shall be a minimum of 4 1/2" from corner. Except for walk-in closets with doors near a corner, doors at closets shall be centered on closet.
- Windows: Shall have at least (1) window in each sleeping room, that meets egress. Shall be provided with tempered glass at hazardous glazing areas. False windows shall be installed with obscure glazing.
- Closets for clothing or coat storage shall be equipped with 1 rod/shelf. Closets for linen shall have 4 open equal shelves. Closets for pantries shall have 4 equal wood shelves, painted.
- Stair treads shall be a min of 9" deep, risers shall be a maximum of 8 1/4", unless noted otherwise, per the current North Carolina Residential Code
- 10. Handrails and Guards at stairs shall be 34" above the finished surface of the ramp surface of the stair. Handrails at landings and overlooks of multilevel spaces shall be 38" above finished floor. Guards (pickets or balusters) shall be spaced with no more than 4" between guards.
- Attic Access shall be provided at all attic area with a height greater than 30°. Minimum clear attic access shall be 20° x 30°. Pull down stairs and access doors in knee walls meeting minimum criteria are also acceptable.
- 12. Garage Door to Living Space shall be 2'-8" x 6'-8" minimum size and shall be 20 minute fire rated and weather sealed.
- 13. Garage Walls, as a minimum, shall be separated from living space by installing 1/2" gypsum board on the garage side of the wall. With habitable space above, the inside of all garage walls require 1/2" GWB supporting 5/8" type X GWB on celling.

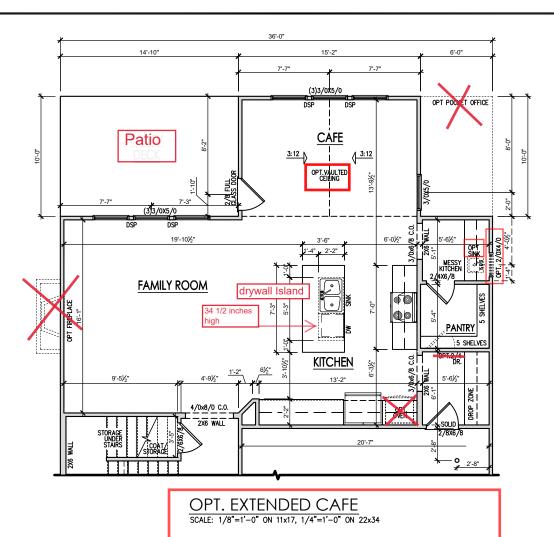

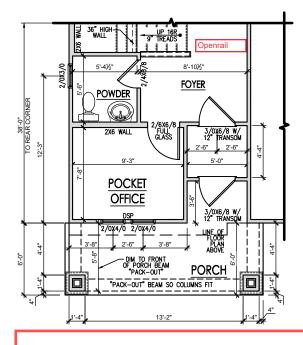

OPT. POCKET OFFICE

W/SMART DOOR DELIVERY CENTER

SCALE: 1/8"=1'-0" ON 11x17, 1/4"=1'-0" ON 22x34

NEW MOHO

l	REV.#	DESCRIPTION	DATE
	-	REFER TO COVER SHEET	11/22/2021
	2	REFER TO COVER SHEET	2/4/2022
	3	REFER TO COVER SHEET	3/30/2022
	4	-	
	2	-	
	9		
	7	-	
	8	-	

PLAN 2 - THE HOLLY - RH
---First Floor Plan Options 'Craftsman'

DRAWN BY: South Designs


ISSUE DATE: 7/1/2021

CURRENT REVISION DATE:
---SCALE:
1/8" = 1'-0"

2.1.1

General Floor Plan Notes shall apply unless noted otherwise on plan.

- Wall Heights: Typically 9°-1 1/2° at first floor and 8°-1 1/2° at second floor and attics U.N.O. All walls are constructed using a double top plate. Splices at Double Top Plate do not need to occur at Vertical Studs but must be at least 24° apart from Joint in other Top Plate layer. Special wall heights are noted on plans where they occur.
- Wall Thickness is typically 3 1/2". 2x6 frame shall be used at walls that back up to plumbing fixtures.
 Walls greater than 10' high shall be framed with 2x6 framing or greater and will be noted as a special condition where it occurs on plan.
- Typical header height shall be 6'-11" AFF at First Floor, and 6'-11" AFF at Second Floor U.N.O. on elevation drawings. Windows at front elevation may be higher at the first floor.
- Jacks: Openings up to 3'-4" wide shall have (1) 2x4 jack stud SPF on each side. Openings greater than 3'-4" wide shall have (2) 2x4 jack studs SPF on each side.
- 5. Soffits, Coffered Ceilings, Trey Ceilings and other significant ceiling plan elements are shown on the floor plans and are denoted as single dashed lines. Unless specifically call out as included, Kitchens <u>do</u> <u>not</u> include soffits over wall cabinetry.
- Door & Window Frames, where occurring near corners, shall be a minimum of 4 1/2" from corner. Except for walk-in closets with doors near a corner, doors at closets shall be centered on closet.
- Windows: Shall have at least (1) window in each sleeping room, that meets egress. Shall be provided with tempered glass at hazardous glazing areas. False windows shall be installed with obscure glazing.
- Closets for clothing or coat storage shall be equipped with 1 rod/shelf. Closets for linen shall have 4 open equal shelves. Closets for pantries shall have 4 equal wood shelves, painted.
- Stair treads shall be a min of 9" deep, risers shall be a maximum of 8 1/4", unless noted otherwise, per the current North Carolina Residential Code
- 10. Handrails and Guards at stairs shall be 34" above the finished surface of the ramp surface of the stair. Handrails at landings and overlooks of multilevel spaces shall be 36" above finished floor. Guards (pickets or balusters) shall be spaced with no more than 4" between guards.
- 11.Attic Access shall be provided at all attic area with a height greater than 30". Minimum clear attic access shall be 20" x 30". Pull down stairs and access doors in knee walls meeting minimum criteria are also acceptable.
- 12.Garage Door to Living Space shall be 2'-8" x 6'-8" minimum size and shall be 20 minute fire rated and weather sealed.
- 13. Garage Walls, as a minimum, shall be separated from living space by installing 1/2" gypsum board on the garage side of the wall. With habitable space above, the inside of all garage walls require 1/2" GWB supporting 5/8" type X GWB on ceiling.

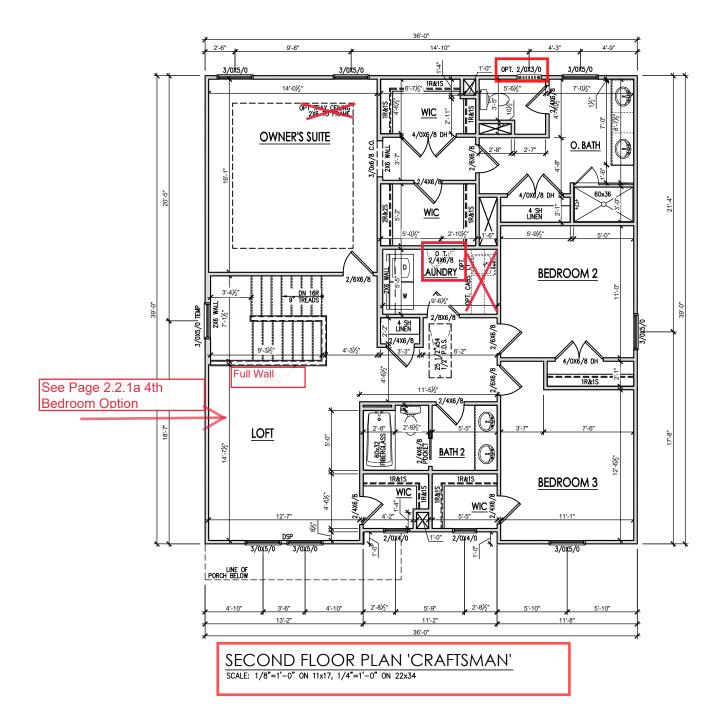



L								
DATE	11/22/2021	2/4/2022	3/30/2022					
DESCRIPTION	REFER TO COVER SHEET	REFER TO COVER SHEET	REFER TO COVER SHEET	-	-	-	1	-
REV.#	1	2	3	4	9	9	7	8

PLAN 2 - THE HOLLY -

Second Floor Plan 'Craftsman'

RH

DRAWN BY: South Designs


ISSUE DATE: 7/1/2021 CURRENT REVISION DATE:

> SCALE: 1/8" = 1'-0"

2.2a

General Floor Plan Notes shall apply unless noted otherwise on plan.

- Wall Heights: Typically 9°-1 1/2° at first floor and 8°-1 1/2° at second floor and attics U.N.O. All walls are constructed using a double top plate. Splices at Double Top Plate do not need to occur at Vertical Studs but must be at least 24° apart from Joint in other Top Plate layer. Special wall heights are noted on plans where they occur.
- Wall Thickness is typically 3 1/2". 2x6 frame shall be used at walls that back up to plumbing fixtures.
 Walls greater than 10' high shall be framed with 2x6 framing or greater and will be noted as a special condition where it occurs on plan.
- 3. Typical header height shall be 6'-11" AFF at First Floor, and 6'-11" AFF at Second Floor U.N.O. on elevation drawings. Windows at front elevation may be higher at the first floor.
- Jacks: Openings up to 3'-4" wide shall have (1) 2x4 jack stud SPF on each side. Openings greater than 3'-4" wide shall have (2) 2x4 jack studs SPF on each side.
- 5. Soffits, Coffered Ceilings, Trey Ceilings and other significant ceiling plan elements are shown on the floor plans and are denoted as single dashed lines. Unless specifically call out as included, Kitchens <u>do</u> <u>not</u> include soffits over wall cabinetry.
- Door & Window Frames, where occurring near corners, shall be a minimum of 4 1/2" from corner. Except for walk-in closets with doors near a corner, doors at closets shall be centered on closet.
- Windows: Shall have at least (1) window in each sleeping room, that meets egress. Shall be provided with tempered glass at hazardous glazing areas. False windows shall be installed with obscure glazing.
- Closets for clothing or coat storage shall be equipped with 1 rod/shelf. Closets for linen shall have 4 open equal shelves. Closets for pantries shall have 4 equal wood shelves, painted.
- Stair treads shall be a min of 9" deep, risers shall be a maximum of 8 1/4", unless noted otherwise, per the current North Carolina Residential Code
- 10. Handralis and Guards at stairs shall be 34" above the finished surface of the ramp surface of the stair. Handralis at landings and overlooks of multillevel spaces shall be 36" above finished floor. Guards (pickets or balusters) shall be spaced with no more than 4" between guards.
- 11. Attic Access shall be provided at all attic area with a height greater than 30". Minimum clear attic access shall be 20" x 30". Pull down stairs and access doors in knee walls meeting minimum criteria are also acceptable.
- 12.Garage Door to Living Space shall be 2'-8" x 6'-8" minimum size and shall be 20 minute fire rated and weather sealed.
- 13. Garage Walls, as a minimum, shall be separated from living space by installing 1/2" gypsum board on the garage side of the wall. With habitable space above, the inside of all garage walls require 1/2" GWB supporting 5/8" type X GWB on ceiling.

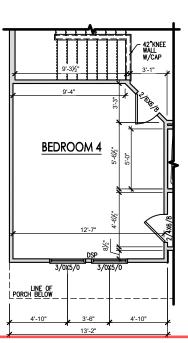

OPT. BEDROOM 4 ILO LOFT SCALE: 1/8"=1'-0" ON 11x17, 1/4"=1'-0" ON 22x34

Ш
≥Σ
ЩO
ラ子
INC.

DATE	11/22/2021	2/4/2022	3/30/2022					!
DESCRIPTION	REFER TO COVER SHEET	REFER TO COVER SHEET	REFER TO COVER SHEET	1	-	_	-	1
REV.#	1	2	3	4	5	9	7	8

-RH

THE HOLLY

~

PLAN (


DRAWN BY: South Designs Second Floor Plan Options 'Craftsman'


ISSUE DATE:

7/1/2021 CURRENT REVISION DATE:

> SCALE: 1/8" = 1'-0"

2.2.1

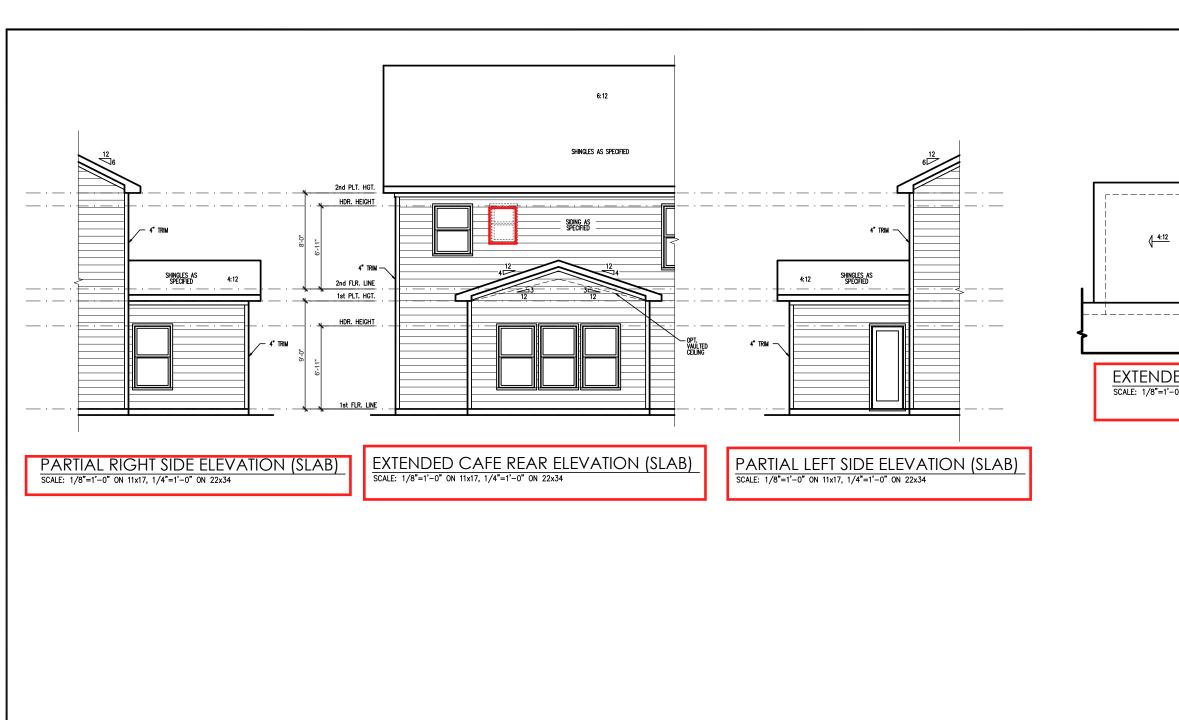

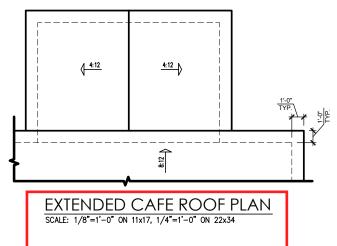

Extended Cafe Plans & Elevations 'Craftsman' Slab

PLAN 2 - THE HOLLY - RH

DRAWN BY: South Designs

ISSUE DATE: 7/1/2021 CURRENT REVISION DATE:

SCALE: 1/8" = 1'-0"

2.6a

General Elevation Notes

General Elevation Notes shall apply unless noted otherwise on plan.

- Roof shall be finished with architectural composition shingles with slopes as noted on plan.
- Ridge Vent shall be provided and installed on all ridges greater than 6' in length per manufacturer's specifications.
- 3. Soffit Vent shall be continuous soffit vent
- House Wrap, "tyvek" or approved equal shall be installed over entire exterior wall per manufacturer's specifications and recommendations.
- Flashing shall be provided above all door and window openings, above finish wall material changes and at wall surfaces where lower roof areas abut vertical wall surfaces.
- Porch Railings shall be provided at all porch walking surfaces greater than 30" above adjacent finished grade. It shall be 36" high with guards spaced no more than 4" apart. Consult community specifications for material.
- Finish Wall Material shall be as noted on elevation drawings.
- 8. Brick Veneer, if included on elevation shall be fled to wall surface with galvanized corrugated metal fles at a rate of 24" oc horizontally and 16" oc vertically so that no more than 2.67sf of brick is supported by (1) fle. Space between face of wall and back face of brick shall be limited to a maximum of 1". Flashing shall be provided behind brick above all wall openings and at base of brick wall. Rashing shall be a minimum of 6-mil poly or other corrosion resistant material and shall be installed so that it laps under the house wrap material a minimum of 2".

 Weepholes shall be provided at a rate of 48" oc and shall not be less than 3/16" in diameter and shall be located immediately above flashing.
- Brick Veneer Support Lintels shall be provided if brick veneer is included on elevation. Lintels shall be provided as listed in the following schedule and shall have a minimum bearing length of 6". Masonry Lintels shall be provided so that deflection is limited to L/600.

sonry Opening Lintel Schedule

Opening Size Angle

 up to 4'-0"
 3-1/2" x 3-1/2" x 5/16"


 4'-1" to 5'-6"
 4" x 3-1/2" x 5/16" LLV

 5'-7" to 6'-6"
 5" x 3-1/2" x 5/16" LLV

 6'-7" to 8'-4"
 6" x 3-1/2" x 5/16" LLV

 8'-5" to 16'-4"
 7" x 4" x 3/8" LLV



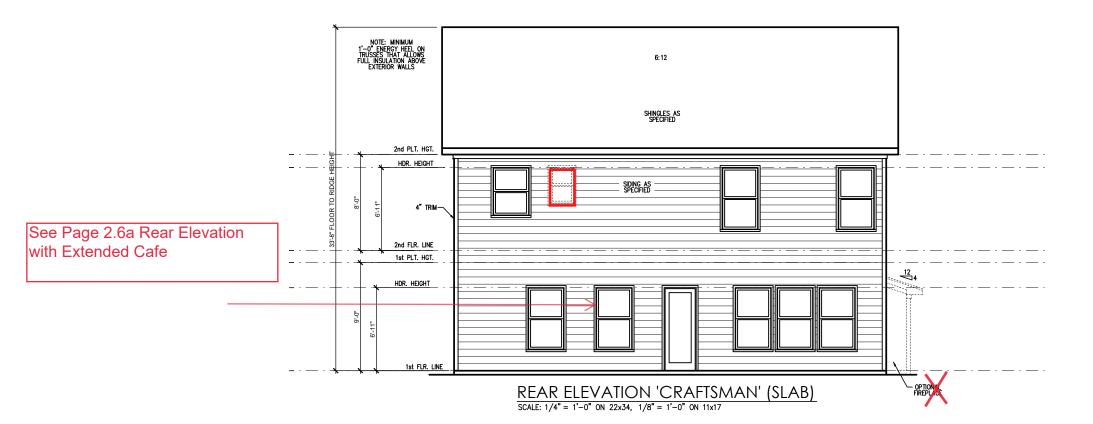

NEW PHOME

	REV.#	DESCRIPTION	DATE
Д	1	REFER TO COVER SHEET	11/22/2021
11	2	REFER TO COVER SHEET	2/4/2022
	3	REFER TO COVER SHEET	3/30/2022
	4		
	2	-	
	9	-	
Slab	7		
	8		

PLAN 2 - THE HOLLY -

Front & Rear Elevations 'Craftsman'

DRAWN BY: South Designs

7/1/2021 CURRENT REVISION DATE:

> SCALE: 1/8" = 1'-0" 3.1a

General Elevation Notes


General Elevation Notes shall apply unless noted otherwise on plan.


- Roof shall be finished with architectural composition shingles with slopes as noted on plan.
- Ridge Vent shall be provided and installed on all ridges greater than 6' in length per manufacturer's specifications.
- 3. Soffit Vent shall be continuous soffit vent
- House Wrap, "tyvek" or approved equal shall be installed over entire exterior wall per manufacturer's specifications and recommendations.
- Flashing shall be provided above all door and window openings, above finish wall material changes and at wall surfaces where lower roof areas abut vertical wall surfaces.
- Porch Raillings shall be provided at all porch walking surfaces greater than 30" above adjacent finished grade. It shall be 36" high with guards spaced no more than 4" apart. Consult community specifications for material.
- Finish Wall Material shall be as noted on elevation drawings.
- 8. Brick Veneer, if included on elevation shall be tied to wall surface with galvanized corrugated metal ties at a rate of 24" oc horizontally and 16" oc vertically so that no more than 2.67st of brick is supported by (1) tie. Space between face of wall and back face of brick shall be limited to a maximum of 1". Flashing shall be provided behind brick above all wall openings and at base of brick wall. Flashing shall be a minimum of 6-mil poly or other corrosion resistant material and shall be installed so that it laps under the house wrap material a minimum of 2". Weepholes shall be provided at a rate of 48" oc and shall not be less than 316" in diameter and shall be located immediately above flashing.
- P. Brick Veneer Support Lintels shall be provided if brick veneer is included on elevation. Lintels shall be provided as listed in the following schedule and shall have a minimum bearing length of 6". Masonry Lintels shall be provided so that deflection is limited to 1/600.

Masonry Opening Lintel Schedule

pening Size Ang

up to 4'-0" 3-1/2" x 3-1/2" x 5/16" 4'-1" to 5'-6" 4" x 3-1/2" x 5/16" LLV 5'-7" to 6'-6" 5" x 3-1/2" x 5/16" LLV 6'-7" to 8'-5" to 16'-4" 7" x 4" x 3/8" LLV

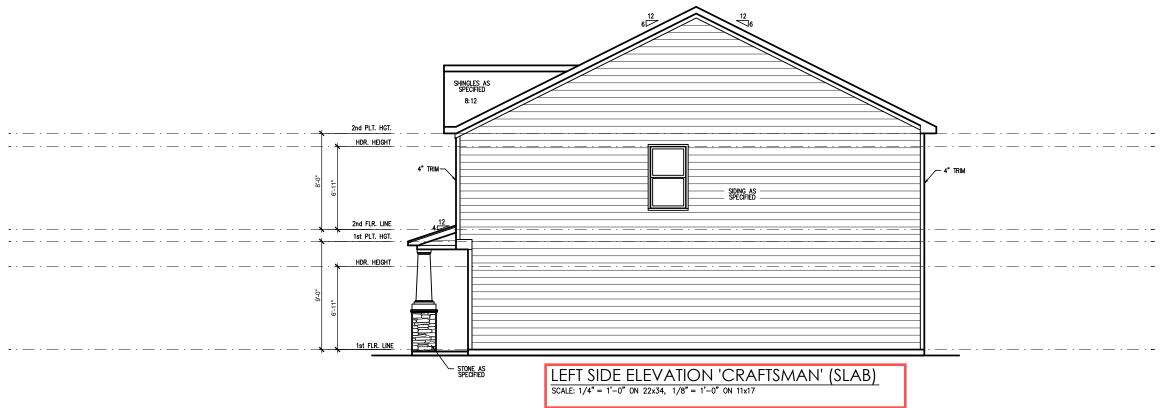

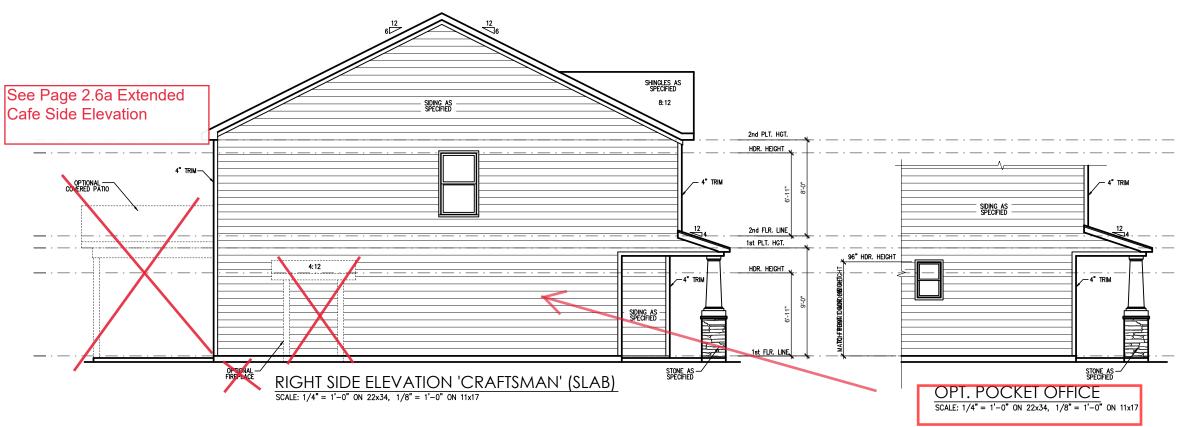



DATE	11/22/2021	2/4/2022	3/30/2022					
DESCRIPTION	REFER TO COVER SHEET	REFER TO COVER SHEET	REFER TO COVER SHEET	****	amma .		-	-
REV.#	1	7	3	7	9	9	7	8

PLAN 2 - THE HOLLY


Side Elevations 'Craftsman' Slab

DRAWN BY: South Designs ISSUE DATE:

7/1/2021
CURRENT REVISION DATE:

3.2a

SCALE: 1/8" = 1'-0"

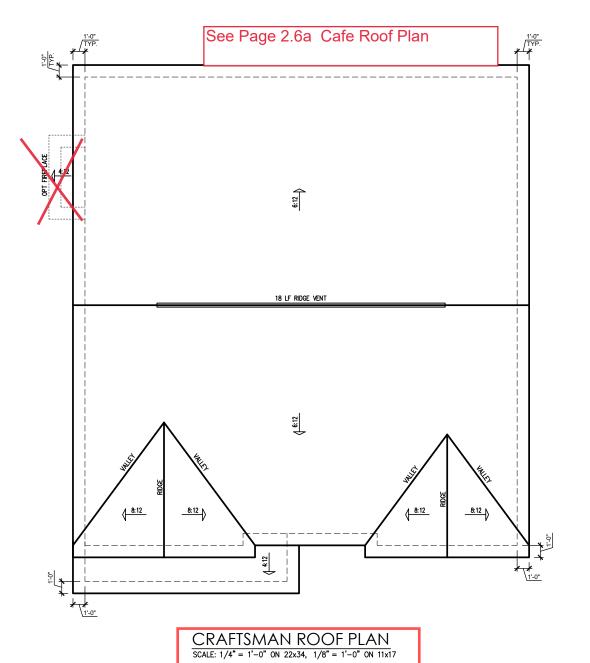

ATTIC VENT SCHEDULE										
CRAFTSMAN										
MAIN HOUSE			SQ FTG	1393	AT / NEAR RIDGE			AT / NEAR EAVE		
VENT TYPE REQUESTANT		. FT.	SQ. FT.	PERCENT OF TOTAL	POT LARGE (SQ. FT. EACH)	POT SMALL (SQ. FT. EACH)	RIDGE VENT (SQ. FT. PER LF)	EAVE VENT (SQ. IN. EACH)	CONT. VENT	
		SUPPLIED	SUPPLIED	0.4236	0.2778	0.125	0.1944	0.0625		
RIDGE VENT	1.86	2.32	3.00	44.44	0	0	24.00			
SOFFIT VENTS	2.79	2.32	3.75	55.56				0	60.00	
TOTAL (MIN)	4.64	4.64	6.75	100.00	POT VENTS MAY BE REQUIRED IF THERE IS INSUFFICIENT RIDGE AVAILABLE					

* SCHEDULE HAS BEEN CALCULATED ASSUMING EAVE VENTILATION AT 50-60% OF TOTAL AND RIDGE AT 40-50% OF TOTAL REQUIRED VENTILATION

NEW HOME:

DATE	11/22/2021	2/4/2022	3/30/2022					
DESCRIPTION	REFER TO COVER SHEET	REFER TO COVER SHEET	REFER TO COVER SHEET	·	omer .	-		-
REV.#	_	2	3	4	5	9	7	8

PLAN 2 - THE HOLLY - RH
--Roof Plan 'Craftsman'

DRAWN BY: South Designs

ISSUE DATE:
7/1/2021
CURRENT REVISION DATE:

SCALE: 1/8" = 1'-0"

3.3a

PROJECT # 21-2816-RH

are to be brought to the are to be brought to the circ. Failure to do so will properly in the circum date of seal.

th.

s not include construction means, methods, techniques
ss, procedures or safety precautions.

stations of discrepances on plans are to be brought to transfer attention of Southern Frainces, Failure to do so to

Southern Engineers, P.A. sequences, p. 3716 Benson Drive, Raleigh, NC 27609 Any devation impediate a phone: (919) 878-1617 Any devation immediate a process. C-4772 Seal is valid former of these confinements and sequences of these confinements.


SOUTH DESIGNS 3716 Bense Pt


2 - The Holly - RH
NEW HOME, INC.

S-1.1

Plan

REFER TO "5D" SHEET(5) FOR STANDARD DETAILS, BRACING DETAILS AND STRUCTURAL NOTES.

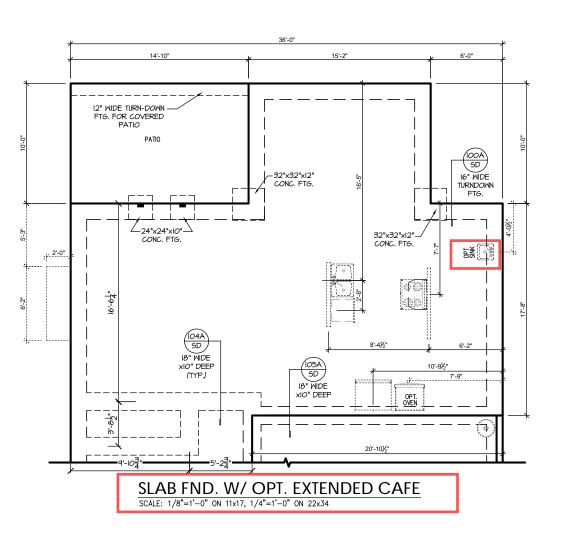

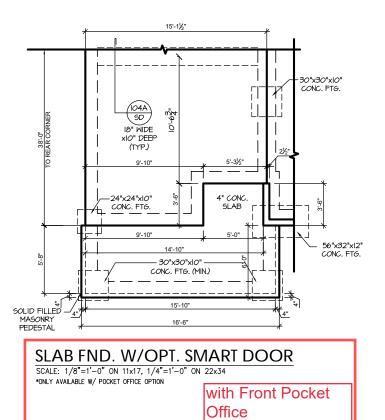



Southern Engineers, P.A. 3716 Benson Drive, Raleigh, NC 27609 Phone: (919) 878-1617 License: C-4772 www.southernengineers.com

PROJECT # 21-2816-RH

SOUTH DESIGNS

RH The Holly NEW HOME, INC. 2

REFER TO "SD" SHEET(S) FOR STANDARD DETAILS, BRACING DETAILS AND STRUCTURAL NOTES.

TRUSS SYSTEM REQUIREMENTS NC (2018 NCRC): Wind: 115-120 mph

- TRUSS SYSTEM LAYOUTS (PLACEMENT PLANS) SHALL BE DESIGNED IN ACCORDANCE WITH SEALED STRUCTURAL PLANS ANY NEED TO CHANGE TRUSSES SHALL BE COORDINATED WITH SOUTHERN
- TRUSS SCHEMATICS (PROFILES) SHALL BE PREPARED AND SEALED BY TRUSS MANUFACTURER.
- ALL TRUSSES SHALL BE DESIGNED FOR BEARING ON SPF #2 OR #3 PLATES OR LEDGERS (UNO).
- ALL REQUIRED ANCHORS FOR TRUSSES DUE TO UPLIFT OR BEARING SHALL MEET THE REQUIREMENTS AS SPECIFIED ON THE TRUSS

HEADER/BEAM & COLUMN NOTES

- ALL EXTERIOR AND LOAD BEARING HEADERS SHALL BE MIN. (2)2x6 (4" WALL) OR (3)2x6 (6" WALL) WITH (I) SUPPORT STUD, UNLESS NOTED
- 2. THE NUMBER SHOWN AT BEAM AND HEADER SUPPORTS INDICATES THE NUMBER OF SUPPORT STUDS REQUIRED IN STUD POCKET OR COLUMN HEADERS IN EXTERIOR WALLS SHALL BE ACCORDING TO ITEM "d" IN TABLE R602.3(5)
 OR AS BELOW PER NCDOI COMMENTARY "KING STUDS AT WALL OPENINGS" REVISED I-9-2020: UP TO 3' SPAN: (I) KING STUD
- OVER 3' UP TO 6' SPAN: (2) KING STUDS OVER 6' UP TO 9' SPAN: (3) KING STUDS
- OVER 9' UP TO 12' SPAN: (4) KING STUDS
- OVER 12' UP TO 15' SPAN: (5) KING STUDS

WOOD "I" JOISTS

- (SHALL BE ONE OF THE FOLLOWING):

 TJI 210 BY TRUS JOIST
- I PI 20 PI IS BY I P
- ALL WOOD "I"JOISTS SHALL BE INSTALLED ACCORDING TO MANUFACTURER'S SPECIFICATIONS.
- INSTALL SQUASH BLOCKS, WEB STIFFENERS ETC. AS REQUIRED BY AND ACCORDING TO THE I-JOIST MANUFACTURER'S SPECIFICATIONS AND INSTRUCTIONS
- HANGERS FOR I-JOISTS ARE THE RESPONSIBILITY OF THE I-JOIST SUPPLIER.
- FLOOR TRUSSES BY MANUFACTURER MAY BE

- PORCH POST NOTES:

 4X4 (6x6) TRT'D POST (OR EQUAL).
- ATTACH TRUSSES (RAFTERS) AT PORCH WITH HURRIGANE CONNECTORS.
- POST CAP: SIMPSON AC4-MAX (AC6-MAX)
 POST CAP AT CORNER: (2) SIMPSON LCE4
- MITER HEADER AT CORNER). HIGH WIND; ADD (1) SIMPSON H6.
- POST BASE: SIMPSON ABU44 (ABU66).
- MONO: %" ANCHOR (EMBED 7")
 CMU: %" ANCHOR (EXTEND TO FOOTING -
- HIGH WIND ONLY) POST BASE: WOOD FOUNDATION: (2) SIMPSON
- CSI6 STRAPS AT POSTS. EXTEND 12" ONTO EACH POST (UPPER AND LOWER) OR TO GIRDER.

and Smart Door

Delivery

NOTE: EQUIVALENT POST CAP AND BASE ACCEPTABLE.

FRAMING NOTES


NC (2018 NCRC): Wind: 115-120 mph

- BRACING METHOD AND TYPE: CONTINUOUSLY SHEATHED WSP. CS-WSP. NOTE THAT THE WALL BRACING AMOUNT PROVIDED ON THE PLANS (DETAILS AND SPECIFICATIONS) IS GREATER THAN THE AMOUNT OF WALL BRACING REQUIRED BY SECTION R602.10 OF THE CODE. SEE NOTES BELOW FOR DETAILS AND SPECIFICATIONS FOR WALL BRACING AND WALL FRAMING.
- 2. EXTERIOR WALL SHEATHING: WALLS SHALL BE BRACED BY SHEATHING WALLS ON ALL STORIES WITH WOOD STRUCTURAL PANEL SHEATHING (MSP) (EXPOSURE B: 7/16", EXPOSURE C: 15/32"), SHEATHING SHALL BE ATTACHED WITH 8d NAILS AT A 6"/12" NAILING PATTERN (6" OC AT PANEL EDGES AND 12" OC AT INTERMEDIATE SUPPORTS). INSTALL BLOCKING AT ALL PANEL EDGES.
- 3. WSP SHEATHING SHALL EXTEND TO THE UPPERMOST DOUBLE BEARING PLATE. BLOCK AT ROOF PER SECTION R602.IO.4.5 AND ATTACH BRACED WALLS PER CODE, WSP SHEATHING BETWEEN FLOORS SHALL BE SPLICED ALONG CONTINUOUS BAND OR THE MSP SHEATHING MAY BE SPLICED ACROSS STUDS (CONTINUOUS ACROSS FLOOR SYSTEM) WITH BLOCKING AT PANEL EDGES. (MINIMUM 12" BEYOND FLOOR BREAK) OR OTHER APPROVED METHOD.
- 4. "HD" = HOLDOWN: HOLD-DOWN DEVICE (NOTED AS "HD" ON PLANS)
 SHALL BE AN 800 POUND CAPACITY ASSEMBLY AS NOTED ON PLANS,
 SEE DETAILS FOR HD ASSEMBLY.
- **GROUND/FIRST FLOOR: USE "HD HOLD-DOWN DETAIL" ON SD SHEET
- (OR EGUIV.)

 **UPPER FLOORS: ATTACH BASE OF KING STUD WITH A SIMPSON CS22

 STRAP DOWN ACROSS THE BAND AND DOWN TO A STUD BELOW OR

 HEADER BELOW. EXTEND STRAP 7" MIN ALONG EACH STUD (OR HEADER) AND ATTACH EACH END W/ (7) 8d NAILS.
- 5. INTERIOR BRACED WALL: (NOTED AS "IBW" ON PLANS) ATTACH I/2" GYPSUM BOARD (GB) ON EACH SIDE OF WALL WITH A MIN. OF 5d COOLER NAILS OR #6 SCREWS @ 7" O.C. ALONG THE EDGES AND AT INTERMEDIATE SUPPORTS.
- 6. INTERIOR BRACED WALL-WOOD STRUCTURAL PANEL: (NOTED AS "IBM-MSP" ON PLANS). ATTACH ONE SIDE WITH 1/6" MSP SHEATHING WITH 8d NAILS AT A 6"/12" NAILING PATTERN (6" OC AT PANEL EDGES AND 12" OC AT INTERMEDIATE SUPPORTS). INSTALL BLOCKING AT ALL PANEL EDGES, ATTACH GB OVER WSP AS REQUIRED, ATTACH OPPOSITE SIDE WITH 1/2" GB WITH A MIN. OF 5d COOLER NAILS OR #6 SCREMS @ 7" OC ALONG THE EDGES AND AT INTERMEDIATE

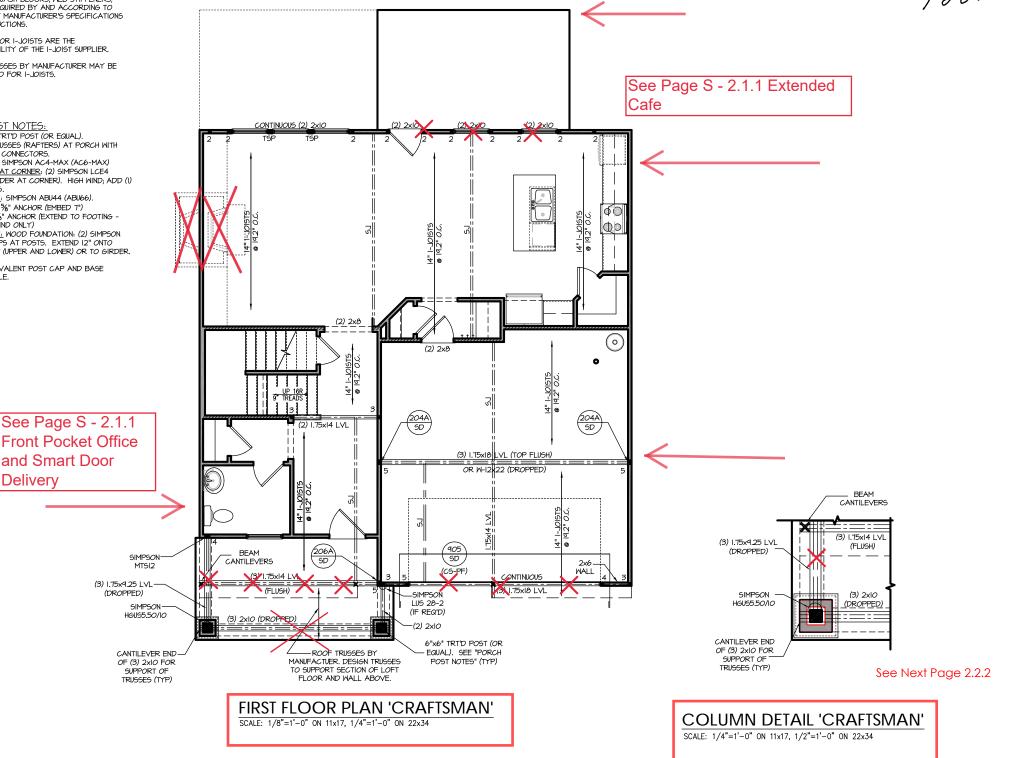



REFER TO "SD" SHEET(S) FOR STANDARD DETAILS BRACING DETAILS AND STRUCTURAL NOTES. PROJECT # 21-2816-RH

CARO

e to be brought to the Failure to do so will

P.A. 27609 Engineers, Drive, Raleigh, NC Southern Engi 3716 Benson Drive, Ra Phone: (919) 8

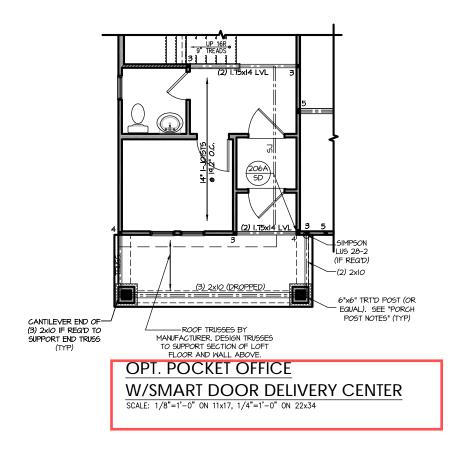

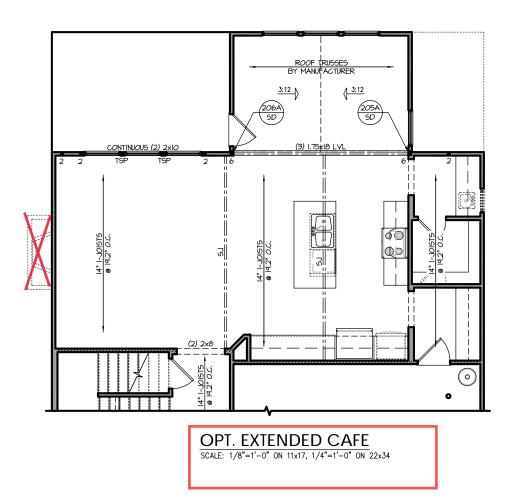

Southern Engineers, P.A. 3716 Benson Drive, Raleigh, NC 27609 Phone: (919) 878-1617 License: C-4772 www.southernengineers.com

PROJECT # 21-2816-RH

SOUTH DESIGNS

RH The Holly NEW HOME, INC.

S-2.1

Plan

REFER TO "SD" SHEET(S) FOR STANDARD DETAILS, BRACING DETAILS AND STRUCTURAL NOTES.

TRUSS SYSTEM REQUIREMENTS NC (2018 NCRC): Wind: 115-120 mph

- TRUSS SYSTEM LAYOUTS (PLACEMENT PLANS) SHALL BE DESIGNED IN ACCORDANCE WITH SEALED STRUCTURAL PLANS ANY NEED TO CHANGE TRUSSES SHALL BE COORDINATED WITH SOUTHERN
- TRUSS SCHEMATICS (PROFILES) SHALL BE PREPARED AND SEALED BY TRUSS MANUFACTURER.
- ALL TRUSSES SHALL BE DESIGNED FOR BEARING ON SPF #2 OR #3 PLATES OR LEDGERS (UNO).
- ALL REQUIRED ANCHORS FOR TRUSSES DUE TO UPLIFT OR BEARING SHALL MEET THE REQUIREMENTS AS SPECIFIED ON THE TRUSS

HEADER/BEAM & COLUMN NOTES

- ALL EXTERIOR AND LOAD BEARING HEADERS SHALL BE MIN. (2)2x6 (4" WALL) OR (3)2x6 (6" WALL) WITH (I) SUPPORT STUD, UNLESS NOTED
- 2. THE NUMBER SHOWN AT BEAM AND HEADER SUPPORTS INDICATES THE NUMBER OF SUPPORT STUDS REQUIRED IN STUD POCKET OR COLUMN. THE NUMBER OF KING STUDS AT EACH END OF HEADERS IN EXTERIOR WALLS SHALL BE ACCORDING TO ITEM "d" IN TABLE R602.3(5)
 OR AS BELOW PER NCDOI COMMENTARY "KING STUDS AT WALL OPENINGS" REVISED I-9-2020: UP TO 3' SPAN: (I) KING STUD
- OVER 3' UP TO 6' SPAN: (2) KING STUDS OVER 6' UP TO 9' SPAN: (3) KING STUDS
- OVER 9' UP TO 12' SPAN: (4) KING STUDS
- OVER 12' UP TO 15' SPAN: (5) KING STUDS

FRAMING NOTES

NC (2018 NCRC): Wind: 115-120 mph

- BRACING METHOD AND TYPE: CONTINUOUSLY SHEATHED WGP; CS-WGP. NOTE THAT THE WALL BRACING AMOUNT PROVIDED ON THE PLANS (DETAILS AND SPECIFICATIONS) IS GREATER THAN THE AMOUNT OF WALL BRACING REQUIRED BY SECTION R602.10 OF THE CODE. SEE NOTES BELOW FOR DETAILS AND SPECIFICATIONS FOR WALL BRACING AND WALL FRAMING.
- 2. EXTERIOR WALL SHEATHING: WALLS SHALL BE BRACED BY SHEATHING WALLS ON ALL STORIES HITH WOOD STRUCTURAL PANEL SHEATHING (WSP) (EXPOSURE B: 7/16". EXPOSURE C: 15/32"). SHEATHING SHALL BE ATTACHED WITH 8d NAILS AT A 6"/12" NAILING PATTERN (6" OC AT PANEL EDGES AND 12" OC AT INTERMEDIATE SUPPORTS). INSTALL BLOCKING AT ALL PANEL EDGES.
- 3. WSP SHEATHING SHALL EXTEND TO THE UPPERMOST DOUBLE BEARING PLATE. BLOCK AT ROOF PER SECTION R602.IO.4.5 AND ATTACH BRACED WALLS PER CODE, WSP SHEATHING BETWEEN FLOORS SHALL BE SPLICED ALONG CONTINUOUS BAND OR THE MSP SHEATHING MAY BE SPLICED ACROSS STUDS (CONTINUOUS ACROSS FLOOR SYSTEM) WITH BLOCKING AT PANEL EDGES. (MINIMUM 12" BEYOND FLOOR BREAK) OR OTHER APPROVED METHOD.
- 4. "HD" = HOLDOWN: HOLD-DOWN DEVICE (NOTED AS "HD" ON PLANS)
 SHALL BE AN 800 POUND CAPACITY ASSEMBLY AS NOTED ON PLANS.
 SEE DETAILS FOR HD ASSEMBLY.
- **GROUND/FIRST FLOOR: USE "HD HOLD-DOWN DETAIL" ON SD SHEET
- ***UPPER FLOORS: ATTACH BASE OF KING STUD MITH A SIMPSON C522
 STRAP DOWN ACROSS THE BAND AND DOWN TO A STUD BELOW OR
 HEADER BELOW. EXTEND STRAP 7" MIN ALONG EACH STUD (OR HEADER) AND ATTACH EACH END W/ (7) 8d NAILS.
- 5. INTERIOR BRACED WALL: (NOTED AS "IBW" ON PLANS) ATTACH I/2" GYPSUM BOARD (GB) ON EACH SIDE OF WALL MITH A MIN. OF 5d COOLER NAILS OR #6 SCREMS @ 7" O.C. ALONG THE EDGES AND AT INTERMEDIATE SUPPORTS.
- 6. INTERIOR BRACED WALL-WOOD STRUCTURAL PANEL: (NOTED AS "IBM-MSP" ON PLANS). ATTACH ONE SIDE WITH 1/6" MSP SHEATHING WITH 8d NAILS AT A 6"/12" NAILING PATTERN (6" OC AT PANEL EDGES AND 12" OC AT INTERMEDIATE SUPPORTS). INSTALL BLOCKING AT ALL PANEL EDGES, ATTACH GB OVER WSP AS REQUIRED, ATTACH OPPOSITE SIDE WITH 1/2" GB WITH A MIN. OF 5d COOLER NAILS OR #6 SCREMS @ 7" OC ALONG THE EDGES AND AT INTERMEDIATE

SIMPSON C520 OR C5HP20 STRAP DOWN ACROSS THE BAND AND DOWN TO A STUD BELOW OR HEADER BELOW. EXTEND STRAP 9" MIN ALONG EACH STUD (OR HEADER) AND ATTACH EACH END W (8) 8d COMMON NAILS (OR EQ). <u>WIC</u> WIC ROOF TRUSSES MANUFACTURE ROOF TRUSSES ____

ATTACH BASE OF STUD WITH A

See Page S - 2.2.1 4th Bedroom

> SECOND FLOOR PLAN 'CRAFTSMAN' SCALE: 1/8"=1'-0" ON 11x17, 1/4"=1'-0" ON 22x34



PROJECT #


21-2816-RH

P.A. 27609 Southern Engineers, F 3716 Benson Drive, Raleigh, NC 2' Phone: (919) 878-1617

REFER TO "SD" SHEET(S) FOR STANDARD DETAILS BRACING DETAILS AND STRUCTURAL NOTES.



NO STRUCTURAL CHANGES FROM BASE PLAN

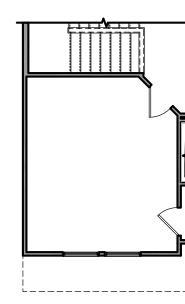

OPT. BEDROOM 4 ILO LOFT SCALE: 1/8"=1'-0" ON 11x17, 1/4"=1'-0" ON 22x34

Southern Engineers, P.A. 3716 Benson Drive, Raleigh, NC 27609 Phone: (919) 878-1617 License: C-4772 www.southernengineers.com

PROJECT # 21-2816-RH

SOUTH DESIGNS

The Holly - RH NEW HOME, INC.

S-2.2.

Plan

TRUSS SYSTEM REQUIREMENTS NC (2018 NCRC): Wind: 115-120 mph


- I. TRUSS SYSTEM LAYOUTS (PLACEMENT PLANS)
 SHALL BE DESIGNED IN ACCORDANCE WITH SEALED
 STRUCTURAL PLANS. ANY NEED TO CHANGE
 TRUSSES SHALL BE COORDINATED WITH SOUTHERN
 ENGINEERS.
- TRUSS SCHEMATICS (PROFILES) SHALL BE
 PREPARED AND SEALED BY TRUSS MANUFACTURER.
- 3. ALL TRUSSES SHALL BE DESIGNED FOR BEARING ON SPF #2 OR #3 PLATES OR LEDGERS (UNO).
- ALL REQUIRED ANCHORS FOR TRUSSES DUE TO UPLIFT OR BEARING SHALL MEET THE REQUIREMENTS AS SPECIFIED ON THE TRUSS SCHEMATICS.

ATTIC VENT SCHEDULE										
CRAFTSMAN										
MAIN HOUSE			SQ FTG	1393	AT	/ NEAR RID	AT / NEAR EAVE			
VENT TYPE	SQ. FT.		SQ. FT. SUPPLIED	PERCENT OF TOTAL SUPPLIED	POT LARGE (SQ. FT. EACH)	POT SMALL (SQ. FT. EACH)	RIDGE VENT (SQ. FT. PER LF)	EAVE VENT (SQ. IN. EACH)	CONT. VENT (SQ. IN. PER LF)	
	RAN	IGE			0.4236	0.2778	0.125	0.1944	0.0625	
RIDGE VENT	1.86	2.32	3.00	44.44	0	0	24.00			
SOFFIT VENTS	2.79	2.32	3.75	55.56			0	60.00		
TOTAL (MIN)	4.64	4.64	6.75	100.00	POT VENTS MAY BE REQUIRED IF THERE IS INSUFFICIENT RIDGE AVAILABLE					

* SCHEDULE HAS BEEN CALCULATED ASSUMING EAVE VENTILATION AT 50-60% OF TOTAL AND RIDGE AT 40-50% OF TOTAL REQUIRED VENTILATION



See S- 6.1 Extended Cafe Roof Plan

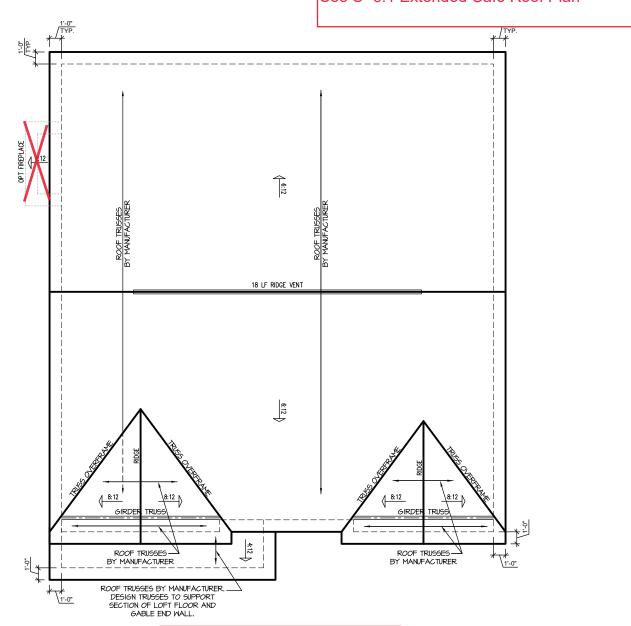

CRAFTSMAN ROOF PLAN
SCALE: 1/4" = 1'-0" ON 22x34, 1/8" = 1'-0" ON 11x17

PROJECT # 21-2816-RH

re to be brought to the Fallure to do so will from date of seal.

nclude construction means, methods, techniq sedures or safety precautions. or discrepances on plans are to be brought

sequences, procedures or safety precautions
Any deviations or discrepancies on plans at
Immediate attention of Southern Engineers
void Southern Engineer's liability.
Seal is valid for projects permitted one year
Use of these plans constitutes amoral of the


Southern Engineers, P.A. 3716 Benson Drive, Raleigh, NC 27609 Phone: (919) 878-1617

SOUTH DESIGNS

: - The Holly - R

S-3.1

REFER TO "SD" SHEET(S) FOR STANDARD DETAILS, BRACING DETAILS AND STRUCTURAL NOTES.

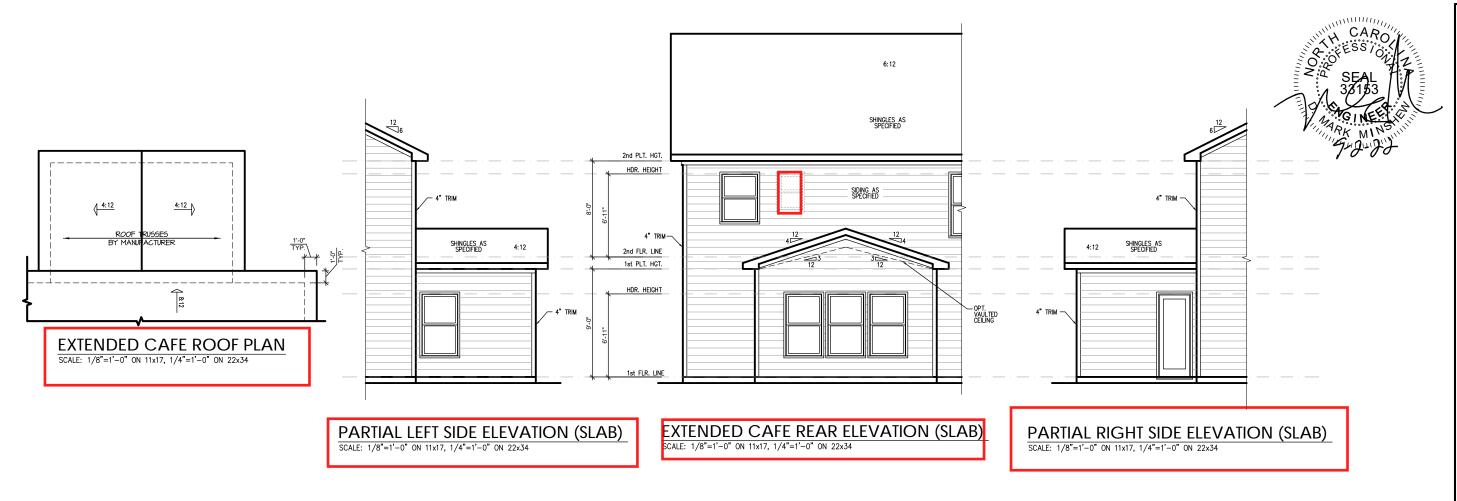

PROJECT # 21-2816-RH

brought to the e to do so will atte of seal.

in sea applies only to structural components on this int.
s. not include construction means, methods, techniques, procedures or safety precautions.

Seal does not include construction means sequences, procedures or safety precaution. Any deviations or discrepancies on plans immediate attention of Southern Engineer void Southern Engineer's liability.

Southern Engineers, P.A. 3716 Benson Drive, Raleigh, NC 27609 Phone: (919) 878-1617

SOUTH DESIGNS

2 - The Holly - RH
NEW HOME, INC.

S-6.1