

THIS PLAN HAS BEEN DRAWN TO CONFORM TO THE 2018 NORTH CAROLINA RESIDENTIAL CODE


CONTRACTOR SHALL VERIFY ALL DIMENSIONS AND CONDITIONS PRIOR TO BEGGINING WORK. CONTRACTOR IS RESPONSIBLE FOR COMPLIANCE WITH ALL STATE AND LOCAL BUILDING CODES AND ORDINANCES. KADS CUSTOM HOME DESIGNS ASSUMES NO LIABILITY FOR SITE CONDITIONS, CONSTRUCTION METHODS OR ANY DEVIATION OF THESE PLANS.


NOTE:


ALL WINDOWS TO BE INSTALLED MUST MEET
A MAXIMUM OF .32 U VALUE OR BETTER, UNLESS
ENERGY CALCULATIONS ARE SUBMITTED WITH PLANS
PROVIDED BY BUILDER AT TIME OF PLAN REVIEW.

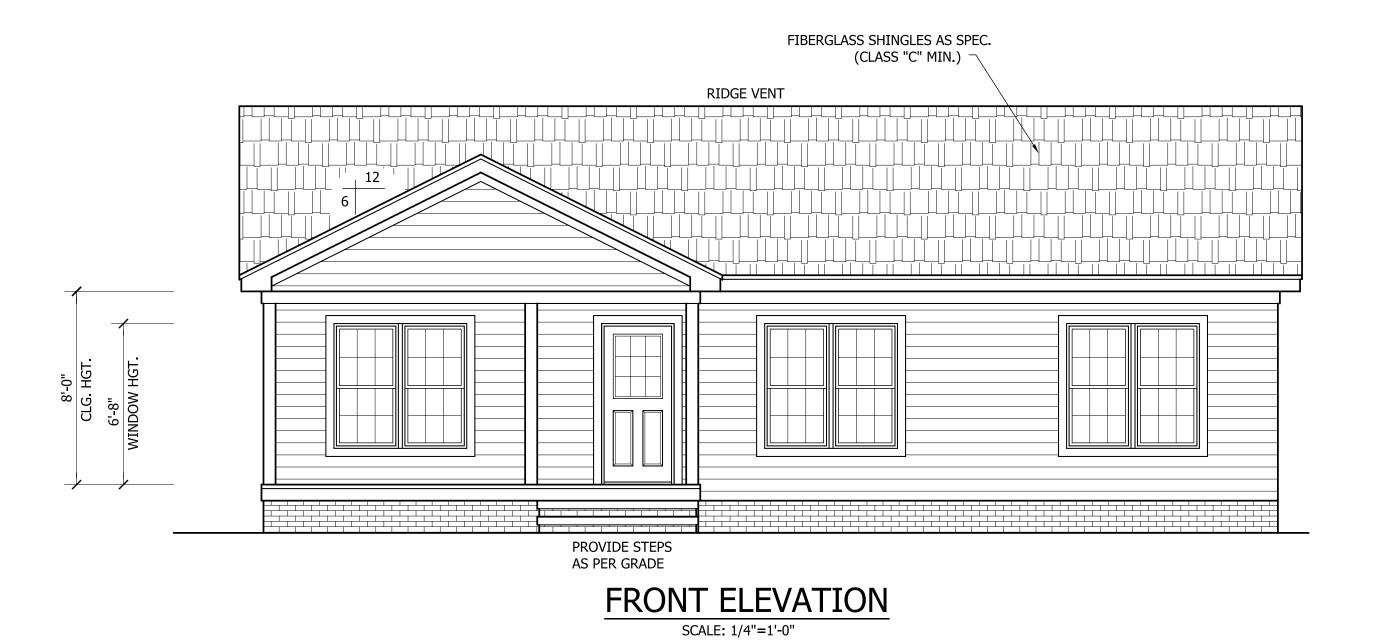

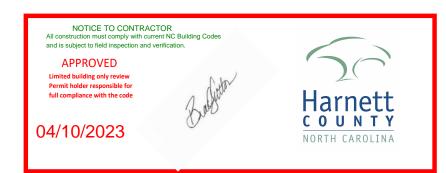

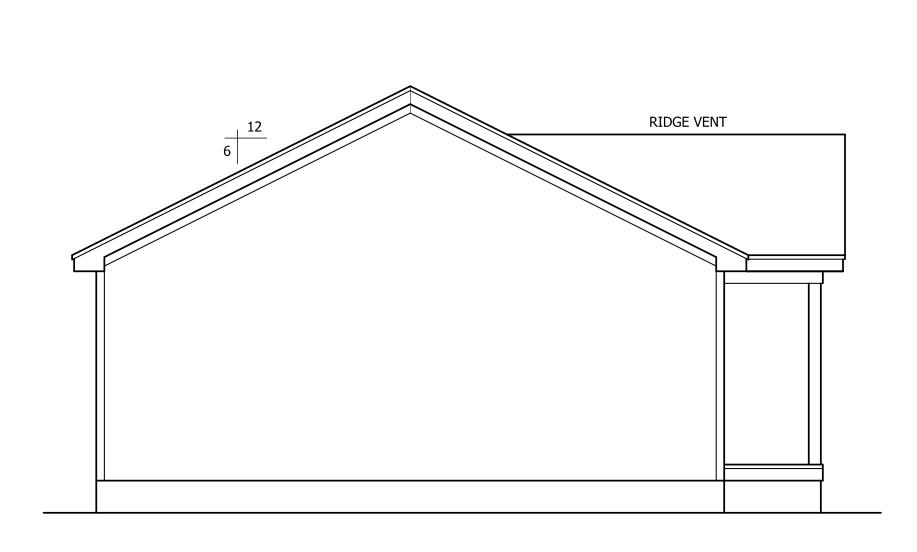

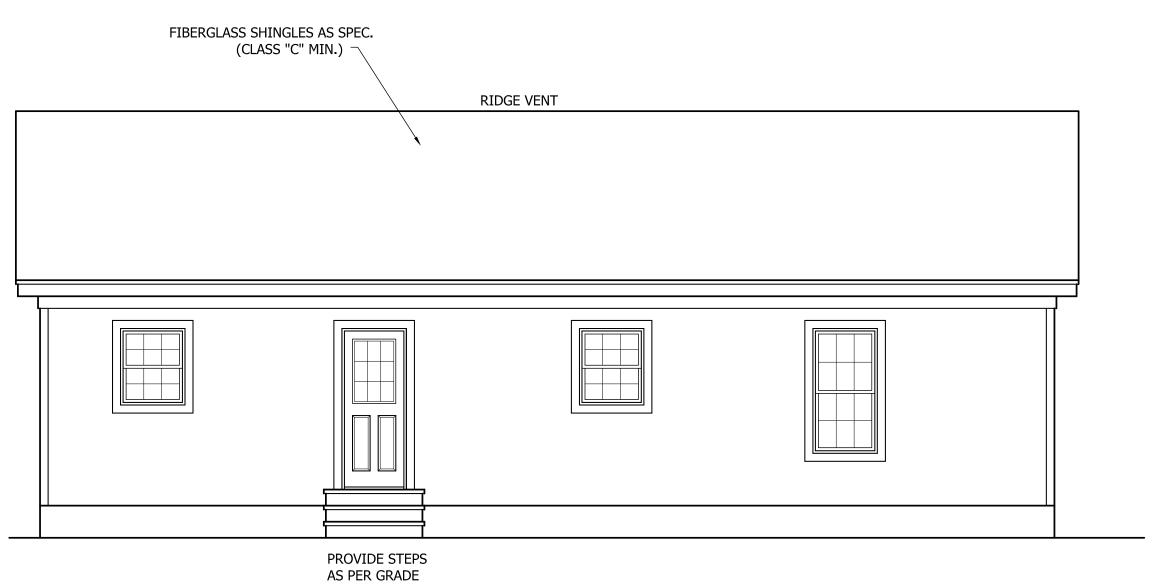

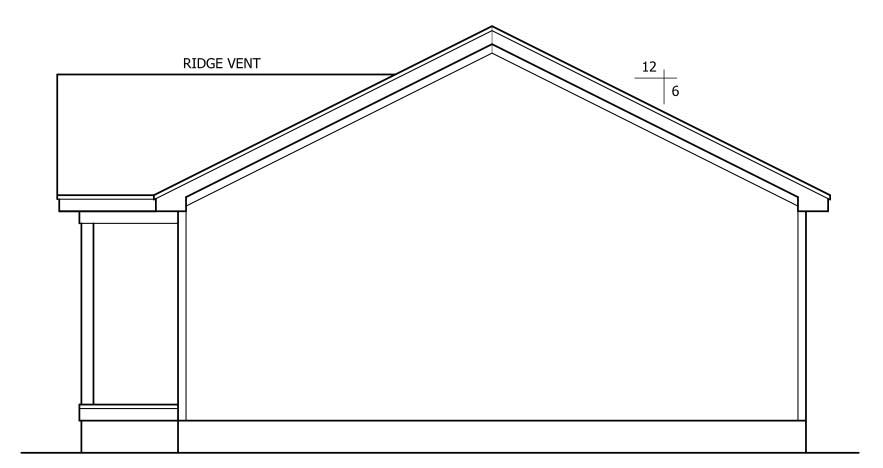

LEFT ELEVATION

SCALE: 1/4"=1'-0"

REAR ELEVATION

SCALE: 1/4"=1'-0"

RIGHT ELEVATION

SCALE: 1/4"=1'-0"

CUSTOM HOME DESIGNS

ANGIER, NC 919-369-7181

DRAWN BY: D.W.O.


DATE: 3/24/23


PAGE NO


1


OF

PLAN NO. DK1092

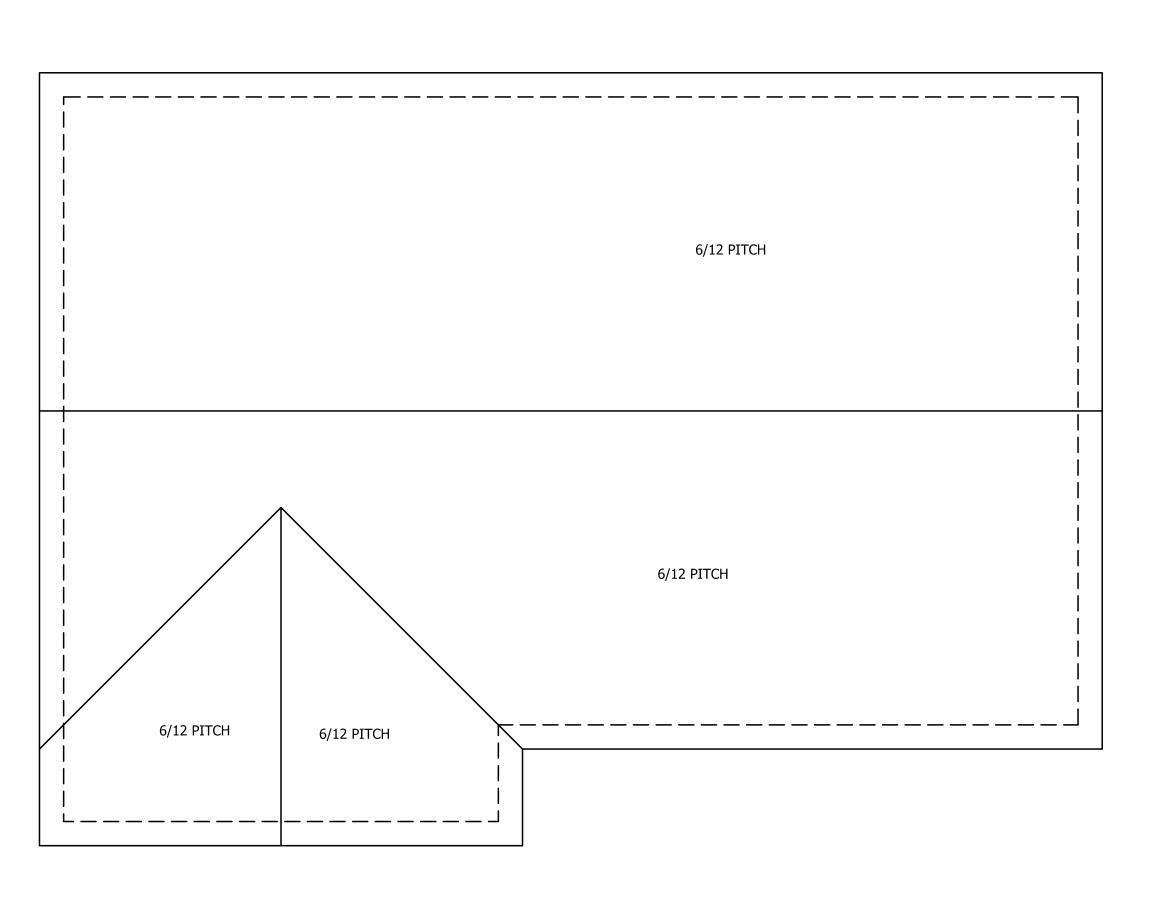

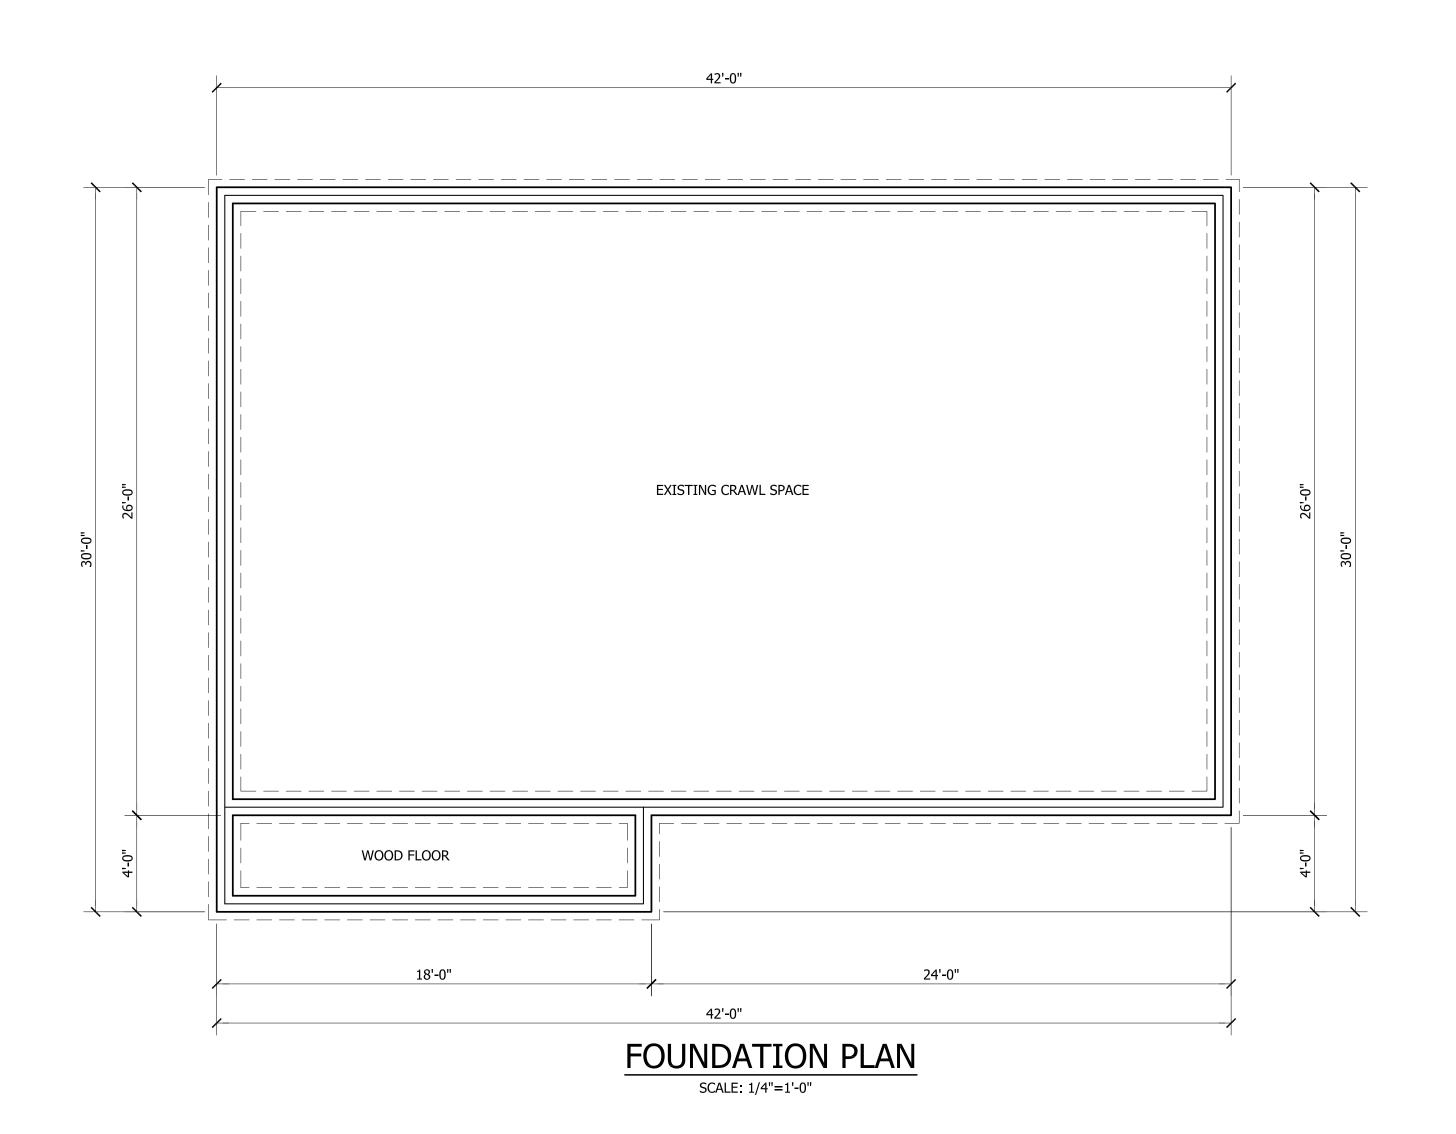

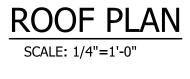

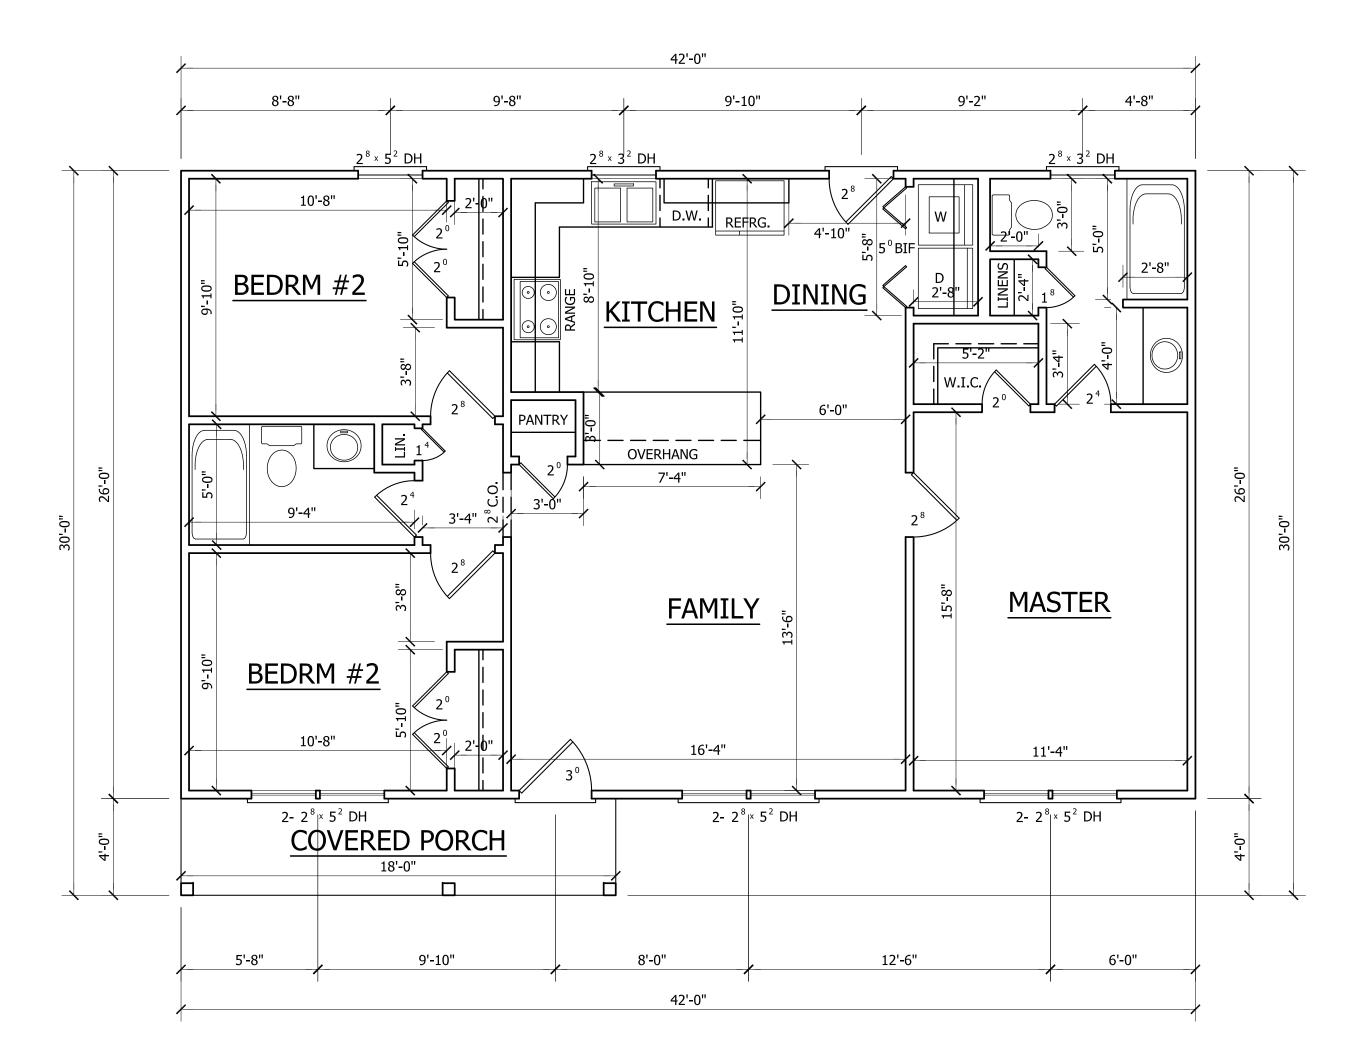


HEATED
FIRST FLOOR HTD. SQ. FT. = 1092
UNHEATED
FRONT PORCH SQ. FT. = 72


FIRST FLOOR PLAN

SCALE: 1/4"=1'-0" 8'-0" CLG. HGT. SET WINDOWS AT 6'-8" A.F.F.

PAUL DAVIS 136 OLD STAGE CT.

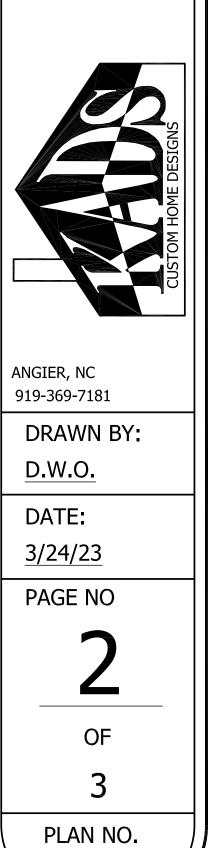

DK1092

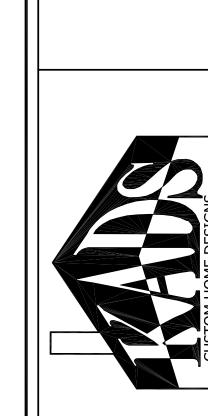

FIRESTOPPING:

handrail height and below the required headroom height.

on either side of the stairway and the minimum clear width

of the stairway at and below the handrail height, including

treads and landings, shall not be less than 31-1/2 inches where

Stairways shall not be less than 36 inches

in clear width at all points above the permitted

Handrails shall not project more than 4.5 inches

a handrail is installed on one side and 27 inches

where handrails are provided on both sides

STAIR DETAIL

ANGIER, NC 919-369-7181


> DRAWN BY: D.W.O.

DATE: 3/24/23

PAGE NO

OF

PLAN NO. DK1092

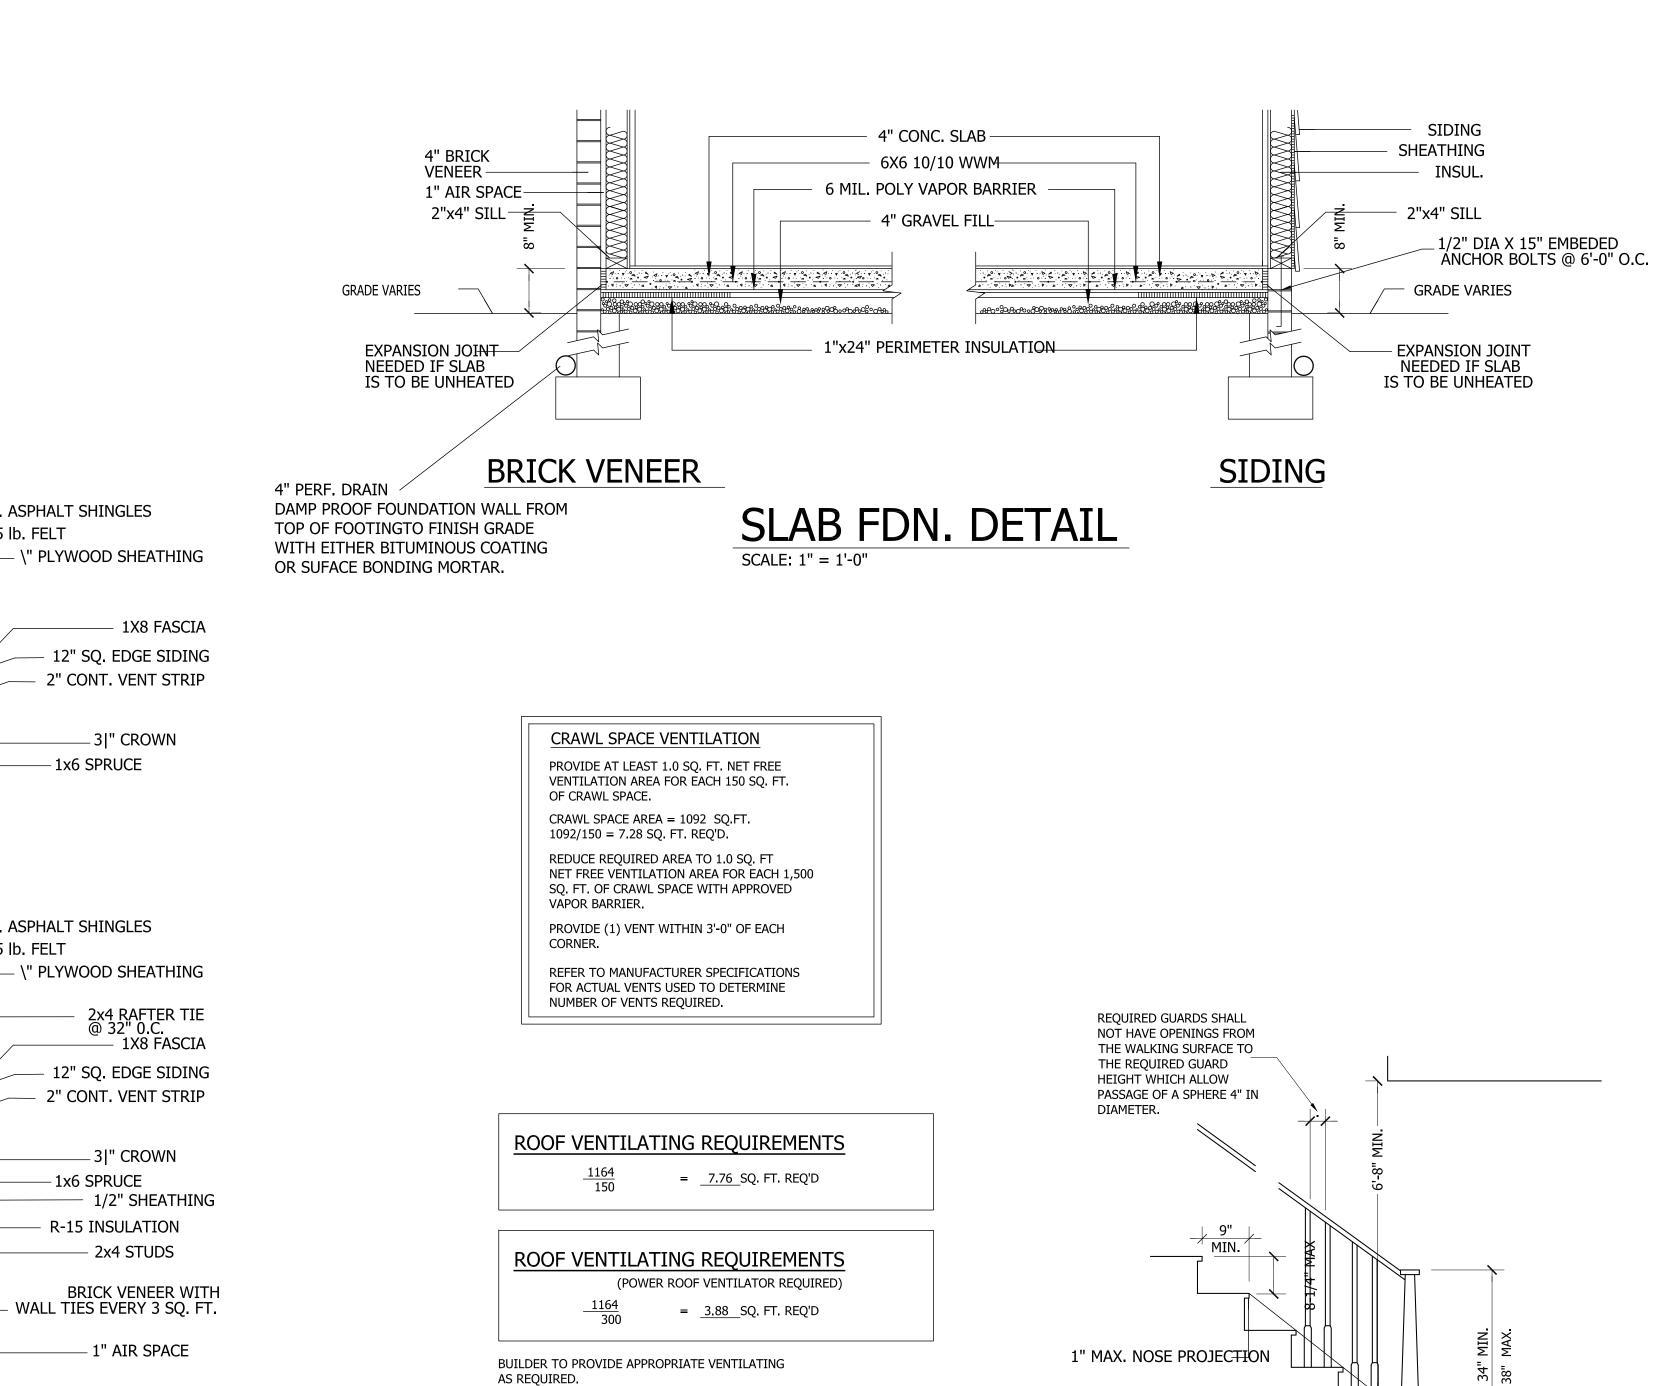

240 lb. ASPHALT SHINGLES

1x6 SPRUCE

- 1x6 SPRUCE

- COMPOSITE WALL INSULATION R-16

240 lb. ASPHALT SHINGLES

— 15 lb. FELT

- SUBFLOOR

- FINISH FLOOR

- 2 X BAND

WEEP HOLES 48" O.C.

— 30# FELT OR FLASHING UP 6" BEHIND SHEATHING

1/2" DIA X 15" EMBEDED ANCHOR BOLTS @ 6'-0" O.C.

4" PERF. DRAIN

DAMP PROOF FOUNDATION WALL FROM

TOP OF FOOTINGTO FINISH GRADE

OR SUFACE BONDING MORTAR.

WITH EITHER BITUMINOUS COATING

— 15 lb. FELT

R-30 INSULATION

1x4 PINE

1x10 SPRUCE

1x10 SPRUCE

ROOF TRUSS PER MANUFACTURER

(SEE TRUSS DESIGN PACKAGE)

—2X4 COLLAR BEAM @ 48" O.C.

R-30 INSULATION -

CLG. JOIST

FL. JOIST

FL. JOIST

1ST FLOOR HVAC IN CRAWL SPACE

(MIN. 22" CLEARANCE)

BRICK SECTION

TREATED SILL

CORBEL BRICK

8" SOLID CAP

- CONC. BLOCK

AS SHOWN BELOW

OPTIONAL ROOF TRUSS DETAIL

1/2" GYPSUM BOARD

COMPOSITE **FLOOR** INSULATION R-20 —

R-19 INSULATIQN

- GIRDER

TYP. FOR INTERIOR WALLS

2ND FLOOR HVAC IN ATTIC

CLG. JOIST

-1x10 SPRUCE


FL. JOIST

FL. JOIST


3" MIN. PROJECTION MAX. - THICKNESS OF

FOOTING

SIDING SECTION

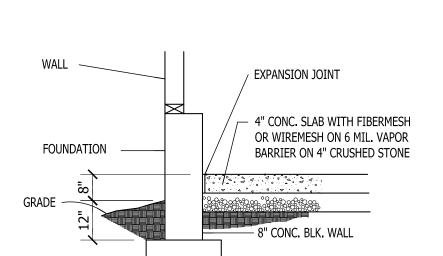

GARAGE SLAB

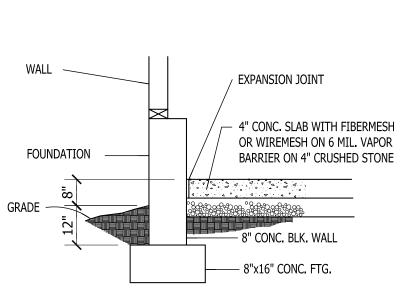



TREATED SILL

- 8" SOLID CAP FOR 2 STORY

4" SOLID CAP FOR 1 STORY

240 lb. ASPHALT SHINGLES

240 lb. ASPHALT SHINGLES

\" PLYWOOD SHEATHING_

15 lb. FELT

\" PLYWOOD SHEATHING_

1x8 FASCIA

3|" CROWN

2x4 RAFTER TIE @ 32" O.C. 1x8 FASCIA ——

3|" CROWN

SIDING-

1/2" SHEATHING-

2x4 STUDS -

SUBFLOOR -

2 X BAND

FINISH FLOOR

FINISH GRADE -

1/2" DIA X 15" EMBEDED ANCHOR BOLTS @ 6'-0" O.C.

12" SQ. EDGE SIDING -

2" CONT. VENT STRIP

12" SQ. EDGE SIDING

2" CONT. VENT STRIP

15 lb. FELT

-1x10 SPRUCE