FIRST FLOOR PLAN
SCALE: 1/4" = 1'-0"

AREAS:

FIRST FLOOR = 1799 SF
BONUS = 338 SF

GARAGE = 564 SF
FRONT PORCH = 206 SF
LANAI = 254 SF
TOTAL COVERED AREA = 3161 SF

WALL TYPES2x4'S @ 16" 0.C.

2x4'S @ 16" O.C. W/ 3 1/2" BATT INSUL.

2x6'S @ 16" O.C. W/

5 1/2" BATT INSUL.

2X4'S @ 16" O.C. W/
5/8" GYP. BD. EACH SIDE

2x6'S @ 16" O.C.-BALLOON FRAME

2x6'S @ 16" O.C. W/ BRICK VENEER

NOTE
HDS DESIGN & DRAFTING SERVICES LLC. IS NOT A LICENSED P.E.
THEREFORE IT IS RECOMMENDED THAT ANY/ALL STRUCTURAL PLANS
INCLUDING FOUNDATION/FRAMING BE REVIEWED/DESIGNED BY
A LICENSED STRUCTURAL P.E. PREFERABLY ONE IN LOCATION OF BUILD

THIS PLAN HAS BEEN MODIFIED FROM ITS ORIGINAL STATUS.

HDS DESIGN &DRAFTING SERVICES LLC. ASSUMES NO LIABILITY
FOR ANY HOME CONSTRUCTED FROM THIS MODIFIED PLAN.

IT IS THE RESPONSIBILITY OF THE PURCHASER/BUILDER
OF THIS PLAN TO PERFORM THE FOLLOWING BEFORE BEGINNING
ACTUAL CONSTRUCTION.

1. BUILDER OR CONTRACTOR MUST VERIFY ALL DIMENSIONS
PRIOR TO PROCEEDING WITH CONSTRUCTION.
2. CONTRACTOR MUST VERIFY COMPLIANCE WITH ALL
LOCAL BUILDING CODES IN THE AREA WHERE THE HOME IS
TO BE CONSTRUCTED.
3. PLANS INDICATE LOCATION ONLY; ENGINEERING
ASPECTS SHOULD INCORPORATE ACTUAL SITE CONDITIONS
BY A LICENSED STRUCTURAL ENGINEER AS REQUIRED.

THIS DRAWING HAS BEEN REVISED
ON THE DATE OF 03/01/2023
FROM IT'S ORIGINAL STATUS BY:
HDS Design & Drafting Service
Herbert D Shearer

Herbert D Shearer

1 HWY 25 N.

Greenbrier Arkansas 72058

501-932-6200 Office #

L'ATTESA DI VITA

DO NOT REPRODUCE

MGGINS

I T E C T

للاً =

DIECT:

REVISIONS:

MAY 25, 2021

A1 OF E1

SECOND FLOOR PLAN
SCALE: 1/4" = 1'-0"

NOTE
HDS DESIGN & DRAFTING SERVICES LLC. IS NOT A LICENSED P.E.
THEREFORE IT IS RECOMMENDED THAT ANY/ALL STRUCTURAL PLANS
INCLUDING FOUNDATION/FRAMING BE REVIEWED/DESIGNED BY
A LICENSED STRUCTURAL P.E. PREFERABLY ONE IN LOCATION OF BUILD

THIS PLAN HAS BEEN MODIFIED FROM ITS ORIGINAL STATUS.

HDS DESIGN &DRAFTING SERVICES LLC. ASSUMES NO LIABILITY
FOR ANY HOME CONSTRUCTED FROM THIS MODIFIED PLAN.

IT IS THE RESPONSIBILITY OF THE PURCHASER/BUILDER
OF THIS PLAN TO PERFORM THE FOLLOWING BEFORE BEGINNING
ACTUAL CONSTRUCTION.

1. BUILDER OR CONTRACTOR MUST VERIFY ALL DIMENSIONS
PRIOR TO PROCEEDING WITH CONSTRUCTION.

2. CONTRACTOR MUST VERIFY COMPLIANCE WITH ALL
LOCAL BUILDING CODES IN THE AREA WHERE THE HOME IS
TO BE CONSTRUCTED.

3. PLANS INDICATE LOCATION ONLY; ENGINEERING
ASPECTS SHOULD INCORPORATE ACTUAL SITE CONDITIONS
BY A LICENSED STRUCTURAL ENGINEER AS REQUIRED.

THIS DRAWING HAS BEEN REVISED ON THE DATE OF 03/01/2023

FROM IT'S ORIGINAL STATUS BY:

HDS Design & Drafting Service Herbert D Shearer 1 HWY 25 N. Greenbrier Arkansas 72058 501-932-6200 Office #

DAVIDE, WIGGINS

A R C H I T E C T

REVISIONS:



NOTE
HDS DESIGN & DRAFTING SERVICES LLC. IS NOT A LICENSED P.E.
THEREFORE IT IS RECOMMENDED THAT ANY/ALL STRUCTURAL PLANS
INCLUDING FOUNDATION/FRAMING BE REVIEWED/DESIGNED BY
A LICENSED STRUCTURAL P.E. PREFERABLY ONE IN LOCATION OF BUILD

THIS PLAN HAS BEEN MODIFIED FROM ITS ORIGINAL STATUS.

HDS DESIGN &DRAFTING SERVICES LLC. ASSUMES NO LIABILITY
FOR ANY HOME CONSTRUCTED FROM THIS MODIFIED PLAN.

IT IS THE RESPONSIBILITY OF THE PURCHASER/BUILDER
OF THIS PLAN TO PERFORM THE FOLLOWING BEFORE BEGINNING
ACTUAL CONSTRUCTION.

1. BUILDER OR CONTRACTOR MUST VERIFY ALL DIMENSIONS
PRIOR TO PROCEEDING WITH CONSTRUCTION.

2. CONTRACTOR MUST VERIFY COMPLIANCE WITH ALL
LOCAL BUILDING CODES IN THE AREA WHERE THE HOME IS
TO BE CONSTRUCTED.

3. PLANS INDICATE LOCATION ONLY; ENGINEERING
ASPECTS SHOULD INCORPORATE ACTUAL SITE CONDITIONS
BY A LICENSED STRUCTURAL ENGINEER AS REQUIRED.

THIS DRAWING HAS BEEN REVISED ON THE DATE OF 03/01/2023 FROM IT'S ORIGINAL STATUS BY: HDS Design & Drafting Service Herbert D Shearer 1 HWY 25 N.

Greenbrier Arkansas 72058 501-932-6200 Office #

LEFT ELEVATION SCALE: 1/4" = 1'-0"



DANID M R C

REVISIONS:

DATE:

RIGHT ELEVATION SCALE: 1/4" = 1'-0"




REAR ELEVATION

SCALE: 1/4" = 1'-0"



REVISIONS:

DATE:

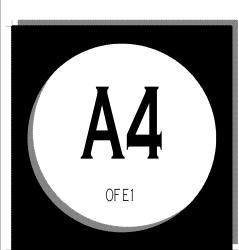

NOTE
HDS DESIGN & DRAFTING SERVICES LLC. IS NOT A LICENSED P.E.
THEREFORE IT IS RECOMMENDED THAT ANY/ALL STRUCTURAL PLANS
INCLUDING FOUNDATION/FRAMING BE REVIEWED/DESIGNED BY
A LICENSED STRUCTURAL P.E. PREFERABLY ONE IN LOCATION OF BUILD

THIS PLAN HAS BEEN MODIFIED FROM ITS ORIGINAL STATUS.

HDS DESIGN &DRAFTING SERVICES LLC. ASSUMES NO LIABILITY
FOR ANY HOME CONSTRUCTED FROM THIS MODIFIED PLAN.

IT IS THE RESPONSIBILITY OF THE PURCHASER/BUILDER
OF THIS PLAN TO PERFORM THE FOLLOWING BEFORE BEGINNING
ACTUAL CONSTRUCTION. ACTUAL CONSTRUCTION.


1. BUILDER OR CONTRACTOR MUST VERIFY ALL DIMENSIONS PRIOR TO PROCEEDING WITH CONSTRUCTION.

2. CONTRACTOR MUST VERIFY COMPLIANCE WITH ALL LOCAL BUILDING CODES IN THE AREA WHERE THE HOME IS TO BE CONSTRUCTED.


3. PLANS INDICATE LOCATION ONLY; ENGINEERING ASPECTS SHOULD INCORPORATE ACTUAL SITE CONDITIONS BY A LICENSED STRUCTURAL ENGINEER AS REQUIRED.

THIS DRAWING HAS BEEN REVISED ON THE DATE OF 03/01/2023 FROM IT'S ORIGINAL STATUS BY:

HDS Design & Drafting Service Herbert D Shearer 1 HWY 25 N. Greenbrier Arkansas 72058 501-932-6200 Office #

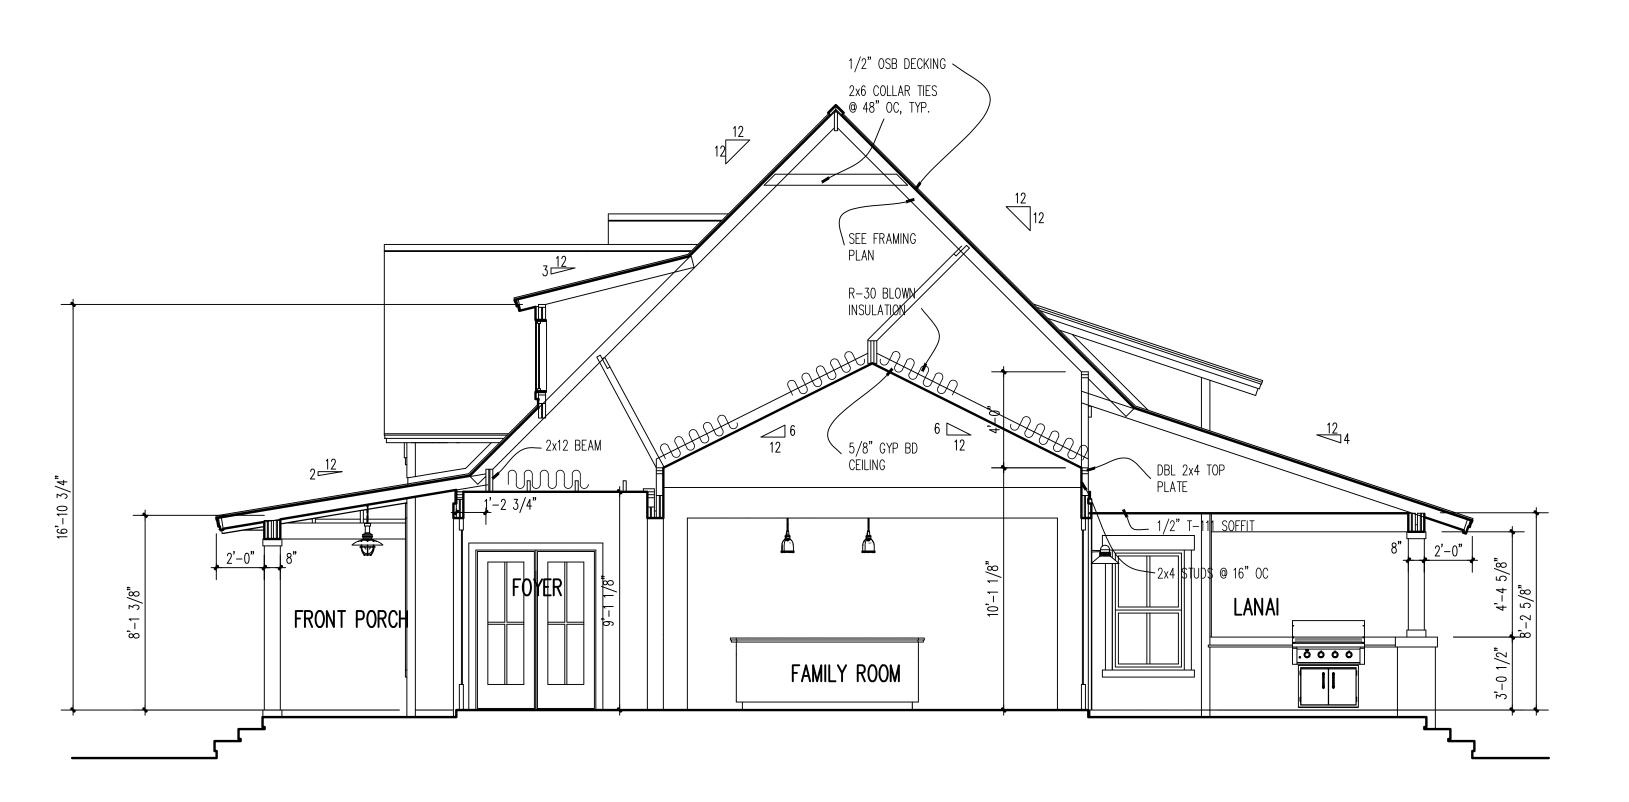


BUILDING SECTION A-A

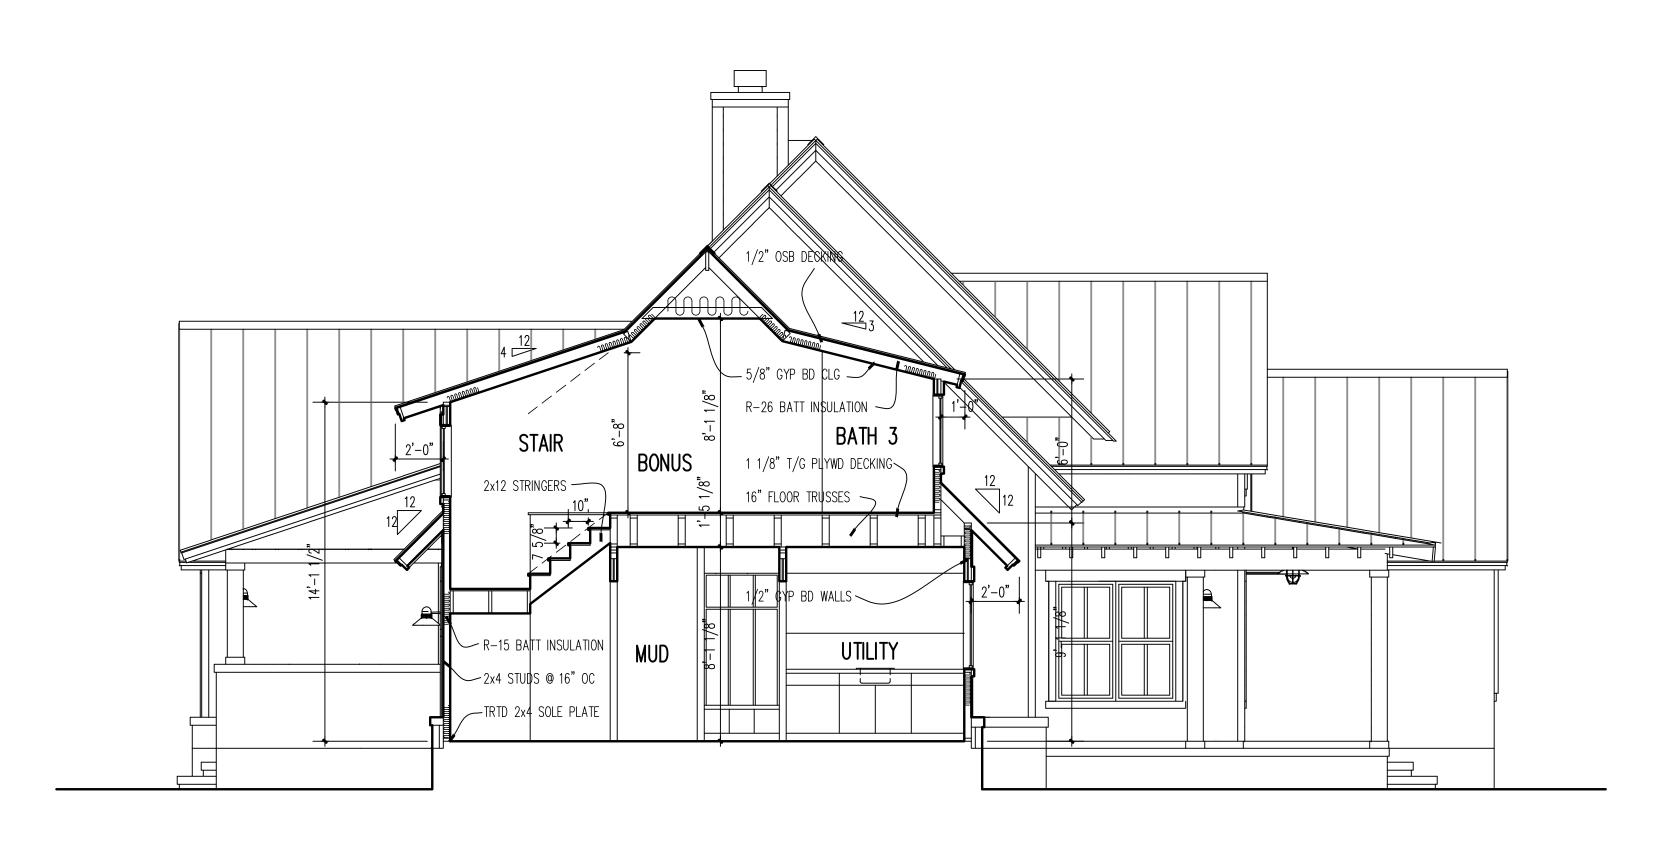

BUILDING SECTION B-B
SCALE: 1/4" = 1'-0"



DATE:

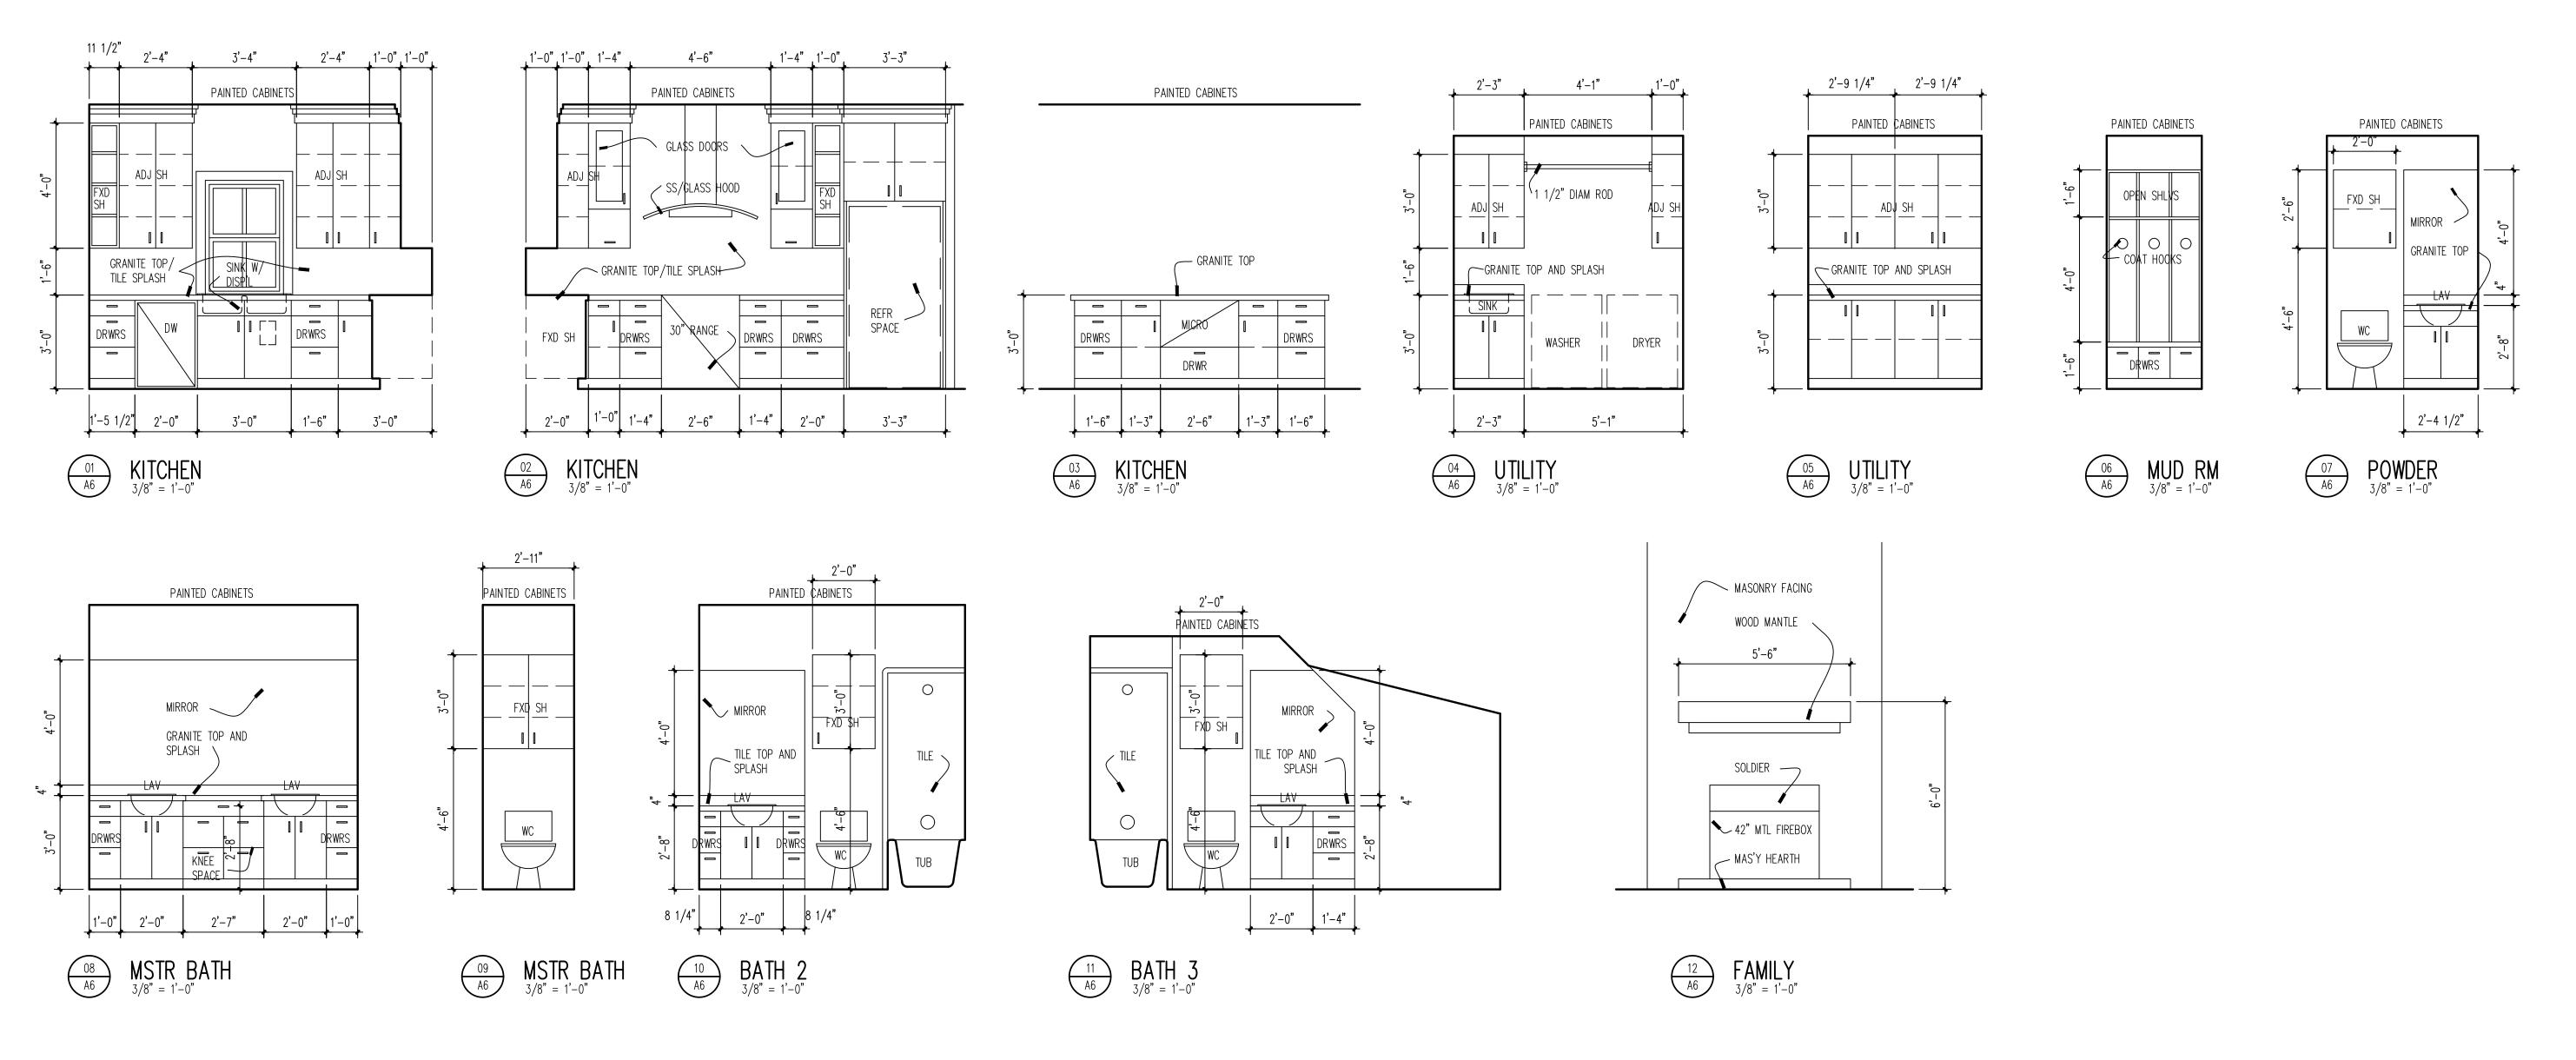

NOTE
HDS DESIGN & DRAFTING SERVICES LLC. IS NOT A LICENSED P.E.
THEREFORE IT IS RECOMMENDED THAT ANY/ALL STRUCTURAL PLANS
INCLUDING FOUNDATION/FRAMING BE REVIEWED/DESIGNED BY
A LICENSED STRUCTURAL P.E. PREFERABLY ONE IN LOCATION OF BUILD


THIS PLAN HAS BEEN MODIFIED FROM ITS ORIGINAL STATUS.
HDS DESIGN &DRAFTING SERVICES LLC. ASSUMES NO LIABILITY
FOR ANY HOME CONSTRUCTED FROM THIS MODIFIED PLAN.
IT IS THE RESPONSIBILITY OF THE PURCHASER/BUILDER
OF THIS PLAN TO PERFORM THE FOLLOWING BEFORE BEGINNING
ACTUAL CONSTRUCTION.

1. BUILDER OR CONTRACTOR MUST VERIFY ALL DIMENSIONS
PRIOR TO PROCEEDING WITH CONSTRUCTION.
2. CONTRACTOR MUST VERIFY COMPLIANCE WITH ALL
LOCAL BUILDING CODES IN THE AREA WHERE THE HOME IS
TO BE CONSTRUCTED.
3. PLANS INDICATE LOCATION ONLY; ENGINEERING
ASPECTS SHOULD INCORPORATE ACTUAL SITE CONDITIONS
BY A LICENSED STRUCTURAL ENGINEER AS REQUIRED.

THIS DRAWING HAS BEEN REVISED ON THE DATE OF 03/01/2023 FROM IT'S ORIGINAL STATUS BY:

HDS Design & Drafting Service Herbert D Shearer 1 HWY 25 N. Greenbrier Arkansas 72058 501-932-6200 Office #

CABINET ELEVATIONS SCALE: 1/4" = 1'-0"

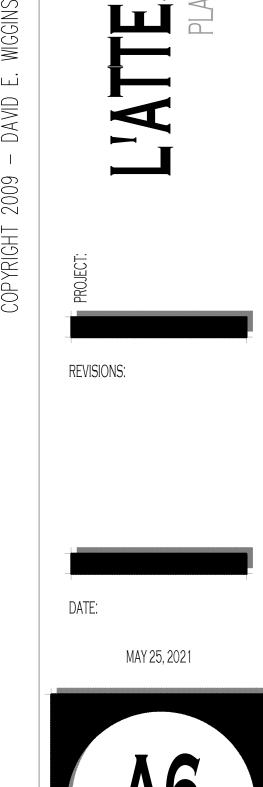

M

SAN NO.

MGGINS

DAWIDE.

FIRST FLOOR:

OPNG. SIZE 2'-3'

SECOND FLOOR

OPNG. SIZE 2'-3'


6'-UP

4'-UP

REVISIONS:

DATE:


MAY 25, 2021

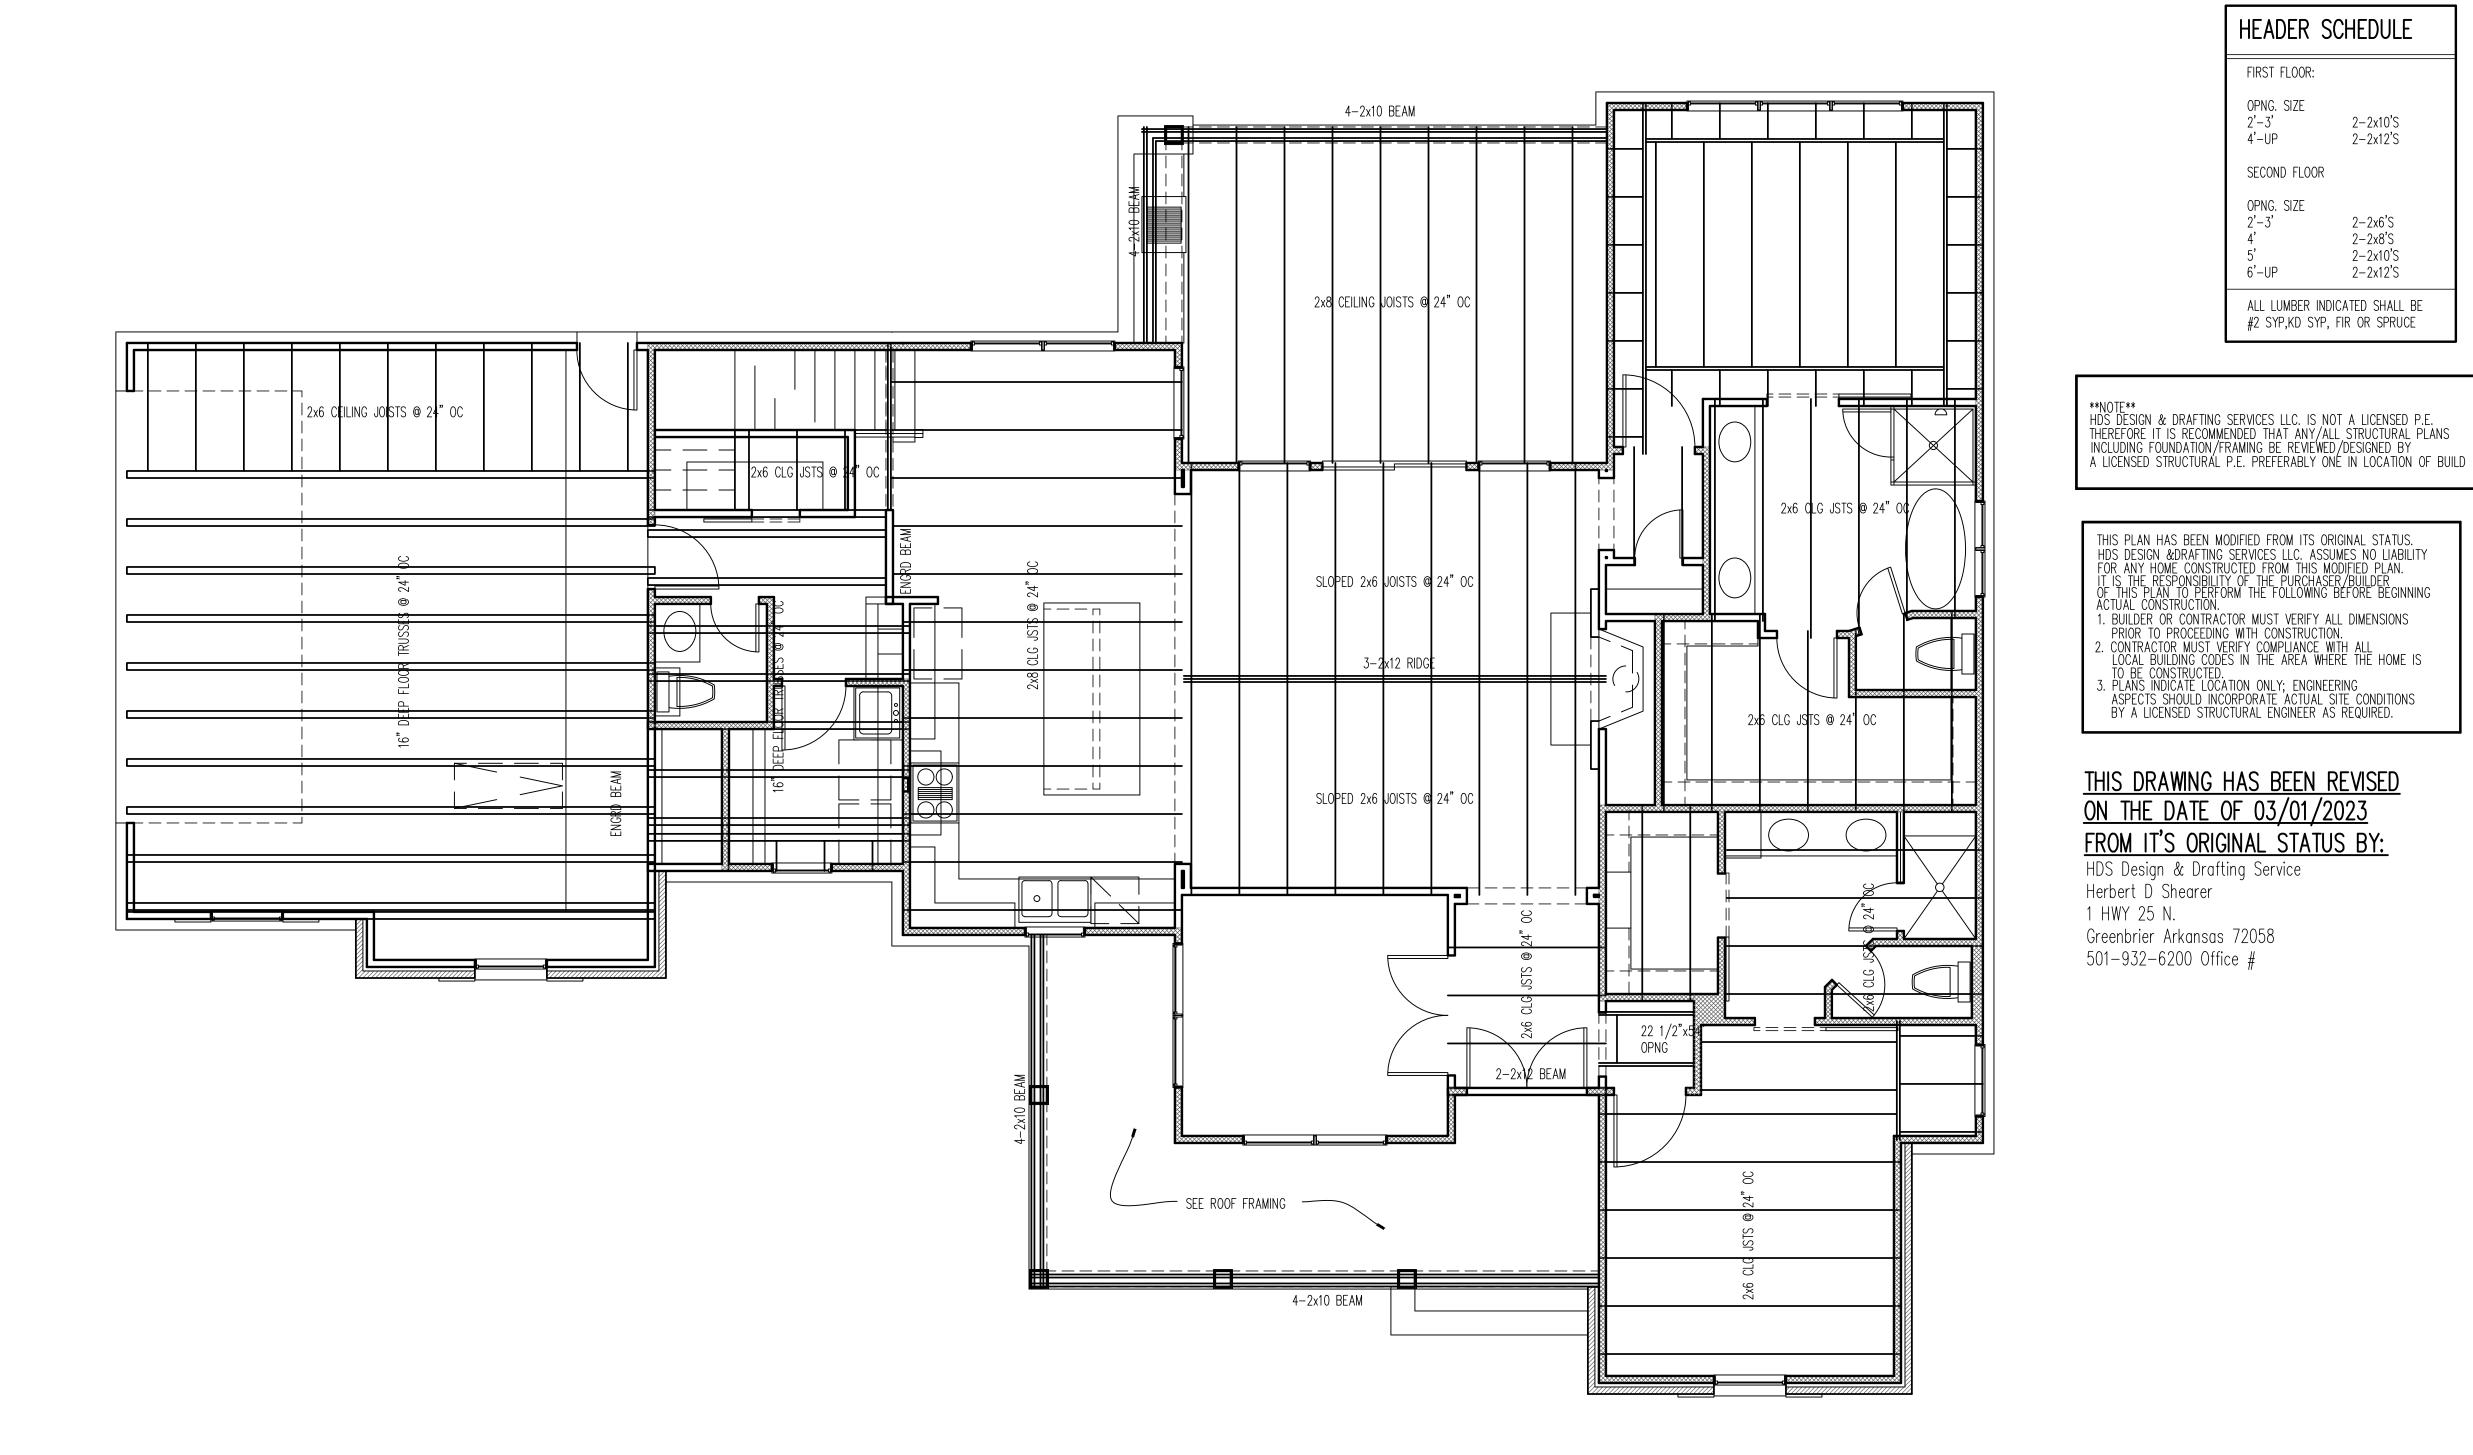


SECOND FLOOR FRAMING PLAN
SCALE: 1/4" = 1'-0"

DATE:

MAY 25, 2021

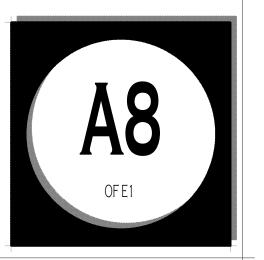

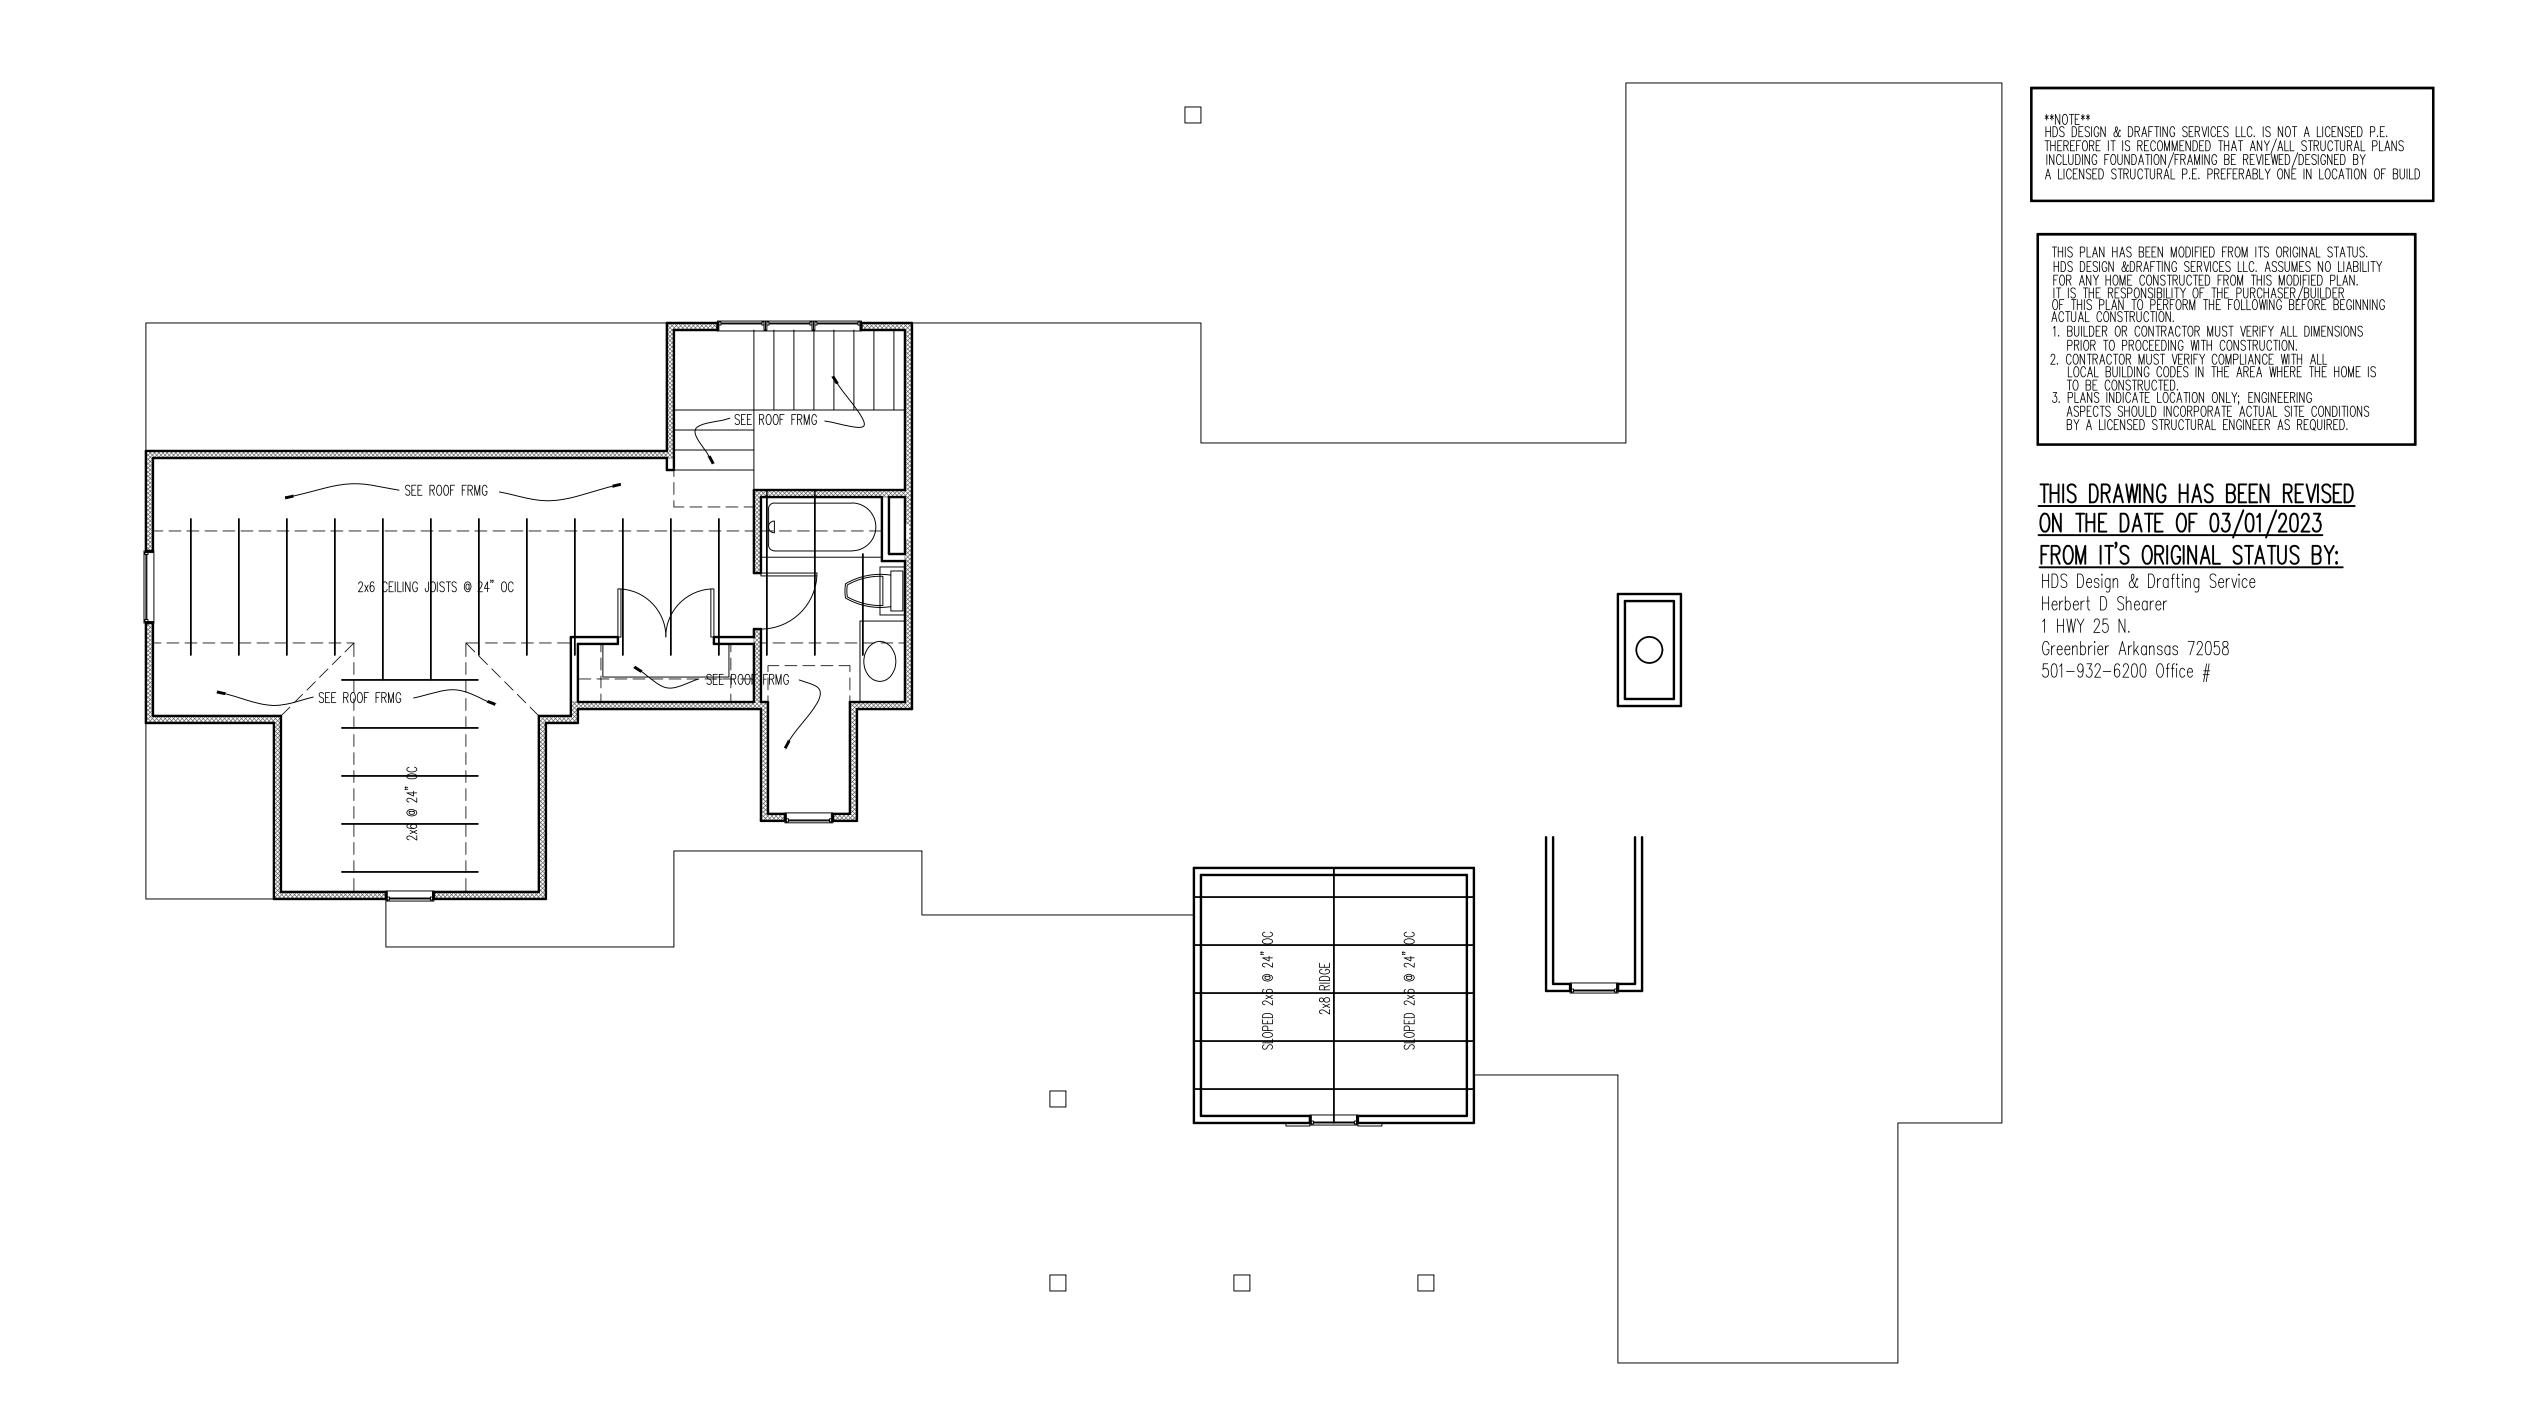

CEILING FRAMING PLAN

FRAMING NOTES:

1. ALL MEMBERS SHALL BE NO. 2 GRADE SYP OR SFP LUMBER.

2. ALL FASCIAS ARE 2x8 GROOVED SPF OR BETTER.

3. ALL RAFTERS ARE 2x6 @ 24" O.C..

4. BRACE ALL INTERSECTIONS OF RIDGE, HIP, OR VALLEYS DOWN TO LOAD BEARING

5. ALL TRUSSES SHALL BE DESIGNED BY A LOCAL ENGINEER, PREFERABLY A TRUSS MANUFACTURER.

NOTE
HDS DESIGN & DRAFTING SERVICES LLC. IS NOT A LICENSED P.E.
THEREFORE IT IS RECOMMENDED THAT ANY/ALL STRUCTURAL PLANS
INCLUDING FOUNDATION/FRAMING BE REVIEWED/DESIGNED BY
A LICENSED STRUCTURAL P.E. PREFERABLY ONE IN LOCATION OF BUILD

THIS PLAN HAS BEEN MODIFIED FROM ITS ORIGINAL STATUS.

HDS DESIGN &DRAFTING SERVICES LLC. ASSUMES NO LIABILITY
FOR ANY HOME CONSTRUCTED FROM THIS MODIFIED PLAN.

IT IS THE RESPONSIBILITY OF THE PURCHASER/BUILDER
OF THIS PLAN TO PERFORM THE FOLLOWING BEFORE BEGINNING
ACTUAL CONSTRUCTION.

1. BUILDER OR CONTRACTOR MUST VERIFY ALL DIMENSIONS
PRIOR TO PROCEEDING WITH CONSTRUCTION.

2. CONTRACTOR MUST VERIFY COMPLIANCE WITH ALL
LOCAL BUILDING CODES IN THE AREA WHERE THE HOME IS
TO BE CONSTRUCTED.

3. PLANS INDICATE LOCATION ONLY; ENGINEERING
ASPECTS SHOULD INCORPORATE ACTUAL SITE CONDITIONS
BY A LICENSED STRUCTURAL ENGINEER AS REQUIRED.

THIS DRAWING HAS BEEN REVISED ON THE DATE OF 03/01/2023 FROM IT'S ORIGINAL STATUS BY:


HDS Design & Drafting Service Herbert D Shearer 1 HWY 25 N. Greenbrier Arkansas 72058 501-932-6200 Office #

MGGINS


DATE:



ROOF FRAMING PLAN

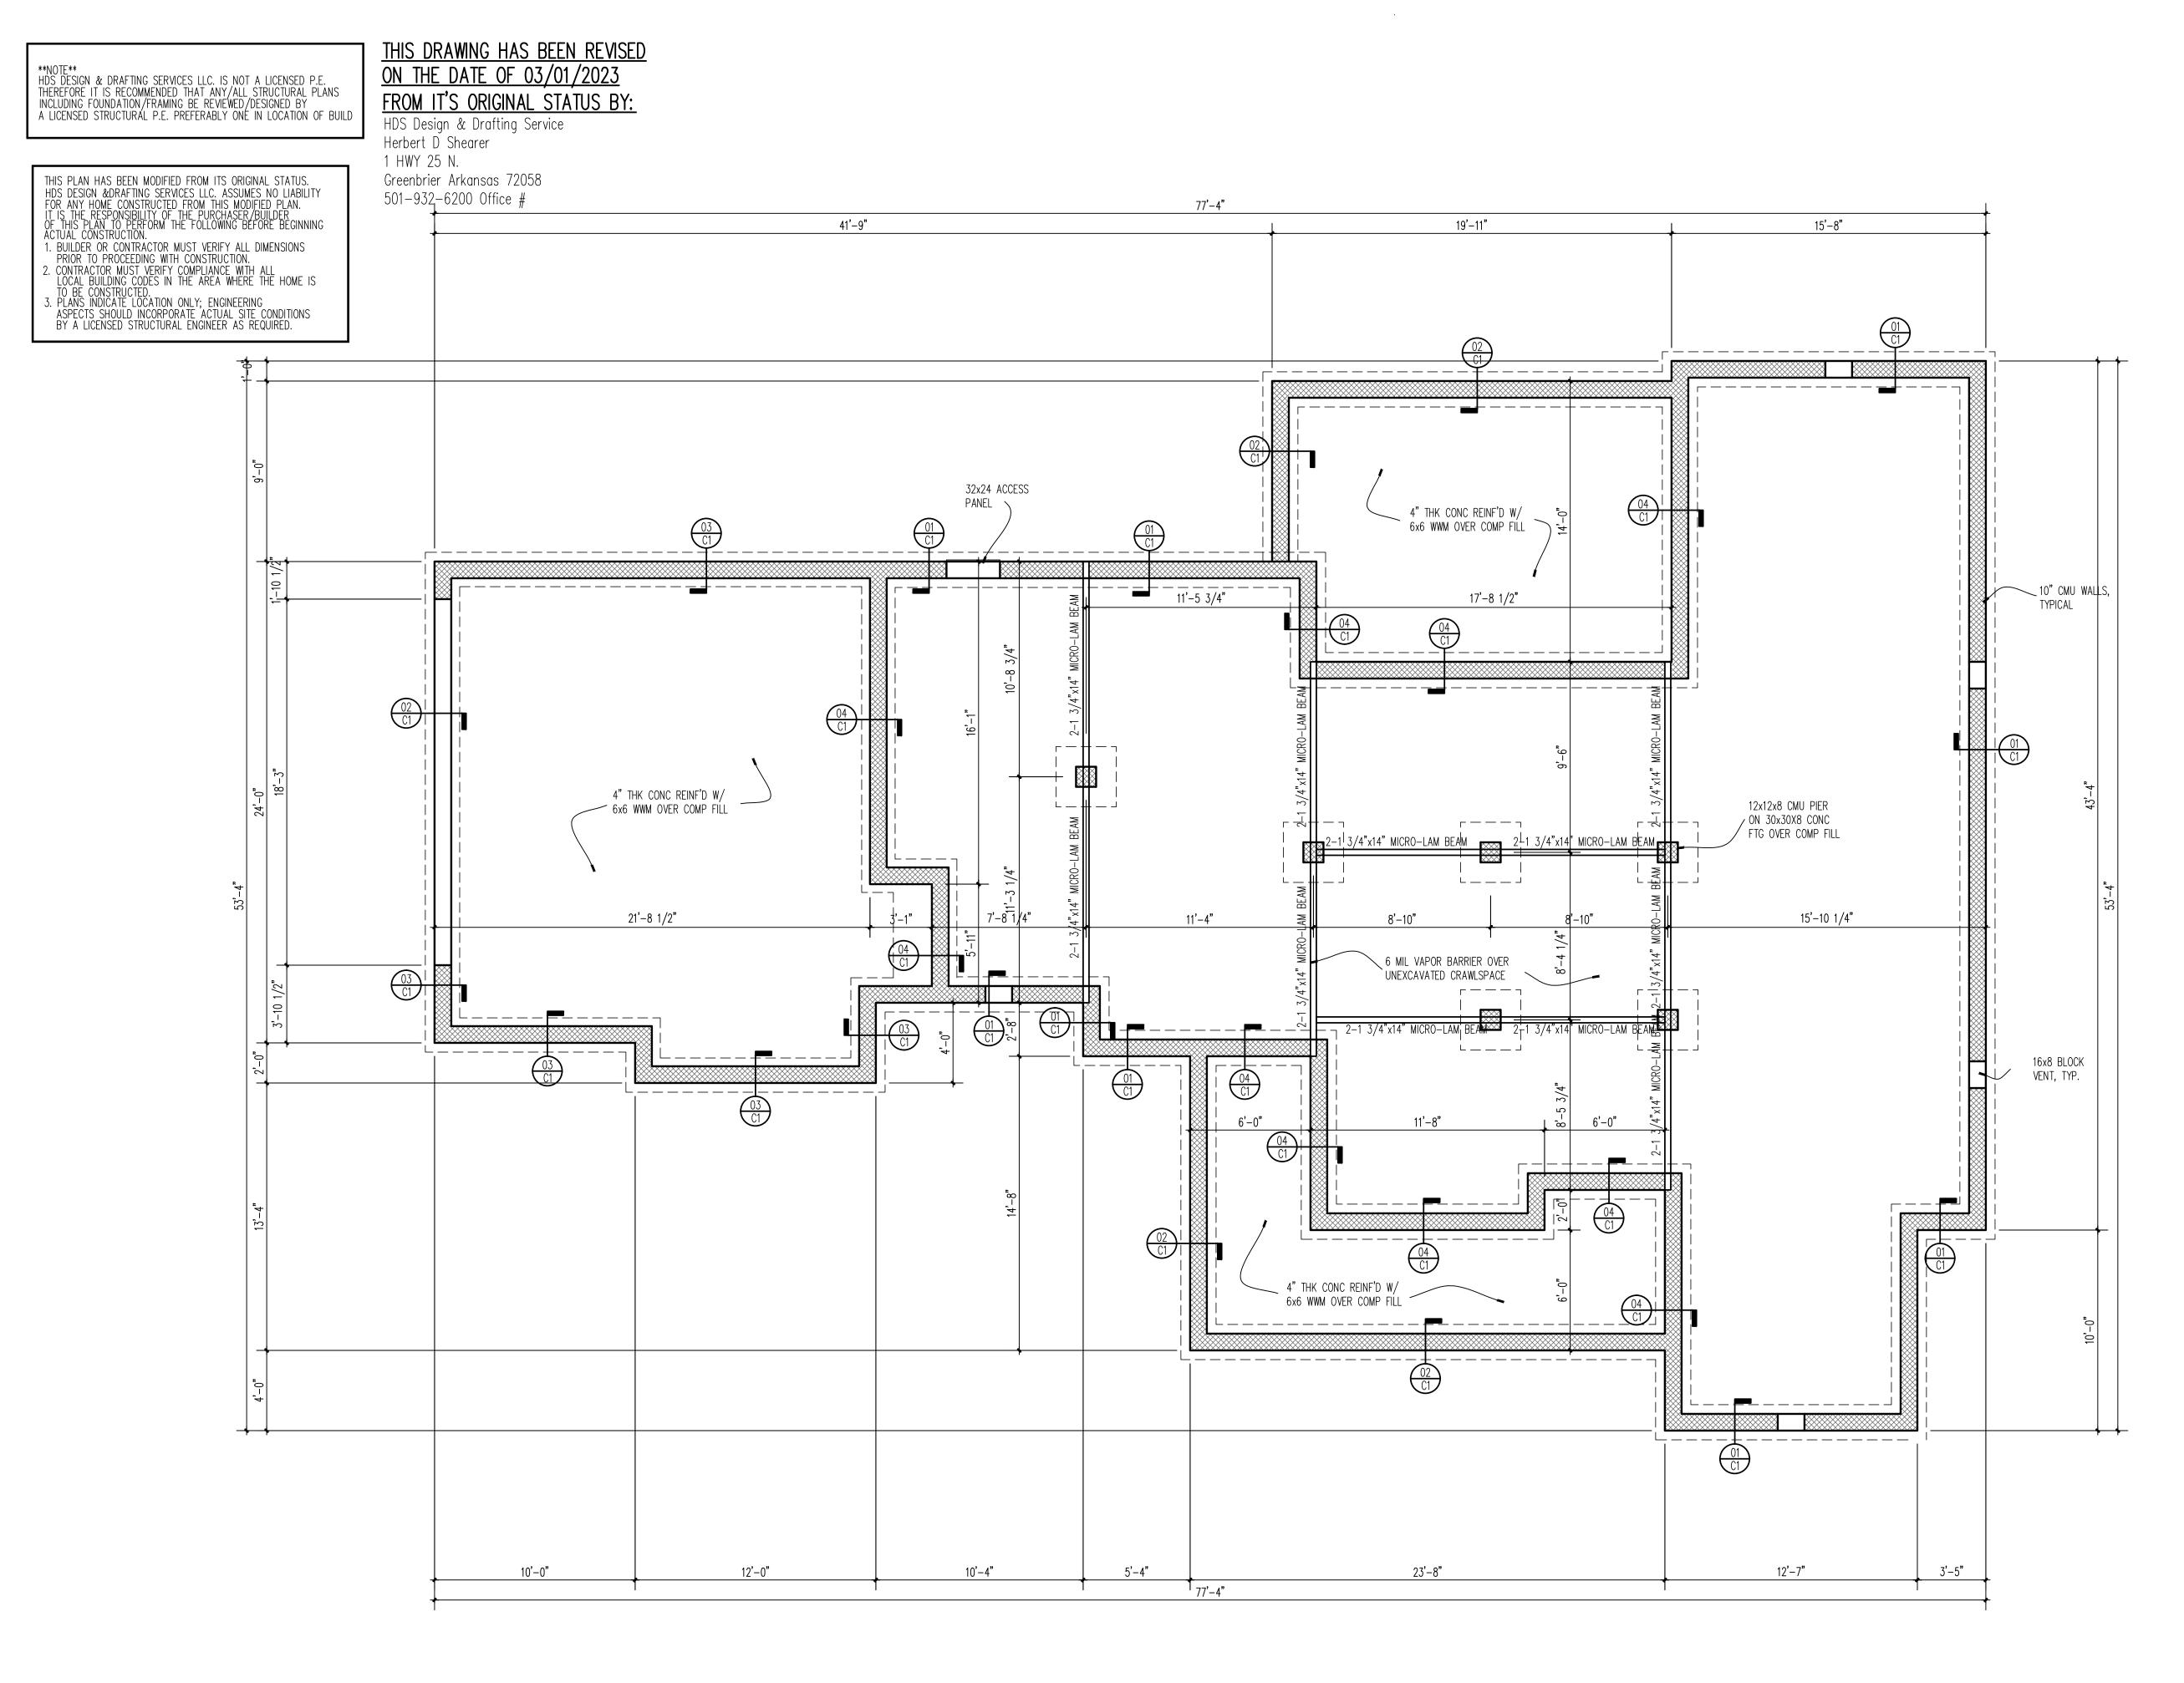





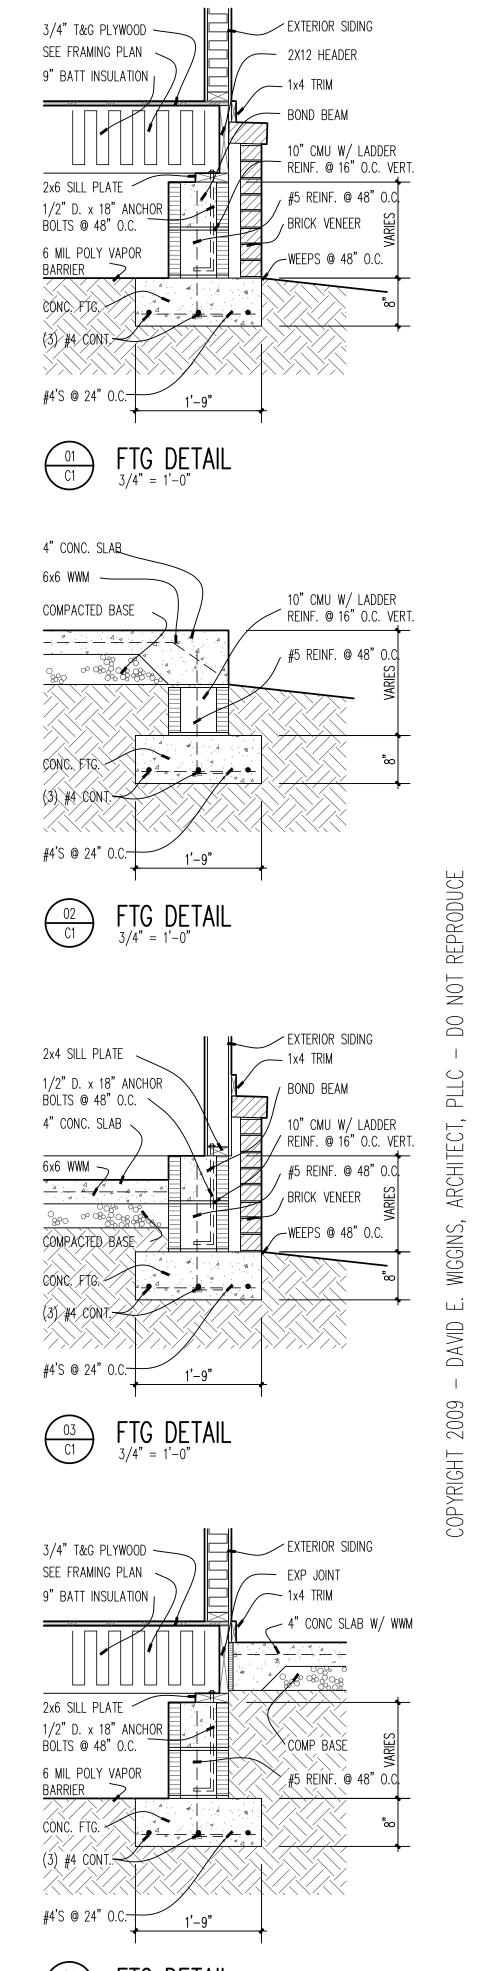

DAWID E, WIGGINS
A R C H I T E C T
A PROFESSIONAL LIMITED LIABILITY CORPORATION
2725 Highland Trail - Leander, Texas - 78641
(512) 260-2750

ATTESA DI VITA

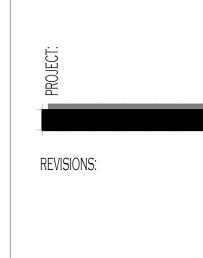

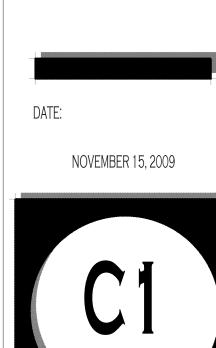

FLOOR FRAMING PLAN

OF #5'S @ 48" O.C. IN FULLY GROUTED CELLS. 5. PROVIDE 3-#5'S CONT. @ BOT. OF ALL CONT. CONC. FOOTINGS.

6. PROVIDE 3-#5'S EA. WAY @ BOT. OF SPOT CONC. FTGS.

1. ALL FRAMING MEMBERS SHALL BE #2 SYP, FIR OR SPRUCE AND SHALL BE TREATED MAT'L @ ALL CRAWL

2. PROVIDE SOLID BLKG. @ MID—SPAN OR @ 8'—6" O.C. MAX. SPACING.

3. CONTRACTOR SHALL VERIFY ALL BEAM SIZES WITH ENGINEER.


4. PROVIDE REINF. @ CMU WALLS

NOTES:

SPACE AREAS.

NOVEMBER 15, 2009



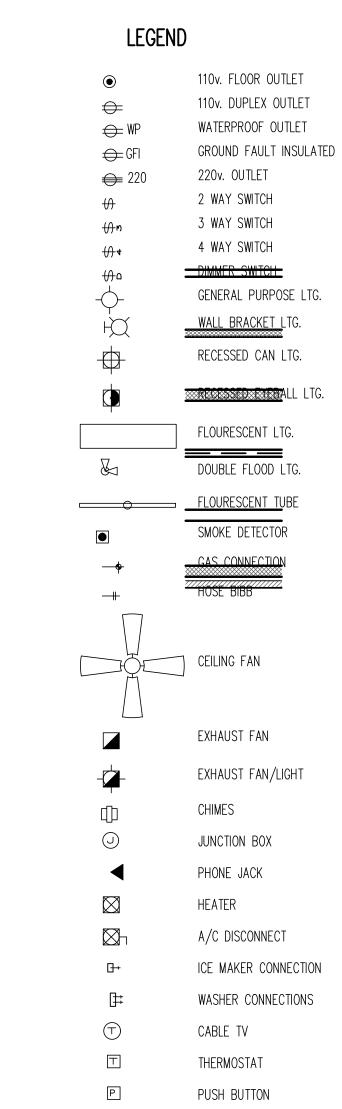

MINI RECESSED CAN LTG.

SNISSIM I

REVISIONS:

DATE:

MAY 25, 2021

FIRST FLOOR ELECTRICAL PLAN


ON THE DATE OF 03/01/2023

HDS Design & Drafting Service Herbert D Shearer

Greenbrier Arkansas 72058 501-932-6200 Office #

1 HWY 25 N.

FROM IT'S ORIGINAL STATUS BY:

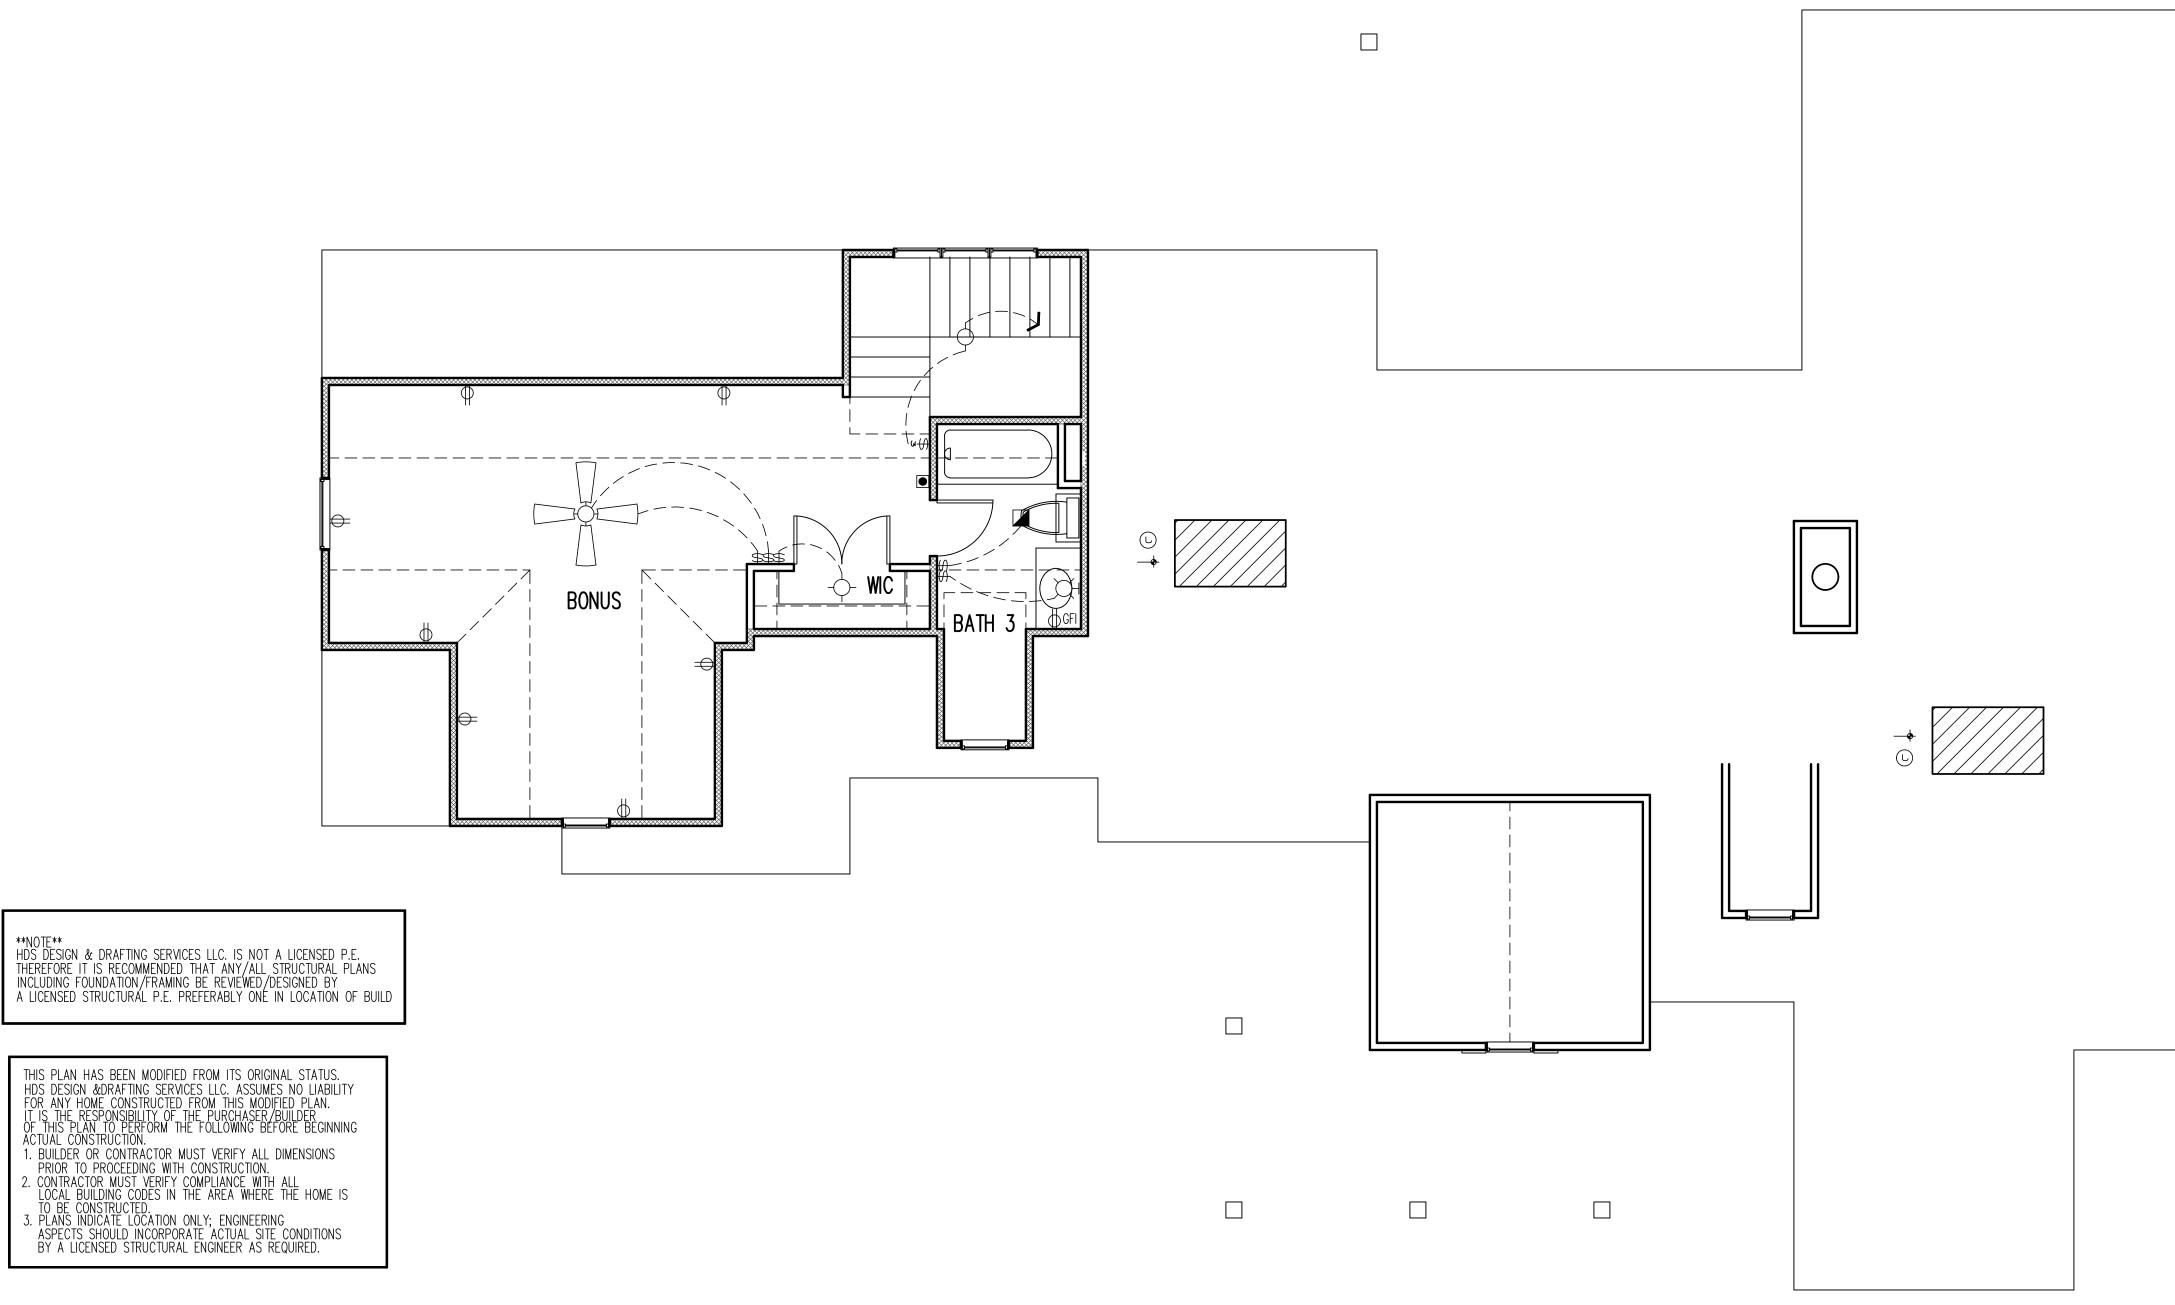

THIS DRAWING HAS BEEN REVISED ON THE DATE OF 03/01/2023

FROM IT'S ORIGINAL STATUS BY:

HDS Design & Drafting Service Herbert D Shearer 1 HWY 25 N. Greenbrier Arkansas 72058 501-932-6200 Office #

SECOND FLOOR ELECTRICAL PLAN

LEGEND

 ● ● ● ● GFI ● 220 ⊕ ⊕ ♠ ⊕ ♠ ⊕ 	110v. FLOOR OUTLET 110v. DUPLEX OUTLET WATERPROOF OUTLET GROUND FAULT INSULATED 220v. OUTLET 2 WAY SWITCH 3 WAY SWITCH 4 WAY SWITCH DIMMER SWITCH GENERAL PURPOSE LTG. WALL BRACKET LTG.
-	RECESSED CAN LTG.
	RECESSED EYEBALL LTG.
	FLOURESCENT LTG.
	DOUBLE FLOOD LTG.
	FLOURESCENT TUBE
	SMOKE DETECTOR
-	GAS CONNECTION
-#	HOSE BIBB
	CEILING FAN
	EXHAUST FAN
	EXHAUST FAN/LIGHT
Ф	CHIMES
\bigcirc	JUNCTION BOX
◀	PHONE JACK
	HEATER
\boxtimes_{\exists}	A/C DISCONNECT
G+	ICE MAKER CONNECTION
₽	WASHER CONNECTIONS
\bigcirc	CABLE TV

MINI RECESSED CAN LTG.



REVISIONS:

DATE:



THIS DRAWING HAS BEEN REVISED ON THE DATE OF 03/01/2023 HDS DESIGN & DRAFTING SERVICES LLC. IS NOT A LICENSED P.E.
THEREFORE IT IS RECOMMENDED THAT ANY/ALL STRUCTURAL PLANS
INCLUDING FOUNDATION/FRAMING BE REVIEWED/DESIGNED BY
A LICENSED STRUCTURAL P.E. PREFERABLY ONE IN LOCATION OF BUILD FROM IT'S ORIGINAL STATUS BY: HDS Design & Drafting Service Herbert D Shearer 1 HWY 25 N. THIS PLAN HAS BEEN MODIFIED FROM ITS ORIGINAL STATUS. Greenbrier Arkansas 72058 HDS DESIGN &DRAFTING SERVICES LLC. ASSUMES NO LIABILITY FOR ANY HOME CONSTRUCTED FROM THIS MODIFIED PLAN. IT IS THE RESPONSIBILITY OF THE PURCHASER/BUILDER OF THIS PLAN TO PERFORM THE FOLLOWING BEFORE BEGINNING ACTUAL CONSTRUCTION. 501-932-6200 Office # 77'-4" 41'-9" 19'-11" 15'-8" 1. BUILDER OR CONTRACTOR MUST VERIFY ALL DIMENSIONS PRIOR TO PROCEEDING WITH CONSTRUCTION. 2. CONTRACTOR MUST VERIFY COMPLIANCE WITH ALL LOCAL BUILDING CODES IN THE AREA WHERE THE HOME IS TO BE CONSTRUCTED.

3. PLANS INDICATE LOCATION ONLY; ENGINEERING ASPECTS SHOULD INCORPORATE ACTUAL SITE CONDITIONS BY A LICENSED STRUCTURAL ENGINEER AS REQUIRED. 32x24 ACCESS PANEL DOUBLE BAND OVER 4" THK CONC REINF'D W/ 6x6 WWM OVER COMP FILL -----10" CMU WALLS, (2) 2 x 10 flush (2) 2 x 10 flush 17'-8" 10'-9" Garage Slab minimum of 10'-9" 11'-4" 8'-8" 9'-0" four inch 3000 psi concrete on Six mil vapor barrier on four inch stone on undisturbed or compacted soils 21'-8" ---------(2)9 1/4 LVL -----16x8 BLOCK VENT, TYP. 8'-10" 9'-0" 4" THK CONC REINF'D W/ 6x6 WWM OVER COMP FILL Attach NEW treated band to house band NOT through siding
with 5/8" HDG Bolts at 20 inches on center
and 3-12d nails Flash as Required OR (2) 5/16" Ledgerlok @ 16 DESIGN TO IRC 2015 NCRC 2018 10'-0" 5'-4" 23'-8" 12'-7" 3'-5" 12'-0" 10'-4" ALL FLOOR JOISTS 11 7/8 BCI 5000 @ 19.2 11 7/8 LPI 20 @ 19.2
or 2 x 10 @ 16 # 2 SPF or Better Size Hollow Masonry Solid Masonry (12"x16" Up to 48" High Up to 9'-0" High 16"x16" Up to 64" High Up to 12'-0" High DESIGN TO IRC 2015 NCRC 2018 (4) 2"x10" #2 SYP -or-DENOTES 12"x16" -or- 16"x16" CMU PIER WITH 8" SOLID CAP ON 30"x30"x10" CONC. FTR. NÉW SFPA SYP Values Used FOUNDATION WALLS
ALL FOUNDATION WALLS 8" BLOCK CRAWL SPACE VENTILATION OR (2) 9 1/4 LVL OFFSET SPLICES 1908 SQ. FT. OF CRAWL / 150=12.75 SQ. FT. OF FREE PARGED -or- 4" BRICK w/ 4" BLOCK w/ 8" SOLID CAP ON 18"x10" CONTINUOUS VENT REQUIRED

NOTE:

REFER TO SECTION 409.1 (CRAWL SPACE VENTILATION)
IN THE NORTH CAROLINA STATE BUILDING CODE (IRC)

IRC 2015 NCRC 2018 REQUIRES VAPOR BARRIER OVER

 $9.58 / 0.44 = 22 - 8 \times 16 \text{ vents (64 SQ IN FREE)}$

100 PERCENT OF CRAWL AREA REDUCING VENTING

 $\frac{2875}{\text{VENT REQUIRED}}$ SQ. FT. OF FREE VENT REQUIRED

Anchor bolts required <u>ALL</u> foundation walls

provide $1/2" \times 10"$ with 7 inch embedment

6' on center and 12 inches from ends / corners

CONCRETE FOOTER

IRC 2015 NCRC 2018 REQUIRES VAPOR BARRIER

OVER 100 PERCENT OF CRAWL AREA

20" x 10" in areas of brick veneer

McRae, John

15 MARCH 2023

J A McRae

drawn by:

Structural Design By:
John Alexander McRae, PE, Inc
218 Coley Farm Road Fuquay-Varina North Carolina 27526 jampe@nc.rr.com (919) 210-5749 P O Box 1466 Apex, NC 27502 Report deficiencies immediately 2303-20 (NC C-2298)

NOTE
HDS DESIGN & DRAFTING SERVICES LLC. IS NOT A LICENSED P.E.
THEREFORE IT IS RECOMMENDED THAT ANY/ALL STRUCTURAL PLANS
INCLUDING FOUNDATION/FRAMING BE REVIEWED/DESIGNED BY
A LICENSED STRUCTURAL P.E. PREFERABLY ONE IN LOCATION OF BUILD

THIS PLAN HAS BEEN MODIFIED FROM ITS ORIGINAL STATUS.
HDS DESIGN &DRAFTING SERVICES LLC. ASSUMES NO LIABILITY
FOR ANY HOME CONSTRUCTED FROM THIS MODIFIED PLAN.
IT IS THE RESPONSIBILITY OF THE PURCHASER/BUILDER
OF THIS PLAN TO PERFORM THE FOLLOWING BEFORE BEGINNING
ACTUAL CONSTRUCTION.

ACTUAL CONSTRUCTION.

1. BUILDER OR CONTRACTOR MUST VERIFY ALL DIMENSIONS PRIOR TO PROCEEDING WITH CONSTRUCTION.

2. CONTRACTOR MUST VERIFY COMPLIANCE WITH ALL LOCAL BUILDING CODES IN THE AREA WHERE THE HOME IS TO BE CONSTRUCTED.

3. PLANS INDICATE LOCATION ONLY; ENGINEERING ASPECTS SHOULD INCORPORATE ACTUAL SITE CONDITIONS BY A LICENSED STRUCTURAL ENGINEER AS REQUIRED.

THIS DRAWING HAS BEEN REVISED

ON THE DATE OF 03/01/2023

HDS Design & Drafting Service

Greenbrier Arkansas 72058 501-932-6200 Office #

Herbert D Shearer

1 HWY 25 N.

FROM IT'S ORIGINAL STATUS BY:

Structural Design By: John Alexander McRae, PE, Inc **218 Coley Farm Road** Fuquay-Varina North Carolina 27526 jampe@nc.rr.com (919) 210-5749 P O Box 1466 Apex, NC 27502 Report deficiencies immediately 2303-20 (NC C-2298)

L______

McRae,

John

15 MARCH 2023

J A McRae

drawn by:

NOTES:

1. ALL FRAMING MEMBERS SHALL BE #2 SYP, FIR OR SPRUCE AND SHALL BE TREATED MAT'L @ ALL CRAWL SPACE AREAS.


2. PROVIDE SOLID BLKG. @ MID-SPAN OR @ 8'-6" O.C. MAX. SPACING.

3. CONTRACTOR SHALL VERIFY ALL BEAM SIZES WITH ENGINEER.

4. PROVIDE REINF. @ CMU WALLS OF #5'S @ 48" O.C. IN FULLY GROUTED CELLS.

5. PROVIDE 3-#3'S CONT. @ BOT. OF ALL CONT. CONC. FOOTINGS.

6. PROVIDE 3-#5'S EA. WAY @ BOT. OF SPOT CONC. FTGS.

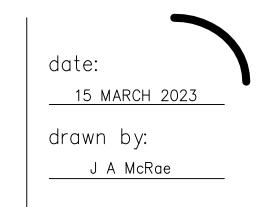

S Coley Farm Road Fuque P O Box 1466 Apex, Cell 919.210.5749 j

McRae, n Alexander INCLUDING FOUNDATION/FRAMING BE REVIEWED/DESIGNED BY A LICENSED STRUCTURAL P.E. PREFERABLY ONE IN LOCATION OF BUILD John

THIS PLAN HAS BEEN MODIFIED FROM ITS ORIGINAL STATUS. HDS DESIGN &DRAFTING SERVICES LLC. ASSUMES NO LIABILITY FOR ANY HOME CONSTRUCTED FROM THIS MODIFIED PLAN. IT IS THE RESPONSIBILITY OF THE PURCHASER/BUILDER OF THIS PLAN TO PERFORM THE FOLLOWING BEFORE BEGINNING ACTUAL CONSTRUCTION. ACTUAL CONSTRUCTION.

1. BUILDER OR CONTRACTOR MUST VERIFY ALL DIMENSIONS PRIOR TO PROCEEDING WITH CONSTRUCTION.


2. CONTRACTOR MUST VERIFY COMPLIANCE WITH ALL LOCAL BUILDING CODES IN THE AREA WHERE THE HOME IS TO BE CONSTRUCTED.

3. PLANS INDICATE LOCATION ONLY; ENGINEERING ASPECTS SHOULD INCORPORATE ACTUAL SITE CONDITIONS BY A LICENSED STRUCTURAL ENGINEER AS REQUIRED.

HDS DESIGN & DRAFTING SERVICES LLC. IS NOT A LICENSED P.E. THEREFORE IT IS RECOMMENDED THAT ANY/ALL STRUCTURAL PLANS

THIS DRAWING HAS BEEN REVISED ON THE DATE OF 03/01/2023 FROM IT'S ORIGINAL STATUS BY: HDS Design & Drafting Service Herbert D Shearer 1 HWY 25 N. Greenbrier Arkansas 72058 501-932-6200 Office #

> 12 varies Rafter Tie Backs 2 x 4 @ 32 kicker to flat plate over minimum 3 joists

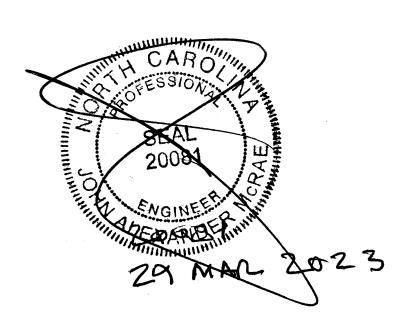

Cathedral and Vaulted Rafters require Collar ties at 32 inches on center in upper third or H2.5A clips ALL Rafters to Ridge. ALL rafters to top plate to be anchored by H2.5A clips 2x8 CEILING JOISTS @ 24" OC | 2x8 CLG JSTS @ 16" OC SLOPED 2x10 JOISTS @ 16" OC 2x8 CLG JSTS @ 16" OC SLOPED 2x6 JOISTS @ 16" OC | opné 2-2x1/2 BEAM (3)2x10 ALL CEILING JOIST 2 X 8 @ 16 Up To 15'
2 X 6 @ 16 Up To 11'
ALL EXTERIOR AND BEARING HEADER (2) 2"x10" u.n.o. (3)2x10 ALL FRAMING #2 SPF OR BETTER u.n.o. ALL Lintels $5 \times 3 \frac{1}{2} \times \frac{1}{4}$ Up to five feet $6 \times 4 \times 5/16$ Over Five Feet

4-2x10 BEAM

header continues to corner with purlins nail perpendicular king stud with 6-16d hand drive or 12-12d gun nails 2 x 6 portal Use full 4' x 8' sheet cut opening after installation wall Top plate header continuous to corner IF SIDING INSTALLED PURLINS TO BE GLUED TO SHEATHING continue header to 5/8" Type "X" on garage ceiling corner with purlins 7/16 OSB on exterior > top and bottom steel beam wall studs Lap OSB from top plate down full eight foot sheet prior to opening cut-out Provide 18 Ga vertical strap one jack each side of opening extending Double or 24" above / below header Nail panel to studs with 8d nails at <u>3</u> inches o.c. at edge and in field

OSB and Gypsum

PFH method

Engineered Alternate Design

Portal Frame with hold downs

LIMITED LENGTH OF WING WALLS WILL REQUIRE 7/16 osb

SHEATHING BOTH SIDES OF WALL LAP osb FROM TOP

PLATE DOWN FULL EIGHT FOOT SHEET PRIOR TO OPENING

CUT-OUT

12x6 CEILING JOISTS @ 24" OC

ALL FLOOR JOISTS 2 X 10 @16 #2 SPF OR BETTER

Or 11 7/8 | Joists at 16" or 19.2" By MFR

ALL LVL BEAMS/HEADERS 3 STUD COLUMNS EACH END u.n.o.

All stories to be sheathed with 7/16" OSB nailed @ six inches on center edges and ends with additional nailing of "braced" panels as noted below:

ALL EXTERIOR BEARING AND NON LOAD BEARING WALLS Four Foot Panel at Corners and Maximum 12' o.c.

Wall Bracing 7/16" OSB Lap OSB from top plate down full eight foot sheet prior to opening cut-out. Nail with 8d Minimum Panel Width 48" u.n.o. nails at THREE inches on center edges/ends six inches in field. Purlins at panel

ALL Brick Lintels $5 \times 3 \frac{1}{2} \times \frac{1}{4}$ Up To Five feet $6 \times 4 \times 5/16$ Over Five Feet

DESIGN TO IRC 2015 / NCRC 2018


Garage Door Wing Walls ONLY

Two 1/2" anchors with

seven inch embed secure wall plates Fill ALL Cells

5/8" HDG Rod Footing to Sill OR # 4 dowels (2 minimum) to #3 bar in bed joint

Structural Design By: John Alexander McRae, PE, Inc 218 Coley Farm Road Fuguay-Varina North Carolina 27526 jampe@nc.rr.com (919) 210-5749 P O Box 1466 Apex, NC 27502 Report deficiencies immediately 2303-20 (NC C-2298)

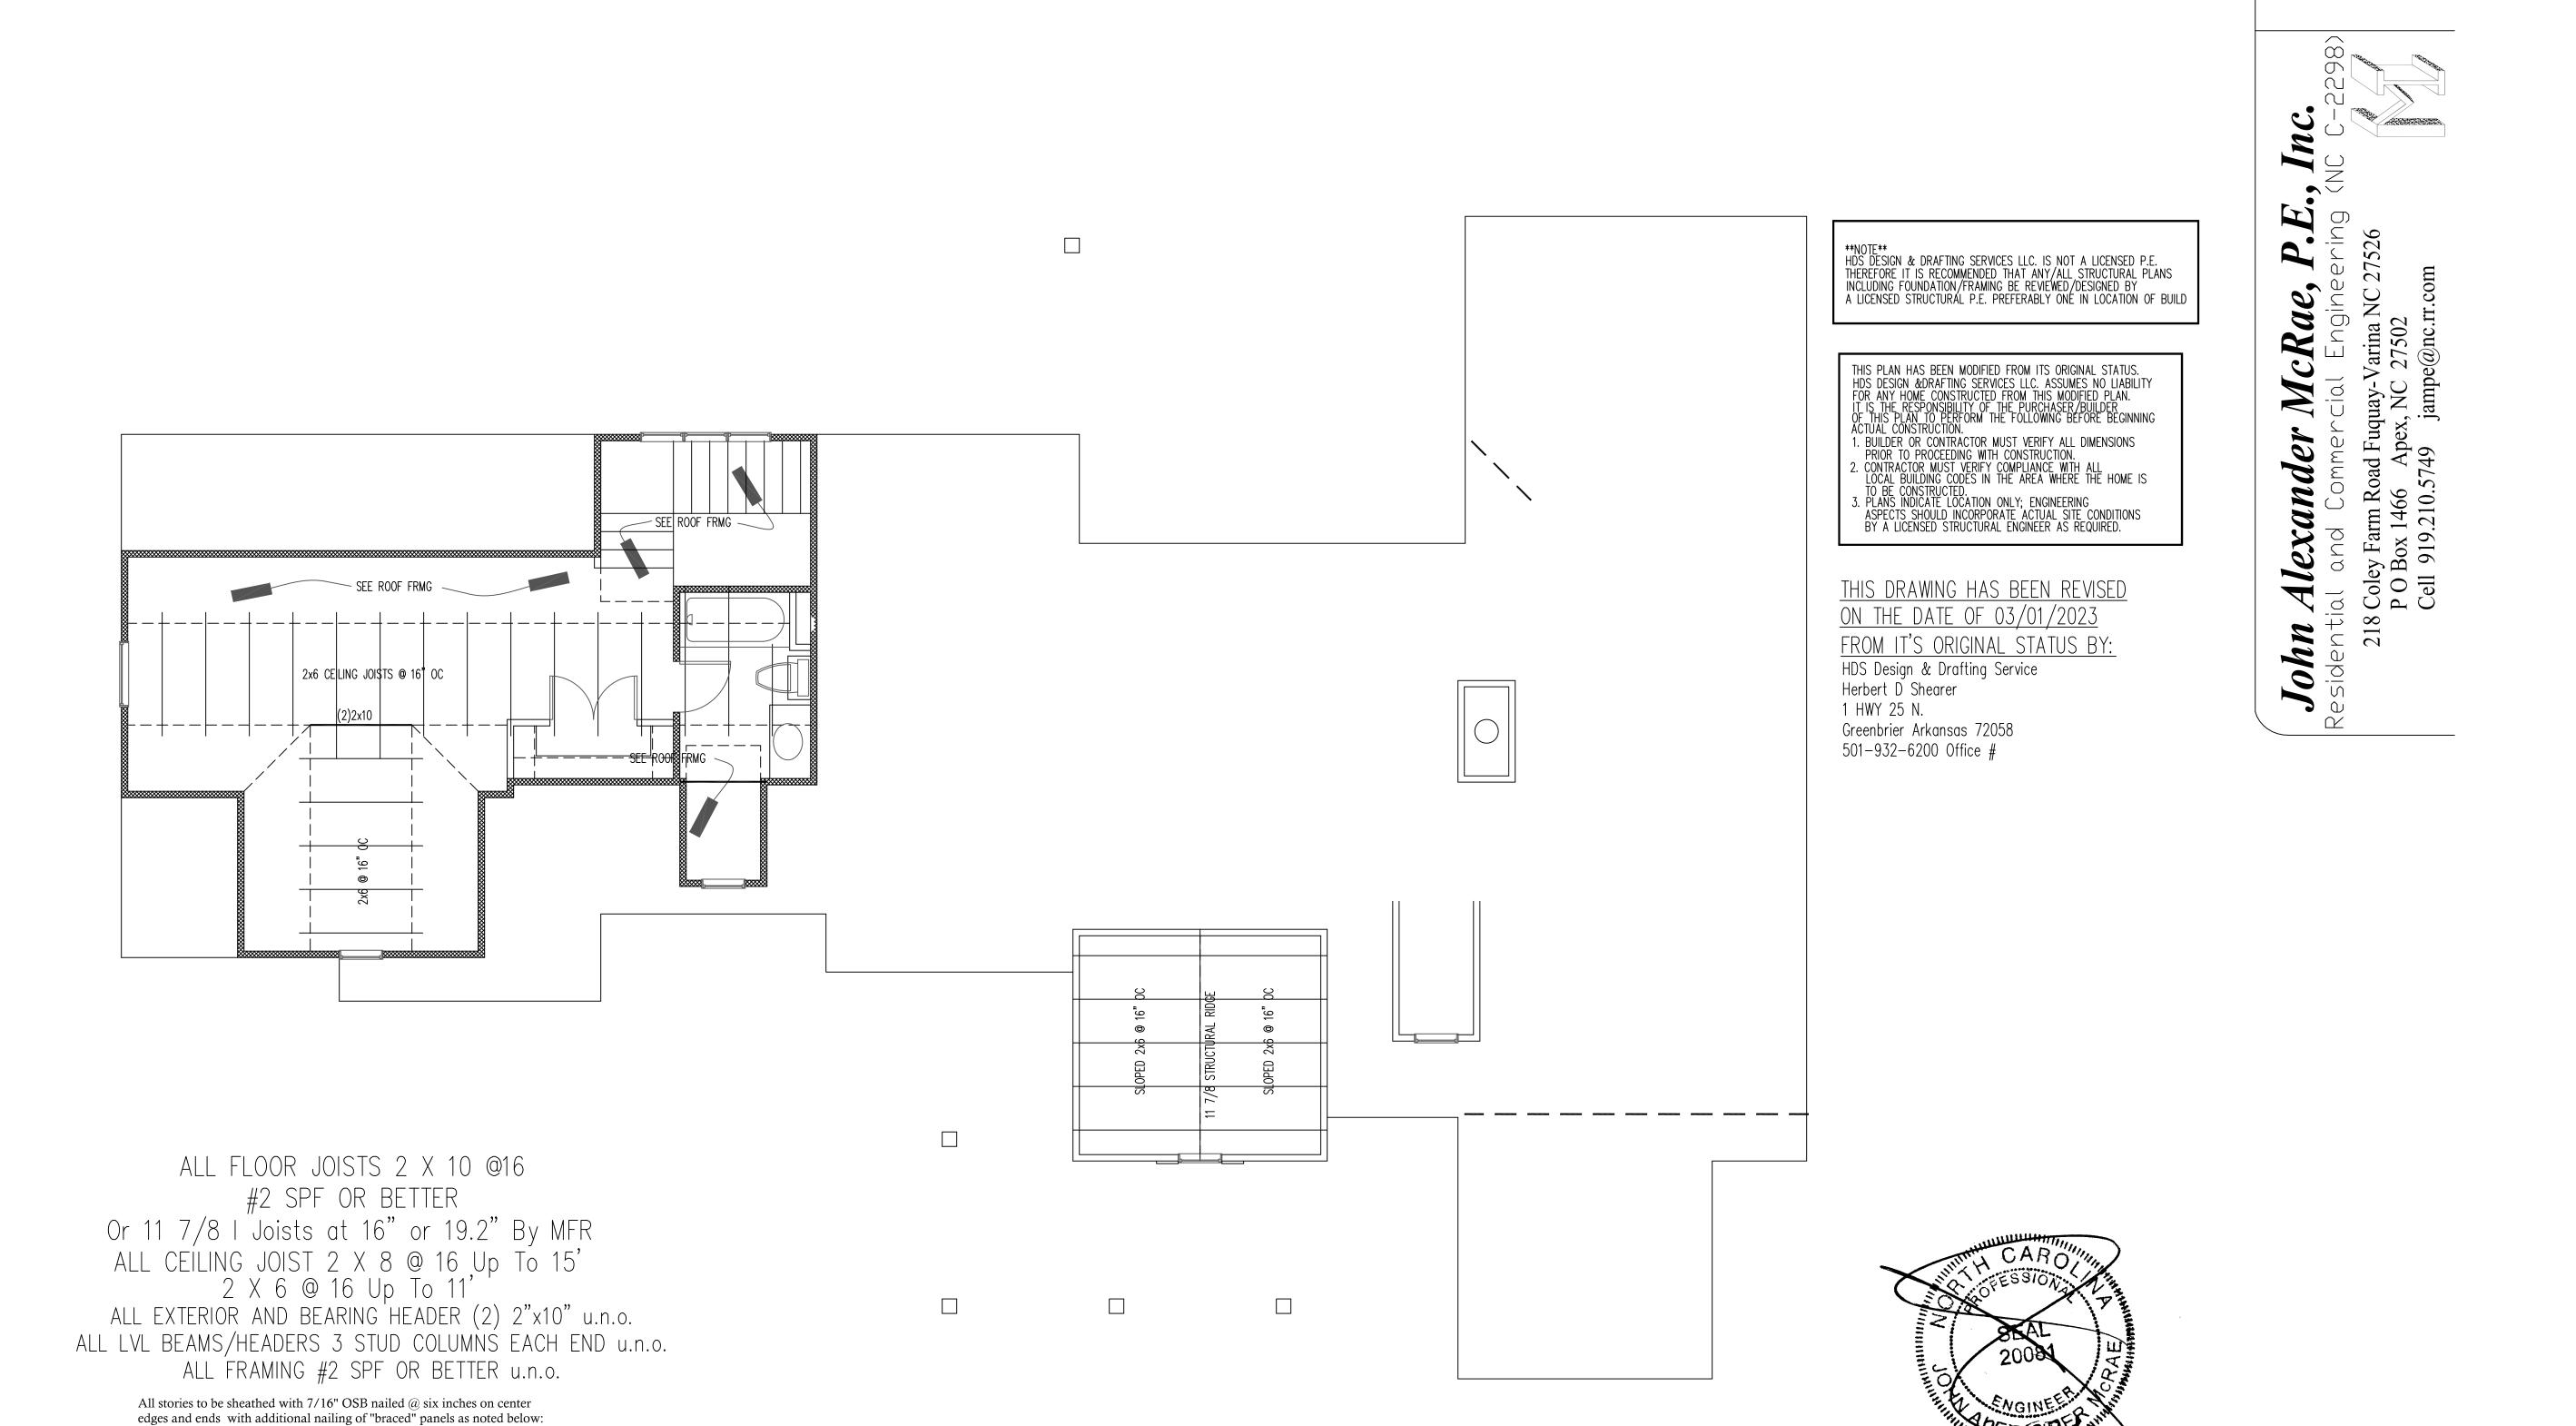

ALL EXTERIOR BEARING AND NON LOAD BEARING WALLS

and Maximum 12' o.c.

Wall Bracing 7/16" OSB Lap OSB from top plate down full eight foot sheet

Four Foot Panel at Corners

prior to opening cut-out. Nail with 8d

six inches in field. Purlins at panel


nails at THREE inches on center edges/ends

Structural Design By:
John Alexander McRae, PE, Inc
218 Coley Farm Road
Fuquay-Varina North Carolina 27526
jampe@nc.rr.com (919) 210-5749
P O Box 1466 Apex, NC 27502
Report deficiencies immediately
2303-20
(NC C-2298)

15 MARCH 2023

J A McRae

drawn by:

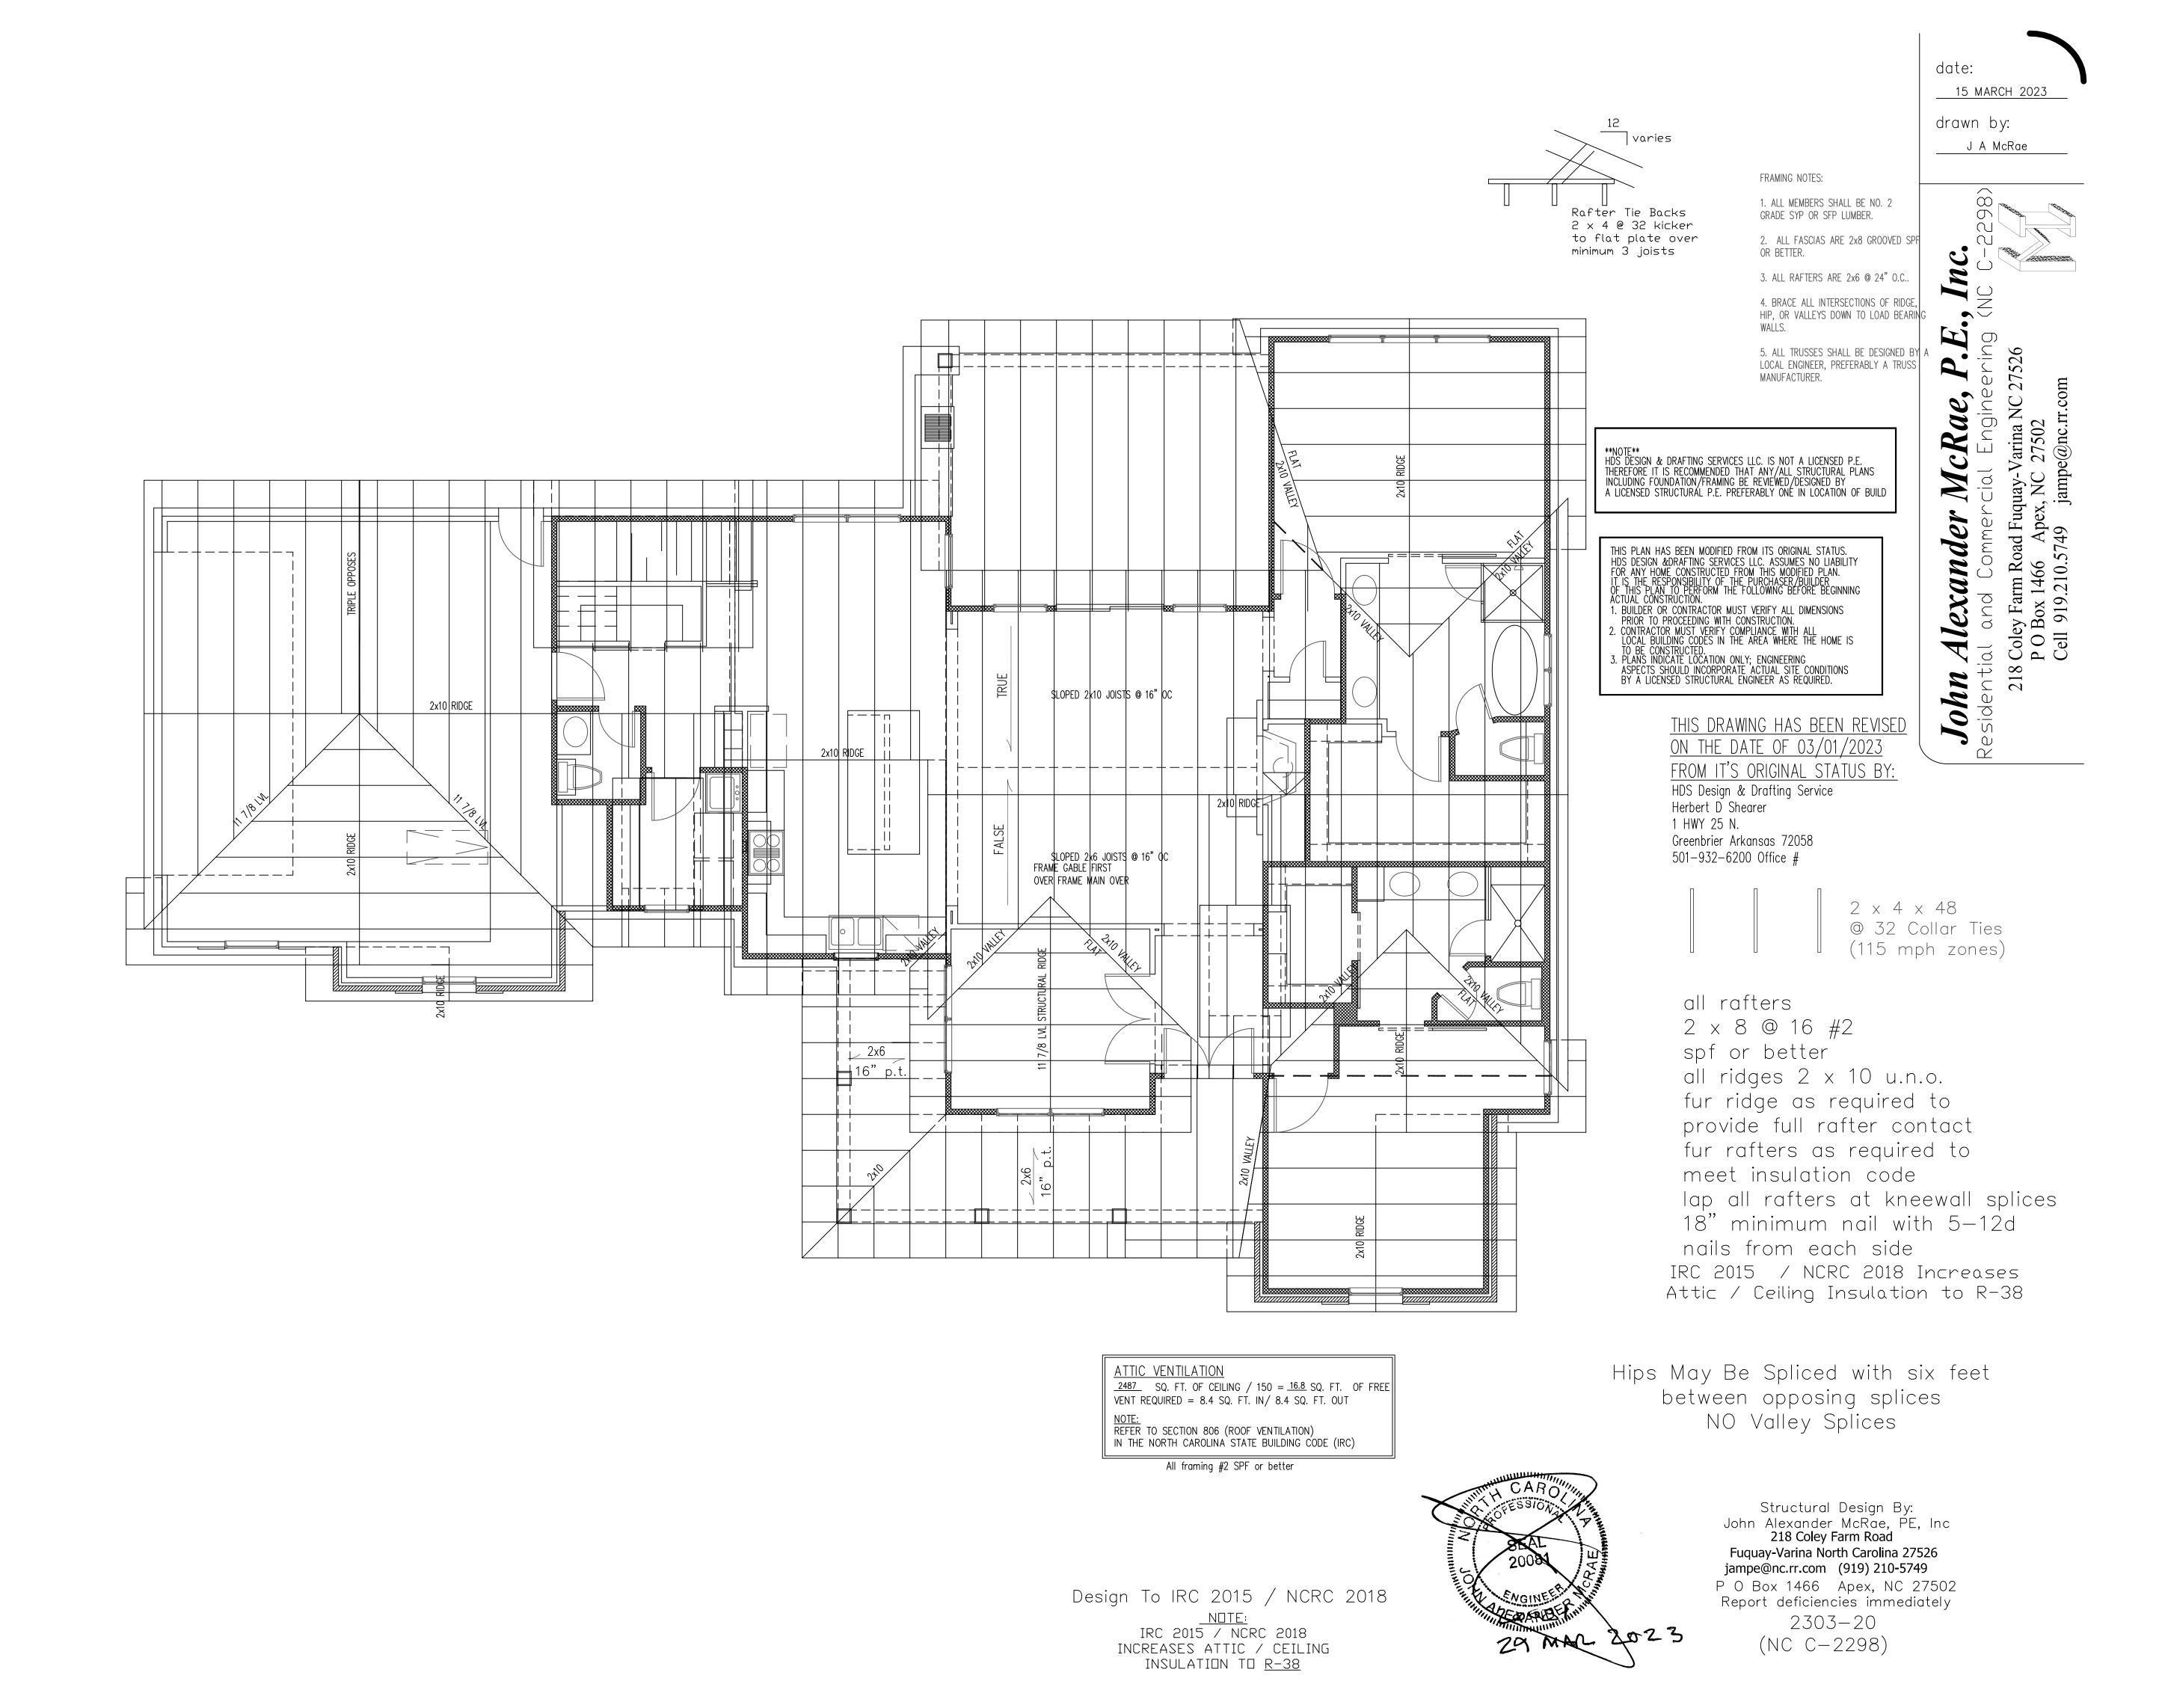

Xref .\ZBASE2.dwa