DETACHED SINGLE FAMILY DWELLING MODEL 628 - GARAGE RIGHT

CONTENTS

- CONTENTS AND PROJECT INFORMATION MONOLITHIC SLAB FOUNDATION PLANS
- MONOLITHIC SLAB FOUNDATION PLANS OPTIONS 2.0
- FIRST FLOOR PLANS
- FIRST FLOOR PLANS OPTIONS
- FIRST FLOOR PLANS OPTIONS
- SECOND FLOOR PLAN 3.2
- **ELEVATION A AND ROOF PLAN**
- ELEVATION B AND ROOF PLAN 4.1
- 4.2 ELEVATION C AND ROOF PLAN
- **ELEVATION D AND ROOF PLAN**
- 4.4 **ELEVATION E AND ROOF PLAN**
- **ELEVATION F AND ROOF PLAN** 4.5
- TYPICAL BUILDING SECTION FOUNDATION, WALL AND SOFFIT DETAILS
- **FOUNDATION AND WALL DETAILS**
- FOUNDATION AND WALL DETAILS 6.2
- **ELEVATION A DETAILS** 6.2A
- ELEVATION B/C/D/E/F DETAILS 6.2B
- FIRST FLOOR ELECTRICAL PLANS
- SECOND FLOOR ELECTRICAL PLAN
- STANDARD DETAILS AND NOTES MONOLITHIC

AREA SCHEDULE	
FIRST FLOOR HEATED *	1,308 SF
SECOND FLOOR HEATED **	1,708 SF
TOTAL HEATED AREA	3,016 SF
GARAGE ***	450 SF
COVERED FRONT PORCH (VARIES) ****	165 SF
TOTAL COVERED AREA	3,631 SF
OPT. COVERED REAR PORCH/SUNROOM *****	138 SF

- * + 68 SF @ OPT. BATHROOM + 25 SF @ ELEV. D
- ** +25 SF @ ELEV. D
- *** + 252 SF @ OPT. THIRD-CAR GARAGE
- + 56 SF @ OPT, GARAGE STORAGE
- **** 150 SF @ ELEV D
 - + 98 SF @ OPT, WRAP AROUND PORCH
- ***** + 174 SF @ OPT. SUNROOM W/ OPT. COVERED PORCH

GENERAL NOTES

- O1. GENERAL CONDITIONS

 1. STARS: ALL STAIRS SHALL BE CONSTRUCTED IN ACCORDANCE WITH THE REQUIREMENTS ESTABLISHED
 BY THE ADOPTED BUILDING CODE. STAIR INFORMATION MAXIMUM STAIR RISER 8-1/4"; MINIMUM STAIR
 TREAD 9" WITH A 3/4" 1-1/4" NOSING ON STAIRS WITH SOUID RISER. MINIMUM STAIR HEADROOM
- 1. STARS: ALL STARS SHALL BE CONSTRUCTED IN ACCORDANCE WITH THE REQUIREMENTS ESTABLISHED BY THE ADOPTED BILLIDING CODE. STAR INFORMATION MAXOMIM STAR REBS 8-1.4" INIMIAM STAR TREAD 9" WITH A 34" 1-1/4" NOSING ON STARS WITH SOUD RISER, MINIMAM STAR HEADROOM 6-6" CLEAR MEASURED VERTICALLY FROM THE STAR NOSING OR FROM THE FLOOR SURFACE OF THE LANDING OR PLATFORM, MINIMAM CLEAR STAR OPENING WOTH SHALL NOT BE LESS THAN 36 INCIRS. STARS WITH OPEN RISES SHALL BE CONSTRUCTED TO PREVENT THE PASSAGE OF A SPHERE OF 4 NOHS OR MORE IN DANIELTER THROUGH THE RISER OPENINGS. THE GREATEST RISER HEIGHT WITHIN ANY FLIGHT OF STARS SHALL NOT EXCEPT THE SHALLEST BY MORE THAN 378 INCIRS. THAS SHALL NOT EXCEPT THE SHALLEST BY MORE THAN 378 INCIRS. AND 38 INCIRS, SEPACITY HE SHALLEST BY MORE THAN 378 INCIRS. AND 38 INCIRS, RESPECTIVELY, MEASURED VERTICALLY FROM THE MOST OF THE TREADS, AND 38 INCIRS, RESPECTIVELY, MEASURED VERTICALLY FROM THE MOST OF THE TREADS, AND 38 INCIRS, RESPECTIVELY, MEASURED VERTICALLY FROM THE MOST OF THE TREADS, SHALL BE CONTINUOUS THE FULL LERGITH OF THE STARS. FROM SHALL BE RETURNED OR SHALL TERMINATE IN NEWEL POSTS OR SAFETY TERMINALS. ALL STARWAYS OF FOUR OR MORE RISERS, HANDRALS SHALL BE CONTINUOUS THE FULL LERGITH OF THE WALL SHALL BE RETURNED OR SHALL TERMINATE IN NEWEL POSTS OR SAFETY TERMINALS. ALL STARWAYS OF FOUR OR MORE RISERS, HANDRALS SHALL BE CONTINUOUS THE FULL LERGITH OF THE WALL SHALL BE RETURNED OR SHALL TERMINATE IN NEWEL, POSTS OR SAFETY TERMINALS. ALL STARWAY HANDRALS SHALL HAVE A CRECULAR CROSS SECTION WITH AND OUTSIDE DAMAETER OF AT LEAST 1-1-14 INCIDES AS NO TIC GREATER THAN 2 INCIDES MAY. OR APPROVED RALL OF EQUIVALENT GRASPABILITY, HANDRALS PROJECTING FROM THE WALL SHALL HAVE A SPACE OF NOT LESS THAN 36 AND THE PRANT THAN 2 INCIDENT AND SHALL BE INSTALLED AT ALL PROCESS, BALCONIES, OR RAISED FLOOR SURFACES SHALL BE REGISTED THAN THOSE SHOWN ON THE PLANS, THE SUPPLIER SHALL NOTIFY THE BULDER AND THE BULDER SHALL CONFIRM WIDDOW SIZES BY COMES BOTHER THE FLOOR OR GRADE BLOOM.

 1. WI

- O2. SITE WORK

 1. PRESUMED SOIL BEARING CAPACITY IS NOTED ON THIS COVER SHEET, THE BUILDER IS RESPONSIBLE FOR VERIFYING THIS BEARING CAPACITY. ALL FOOTINGS SHALL BEAR ON UNDISTURBED SOIL OR ENGINEERED FILE.

 THE BOTTOM OF ALL FOOTINGS SHALL BE BELOW THE FROST LINE AS DEFINED BY THIS COVER SHEET, THE
- 2. THE BOTTOM OF ALL POOTINGS SHALL BE BELOW THE FROST LINE AS DEPINED BY THIS COVER S DEAWHOS OR THE GOVERNING BUILDING OFFICIAL'S REQUIREMENTS AND/OR 12* MINIMUM.
 3. FOR BASSMENT CONDITIONS, THE MAXBRUM VERTICAL DISTANCE HEASURED FROM THE TOP OF A BASSEMENT FLOOR SLAST OTHE OUTSIDE PRINSHED GRADE SHALL NOT EXCEED DISTANCES FOR THE WALL, THICKNESS AS SHOWN IN RC TABLES R-404.1.1 (1-4) OR R-404.1.2 (1-9) BASED ON WALL TYPE AND SOIL CLASS.

- WALL TYPÉ AND SOIL CLASS.

 DO NOT BACKFILL UNTIL WALLS HAVE CURED AND THE ENTIRE BUILDING STRUCTURE ABOVE IS N
 PLACE. BACKFILL SHALL BE CLEAN GRANALAR FILL, FREE OF ORGANIC MATERIAL, FLACED
 EQUALITY ON ALL SIDES, COMPACTED TO 95% MAXIMAIN DAY DENSITY PER ASTIM D 698.
 FINISHED GRANDE SHALL SLOPE AWAY FROM THE BUILDING AT A MINAMUN SLOPE OF 6 INCHES PER FOR
 A MINIMUM DISTANCE OF 10 FEET FROM THE BUILDING PER RC SECTION R401.3.
 TERMITIE TREATMENT -TREAT INTENOR AND EXTERIOR EARTH AT PERIMETER WITH EPA APPROVED
 TERMICOR. SPRAY BORA-CARGO REQ. TERMICOR & MOLD TREATMENT ON STUDDS 3 FEET ABOVE SLABS
 PER MANUFACTURER'S RECOMMENDATIONS. PROVIDE TERMITE SHIELDS WHERE SHOWN ON PLANS.
 CAST-N-PLACE CONDISTED.

- PER MANUFACTURER'S RECOMMENDATIONS. PROVIDE TERMITE SHIELDS WHERE SHOWN ON PLANS.

 3. CAST-MF-AGE CONCRETE

 1. CONCRETE SHALL HAVE A MINIMUM 28-DAY COMPRESSIVE STRENGTH OF 3,000 PSI.

 5. CENTERIOR SLABS TO BE 3,000 PSI, MIN. 5% & MAX. 7% AIR ENTRAINED CONCRETE.

 2. CONCRETE PLACEMENT SHALL COMPLY WITH RECOMMENDATIONS OF ACI 332.

 5. CONCRETE SLABS SHALL INVE POLYPROPYLINE FIBER ADDITY (1,5 LB/CY) OR WHY REINFORCEMENT

 6. X 6, W1.4.X W1.4 PSR ASTIN A 185 LOCATED HIDWAY THROUGH THE SLAB THICKNESS. ALL SLABS

 4. X 7. ALL SLABS CONCRETE SHALL SHALL SHALL SLABS. ARE TO BEAR ON COMPACTED FILL TESTED FOR 95% MAXIMUM DRY DENSITY PER ASTM D 698.
 REINFORCING STEEL WHERE SHOWN ON PLANS SHALL CONFORM TO ASTM A 615, GRADE 60 MIN.,
- . PROVIDE A 6 MIL POLYETHELENE MOISTURE VAPOR BARRIER MEMBRANE UNDER INTERIOR AND GARAGE
- CONCRETE SLABS AND FOOTINGS WHERE INDICATED ON THE DRAWINGS. LAP SHEETS 6" MIN. AT JOINTS.

 COVERED PORCHES SLABS SHALL SLOPE AT A MINIMUM SLOPE OF 1/8" PER FOOT TO DRAIN WATER AWAY FROM EXTERIOR WALLS. UNCOVERED PATIO SLABS SHALL SLOPE AT 1/4" PER FOOT.

6. MASONRY 1. CONCRETE MASONRY UNITS (CMU) SHALL CONFORM TO ASTN C90, GRADE N, NORMAL WEIGHT UNITS.

- 1. CONTRACT DE TYPE "IN WITH A 28 DAY COMPRESSIVE STREAM TO AS 100 PS. PROVIDE CONTINUOUS HOROCHTAIN WITH A 28 DAY COMPRESSIVE STREAM THE AS THE ASTIN CAPO STATE AS THE AS
- OF 2,500 PS. GROUT ALL CELLS RECEIVING ANCHORS AND THE TOP COURSE OF ALL BEARING WALLS.

 4. FACE BRICK SHALL BE STANDARD SIZE AND COMPLY WITH ASTN C216, RUNNING BOND WITH TOOLED

 JOINT APPLICATION. SECURE BRICK VENEER TO WALL STUDS WITH 22 GA. GALV. METAL TIES ATTACHED

 TO STUDS WITH 8d MALS SPACING AS SHOWN ON PLANS.
- ANOUS WATERPROOF MEMBRANE TO THE EXTERIOR OF ALL BASEMENT WALLS TO BE BELOW
- 6. MANUFACTURED STONE WHERE SHOWN ON PLANS, SHALL BE INSTALLED IN STRICT ACCORDANCE WITH MANUFACTURER'S INSTALLATION INSTRUCTIONS AND DETAILS AND THE MASONRY VENEER WANDFACTURER'S INSTALLATION (MYMA) "INSTALLATION QUOE AND DETAILING OPTIONS FOR COMPLIANCE MANUFACTURER'S ASSOCIATION (MYMA)" "INSTALLATION QUOE AND DETAILING OPTIONS FOR COMPLIANCE

- WITH AS IN CLYDU.

 05. STRUCTURAL STEEL

 1. STEEL BEANS AND PLATES SHALL CONFORM WITH ASTM A36, STEEL COLUMNS SHALL CONFORM

 11. STEEL BEANS AND PLATES SHALL CONFORM WITH ASTM A36.
- 1. STEEL BEAMS AND PLATES SHALL CONFORM WITH ASTM A36, STEEL CULLIMING SHALL CURRINGS TO ASTM A33,
 2. ALL STRUCTURAL STEEL SHALL BE INSTALLED IN ACCORDANCE WITH CURRENT AISC SPECIFICATIONS AND "STEEL CONSTRUCTION MANIAL." ALL PIPE COLUMNS SHALL BE STANDARD WEIGHT STEEL COLUMNS IN ACCORDANCE WITH ASTM ASOO AND FINSTED WITH CONSOION RESISTANT COATING PER ASTM B117. STEEL COLUMNS AT BASEMENT LOCATIONS SHALL PENETRATE THE BASEMENT SLAB DOWN TO THE TOP OF THE COLUMN FOOTING BELOW SLAB.
- 3. ALL BRICK STEEL LINTELS SHALL BE SIZED PER STRUCTURAL DRAWINGS ON SHEET SD1.

- 05. WOOD

 1. FRAMING LUMBER SHALL BE DENTIFED BY A GRADE MARK OR CERTIFICATE OF INSPECTION WHICH
- PROVIDES THE PULLOWING MINIMON DESIGN VALUES:

 HEMBER

 FRAMING LUNBER

 FRAMING LUNBER

 FRAMING LUNBER

 FRAMING LUNBER

 FRAMING LUNBER

 FRESURE TREATED LUMBER

 FRESURE THE PD = 975 PSI

 FC = 425 PSI

 FLATES

 FC = 425 PSI

 FLOCKING

 2. CONSTRUCTION SHALL BE IN ACCORDANCE WITH THE AMERICAN FOREST AND PAPER ASSOCIATION (AF&PA),

 "WOOD FRAME CONSTRUCTION HAMLIAL," (WFCM) AND SHALL COMPLY WITH IRCR 8301.1 TO SUPPORT

 AND TRANSFER ALL LOADS SAPELY TO THE FOUNDATION.

 3. THE DESIGN LOADS FOR PREFABRICATED WOOD TRUSSES ARE PFR THESE SPECS., THE GOVERNING BUILDING CODE

 AND CURRENT EDTIONS OF THI -I AND NDS. THE TRUSS MAME, SHALL PROVIDE SHOP DRAWINGS, SEALED BY A STATE
 LICENSED DESIGNIN PROFESSIONAL, FOR APPROVAL PROTO TO FABRICATION. INSTALL TRUSSES AND ENGINEERED

 LUCHASED DESIGNIN PROFESSIONAL, FOR APPROVAL PROTO TO FABRICATION. INSTALL TRUSSES AND ENGINEERED

 LUNBER IN STRUCT ACCORDANCE WITH THE SHOP DRAWINGS AND WTCA-BI AND WTCA-B2. ALL POINT LOADS,

 PARTIAL UNFROMA LOAD OR COMBINATIONS THEREOF SHALL BE OFFERNATED BY THE TRUSS HAMUFACTURER AND

 ACCOUNTED FOR IN THE DESIGN OF THE ROOF AND/OR FLOOR SYSTEM.

 A. PREFABRICATED WOOD-LOSTS SHALL BE PATED PER ASTIN DISOS AND INSTALLED PER SHOP DRAWINGS

 AND DETAILS PROVIDED BY THE HAMUFACTURER.

 3. HANGERS, ANCHORS AND ASTATERES, WEND CALLED FOR IN SHOP DRAWINGS OR THESE DRAWINGS,

 SHALL BE INSTALLED IN COMPLIANCE WITH THE MAMFACTURER'S INSTRUCTIONS.

 ALL HAMSRES, FRAMING ANCHORS AND FASTENERS IN CONTACT WITH PRESSURE TREATED WOOD TO BE STAINLESS

 STEEL OR CALVANIZED PER GIBS BATING "J-AMX" COATING BY SURPSON OR TREFLE ZINC" BY USP.

 5. EMAIS AND HEADERS ARE TO BEAR ON LACK STUDS AS NOTED ON THE PLANS, SHOP DRAWINGS, OR PER COOE.

 PROVIDE SOLD BLOCKING BELOW ALL JACK STUDS FOR MINGS A NOTED ON THE PLANS, SHOP DRAWINGS, OR PER COOE.

 PROVIDE SOLD BLOCKING BELOW ALL JACK STUDS FOR MINGS OF PLANS, SHOP DRAWINGS, OR PER COOE.

 PROVIDE SOLD BLOCKING BELOW ALL JACK STUDS OF PRAYINGS AND DETECTED THE ATE.

 5. PROVIDE SOLD BLOCKING BELOW ALL JACK STUDS OF PRAYINGS OF PLANS, SHOP

- 10. STOUS FOR EXTENDIN WALLS SHALL BE SUZED FER THE INTERNATIONAL RESIDENTIAL CODE, TABLE REGOZ.S.1

 11. ALL NOTICHES AND CUTS IN FRAJAING SHALL NOT EXCEED MAX, DIJENSIONS AS DEFINED IN THE IRC ROSC.S.

 97. THERMAL AND MOSTIME PROTECTION

 1. INISTALL RISULATION MATERIALS TO MEET THE 'R' VALUES AS SHOWN ON THE DRAWINGS. FIT INSULATION TIGHT INTO SPACES AND LEAVE NO GAPS OR VOIDS. PROVIDE RIGIO INSULATION WHERE SHOWN ON PLANS, AT INTERIOR WALLS SEAL ALL JOINTS, SEAMS AND PENETRATIONS TO PREVENT ARE LEAKAGE PER INTO 2.4.

 2. INISTALL FIBERGLASS/ASPHALT ROOF SHINGLES IN ACCORDANCE WITH MANUE, INSTRUCTIONS AND ASPHALT ROOFING MANUFACTURERS ASSOC, "ASPHALT ROOF SHINGLES IN ACCORDANCE WITH MANUE, INSTRUCTIONS AND ASPHALT ROOFING FIBE RESISTANCE PER ASTM E 108 OR U. T.90 AND WIND RESISTANCE CLASS PER ASTM D7158 OR D3161 FOR WIND SPEED. INSTALL UNDERLAYMENT PER ROOF SLOPE AND INC ROSS. 2.2. AND CONTORNING TO ASTM D226.

 3. INSTALL FLASHING, SHEET METAL, GUITTERS AND DOWNSPOUTS PER PLANS AND PER "ASPHALT ROOFING RESIDENTIAL MANUE." AND "ANCHTECTURAL SHEET WETAL LANGUE." BY SHANCAN. BYSTALL FLASHING AT ALL ROOF TO WALL CONDITIONS, EXTENDIOR OPENINGS AND ELSEWHERE WHERE REQUIRED.

 4. INSTALL A WATER-RESISTANCE AND E96 FOR PENAGRABILITY AND BE INSTALLED FOR MATER RESISTANCE AND E96 FOR PENAGRABILITY AND BE INSTALLED. THE RESISTANCE AND E96 FOR PENAGRABILITY AND BE INSTALLED. THE RESISTANCE AND E96 FOR PENAGRABILITY AND BE INSTALLED. THE RISTALLATION INSTRUCTIONS.

 5. INSTALL SONICE AND ACCESSORY COMPONENTS IN STRUCT ACCORDANCE WITH MANUFACTURERS INSTRUCTIONS.

 5. INSTALL, SONICE AND ACCESSORY COMPONENTS IN STRUCT ACCORDANCE WITH MANUFACTURERS INSTRUCTIONS.

 5. INSTALL SONICE AND ACCESSORY COMPONENTS IN STRUCT ACCORDANCE WITH MANUFACTURERS INSTRUCTIONS.

 5. INSTALL SONICE AND ACCESSORY COMPONENTS IN STRUCT ACCORDANCE WITH MANUFACTURERS INSTRUCTIONS.

 5. INSTALL SONICE AND ACCESSORY COMPONENTS IN STRUCT ACCORDANCE WITH MANUFACTURERS INSTRUCTIONS.

 5. INSTALL SONICE AND ACCESSORY COMPONENTS IN STRUCT ACCORDANCE WITH MANUFACTUR

- 28. DOORS, WINDOWS AND GLASS

 1. INSTALL DOORS IN ACCORDANCE WITH MANUFACTURER'S WRITTEN INSTALLATION RECOMMENDATIONS 1. INSTALL DOORS IN ACCORDANCE WITH MANUFACTURER'S WRITTEN INSTALLATION RECOMMENDATIONS.
 2. ALL ALLIMINUM ANO/OR VERY. (EVC) AND/OR WOOD WINDOWS AND DOORS SHALL CONFORM TO CLASS R WITH DP PEAFORMANCE GRADE AS NOTED ON THE COVER SHEET, TESTED PER ANAMA/WOMA/CSA 101/18,24/440 FOR THE APPLICABLE WINDOW AND DOOR TYPES SHOWN ON THE DRAWINGS, INSTALL TEMPERED GLASS AND WINDOWS WHERE NOTED ON PLANS OR AS REQURED BY CODE. EMERGY PERFORMANCE RATINGS FOR U VALUES AND SHGC SHALL BE AS NOTED ON THE COVER SHEET AND INSTEED PER NET 100 AND NET 20 OR RESPECTIVELY.
 3. INSTALLATION AND PLASHING OF WINDOWS AND DOORS TO BE N ACCORDANCE WITH MANUFACTURERS WRITTEN NISTALLATION HYDIOTIONS AND ASTIME 2112.
 4. INSECT SCREENS TO BE IN ACCORDANCE WITH ANAL/SMA 1004, ANSI/SMA 2006, OR ANSI/SMA 3001.
 5. PROVIDE AND INSTALL HARDWARD PER DOWARTS SCRIPTION.
- PROVIDE AND INSTALL HARDWARE PER OWNER'S SCHEDULE.
- 6. GARAGE DOORS SHALL BE CERTIFIED IN ACCORDANCE WITH ASTM/DASMA 108 FOR THE APPLICABLE WIND PRESSURES AS NOTED ON THE COVER SHEET,

- 09. FINISHES

 1. GYPSUM WALL BOARD, GYPSUM SHEATHING MATERIALS AND ACCESSORIES SHALL BE INSTALLED IN ACCORDANCE
- WITH IRC R702.3 AND WITH GA-253 "APPLICATION OF GYPSUM SHEATTING" PUBLISHED BY THE GYPSUM ASSOCIATION 2. INSTALL FLOOR COVERINGS AS SHOWN ON PLANS OR PER OWNER'S SCHEDULE PER MANUF, INSTALLATION INSTRUCTION OF THE CONTROL OF THE CO
- O. SPECIALTIES

 1. PROVIDE KITCHEN AND BATH CABINETS FIXTURES AND APPLIANCES, FREFLACE, HARDWARE AND MISC. ITEMS PER OWNERS
 SCHEDULE. INSTALLATIONS TO BE IN ACCORDANCE WITH APPROVED SHOP DRAWINGS AND MANUFACTURER'S
 INSTALLATION INSTRUCTIONS. PRE-FAB FIREPLACES TO BE UL LISTED AND COMPLY WITH UL 127.

- INSTALLATION INSTRUCTIONS. PRE-PAID FINE PAID FINE PAID FOR PAID F

- ENERGY COMPANIACE CERTIFICATE AND ALL OTHER REQUIREMENTS OF THE CORRENT ENERGY CODE.

 1. TERMINAL HOOK UP IS REQUIRED FOR ALL FUTURES, APPLIANCES, MOTORS, FANS AND CONTROLS. LOCATION OF OUTLETS AND EQUIPMENT ON PLANS IS APPROXIMATE, EXACT ROUTING OF WIRING AND OUTLETS SHALL BE GOVERNED BY STRUCTURAL CONDITIONS AND OBSTRUCTIONS.

 2. ALL ELECTRICAL BREAKERS AND CONTROLS SHALL BE PROPERLY LABELED, INSTALL GFO PROTECTED AND AFCI OUTLETS WHERE SHOWN ON PLANS OR AS REQUIRED BY CODE, MATERIAL AND EQUIPMENT SHALL BEAR A UIL LABEL. LIGHT FORTIRES MUST MEET CLEARANCES STATED IN THE NEC. INSTALL LIGHT SWITCHES AT 3' 6" A.F.F. AND OUTLETS 12" A.E.F. TO CENTER HE IL NO.
- 12" A.F. R. TO CENTERLINE U.M.O.

 3. INSTALL ELECTRIC SHOKE DETECTORS, CARBON MONOXOPE/ALARIAS WHERE SHOWN ON PLANS. ALL DETECTORS
 MUST BE INTER-CONNECTED AND INCORPORATE A BATTERY BACK-UP. INSTALL PER NFPA 72 AND UL 217 REQUIREMENTS.
 CO ALARIAS TO COMPLY WITH NFPA 720 AND UL 2075, COMBINATION SHOKE/CO ALARIAS MUST BE LISTED PER UL 2034.

 4. PROVIDE HIGH EFFICACY LAMPS IN PERMANENT FIXTURES PER CURRENT EMERGY CODE. 17. PLINEING
 1. INSTALL PLIMBING FIXTURES, SUPPLY AND WASTE LINES PER GOVERNING CODE. ALL NOTCHES AND CUTS IN FRAMING
 SHALL NOT EXCEED MAX. DIMENSIONS AS DEFINED IN THE BUILDING CODE. PROTECT PLUMBING LINES AND REINFORCE STUD
 WALL NOTCHES WITH 16 GA. METAL PLATES.


BUILDING CODE SUMMARY

Owner: Contact Pe	Chesapeake Hon rson: Mark Kring	Telephone #: (919)	256-3060 E-m	nall: Mark@cheshomes.co
DESIGNER	OF RECORD;	·····		
Designer	Name	License #	Telephone #:	E-mail:
Architect	James W. Wentling	NC-Arch. # 4642	(215) 568-2551	
Structural:	Jonathan A. Troxler	NC-P.E., # 27845	(919) 878-1617	@wentlinghouseplan itroxler @southemengineers



CLIMATIC & GEOGRAPHIC DESIGN CRITERIA:

Ground Snow Load:
Design Wind Speed:
Seismic Site Class:
Seismic Design Category:
Weathering:
Frost Line:
Termite Decay:
Winter Design Temp.:
Climate Zone:

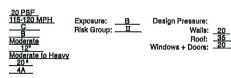

ENERGY EFFICIENCY:

(R-30 w/ Raised Heel Truss) Floors: Slab; Glazing 'U' Value:

(Note: Minimum insulation values per Southern Energy Reports)

SOIL BEARING CAPACITIES:

Presumptive Bearing Capacity: 2.000 PSF

Homesite 172 Plan 628 Elevation B Garage Right

- -Mono Slab
- -Patio
- -Full Bath at Bed 5
- -Rear Covered Porch
- -Flush Island Countertop
- -Bench and Pegs
- -First Floor Pickets and Rails
- -Double Bowl at Hall Bath
- -Door to Bath at Bed 4

JAMES WENTLING/ ARCHITECT

> LAND TITLE BUILDING 100 SOUTH BROAD STREET. SUITE 1524 PHILADELPHIA, PA 19110

ARCHITECTURE

LAND PLANNING GRAPHICS

THESE PLANS ARE COPYRIGHTED AND ARE SUBJECT TO COPYRIGHT PROTECTION AS AN ARCHITECTURAL WORK "UNDER SECTIONAL TO A COPYRIGHT ACT, 17 U.S.C. AS AMERICAD DECEMBER 1, 190 AND KNOWN AS THE "ARCHITECTURAL WORKS."





DN 01-10-19 CONVERT OLAHS DN 02-14-19 STRUCT, DWGS, REV. CH 12-10-19 ADD KINGST, RLBV, D + R CH 05-18-20 ELEV. F + SUNRM. W/ COV. 01-13-16 NO SCALE PERMITS/CONSTRUCTION

MODEL 628 -GARAGE RIGHT

CHESAPEAKE HOMES OF NC Raleigh, NC 27604 (919) 256-3060 (919) 556-0690 Fax

CONTENTS AND PROJECT INFORMATION

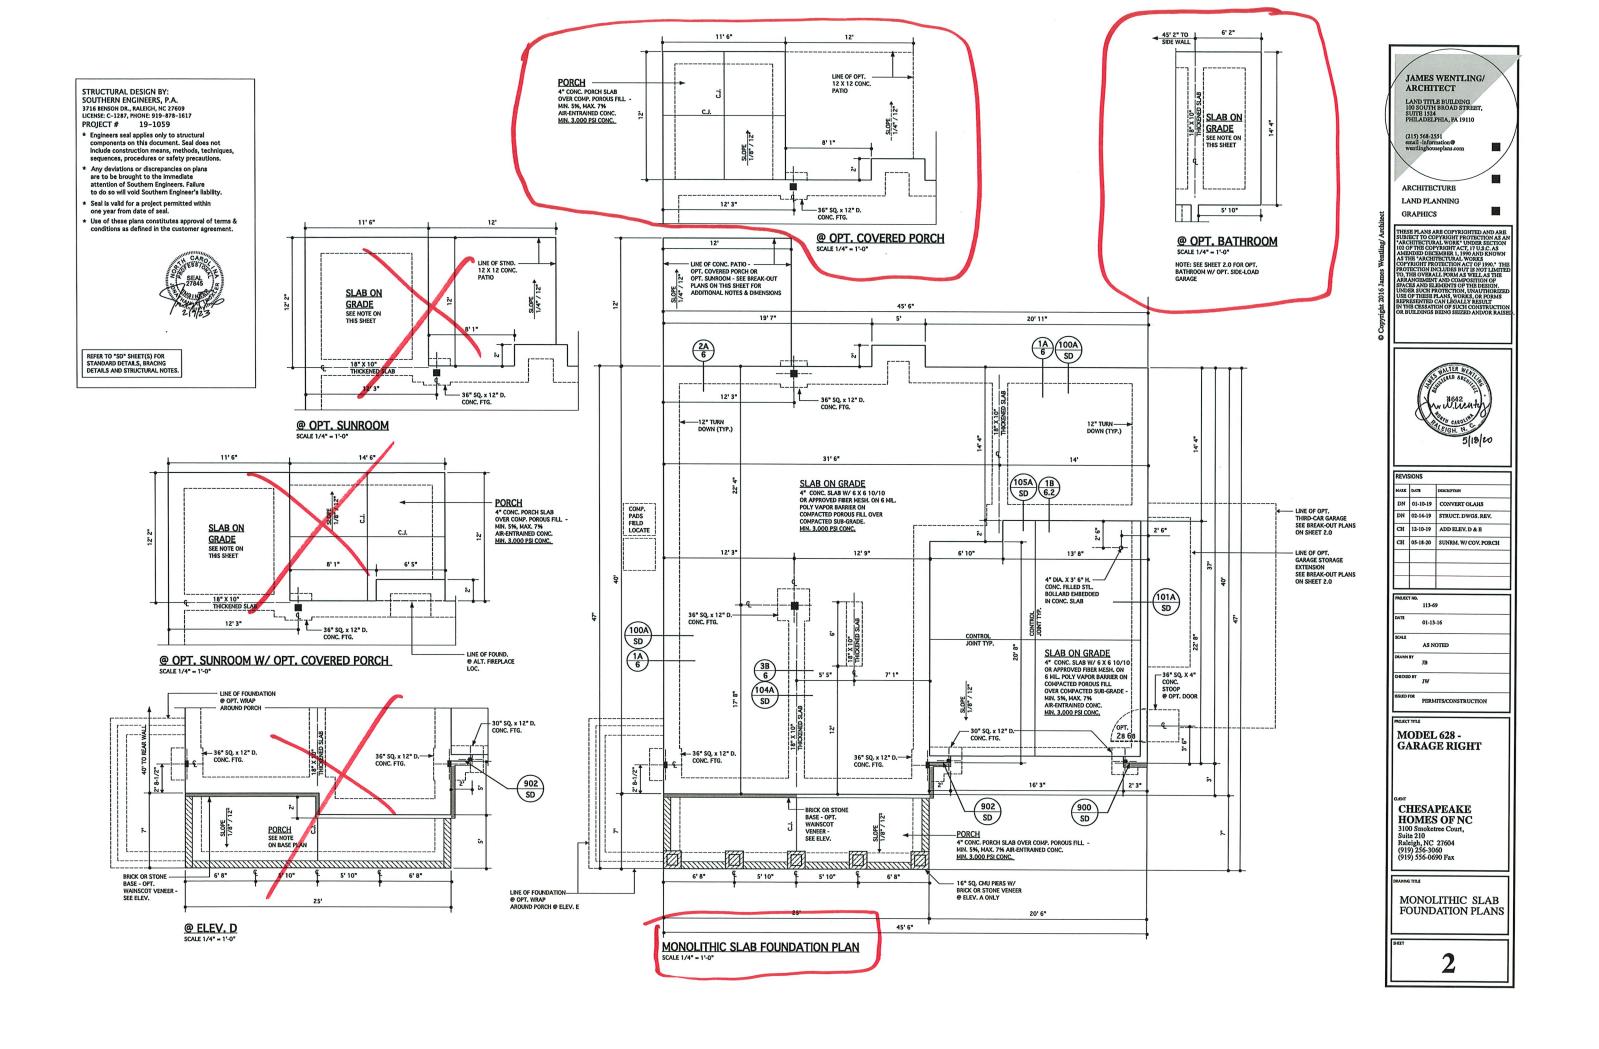

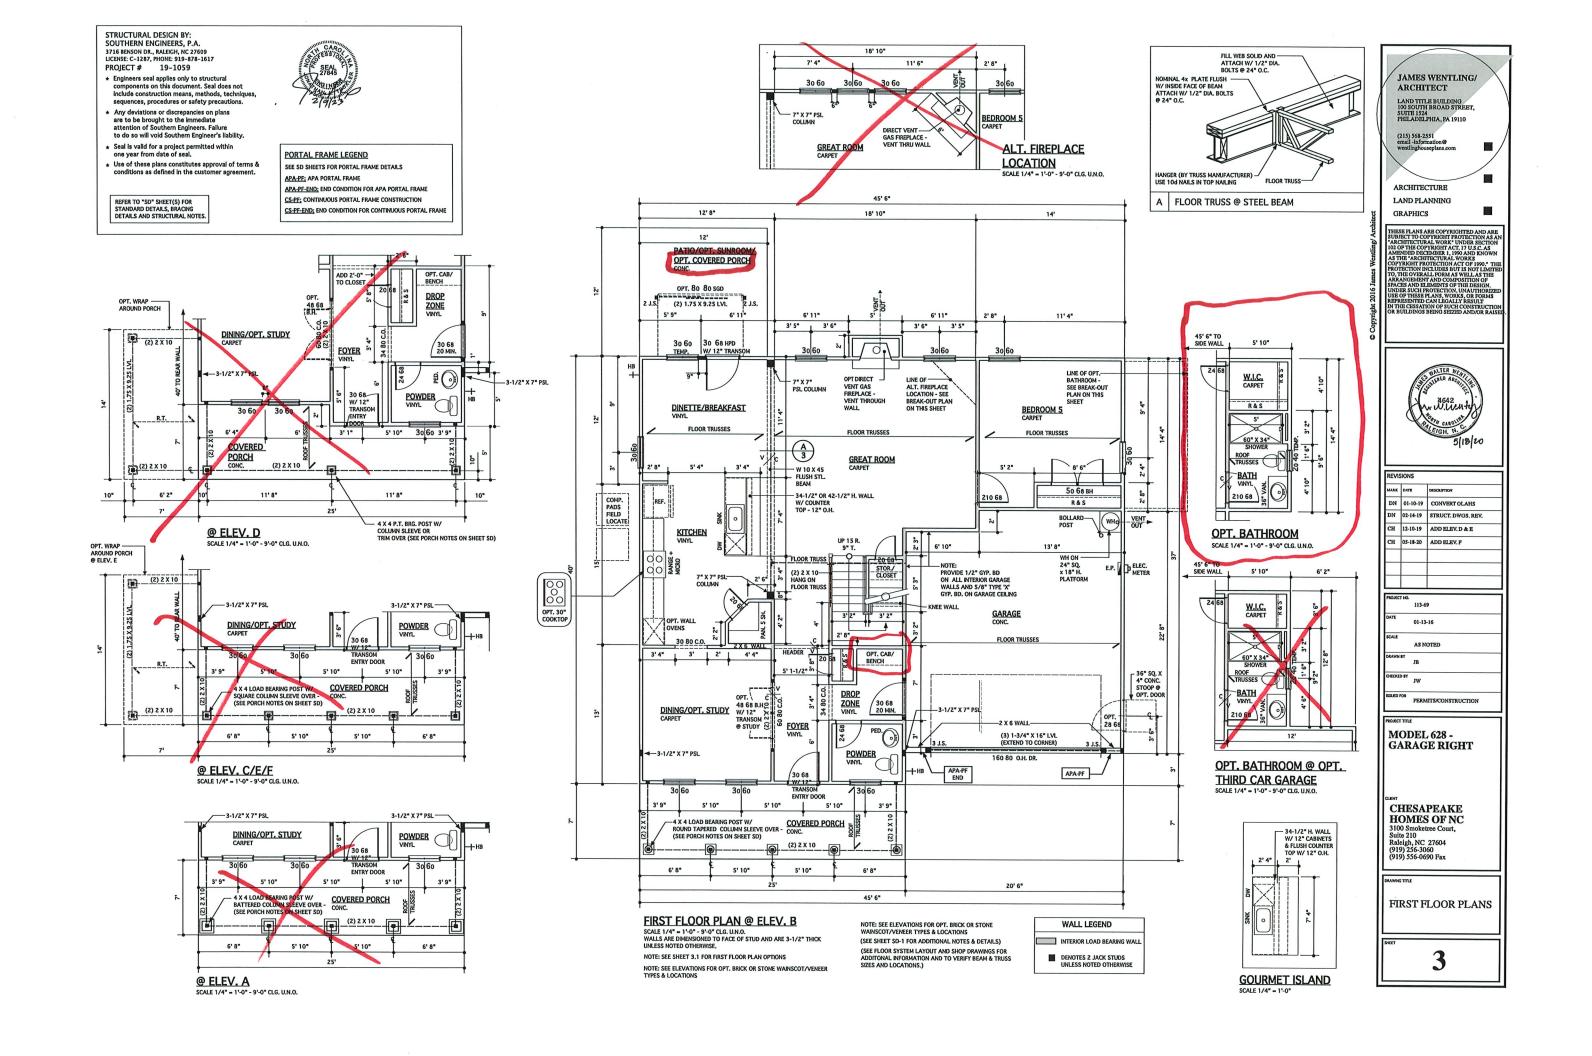

STRUCTURAL DESIGN BY:
SOUTHERN ENGINEERS, P.A.
3716 BENSON DR., RALEICH, NC 27609
LICENSE: C-1287, PHONE: 919-878-1617
PROJECT # 19-1059

- * Engineers seal applies only to structural components on this document. Seal does not include construction means, methods, techniques, sequences, procedures or safety precautions.
- * Any deviations or discrepancies on plans are to be brought to the immediate attention of Southern Engineers. Failure to do so will void Southern Engineer's liability.
- * Seal is valid for a project permitted within one year from date of seal.
- ★ Use of these plans constitutes approval of terms & conditions as defined in the customer agreement.

REFER TO "SD" SHEET(S) FOR STANDARD DETAILS, BRACING DETAILS AND STRUCTURAL NOTES.

PORTAL FRAME LEGEND

SEE SD SHEETS FOR PORTAL FRAME DETAILS

APA-PF; APA PORTAL FRAME

APA-PF-END; END CONDITION FOR APA PORTAL FRAME

CS-PF; CONTINUOUS PORTAL FRAME CONSTRUCTION


CS-PF-END; END CONDITION FOR CONTINUOUS PORTAL FRAME




WALL LEGEND


INTERIOR LOAD BEARING WALL

DENOTES 2 JACK STUDS UNLESS NOTED OTHERWISE

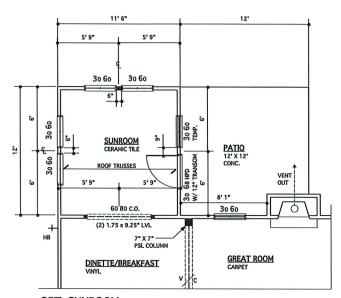


OPT. SUNROOM SCALE 1/4" = 1'-0" - 9'-0" CLG, U.N.O.

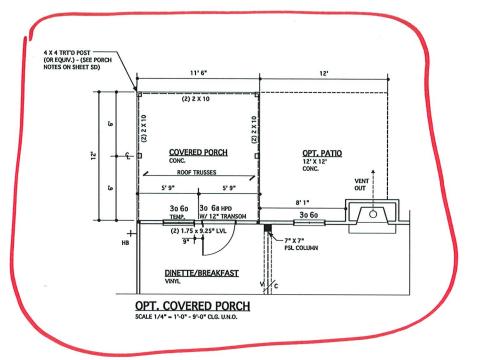

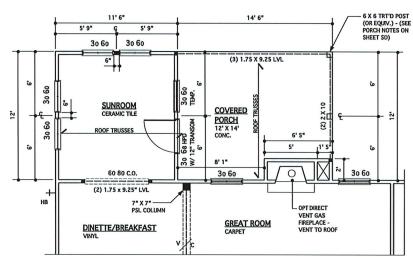

OPT. SUNROOM W/ OPT. COVERED PORCH
SCALE 1/4" = 1'-0" - 9'-0" CLG, U.N.O.

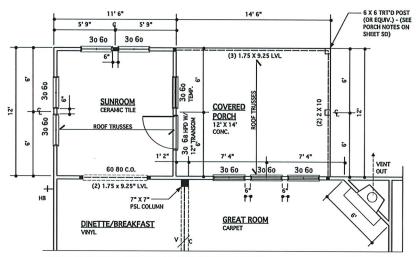

OPT. SUNROOM W/ OPT. COVERED PORCH
& ALT. FIREPLACE LOCATION
SCALE 1/4" - 1'-0" - 9'-0" CLG, UNO.

ARCHITECTURE

ARCHITECT

LAND THA ANILDISG

100 SOUTH ARCHITECT,
SOUTH ARCHITECT,
SOUTH ARCHITECT,
SOUTH ARCHITECTURE

LAND PLANNING

GRAPHICS

THESE PLANS ARE COPYRIGHTED AND ARE SUBJECT TO COPYRIGHT PROTECTION AS AN ARCHITECTURAL WORK UNDER SECTION 10.0 OF THE COPYRIGHT ACT, 17 U.S.C. AS AMENDED DECEMBER, 1, 1909 AND KNOWN AS THE "ARCHITECTURAL WORKS OF COPYRIGHT ROTICITION ACT OF 1950." THE COPYRIGHT ROTICITION ACT OF 1950. THE TO, THE OVERALL FORM AS WELL AS THE TO, THE OVERALL FORM AS WELL AS THE ARRANGEMENT AND COMPOSITION OF SPACES AND ELEMENTS OF THE DESIGN, UNDER SUCH PROTECTION, UNAUTHORIZED USE OF THISSE PLANS, WORKS, OR FORMS USED OF THISSE PLANS, WORKS, OR FORMS IN THE CESSIATION OF SUCH CONSTRUCTION OR BUILDINGS BEING SEIZED AND/OR RAISE



	VISIONS			
MARK	DATE	DESCRIPTION		
PROJECT	TNO. 113-			
	113-	09		
DATE	05-1	8-20		
SCALE				
	0.000	NOTED		
DRAWN	CH			
OÆOŒ	JW.			
ISSUED F	OR PER	MITS/CONSTRUCTION		

MODEL 628 -GARAGE RIGHT


CHESAPEAKE


HOMES OF NC 3100 Smoketree Court, Suite 210 Raleigh, NC 27604 (919) 256-3060 (919) 556-0690 Fax


DRAWING TITLE

FIRST FLOOR PLAN - OPTIONS

3.1.1

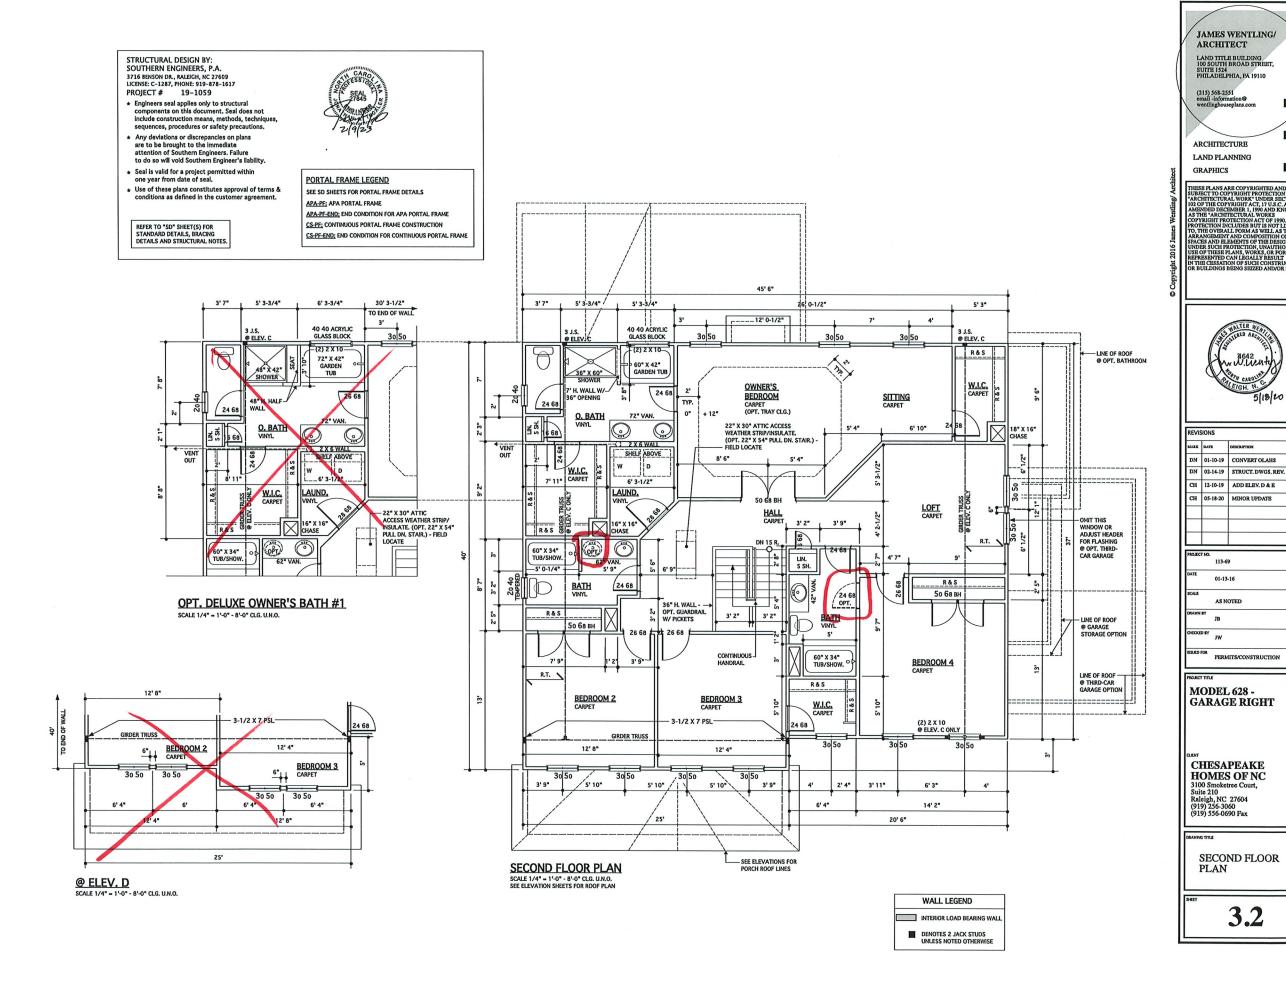

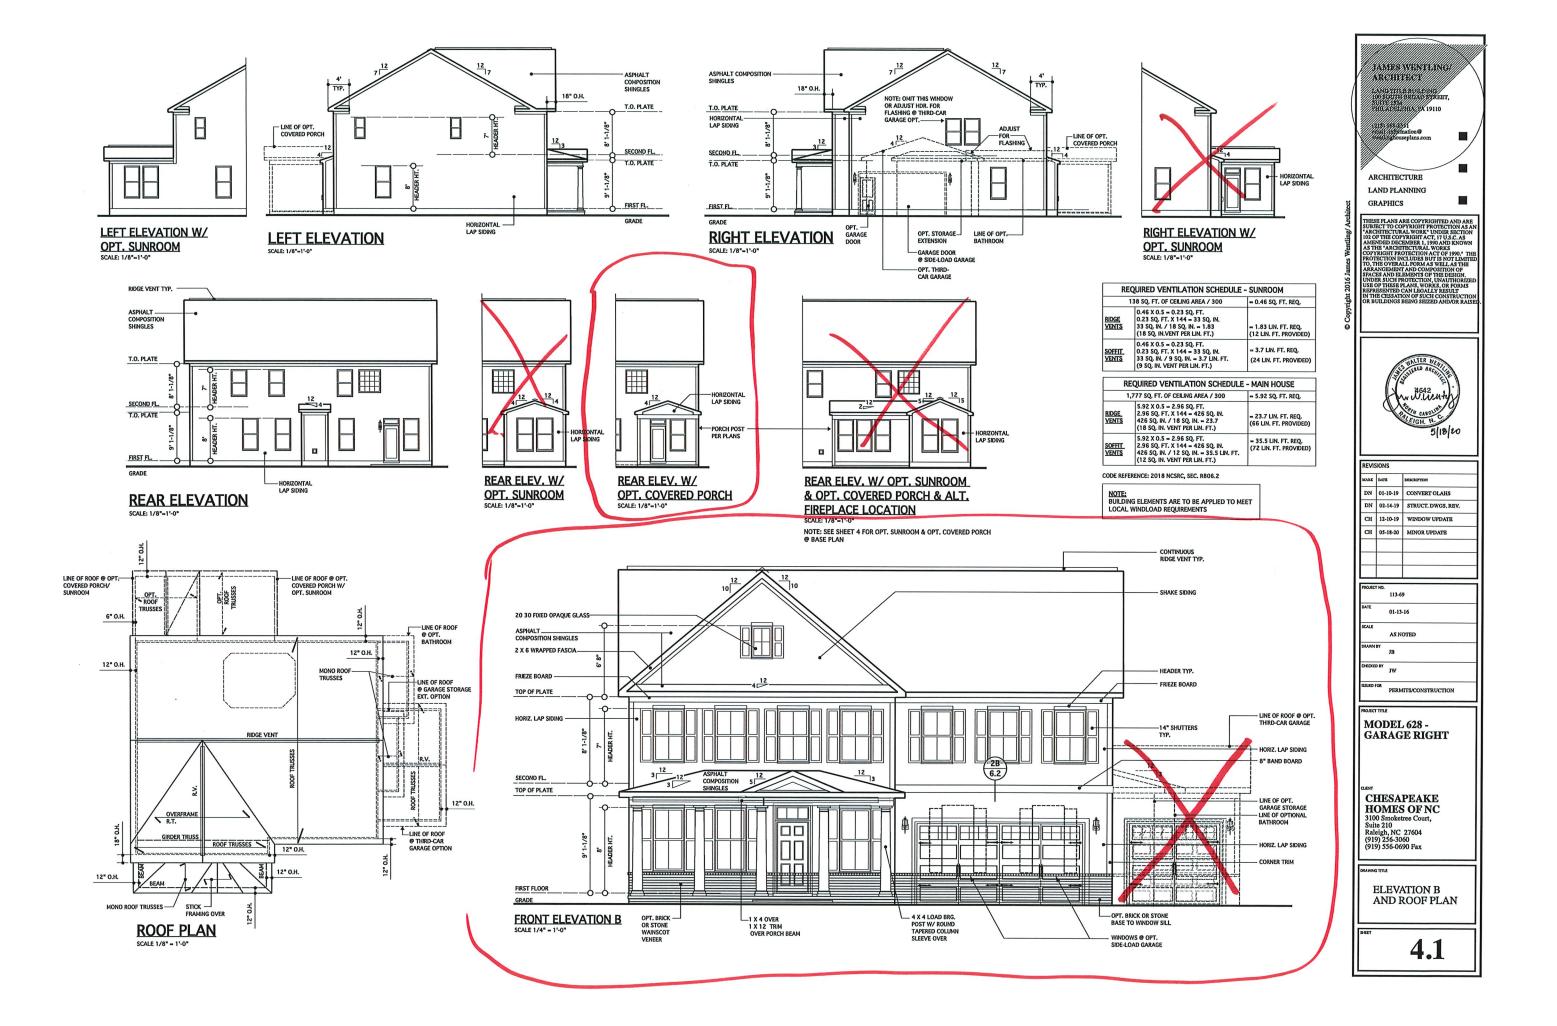

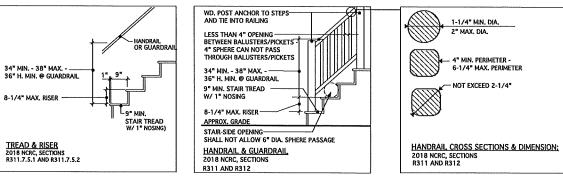


TYP. STAIR SECTION

NO SCALE ALL STAIR AND GUARD REQUIREMENTS TO COMPLY WITH R-311 AND R312 NCRC 2018


TYPICAL RAILING @ PORCH/DECK SCALE: 1/2" = 1'-0"

(PROVIDE GUARDRAIL BOTH SIDES WHEN HEIGHT ABOVE GRADE EXCEEDS 30"/ PROVIDE HANDRAIL ONE SIDE OF STEPS WHERE 4 OR MORE RISERS)

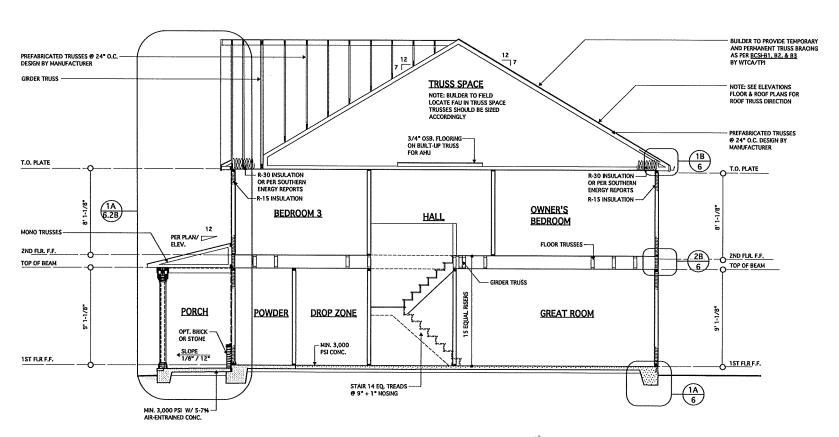

TYPICAL BUILDING SECTION @ ELEVATION B

SCALE: 1/4" = 1'-0"
Note: Minimum insulation values subject to Southern Energy

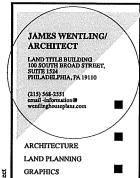





	Mark.	DATE	DESCRIPTION
i	DN	01-10-19	CONVERT OLAHS
	DN	02-14-19	STRUCT. DWGS. REV.
	CH	05-18-20	MINOR UPDATE
ı			
١			
- 1			
	PROJECT	г но. 113-6	•
	DATE	01-13	-16
	SCALE		
			отео
	DRAKN	JB	
	OEOXI	JW	
	ISSUED		ITS/CONSTRUCTION


MODEL 628 -GARAGE RIGHT


CHESAPEAKE HOMES OF NC 3100 Smoketree Court, Suite 210 Raleigh, NC 27604 (919) 256-3060 (919) 556-0690 Pax


BUILDING SECTIONS

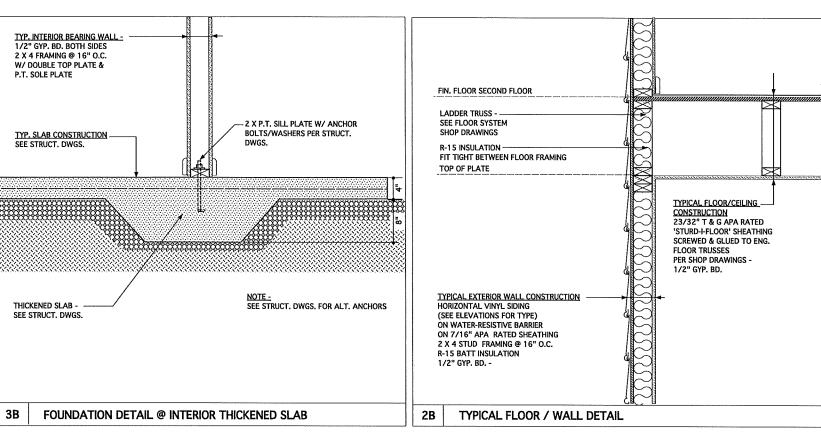


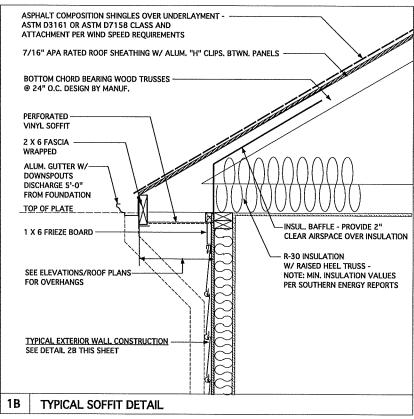

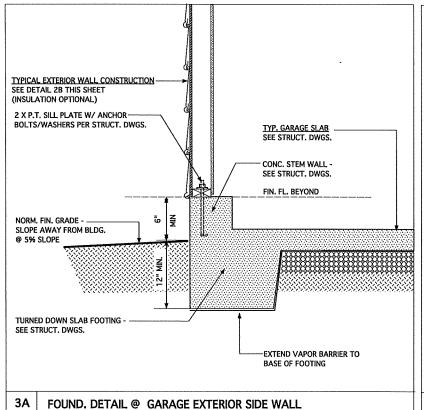

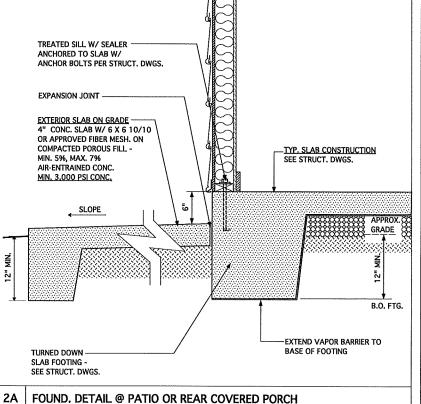

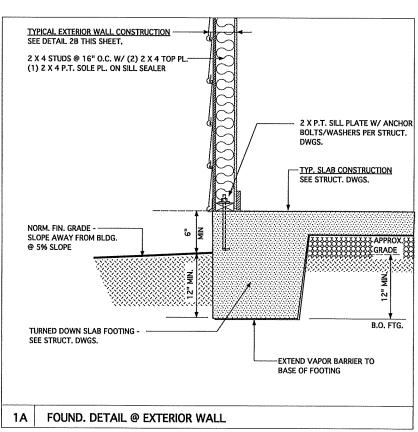

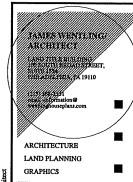

THESE PLANS ARE COPYRIGHTED AND ARE SUBJECT TO COPYRIGHT PROTECTION AS AN ARCHITECTURAL WORK UNDER SECTION 10.0 OF THE COPYRIGHT ACT, 17 U.S.C. AS ARMINDED DECEMBER 1, 1900, AND EXONOM COPYRIGHT ACT, 17 U.S.C. AS ARMINDED DECEMBER 1, 1900, AND EXONOM PROTECTION INCLUDES BUT IS NOT LIMITED TO, THE OFFICIAL PROTECTION INCLUDES BUT IS NOT LIMITED TO, THE OFFICIAL PROTECTION ACT OF 1900. THE DESIGN OF THE OFFICIAL PROTECTION IN AUGUST 100 OF SPACES AND ELEMENTS OF THE DESIGN.

UNDER SULF PROTECTION, UNAUTHORIZED REPRESENTED CAN LEGALLY RESULT BY THE COPYRIGHT AND COMPOSITION OF SPACES AND ELEMENTS OF THE DESIGN.

OFFICIAL PROTECTION, UNAUTHORIZED AND THE DESIGN OF SWILL FROM THE DESIGN OF SWILL FROM THE OFFICIAL PROTECTION OF THE DESIGN OF SWILL FROM THE PROTECTION OF SWILL FROM THE PROTECTIO



DN 01-10-19 CONVERT OLAI DN 02-14-19 STRUCT, DWG	15
DN 02-14-19 STRUCT, DWG	
	. REV
CH 05-18-20 MINOR UPDATE	В


PROJECT HO.	*****
	113-69
DATE	01-13-16
SCALE	1-1/2" = 1'-0"
DRAWN BY	JB
O ECUED ST	лw
ISSUED FOR	PERMITS/CONSTRUCTION


MODEL 628 -GARAGE RIGHT


CHESAPEAKE HOMES OF NC 3100 Smoketree Court, Suite 210 Raleigh, NC 27604 (919) 256-3060 (919) 536-0690 Fax


MONOLITHIC SLAB FOUNDATION, WALL AND SOFFIT DETAILS




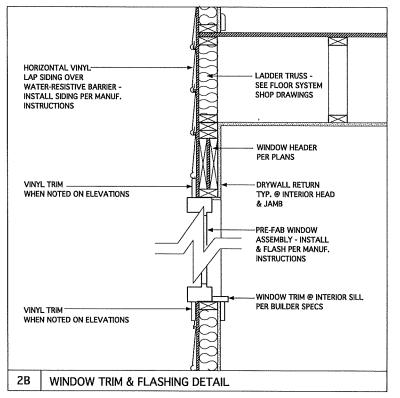


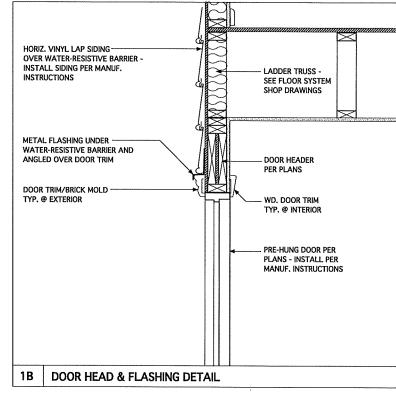

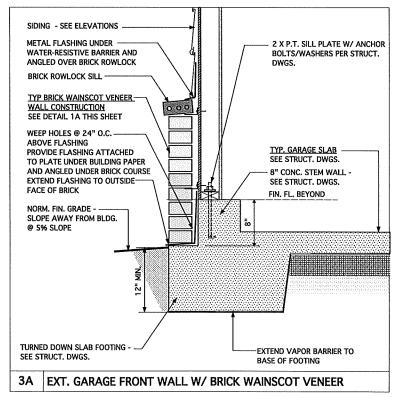

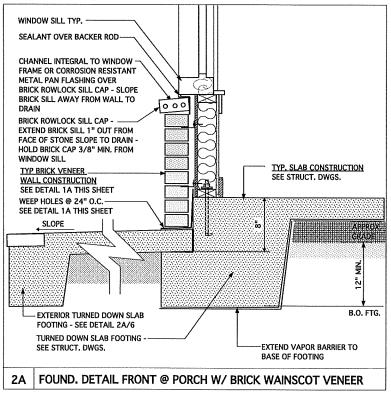

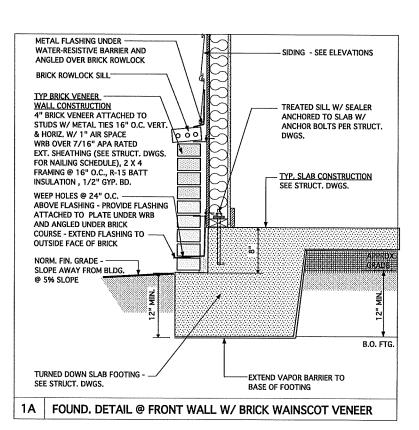

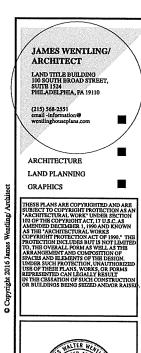



MARK	DATE	DESCRIPTION
DN	01-10-19	CONVERT OLAHS
DN	02-14-19	STRUCT, DWGS, REV
СН	05-18-20	MINOR UPDATE


	113-69
	01-13-16
	SCALE 1-1/2' = 1'-0'
I	DRAWN BY JB
	CHECKED BA
	SSUED FOR PERMITS/CONSTRUCTION


MODEL 628 -GARAGE RIGHT


CHESAPEAKE HOMES OF NC 3100 Smoketree Court, Suite 210 Raleigh, NC 27604 (919) 256-3060 (919) 556-0690 Fax


MONOLITHIC SLAB FOUNDATION AND WALL DETAILS


6.1

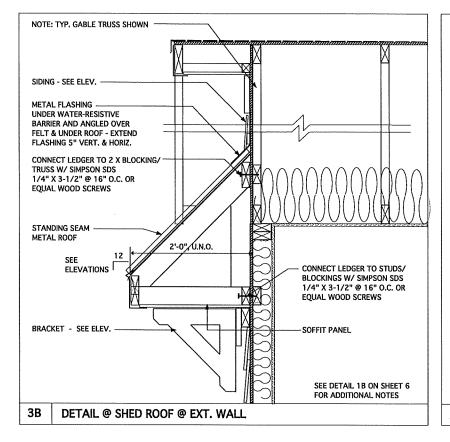


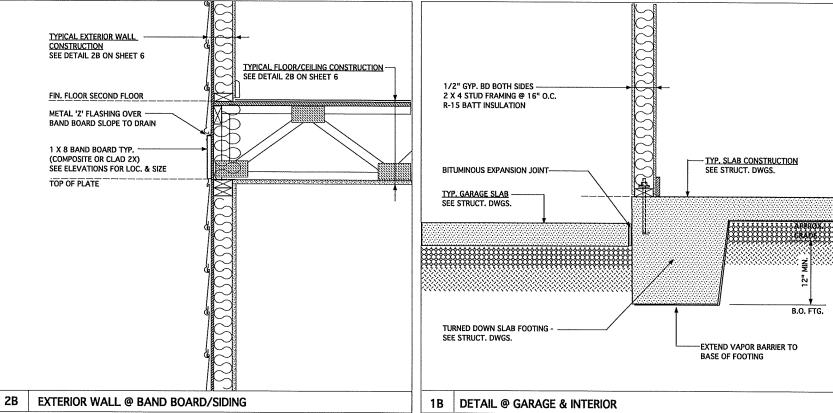

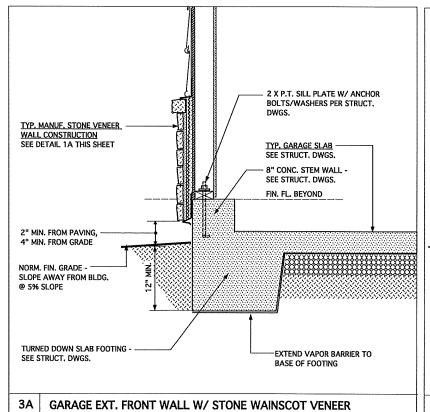

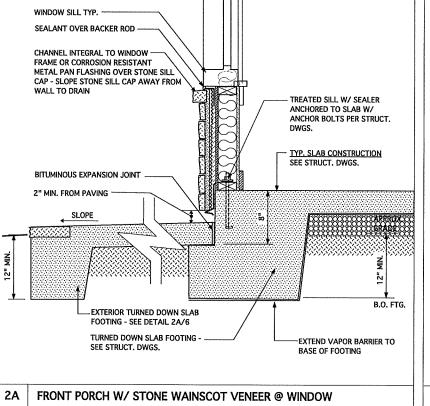

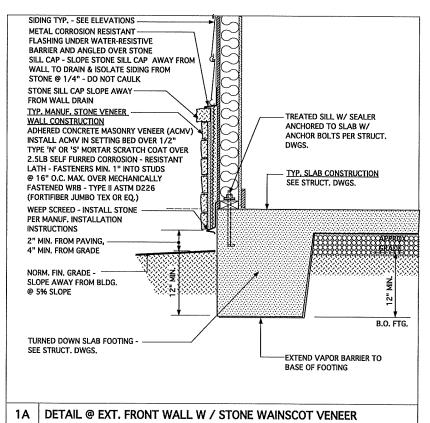

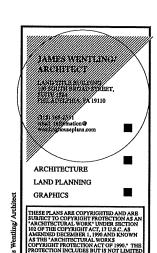

SOUTH WITH WATER OF THE PARTY O

		1
DN	01-10-19	CONVERT OLAHS
DN	02-14-19	STRUCT, DWGS, REV
СН	12-10-19	DETAIL 3B/2B
CH	05-18-20	MINOR UPDATE


LL_		
PROJECT NO.		
	113-69	
DATE	01-13-16	
SCALE	1-1/2* = 1'-0*	
DRAWN BY	JB	
O ECKED BY	JW.	
KOEN DO		

MODEL 628 -GARAGE RIGHT

CHESAPEAKE
HOMES OF NC
3100 Smoketree Court,
Suite 210
Raleigh, NC 27604
(919) 256-3060
(919) 556-0690 Fax

MONOLITHIC SLAB FOUNDATION AND WALL DETAILS

6.2

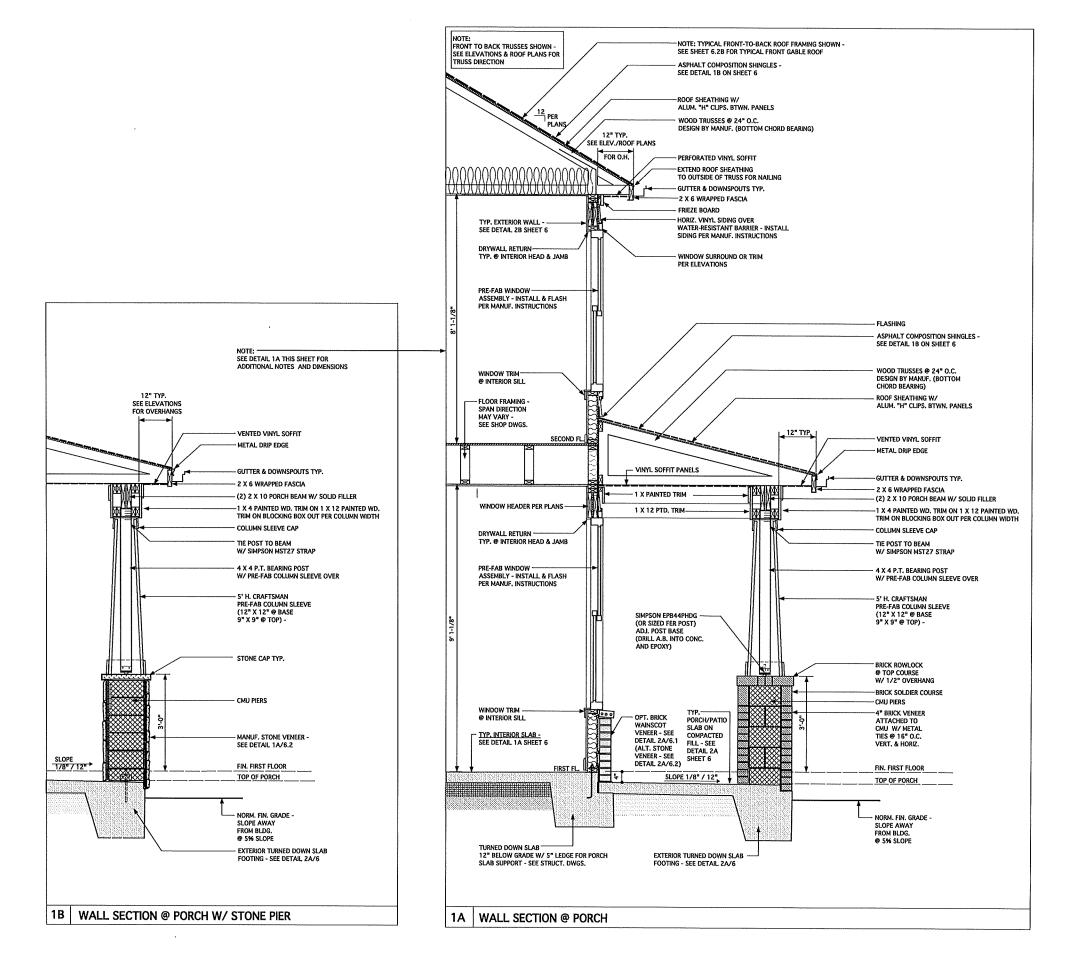

JAMES WENTLING/ ARCHITECT

LAND TITLE BUILDING 100 SOUTH BROAD STREET, SUITE 1524 PHILADELPHIA, PA 19110

215) 568-2551

ARCHITECTURE

LAND PLANNING GRAPHICS

THESE PLANS ARE COPYRIGHTED AND AR SUBJECT TO COPYRIGHT PROTECTION AS SUBJECT TO COPYRIGHT ACT, IT DIS. C. AS TAKENHETCHEM, WORK 'UNDER SECTIO 100 OF THE COPYRIGHT ACT, IT DIS. C. AS TO COMMITTED THE COPYRIGHT ACT, IT DIS. C. AS THE ANCHITECTURAL WORK COPYRIGHT PROTECTION ACT OF 1990. "THE PROTECTION ACT OF 1990." THE PROTECTION ACT OF 1990. THE PROTECTION, UNAUTHORIZE WAS ALLY AS THE PROTECTION, UNAUTHORIZE WAS OFFICED ALLY RESULT THE ACT OF 1990. THE PROTECTION, UNAUTHORIZE WAS OFFICED AND WORK OR FORM SEPTEMENTED CAN LEGALLY RESULT ON THE CESSION OF SUCH CONSTRUCTION, UNDER SULPHING WAS ALLY RESULT.



MAR		DESCRIPTION
DN	01-10-19	CONVERT OLAHS
DN	02-14-19	STRUCT, DWGS, REV
CH	05-18-20	MINOR UPDATE

PROJECT NO.	
	113-69
DATE	01-13-16
SCALE	3/4" = 1'-0"
DRAWN BY	JB.
O-ECKED BY	JW
ISSUED FOR	PERMITS/CONSTRUCTION

MODEL 628 -GARAGE RIGHT


ENT


CHESAPEAKE
HOMES OF NC
3100 Smoketree Court,
Suite 210
Raleigh, NC 27604
(919) 256-3060
(919) 556-0690 Fax

DRAWING TITL

ELEVATION A -DETAILS

6.2A

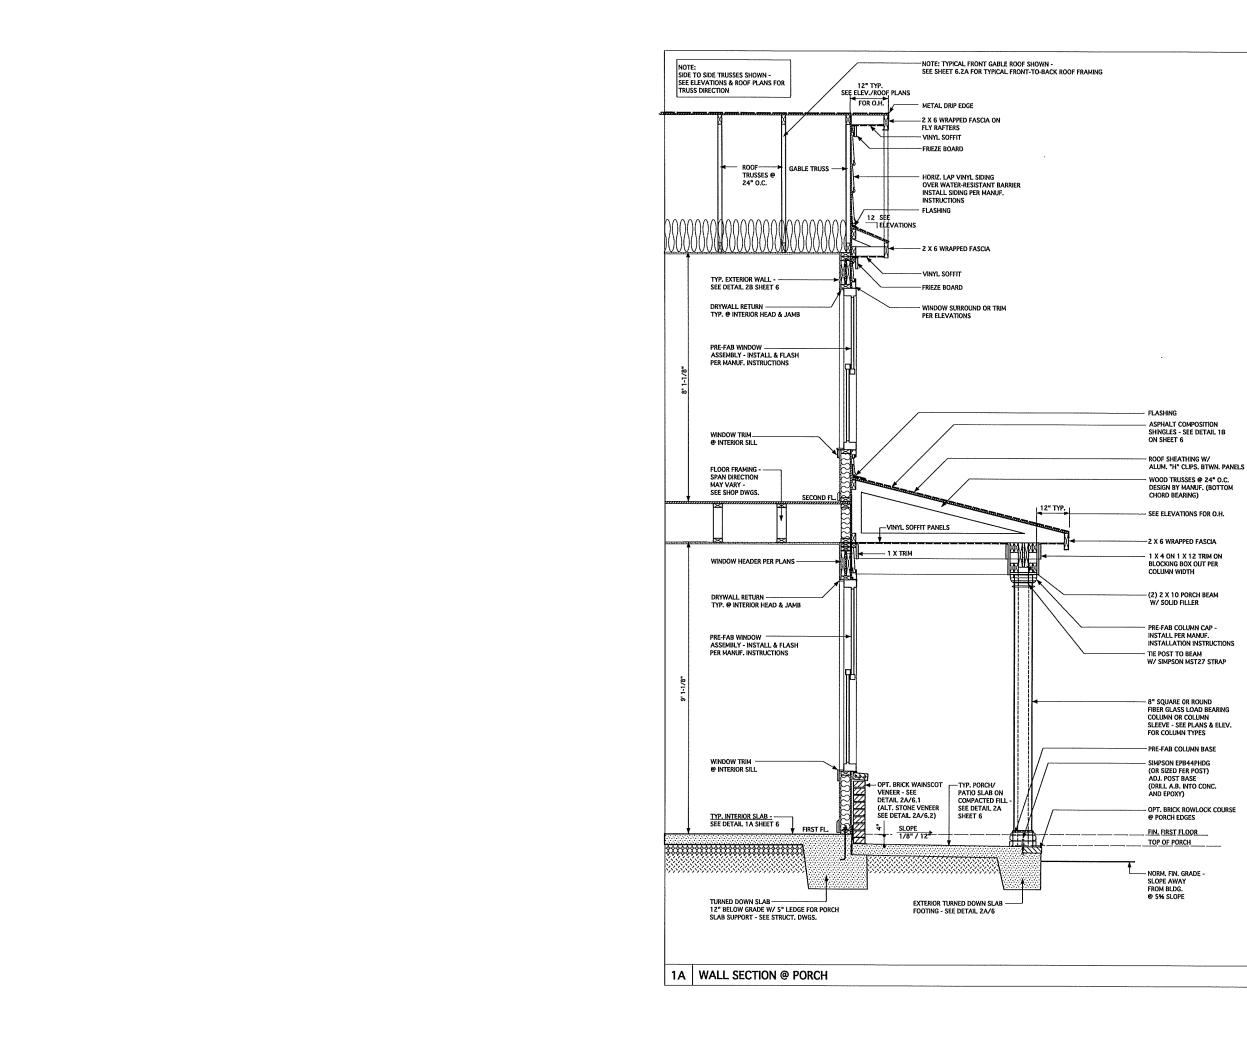

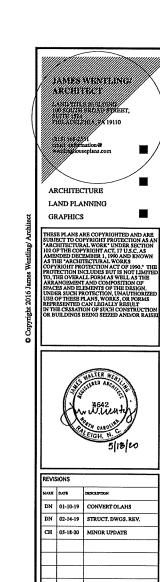

FLASHING

- SEE ELEVATIONS FOR O.H.

-2 x 6 wrapped fascia

COLUMN OR COLUMN
SLEEVE - SEE PLANS & ELEV.
FOR COLUMN TYPES

PRE-FAB COLUMN BASE

AND EPOXY)

TOP OF PORCH

@ 5% SLOPE

PROJECT NO.	
	113-69
DATE	01-13-16
	01-13-10
SCALE	
3	/4° = 1'-0°
DRAWN BY	
	В
OECKED BY	
	JW
ISSUED FOR	
	PERMITS/CONSTRUCTION


MODEL 628 -GARAGE RIGHT


CHESAPEAKE HOMES OF NC

3100 Smoketree Court, Suite 210 Raleigh, NC 27604 (919) 256-3060 (919) 556-0690 Fax

ELEVATION B/C/D/E/F - DETAILS


6.2B

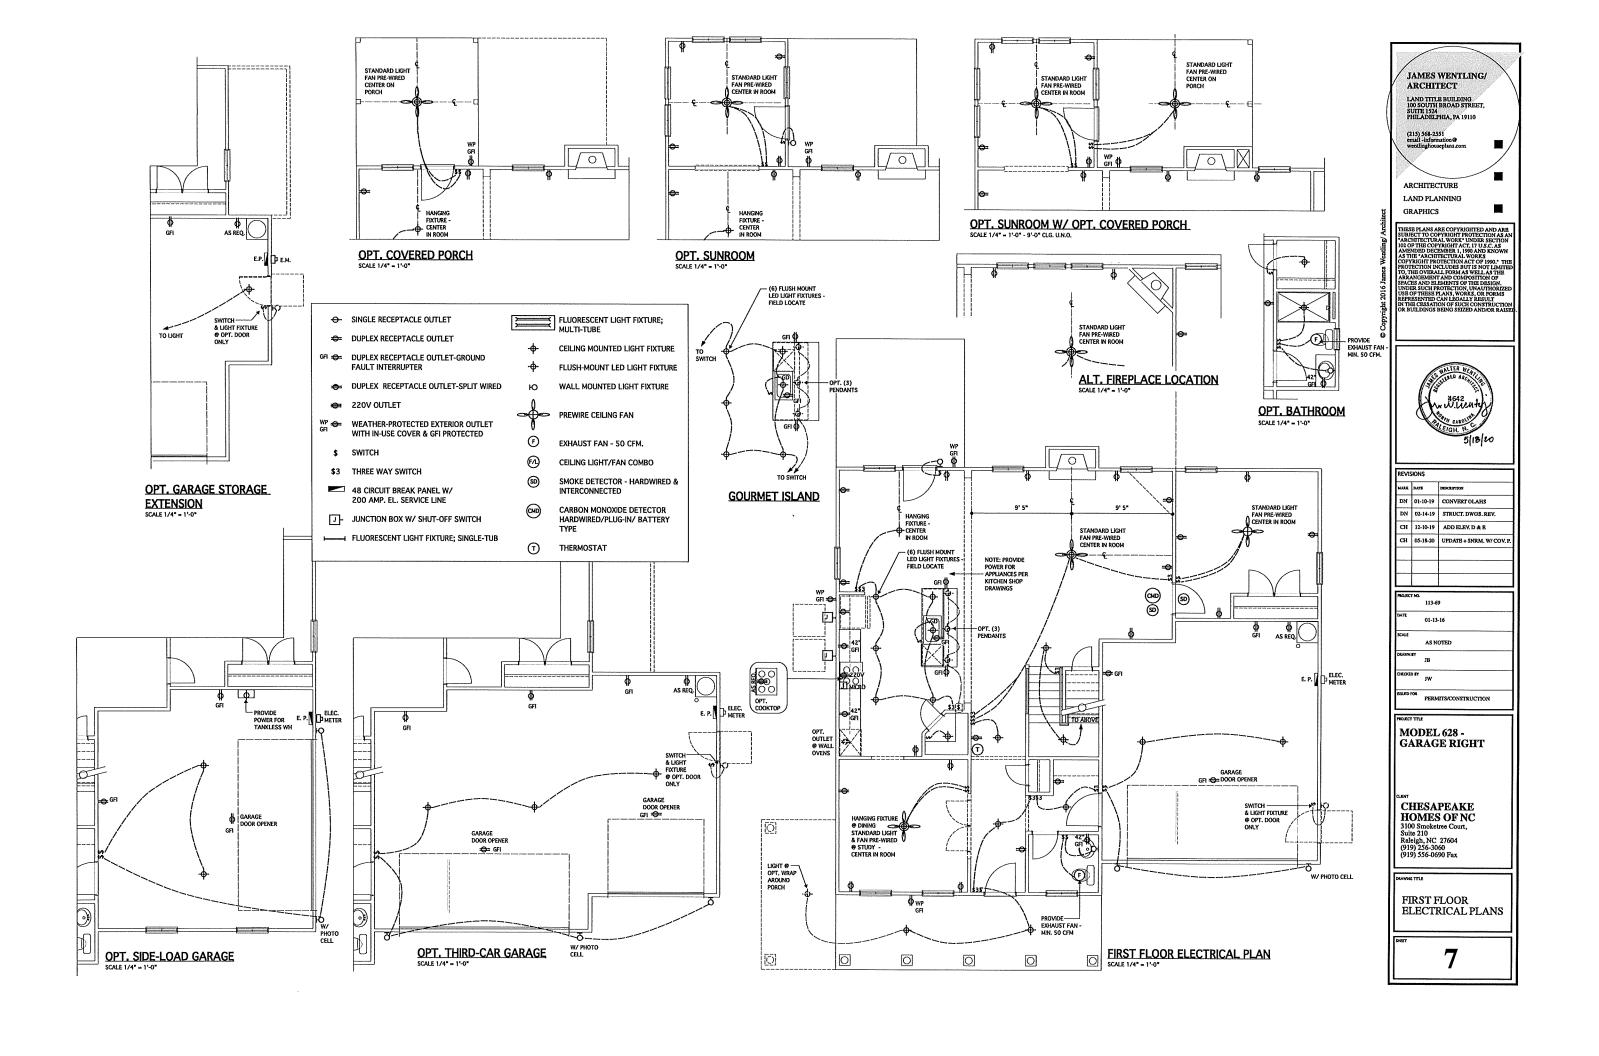

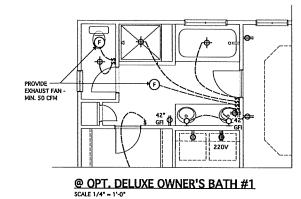

(e) ______

@ ELEV. D SCALE: 1/4" = 1'-0"

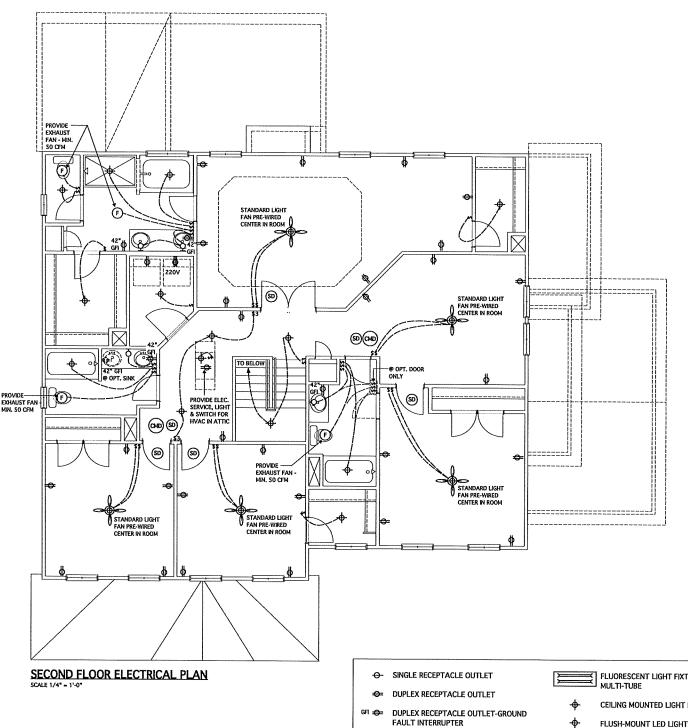

➡ DUPLEX RECEPTACLE OUTLET-SPLIT WIRED

⊕ 220V OUTLET

WEATHER-PROTECTED EXTERIOR OUTLET WITH IN-USE COVER & GFI PROTECTED

\$ SWITCH

\$3 THREE WAY SWITCH

48 CIRCUIT BREAK PANEL W/ 200 AMP, EL. SERVICE LINE

J- JUNCTION BOX W/ SHUT-OFF SWITCH

FLUORESCENT LIGHT FIXTURE; SINGLE-TUB

FLUORESCENT LIGHT FIXTURE;
MULTI-TUBE

CEILING MOUNTED LIGHT FIXTURE FLUSH-MOUNT LED LIGHT FIXTURE

WALL MOUNTED LIGHT FIXTURE

PREWIRE CEILING FAN

Ð EXHAUST FAN - 50 CFM,

FΛ CEILING LIGHT/FAN COMBO SMOKE DETECTOR - HARDWIRED & INTERCONNECTED

CARBON MONOXIDE DETECTOR HARDWIRED/PLUG-IN/ BATTERY

Ŧ THERMOSTAT JAMES WENTLING/ ARCHITECT

LAND TITLE BUILDING 100 SOUTH BROAD STREET, SUITE 1524 PHILADELPHIA, PA 19110

LAND PLANNING GRAPHICS



DN 01-10-19 CONVERT OLAHS DN 02-14-19 STRUCT. DWGS, REV. CH 12-10-19 ADD ELEV. D & E CH 05-18-20 MINOR UPDATE 113-69 01-13-16

PERMITS/CONSTRUCTION

MODEL 628 -GARAGE RIGHT

CHESAPEAKE HOMES OF NC

3100 Smoketree Court, Suite 210 Raleigh, NC 27604 (919) 256-3060 (919) 556-0690 Fax

SECOND FLOOR **ELECTRICAL PLANS**

STRUCTURAL NOTES No (2018 NORO), Plandi 115-120 mph

- BIGNEER'S SEAL APPLES ONLY TO STRICTURAL COMPONENTS INCLIDING ROOF RAFTERS, INFS VALLEYS, RIDGES, FLOORS, MALLS, BEANS AND HEADERS, COLLING, CAMILLEYERS, CHEEL LAOD BEANS MALLS, PER I GENERAL SYSTEM, FOOTHS, AND FLOOR SYSTEM BIGNEER'S SEAL DOES NOT CENTER TO HERBICANAL ACCURACY OR NACHITECTURAL LAYOUT INCLIDING ROOF SYSTEM, ALL REGULATEDING FOR PROFESSIONAL CENTER/CAND SHALL BE PROVIDED BY

- COSINGTION PROVIDE AND THE BILLING CODE.

 DESIGN LOADS (LISTED AS LIVE LAAD, READ LOAD) DEPLECTION

 ROOSE OTHER THAN ELEPTING ROOSES (AD PET, 10 PST, L'260)

 ATTIC HITTER STANSE (AD PST, 10 PST, L'260)

 ATTIC HITTER STANSEN (STANG (20 PST, 10 PST, L'260)

 ATTIC HITTER STANSEN (STANG (20 PST, 10 PST, L'260)

 ATTIC HITTER STANSEN (STANG (20 PST, 10 PST, L'260)

 EXTERNOR BALCONES (60 PST, 10 PST, L'260)

 EXCESSOR BALCONES (60 PST, 10 PST, L'260)

 EXCESSOR BALCONES (60 PST, 10 PST, L'260)

 PASSENSER VISICLE GARAGES (50 PST, 10 PST, L'260)

 FREE ESCANSE VISICLE GARAGES (50 PST, 10 PST, L'260)

 SKON (20 PST)

- WALLS SHALL BE BRACED BY SHEATHING HALLS ON ALL STORIES HITH MOOD STRUCTURAL PANELS, SEE FRAMING HOTES FOR THICKNESS AND WAILING REGURDHEITS. SEE APPENDIX H (DCA6) FOR EXTERIOR DECK REQUIREMENTS INCLIDING ATTACHMENTS FOR LATERAL LOADS.
- 6. CONCRETE SHALL HAVE A HARMM 20 DAY STRENGTH OF 5000 PSI AND A HAVSHAM SLIMP OF 5 NOTES INLESS NOTES OFFENSES (NO). AR BITRANED FER YABLE 4022, ALL CONCRETE SHALL BE PROPORTICADE, NOBES, INACES, SHALL BE TAKEN FROM THE EXIT END OF THE PARK CONTROL AND TAKEN TO SHALL BE TAKEN FROM THE EXIT END OF THE PARK CONTROL ADDITION IN SHAD SHALL BE SHACED AN ORD OF 1-50 THE SHALL BETT OF THE THE SHALL BETT OF THE THE SHALL BETT OF THE THE OFFENSES OFFENSES SHALL BE SHALL BETT OF THE THE SHALL BETT OF THE THE OFFENSES OFFENSES SHALL BETT OF THE THE OFFENSES OFFENSES SHALL BETT OF THE THE OFFENSES OFFENSES SHALL BETT OFFENSES OFFENSES OFFENSES SHALL BETT OFFENSES OFFENSES OFFENSES SHALL BETT OFFENSES OFFENS
- ALL FRANCE LIMBER SHALL BE SET \$2 (Fb = 615 PS) INLESS HOTED OTHERRISE (IND), ALL
 TREATED LIMBER SHALL BE SYP # 2. PLATE HATERIAL HAY BE SEF # 3 OR SYP #3 (Fc(perp)
 425 PS HN).
- L.V.L. SHALL BE LAMINITED VEHEER LIMMER. Rh-2600 PSI, Fn-260 PSI, Fn-1850 PSI.
 PSIL. SHALL BE PARALLE. STRAND LIMBER. Rh-2600 PSI, Fn-260 PSI, En-2600 PSI.
 LSIL. SHALL BE LAMINITED STRAND LIMBER. Rh-2620 PSI, Fn-400 PSI, En-18540 PSI.
 NSTALL ALL COMECTICIS PER HAMFACTIREPS INSTRUCTIONS.
- 10. ALL ROOF TRIES AND I-JOIST LAYOUTS SHALL BE PREPARED IN ACCORDANCE HITH THE SEALED STRICTURAL DRAWNINGS TRUSSES AND I-JOISTS SHALL BE RETALLED ACCORDANG THE HAMEACHIRES SERVICATIONS, ANY CHANGE IN TRUSS OR I-JOIST LAYOUT SHALL BE COORDINATED WITH SOUTHERN ENGINEERS.
- ALL STRUCTURAL STEEL SHALL BE ASSILT A-50. STEEL BEAMS SHALL BE SHIP ORTED AT EACH BUT STEEL SHALL BEAMS SHALL BE SHALL BE ASSILTED AS SHALL BE ASSILTED.
- REBAR SHALL BE DEFORMED STEEL, ASTINGS, GRADE 60. LAP ALL REBAR SPLKES 30 BAR DIAMETERS.
- B. FLITCH BEAMS SHALL BE BOLTED TOGETHER USING (2) ROWS OF 1/2" PIAMETER BOLTS (ASTM AS2) HITM HASHESS FLACED INDER THE THEADED BID OF BOLT, BOLTS SHALL BE SPACED AT 24" O.C. (MAX), AND STAGESED AT THE TOP AND BOTTOM OF BEAM (2" BOSE DISTANCE), WITH 2 BOLTS LOCATED AT 6" FROM EACH BD.
- . BRUCK LINTELS (HEN REQUIRED) SHALL BE 3 V2\\(S) V2\\(V4\)\(V4\)\(V5\)\(V4\)\(V5\)\(V6\)\(V

FRAMING NOTES NC (2018 NCRC): Wind: 115-120 mph

- BRACHS HETHOR AND TITE. CANTRUCKLY SEATHED HER, CS-HEP.
 HOTE THAT THE HALL BRACHS AND IT PROVIDED ON HE FLANS
 HALL BRACHS REGIMEN TO SECTION PROVIDED ON SECURIOR SEE
 HOTE BELON FOR DETAILS AND SPECIFICATIONS FOR INALL
 BRACHS AND HALL RAWNES.
- Exterior Mall Sharing, Malls Shall be Braced by Sheatings Malls on all stores with mode strictura. Parel sheating 6499 (2009) Ere 1767, 1900-2018 C. 19327; Sheatings Shall be attached with ad Mals at a 6/12? Walling Pattern (6/10) of at Parel 1908-3 MD 12° Cat A fine-eduate Supports). Install Blocking at all parel 19063.
- 3. HEP SHATINIS SHALL DATED TO THE IPPERVOST DOUBLE BEARING PLATE, BLOCK AT ROOF PER SECTION REQUIDED AN ATTACH PRACED HALLS FER COSE, HEY SHATINISH SHETTENEN FLOORS SHALL BE SPLICED ALONG COMMUNICATION ON THE HEP SHATINISH HAY BE SPLICED ALONG SHOUSD, COMMUNICATIONS FLOOR STOTED HIT BLOCKING AT PAREL EDGES, (MERCHA 12" BETOND FLOOR SHEAK) OR OTHER APPROVED HERIDO.
- 180° » HOLDOMA, HOLD-DOWN DRYCE (NOTED AS 180° ON PLANS) SHALL BE AN BOO PRADO CAPACITY ASSERBLY AS NOTED ON PLANS, SEE DETAILS FOR ID ASSERBLY, AS NOTED ON PLANS, "MSGAND/PREST PLOOR," USE 11D HOLD-DOWN DETAIL" ON 50 SHEET (OR BOAY)
- (OR EGIN)

 "IMPER ELOOPS, ATTACH BASE OF KING STILD HITH A SIMPSON C522
 STRAY DOWN ACROSS THE BAND AND DOWN TO A STILD BELOW OR
 HEADER BELOW, EXTREM STRAY IT WAN ALONG EACH STILD (OR
 HEADER BELOW, EXTREM STRAY IT WAN ALONG EACH STILD (OR
 HEADER) AND ATTACH EACH BID W (1) BO WALS.
- NITERIOR BRACED HALL, (NOTED AS "BM" OH PLANS) ATTACH (V2" 6YPSIM BOARD (68) ON EACH SIDE OF INALL NITH A MIL OF 50 COCLER HALE OR NO SCREMS 0 1" OZ. ALCHS THE EIGHES AND AT NITER-EDIATE SUPPORTS. INTERIOR BRACED HALL HOOD STRUCTURAL PAREL (MOTED AS "BHASE" ON PLANS), ATTACH ONE SIDE HITH X'S MEY STEATINGS HITH MIST HALL BOOKES AT A 61/2" MALLING PATTERN (6" CC AT PAREL BOOKS AND 12" CC AT MISTREPANTE SEPPORTIS). SINCILL BLOCKING AT ALL PAREL BOOKS, ATTACH 69 OVER MEY AS REQUIRED, ATTACH OPPORTE SIDE HITH 10" 69 HITH A MIN OF SI COOLER MUSS OR 46 SCRENG OF THE CALONIC HIT AND THE MISTREPORTATE.

HEADER/BEAM & COLUMN NOTES

- I. ALL EXTERIOR AND LOAD BEARING HEADERS SHALL BE HER (2)26 (4" HALL) OR (8)26 (6" HALL) HITH (1) SUPPORT STUD, UNLESS NOTED OTHERWISE.
- DIRECTION OF SHAPE SHAPE

TRUSS SYSTEM REQUIREMENTS No (2018 NORC): Wind: 115-120 mph

- TRUSS SYSTEM LAYOUTS (PLACEMENT PLANS) SHALL BE DESIGNED IN ACCORDANCE HITH SEALED STRUCTURAL PLANS, MY NEED TO CHANGE TRUSSES SHALL BE COORDINATED WITH SOUTHERN
- TRUSS SCHENATICS (FROFILES) SHALL BE PREPARED AND SEALED BY TRUSS MANUFACTURER
- ALL TRUSSES SHALL BE DESIGNED FOR BEARING ON SPF 92 OR #3 PLATES OR LEDGERS (ANO).
- ALL REGURDED ANCHORS FOR TRUSSES DUE TO UPLIFT OR BEARING SHALL MEET THE REGURDENENTS AS SPECIFIED ON THE TRUSS

- PORCH POST NOTES:

 4 MM (6x8) TRITP POST (OR EQUA.).

 4 ATTACH INSEES (MATTERS) AT PORCH HITH HERICANE CONNECTIONS.

 1 POST CASE SPINSON ACHAN (ACCHAN)

 2 POST CAP AT CORNERS (2) 59495ON LOZA (FILE MATTER) ADD (1) 5445ON LOZA (FILE MATTER) ADD (2) 5445ON LOZA (FILE MATTER) ADD

- MITER HEADER AT CORRECT, HIGH MIDD, ADD (I) SEPSON HIS.


 5. EOST BASS, SHPSCH ABUH (ABUK),

 5. LOST BASS, TAKHOR (BHED T)


 5.1. LOSD, N. MACHOR (BHED T)

 5.2. LOSD, N. MACHOR (BHED T)


 6. EOST BASS, HOOD KOADATICAL (I) SHPSCH CRIS BASS, HOOD KOADATICAL (I) SHPSCH CRIS BASS, HOOD KOADATICAL (I) SHPSCH CRIS BTASS AT ROSTS, ENTED 12' CATIO EACH FOST (IPPER AND LOVER) OR TO GIRDER.
- HOTE, EQUIVALENT POST CAP AND BASE

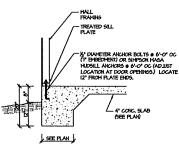


MONOLITHIC SLAB FOOTING (SIDING OR EQUAL)

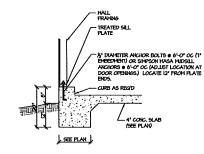



MONOLITHIC SLAB @ GARAGE (SIDING OR EQUAL)

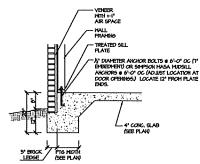


MONOLITHIC SLAB FOOTING MENERY

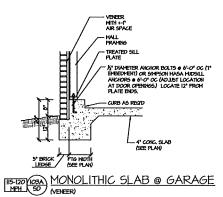

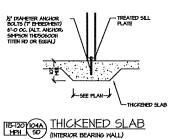

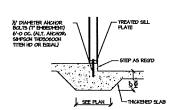

THICKENED SLAB @ GARAGE (INTERIOR SARAGE WALL)

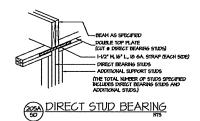

HTT4 HOLDONN H-B-Mda-VZ WAS

Ħ

Appear | Feet |

/~# 2x PLANE

STATE HATE

STATE STATE

STATE STATE

STATE STATE

STATE STATE STATE

STATE STATE

STATE STATE

STATE STATE

STATE STATE

STATE

STATE

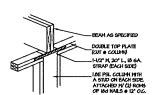


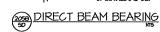

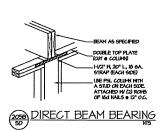


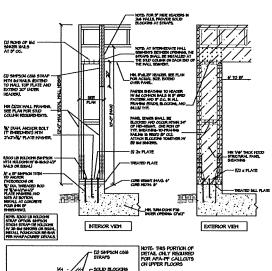

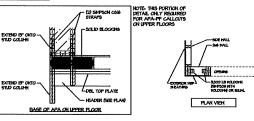

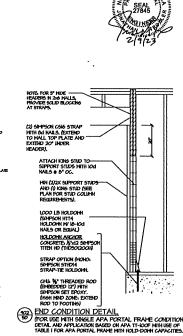


BEVATION (50) APA PORTAL FRAME W HOLD-DOWNS
50 DETAIL AND APPLICATION BASED ON APA TI-LOOF NITH USE
OF TABLE I FOR APA PORTAL FRAME WITH HOLD-DOWN
CAPACITIES.

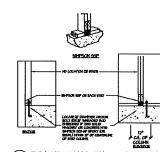


APA PORTAL FRAME W HOLD-DOWNS
DETAIL AND APPLICATION BASED ON APA TIT-DOOF MITH USE
OF TABLE I FOR APA PORTAL FRAME MITH HOLD-DOWN

SIMPSON HTT4 SIMPSON STHOIA

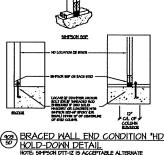

SENDER HE HE OF THE ABOVE THE ABOVE

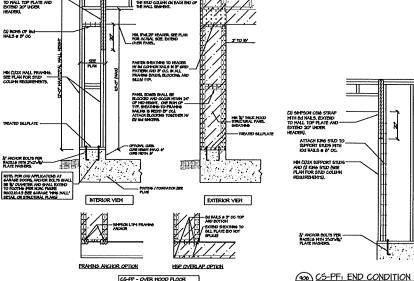

(GS) CS-PF: CONTINUOUS PORTAL FRAME CONSTRUCTION
(SO) DETAIL AND APPLICATION BASED ON ICER FIGURE
REGOLD 1 - PORTAL FRAME CONSTRUCTION

(SD) CS-PF: END CONDITION DETAIL FOR USE WITH SHELE CS-PF CONDITION DETAIL AND APPLICATION BASED ON INFAC FIGURE REOLIDI - PORTAL PRANE CONSTRUCTION

are to be brought to the seal. tions

PROIECT#

Multiple

only to struc Engineers seal al document
Seal does not in sequences, proce
Any deviations or immediate atten void Southern E
Seal is valid for I
Use of these plat defined in the cu

P.A. 27609

uthern Engineers, I 6 Benson Drive, Raleigh, NC 2 Phone: (919) 878-1617 License: C-4772 uthern 3716 ō Š

'entling, Architect 8 James

> ofNC otes Homes

Detail tandard and Ğ Š

SD-1 MONO