GENERAL FOUNDATION NOTES:

1. THIS PLAN DESIGNED IN ACCORDANCE WITH THE NORTH CAROLINA RESIDENTIAL BUILDING CODE, 2018 EDITION.

2. WALL FOOTING TO BE A MINIMUM OF 16" WIDE AND CONSTRUCTED WITH 3000 PSI CONCRETE. FOR FOUNDATION WALL HEIGHT, THICKNESS AND BACKFILL REQUIREMENTS REFER TO STATE AND LOCAL BUILDING CODES. THE ASSUMED SOIL BEARING CAPACITY FOR THIS PROJECT IS 2000 PSF. THE CONTRACTOR MUST VERIFY THE SITE CONDITIONS AND CONTACT A SOILS ENGINEER IF MARGINAL OR UNSTABLE SOILS ARE ENCOUNTERED.

3. ALL FOOTINGS SHALL BEAR ON UNDISTURBED SUB-GRADE A MINIMUM OF 12" BELOW ADJACENT FINISHED GRADE OR AS OTHERWISE DIRECTED BY THE LOCAL INSPECTOR.

4. REINFORCING STEEL SHOWN ON THESE DRAWINGS SHALL BE GRADE 60

5. GRANULAR MATERIAL MAY BE NODOT #57 OR #67 STONE, OR VERY COURSE SAND WITH NO FINES. WEEP HOLES SHALL BE INSTALLED AT THE BASE OF THE MASONRY WALL TO ALLOW FOR FREE DRAINAGE OF ANY WATER THAT MIGHT COLLECT BEHIND THE WALL FACE.

6. MINIMUM CLEARANCE ON REINFORCING STEEL SHALL BE $1\frac{1}{2}$ " FROM SIDES AND TOP OF FOOTING AND 3" FROM BOTTOM OF FOOTING.

STRUCTURAL EVALUATION BY:

WILKINS ENGINEERING, P.C. Post Office Box 37446 Raleigh, North Carolina 27627


- Dogus Signer as Wilkins


FILE: HOLLEMAN

*THE ENGINEER'S SEAL AND SIGNATURE APPLY ONLY TO THE STRUCTURAL ELEMENTS OF THIS DOCUMENT. ENGINEER'S APPROVAL DOES NOT INCLUDE CONSTRUCTION REVIEW, MEANS, METHODS, TECHNIQUES OR SEQUENCES OF CONSTRUCTION OR SAFETY REQUIREMENTS. THE CONTRACTOR IS REQUIRED TO ENSURE PROPER SAFETY PRECAUTIONS.

*ANY DEVIATIONS OR DISCREPANCIES IN THESE DRAWINGS ARE TO BE BROUGHT TO THE IMMEDIATE ATTENTION OF THE ENGINEER AND FAILURE TO DO SO WILL YOID THE ENGINEER'S LIABILITY. CHANGES TO THE DESIGN ARE ONLY ALLOWED WITH THE WRITTEN APPROVAL OF THE ENGINEER.


*DO NOT SCALE THESE DRAWINGS. ENGINEERING APPROVAL EXPIRES IN ONE YEAR,

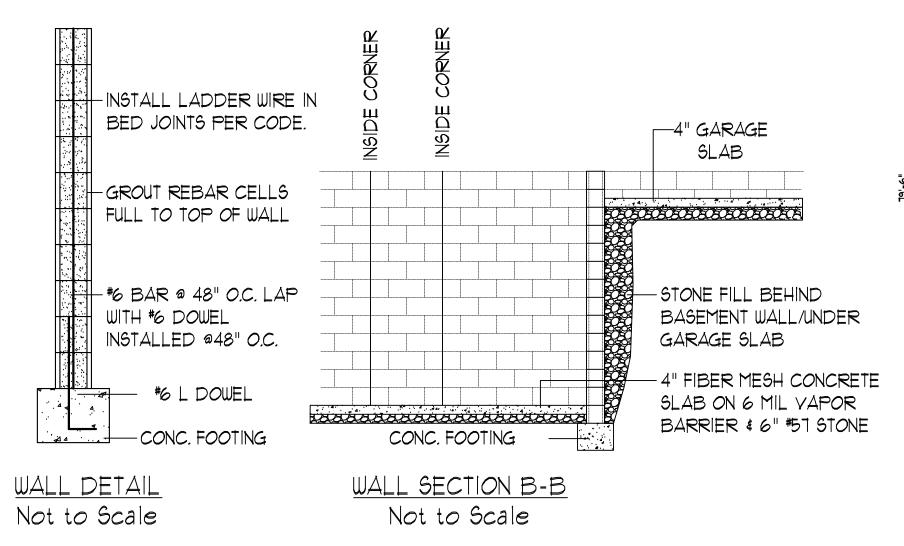

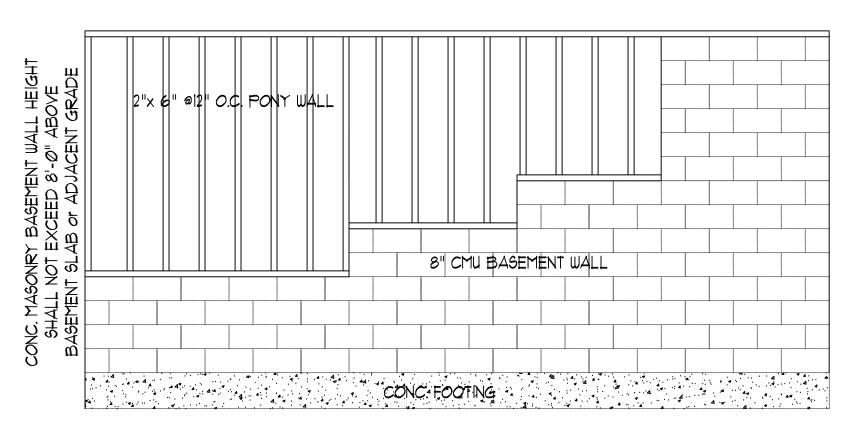

WALL SECTION A-A Not to Scale

THIS BASEMENT/FOUNDATION PLAN REPLACES SHEET SI OF "THE TOPSAIL" PLAN (PROJECT #16-1550 PREPARED BY SOUTHERN ENGINEERS & NAUSET HOMES, LLC. THE REMAINING PLAN SHEETS SHOWING STRUCTURAL ELEMENTS, SECOND FLOOR AND ROOF FRAMING ARE TO BE USED IN CONJUNCTION WITH THIS FOUNDATION AND FIRST FLOOR FRAMING PLAN.

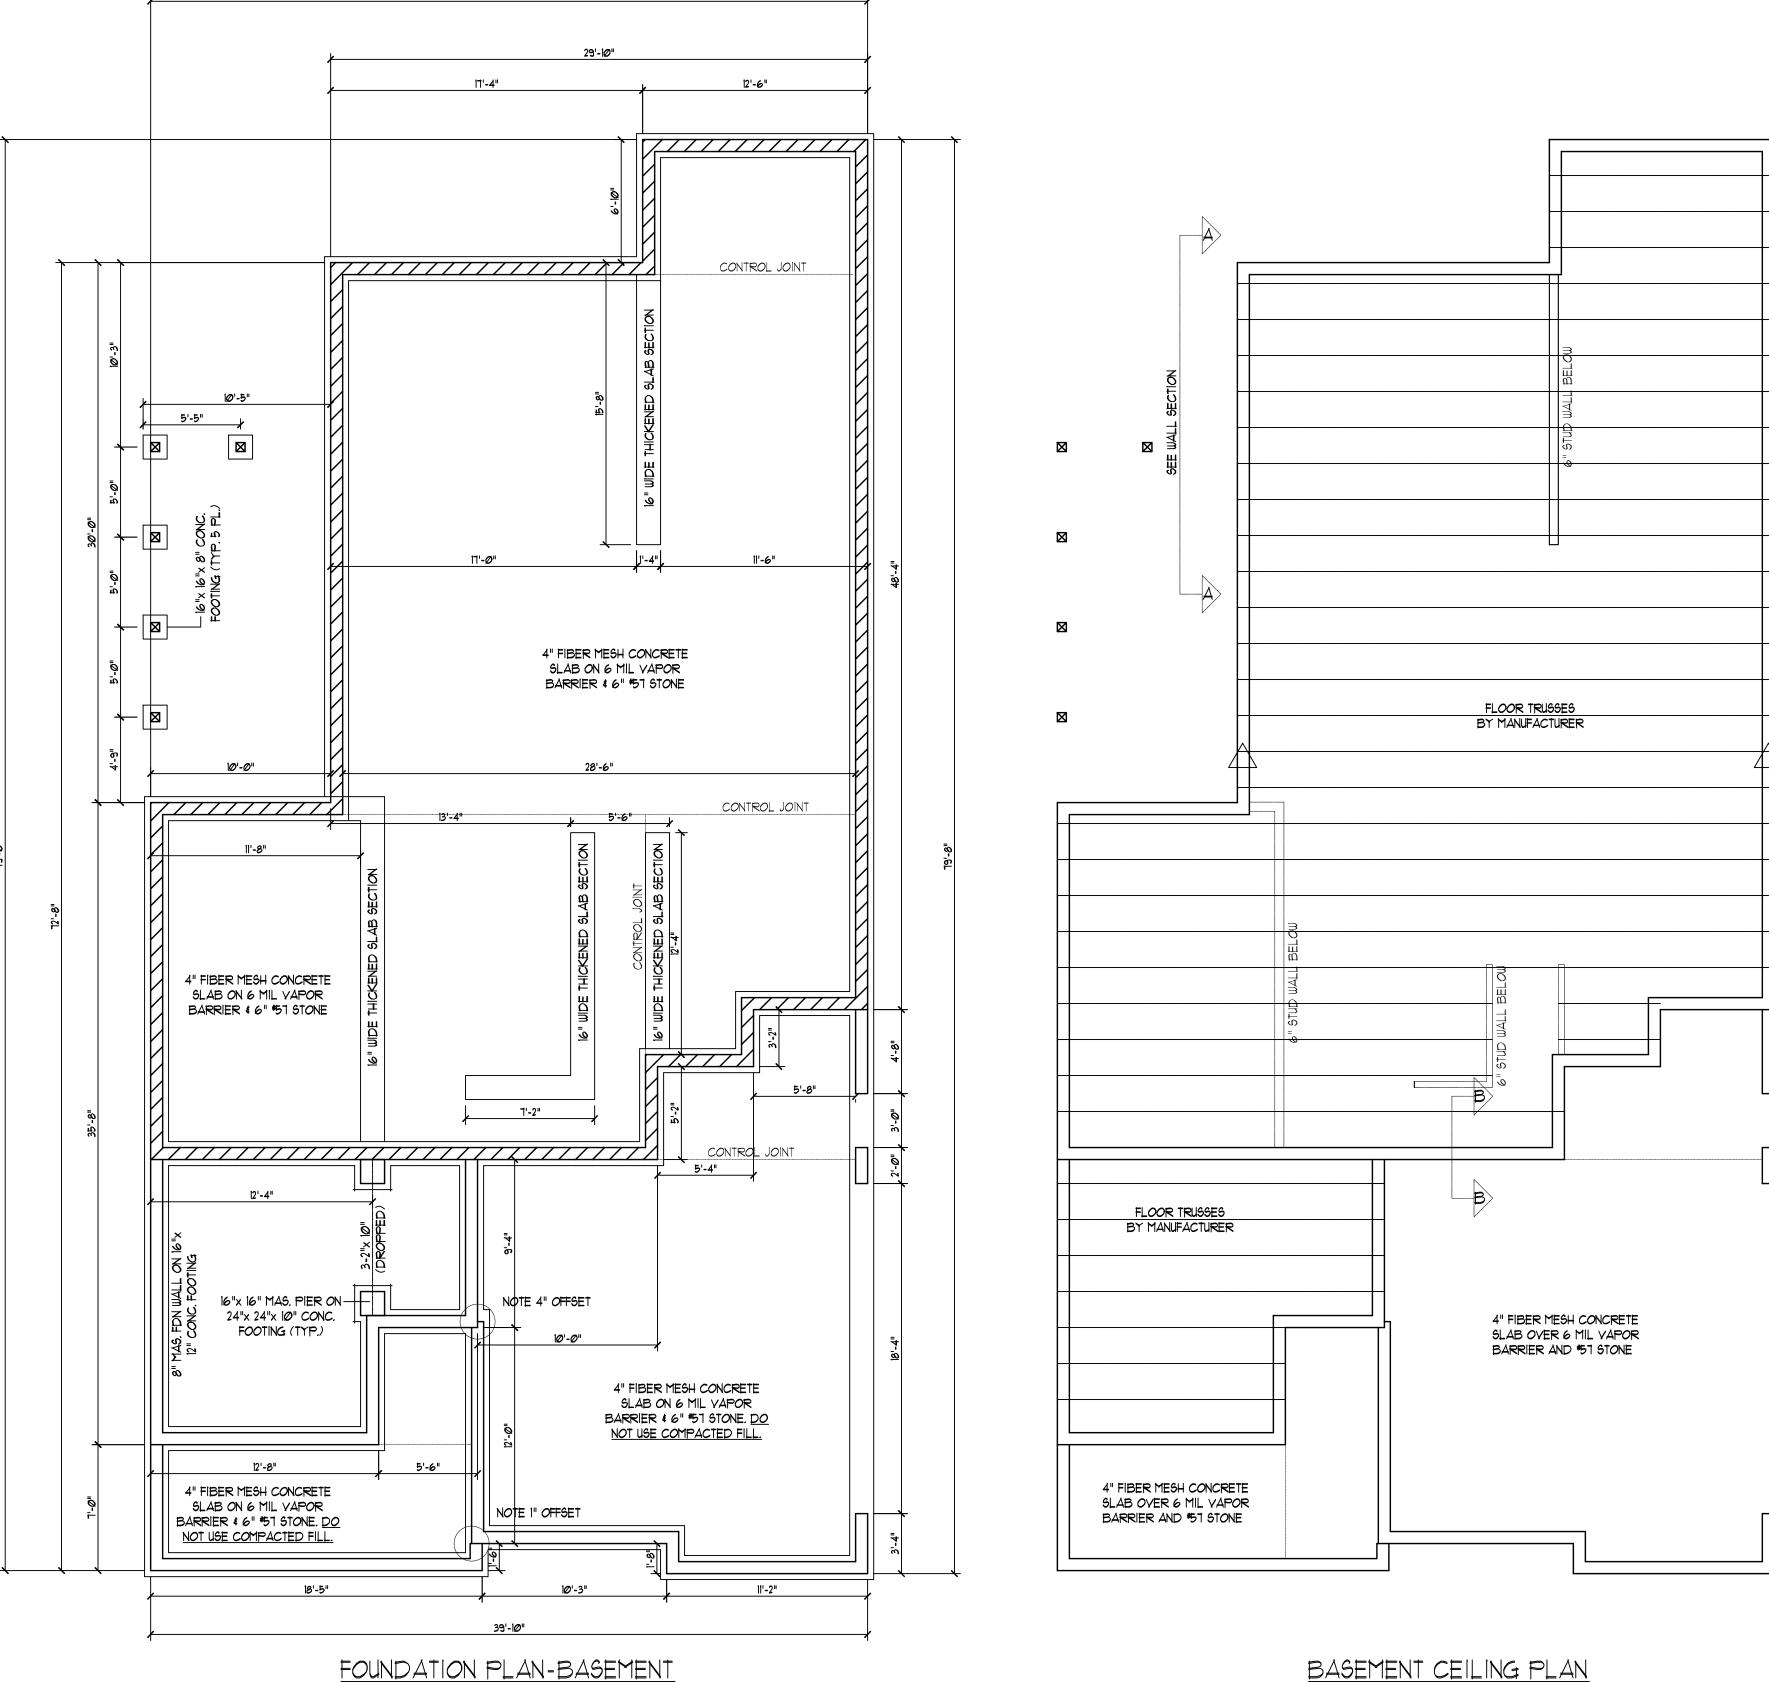

Scale: 3/16"= 1'-0"

Scale: 3/16"= 1'-0"

Sheet No.