

FRONT ELEVATION

Scale: 1/4" = 1'0"

9'0" CEILING HEIGHT FIRST FLOOR (HEADER HEIGHT 7'6") 8'0" CEILING HEIGHT SECOND FLOOR (HEADER HEIGHT 7')

FRAME WINDOWS TO HEADER HEIGHT



LEFT ELEVATION

Scale: 1/8" = 1'0"



REAR ELEVATION

Scale: 1/8" = 1'0"



RIGHT ELEVATION

Scale: 1/8" = 1'0"

PLAN: Taggart

aggart

ELEVATIONS

SHEET TITLE:

PROJECT ADDRESS: 112 Sears Dr. (Lot 24)

Precision Custom Homes
Raeford, NC

DATE:

3/3/23

SCALE:

1/4" = 1'

SHEET:



Precision Custom Hom Raeford, NC n@PrecisionCustomHom


DATE:

3/3/23 SCALE:

1/4" = 1'

SHEET:


A-2

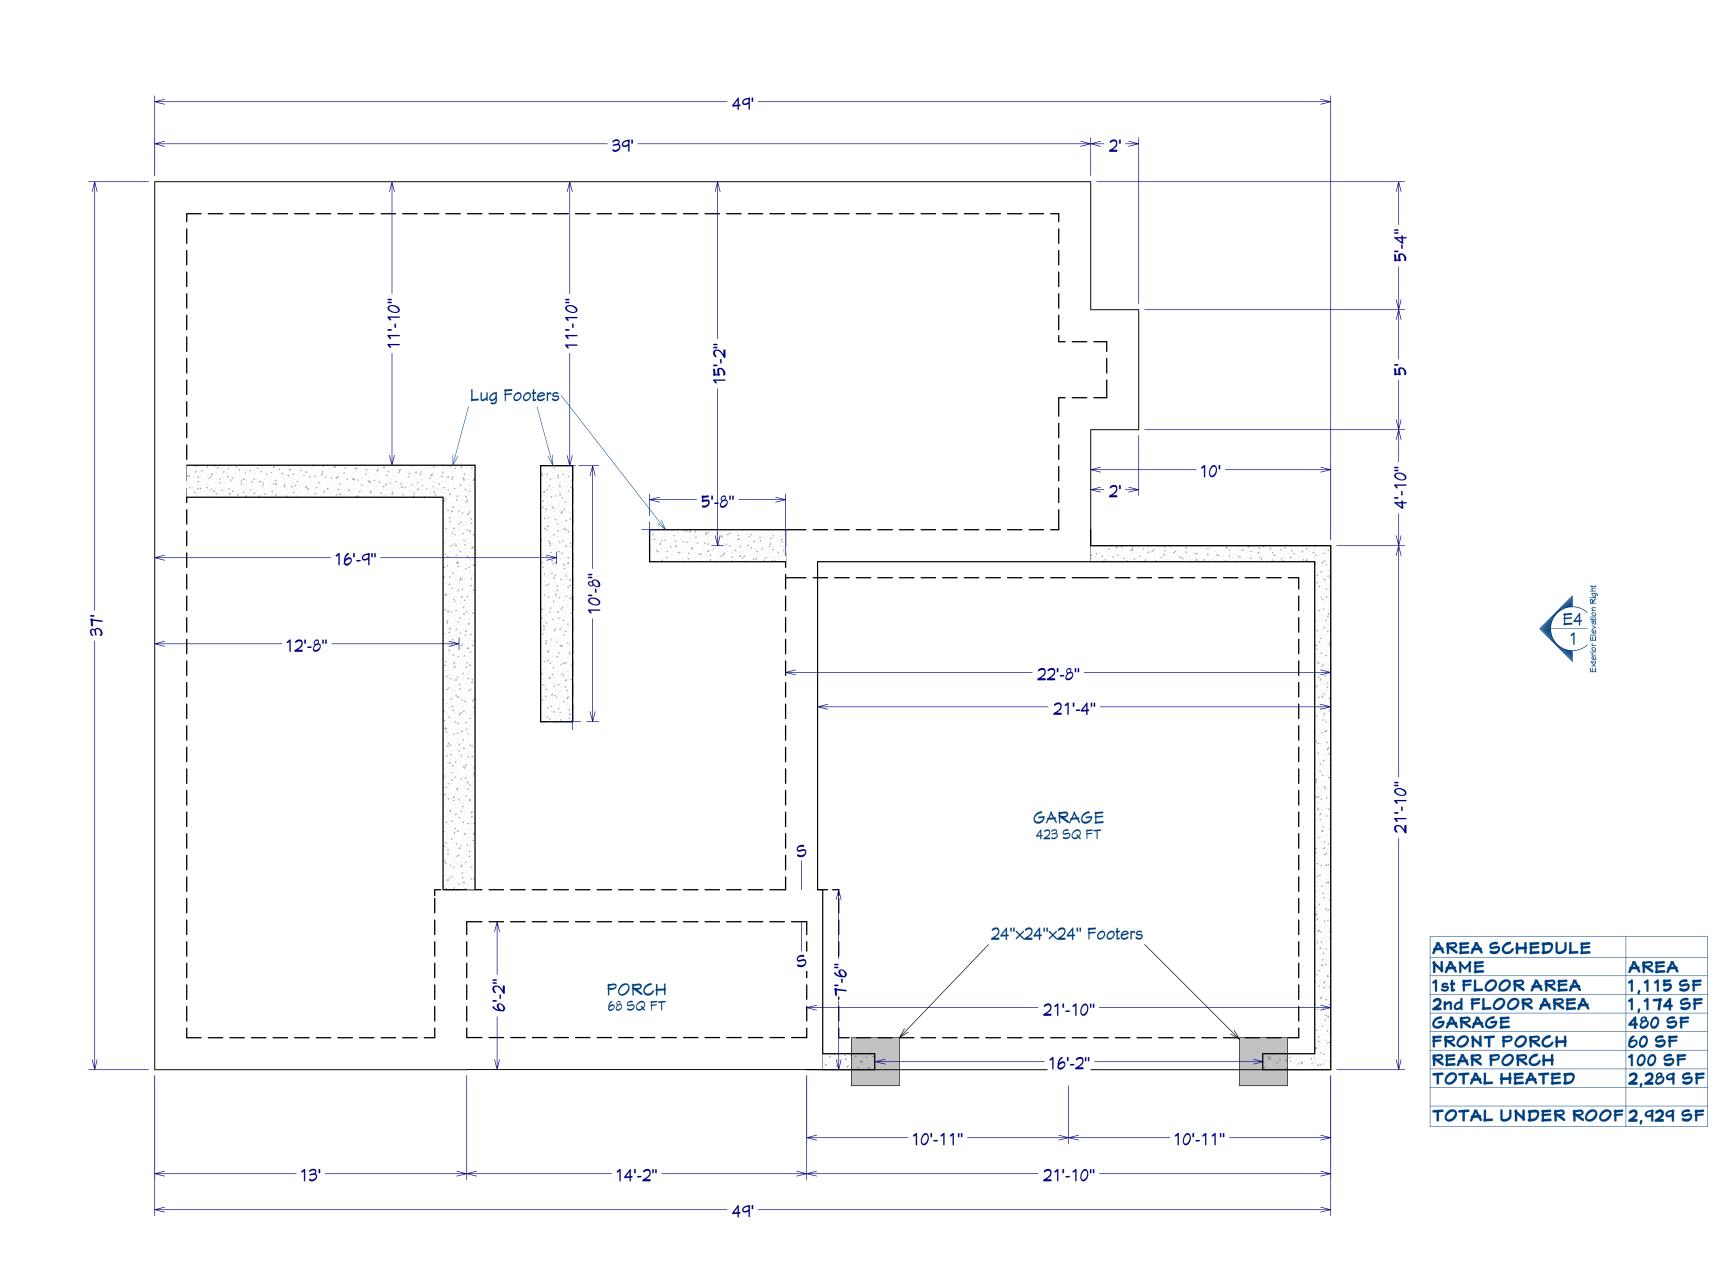

Scale: 1/4" = 1'0"

MONOLITHIC SLAB

-16"→

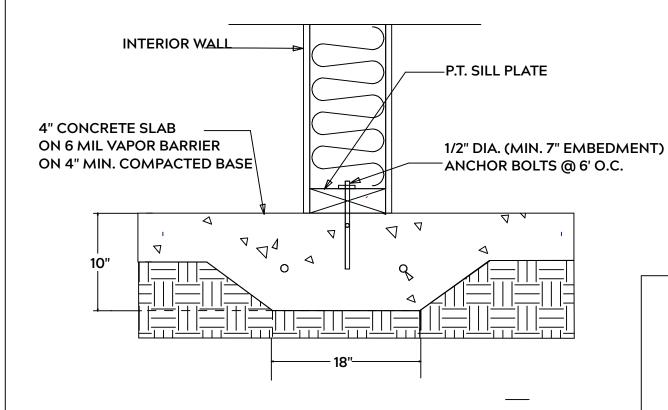

2 X STUDS @ 16" O.C.

SILL SEAL

1/2" DIA. (MIN. 7" EMBEDMENT)

(ADJUST LOCATIONS AT DOOR

LOCATE 12" FROM PLATE ENDS

ANCHOR BOLTS @ 6' O.C.

CODES

4" CONCRETE

SLAB

MOISTURE BARRIER


OPENINGS)

COMPACTED FILL

6 MIL.

INSULATION TO MEET LOCAL

LUG FOOTING

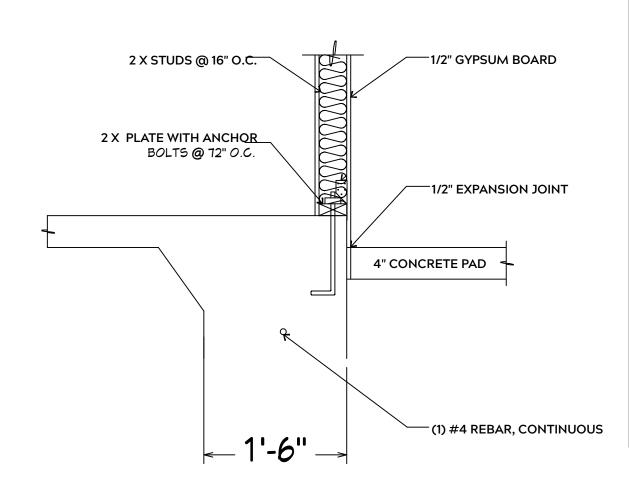


THE 28 DAY COMPRESSIVE STRENGTH OF ALL **FOOTINGS IS 3000 PSI**

PROVIDE WATER PROOFING AND PERIMTER **DRAINS AS REQUIRED**

FOOTING WIDTHS ARE BASED ON A LOAD BEARING SOIL CAPACITY OF 2000 PSI

PROVIDE 6 MIL POLY VAPOR BARRIER TO COVER GROUND IN CRAWL SPACE AND **GROUND UNDER POURED CONCRETE**

ALL ANCHOR BOLTS TO BE 1/2" X 12" LONG. ANCHOR BOLTS SHALL BE SPACED AT A MAXIMUM OF 6' ON CENTER AND NO MORE THEN 1' FROM EACH CORNER

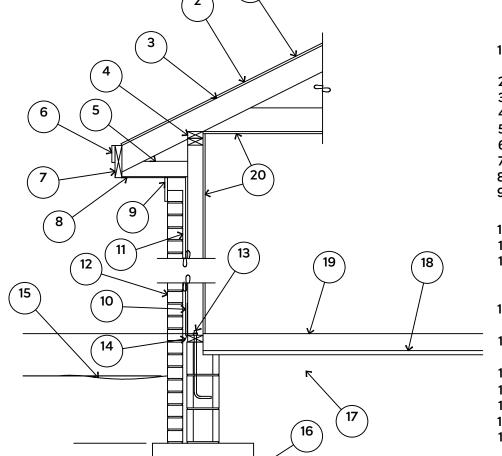

15# FELT UNDERLAYMENT UNDER COMPOSITION SHINGLES.

2. ROOF DECKING.

3. 2 X RAFTERS / ENGINEERED TRUSSES

DOUBLE TOP PLATE.

5. 2 X 4 RETURN. 6. 3/4" FASCIA OR PVC TRIM COIL

7. 2 X FASCIA

1/4" PLYWOOD OR VINYL SOFFIT

9. 1X FREIZE BOARD (TO BE USED WITH **BRICK VENEERS)**

10. INSULATION BOARD OR HOUSE WRAP

11. AIR SPACE.

12 BRICK WITH BRICK TIES PER MANUFACTURER'S SPECIFICATIONS.

13. 1/2" X 12" ANCHOR BOLTS, 6'-0" O.C., 12" FROM CORNERS.

4. FLASHING WITH WEEP HOLES @ 48" O.C.

15. FINISHED GRADE.

16. FOOTING

17. COMPACTED EARTH FILL

18. 6 MIL. VAPOR BARRIER 19. 4" CONCRETE SLAB, 3,000 P.S.I.

WITH 6" X 6" 10 GA. X 10 GA. WELDED WIRE FABRIC.

20. 1/2" GYPSUM BOARD.

EXTERIOR WALL SECTION

GENERAL FRAMING NOTES:

ALL LUMBER IN CONTACT WITH CONCRETE OR MASONRY SHALLE BE PRESSURE TREATED

FRAMING LUMBER SHALL BE SYP #2 GRADE AND / OR SPRUCE PINE FIR #1 AND / OR KILN DRIED

WHERE PRE-ENGINEERED JOISTS AND TRUSSES ARE USED, MANUFACTURER SHALL PROVIDE DRAWINGS / SCHEMATICS, WHICH SHALL BEAR OF A N.C. **ENGINEER**

STUDS AND JOISTS SHALL NOT BE CUT TO INSTALL PLUMBING OR WIRING WITHOUT ADDING METAL OR WOOD SIDE PANELS TO STRENGTHEN MEMBER TO ITS ORIGINAL CAPACITY

NAIL MULTIPLE MEMBERS WITH 2 ROWS OF 16d NAILS STAGGERED 32" O.C. AND USE 3 X 16d NAILS 2" IN AT EACH END.


NAIL FLOOR JOISTS TO SILL PLATE WITH WITH 8d TOE NAILS

ALL EXPOSED FRAMING ON PORCHES OR DECKS SHALL BE PRESSURE **TREATED**

PROVIDE WATERPROOFING AND DRAINS AS REQUIRED

ALL FRAMING TO BE 16" O.C. WALL FRAMING DIMENSIONS ARE BASED ON 2X4 OR 2X6 EXTERIOR WALLS AND 2X4 INTERIOR WALLS. DOULBE / TRIPLE JACK STUDS AS NECESSARY UNDER HEADERS AS REQUIRED

LVL'S TO BE SIZED BY OTHERS (TRUSS MANUFACTURER)

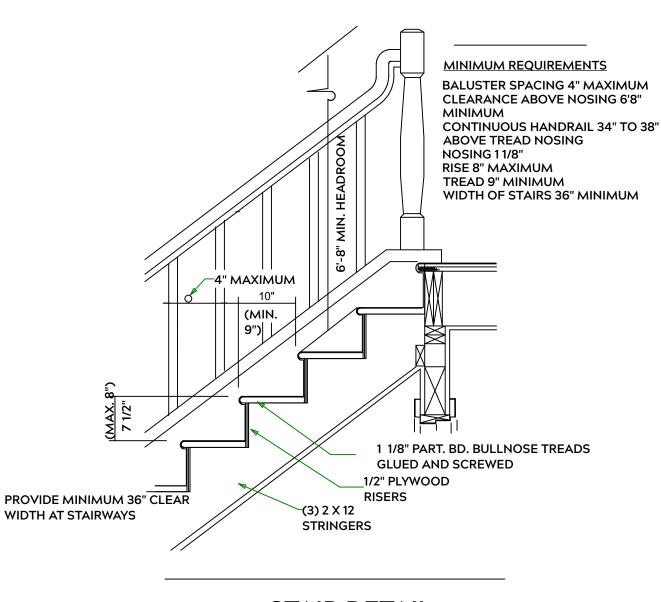

STAIR DETAIL

INTERIOR WALL @ GARAGE STEP DOWN

PLAN: Taggart

> SHEETS AIL

ET

r ADDRESS: Dr. (Lot 24) PROJECT 112 Sears [

Precision Custom Hor Raeford, NC @PrecisionCustomHor

DATE:

3/3/23

SCALE:


1/4" = 1'

SHEET:



1st FLOOR

PROJECT ADDRESS: 112 Sears Dr. (Lot 24)

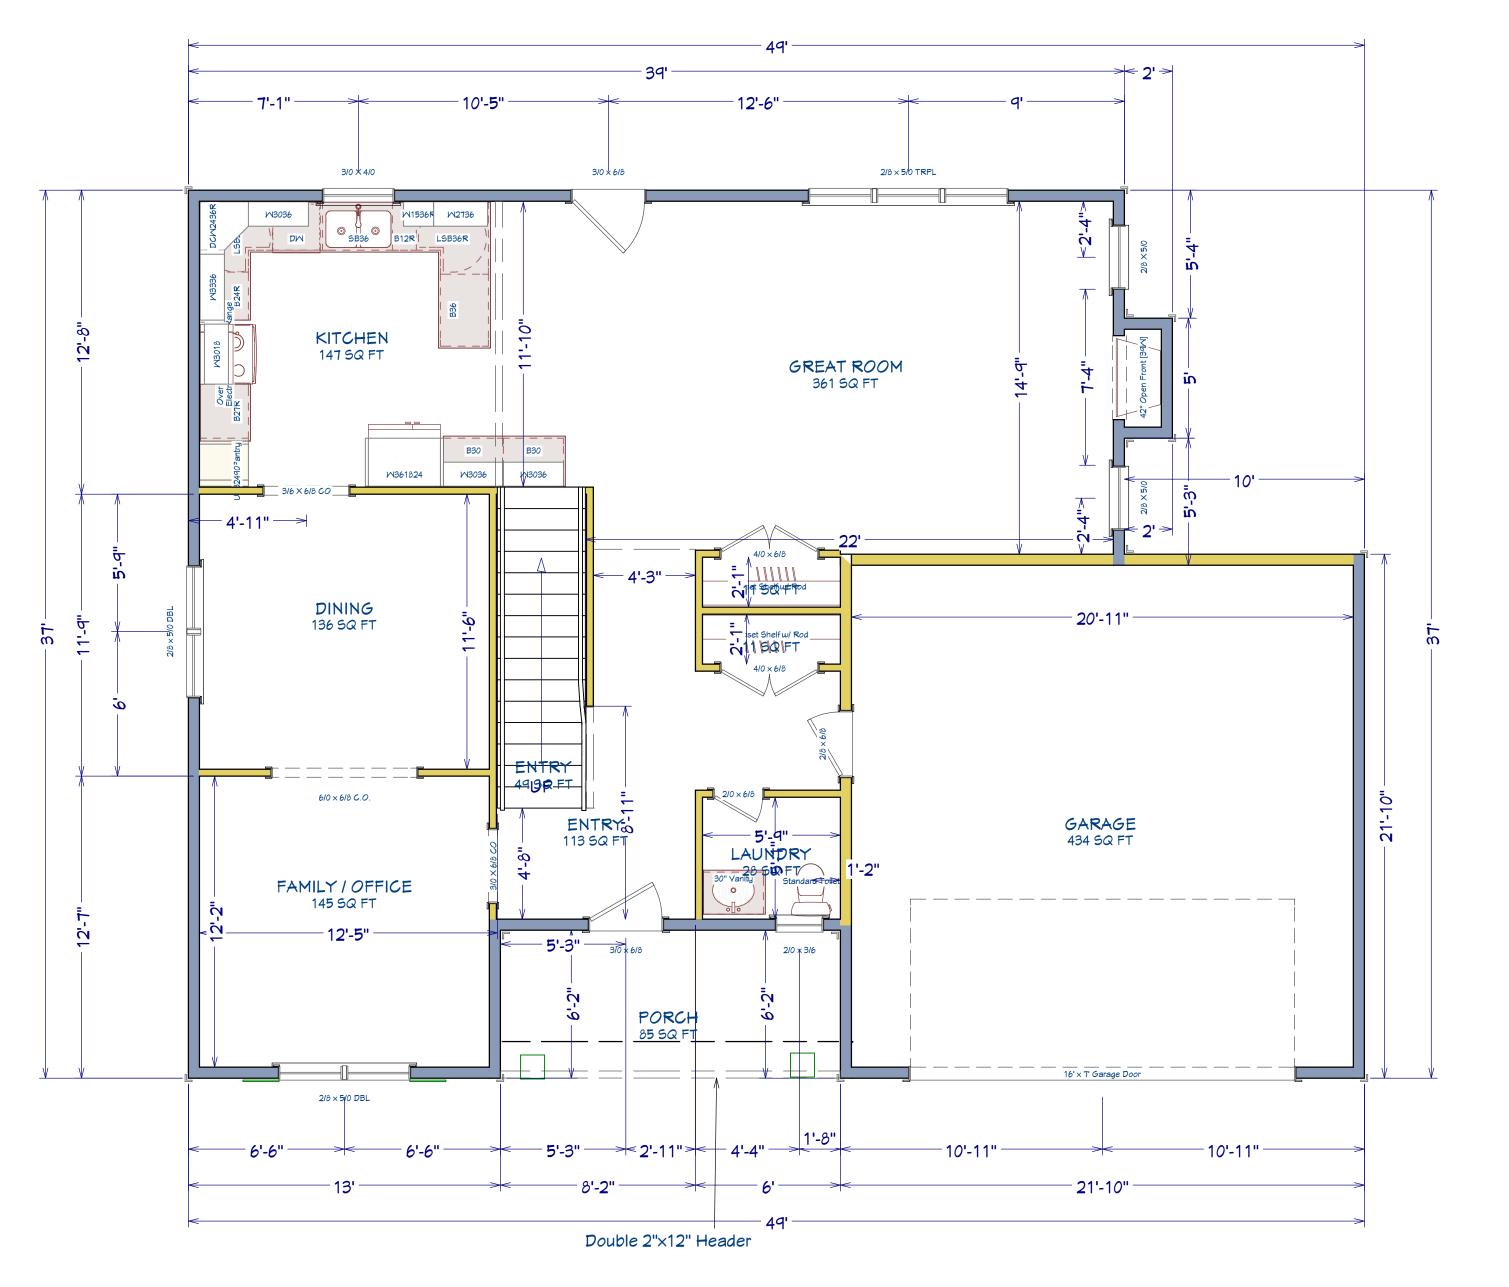



AREA SCHEDULE	
NAME	AREA
1st FLOOR AREA	1,115 SF
2nd FLOOR AREA	1,174 SF
GARAGE	480 SF
FRONT PORCH	60 SF
REAR PORCH	100 SF
TOTAL HEATED	2,289 SF

TOTAL UNDER ROOF 2,929 SF


DATE:

Precision Custom Horr Raeford, NC un@PrecisionCustomHom

3/3/23

SCALE: 1/4" = 1'

SHEET:

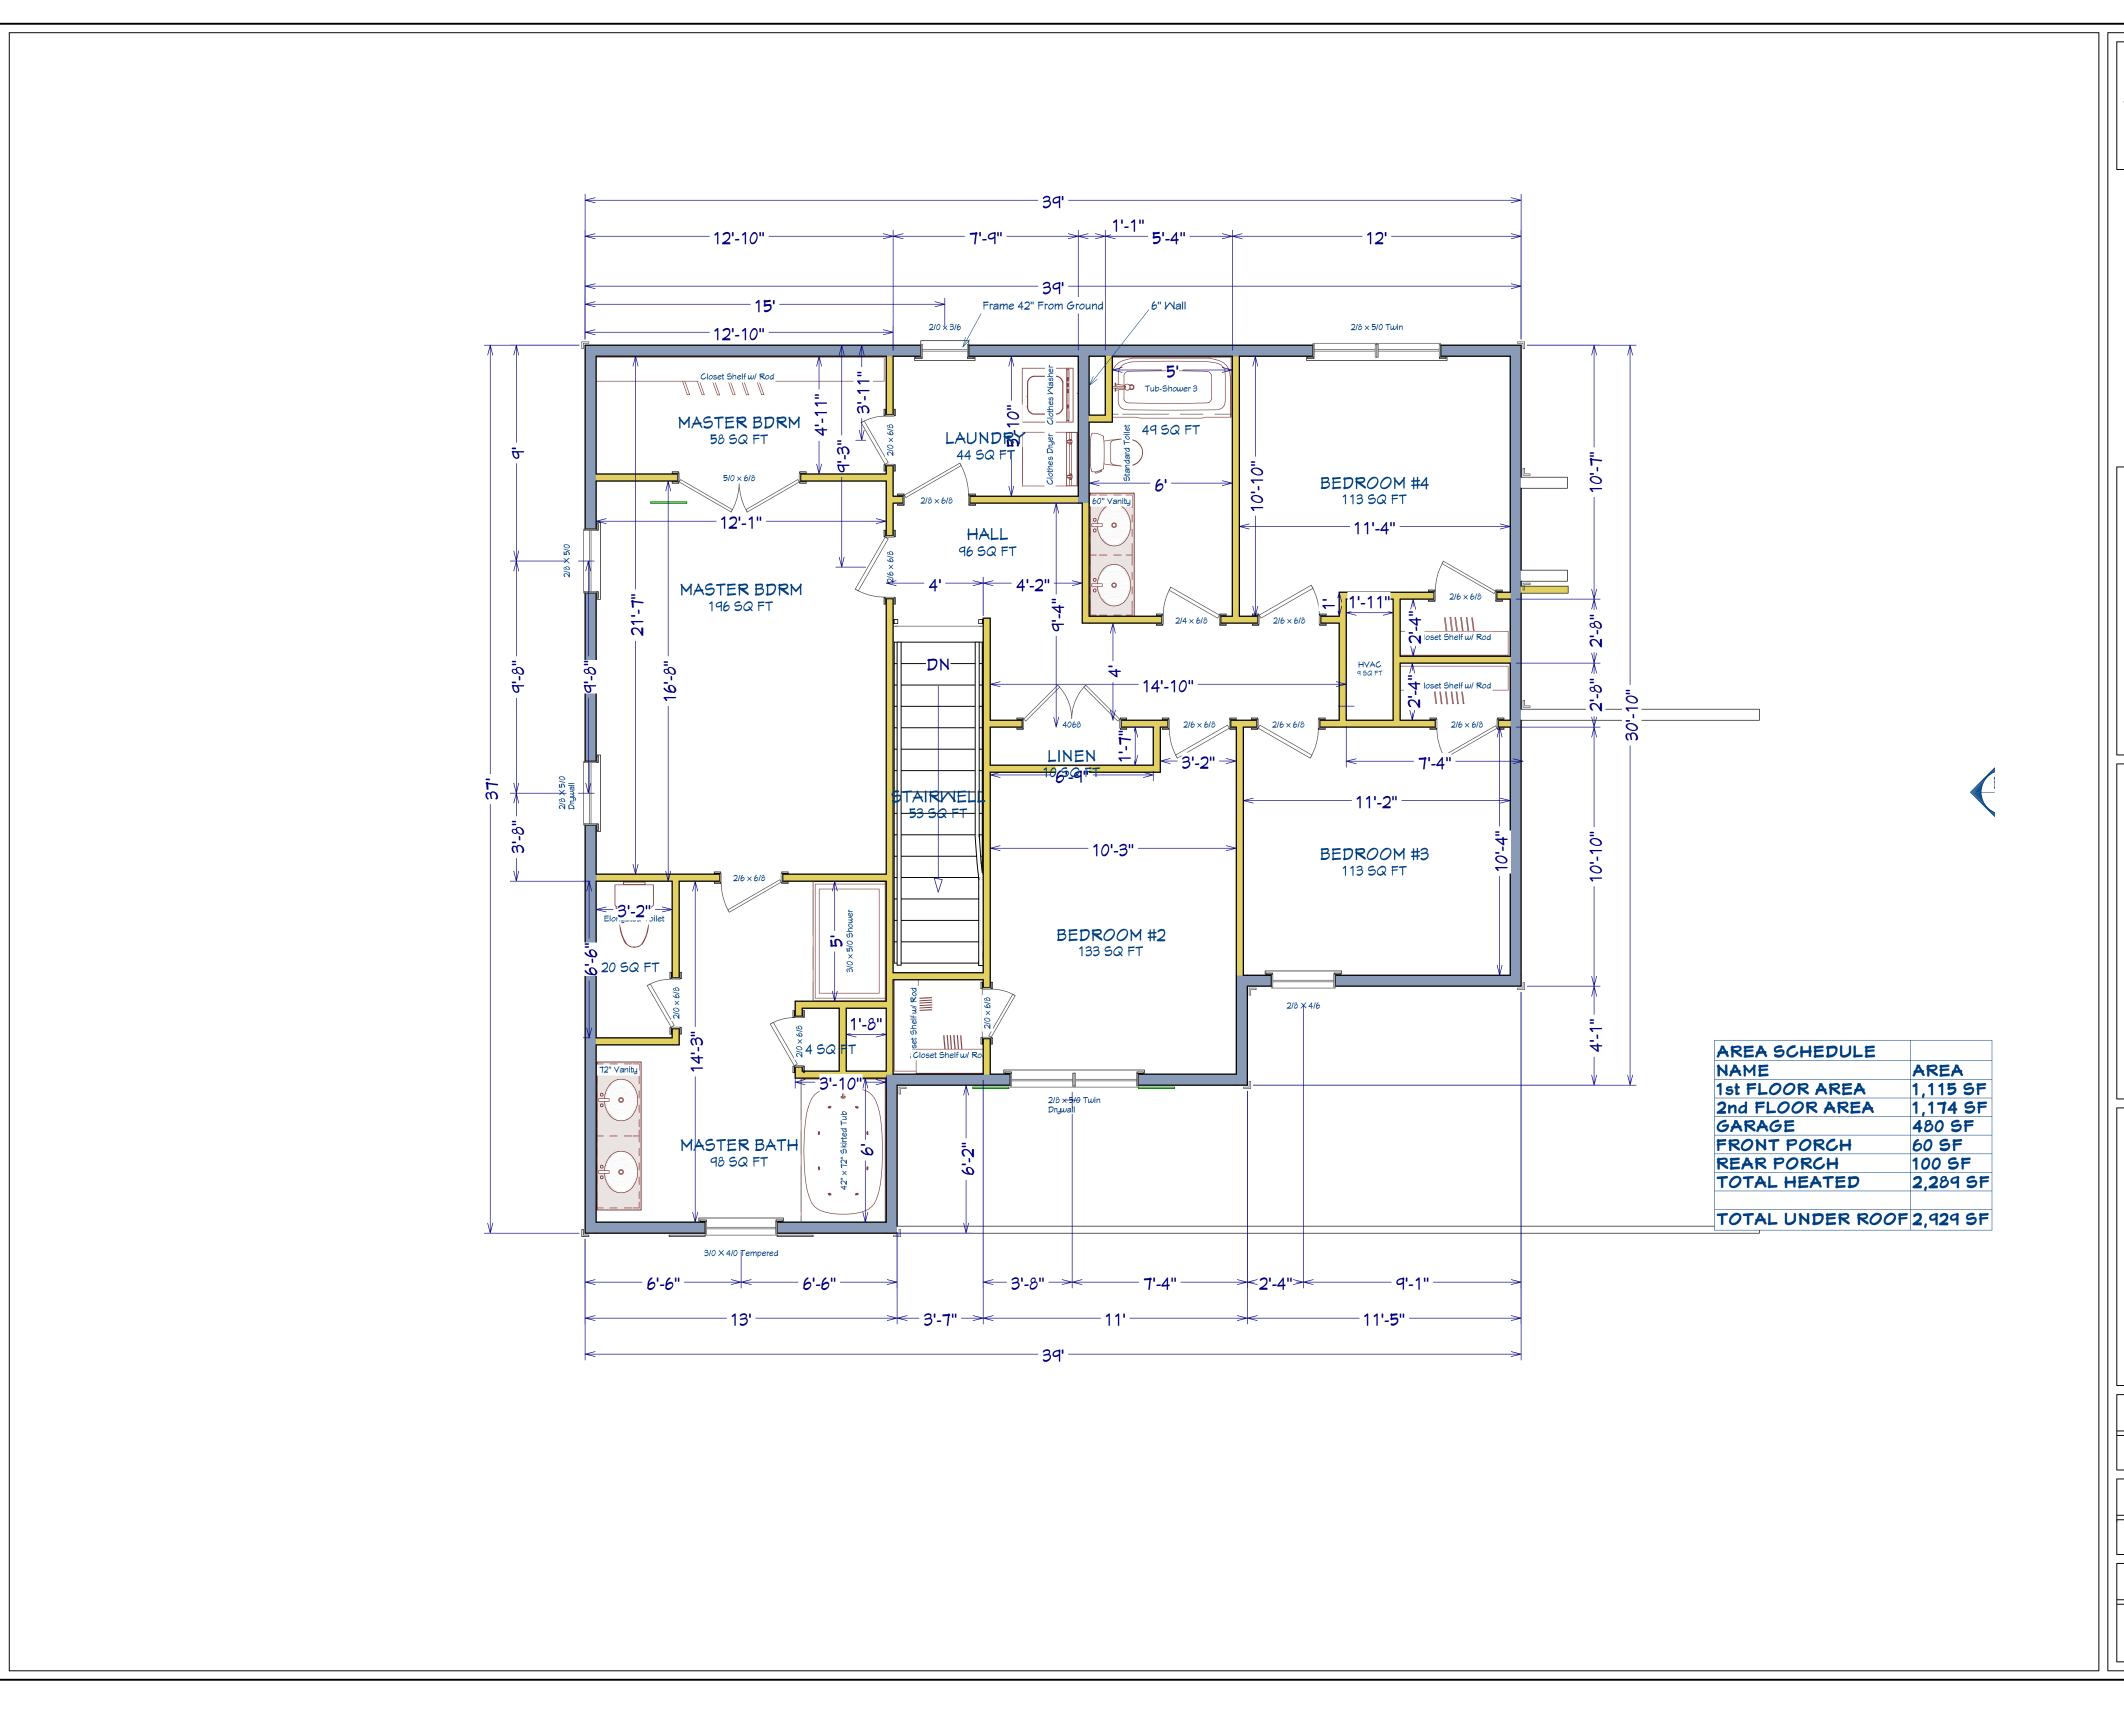

PLAN: Taggart

2nd FLOOR


PROJECT ADDRESS: 112 Sears Dr. (Lot 24)

DATE:

3/3/23 SCALE:

1/4" = 1'

SHEET:

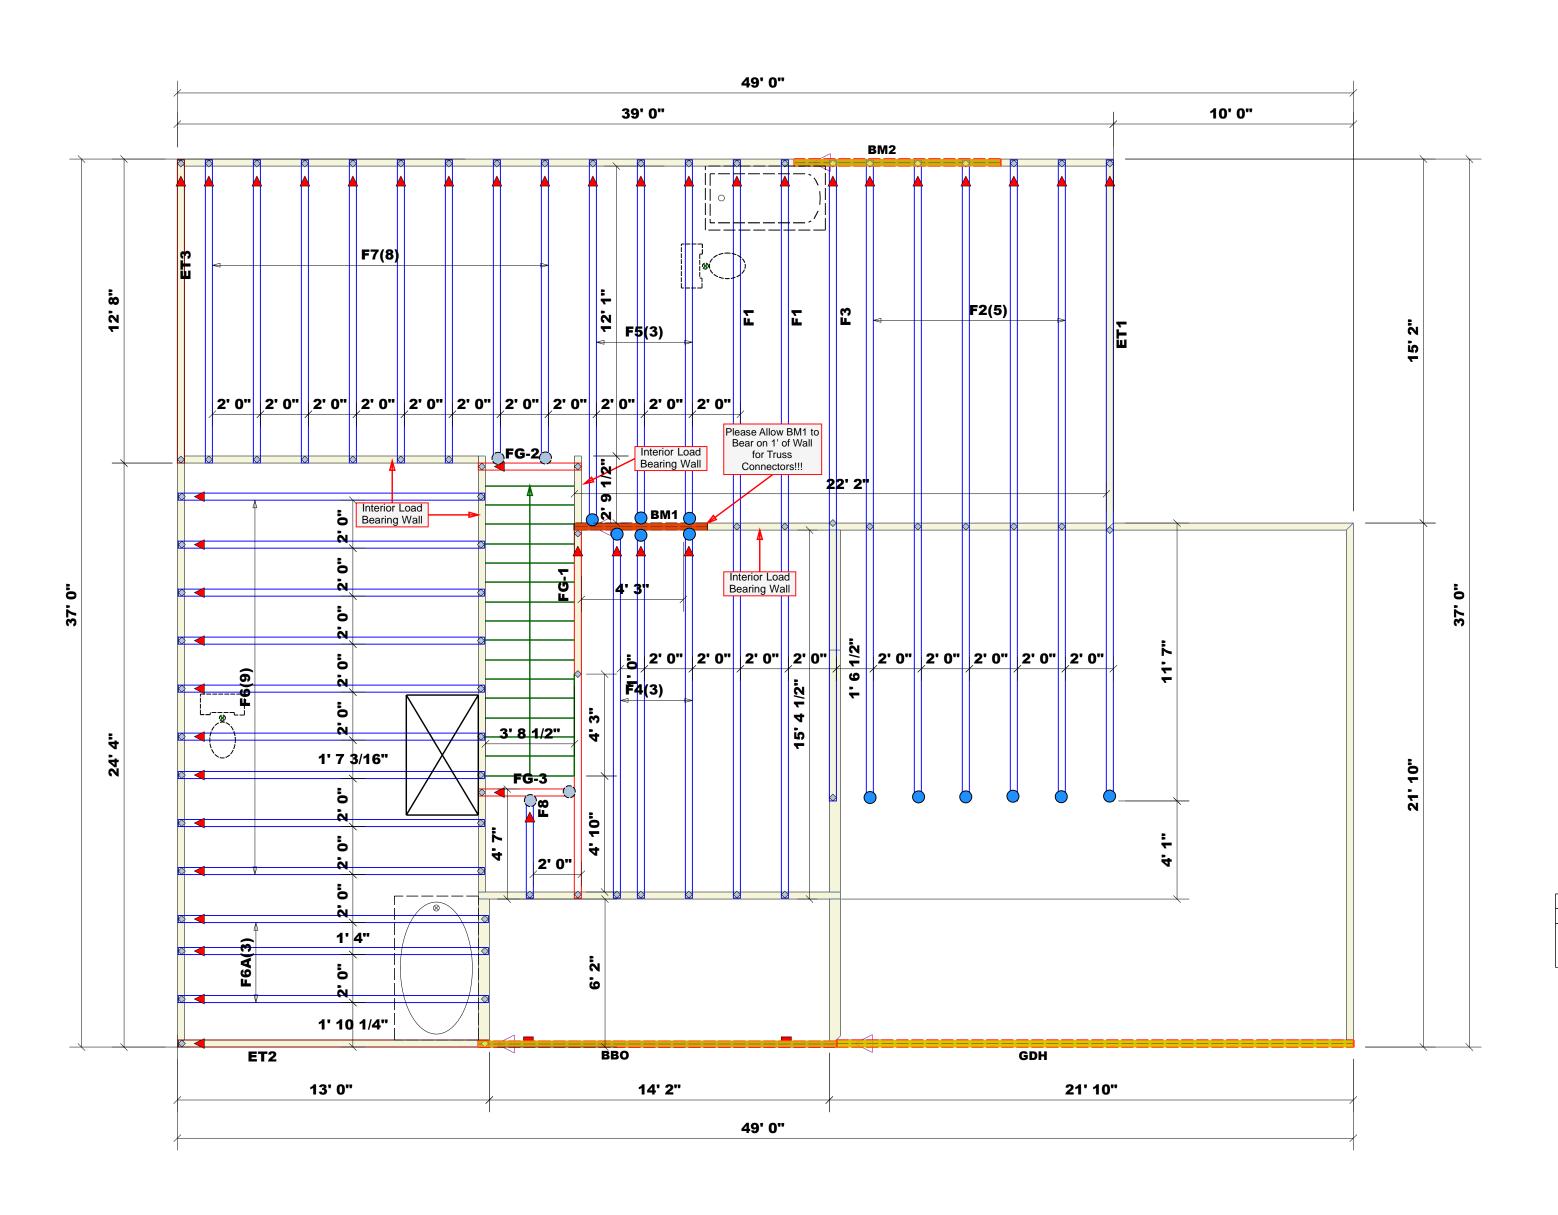



Dimension Notes

1. All exterior wall to wall dimensions are to face of stud unless noted otherwise
2. All interior wall dimensions are to face of stud unless noted otherwise
3. All exterior wall to truss dimensions are to face of stud unless noted otherwise

Roof Area = 2285.9 sq.ft.
Ridge Line = 76.13 ft.
Hip Line = 0 ft.
Horiz. OH = 160.38 ft.
Raked OH = 172.31 ft.
Decking = 79 sheets

All Walls Shown Are Considered Load Bearing

▲ = Indicates Left End of Truss (Reference Engineered Truss Drawing) Do Not Erect Trusses Backwards

Truss Placement Plan
Scale: 1/4"=1'

	Conne	Nail Info	ormation			
Sym	Product	Manuf	Qty	Supported Member	Header	Truss
	HUS26	USP	13	Varies	16d/3-1/2"	16d/3-1/2"
	JUS24	USP	5	Varies	10d/3"	10d/3"
	THD26-2	USP	1	Varies	16d/3-1/2"	10d/3"
	HUS410	USP	12	Varies	16d/3-1/2"	16d/3-1/2"
	MSH422	USP	4	Varies	10d/3"	10d/3"

Hatch Legend
Padded HVAC
2nd Floor Walls @ 8' 1 1/2" UNO
Flush Beam
Drop Beam

		Products			
PlotID	Length	Product	Plies	Net Qty	Fab Type
BM2	9' 0"	1-3/4"x 9-1/4" LVL Kerto-S	2	2	FF
GDH	22' 0"	1-3/4"x 11-7/8" LVL Kerto-S	2	2	FF
BM1	6' 0"	1-3/4"x 14" LVL Kerto-S	2	2	FF

ROOF & FLOOR TRUSSES & BEAMS

Reilly Road Industrial Park Fayetteville, N.C. 28309 Phone: (910) 864-8787 Fax: (910) 864-4444

Bearing reactions less than or equal to 3000# are deemed to comply with the prescriptive Code requirements. The contractor shall refer to the attached Tables (derived from the prescriptive Code requirements) to determine the minimum foundation size and number of wood studs required to support reactions greater than 3000# but not greater than 15000#. A registered design professional shall be retained to design the support system for any reaction that exceeds those specified in the attached Tables. A registered design professional shall be retained to design the support system for all reactions that exceed 15000#.

Signature_

Neil Baggett

LOAD CHART FOR JACK STUDS
(BASED ON TABLES R502.5(1) & (b))

	(D	NJLU U	IN INDLL) NOUL.	J(1) & (L	<i>,,,</i>	
NU	MBER C		STUDS R			A END OF	•
END REACTION (UP TO)	REQ'D STUDS FOR (2) PLY HEADER		END REACTION (UP TO)	REQ'D STUDS FOR (3) PLY HEADER		END REACTION (UP TO)	REQ'D STUDS FOR
1700	1		2550	1		3400	1
3400	2		5100	2		6800	2
5100	3		7650	3		10200	3
6800	4		10200	4		13600	4
8500	5		12750	5		17000	5
10200	6		15300	6			
11900	7						
13600	8						
15300	9						

Renovations	COUNTY	Harnett	
	ADDRESS	24 Liberty Meadows	'
	WODEL	Floor	
	DATE REV.	3/6/2023	
	DRAWN BY	DRAWN BY Neil Baggett	
	SALESMAN	SALESMAN Neil Baggett	

THIS IS A TRUSS PLACEMENT DIAGRAM ONLY.

These trusses are designed as individual building components to be incorporated into the building design at the specification of the building designer. See individual design sheets for each truss design identified on the placement drawing. The building designer is responsible for temporary and permanent bracing of the roof and floor system and for the overall structure. The design of the truss support structure including headers, beams, walls, and columns is the responsibility of the building designer. For general guidance regarding bracing, consult BCSI-B1 and BCSI-B3 provided with the truss delivery package or online @ sbcindustry.com

PLAN

3/3/2023

SEAL DATE

N/A

QUOTE#


J0323-4864

Precision Custom Homes

BUILDER

24 Liberty Meado

JOB NAME

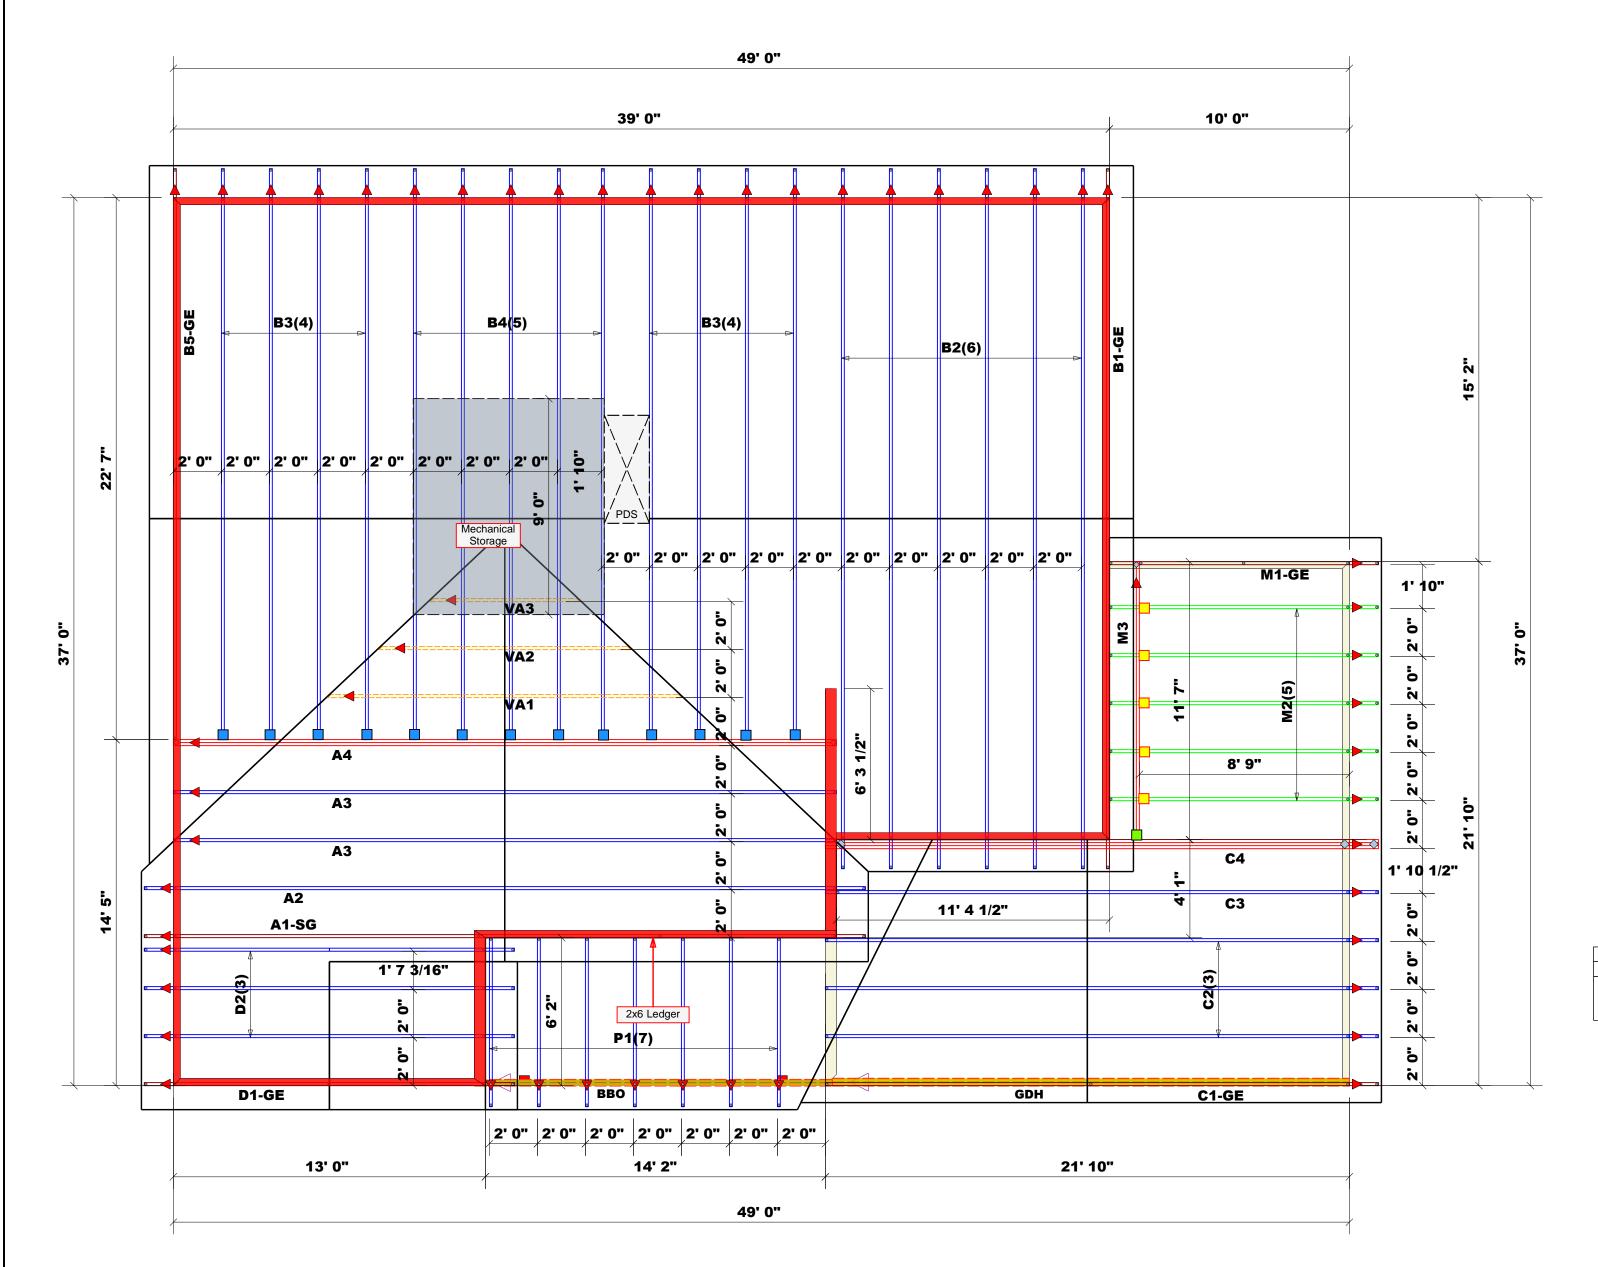



Dimension Notes Dimension Notes

1. All exterior wall to wall dimensions are to face of stud unless noted otherwise

2. All interior wall dimensions are to face of stud unless noted otherwise

3. All exterior wall to truss dimensions are to face of stud unless noted otherwise

Roof Area = 2285.9 sq.ft. Ridge Line = 76.13 ft. Hip Line = 0 ft. Horiz. OH = 160.38 ft. Raked OH = 172.31 ft. Decking = 79 sheets

All Walls Shown Are Considered Load Bearing

= Indicates Left End of Truss (Reference Engineered Truss Drawing) Do Not Erect Trusses Backwards

Truss Placement Plan
Scale: 1/4"=1'

Nail Information Connector Information Sym Product Manuf Qty Supported Header Truss HUS26 USP 13 Varies 16d/3-1/2" 16d/3-1/2" JUS24 USP 5 Varies 10d/3" 10d/3" THD26-2 USP 1 Varies 16d/3-1/2" 10d/3"

HUS410 USP 12 Varies 16d/3-1/2" 16d/3-1/2"

MSH422 USP 4 Varies 10d/3" 10d/3"

	Hatch Legend
	Padded HVAC
	2nd Floor Walls @ 8' 1 1/2" UNO
	Flush Beam
	Drop Beam

		Products			
PlotID	Length	Product	Plies	Net Qty	Fab Type
BM2	9' 0"	1-3/4"x 9-1/4" LVL Kerto-S	2	2	FF
GDH	22' 0"	1-3/4"x 11-7/8" LVL Kerto-S	2	2	FF
BM1	6' 0"	1-3/4"x 14" LVL Kerto-S	2	2	FF

COMTECH **ROOF & FLOOR TRUSSES & BEAMS**

Reilly Road Industrial Park Fayetteville, N.C. 28309 Phone: (910) 864-8787 Fax: (910) 864-4444

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Neil Baggett

LOAD CHART FOR JACK STUDS (BASED ON TABLES R502.5(1) & (b))

	(-				 -,,	
NU	MBER C	F JACI	STUDS R		A END OF	•
END REACTION (UP TO)	REQ'D STUDS FOR (2) PLY HEADER		END REACTION (UP TO)	REQ'D STUDS FOR (3) PLY HEADER	END REACTION (UP TO)	REQ'D STUDS FOR
1700	1		2550	1	3400	1
3400	2		5100	2	6800	2
5100	3		7650	3	10200	3
6800	4		10200	4	13600	4
8500	5		12750	5	17000	5
10200	6		15300	6		
11900	7					
13600	8					
15300	9					

Harnett	24 Liberty Meadows	Roof	3/6/2023	DRAWN BY Neil Baggett	SALESMAN Neil Baggett	
COUNTY	ADDRESS	MODEL	DATE REV.	DRAWN BY	SALESMAN	
vations						

JOB NAME SEAL DATE QUOTE# JOB# PLAN THIS IS A TRUSS PLACEMENT DIAGRAM ONLY. THIS IS A TRUSS PLACEMENT DIAGRAM ONLY.
These trusses are designed as individual building components to be incorporated into the building design at the specification of the building design at the specification of the building designer. See individual design sheets for each truss design identified on the placement drawing. The building designer is responsible for temporary and permanent bracing of the roof and floor system and for the overall structure. The design of the truss support structure including headers, beams, walls, and columns is the responsibility of the building designer. For general guidance regarding bracing, consult BCSI-B1 and BCSI-B3 provided with the truss delivery package or online @ sbcindustry.com

3/3/2023

N/A

J0323-4863

Precision Custom Homes & Renov

BUILDER

24 Liberty Meadows

357.4 lbs.

357.4 lbs.

ORDER DATE **QUOTE #** 0000007216 **DELIVERY DATE** / / **CUSTOMER ACCT# ROOF & FLOOR DATE OF INVOICE** 11 **CUSTOMER PO#** ComTech TRUSSES & BEAMS ORDERED BY Shaun Garderner **INVOICE #** COUNTY Harnett **TERMS** Reilly Road Industrial Park P.O. Box 40408 Fayetteville, N.C. 28309 (910) 864-TRUS SUPERINTENDANT Shaun Garderner **SALES REP** Neil Baggett (910) 988-8172 Neil Baggett **JOBSITE PHONE # SALES AREA LOT #** 24 **Precision Custom Homes** JOB NAME: Lot 24 Liberty Meadow SUBDIV: Liberty Meadow SOLD 256 Briar Hill Rd. **MODEL:** Floor TAG: Taggart JOB CATEGORY: B & S - Build and Ship **DELIVERY INSTRUCTIONS:** Raeford, NC 28376 T 52 MILES ROUND TRIP (910) 988-8172 SHIP **Precision Custom Homes and** SPECIAL INSTRUCTIONS: Lot 24 Liberty Meadow Modified from 17 Vista Point T O Cameron, NC **PLAN SEAL DATE:** DATE BY HEEL HEIGHT 00-06-08 BUILDING DEPARTMENT OVERHANG INFO **REQ. LAYOUTS REQ. ENGINEERING** QUOTE END CUT RETURN LAYOUT NB 03/06/23 Floor Order 03/06/23 **GABLE STUDS** 24 IN. OC **CUTTING** NB PLUMB JOBSITE **JOBSITE LOADING** TCLL-TCDL-BCLL-BCDL STRESS INCR. FLOOR TRUSSES FLOOR TRUSS SPACING: 24.0 IN. O.C. (TYP.) **INFORMATION** 40.0,10.0,0.0,5.0 1.00 **FLOOR** QTY DEPTH BASE O/A END TYPE **INT BEARING REACTIONS PROFILE** PLY ID **SPAN** SPAN LEFT RIGHT SIZE LOCATION 01-02-00 Joint 9 Joint 14 690.4 lbs. 3 F6A 12-11-00 12-11-00 690.4 lbs. 365.4 lbs. 365.4 lbs. Joint 9 Joint 15 01-02-00 12-07-08 12-07-08 680.6 lbs. 674.4 lbs. 8 F7 293.6 lbs. 420.3 lbs. 01-02-00 Joint 5 Joint 8 F8 04-03-00 04-03-00 213.8 lbs. 220.0 lbs. 152.5 lbs. 153.7 lbs. Joint 14 Joint 19 Joint 20 Joint 21 Joint 22 01-02-00 142.2 lbs. FG-1 15-04-00 15-04-00 591.8 lbs. 710.0 lbs. 61.8 lbs. 160.8 lbs. 269.5 lbs. -80.9 lbs. 36.9 lbs. 318 8 lbs 49 9 lbs Joint 4 Joint 6 01-02-00 04-03-08 04-03-08 921.9 lbs. FG-2 692.3 lbs 01-02-00 Joint 4 Joint 6 04-00-00 FG-3 04-00-00 266.2 lbs. 260.0 lbs. **ITEMS LENGTH** QTY **ITEM TYPE** SIZE **PART NUMBER NOTES** FT-IN-16 Hangers, USP SIMPSON (HUS410) 12 **HUS 410** LVL Beams (Sized) LVL, 1-3/4" x 9-1/4" (S) BM2 09-00-00 LVL Beams (Sized) LVL, 1-3/4" x 11-7/8" (S) 22-00-00 **GDH** LVL Beams (Sized) LVL, 1-3/4" x 14" (S) 06-00-00 BM1

REQ. QUOTE DATE

11

09/23/22

Reaction Summary of Order

DATE 03/06/23

J0922-4864

ORDER#

PAGE 2

DATE 03/06/23 PAGE 3 **Reaction Summary of Order**

ROOF & FLOOR ComTech | TRUSSES & BEAMS Reilly Road Industrial Park P.O. Box 40408 Fayetteville, N.C. 28309 (910) 864-TRUS

		D/(12)	70/00/20 17(02 0
REQ. QUOTE DATE	11	ORDER#	J0922-4864
ORDER DATE	09/23/22	QUOTE #	
DELIVERY DATE	11	CUSTOMER ACCT#	0000007216
DATE OF INVOICE	11	CUSTOMER PO#	
ORDERED BY	Shaun Garderner	INVOICE #	
COUNTY	Harnett	TERMS	
SUPERINTENDANT	Shaun Garderner	SALES REP	Neil Baggett
JOBSITE PHONE #	(910) 988-8172	SALES AREA	Neil Baggett

Precision Custom Homes 256 Briar Hill Rd. Raeford, NC 28376 (910) 988-8172

Precision Custom Homes and

Lot 24 Liberty Meadow

Cameron, NC

LOT # 24 JOB NAME: Lot 24 Liberty Meadow SUBDIV: Liberty Meadow JOB CATEGORY: B & S - Build and Ship MODEL: Floor TAG: Taggart

DELIVERY INSTRUCTIONS: 52 MILES ROUND TRIP

SPECIAL INSTRUCTIONS:

Modified from 17 Vista Point

PLAN SEAL DATE: DATE

BUILDING DEPARTMENT	OVERHA	ANG INFO	HEEL HEIGHT	00-06-08	RI	EQ. I	AYOUTS		REQ.	ENC	SINEERING		QUOTE		11
Floor Order	END CUT	RETURN											LAYOUT	NB	03/06/23
	PLUMB	·	GABLE STUDS	24 IN. OC			JOBSITE	1			JOBSITE	1	CUTTING	NB	03/06/23

ITEMS

SOLD

ТО

SHIP

QTY	ITEM TYPE	SIZE	LENGTH FT-IN-16	PART NUMBER	NOTES
4	Hangers, USP	MSH422			SIMPSON (THA422)

ROOF & FLOOR ComTech TRUSSES & BEAMS Reilly Road Industrial Park P.O. Box 40408 Fayetteville, N.C. 28309 (910) 864-TRUS

REQ. QUOTE DATE	/ /	ORDER#	J0922-4863
ORDER DATE	09/23/22	QUOTE #	
DELIVERY DATE	11	CUSTOMER ACCT#	0000007216
DATE OF INVOICE	11	CUSTOMER PO#	
ORDERED BY	Shaun Garderner	INVOICE #	
COUNTY	Harnett	TERMS	
SUPERINTENDANT	Shaun Garderner	SALES REP	Neil Baggett
JOBSITE PHONE #	(910) 988-8172	SALES AREA	Neil Baggett

Precision Custom Homes 256 Briar Hill Rd. Raeford, NC 28376

(910) 988-8172

ROOF TRUSSES

SOLD

TO

JOB NAME: Lot 24 Liberty Meadow **LOT #** 24 **SUBDIV:**Liberty Meadow MODEL:Roof TAG: Taggart JOB CATEGORY: B & S - Build and Ship

DELIVERY INSTRUCTIONS:

52 miles round trip

LOADING

Precision Custom Homes and Lot 24 Liberty Meadow Cameron, NC

SPECIAL INSTRUCTIONS: Modified from 17 Vista Point

TCLL-TCDL-BCLL-BCDL STRESS INCR.

PLAN SEAL DATE:

BUILDING DEPARTMENT	OVERHA	ANG INFO	HEEL HEIGHT	00-06-08	RI	EQ. I	LAYOUTS		REQ.	ENGINEERING		QUOTE		11
Roof Order	END CUT	RETURN										LAYOUT	NB	03/06/23
-	PLUMB		GABLE STUDS	24 IN. OC			JOBSITE	1		JOBSITE	1	CUTTING	NB	03/06/23

ROOF T	OOF TRUSSES LOADING TCLL-TCDL-BCLL-BCDL STRESS INCR. 20.0,10.0,0.0,10.0 1.15								ROOF TRUSS SPACING: 24.0 IN. O.C. (TYP.)					
PROFILE	QTY	PIT	СН	TYPE	BASE	_) IBER		HANG					1
PROFILE	PLY	TOP	ВОТ	ID	O/A	TOP	BOT	LEFT	RIGHT	REACTIO	NS			
	1	8.00	0.00	GABLE A1-SG	27-07-08 27-07-08			01-02-08	01-02-08	Joint 2 547.3 lbs. -36.6 lbs.	Joint 16 121.9 lbs. -5.5 lbs.	Joint 18 160.2 lbs. -44.6 lbs.	Joint 19 175.1 lbs. -47.7 lbs.	Joint 20 170.9 lbs. -45.7 lbs.
	1	8.00	0.00	COMMON A2	27-07-08 27-07-08	2 X 6	2 X 6	01-02-08	01-02-08	Joint 2 1442.1 lbs. -74.9 lbs.	Joint 10 1442.1 lbs. -74.9 lbs.			
	2	8.00	0.00	COMMON A3	27-07-08 27-07-08	2 X 6	2 X 6			Joint 1 1373.1 lbs. -57.5 lbs.	Joint 9 1373.1 lbs. -57.5 lbs.			
	1 2 Ply	8.00	0.00	COMMON A4	27-07-08 27-07-08	2 X 6	2 X 6			Joint 1 7614.4 lbs. -360.5 lbs.	Joint 5 7778.8 lbs. -368.0 lbs.			
	1	8.50	0.00	GABLE B1-GE	26-09-00 26-09-00	2 X 6	2 X 6	01-02-08	01-02-08	Joint 2 211.1 lbs. -61.1 lbs.	Joint 16 180.0 lbs. -14.5 lbs.	Joint 18 193.9 lbs. -109.0 lbs.	Joint 19 175.0 lbs. -92.3 lbs.	Joint 20 177.9 lbs. -91.9 lbs.
	6	8.50	0.00	COMMON B2	26-09-00 26-09-00	2 X 6	2 X 6	01-02-08	01-02-08	Joint 2 1404.3 lbs. -70.5 lbs.	Joint 10 1404.3 lbs. -70.5 lbs.			
	8	8.50	0.00	COMMON B3	26-09-00 22-07-00	2 X 6	2 X 6	01-02-08		Joint 2 1159.6 lbs. -61.1 lbs.	Joint 11 1086.1 lbs. -35.2 lbs.			
	5	8.50	0.00	COMMON B4	26-09-00 22-07-00	2 X 6	2 X 6	01-02-08		Joint 2 1159.6 lbs. -61.1 lbs.	Joint 11 1086.1 lbs. -35.2 lbs.			
	1	8.50	0.00	GABLE B5-GE	26-09-00 22-07-00	2 X 6	2 X 6	01-02-08		Joint 2 209.2 lbs. -60.2 lbs.	Joint 15 240.4 lbs. -90.0 lbs.	Joint 16 239.8 lbs. -290.4 lbs.	Joint 17 181.0 lbs. -99.8 lbs.	Joint 18 184.0 lbs. -108.5 lbs.
	1	7.00	0.00	GABLE C1-GE	21-10-00 21-10-00	2 X 6	2 X 6	01-02-08		Joint 2 189.8 lbs. -30.3 lbs.	Joint 12 110.7 lbs. 11.0 lbs.	Joint 13 262.1 lbs. -127.1 lbs.	Joint 14 146.4 lbs. -64.7 lbs.	Joint 15 181.6 lbs. -87.3 lbs.
	3	7.00	0.00	COMMON C2	21-10-00 21-10-00	2 X 6	2 X 6	01-02-08		Joint 2 1061.6 lbs. -65.5 lbs.	Joint 8 990.7 lbs. -48.0 lbs.			

DATE 03/06/23 PAGE 2

Reaction Summary of Order ROOF & FLOOR ComTech TRUSSES & BEAMS Reilly Road Industrial Park P.O. Box 40408

REQ. QUOTE DATE 11 ORDER# J0922-4863 **ORDER DATE** 09/23/22 **QUOTE # DELIVERY DATE** 0000007216 11 **CUSTOMER ACCT#** DATE OF INVOICE 11 **CUSTOMER PO#** ORDERED BY Shaun Garderner **INVOICE #** COUNTY Harnett **TERMS** Shaun Garderner Neil Baggett **SUPERINTENDANT SALES REP** (910) 988-8172 Neil Baggett **JOBSITE PHONE # SALES AREA**

ROOF TRUSS SPACING: 24.0 IN. O.C. (TYP.)

Precision Custom Homes 256 Briar Hill Rd. Raeford, NC 28376

(910) 988-8172

Cameron, NC

ROOF TRUSSES

SOLD

T O

S H I P

T O

Fayetteville, N.C. 28309 (910) 864-TRUS

JOB NAME: Lot 24 Liberty Meadow **LOT #** 24 SUBDIV: Liberty Meadow MODEL: Roof TAG: Taggart JOB CATEGORY: B & S - Build and Ship

DELIVERY INSTRUCTIONS:

52 miles round trip

Precision Custom Homes and Lot 24 Liberty Meadow

LOADING

SPECIAL INSTRUCTIONS: Modified from 17 Vista Point

TCLL-TCDL-BCLL-BCDL

PLAN SEAL DATE:

DATE

BUILDING DEPARTMENT OVERHANG INFO HEEL HEIGHT 00-06-08 QUOTE **REQ. LAYOUTS REQ. ENGINEERING** LAYOUT NB 03/06/23 END CUT RETURN Roof Order **CUTTING** NB 03/06/23 PLUMB **GABLE STUDS** 24 IN. OC JOBSITE JOBSITE

STRESS INCR.

KOOF II		JOLO	' IN	FORMATION				1.15	1 KU	JF 18033 3PF	ACING. 24.0	IIV. O.C. (11F	.)	
PROFILE	QTY	PIT		TYPE	BASE	LUN	BER	OVER	HANG	REACTIONS	<u> </u>			
	PLY	TOP	BOT	ID	O/A	TOP	вот	LEFT	RIGHT					
				COMMON	21-10-00	2 4 6	2 7 2	04 00 00		_ ·	Joint 10			
	1	7.00	0.00	C3	21-10-00	2 % 6	2 % 6	01-02-08		1057.9 lbs.	966.4 lbs.			
										-65.4 lbs.	-40.3 lbs.			
	1 3 Ply		0.00	COMMON C4	21-06-08	2 V 6	2 V 10	01-02-08	00 03 09		Joint 6			
	3 Ply	7.00	0.00	04	21-00-00	2 ^ 0	2 / 10	01-02-06	00-03-06	5311.4 lbs.	10526.8 lbs.			
					1			l	1	-344.2 lbs.	-238.7 lbs.			
				OAD! E	40.00.00									
	1	8.00	0.00	GABLE D1-GE	13-00-00	2 × 4	2 X 6	01-02-08	01-02-08	Joint 2 585.7 lbs.	Joint 4			
	'	0.00	0.00	DI-OL	10-00-00	2 7 7	2 7 0	01-02-00	01-02-00		591.8 lbs. -137.9 lbs.			
						 	 		<u> </u>	-136.0 lbs.	-137.9 IDS.			
				COMMON	13-00-00					loint 2	loint 4			
	3	8.00	0.00			2 X 4	2 X 6	01-02-08	01-02-08	Joint 2 585.7 lbs.	Joint 4 591.8 lbs.			
	"	0.00	0.00	52	10 00 00	- ~ .	- ~ 0	01 02 00	01 02 00	-45.7 lbs.	-46.5 lbs.			
						 	<u> </u>			-45.7 lbs.	-40.5 IDS.			
				GABLE	08-09-00					Joint 2	laint O	laint O	Joint 10	laint 11
A	1	7.00	0.00			2 X 6	2 X 6	01-02-08	01-03-00	169.9 lbs.	Joint 8 204.8 lbs.	Joint 9 117.8 lbs.	165.2 lbs.	Joint 11 231.3 lbs.
	'	7.00	0.00	OL	00 00 00	- ~ 0	- ~ 0	01 02 00	01 00 00	14.0 lbs.	-129.6 lbs.	-35.3 lbs.	-77.3 lbs.	-120.5 lbs.
						 				14.0 lbs.	-129.0 IDS.	-33.3 ibs.	-11.3 IDS.	-120.5 lbs.
				MOK CLOSED	00 00 00					laint O	laint G			
	5	7.00	0.00	JACK-CLOSED M2	08-09-00	2 X 6	2 X 6	01-02-08	01-03-00	Joint 2 398.5 lbs.	Joint 6 455.7 lbs.			
	3	7.00	0.00	IVIZ	00-03-00	2 7 0	2 7 0	01-02-00	01-00-00	16.7 lbs.	-122.3 lbs.			
						 	l			10.7 lbs.	-122.3 IDS.			
	,			FLAT	11-07-00					Joint 4	Joint 6			
	2 Ply	0.00	0.00		11-07-00	2 X 6	2 X 6			2138.5 lbs.	2281.9 lbs.			
	2 1 1y	0.00	0.00	1110	110700	- / 0	- ~ 0			-456.7 lbs.	-564.7 lbs.			
						 	l	l		-430.7 lbs.	-304.7 lbs.			
				MONOPITCH	06-02-00					Joint 2	Joint 4			
· ·	7	3.50	0.00			2 X 4	2 X 4	00-10-08		297.7 lbs.	227.3 lbs.			
· ·	'	0.50	0.00			- / · ·	- / · ·	30		-120.4 lbs.	-95.2 lbs.			
					<u> </u>	l	l	l	<u> </u>	-120.7103.	-30.2 IDS.			
				VALLEY	14-05-14					Joint 1	Joint 5	Joint 6	Joint 7	Joint 8
	1	8.00	0.00		14-05-14	2 X 4	2 X 4			110.2 lbs.	97.7 lbs.	344.5 lbs.	258.2 lbs.	344.8 lbs.
	'	0.00	0.50							-10.7 lbs.	8.1 lbs.	-99.0 lbs.	49.4 lbs.	-99.1 lbs.
						 	 		<u> </u>	10.7 103.	J. 1 IDJ.	-00.0 ib3.	70.7 103.	55.1 lb5.
				VALLEY	10-02-14					Joint 1	Joint 3	Joint 4		
	1	8.00	0.00		10-02-14	2 X 4	2 X 4			185.6 lbs.	185.5 lbs.	376.6 lbs.		
	'	3.00	3.00	_						-23.1 lbs.	-30.4 lbs.	6.4 lbs.		
					<u> </u>	l	<u> </u>	l	<u> </u>	20.1100.	50.1155.	0.1150.		
				VALLEY	05-11-14					Joint 1	Joint 3	Joint 4		
	1	8.00	0.00		05-11-14	2 X 4	2 X 4			110.9 lbs.	110.8 lbs.	186.0 lbs.		
	'		3.30							-17.5 lbs.	-21.5 lbs.	13.3 lbs.		
1				1					L		150.			

ITEMS

QTY	ITEM TYPE	SIZE	LENGTH FT-IN-16	PART NUMBER	NOTES
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ROOF & FLOOR ComTech TRUSSES & BEAMS Reilly Road Industrial Park P.O. Box 40408 Fayetteville, N.C. 28309 (910) 864-TRUS

		D/(12)	70/00/20 17(02 0
REQ. QUOTE DATE	11	ORDER#	J0922-4863
ORDER DATE	09/23/22	QUOTE #	
DELIVERY DATE	11	CUSTOMER ACCT#	0000007216
DATE OF INVOICE	11	CUSTOMER PO#	
ORDERED BY	Shaun Garderner	INVOICE #	
COUNTY	Harnett	TERMS	
SUPERINTENDANT	Shaun Garderner	SALES REP	Neil Baggett
JOBSITE PHONE #	(910) 988-8172	SALES AREA	Neil Baggett

Precision Custom Homes 256 Briar Hill Rd. Raeford, NC 28376 (910) 988-8172

JOB NAME: Lot 24 Liberty Meadow **LOT #** 24 **SUBDIV:**Liberty Meadow JOB CATEGORY: B & S - Build and Ship MODEL:Roof TAG: Taggart

DELIVERY INSTRUCTIONS:

52 miles round trip

Precision Custom Homes and Lot 24 Liberty Meadow Cameron, NC

SPECIAL INSTRUCTIONS: Modified from 17 Vista Point

> **PLAN SEAL DATE:** DATE

BUILDING DEPARTMENT OVERHANG INFO HEEL HEIGHT 00-06-08 REQ. LAYOUTS REQ. ENGINEERING QUOTE END CUT RETURN LAYOUT NB 03/06/23 03/06/23 GABLE STUDS 24 IN. OC **CUTTING** NB PLUMB JOBSITE JOBSITE

ITEMS

Roof Order

SOLD

TO

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QTY	ITEM TYPE	SIZE	LENGTH FT-IN-16	PART NUMBER	NOTES
13	Hangers, USP	HUS 26			SIMPSON (HUS26)
5	Hangers, USP	JUS24			SIMPSON (LUS24)
1	Hangers, USP	THD26-2			SIMPSON (HHUS26-2)