




HOLLY PLACE LOT 2
4071 BARBEQUE CHURCH RD
SANFORD, NC

- GENERAL NOTES**
1. ALL WORK SHALL BE PERFORMED IN ACCORDANCE WITH ALL APPLICABLE NATIONAL, STATE, AND LOCAL CODES AND REGULATIONS.
 2. CONTRACTOR SHALL THOROUGHLY REVIEW ALL SHEETS IN PLAN SET AND VERIFY ALL DETAILS AND DIMENSIONS BEFORE BEGINNING CONSTRUCTION. ANY DISCREPANCIES SHALL BE REPORTED TO RENAISSANCE RESIDENTIAL DESIGN, INC. FOR JUSTIFICATION AND/OR CORRECTION BEFORE PROCEEDING WITH WORK. CONTRACTORS SHALL ASSUME RESPONSIBILITY FOR ERRORS THAT ARE NOT REPORTED PRIOR TO CONSTRUCTION.
 3. ALL DIMENSIONS SHOULD BE READ OR CALCULATED AND NEVER SCALED.
 4. CONTRACTOR SHALL ENSURE COMPATIBILITY OF THE BUILDING WITH ALL SITE REQUIREMENTS.

STEPS PER GRADE AS REQ.
FRONT ELEVATION-C
SCALE: 1/4" = 1'-0"

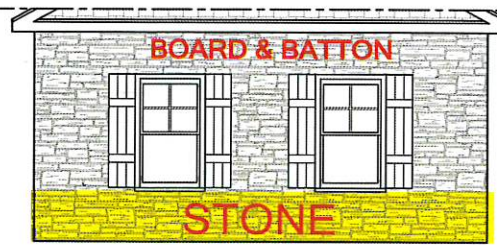


SIDE LOAD GARAGE
SCALE: 1/4" = 1'-0"

PLANS DESIGNED TO THE
NORTH CAROLINA STATE
RESIDENTIAL BUILDING CODE.

NOTICE TO CONTRACTOR
All construction must comply with current NC Building Codes and is subject to field inspection and verification.

APPROVED
Ultimate building quality review.
Permit holder responsible for full compliance with the code.


09/18/2023

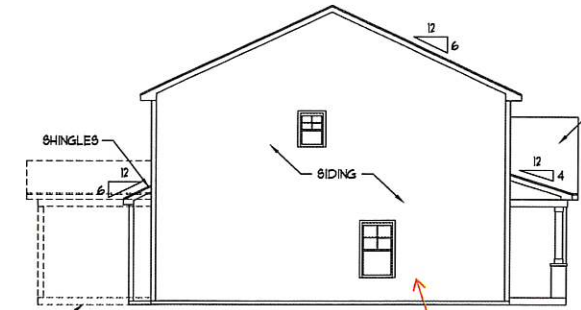


LEFT ELEVATION
SCALE: 1/8" = 1'-0"



REAR ELEVATION
SCALE: 1/8" = 1'-0"

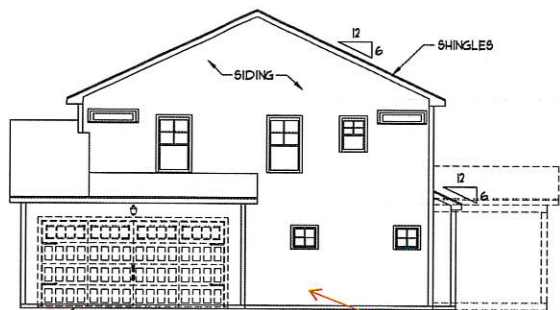

RIGHT ELEVATION
SCALE: 1/8" = 1'-0"

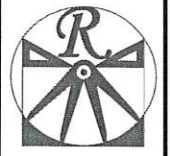

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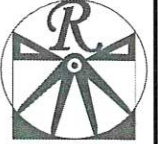
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WEAVER HOMES
CAROLINA COLLECTION
MAGNOLIA-II

DATE: FEBRUARY 19, 2021
REV: _____
SCALE: 1/4" = 1'-0"
DRAWN BY: WG
ENGINEERED BY: _____
REVIEWED BY: _____

C - ELEVATIONS
A-3



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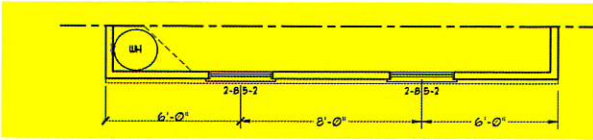
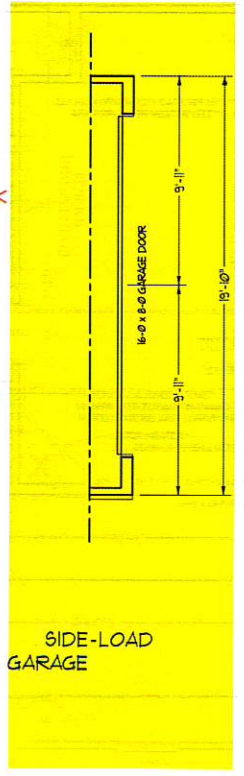
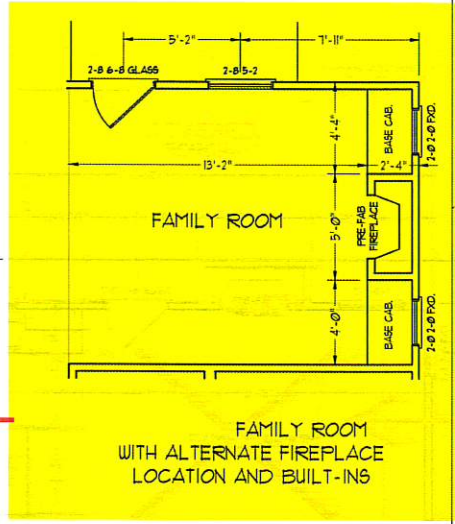
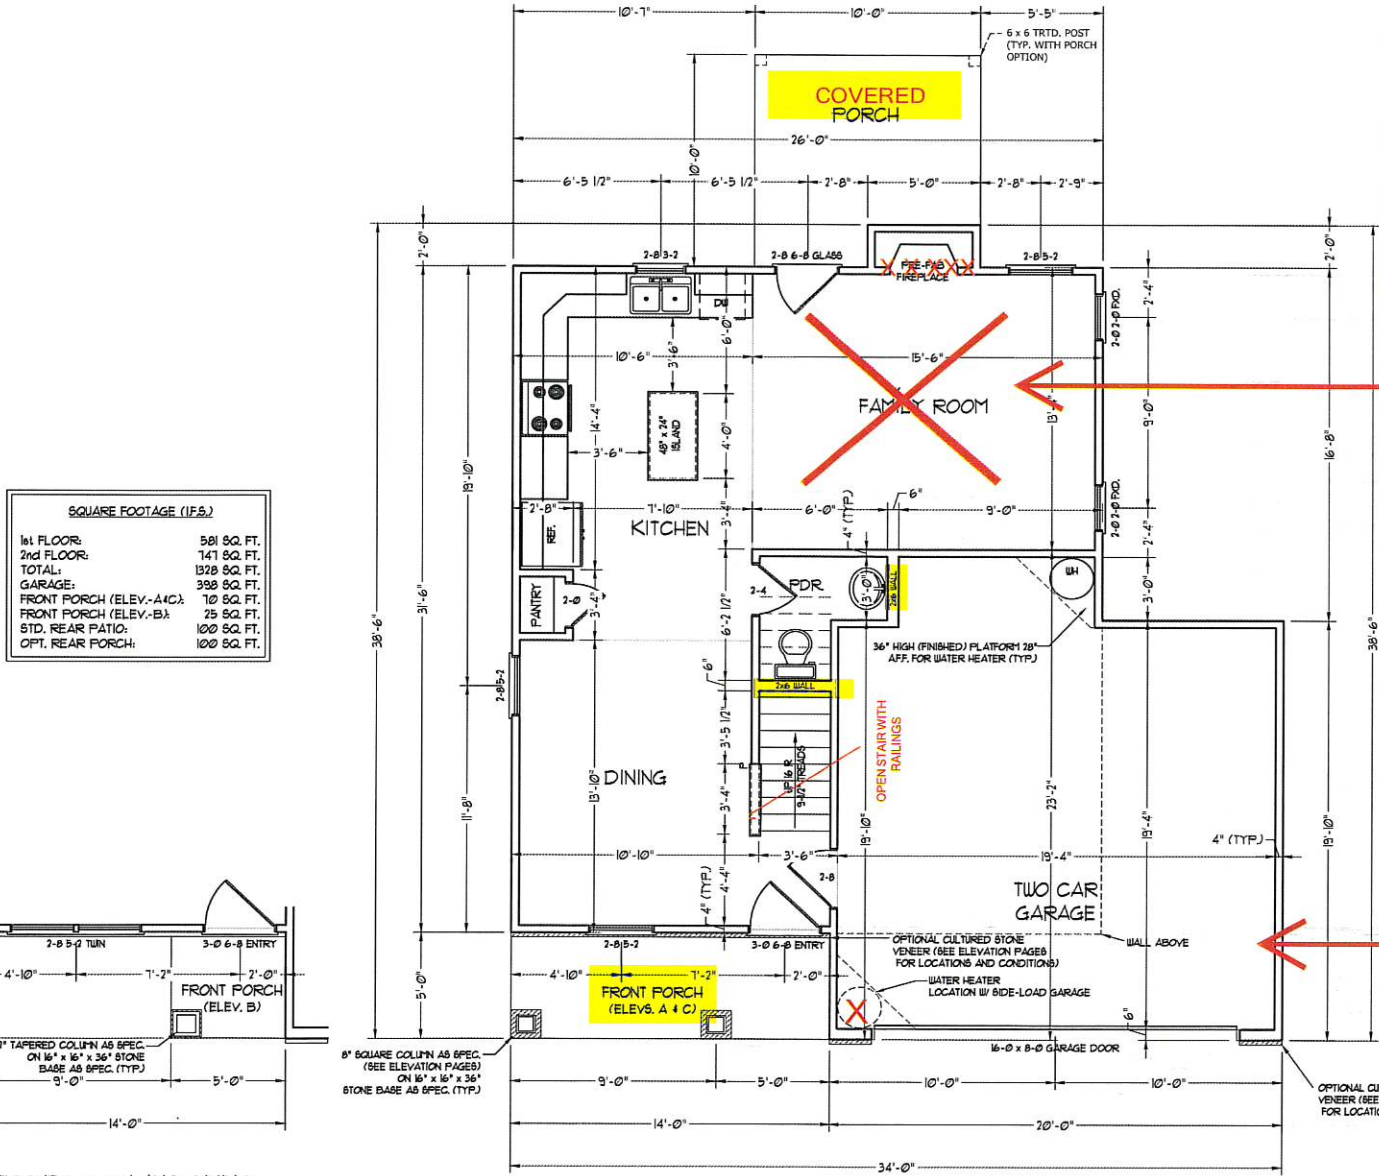
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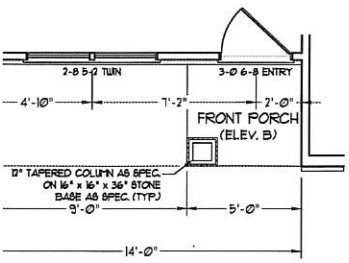
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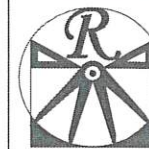
FIRST FLOOR PLAN
A-4



SQUARE FOOTAGE (IFS.)	
1st FLOOR:	581 SQ. FT.
2nd FLOOR:	141 SQ. FT.
TOTAL:	722 SQ. FT.
GARAGE:	398 SQ. FT.
FRONT PORCH (ELEV. A & C):	10 SQ. FT.
FRONT PORCH (ELEV. B):	78 SQ. FT.
STD. REAR PATIO:	100 SQ. FT.
OPT. REAR PORCH:	100 SQ. FT.



FRONT PORCH AND DINING ROOM WINDOW ELEVATION B



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CAROLINA COLLECTION
MAGNOLIA-II**

DATE: FEBRUARY 19, 2021
REV. _____
SCALE: 1/4" = 1'-0"
DRAWN BY: WG
ENGINEERED BY: _____
REVIEWED BY: _____
FIRST FLOOR
ELECTRICAL
PLAN
E-1

CRITICAL LAYOUT NOTES:


BLOCK AND WIRE FOR ALL CEILING FANS PER PLAN.

VANITY LIGHTS TO BE SET 90° AFF. (TYP.)




ADDITIONAL EXTERIOR OUTLETS REQUIRED BY CODE TO BE LOCATED BY ELECTRICIAN.

PLACE SWITCHES 8" MIN FROM EDG. OPENINGS.


- CRITICAL LEGEND**
- > V OUTLET
 - > V GFI OUTLET
 - > V SWITCHED OUTLET
 - > V BASEBOARD OUTLET
 - FLEX
 - COUNTER OR FLOOR MOUNTED
 - COUNTER OR FLOOR MOUNTED 100V GFI
 - WATER-PROOF
 - Ø V OUTLET
 - > V DEDICATED CIRCUIT
 - Ø V DEDICATED CIRCUIT
 - SPECIAL PURPOSE (240 V, ETC.)
 - ALL MOUNT LIGHT
 - CEILING MOUNT LIGHT
 - PENDANT LIGHT
 - RECESSED CAN LIGHT
 - IN CAN LIGHT
 - REBALL LIGHT
 - 120V REBEGENT LIGHT
 - REBEG CABINET LIGHT
 - ROOD LIGHT
- ⊕ SWITCH
 - ⊕ DIMMER SWITCH
 - △ TELEPHONE
 - △ DATA
 - △ TELEPHONE AND DATA
 - TV CONNECTION
 - TV DATA
 - CONDUIT FOR COMPONENT WIRING
 - BREAKER
 - 100 V SMOKE/CH DETECTOR
 - 100 V SMOKE DETECTOR
 - EXHAUST FAN
 - LOW VOLTAGE PANEL
 - ALARM PANEL
 - CEILING FAN
 - CEILING FAN W/ LIGHT

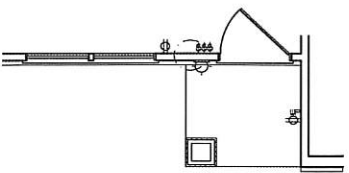

FRONT PORCH AND DINING ROOM WINDOW ELEVATION B

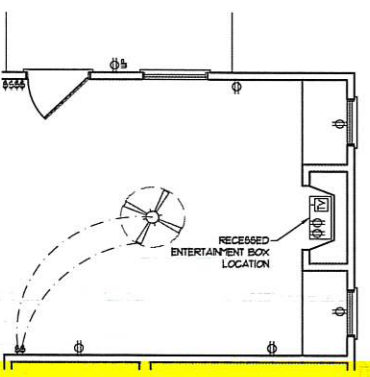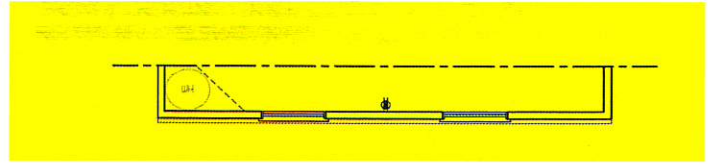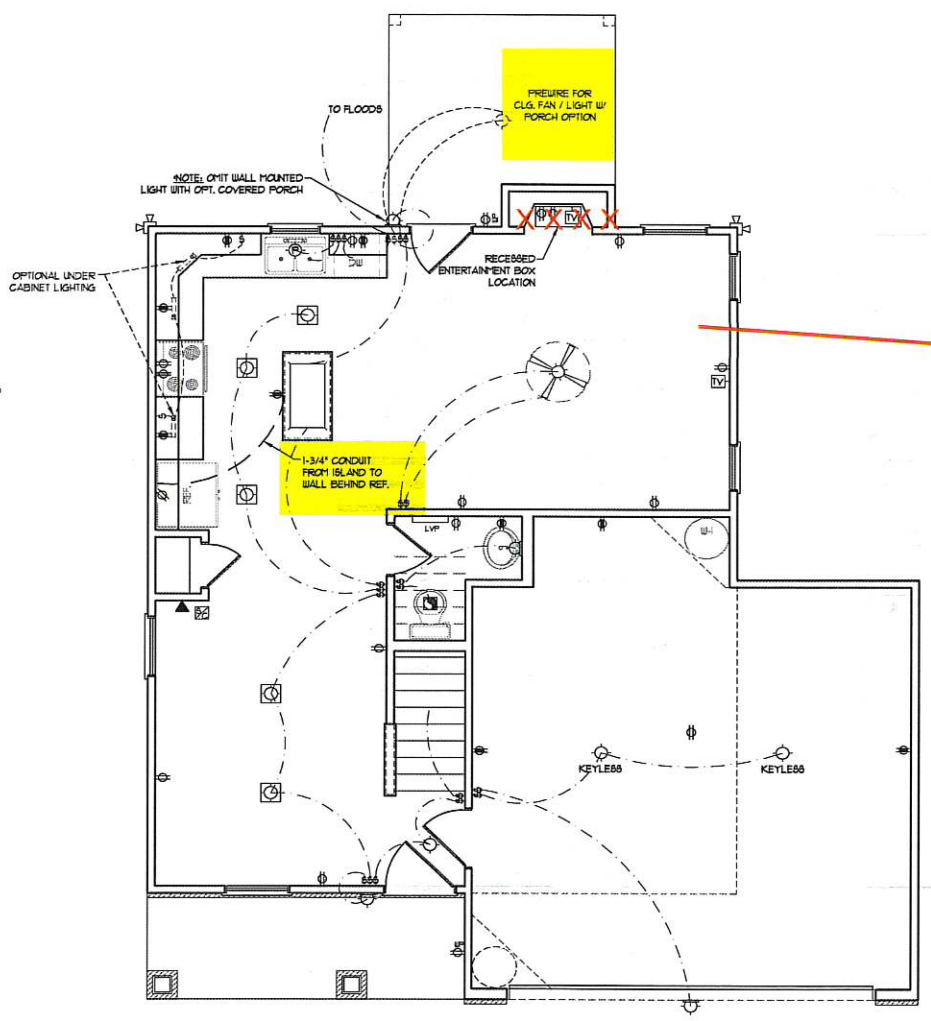

OPTIONAL FAMILY ROOM WITH ALTERNATE FIREPLACE LOCATION AND BUILT-INS

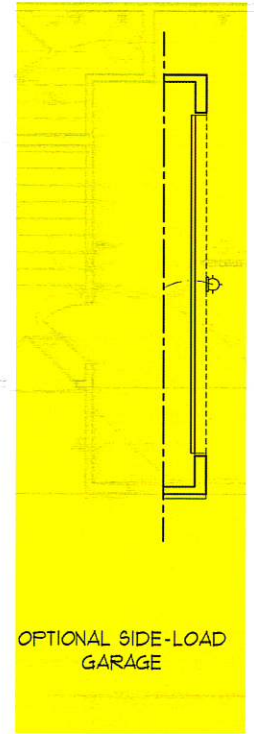

OPTIONAL SIDE-LOAD GARAGE

CRITICAL LAYOUT NOTES:

BLOCK AND WIRE FOR ALL
CEILING FANS PER PLAN



VANITY LIGHTS TO BE SET
90° APF. (TYP)

ADDITIONAL EXTERIOR OUTLETS
REQUIRED BY CODE TO BE
LOCATED BY ELECTRICIAN

PLACE SWITCHES 8" MIN FROM
ROUGH OPENINGS.

SYMBOL LEGEND

- ⊔ V OUTLET
- ⊔ GFI OUTLET
- ⊔ SWITCHED OUTLET
- ⊔ V BASEBOARD OUTLET
- ⊔ FLEX
- ⊔ CENTER OR FLOOR MOUNTED
- ⊔ CENTER OR FLOOR MOUNTED 110V GFI
- ⊔ WATERPROOF
- ⊔ V OUTLET
- ⊔ V DEDICATED CIRCUIT
- ⊔ V DEDICATED CIRCUIT
- ⊔ SPECIAL PURPOSE (240 V, ETC.)
- ⊔ ALL MOUNT LIGHT
- ⊔ CEILING MOUNT LIGHT
- ⊔ PENDANT LIGHT
- ⊔ RECESSED CAN LIGHT
- ⊔ IN CAN LIGHT
- ⊔ REBALL LIGHT
- ⊔ CORESET LIGHT
- ⊔ UNDERCABINET LIGHT
- ⊔ CLOSET LIGHT
- ⊔ SWITCH
- ⊔ DIMMER SWITCH
- ⊔ TELEPHONE
- ⊔ DATA
- ⊔ TELEPHONE AND DATA
- ⊔ TV CONNECTION
- ⊔ TV DATA
- ⊔ CONDUIT FOR COMPONENT WIRING
- ⊔ BREAKER
- ⊔ 110 V SMOKE / CO DETECTOR
- ⊔ 110 V SMOKE DETECTOR
- ⊔ EXHAUST FAN
- ⊔ LOW VOLTAGE PANEL
- ⊔ ALARM PANEL
- ⊔ CEILING FAN
- ⊔ CEILING FAN W/ LIGHT

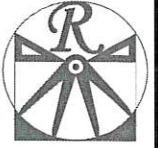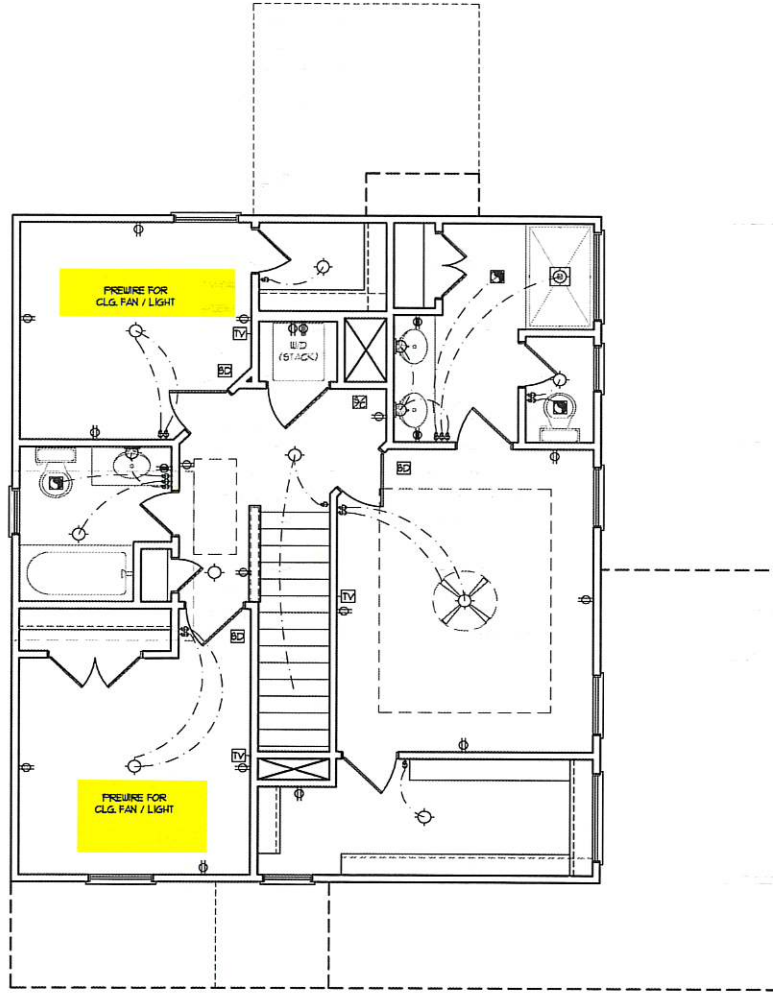

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Client: Weaver Homes Carolina Collection Magnolia II - 2nd Floor

THESE PROVISIONS, INCLUDING LISTED OPTIONS AND NOTES, SHALL BE CONSIDERED PART OF THESE PLANS. ANY CHANGES TO THESE PLANS SHALL BE MADE BY A REVISION. ANY CHANGES TO THESE PLANS SHALL BE MADE BY A REVISION. ANY CHANGES TO THESE PLANS SHALL BE MADE BY A REVISION. ANY CHANGES TO THESE PLANS SHALL BE MADE BY A REVISION.

WEAVER HOMES
CAROLINA COLLECTION
MAGNOLIA-II


DATE: FEBRUARY 19, 2021
REV. _____
SCALE: 1/4" = 1'-0"
DRAWN BY: WG
ENGINEERED BY:
REVIEWED BY:
SECOND FLOOR
ELECTRICAL
PLAN
E-2

IGN WIND SPEED NOTES FOR LESS THAN 30' MEAN ROOF HEIGHT:


DESIGN PER NORTH CAROLINA CODE, 2018 EDITION. WIND ZONES INSTALL 1/2" ANCHOR C. AND WITHIN 1'-0" FROM END OF ANCHOR BOLTS MUST EXTEND A 7" INTO CONCRETE OR 15" INTO CATE BOLT WITHIN MIDDLE THIRD 1TH.

WIND ZONES INSTALL 1/2" ANCHOR C. AND WITHIN 1'-0" FROM END OF ANCHOR BOLTS MUST EXTEND A 7" INTO CONCRETE OR 15" INTO CATE BOLT WITHIN MIDDLE THIRD 1TH. EIGHT IS LESS THAN 30 FEET. ULS DESIGNED FOR 120 OR 130 MPH



OSB SHEATHING ON ALL EXTERIOR STORIES IN ACCORDANCE WITH 1.10.3 OF THE NCR, 2018 EDITION. COMPLIANCE AND VALUES OF THE BUILDING TO BE IN WITH CHAPTER 11 OF THE NCR.

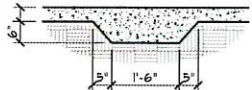


THICKENED SLAB DETAIL

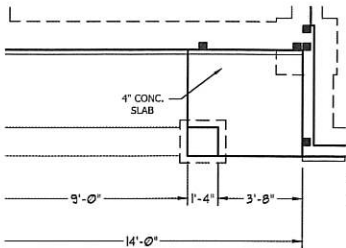


FRONT PORCH ELEVATION B

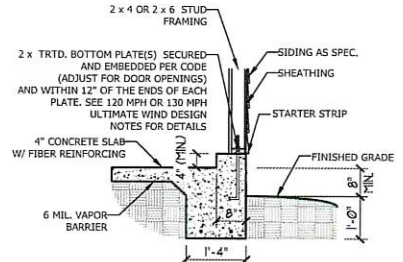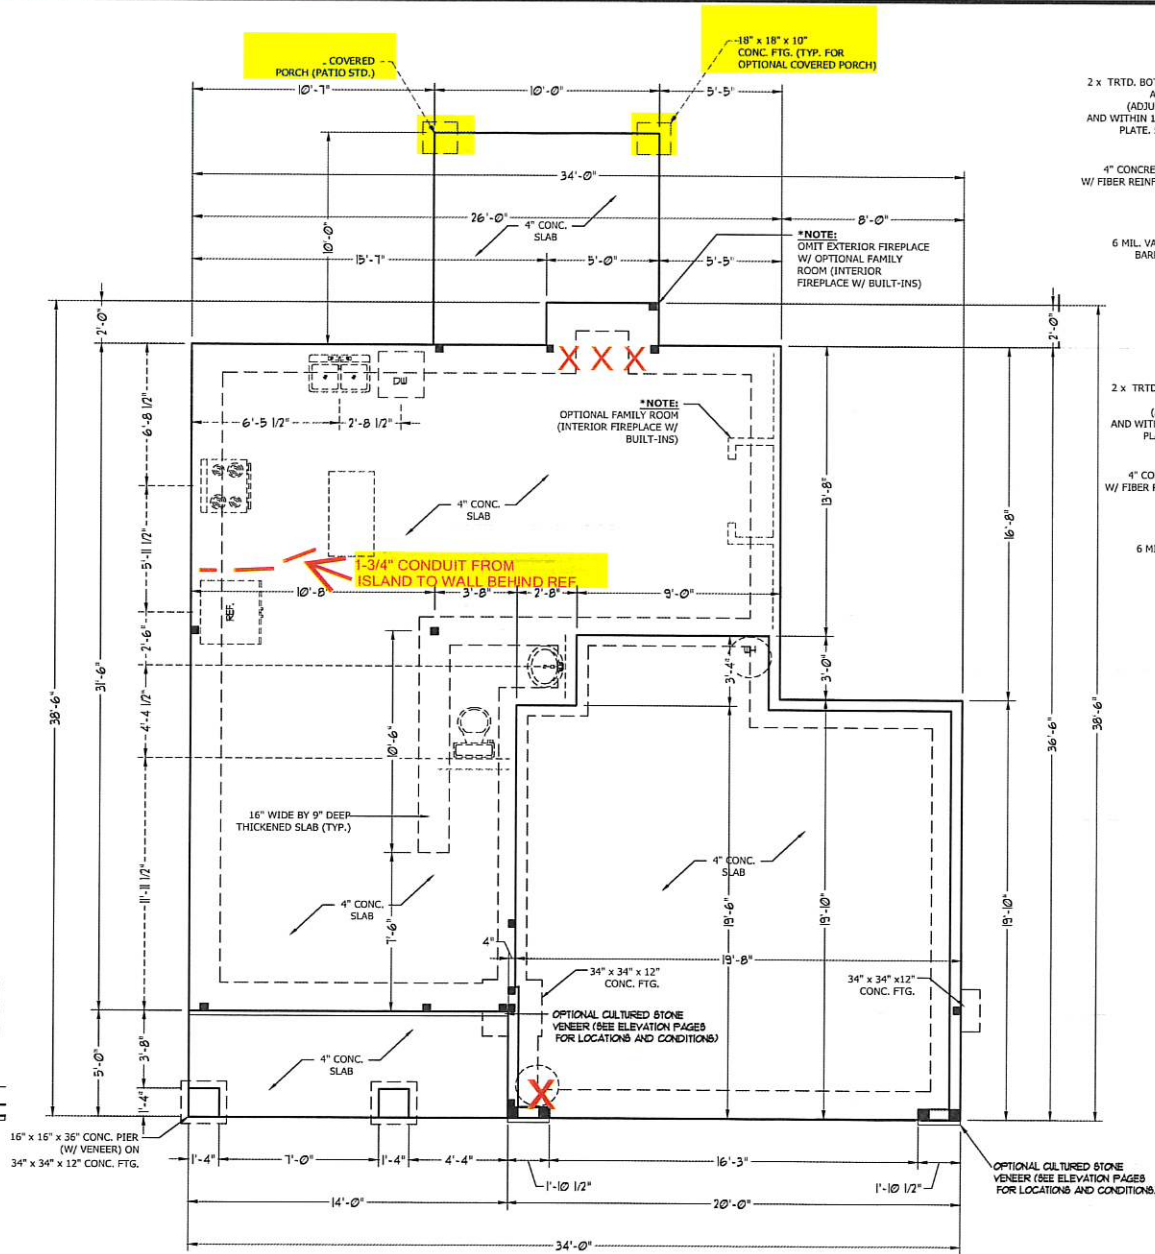



GARAGE CURB DETAIL

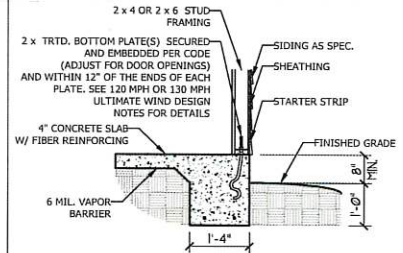

TYPICAL SLAB DETAIL

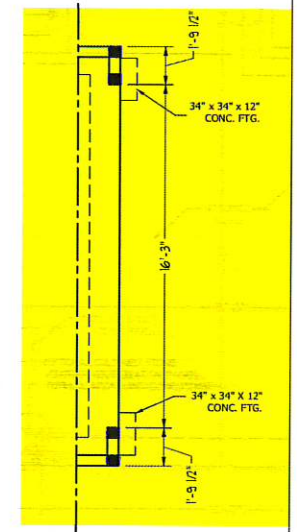

SIDE-LOAD GARAGE

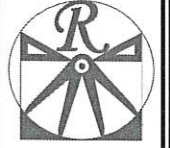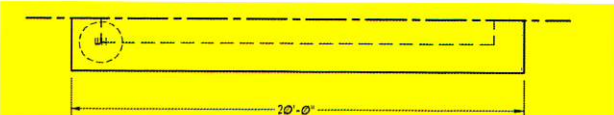

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CAROLINA COLLECTION
MAGNOLIA-II

DATE: FEBRUARY 19, 2021
REV:
SCALE: 1/4" = 1'-0"
DRAWN BY: WC
ENGINEERED BY:
REVIEWED BY:


MONO SLAB
FOUNDATION
PLAN

JRAL NOTES:




- 1. ALL TREATED LUMBER TO BE SPF #2 (UNO). ALL TREATED LUMBER TO BE SYP #2
- 2. ALL BEARING HEADERS TO BE (2) 2 x 6 (UNO).
- 3. AN EXTRA JOIST UNDER WALLS PARALLEL TO FLOOR JOISTS
- 4. ALL WINDOW AND DOOR HEADERS TO BE SUPPORTED W/ (1) JACK STUD AND (1) KING STUD (UNO.). SEE TABLE R602.7.5 FOR ADDITIONAL KING STUD REQUIREMENTS.
- 5. ALL POINT LOADS WHICH REQUIRE SOLID BLOCKING TO GIRDER OR TRUSS. ALL SQUARES TO BE (2) STUDS (UNO.)
- 6. ALL POSTS SHALL BE ANCHORED TO SLABS W/ SIMPSON ABU44 POST BASES (JAL) AND 6 X 6 POSTS W/ ABU66 POST BASES (OR EQUAL) (UNO). ALL 4 X 4 (J) & 6 POSTS TO BE INSTALLED WITH 700 LB CAPACITY UPLIFT CONNECTORS (UNO.)
- 7. ALL GLASS, ALUMINUM, OR COLUMN ENG. BY OTHERS, SECURE TO SLAB W/ ANCHOR BOLTS USING 2" CONC. SCREWS. FASTEN ANGLES ON OPPOSITE SIDE OF COLUMN. THROUGH BOLTS MUST BE INSTALLED PRIOR TO SETTING COLUMN.

WALL PANEL NOTES:

- 1. ALL EXTERIOR WALLS TO BE SHEATHED WITH 5/8" CS-SFB IN ACCORDANCE WITH SECTION R602.10.3 UNLESS OTHERWISE NOTED.
- 2. ALL INTERIOR SIDES OF EXTERIOR WALLS AND BOTH SIDES OF INTERIOR WALLS TO HAVE 1/2" GYPSUM INSTALLED. WHEN USING METHOD GB GYPSUM TO BE FASTENED PER TABLE R602.10.1.1.
- 3. ALL HOLD DOWN DEVICES FASTENED TO THE EDGE OF THE WALL PANEL NEAREST TO THE CORNER.
- 4. ALL PER TABLE R602.10.1

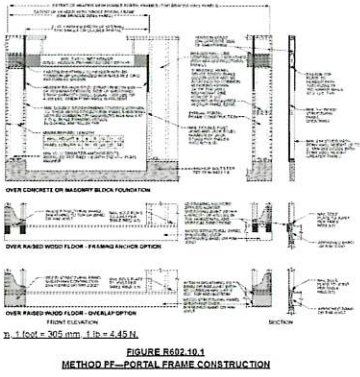

FRONT PORCH AND DINING ROOM WINDOW ELEVATION B

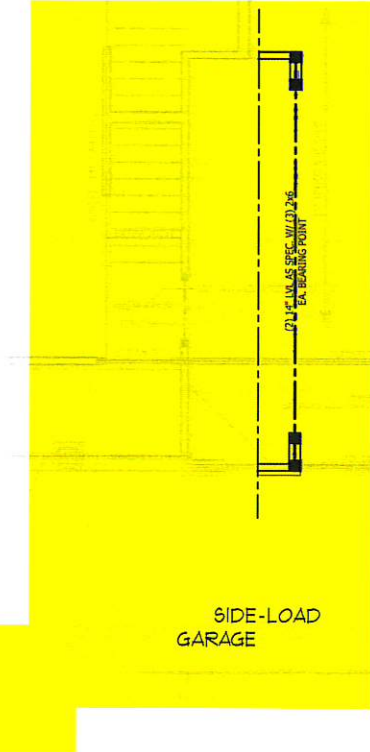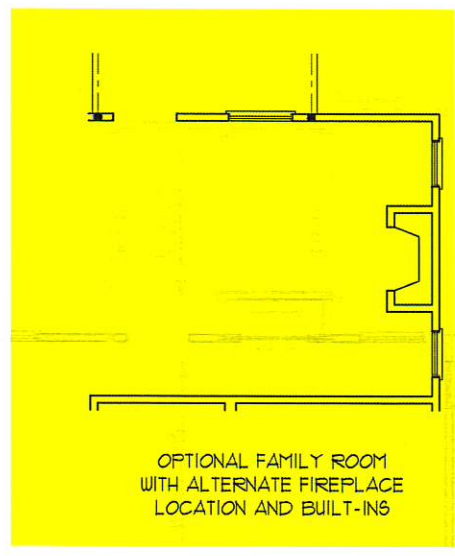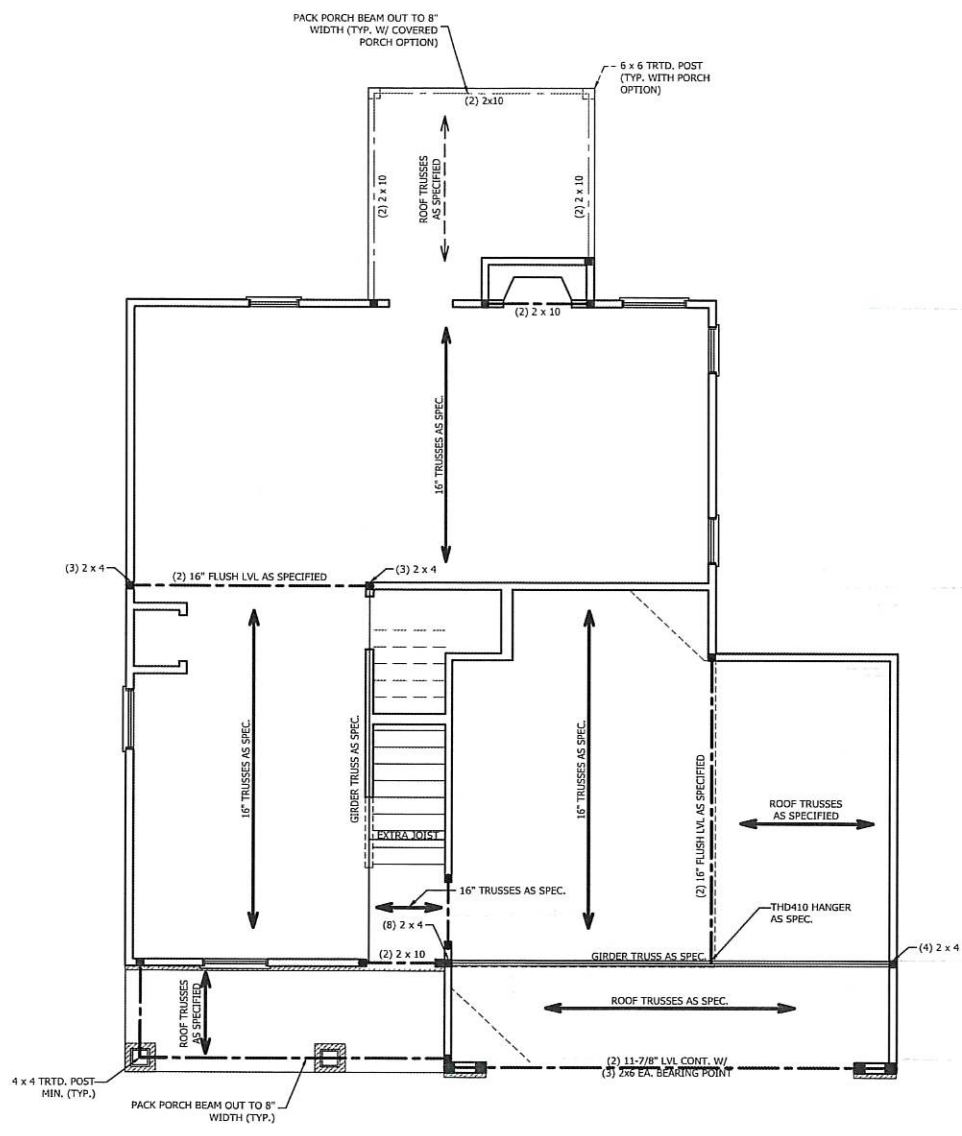

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DATE: FEBRUARY 19, 2021
REV. _____
SCALE: 1/4" = 1'-0"
DRAWN BY: WC
ENGINEERED BY: _____
REVIEWED BY: _____

SECOND FLOOR FRAMING PLAN
S-2



TABLE R602.7.5
MINIMUM NUMBER OF FULL HEIGHT STUDS
AT EACH END OF HEADERS IN EXTERIOR WALLS

HEADER SPAN (FEET)	MAXIMUM STUD SPACING (INCHES) (PER TABLE R602.3.15)	
	16	24
UP TO 3'	1	1
4'	2	1
8'	3	2
12'	5	3
16'	6	4

STRUCTURAL NOTES:

1. ALL FRAMING LUMBER TO BE SPF #2 (UNO), ALL TREATED LUMBER TO BE SYP #2 (UNO).
2. ALL LOAD BEARING HEADERS TO BE (2) 2" X 6" (UNO).
3. WINDOW AND DOOR HEADERS TO BE SUPPORTED w/ (1) JACK STUD AND (1) KING STUD EA. END (UNO), SEE TABLE R602.7.5 FOR ADDITIONAL KING STUD REQUIREMENTS.
4. SQUARES DENOTE POINT LOADS WHICH REQUIRE SOLID BLOCKING TO GIRDER OR FOUNDATION. ALL SQUARES TO BE (2) STUDS (UNO).

DSP - DOUBLE STUD POCKET
TSP - TRIPLE STUD POCKET

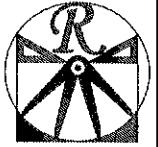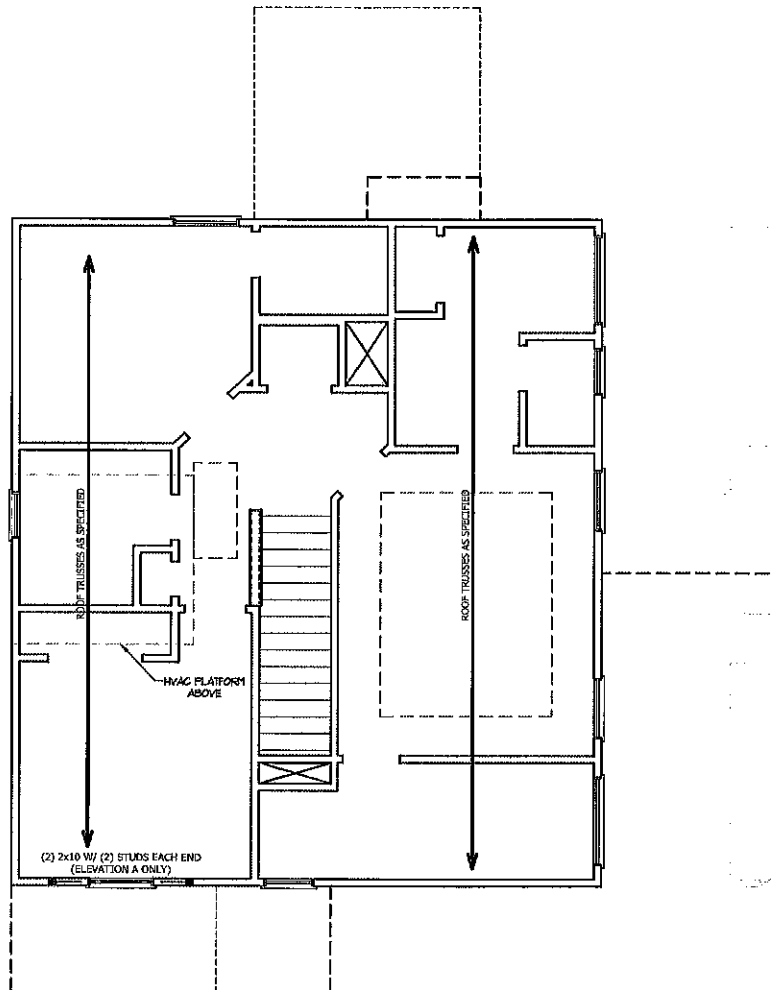

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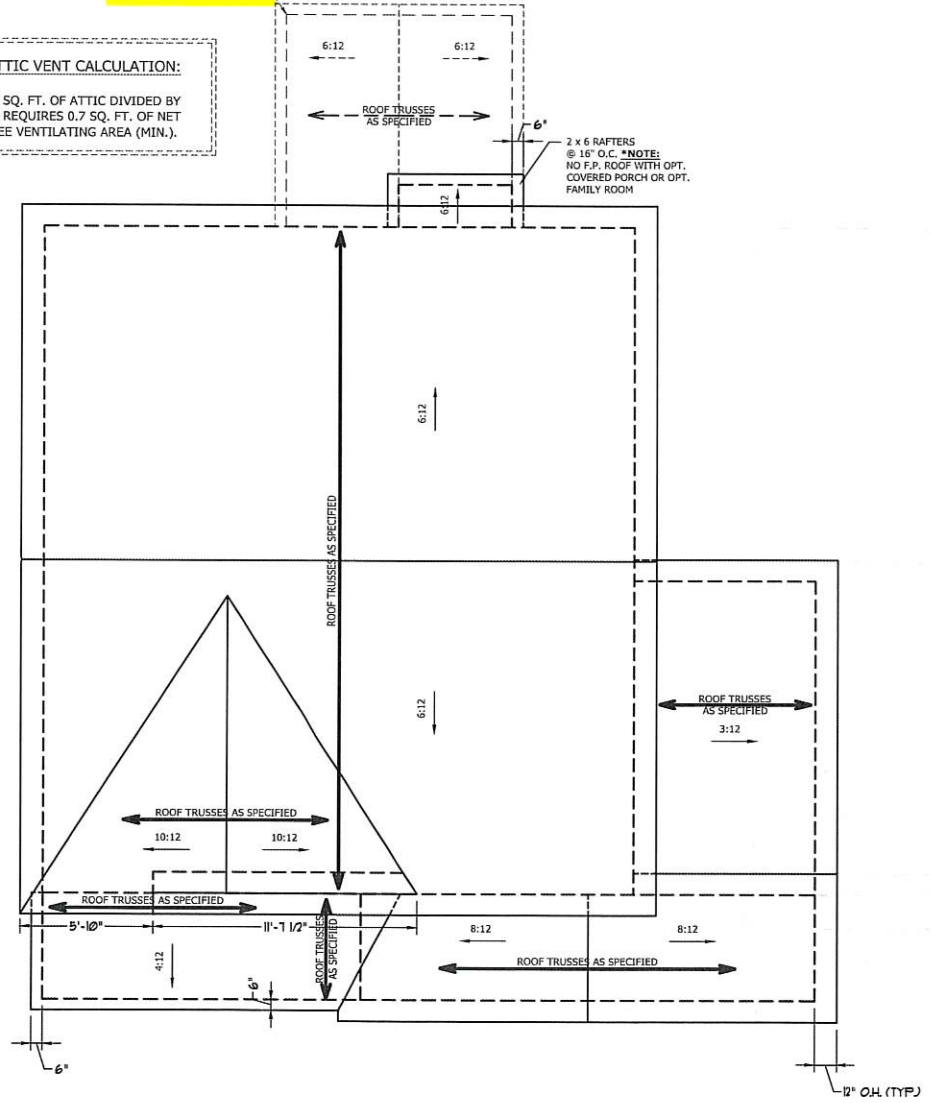
**WEAVER HOMES
CAROLINA COLLECTION
MAGNOLIA II**

DATE: FEBRUARY 19, 2021
REV. _____
SCALE: 1/4" = 1'-0"
DRAWN BY: WJG
ENGINEERED BY: _____
REVIEWED BY: _____

ATTIC FLOOR
FRAMING PLAN
S-3

ATTIC VENT CALCULATION:
 100 SQ. FT. OF ATTIC DIVIDED BY
 150 REQUIRES 0.7 SQ. FT. OF NET
 FREE VENTILATING AREA (MIN.).

COVERED
 PORCH (PATIO STD.)



ELEVATION C

ATTIC VENT CALCULATION:
 1250 SQ. FT. OF ATTIC DIVIDED BY
 150 REQUIRES 8.3 SQ. FT. OF NET
 FREE VENTILATING AREA (MIN.).

- STRUCTURAL NOTES:**
1. ALL FRAMING LUMBER TO BE #2 SPF (UNO).
 2. HIP SPLICES ARE TO BE SPACED A MIN. OF 8'-0". FASTEN MEMBERS WITH THREE ROWS OF 12d NAILS @ 16" O.C. (TYP.)
 3. STICK FRAME OVER-FRAMED ROOF SECTIONS W/ 2 x 8 RIDGES, 2 x 6 RAFTERS @ 16" O.C. AND FLAT 2 x 10 VALLEYS OR USE VALLEY TRUSSES.
 4. FASTEN FLAT VALLEYS TO RAFTERS OR TRUSSES WITH SIMPSON H2.5A HURRICANE TIES @ 32" O.C. MAX. PASS HURRICANE TIES THROUGH NOTCH IN ROOF SHEATHING. EACH RAFTER IS TO BE FASTENED TO THE FLAT VALLEY WITH A MIN. OF (6) 12d TOE NAILS.
 5. REFER TO SECTION R802.11 OF THE 2018 NCR FOR REQUIRED UPLIFT RESISTANCE AT RAFTERS AND TRUSSES.



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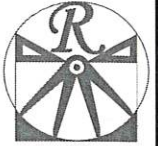
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WEAVER HOMES
CAROLINA COLLECTION
MAGNOLIA-II

DATE: FEBRUARY 19, 2021
 REV.:
 SCALE: 1/4" = 1'-0"
 DRAWN BY: WG
 ENGINEERED BY:
 REVIEWED BY:

ROOF PLAN
 ELEVATION - C
 S-4



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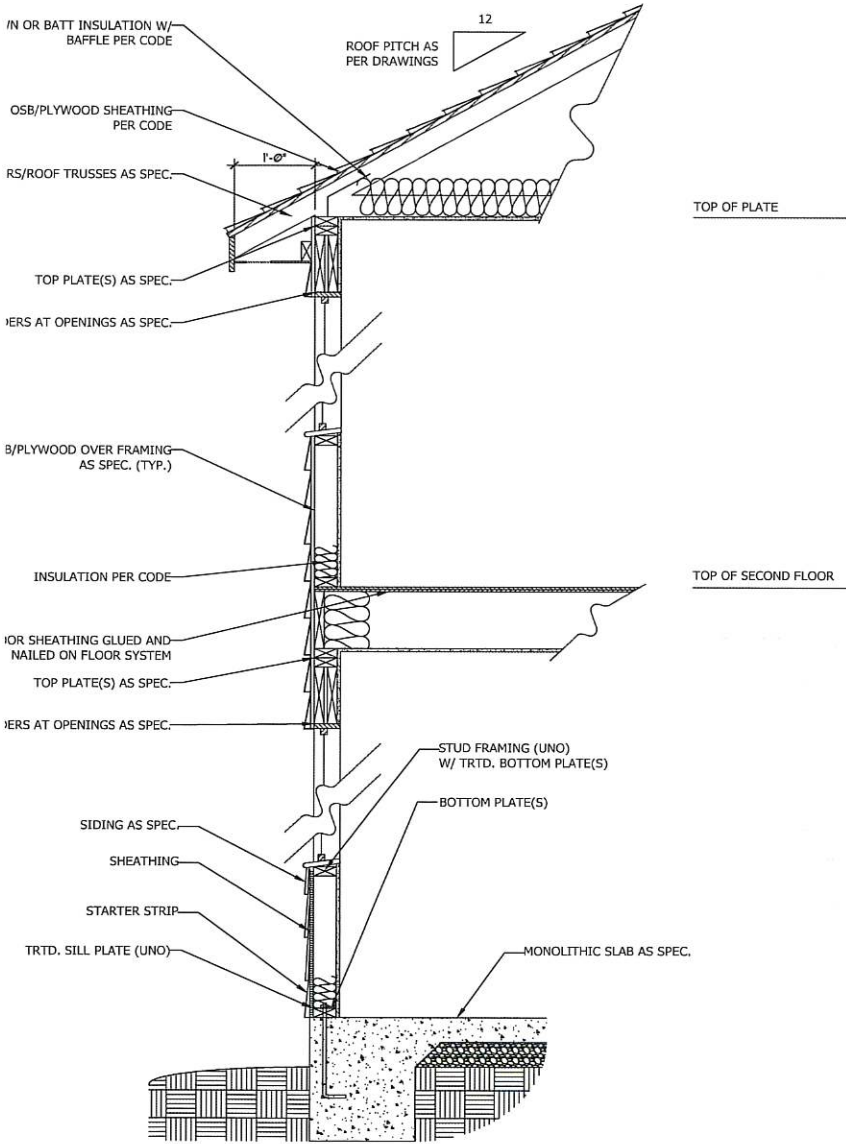
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WEAVER HOMES
CAROLINA COLLECTION
MAGNOLIA-II


DATE: FEBRUARY 19, 2021
REV. _____
SCALE: 1/4" = 1'-0"
DRAWN BY: WJC
ENGINEERED BY: _____
REVIEWED BY: _____

TYPICAL WALL SECTIONS

D-1




WALL SECTION W/ SLAB
W/ STD. SIDING SHOWN (NTS)

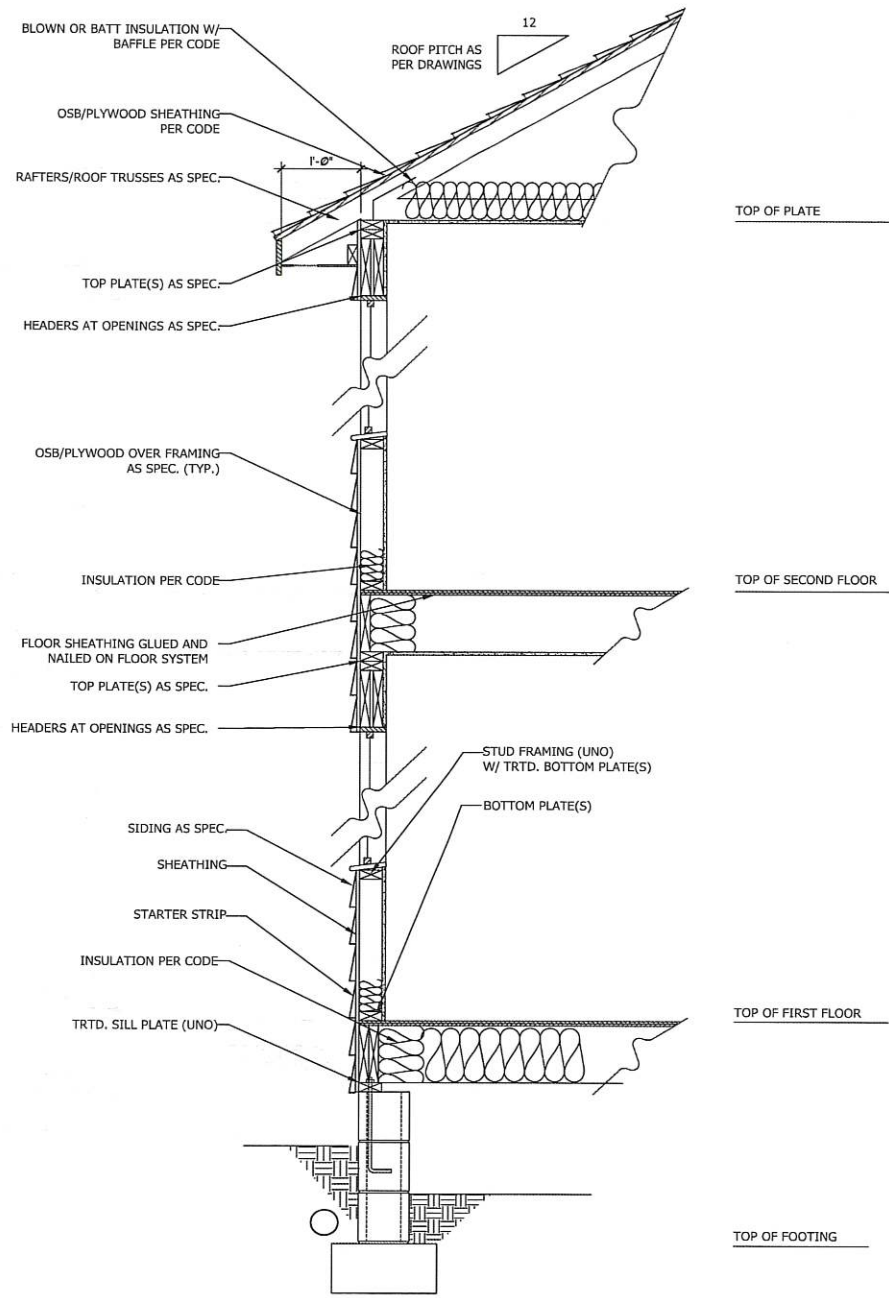

WALL SECTION W/ CRAWL SPACE
W/ STD. SIDING SHOWN (NTS)

Bearing reactions less than or equal to 3000# are deemed to comply with the prescriptive Code requirements. The contractor shall refer to the attached Tables (derived from the prescriptive Code requirements) to determine the minimum foundation size and number of wood studs required to support reactions greater than 3000# but not greater than 15000#. A registered design professional shall be retained to design the support system for any reaction that exceeds those specified in the attached Tables. A registered design professional shall be retained to design the support system for all reactions that exceed 15000#.

Signature Jonathan Landry
Jonathan Landry

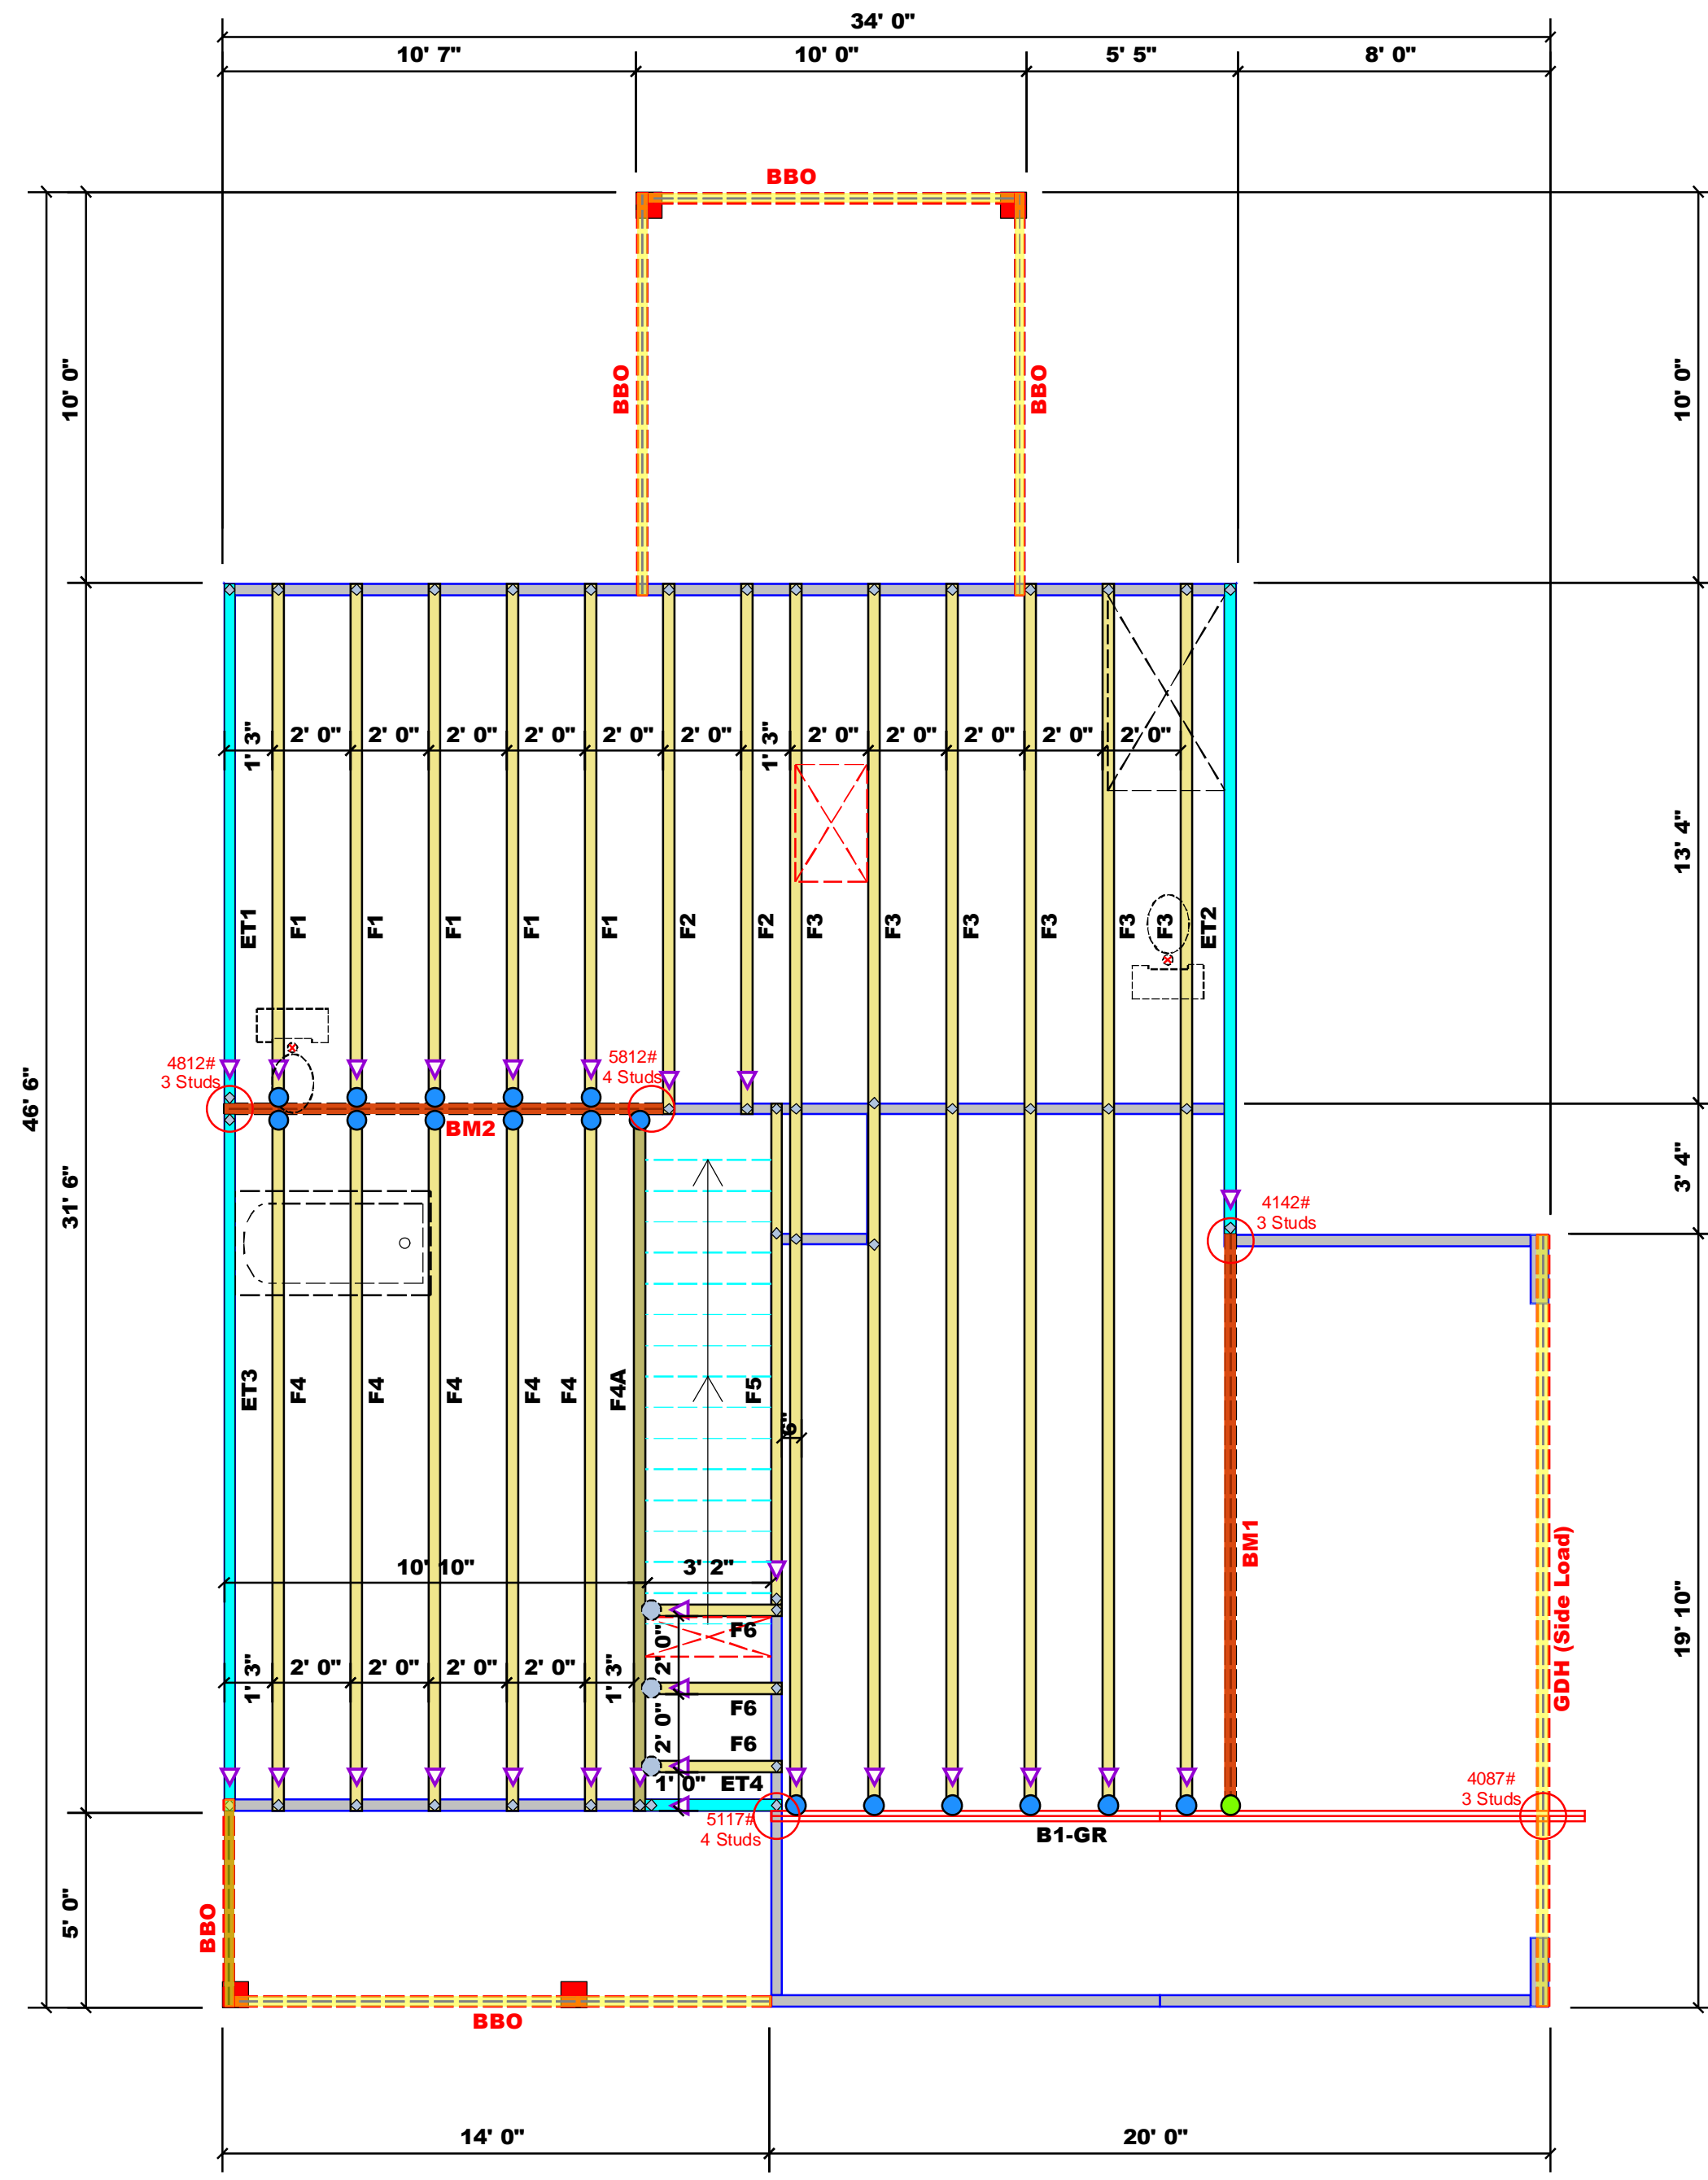

All Truss Reactions are Less than 3,000 lbs. Unless Noted Otherwise.
○ -- Denotes Reaction Greater than 3,000 lbs. Reaction / # of Studs

All Walls Shown Are Considered Load Bearing

- Plumbing Drop Notes
1. Plumbing drop locations shown are NOT exact.
 2. Contractor to verify ALL plumbing drop locations prior to setting Floor Trusses.
 3. Adjust spacing as needed not to exceed 24"oc.

- Dimension Notes
1. All exterior wall to wall dimensions are to face of sheathing unless noted otherwise
 2. All interior wall dimensions are to face of stud unless noted otherwise
 3. All exterior wall to truss dimensions are to face of stud unless noted otherwise

Hatch Legend

- Second Floor Walls
- Box Storage
- Tray Ceiling
- Flush Beam
- Drop Beam

Connector Information				Nail Information		
Sym	Product	Manuf	Qty	Supported Member	Header	Truss
●	HUS410	USP	17	NA	16d/3-1/2"	16d/3-1/2"
●	MSH422	USP	3	Varies	10d/3"	10d/3"
●	THD410	USP	1	NA	16d/3-1/2"	10d/3"

Products					
PlotID	Length	Product	Plies	Net Qty	Fab Type
BM1	15' 0"	1-3/4"x 16" LVL Kerto-S	2	2	FF
BM2	12' 0"	1-3/4"x 16" LVL Kerto-S	2	2	FF
GDH (Side Load)	20' 0"	1-3/4"x 14" LVL Kerto-S	2	2	FF

1 Truss Placement Plan
Scale: 1/4"=1'

LOAD CHART FOR JACK STUDS
(BASED ON TABLES R502.5(1) & (b))
NUMBER OF JACK STUDS REQUIRED @ EA END OF HEADER/GIRDER

END REACTION (UP TO)	REQ'D STUDS FOR (U) BY HEADER	END REACTION (UP TO)	REQ'D STUDS FOR (U) BY HEADER	END REACTION (UP TO)	REQ'D STUDS FOR (U) BY HEADER
1700	1	2550	1	3400	1
3400	2	5100	2	6800	2
5100	3	7650	3	10200	3
6800	4	10200	4	13600	4
8500	5	12750	5	17000	5
10200	6	15300	6		
11900	7				
13600	8				
15300	9				

BUILDER	JOB NAME	PLAN	SEAL DATE	QUOTE #	JOB #
Weaver Development	Lot 2 Holly Place	Magnolia II "C" / 2GRS, CP	N/A		J0223-0920


CITY / CO.	Sanford / Harnett
ADDRESS	4071 Barbeque Church Road
MODEL	Floor
DATE REV.	04/26/23
DRAWN BY	Lenny Norris
SALES REP.	Jonathan Landry

▲ = Denotes Left End of Truss
(Reference Engineered Truss Drawing)

THIS IS A TRUSS PLACEMENT DIAGRAM ONLY. These trusses are designed as individual building components to be incorporated into the building design at the specification of the building designer. See individual design sheets for each truss design identified on the placement drawing. The building designer is responsible for temporary and permanent bracing of the roof and floor system and for the overall structure. The design of the truss support structure including headers, beams, walls, and columns is the responsibility of the building designer. For general guidance regarding bracing, consult BCSI-B1 and BCSI-B3 provided with the truss delivery package or online @ sbcindustry.com

Bearing reactions less than or equal to 3000# are deemed to comply with the prescriptive Code requirements. The contractor shall refer to the attached Tables (derived from the prescriptive Code requirements) to determine the minimum foundation size and number of wood studs required to support reactions greater than 3000# but not greater than 15000#. A registered design professional shall be retained to design the support system for any reaction that exceeds those specified in the attached Tables. A registered design professional shall be retained to design the support system for all reactions that exceed 15000#.

Signature Jonathan Landry
Jonathan Landry

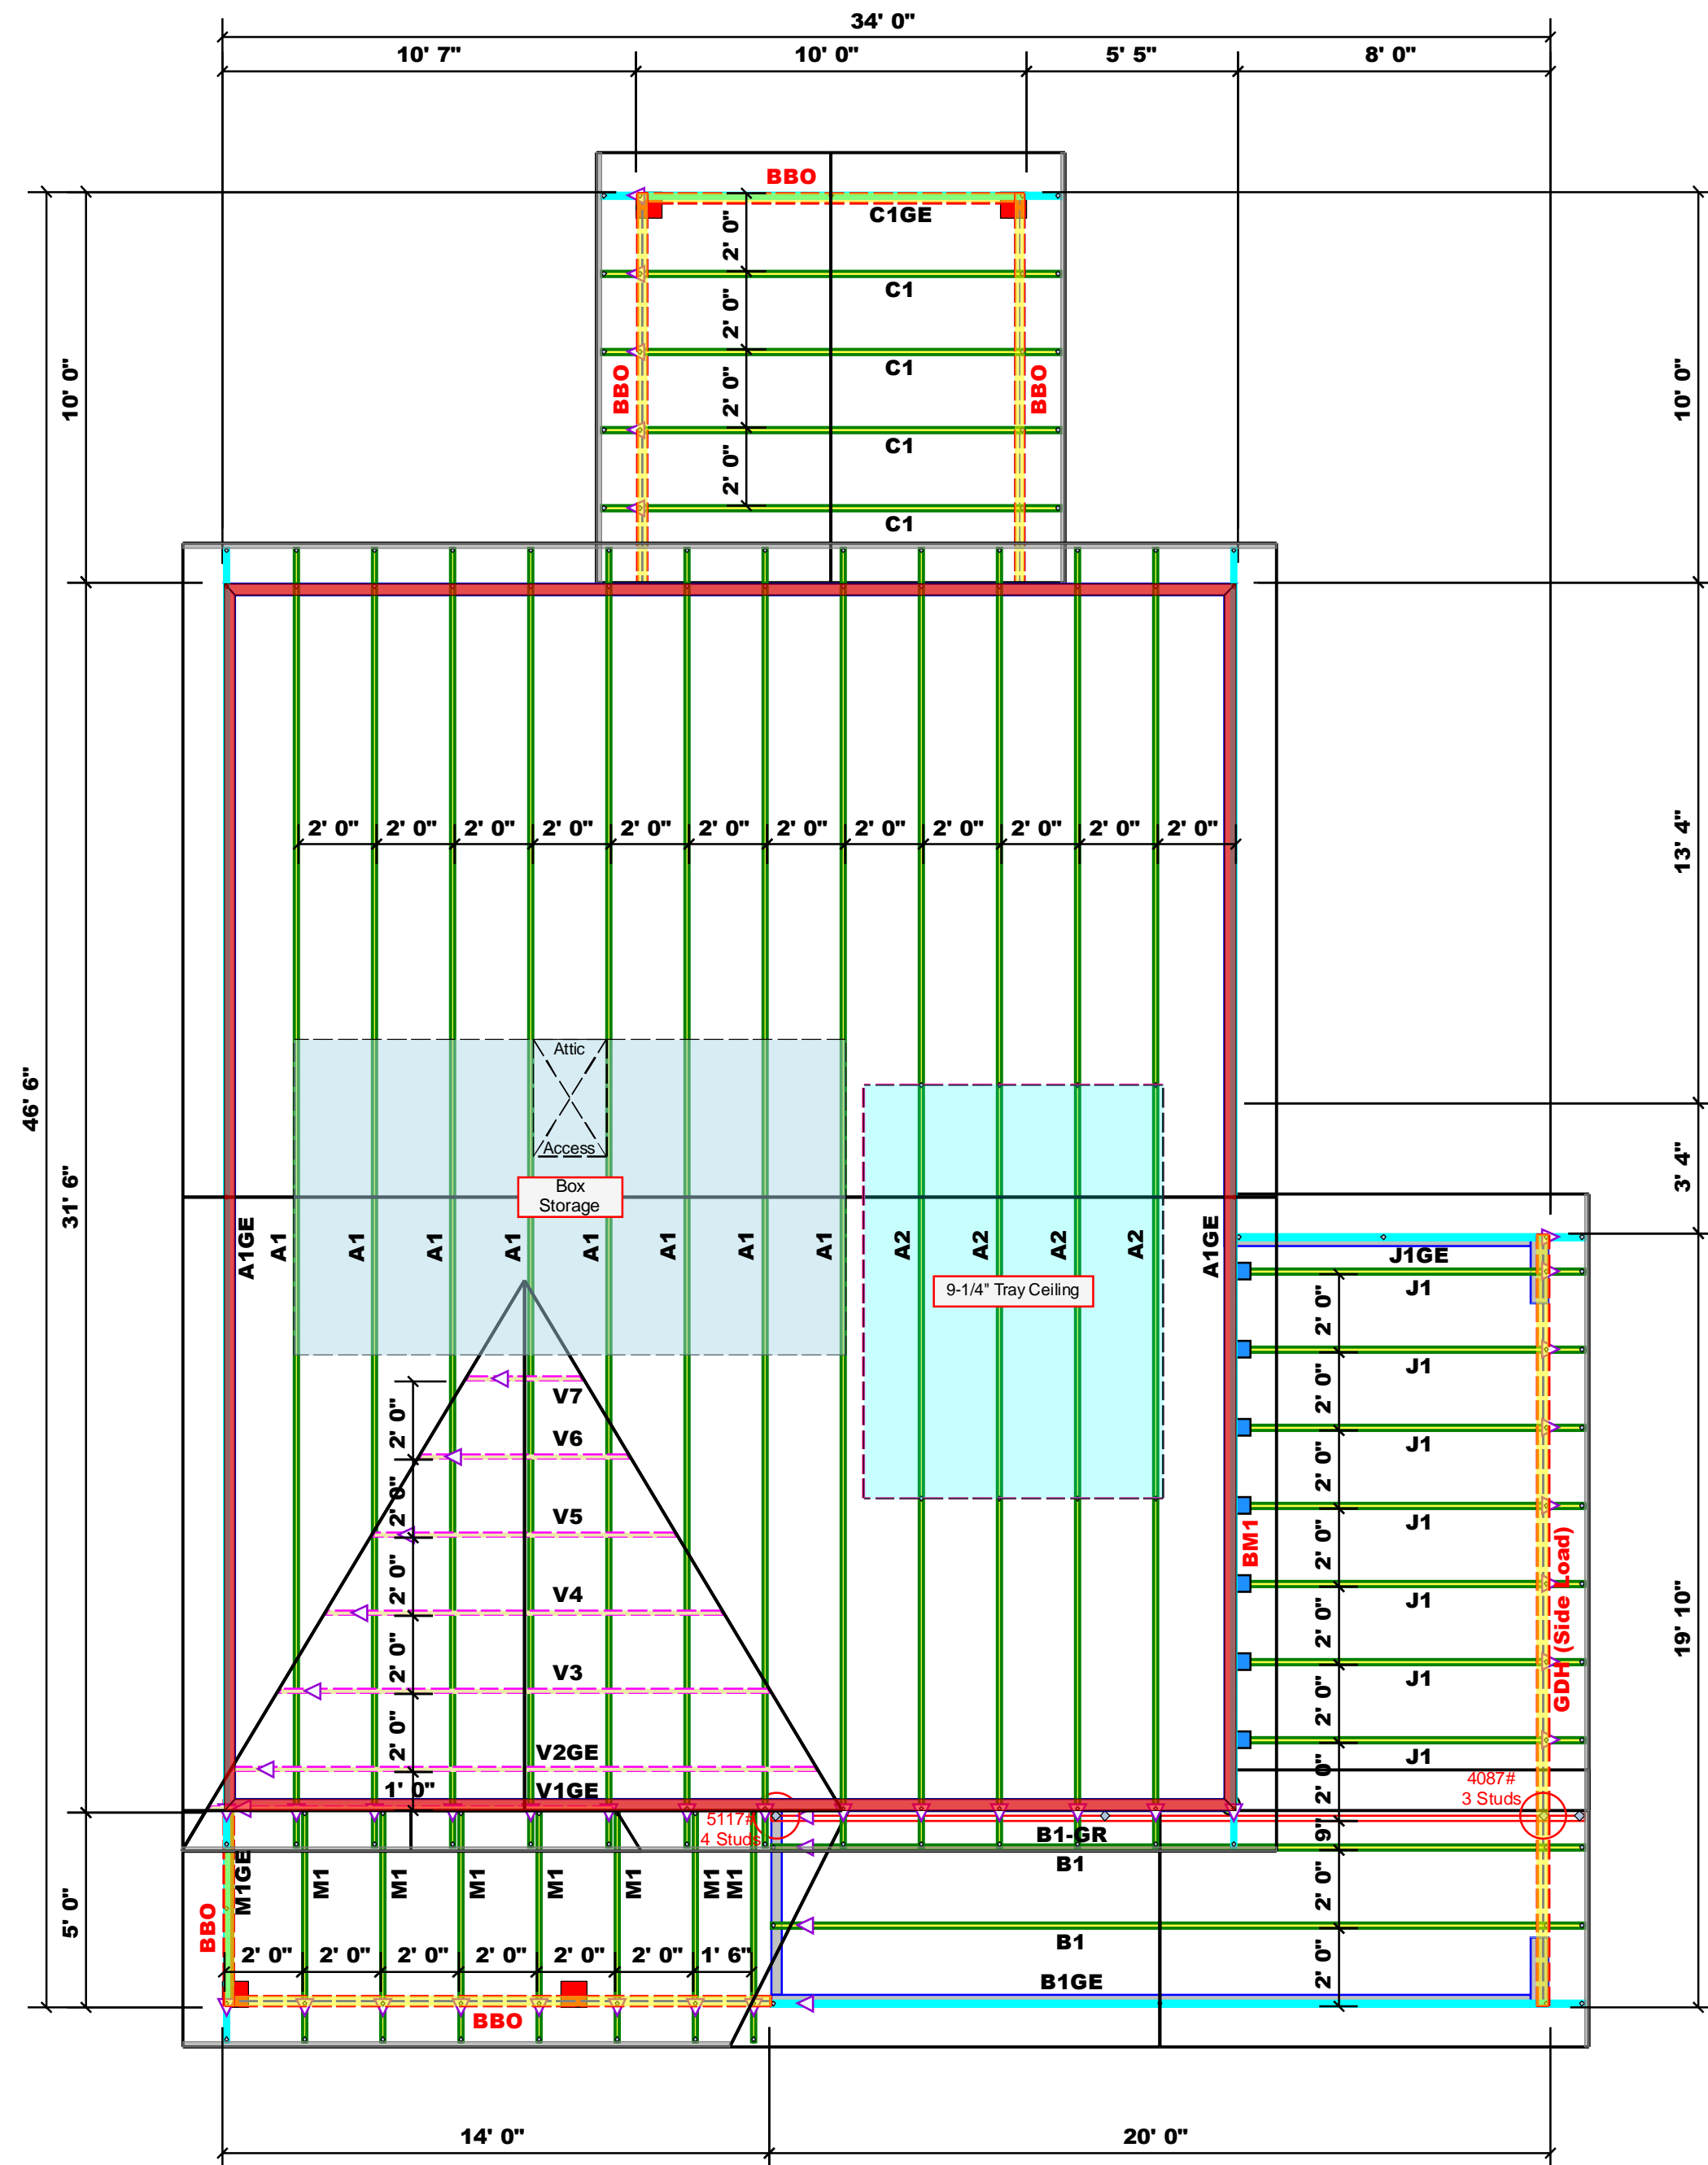

All Truss Reactions are Less than 3,000 lbs. Unless Noted Otherwise.
 ○ -- Denotes Reaction Greater than 3,000 lbs. Reaction / # of Studs

All Walls Shown Are Considered Load Bearing

Roof Area = 1637.75 sq.ft.
Ridge Line = 59.66 ft.
Hip Line = 1.32 ft.
Horiz. OH = 108.58 ft.
Raked OH = 144.92 ft.
Decking = 56 sheets

- Dimension Notes**
- All exterior wall to wall dimensions are to face of sheathing unless noted otherwise
 - All interior wall dimensions are to face of stud unless noted otherwise
 - All exterior wall to truss dimensions are to face of stud unless noted otherwise

Hatch Legend

- Second Floor Walls
- Box Storage
- Flush Beam
- Drop Beam

Connector Information					Nail Information	
Sym	Product	Manuf	Qty	Supported Member	Header	Truss
■	HUS26	USP	7	NA	16d/3-1/2"	16d/3-1/2"

Products					
PlotID	Length	Product	Plies	Net Qty	Fab Type
BM1	15' 0"	1-3/4"x 16" LVL Kerto-S	2	2	FF
BM2	12' 0"	1-3/4"x 16" LVL Kerto-S	2	2	FF
GDH (Side Load)	20' 0"	1-3/4"x 14" LVL Kerto-S	2	2	FF

1 Truss Placement Plan
Scale: 1/4"=1'

LOAD CHART FOR JACK STUDS
(BASED ON TABLES R502.5(1) & (b))

NUMBER OF JACK STUDS REQUIRED @ EA END OF HEADER/GIRDER					
END REACTION (UP TO)	REQ'D STUDS FOR (1) 1/2" HEADER	END REACTION (UP TO)	REQ'D STUDS FOR (1) 1/2" HEADER	END REACTION (UP TO)	REQ'D STUDS FOR (1) 1/2" HEADER
1700	1	2550	1	3400	1
3400	2	5100	2	6800	2
5100	3	7650	3	10200	3
6800	4	10200	4	13600	4
8500	5	12750	5	17000	5
10200	6	15300	6		
11900	7				
13600	8				
15300	9				


BUILDER	WEAVER DEVELOPMENT	CITY / CO.	SANFORD / HARNETT
JOB NAME	Lot 2 Holly Place	ADDRESS	4071 Barbeque Church Road
PLAN	Magnolia II "C" / 2GRS, CP	MODEL	Roof
SEAL DATE	N/A	DATE REV.	05/23/23
QUOTE #		DRAWN BY	Jonathan Landry
JOB #	J0223-0919	SALES REP.	Lenny Norris

▲ = Denotes Left End of Truss
(Reference Engineered Truss Drawing)

THIS IS A TRUSS PLACEMENT DIAGRAM ONLY. These trusses are designed as individual building components to be incorporated into the building design at the specification of the building designer. See individual design sheets for each truss design identified on the placement drawing. The building designer is responsible for temporary and permanent bracing of the roof and floor system and for the overall structure. The design of the truss support structure including headers, beams, walls, and columns is the responsibility of the building designer. For general guidance regarding bracing, consult BCSI-B1 and BCSI-B3 provided with the truss delivery package or online @ sbcindustry.com

GDH (Side Load) Kerto-S LVL 1.750" X 14.000" 2-Ply - PASSED

Level: Level

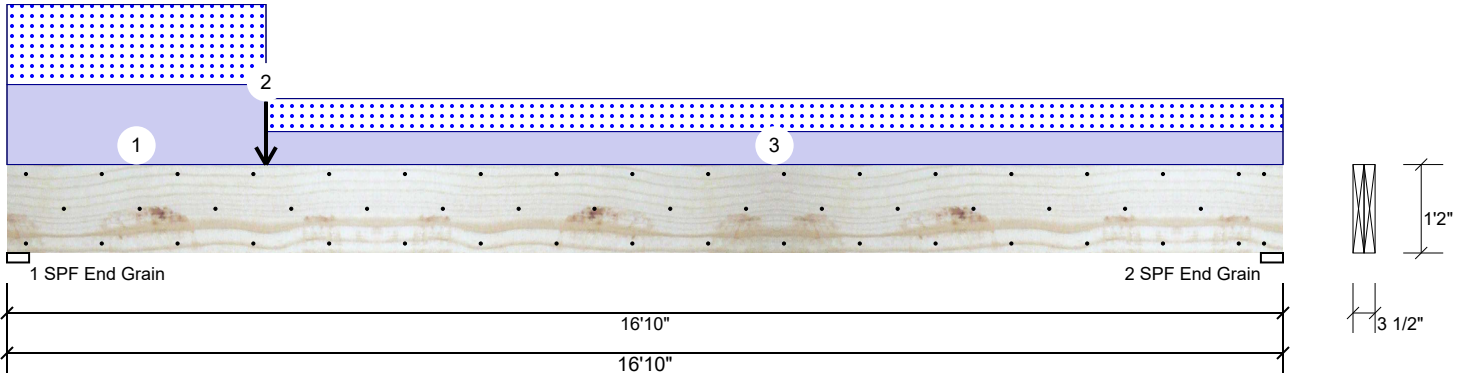

Member Information

Type:	Girder	Application:	Floor
Plies:	2	Design Method:	ASD
Moisture Condition:	Dry	Building Code:	IBC/IRC 2015
Deflection LL:	480	Load Sharing:	No
Deflection TL:	360	Deck:	Not Checked
Importance:	Normal - II	Ceiling:	Gypsum 1/2"
Temperature:	Temp <= 100°F		

Reactions UNPATTERNED lb (Uplift)

Brg	Direction	Live	Dead	Snow	Wind	Const
1	Vertical	0	2855	2764	0	0
2	Vertical	0	1260	1169	0	0

Bearings

Bearing	Length	Dir.	Cap.	React D/L lb	Total	Ld. Case	Ld. Comb.
1 - SPF End Grain	3.500"	Vert	55%	2855 / 2764	5619	L	D+S
2 - SPF End Grain	3.500"	Vert	24%	1260 / 1169	2429	L	D+S

Analysis Results

Analysis	Actual	Location	Allowed	Capacity	Comb.	Case
Moment	15402 ft-lb	3'8 3/8"	31049 ft-lb	0.496 (50%)	D+S	L
Unbraced	15402 ft-lb	3'8 3/8"	15412 ft-lb	0.999 (100%)	D+S	L
Shear	5000 lb	1'5 1/2"	12021 lb	0.416 (42%)	D+S	L
LL Defl inch	0.228 (L/861)	7'8 1/16"	0.409 (L/480)	0.558 (56%)	S	L
TL Defl inch	0.468 (L/420)	7'8 5/16"	0.546 (L/360)	0.858 (86%)	D+S	L

Design Notes

- Provide support to prevent lateral movement and rotation at the end bearings. Lateral support may also be required at the interior bearings by the building code.
- Fasten all plies using 3 rows of 10d Box nails (.128x3") at 12" o.c. Maximum end distance not to exceed 6".
- Refer to last page of calculations for fasteners required for specified loads.
- Girders are designed to be supported on the bottom edge only.
- Top loads must be supported equally by all plies.
- Top must be laterally braced at a maximum of 6'7 7/16" o.c.
- Lateral slenderness ratio based on single ply width.

ID	Load Type	Location	Trib Width	Side	Dead 0.9	Live 1	Snow 1.15	Wind 1.6	Const. 1.25	Comments
1	Part. Uniform	0-0-0 to 3-5-0		Top	211 PLF	0 PLF	211 PLF	0 PLF	0 PLF	B1
2	Point	3-5-0		Top	2044 lb	0 lb	2044 lb	0 lb	0 lb	B1-GR
	Bearing Length	0-3-8								
3	Part. Uniform	3-5-0 to 16-10-0		Top	87 PLF	0 PLF	87 PLF	0 PLF	0 PLF	J1
	Self Weight				11 PLF					

Notes

Calculated Structured Designs is responsible only of the structural adequacy of this component based on the design criteria and loadings shown. It is the responsibility of the customer and/or the contractor to ensure the component suitability of the intended application, and to verify the dimensions and loads.

Lumber

- Dry service conditions, unless noted otherwise
- LVL not to be treated with fire retardant or corrosive chemicals

Handling & Installation

- LVL beams must not be cut or drilled
- Refer to manufacturer's product information regarding installation requirements, multi-ply fastening details, beam strength values, and code approvals
- Damaged Beams must not be used
- Design assumes top edge is laterally restrained

6. For flat roofs provide proper drainage to prevent ponding

This design is valid until 11/3/2024

Manufacturer Info


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 Norwalk, CT 06851
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Comtech
 Reilly Road Industrial Park P.O. Box 40408, NC
 USA
 28309
 910-864-8787



GDH (Side Load) Kerto-S LVL 1.750" X 14.000" 2-Ply - PASSED

Level: Level

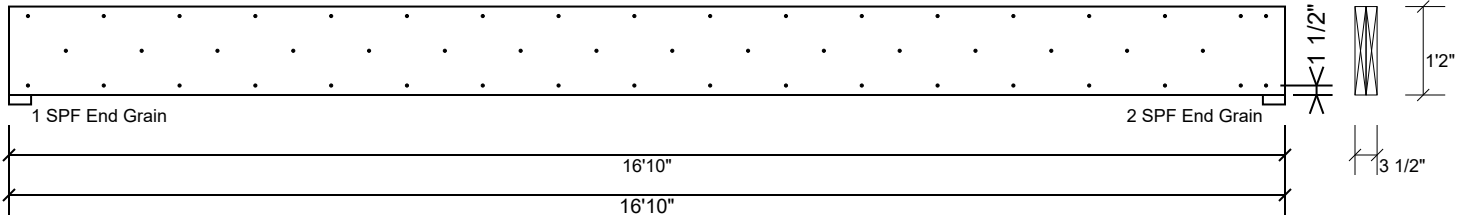

Multi-Ply Analysis

Fasten all plies using 3 rows of 10d Box nails (.128x3") at 12" o.c.. Maximum end distance not to exceed 6".

Capacity	0.0 %
Load	0.0 PLF
Yield Limit per Foot	245.6 PLF
Yield Limit per Fastener	81.9 lb.
Yield Mode	IV
Edge Distance	1 1/2"
Min. End Distance	3"
Load Combination	
Duration Factor	1.00

Notes

Calculated Structured Designs is responsible only of the structural adequacy of this component based on the design criteria and loadings shown. It is the responsibility of the customer and/or the contractor to ensure the component suitability of the intended application, and to verify the dimensions and loads.

Lumber

1. Dry service conditions, unless noted otherwise
2. LVL not to be treated with fire retardant or corrosive

chemicals

Handling & Installation

1. LVL beams must not be cut or drilled
2. Refer to manufacturer's product information regarding installation requirements, multi-ply fastening details, beam strength values, and code approvals
3. Damaged Beams must not be used
4. Design assumes top edge is laterally restrained
5. Provide lateral support at bearing points to avoid lateral displacement and rotation

6. For flat roofs provide proper drainage to prevent ponding

This design is valid until 11/3/2024

Manufacturer Info

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