
Residence for

nesidence iu	NOTICE TO CONTRACTOR All contaniotion much comprise with current RC Building Codes and is subject to field support and wellfoldion.	
Garman Homes	Limite during environment Permit buder responsible for following and the code Harpenett	
	03/01/2023	
Lot 0082 Serenity		
Fuquay Varina, North	Carolina See Pg 2 notes	
INDEX TO I	DRAWINGS	
COVER SHEET 1 FRONT & LEFT SIDE ELEVATIONS 2 REAR & RIGHT SIDE ELEVATIONS 3 FIRST & SECOND FLOOR PLANS E FIRST & SECOND FLOOR ELECTRICAL PLANS M FIRST & SECOND FLOOR MECHANICAL PLANS P FIRST FLOOR PLUMBING PLAN D CONSTRUCTION DETAILS	S1FOUNDATION PLAN - CRAWLSPACE STANDARDS2FIRST FLOOR FRAMING PLANS3SECOND FLOOR FRAMING PLAN - PULL DOWN STAIR STANDARDS4ROOF FRAMING PLANSD1STRUCTURAL DETAILSSD2STRUCTURAL DETAILSSD3STRUCTURAL DETAILSSPECCONSTRUCTION SPECIFICATIONS	
GENERAL NOTES 1. ALL WORK TO BE DONE IN STRICT ACCORDANCE WITH NORTH CAROLINA STATE RESIDENTIAL BUILDING CODE, 2018 EDITION (HEREWITH SHOWN AS N.C.S.R.B.C.).	RESIDENTIAL BUILDING CODE SUMMARY 1. PLANS ARE DESIGNED TO THE 2018 N.C.S.R.B.C. 2. HOUSE IS DESIGNED FOR 115 MPH ULTIMATE DESIGN WIND SPEED (89 MPH NOMINAL DESIGN WIND SPEED), EXPOSURE B.	
2. DIMENSIONS SHOWN ON DRAWINGS GOVERN OVER SCALE.	3. ANCHOR BOLTS SHALL BE MIN. 1/2" DIAMETER AND SHALL EXTEND 7" MIN. INTO	
3. STUD WALL DESIGN SHALL CONFORM TO ALL N.C.S.R.B.C. REQUIREMENTS	MASONRY OR CONCRETE. BOLTS TO BE NO MORE THAN 6' O.C. AND WITHIN 12" FROM THE CORNER.	
4. CONTRACTOR SHALL USE TEMPERED SAFETY GLASS IN ALL LOCATIONS AS REQUIRED BY N.C.S.R.B.C., 2018 EDITION, SECTION R308.4.	 MEAN ROOF HEIGHT: 28'-10" COMPONENT & CLADDING DESIGNED FOR THE FOLLOWING LOADS: 	
5. ANY HABITABLE ROOM SHALL MEET ALL LIGHT/VENTILATION AND EGRESS AS REQUIRED BY N.C.S.R.B.C. 2018 EDITION, SECTIONS R-303.1 AND R-310.1.	MEAN ROOF HGT: UP TO 30' 30'-1" TO 35' 35'-1" TO 40' 40'-1" TO 45' ZONE 1 16.5,-18.0 17.3,-18.9 17.3,-18.9 17.3,-18.9 ZONE 2 16.5,-21.0 17.3,-22.1 17.3,-22.1 17.3,-22.1 ZONE 3 16.5,-21.0 17.3,-22.1 17.3,-22.1 17.3,-22.1	
6. ALL EXTERIOR WALLS SHOWN ON FLOOR PLANS ARE 2X6 FRAME UNLESS NOTED OTHERWISE. ALL INTERIOR WALLS SHOWN ON FLOOR PLANS ARE 2X4 FRAME UNLESS NOTED OTHERWISE.	ZONE 4 18.0,-19.5 18.9,-20.5 18.9,-20.5 18.9,-20.5 ZONE 5 18.0,-24.1 18.9,-25.3 18.9,-25.3 18.9,-25.3 6. MINIMUM VALUES FOR ENERGY COMPLIANCE: Zone 4 2000 2000	
7. ALL ANGLED WALLS SHOWN ON FLOOR PLANS ARE 45 UNLESS NOTED OTHERWISE.	7. MAXIMUM GLAZING U-FACTOR: .35	
8. ALL WINDOWS SHALL HAVE A MINIMUM DPI RATING OF 25. BUILDER SHALL VERIFY WITH WINDOW MANUFACTURER THAT UNITS INSTALLED	8. INSULATING VALUES: CEILING: R-38 / WALLS: R-15 / FLOOR: R-19 SLABS: R-10. CODE REFERENCE: TABLE N1102.1	
MEET THESE REQUIREMENTS AS PER N.C.S.R.B.C., 2018 EDITION, TABLE 301.2(4).	AREA CALCULATIONS	
9. ENERGY EFFICIENCY REQUIREMENTS FOR THE SPECIFIC CLIMATE ZONE WHERE STRUCTURE IS BEING BUILT SHALL BE IN ACCORDANCE WITH CHAPTER 11 OF THE N.C.S.R.B.C., 2018 EDITION, AS SHOWN IN SECTION N1101.2.	HEATED (SQ. FT.)UNHEATED (SQ. FT.)UNFINISHED (SQ. FT.)BASEMENT:N/AGARAGE:260BASEMENT:N/A1ST FLOOR:1163FRONT PORCH:1121ST FLOOR:N/A2ND FLOOR:702PATIO:1002ND FLOOR:132SCREEN PORCH:ATTIC:N/A	
MATERIALS LEGEND	TOTAL: 1865 (OPTIONAL) N/A TOTAL: 132 TOTAL: 472 132	
EARTH/COMPACT FINISH WOOD	OVERALL DIMENSIONS WIDTH: 43'-6"	
CONCRETE ROUGH WOOD	FOUNDATION VENTILATION CALCULATIONS	
BRICK BLOCKING	(REFERENCE: N.C.S.R.B.C. 2018 EDITION SECTION R408)	
CONCRETE BLOCK/STONE	NOT APPLICABLE WITH SLAB FOUNDATIONS	
STEEL BATT INSULATION		
ALUMINUM		
TOILET ACCESSORIES LEGEND PROVIDE 2X4 BLOCKING IN THE WALL FOR THE FOLLOWING: TB TOWEL BAR TP TOILET PAPER HOLDER TP TOILET PAPER HOLDER	ATTIC VENTILATION REQUIREMENTS NATURAL ROOF VENTILATION CALCULATIONS <u>1535 SQ. FT.</u> = 10.23 SQ. FT. VENT REQ'D 1535 SQ. FT. = 5.12 SQ. FT. VENT REQ'D	
TR TOWEL RING MC MEDICINE CABINET MR MAGAZINE RACK	150 300 BUILDER TO PROVIDE APPROPRIATE BUILDER TO PROVIDE APPROPRIATE VENTILATING AS REQUIRED PER CODE VENTILATING AS REQUIRED PER CODE	

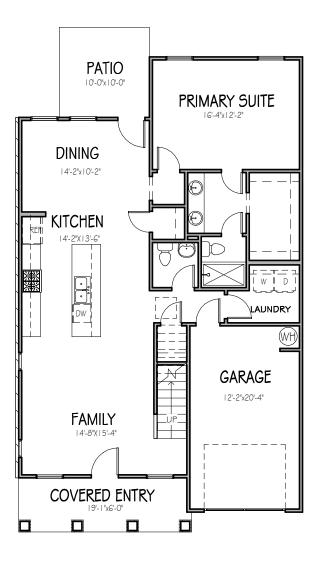







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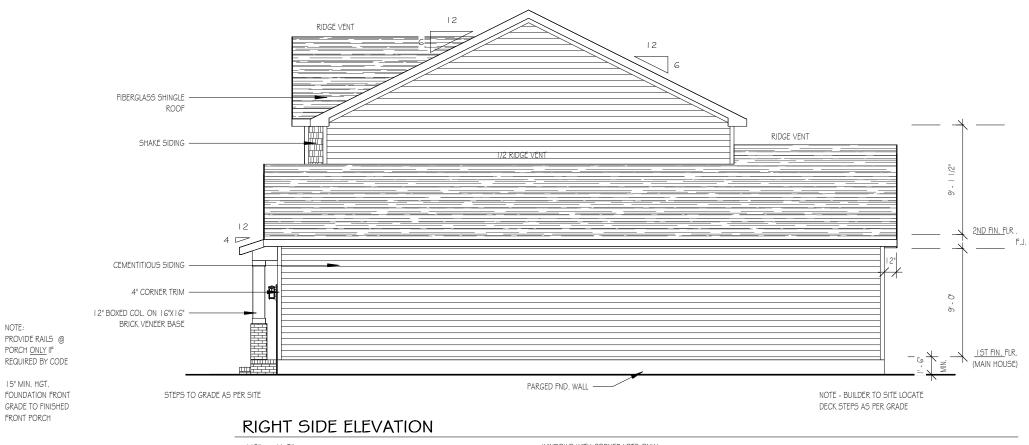


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4/5/22

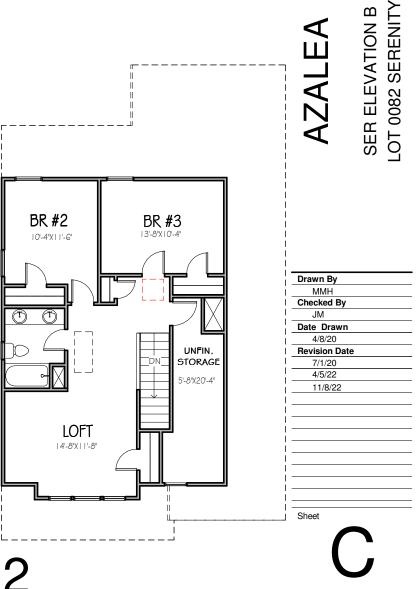

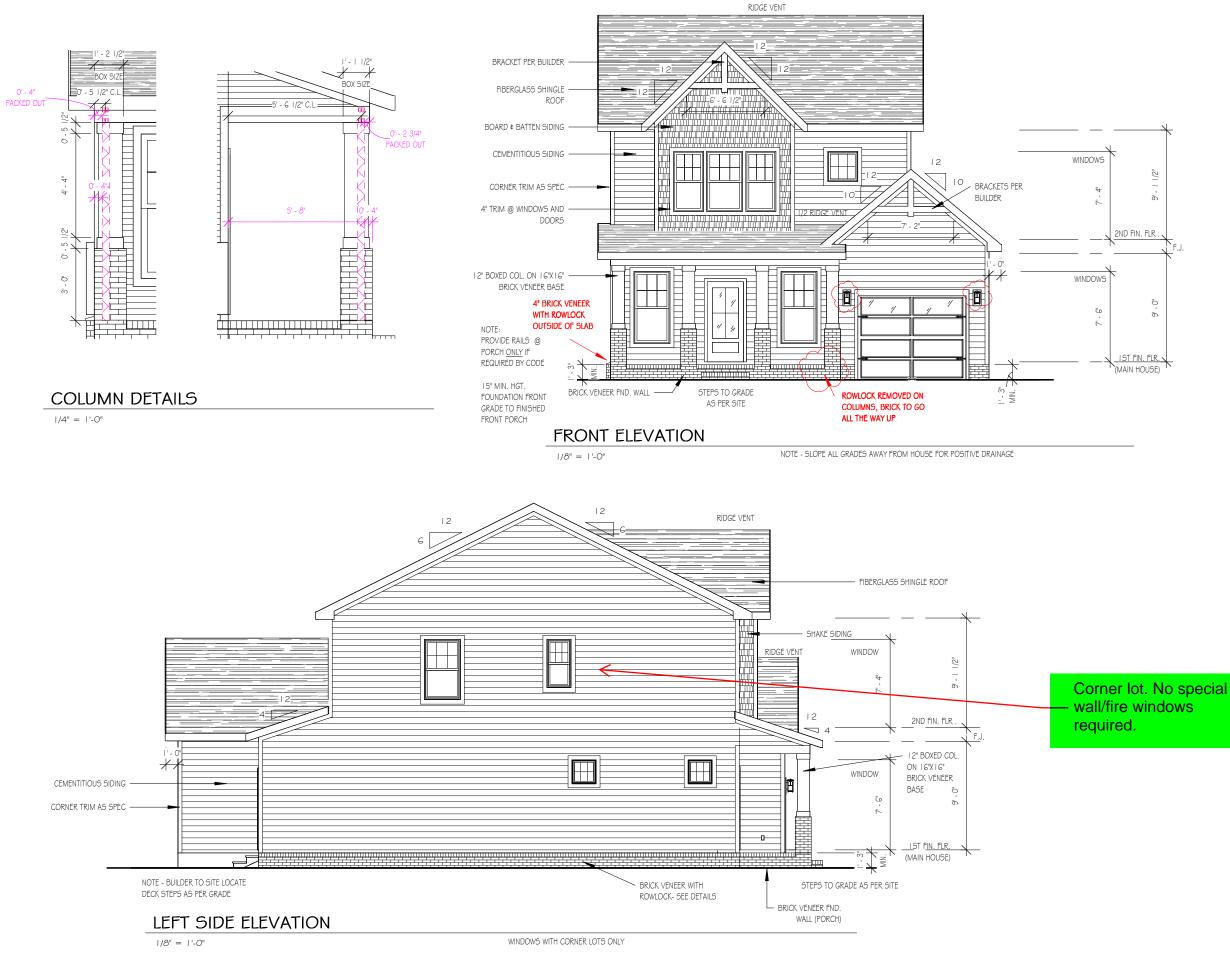REAR ELEVATION






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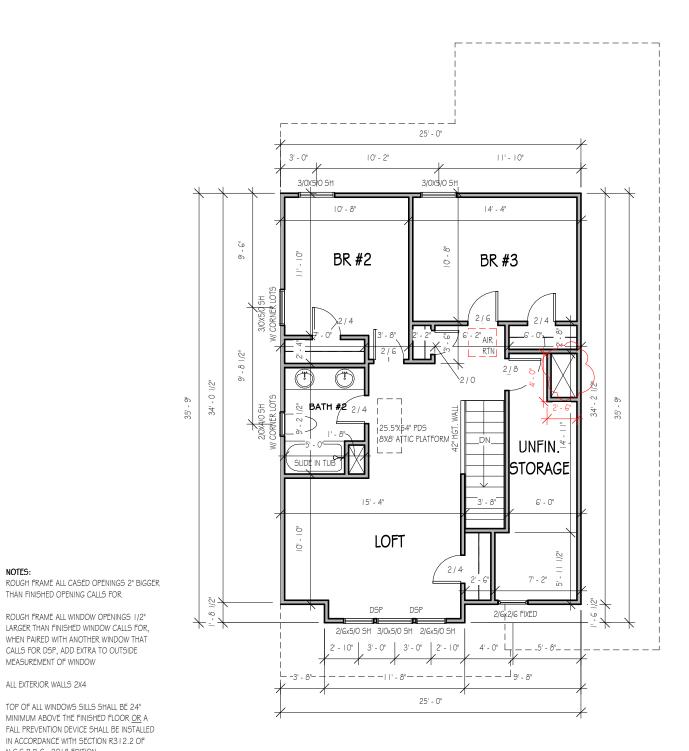
ROUGH FRAME ALL CASED OPENINGS 2" BIGGER THAN FINISHED OPENING CALLS FOR

ROUGH FRAME ALL WINDOW OPENINGS 1/2" LARGER THAN FINISHED WINDOW CALLS FOR, WHEN PAIRED WITH ANOTHER WINDOW THAT CALLS FOR DSP, ADD EXTRA TO OUTSIDE MEASUREMENT OF WINDOW

ALL EXTERIOR WALLS 2X4

TOP OF ALL WINDOWS SILLS SHALL BE 24" MINIMUM ABOVE THE FINISHED FLOOR OR A FALL PREVENTION DEVICE SHALL BE INSTALLED IN ACCORDANCE WITH SECTION R312.2 OF N.C.S.R.B.C., 2018 EDITION

GBG (GRILL BEWTEEEN GLASS) TO BE ADDED TO CORNER LOT WINDOWS

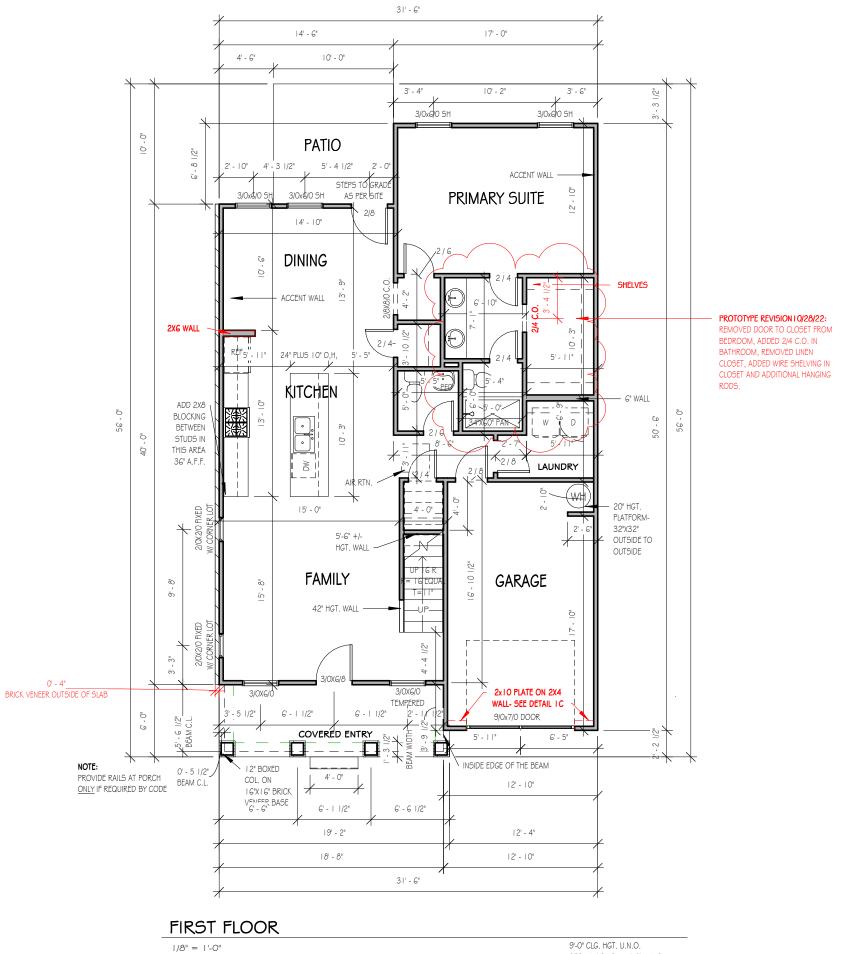

SECOND FLOOR

1/8" = 1'-0"

NOTES:

THAN FINISHED OPENING CALLS FOR

ROUGH FRAME ALL WINDOW OPENINGS 1/2" LARGER THAN FINISHED WINDOW CALLS FOR,

WHEN PAIRED WITH ANOTHER WINDOW THAT

CALLS FOR DSP, ADD EXTRA TO OUTSIDE MEASUREMENT OF WINDOW

TOP OF ALL WINDOWS SILLS SHALL BE 24" MINIMUM ABOVE THE FINISHED FLOOR OR A

ALL EXTERIOR WALLS 2X4

N.C.S.R.B.C., 2018 EDITION

9'-0" CLG. HGT. U.N.O. SET WINDOWS @ 7'-4" U.N.O.

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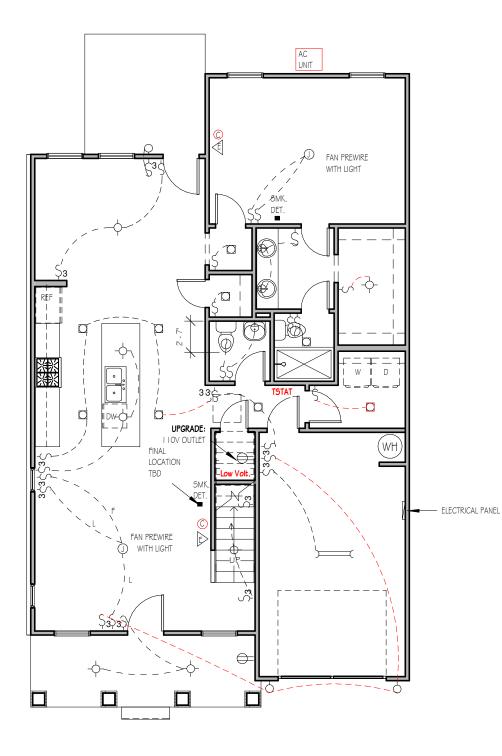



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**NOTE: THREE ETHERNET OUTLETS IN THESE PREDETERMINED LOCATIONS ARE STANDARD. ANY ADDITIONAL OUTLETS ARE AN UPGRADE.

FIRST FLOOR ELECTRICAL PLAN

1/8" = 1'-0"

NOTE - ELECTRICAL RECEPTACLE AND SWITCH QUANTITIES AND LOCATIONS SHOWN ON PLAN ARE FOR ILLUSTRATION PURPOSES ONLY. ACTUAL NUMBER AN D LOCATIONS SHALL BE FIELD DETERMINED AS PER CLIENT AND BUILDER EXCEPT WHERE CODE REQUIREMENTS APPLY.

SECOND FLOOR ELECTRICAL PLAN

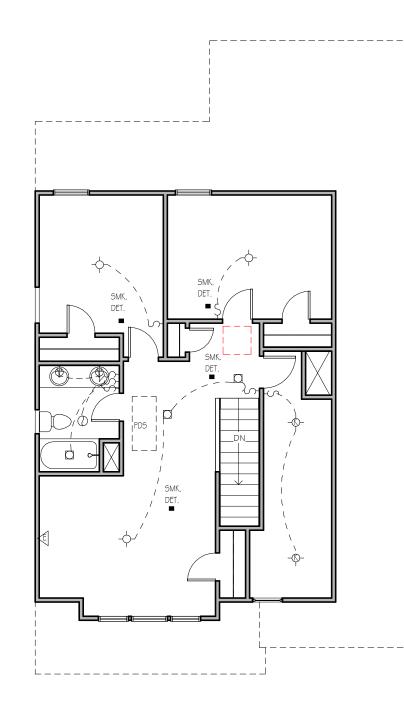1/8" = 1'-0"

NOTE - ELECTRICAL RECEPTACLE AND SWITCH QUANTITIES AND LOCATIONS SHOWN ON PLAN ARE FOR ILLUSTRATION PURPOSES ONLY. ACTUAL NUMBER AN D LOCATIONS SHALL BE FIELD DETERMINED AS PER CLIENT AND BUILDER EXCEPT WHERE CODE REQUIREMENTS APPLY.

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ELECTRICAL LECEND



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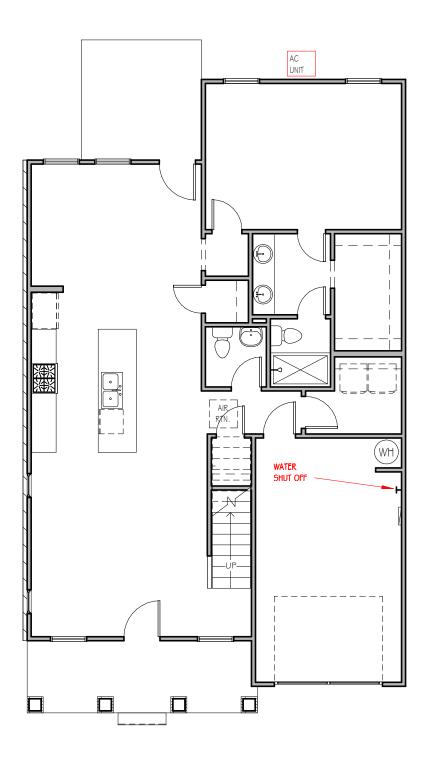


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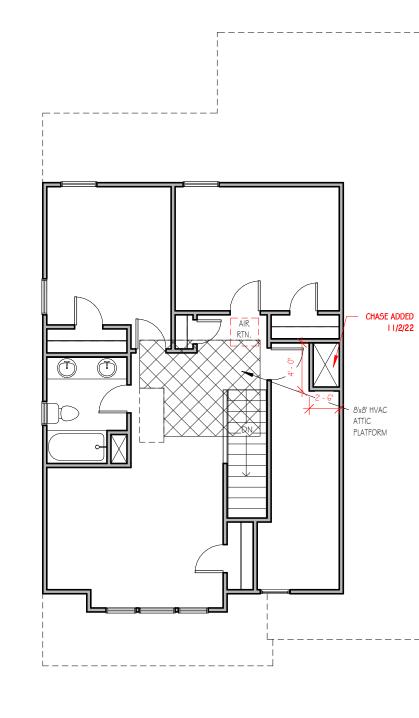


-ф Цент Филиме
Ó - FANLIGHT
OWP- WATERPROOF OUTLET
CI - RECESSED LIGHTING
+ - BINKLE PULL BATCH
B - D-WAY SWITCH
\$ - 4-MAY SMITCH
F - DHHER SHITCH
- MOKE DETECTOR
PA - HLOOD Lianina
V - EVERALL SHOTS
OF THE PROPERTY OF THE PROP
220 VOLT REGETTACLE
- BWITCHED RECEPTAGLE (TOP WIRE ONLY)
GROUND FAILT CIRCUIT NTERRUPTOR
телск нанта
- Hukinesatikr Lievinike
0 - CABLE OUTLET
A - TELEPHONE OUTLET
A - COMPUTER DATA OUTLET
2 - DURGLAR ALARM
- INTERSOM
NOTE: ALL ELECTRICAL TO BE VERIFIED BY OWNER/BULDER BEFORE ROUGH-IN.





1/8" = 1'-0"



SECOND FLOOR MECHANICAL PAGE

|/8" = |'-0"


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FIRST FLOOR PLUMBING

1/8" = 1'-0"

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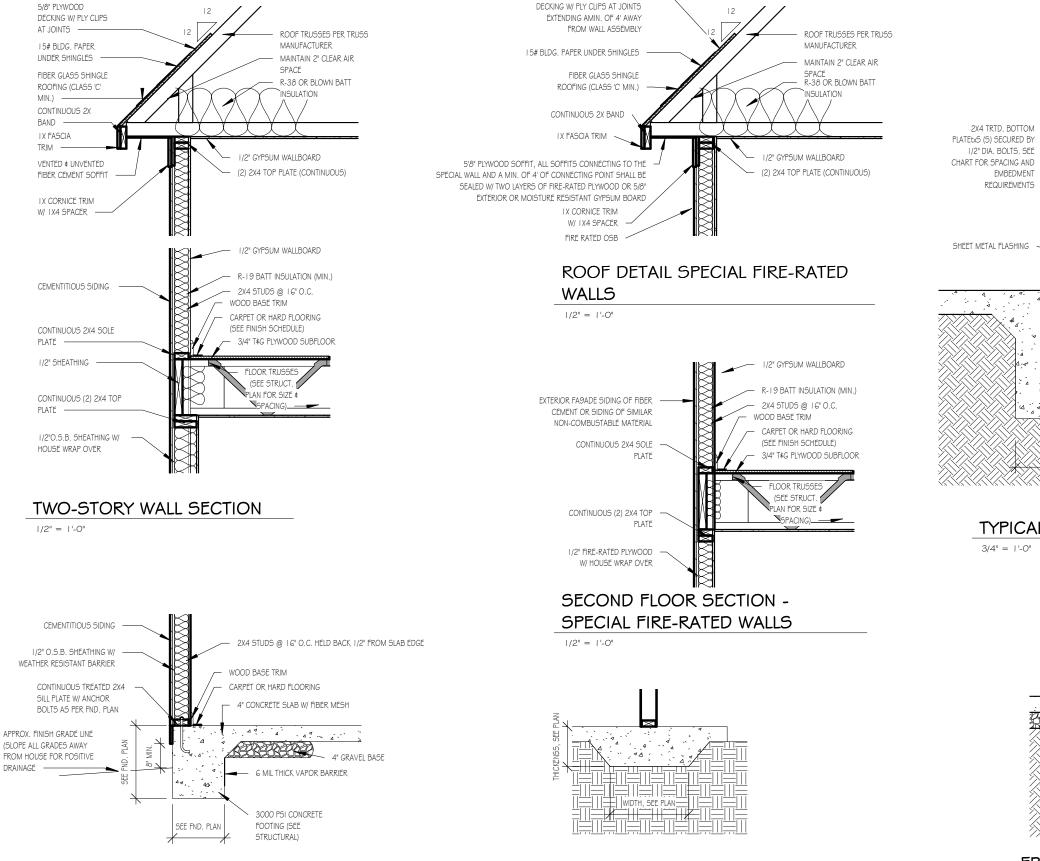
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1/2" FIRE-RATED PLYWOOD -

FOUNDATION DETAIL - SLAB


1/2" = 1'-0"

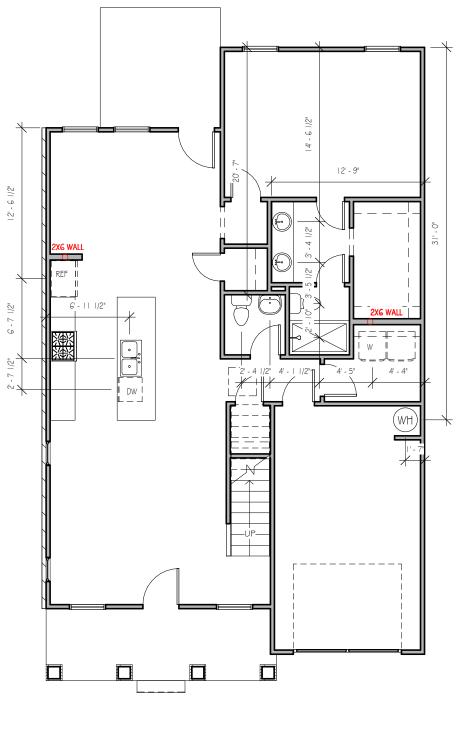DRAINAGE


LUG FOOTING 1/2" = 1'-0"

1/2" = 1'-0"

FRONT PORCH COLUMNS SUPPORT ATTACHMENT

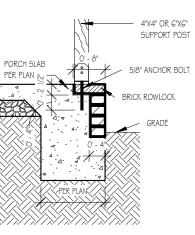

TYPICAL SLAB W/ BRICK VENEER

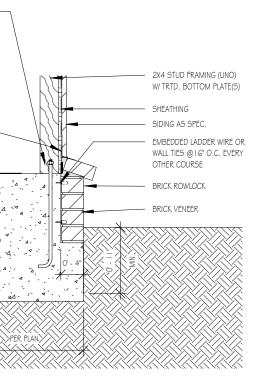

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CONSTRUCTION. ONCE A PERMIT HAS

BEEN ISSUED, CONTRACTOR SHALL

ACCURACY OF THE PLANS AND ANY

CHANGES MADE DURING

CONSTRUCTION.

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SERENITY COLLECTION \frown Ш SHEI 4 PIC


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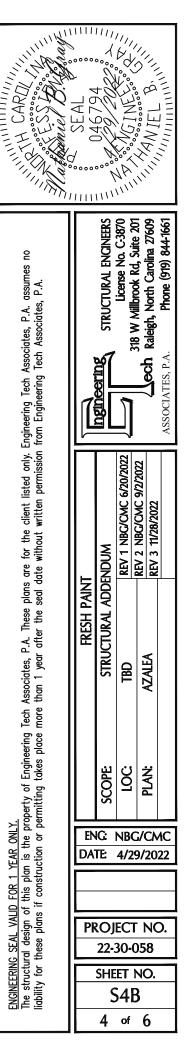
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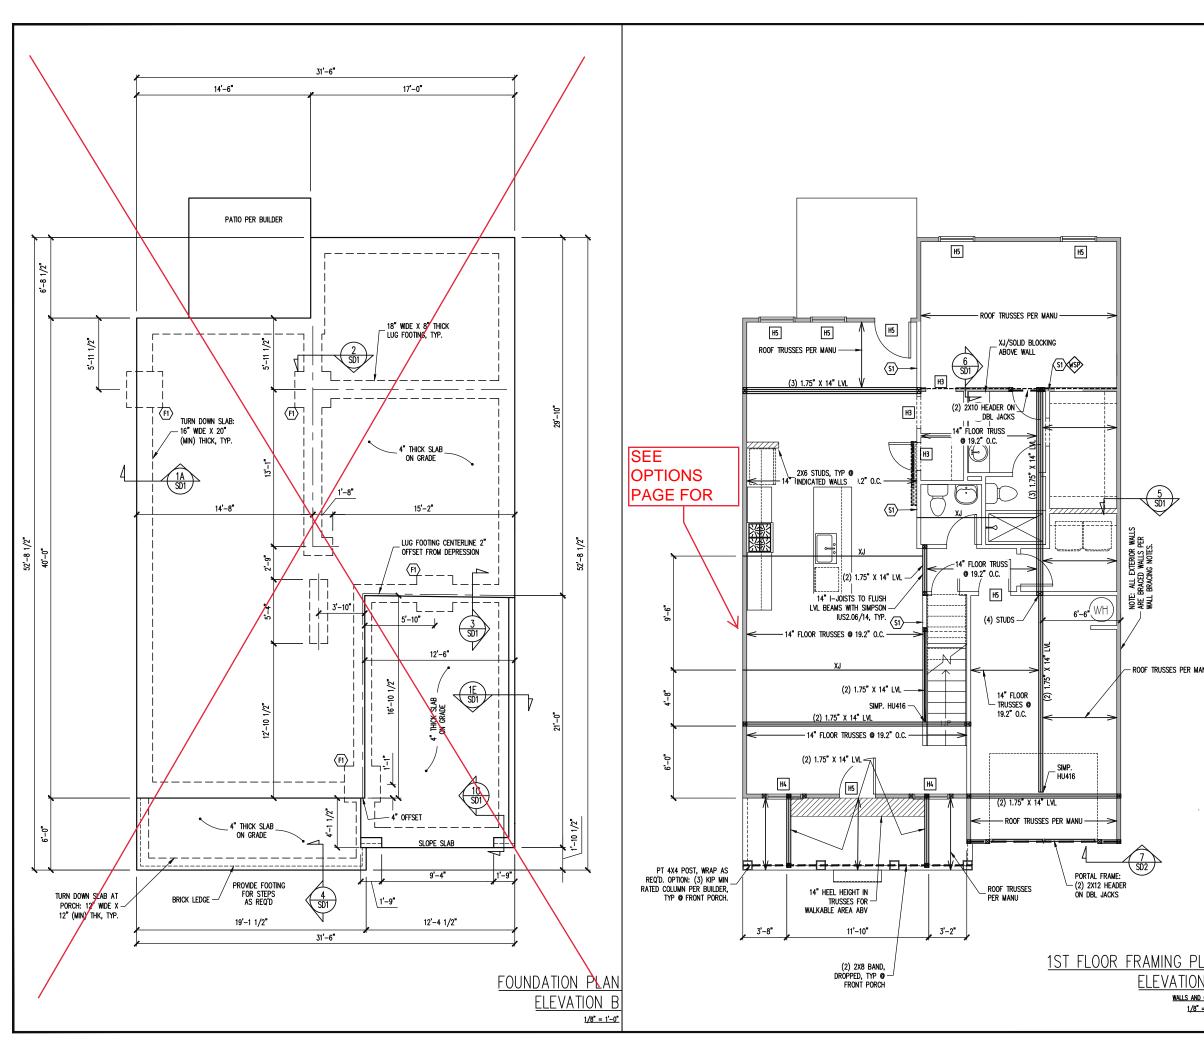
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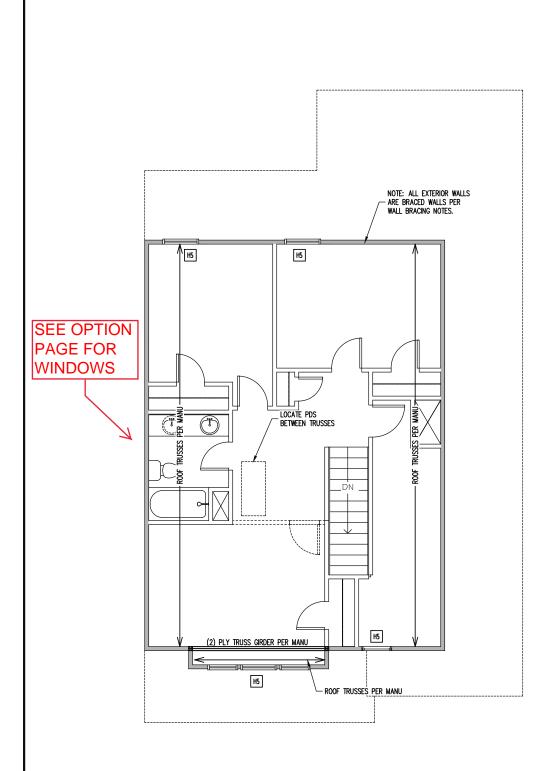











FRAMING SCEDULE S1 INTERIOR LOAD BEARING WALL: SECURE TO THICKENED SLAB BELOW WITH 1/2"# RED HEADER ANCHOR (OR EQUAL) @ 6"-0" O.C., 12" MAX FROM ENDS / CORNERS OF WALL, 7" MIN EMBEDMENT INTO SLAB BELOW. JOIST SUBSTITUTION	CARDINI (11/1/1/1/1/1/1/1/1/1/1/1/1/1/1/1/1/1/1
14" FLOOR TRUSSES PERMITTED TO BE SUBSTITUTED WITH 14" I-JOISTS. MAINTAIN MINIMUM SPACING AS CALLED OUT ON PLANS. SIMP. IUS/ITS2.06/14 HANGERS TO BE SUBSTITUTED WITH SIMP. IUS/ITS2.06/14 HANGER WHEN I-JOISTS HAVE BEEN INSTALLED. CONSTRUCTION SPECIFICATIONS INSTANT REFERENCES REFER TO THE CONSTRUCTION SPECIFICATIONS SECTIONS FOR THE FOLLOWING INFORMATION: PART 1.01: CURRENT GOVERNING CODE PART 14: STUD SUPPORT FOR BEAMS PART 17: KING STUDS FOR EXTERIOR WALLS SEE DETAIL / CONSTRUCTION SPECIFICATIONS SHEETS FOR I-JOISTS ALLOWABLE SUBSTITUTIONS	plans are for the client listed only. Engineering Tech Associates, P.A. assumes no seal date without written permission from Engineering Tech Associates, P.A. assumes no PAINT ADDENDUM REV 1 NBC/CMC 6/20/2022 REV 1 NBC/CMC 6/20/2022 REV 2 NBC/CMC 6/20/2022 REV 2 NBC/CMC 6/20/2022 ASSOCIATES, P.A. assumes no assumes no for Associates, P.A. assumes no assumes no for Associates, P.A. assumes no assumes no associates, P.A. assumes no assumes no associates, P.A. assumes no assumes no associates, P.A. assumes no associates, P.A. associates, P.A. associates, P.A. associates, P.A. Associates, P.A. associates, P.A.
WALL BRACING SHADED WALLS: ALL EXTERIOR STUD WALLS, EXTERIOR SIDE, ARE TO BE CONTINUOUSLY SHEATHED WITH 7/16 APA RATED CSB NALED TO STUDS WITH 8d NAILS © 6" O.C. AT PANEL EDGES, 12" O.C. IN PANEL FIELD. WSP - ONE SIDE OF INTERIOR WALL OR INSIDE OF EXTERIOR WALL WITH 3/8" MIN. THICKNESS WOOD STRUCTURAL PANELING. ATTACH WSP TO STUD WALL WITH 8d NAILS © 4" O.C. AT PANEL EDGES, 8" O.C. IN PANEL FIELD. NOTES: PROVIDED CONTINUOUS SHEATHING = 164' MIN. REFERENCE PART 16.02 OF CONSTRUCTION SPECIFICATIONS FOR GENERAL WIND BRACING INFORMATION. HEADER SCHEDULE H1< SINGLE 2X4 TURNED FLAT (A)	h Associates, P.A. These plans are for the client listed only. e than 1 year after the seal date without written permission FRESH PAINT STRUCTURAL ADDENDUM TBD TBD REV 2 NBC/CMC 6/20/2022 AZALEA REV 3 11/28/2022
H2 (2) 2X4'S ON SINGLE JACKS (B) H3 (2) 2X10'S ON SINGLE JACKS (C) H4 (2) 1.75" X 9.25" LVL'S ON DBL JACKS H5 (2) 2X8'S ON SINGLE JACKS	FOR 1 YEAR ONLY. this plan is the property of Engineering Tech Associates, P.A. These f construction or permitting takes place more than 1 year after the TECH I and the second s
AN B CELING AN AN B CELING COLOR COL	ENC: NBC/CMC The structural design of this plan is the plans if construction or plans if construction or these plans if construction or plans if SHEET NO. SHEET NO. SHEET NO. SHEET NO. 1 of 6

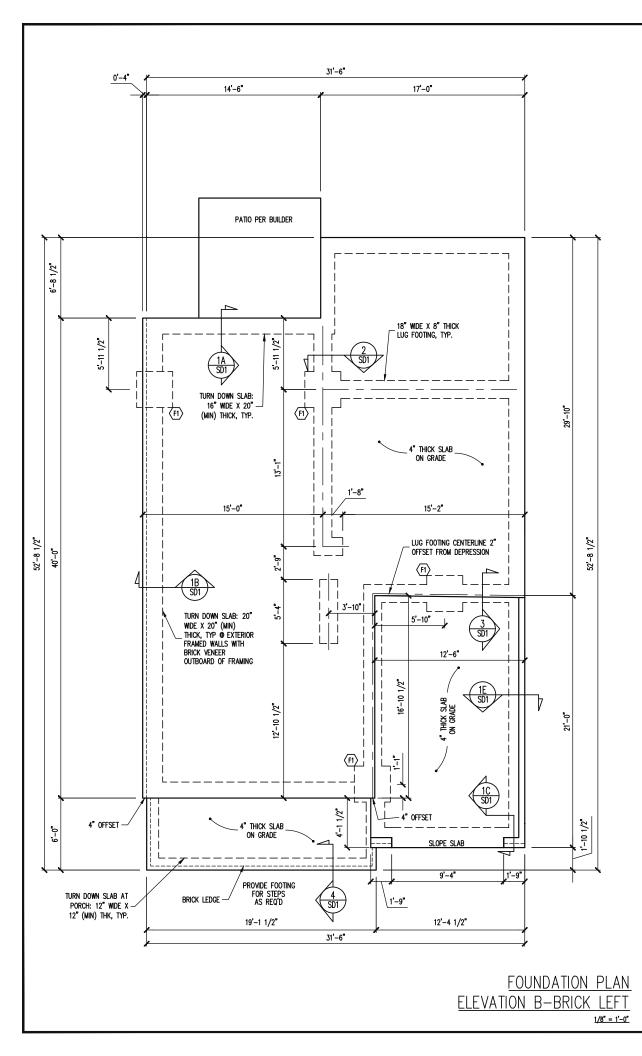


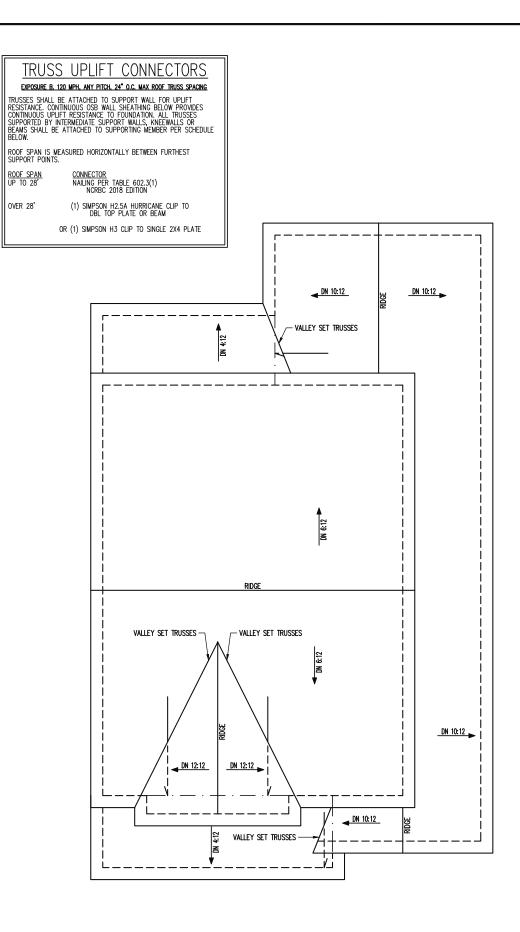


2ND FLOOR FRAMING PLAN ELEVATION B WALLS AND CEILING 1/8" = 1-0" ROOF FRAMING PLAN ELEVATION B

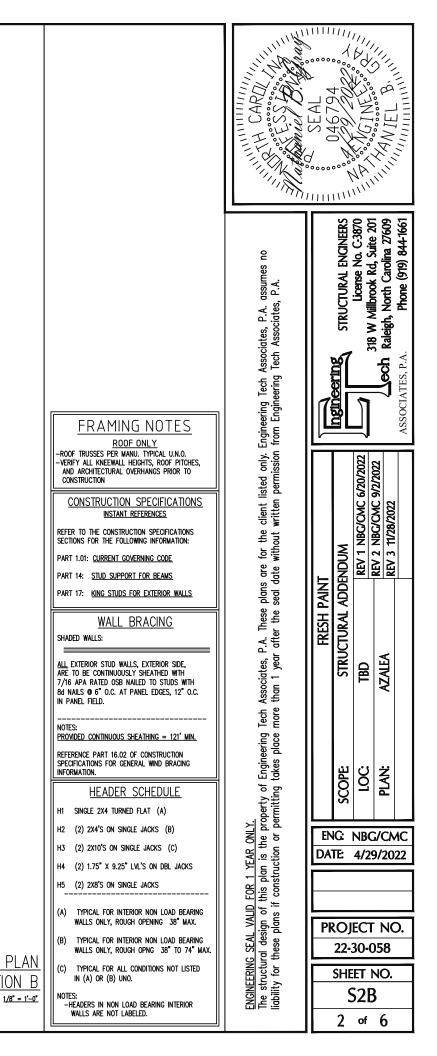


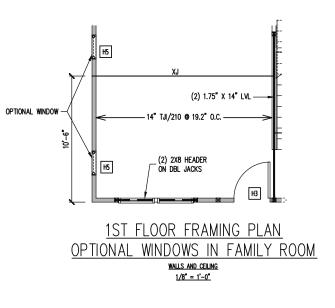


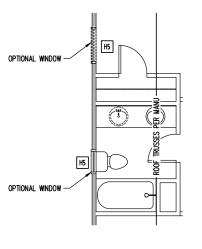

2ND FLOOR FRAMING PLAN OPTIONAL WINDOWS WALLS AND CELING 1/8" = 1"-0"

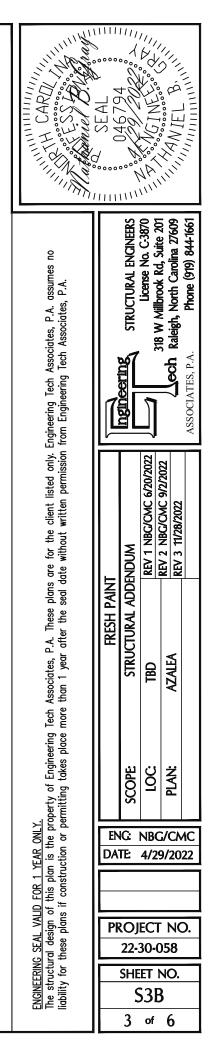

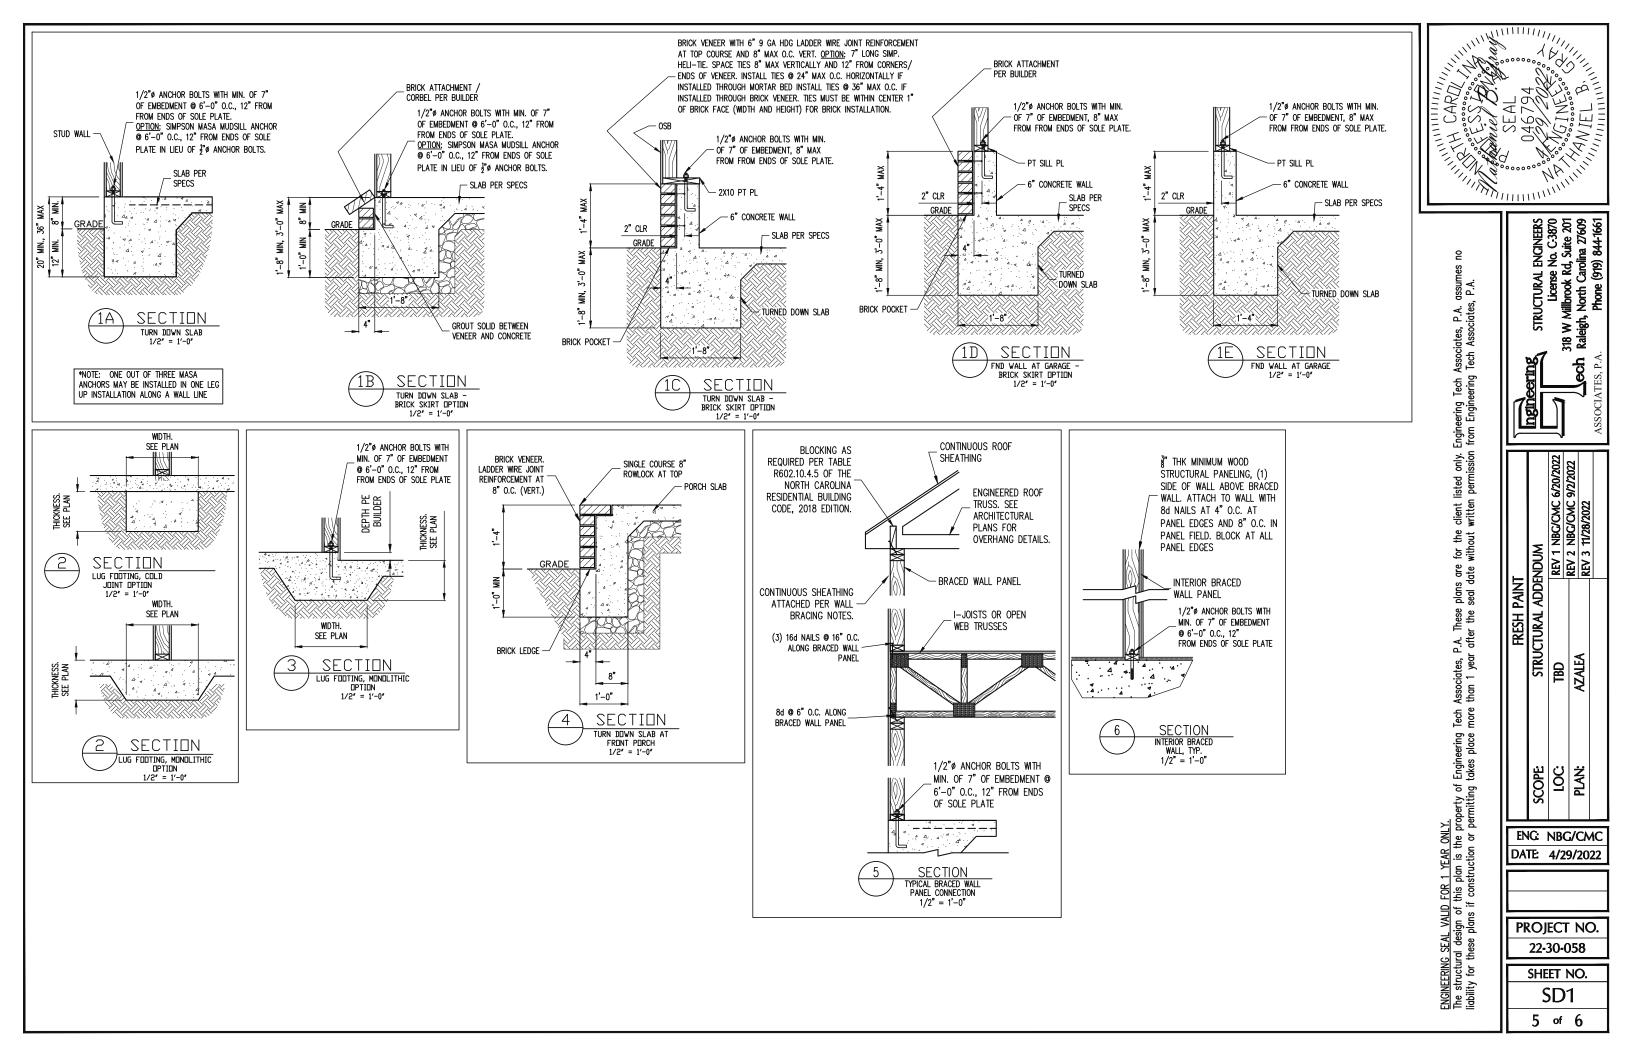

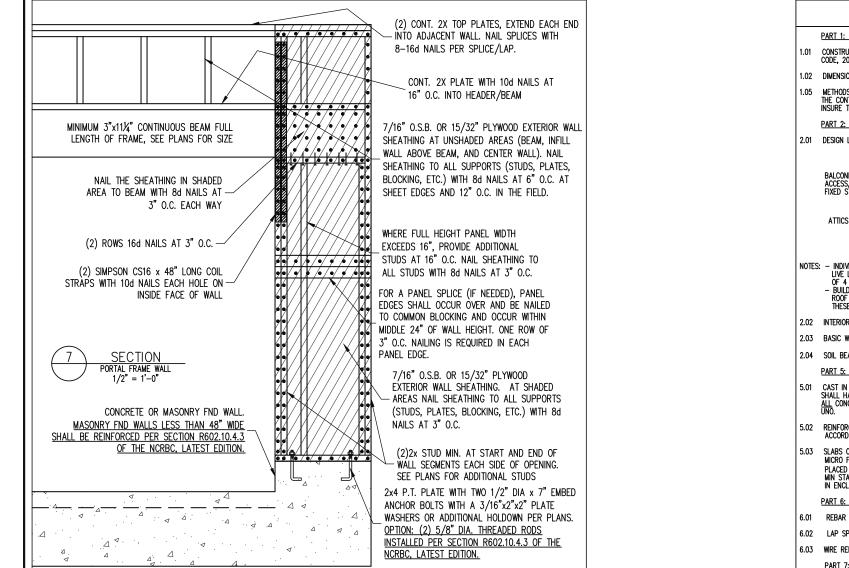

NOTE: MAINTAIN JOIST DEPTH, DIRECTION, AND SPACING SPECIFIED ON PLANS.						ABOVE	-	BREVIATION FOUNDATION	1	TRIPLE JOIS
MANUFACTURER BLUELINX BOISE CASCADE BOISE CASCADE INTERNATIONAL BEAMS LP CORP NORDIC ROSEBURG WEYERHAEUSER	11.875" 11.875" 11.875" 11.875" 11.875"	BLI 40 BCI 5000s BCI 6000s IB 400 LPI 20+	SIMPSON FACE MOUNT HGR IUS2.56/11.88 IUS2.06/11.88 IUS2.56/11.88 IUS2.56/11.88 IUS2.56/11.88 IUS2.56/11.88 IUS2.66/11.88	SIMPSON TOP FLANGE HGR ITS2.56/11.88 ITS2.06/11.88 ITS2.56/11.88 ITS2.56/11.88 ITS2.56/11.88 ITS2.56/11.88 ITS2.06/11.88	CS DIA DBL DJ DSP EQ EA FLG	BOTH BOTH ENDS BETWEEN CAST IN PLACE CONCRETE CONTINUOUS SHEATHING DIAMETER DOUBLE JOIST DOUBLE JOIST DOBL STUD POCKET EQUAL EACH FLANGE FLICH PLATE	HDG HGR LVL NTS O.C. PSL PT QJ SP	FOOTING HOT DIPPED GALVANIZED HANGER LAMINATED VENEER LUMBER NOT TO SCALE ON CENTER PARALLEL STRAND LUMBER PRESSURE TREATED QUAD JOIST STUD POCKET SQUARE		Typical Triple Sti Unless N Otherwise Extra Joi
WEYERHAEUSER BLUELINX BOISE CASCADE	11.875" 14" 14"	EEI-20 BLI 40 BCI 5000s	IUS2.37/11.88 IUS2.56/14 IUS2.06/14	ITS2.37/11.88 ITS2.56/14 ITS2.06/14	FLR	FLOOR		NOTES		
BOISE CASCADE LP CORP NORDIC ROSEBURG WEYERHAEUSER WEYERHAEUSER	14" 14" 14" 14" 14" 14"	BCI 6000S LPI 20+ NI 40X RFPI 40s TJI 210 EEI-20	IUS2.37/14 IUS2.56/14 IUS2.56/14 IUS2.56/14 IUS2.06/14 IUS2.37/14	ITS2.37/14 ITS2.56/14 ITS2.56/14 ITS2.56/14 ITS2.06/14 ITS2.73/14	SHALL FOLLOW 1) T	JILDER IS RESPONSIBLE FO IMMEDIATELY CONTACT TH ING CONDITIONS ARE NOTI HE WORKING PLANS DO NO HE PLANS CONTAIN DISCRE	e engini Ed befo It bear	ming plans prior to (EER of Record (EOR) RE or During Constru The seal of the EOR	Before Pr Jction:	
	THE PROF	PERTIES OF T	e may be used pr Hose listed. Sub: Jes as desired.		RESPO	RRORS DUE TO A FAILURE NSIBILITY OF THE EOR. FUF E THAN ANY REVISIONS IS: NTRACTORS	RTHERMO	RE, IT IS THE RESPONS	BILITY OF	THE BUILDER
	THE EOR DOES NOT PERFORM FENESTRATION OR VENTING CALCULAT CALCULATIONS THAT ARE NOT DIRECTLY RELATED TO STRUCTURAL E							D 1111/ 0711		

ROOF AND FLOOR TRUSSES TO BE DESIGNED BY AN ENGINEER REGISTERED BY THE STATE. FINAL TRUSS DRAWING SHOULD BE SUBMITTED TO THE EOR FOR REVIEW

	<u>CONSTRUCTION</u>	<u>SPE</u>	<u>CIFICATIONS</u>
	PART 1: GENERAL		PART 14: STUD SUPPORTS
1.01	CONSTRUCTION SHALL MEET THE REQUIREMENTS OF THE NORTH CAROLINA RESIDENTIAL CODE, 2018 EDITION.	14.01	Steel, Engineered Lumb Shall bear as follows:
1.02	DIMENSIONS SHOWN SHALL GOVERN OVER SCALE ON THESE DRAWINGS.		hen the beam is perpend Hall bear <u>full width</u> on (a minimum of three gan
1.05	METHODS, PROCEDURES AND SEQUENCES OF CONSTRUCTION ARE THE RESPONSIBILITY OF THE CONTRACTOR, WHO SHALL TAKE ALL NECESSARY PRECAUTIONS TO MAINTAIN AND INSURE THE INTEGRITY OF THE STRUCTURE AT ALL STAGES OF CONSTRUCTION.	OF TH	(a minimum of three gan 5 studs such that the s 16 beam being supported, 17 dition particular care
	PART 2: DESIGN LOADS	T- 2-B	ie beam Eams bearing onto the e
2.01	DESIGN LOADS SHALL CONFORM WITH THE TABLE BELOW: USE LIVE LOAD (PSF) DEAD LOAD (PSF)	A CC	Minimum of 4 1/2" onto Dlumn typ uno.
	BALCONIES, DECKS, ATTICS WITH FIXED STAIR	14.02	
	ACCESS, DWELLING UNITS INCLUDING ATTICS WITH FIXED STAIR ACCESS, STAIRS, FIRE ESCAPES 40 10	SH	hen the beam is perpend Iall bear <u>full width</u> on Ir a continuous Rim Jois
	GARAGES (PASSENGER CARS ONLY) 50 ATTICS (NO STORAGE, LESS THAN 5' HEADROOM) 10 10		NGED STUD COLUMN THE S BE SUPPORTED BY (3) ST TAKEN TO ENSURE STUD
	ATTICS (WE STORAGE, LESS TITAL STORAGE) 20 10	2-B	eams bearing onto the e
	ROOF 20 10 (15 FOR VAULTS)		NIMUM OF 3" ONTO THE WA 'P UNO.
NOTES:	 INDIVIDUAL STAIR TREADS ARE TO BE DESIGNED FOR THE UNIFORMLY DISTRIBUTED LIVE LOAD OF 40 PSF OR A 300 LB. CONCENTRATED LOAD ACTING OVER AN AREA OF 4 SQ. WHICHEVER PRODUCES THE GREATER STRESS. BUILDER TO VERIFY DEAD LOAD DOES NOT EXCEED 10 PSF WHEN HEAVY FLOOR OR ROOF FINISHES SUCH AS TILE OR SLATE ARE UTILIZED. NOTIFY ENGINEERING UNDER THESE CONDITIONED 	14.03	Extra Joists Bearing O The Beam Shall be Sui
	UT # 30. WITHOUTEVER FROUDUCES THE WREATER STRESS. - BUILDER TO VERIFY DEAD LOAD DOES NOT EXCEED 10 PSF WHEN HEAVY FLOOR OR ROOF FINISHES SUCH AS TILE OR SLATE ARE UTILIZED. NOTIFY FNGNEFRING INDER	14.04	STUDS THAT ARE GANGED THE COLUMN NAILED TOO
	THESE CONDITIONS		OF 10d NAILS @ 8" O.C., BE CONTINUOUS DOWN TO
2.02 2.03	INTERIOR WALLS: 5 PSF LATERAL. BASIC WIND DESIGN VELOCITY OF 120 MPH.		STRUCTURAL ELEMENT SU FLOOR LEVELS SHALL BE
2.05	SOIL BEARING CAPACITY 2000 PSF (PRESUMPTIVE).		WITHIN THE CAVITY FORME FLOOR JOISTS.
	PART 5: CONCRETE AND SLABS ON GRADE		PART 15: NAILING OF MUL
5.01	CAST IN PLACE CONCRETE SHALL BE OF NORMAL WEIGHT, 6% AIR ENTRAINMENT, AND SHALL HAVE A MINIMUM COMPRESSIVE STRENGTH OF 3000 PSI AT 28 DAYS TYP UNO. ALL CONCRETE, INCLUDING CONCRETE FOR FOOTINGS, IS TO BE CAST IN PLACE, TYP UNO.	15.01	SOLID SAWN LUMBER JOIS ADJACENT MEMBERS IN TH @ 16" O.C. FOR 2X10 OR ROW OF 10d NAILS @ 16"
5.02	REINFORCED CAST IN PLACE CONCRETE SHALL BE PROPORTIONED, MIXED AND PLACED IN ACCORDANCE WITH THE SPECIFICATIONS OF ACI 318, LATEST EDITION.	15.02	LVL MEMBERS THAT ARE IN THE BEAM FASTENED UNO
5.03	slabs on grade, if any, shall contain synthetic polypropylene fibrillated micro fibers, fiber length 1 1/2", dosage rate 1 1/2 LBS/CU yd. slab to be placed on a 6 mil vapor barrier on 2" min granular fill on soll with 90% min standard proctor density. Vapor barrier may be omitted for slabs not	16.01	PART 16: WALL FRAMING STUD WALLS SHALL CONS BE CONTINUOUS FROM SO
	IN ENCLOSED AREAS		OR ROOF. NO INTERMEDIA STUD WALL EXCEPT AS R
6.01	P <u>ART 6: REBAR AND WIRE REINFORCEMENT</u> REBAR SHALL BE DEFORMED STEEL CONFORMING TO ASTM A615 GRADE 60 TYP UNO		FOR SUCH OPENINGS SHA MAX ALLOWABLE WALL
6.02	LAP SPLICES SHALL BE CLASS B AS DEFINED BY ACI 318, TYP UNO		AND DBL TOP PLATE / 2X6 PURLINS AT 8' HE 2X4 @ 15" 0
6.03	WRE REINFORCEMENT SHALL BE 9 GA AND SHALL CONFORM TO ASTM A1064.		2X4 @ 16" 0 2X4 @ 12" 0 DBL 2X4 @ 16" 0
7.01	<u>PART 7: MASONRY</u> CONCRETE MASONRY UNITS SHALL CONFORM TO ASTM C90 AND C55, NORMAL WEIGHT, f'M = 1,500 PSI MIN	16.02	FOR WALL BRACING THE F -BLOCKING AT UNSUPPOR -WALL BRACING IS BY EN
7.02	CLAY MASONRY UNITS SHALL CONFORM TO ASTM C62-17 GRADE SW		602.10 OF THE 2018 NO WITH ALTERNATIVE METH OF THE 2018 NCRC HAS
7.03	MORTAR SHALL BE TYPE S. MORTAR AND GROUT SHALL CONFORM TO ASTM C476, MIN COMPRESSIVE STRENGTH OF 2000 PSI.		-BRACED WALL PANELS S PROVIDE CONTINUOUS P R602.3.5 AND R802.11
7.04	MASONRY CONSTRUCTION SHALL CONFORM TO THE SPECIFICATIONS OF ACI 530		-MAY SUBSTITUTE WSP FO -SINGLE JOIST, CONTINUO
7.05	LADDER WIRE REINFORCEMENT SHALL CONFORM TO ASTM A951. 6" MIN LAPS FOR CONTINUOUS WALL APPLICATIONS PART 8: BOLTS AND LAG SCREWS		ABOVE AND BELOW ALL WITH 16d TOE NAILS @ 6 BELOW WITH (3) 16d NAI WALL LINES ONLY REQUIR
8.03	ANCHOR RODS AND BOLTS SHALL CONFORM TO ASTM F1554-15 GRADE 36 UNO. BENT		PART 17: KING STUDS
	ANCHOR BOLTS SHALL HAVE A 2" MIN HOOK UNO DART 0: DRIVEN EASTENERS	17.01	King studs for opening
9.01	P <u>art 9: Driven Fasteners</u> Nails, spikes and staples shall conform to astm f 1667– 05. Nails are to be		MAX OPENING WIDTH 5'
	COMMÓN WIRE OR BOX PART 10: DIMENSIONAL LUMBER		STUD SIZE 2X6 2X8
10.01	Solid Sawn wood framing design is based on No. 2 spruce Pine Fir <u>or</u> syp #2		PART 18: SUBSTITUTIONS
PAR	FOR JOISTS, RAFTERS, GIRDERS, BEAMS, STUDS, ETC.	18.01	MATERIAL OR MEMBER SIZ
11.01	LVL OR PSL MINIMUM ALLOWABLE DESIGN STRESSES ARE AS FOLLOWS:		DEVIATIONS REQUIRE THE DESIGNERS. UNAUTHORIZED RESPONSIBILITY OF THE C
	E= 1.9 X 10E6 P3, Fb = 2600 PS, Fv = 285 P3, Fc = 750 PSI LSL MINIMUM ALLOWABLE DESIGN STRESSES ARE AS FOLLOWS: E= 1.3 X 10E6 P3, Fb = 1700 PS, Fv = 400 PSI, Fc = 680 PSI		PART 19: OWNERSHIP OF
11.02	e= 1.3 x 1020 F31, FD = 1700 F31, FV = 400 F31, FC = 000 F31 LVL or PSL members may be ripped from deeper members to match the member depth specified in the plans	19.01	THE STRUCTURAL DESIGN OF ENGINEERING TECH AS ARE FOR THE ONE TIME
	PART 12: PRESSURE TREATED LUMBER		AND FOR THE CLIENT LIS FOR THESE PLANS IF TH
12.01	LUMBER IN CONTACT WITH THE GROUND, CONCRETE OR MASONRY SHALL BE PRESSURE TREATED IN ACCORDANCE WITH AWPA STANDARD C-15. ALL OTHER EXPOSED LUMBER SHALL BE TREATED IN ACCORDANCE WITH AWPA STANDARD C-2 OR BY ANY METHOD GWING EQUAL PROTECTION. THE BUILDING CODE OFFICE MAY ALSO APPROVE A NATURAL DECAY RESISTANT WOOD PER SECTION 19-6(A)		IN PART, FOR CONSTRUC WITHOUT WRITTEN PERMIS

PORTS FOR BEAMS

LUMBER, AND FLITCH PLATE BEAMS BEARING ON A STUD WALL LOWS:

Republicular to, or skewed relative to the wall, the beam \underline{H} on the supporting wall indicated and shall be supported \underline{E} ganged studs, or a ganged stud column with a number the stud column is at least as wide as the true width of dred, whichever is greater, typ und. For the skewed CARE SHALL BE TAKEN TO ENSURE STUD COLUMN IS CENTERED ON

THE END OF A STUD WALL PARALLEL TO THE BEAM SHALL BEAR NTO THE WALL AND BE SUPPORTED BY A TRPL STUD GANGED

BEAMS BEARING ON A STUD WALL SHALL BEAR AS FOLLOWS:

Rendicular to, or skewed relative to the wall, the beam $\frac{1}{2}$ on the supporting wall indicated (less 1 1/2" to allow JOIST WHERE APPLICABLE) AND SHALL BE SUPPORTED BY A he same width as the beam typ uno. (e.g. a triple 2x10 is) STUDS), FOR THE SKEWED CONDITION PARTICULAR CARE SHALL TID COLUMN IS CENTERED ON THE BEAM HE END OF A STUD WALL PARALLEL TO THE BEAM SHALL BEAR / E WALL AND BE SUPPORTED BY A DBL STUD GANGED COLUMN

ING ON A STUD WALL PERPENDICULAR TO OR SKEWED RELATIVE TO BE SUPPORTED BY ONE ADDITIONAL STUD.

NGED TO FORM A COLUMN SHALL HAVE ADJACENT STUDS WITHIN D TOGETHER WITH ONE ROW OF 10d NAILS AT 8" O.C. (TWO ROWS O.C., 3" APART, FOR 2X8 OR 2X10 STUDS) ALL COLUMNS SHALL NOT THE FOUNDATION OR OTHER PROPERLY DESCRED T SUCH AS A BEAM. COLUMNS TRANSFERRING LOADS THROUGH BE SOLDLY BLOCKED FOR THE FULL WIDTH OF THE STUD COLUMN ONLY DE ORMED BY THE

MULTI PLY WOOD BEAMS

R JOISTS THAT ARE GANGED TO FORM A BEAM SHALL HAVE IN THE BEAM NAILED TOGETHER WITH THREE ROWS OF 10d NAILS OR LARGER, TWO ROWS OF 10d NAILS @ 16" O.C. FOR 2X8, ONE 16" O.C. FOR 2X6 OR SMALLER. STAGGER ROWS 5" MIN.

ARE GANGED TO FORM A BEAM SHALL HAVE ADJACENT MEMBERS TENED TOGETHER PER MANUFACTURERS RECOMMENDATIONS, TYP

MING AND BRACING

CONSIST OF 2X4 STUDS SPACED AT 16" O.C. UNO. STUDS SHALL M SOLE PLATE AT FLOOR TO DOUBLE TOP PLATE AT THE CEILING MEDIATE BANDS OR PLATES SHALL CAUSE DISCONTINUITIES IN A ABJAILE DANUS OF FORES SHALL GROUP DISCONTINUITIES IN A AS REQUIRED FOR DOOR OR WINDOW OPENINGS. THE KING STUDS SHALL BE CONTINUOUS, TYP UNO. WALL HEIGHTS FOR EXTERIOR STUD WALLS, WITH SOLE PLATE WALL HIGHTS FURCH SATERIOR STOD WALLS, WITH SOLE PLATE ATE AND 7/16° OSE EXTERIOR BRACING AND ROW OF 2X4 / 8° HEIGHT (AND AT 16° HEIGHT FOR TALL WALLS), TYP UNO: 16° O.C.: 11°−0° ZX6 @ 16° O.C.: 17°−0° 12° O.C.: 12°−0° ZX6 @ 16° O.C.: 21°−0°

THE FOLLOWING SHALL APPLY:

THE FOLLOWING STALL APPLY: PPORTED PAREL EDGES IS REQUIRED TYP UNO. BY ENGINEERED DESIGN AND NOT PRESCRIPTIVE PER SECTION 18 NCRC. CONTINUOUS SHEATHING HAS BEEN PROVIDED, ALONG METHODS TO INSURE THE MINIMUM INTENT OF SECTION 602.10 C HAS BEEN MET AND EXCEEDED. EL SUML BE ENSTRIED IN ADDORDANCE WITH TABLE E02 3(1)

ELS SHALL BE FASTENED IN ACCORDANCE WITH TABLE 602.3(1) TO US PANEL UPLIFT RESISTANCE AND COMPLIANCE WITH NORBC 2.11_UNLESS NOTED OTHERWISE ON STRUCTURAL PLANS. SP FOR GB

is for GB in Joist, or Blocking of Equal Depth is required all braced walls. Nail blocking above wall to top plate S \odot 6° 0.C. Nail Sole plate of braced wall to blocking A NAILS @ 16" O.C. BLOCKING AT HORIZONTAL JOINTS IN BRACED REQUIRED AT SHADED WALLS, UNO.

ENINGS IN EXTERIOR WALLS SHALL BE AS FOLLOWS:

5'-0"	NUMBE 9'-0"	r of Kin 13'-0"	g studs 17°-0"	21'-0'
1	2	3	4	5
1	1	2	2	2
1	1	1	1	2

ER SIZE SUBSTITUTIONS OR PLAN THE WRITTEN AUTHORIZATION OF THE RIZED DEVIATIONS ARE THE SOLE HE CONTRACTOR.

OF STRUCTURAL DESIGN

ESIGN OF THIS PLAN IS THE PROPERTY CH ASSOCIATES (ETA). THESE PLANS TIME USE AT THE LOCATION INDICATED IT LISTED. ETA ASSUMES NO LIABILITY THEY ARE REPRODUCED. IN WHOLE OR STRUCTION AT ANY OTHER LOCATION

